

CAMBRIDGE HISTORICAL COMMISSION RECEIVED

831 Massachusetts Avenue, 2nd Fl., Cambridge, Massachusetts 02139 Telephone: 617 349 4683 Fax: 617 349 3116 TTY: 617 349 6112

E-mail: histcomm@cambridgema.gov URL: http://www.cambridgema.gov/Historio 16 2016

APPLICATION FOR CERTIFICATE

CAMBRIDGE HISTORICAL COMMISSION

- 1. The undersigned hereby applies to the Cambridge Historical Commission for a Certificate of (check one box): Appropriateness, Nonapplicability, or Hardship, in accordance with Chapter 40C of the Massachusetts General Laws and/or Chapter 2.78 of the Municipal Code.
- 2. Address of property: 43 Reservoir Street

, Cambridge, Massachusetts

3. Describe the proposed alteration(s), construction or demolition in the space provided below: (An additional page can be attached, if necessary).

Exterior maintenance of the existing house to include:

- The cleaning and painting of existing stucco. The existing stucco finish to remain.
- The stripping/scraping and repainting of all existing trim.
- The replacement of existing dental trim with holes provided that the holes are not for aesthetic reasons, but for roof venting.
- The replacement of existing roof with a new slate roof to match the slate on the existing garage.
- The removal and re-installation of copper gutters for the purposes of stripping and repainting trim.
- The installation of shutters on east and south elevations.
- The removal of the existing trellis at the south elevation of the house.
- The demolition of the second floor sleeping porch.
- The demolition of the existing pergola at the west elevation of the house.
- The restoration of the existing leaded glass windows in the Living Room bay.
- The replacement of existing windows with new custom replacement wood windows.

I certify that the information contained herein is true and accurate to the best of my knowledge and belief. The undersigned also attests that he/she has read the statements printed on the reverse.

Name of Property Owner of Record: Daniel Sterner	& Elizabeth Clark Libert		
Mailing Address: 43 Reservoir Street, Cambridge, MA 02138			
Telephone/Fax: 610-451-6062 (Dan Cell)	E-mail: dsterner@forestproperties.net		
Signature of Property Owner of Record: (Required field; application will not be considered complete without property owner's signature)			
Name of proponent, if not record owner:			
Mailing Address:			
Telephone/Fax:	E-mail:		
(C CC 1)			
(for office use only):	2175 0101.		
(for office use only): Date Application Received: 8 16 16 Case Number	r: 3675 Hearing Date: 9 8 16		
(for office use only): Date Application Received: Sill Case Number Type of Certificate Issued:	r: 3675 Hearing Date: 9 8 16 Date Issued:		

* visible from public way and advertised for public hearing. As noted by S. Burks, CHC

STERNER RESIDENCE

43 RESERVOIR STREET CAMBRIDGE, MA



HISTORIC REVIEW 08/15/16




222 Third Street, Suite 3212 tel: 617 621-1455 Cambridge, MA 02142 fax 617 621-1477 www.LDa-Architects.com


F.A.R. DIAGRAMS

ZONING CALCULATIONS	
BASEMENT AREA:	N/A
FIRST FLOOR AREA:	2,042.8 SF
SECOND FLOOR AREA	1,860.5 SF
ATTIC FLOOR AREA:	872.4 SF
TOTAL AREA:	4,775.7 SF
EXISTING TOTAL AREA:	4,905 8 SF
F.A.R. ALLOWABLE AREA:	12,817 SF

FLOOR AREA GROSS

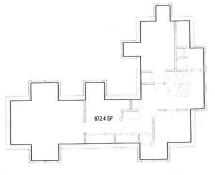

ATTIC FLOOR PLAN ZONING

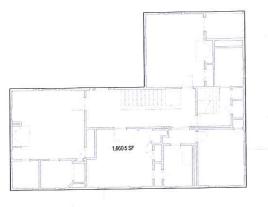

3 SECOND FLOOR ZONING PLAN



2 FIRST FLOOR ZONING DIAGRAM



ABBREVIATIONS

OC ON CENTER AFF ABOVE FINISH FLOOR POUND PER CUBIC FOOT PLASTIC LAMINATE PRESERVATIVE TREATED POLYVINYL CHLORIDE CIP CAST-IN-PLACE CONC CONCRETE EXIST **EXISTING** SQUARE FOOT SHEET SIMLAR SPECIFICATIONS FIN FLR FT FINISH FLOOR FOOT GC GWB TREAD TONGUE AND GROOVE TYPICAL HP HIGH POINT IN MAX MOF MDO MIN MISC MO AND AT NUMBER CENTERLINE

DRAWING LIST

ZONING

NOT TO SCALE

NTS

LOCATION:

43 RESERVOIR STREET CAMBRIDGE, MA 02138 BOOK 63349, PAGE 225

237-36 CITY OF CAMBRIDGE ZONING ORDINANCE ORDINANCE #1372 JUNE 15, 2016

ZONING DISTRICT: LOT AREA MINIMUM. 8,000SF

FAR

ACTUAL: 25,634 SF MAXIMUM: (0.5) 12,817 SF ACTUAL: 4,775.7 SF

ACTUAL: 28'-9" (ESTIMATE)

GENERAL PROJECT NOTES

THE FROJECT CONSISTS OF EXTERIOR AND INTERIOR MAINTENANCE OF AN EXISTING SINGLE FAMILY RESIDENCE.

THE ERRAINING SAFE INTENDED TO BE READ IN CONJUNICTION WITH SPECIFICATIONS. PROMPILY REPORT DISCREPANCIES IN THE DRAWINGS AND BETWEEN DRAWINGS AND SPECIFICATIONS TO THE ARCHITECT AMDIOR OWNER.

THE CONTRACTOR IS TO COMPLETE THE WORK IN COMPUNICE WITH ZONING ORDINANCES, BUILDING COOSE, ENERGY CODES AND GENERAL LAWS APPLICABLE TO THE REGULATORY JURISDICTION OF THE PROJECT ITS THE REPORSIBILITY OF THE CONTRACTOR AND THE CONTRACTOR SUB-CONTRACTORS TO REVIEW EXISTING SITE AND BUILDING CONSTITUTIONS TO THE EXTENT MECESSARY TO CONFIRM THAT THE WORK CAN BE EXECUTED WITHOUT DELAYS OR ADDITIONAL COST

BUILDING CODE

BUILDING CODE: INTERNATIONAL RESIDENTIAL CODE 2009 (IRC)
780 CARS 1.00, IMASSACHUSETTS AMERIMMENTS TO THE IRC
ONE AND TWO FAMILY DWELLING

ENERGY CODE: 780 CMR, 8TH EDITION, APPENDIX 115 AA 'STRETCH' ENERGY CODE INTERNATIONAL ENERGY CONSERVATION CODE (IECC) 2009

MINIMUM THERMAL PERFORMANCE (CLIMATE ZONE 5)

CEILING MINIMUM.
WALLS MINIMUM:
BASEMENT WALLS MINIMUM:
CRAWLSPACE WALLS MINIMUM:
SLAB-ON-GRADE MINIMUM: FENESTRATION MAXIMUM:

ACTUAL: R-38 MINIMUM

LOCUS MAP



LOCATION MAP

STERNER RESIDENCE

LDa Architecture & Interiors, LLP 222 Third Street, Suite 3212 Cambridge, MA 02142 617 621-1455 fax 617 621-1477 www.LDa Architects.com

43 RESERVOIR STREET CAMBRIDGE, MA

ISSUANCE: HISTORIC SET

As indicated SCALE: Author DRAWN: CHECKED: Checker

SHEET INFO: INDEX SHEET

SYMBOLS KEY



FLEVATION MARKER DOOR REFERENCE NUMBER



ELEVATION CALL OU



KEYNOTE REFERENCE



STRUCTURAL GRID LINE

(1 A101)

DETAIL REFERENCE

WINDOW SCHEDULE

BASEMENT

NUMBER	WIDTH - VIF	HEIGHT - VIF	TYPE	
001	2-8"	4:-2"	A	EXISTING TO REMAIN - REPAINT ONLY
002	2-8"	4'-2"	A	EXISTING TO REMAIN - REPAINT ONLY
003	7-8"	4'-2"	A	EXISTING TO REMAIN - REPAINT ONLY
004	7-8'	4:-2"	A	EXISTING TO REMAIN - REPAINT ONLY
005	2.8"	4-2	X	EXISTING TO REMAIN - REPAINT ONLY
006	2-8'	2-8 1/2"	W	EXISTING TO REMAIN - REPAINT ONLY
007	2-8*	2-8 1/2"	W	EXISTING TO REMAIN - REPAINT ONLY
008	2.8"	2-8 1/2*	W	EXISTING TO REMAIN - REPAINT ONLY
009	2-8"	2-8 1/2*	W	EXISTING TO REMAIN - REPAINT ONLY
010	2-8'	2-8 1/2*	В	EXISTING TO REMAIN - REPAINT ONLY
011	2-8'	2-8 1/2"	В	EXISTING TO REMAIN - REPAINT ONLY
012	7-8'	2-8 1/2*	В	EXISTING TO REMAIN - REPAINT ONLY
013	2.8"	2-8 1/2"	V	EXISTING TO REMAIN - REPAINT ONLY
014	7-8	2-8 1/2"	V	EXISTING TO REMAIN - REPAINT ONLY
015	2-8'	2-8 1/2*	В	EXISTING TO REMAIN - REPAINT ONLY
016	2-8"	2-8 1/2"	В	EXISTING TO REMAIN - REPAINT ONLY
017	1'-8'	2-8 1/2"	U	EXISTING TO REMAIN - REPAINT ONLY

1ST FLOOR

NUMBER	WIDTH - VIF	HEIGHT - VIF	TYPE	NOTES
101	2-8*	4-2	Y	DOUBLE HUNG - 12/12 LITES
102	2-8"	4-2	Υ	DOUBLE HUNG - 12/12 LITES
103	2-0 1/4"	4'-11 3/4'	C	DOUBLE HUNG - 9/9 LITES
104	2-0 1/4"	4'-11 3/4'	C	DOUBLE HUNG - 9/9 LITES
105	2-8*	4'-2"	A	EXISTING TO REMAIN - REPAINT ONLY
106	2-4"	1'-10"	D	EXISTING TO REMAIN - REPAINT ONLY
107	2-0 1/4"	4'-2"	E	EXISTING TO REMAIN - REPAINT ONLY
108	2-0 1/4"	4-2	E	EXISTING TO REMAIN - REPAINT ONLY
109	2-0 1/4*	4'-2"	E	EXISTING TO REMAIN - REPAINT ONLY
110	2-0 1/4"	4-2	E	EXISTING TO REMAIN - REPAINT ONLY
111	2-0 1/4"	4.2	E	EXISTING TO REMAIN - REPAINT ONLY
112	2-0 1/4*	4'-2"	E	EXISTING TO REMAIN - REPAINT ONLY
113	2.8"	4'-2'	A	DOUBLE HUNG - 8/12 LITES
114	1'-5"	4'-11 1/2"	F	DOUBLE HUNG - 6/6 LITES
115	3-3 3/4*	4'-11 1/2'	G	DOUBLE HUNG - 15/15 LITES
116	1'-5"	4'-11 1/2'	F	DOUBLE HUNG - 6/6 LITES
117	3'-3"	6'-11 1/2"	H	EXISTING TO REMAIN - REPAINT ONLY
118	3-3*	6-11 1/2*	H	EXISTING TO REMAIN - REPAINT ONLY
119	10 1/2"	6-11"	1	EXISTING TO REMAIN - REPAINT ONLY
120	3'-6"	6-11"	J	EXISTING TO REMAIN - REPAINT ONLY
121	10 1/2"	6-11"	1	EXISTING TO REMAIN - REPAINT ONLY
122	1'-7 3/4"	7.0	K	EXISTING TO REMAIN - REPAINT ONLY
123	3-3"	6-11 1/2"	Н	EXISTING TO REMAIN - REPAINT ONLY
124	1'-7 3/4"	7-0	K	EXISTING TO REMAIN - REPAINT ONLY
125	2-8*	4.2	Υ	EXISTING TO REMAIN - REPAINT ONLY
126	2.8"	4'-2"	Υ	EXISTING TO REMAIN - REPAINT ONLY
127	1'-7"	1'-7 34'	М	CASEMENT - 24 LITES - REFINISH EXISTING LEADED GLASS WINDOWS
128	1'-7"	3.0 1/4"	L	CASEMENT - 12 LITES - REFINISH EXISTING LEADED GLASS WINDOWS
129	1'-7"	1'-7 34'	M	CASEMENT - 24 LITES - REFINISH EXISTING LEADED GLASS WINDOWS
130	1'-7"	3-0 1/4"	L	CASEMENT - 12 LITES - REFINISH EXISTING LEADED GLASS WINDOWS
131	1'-7'	1'-7 3'4"	М	CASEMENT - 24 LITES - REFINISH EXISTING LEADED GLASS WINDOWS
132	1:-7*	3-0 1/4*	L	CASEMENT - 12 LITES - REFINISH EXISTING LEADED GLASS WINDOWS
133	1:-7*	1'-7 34'	М	CASEMENT - 24 LITES - REFINISH EXISTING LEADED GLASS WINDOWS
134	1'-7'	3-0 1/4*	L	CASEMENT - 12 LITES - REFINISH EXISTING LEADED GLASS WINDOWS
135	1'-7'	1'-7 34'	М	CASEMENT - 24 LITES - REFINISH EXISTING LEADED GLASS WINDOWS
136	1-7	3'-0 1/4"	L	CASEMENT - 12 LITES - REFINISH EXISTING LEADED GLASS WINDOWS
137	1'-7"	1'-7 3'4"	М	CASEMENT - 24 LITES - REFINISH EXISTING LEADED GLASS WINDOWS
138	1'-7"	3'-0 1/4"	L	CASEMENT - 12 LITES - REFINISH EXISTING LEADED GLASS WINDOWS
139	1'-7"	1'-7 3'4'	М	CASEMENT - 24 LITES - REFINISH EXISTING LEADED GLASS WINDOWS
140	1'-7'	3'-0 1/4"	L	CASEMENT - 12 LITES - REFINISH EXISTING LEADED GLASS WINDOWS
141	1'-7*	1'-7 3/4'	М	CASEMENT - 24 LITES - REFINISH EXISTING LEADED GLASS WINDOWS
142	1'-7"	3'-0 1/4"	L	CASEMENT - 12 LITES - REFINISH EXISTING LEADED GLASS WINDOWS
143	1'-7'	1'-7 3'4"	М	CASEMENT - 24 LITES - REFINISH EXISTING LEADED GLASS WINDOWS
144	1:-7"	3'-0 1/4"	L	CASEMENT - 12 LITES - REFINISH EXISTING LEADED GLASS WINDOWS

2ND FLOOR

NUMBER	WIDTH - VIF	HEIGHT - VIF	TYPE	NOTES
201	10 1/2"	6'-6"	N	EXISTING TO REMAIN - REPAINT ONLY
202	3-3'	6'-6'	0	EXISTING TO REMAIN - REPAINT ONLY
203	10 1/2"	6:-6*	N	EXISTING TO REMAIN - REPAINT ONLY
204	2-8"	4'-2"	A	DOUBLE HUNG - 8/12 LITES
205	2-8"	4'-2"	A	DOUBLE HUNG - 8/12 LITES
206	1'-5 1/4"	4'-2'	P	DOUBLE HUNG - 4/6 LITES
207	3-3 1/2"	4'-2'	Q	DOUBLE HUNG - 5/15 LITES
208	1'-5 1/4"	4'-2'	P	DOUBLE HUNG - 4/6 LITES
209	3-3	6'-6"	0	EXISTING TO REMAIN - REPAINT ONLY
210	2-0 1/4"	4.2	E	DOUBLE HUNG - 69 LITES
211	2-0 1/4"	4'-2'	E	DOUBLE HUNG - 6/9 LITES
212	1'-5 1/4"	4'-2"	P	DOUBLE HUNG - 4/6 LITES
213	2-8"	4'-2'	A	DOUBLE HUNG - 8/12 LITES
214	2-8'	4'-2"	A	DOUBLE HUNG - 8/12 LITES
215	2-0 1/4"	4'-11 3/4"	Z	DOUBLE HUNG - 6/9 LITES
216	2-0 1/4"	4'-11 3/4"	Z	DOUBLE HUNG - 6/9 LITES
217	2-8*	4'-2"	A	DOUBLE HUNG - 8/12 LITES
218	2-8"	4:-2"	A	DOUBLE HUNG - 8/12 LITES
219	2-8'	4'-2"	A	DOUBLE HUNG - 8/12 LITES
220	1'-5 1/4'	4'-2'	P	DOUBLE HUNG - 4/6 LITES
221	3-3 1/2"	4:-2"	0	DOUBLE HUNG - 5/15 LITES
222	1'-5 1/4'	4'-2"	P	DOUBLE HUNG - 4/6 LITES
223	1'-8'	4:-2"	R	DOUBLE HUNG - 4/6 LITES
224	2-0 1/4"	4'-2'	E	DOUBLE HUNG - 6/9 LITES
225	2-8'	4'-2'	A	DOUBLE HUNG - 8/12 LITES
226	1'-5 1/4"	4'-2'	P	DOUBLE HUNG - 4/6 LITES
227	3-3 1/2"	4-2	Q	DOUBLE HUNG - 5/15 LITES
228	1'-5 1/4"	4'-2'	P	DOUBLE HUNG - 4/6 LITES

3RD FLOOR

NUMBER	WDTH-VIF	HEIGHT - VIF	TYPE	NOTES
301	4'-3'	2-8 1/2"	S	FRENCH CASEMENT - 18 LITES
302	2-10"	2-8 1/2"	T	FRENCH CASEMENT - 12 LITES
303	2-10*	2-8 1/2"	T	FRENCH CASEMENT - 12 LITES
304	2-10"	2-8 1/2"	T	FRENCH CASEMENT - 12 LITES
305	2-10"	7-8 1/2"	T	FRENCH CASEMENT - 12 LITES
306	7-10*	2-8 1/2"	T	FRENCH CASEMENT - 12 LITES
307	2-10"	2-8 1/2"	T	FRENCH CASEMENT - 12 LITES
308	2-10"	2-8 1/2"	T	FRENCH CASEMENT - 12 LITES
309	2-10"	2-8 1/2"	T	FRENCH CASEMENT - 12 LITES
310	2-10*	2-8 1/2"	T	FRENCH CASEMENT - 12 LITES
311	2-10"	2-8 1/2"	T	FRENCH CASEMENT - 12 LITES
312	2-10*	2-8 1/2"	T	FRENCH CASEMENT - 12 LITES

GENERAL NOTES

WINDOWS TO BE MARVIN WOOD ULTIMATE REPLACEMENT WINDOWS CONTRACTOR TO VERIFY ALL WINDOW OPENING DIMENSIONS.

LDa Architecture & Interiors, LLP 222 Third Street, Suite 3212 Cambridge, MA 02142 617 621-1455 fax 617 621-1477 www.LDa Architects.com

ISSUANCE: HISTORIC SET

STERNER RESIDENCE


DATE: 08/15/16
SCALE: 144° = 1'-0'
DRAWN: Author
CHECKED. Checker
SHEET INFO.
WINDOW SCHEDULE

GENERAL FLOOR PLAN NOTES

- IN ET ALSO FLOORS TO FEMOLE TO REVIEW EXISTING AND PROPOSED DIMERISONS AND ALIGNMENTS AND CONTRACTOR TO REVIEW EXISTING AND PROPOSED DIMERISONS AND ALIGNMENTS AND CONTRIVATIONS AND ALIGNMENTS SHOWN CAN BE ACHIEVED DISCREPANCES BETWEEN PROPOSED ALIGNMENTS AND LOCATIONS AND EXISTING CONDITIONS MADE BERGENT TO THE ATTENTION OF THE ARCHITECT PRIOR TO A SHOWN AND EXISTING CONDITIONS MAST BE RELD VERRIED PRIOR TO A SHOWN ON THE ARCHITECT PRIOR TO CONTRIVEN SHOWN AND EXISTING CONDITIONS MAST BE RELD VERRIED PRIOR TO CONTRIVEN SHOWN AND SHOWN TO CONTRIVENT AND ALIGNMENT AND ALIGNMENT TO CONTRIVENT AND ALIGNMENT AND ALIGNMENT TO CONTRIVENT AND ALIGNMENT AND ALI

	WALL	KEY
SE THIS		EXISTING TO REMAIN
TING		NEW INTERIOR PARTITION
ND		NEW INSULATED INTERIOR FURRING WALL
OR		NEW EXTERIOR WALL
OR	7 - 2 - 1	NEW CONCRETE FOUNDATION WALL



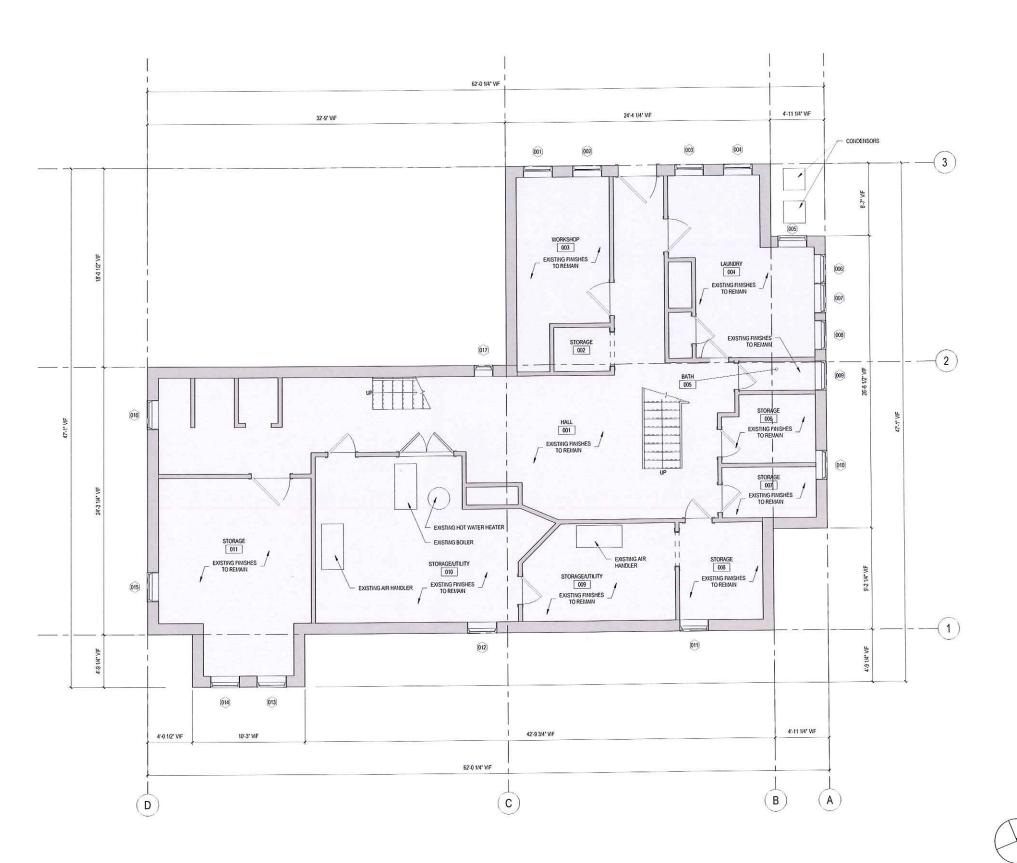



LDa Architecture & Interiors, LLP 222 Third Street, Suite 3212 Cambridge, MA 02142 617 621-1455 fax 617 621-1477 www.LDa-Architects.com

ISSUANCE: HISTORIC SET


REVISION:

SCALE: As indicated DRAWN:

CHECKED: Checker

SHEET INFO.
BASEMENT FLOOR PLAN



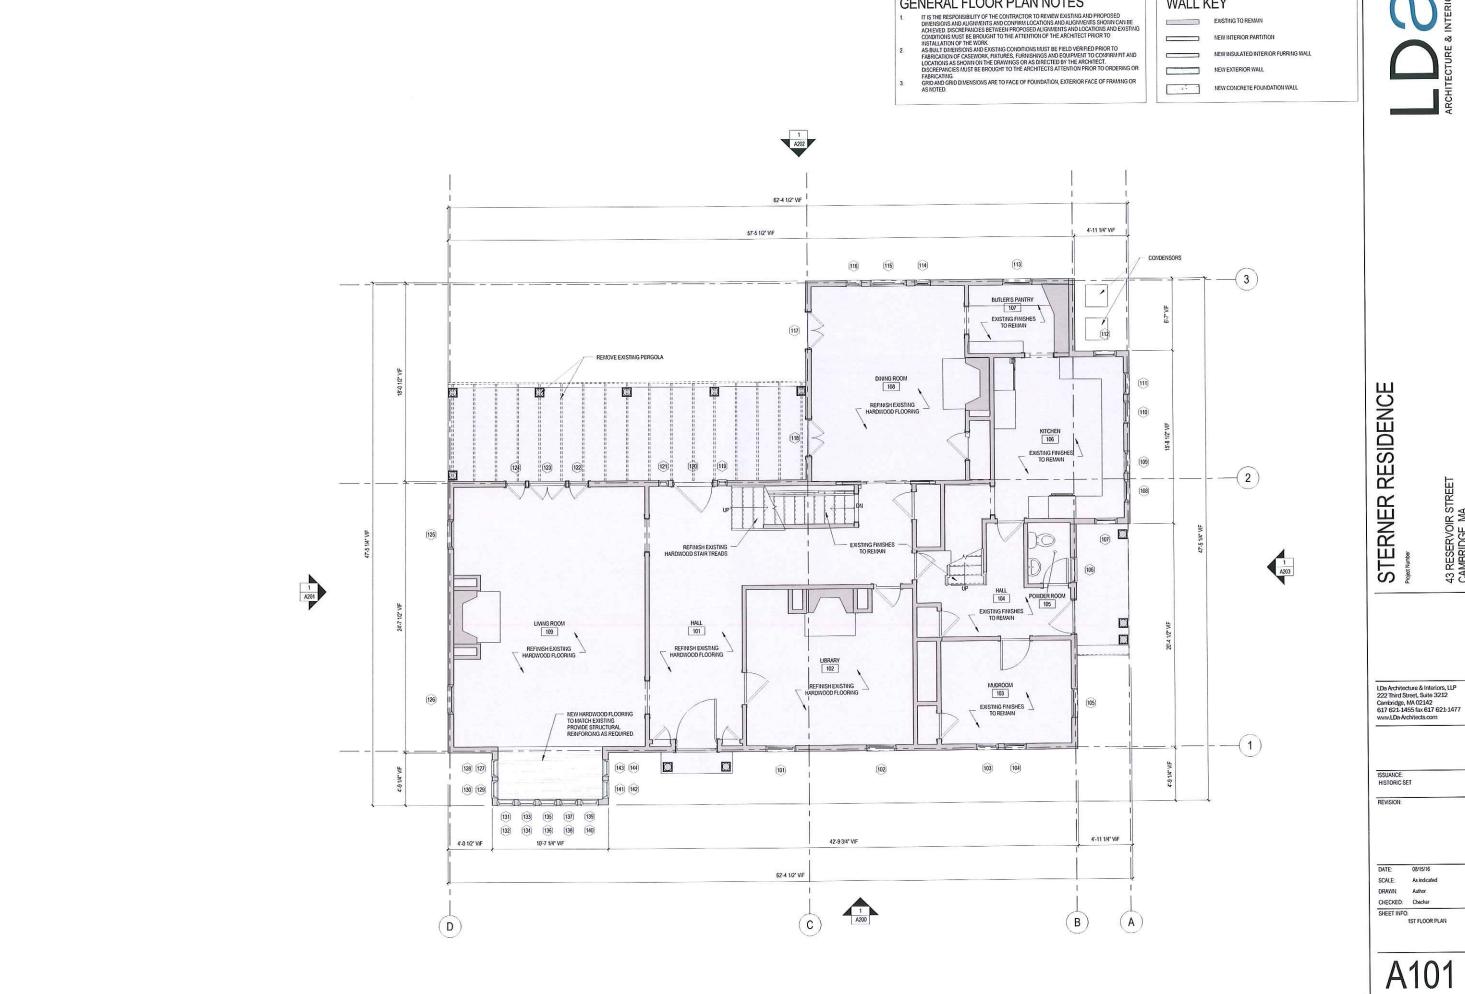


GENERAL FLOOR PLAN NOTES

WALL KEY

08/15/16 As indicated


A101

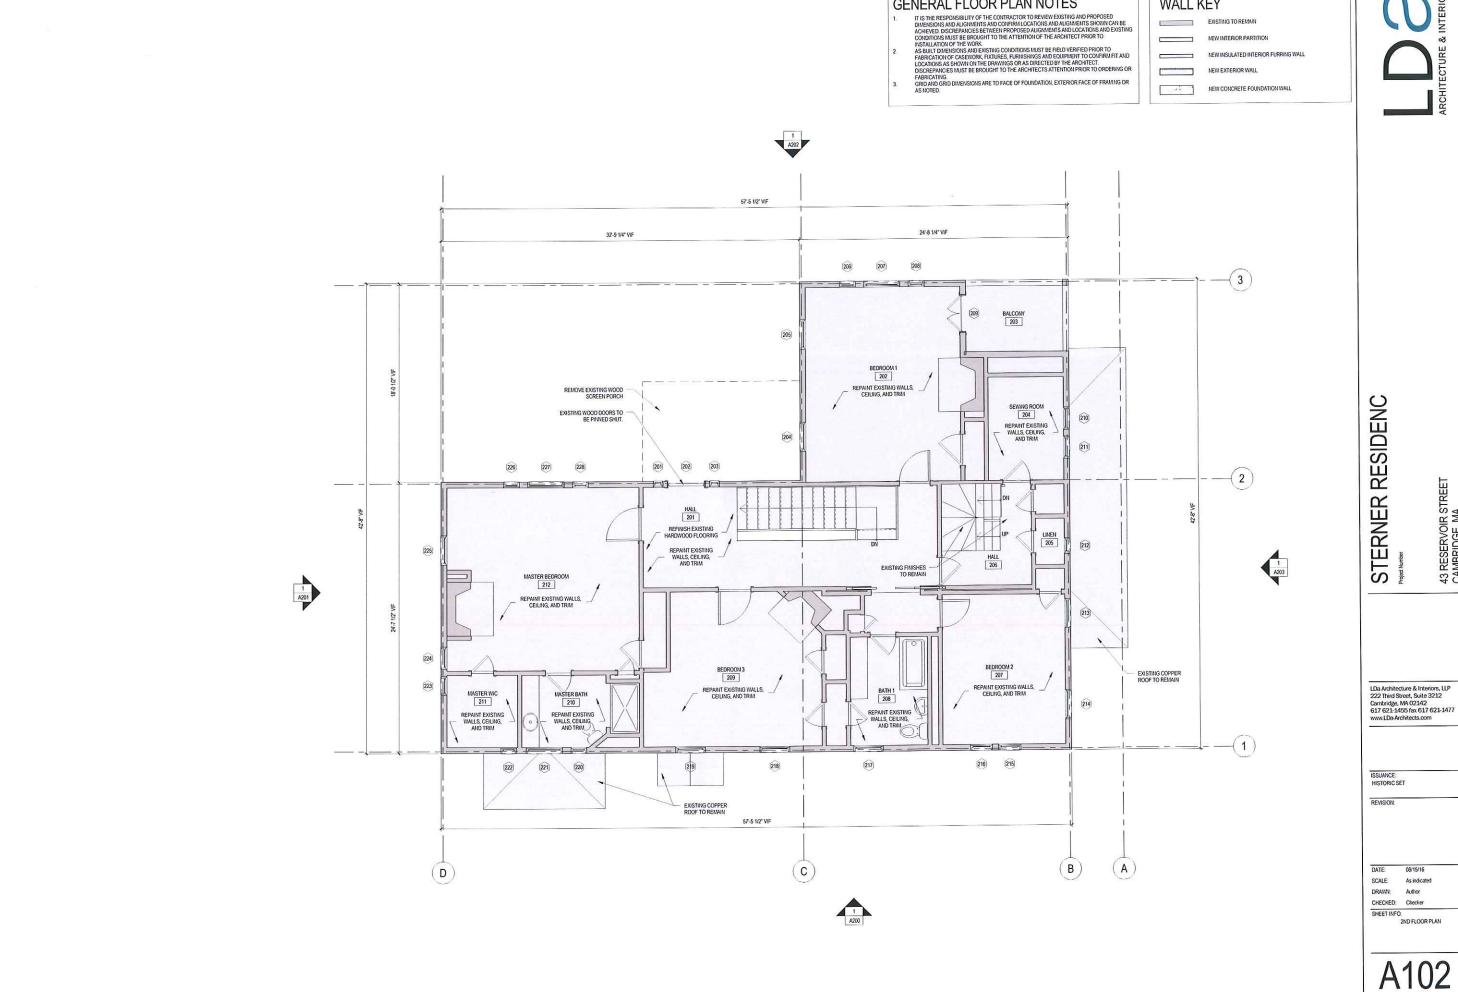

GENERAL FLOOR PLAN NOTES

WALL KEY



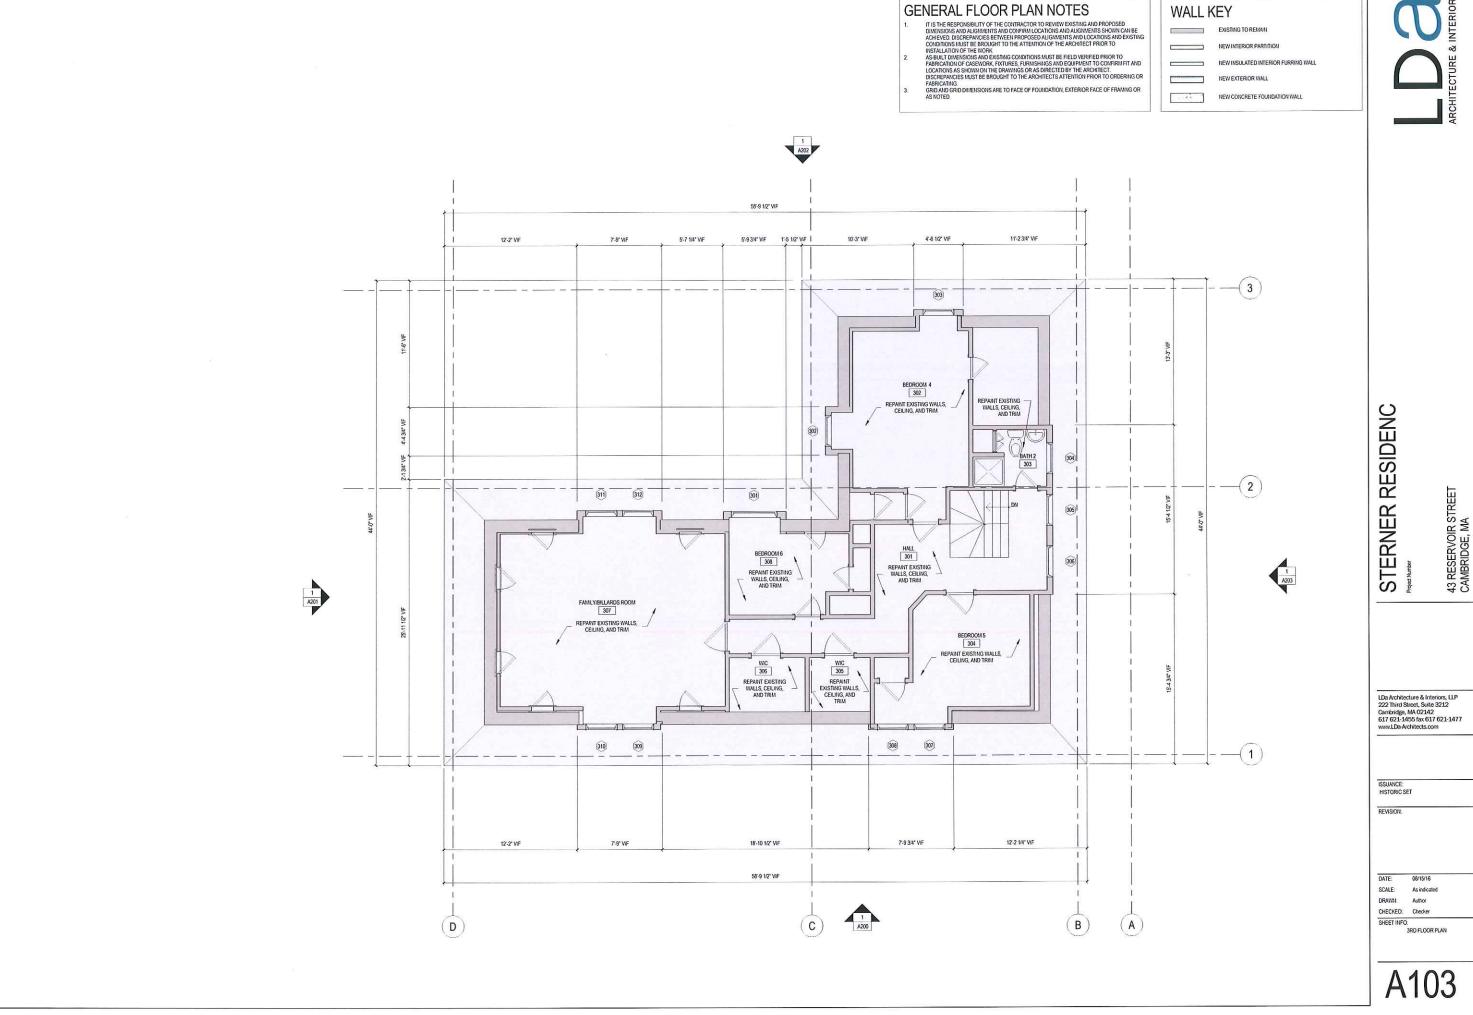



PROVIDE NEW SLATE ROOF TO MATCH EXISTING GARAGE.

NEW PAINTED WOOD DENTIL TRIM TO MATCH EXISTING, TYP. THROUGHOUT.

PATCH AND REPAINT EXISTING WOOD SOFFITS AS REQUIRED, TYP THROUGHOUT.

NEW WOOD REPLACEMENT WINDOWS MATCH EXISTING. PATCH AND REPAINT EXISTING WINDOW TRIM, TYP THROUGHOUT.

PATCH AND REPAINT EXISTING CLAPBOARD SIDING, TYP. THROUGHOUT. PROVIDE NEW SLATE ROOF TO MATCH EXISTING GARAGE

EXISTING GUTTERS AND DOWNSPOUTS TO REMAIN. REMOVE AND REINSTALL FOR PAINTING.

NEW PAINTED WOOD DENTIL TRIM TO MATCH EXISTING, TYP. THROUGHOUT.

PATCH AND REPAINT EXISTING WOOD SOFFITS AS REQUIRED, TYP THROUGHOUT. PATCH AND REPAINT EXISTING STUCCO AS REQUIRED, TYP THROUGHOUT. NEW WOOD REPLACEMENT WINDOWS MATCH EXISTING.

PATCH AND REPAINT EXISTING WINDOW TRIM, TYP THROUGHOUT.

EXISTING GUTTERS AND DOWNSPOUTS TO REMAIN. REMOVE AND REINSTALL FOR PAINTING.

REVISION:

DATE: SCALE: 12" = 1"-0" DRAWN:

CHECKED: Checker

SHEET INFO.
EXISTING EXTERIOR ELEVATION - EAST
(FRONT)

A200




STRIP AND PAINT EXISTING TRIM, COLUMNS, -AND PANELING @ FRONT ENTRY

PATCH AND REPAINT EXISTING CLAPBOARD SIDING, TYP. THROUGHOUT.

EXISTING BRICK CHIMNEYS TO REMAIN, TYP.

PATCH AND REPAINT EXISTING TRIM, TYP. THROUGHOUT,

3 EAST (FRONT) ELEVATION SCALE: 12" = 1"-0" PROVIDE NEW SLATE ROOF TO MATCH EXISTING GARAGE

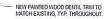

PATCH AND REPAINT EXISTING WOOD SOFFITS AS REQUIRED, TYP THROUGHOUT.

PATCH AND REPAINT EXISTING WINDOW TRIM, TYP THROUGHOUT.

PATCH AND REPAINT EXISTING STUCCO AS REQUIRED, TYP THROUGHOUT.



PROVIDE NEW PAINTED WOOD SHUTTERS

@ EAST AND SOUTH ELEVATIONS, TYP.

NEW WOOD REPLACEMENT WINDOWS MATCH EXISTING.

EXISTING COPPER ROOFING AND FLASHING TO REMAIN, TYP.

STRIP AND PAINT EXISTING TRIM, COLUMNS, AND PANELING @ FRONT ENTRY.

1 EAST (FRONT) ELEVATION SCALE: 12"= 1"-0"

PATCH AND REPAINT EXISTING CLAPBOARD SIDING, TYP. THROUGHOUT.

EXISTING COPPER ROOFING AND FLASHING TO REMAIN, TYP.

REFINISH EXISTING LEADED GLASS WINDOWS @ BAY AND INSTALL NEW PAINTED WOOD STORM WINDOWS

2 EAST (FRONT) ELEVATION SCALE: 12° = 1'-0°

EXISTING BRICK CHIMNEYS TO REMAIN, TYP.

EXISTING GUTTERS AND DOWNSPOUTS TO REMAIN REMOVE AND REINSTALL FOR PAINTING.

NEW WOOD REPLACEMENT WINDOWS MATCH EXISTING.

PROVIDE NEW PAINTED WOOD SHUTTERS @ EAST AND SOUTH ELEVATIONS, TYP.

PATCH AND REPAINT EXISTING STUCCO AS REQUIRED, TYP THROUGHOUT.

REMOVE EXISTING WOOD LATTICE

ISSUANCE: HISTORIC SET


REVISION:


DATE: 08/15/16 SCALE: 12' = 1'-0' DRAWN: Author

CHECKED. Checker

SHEET INFO: EXISTING EXTERIOR ELEVATION-SOUTH (SIDE)

A201

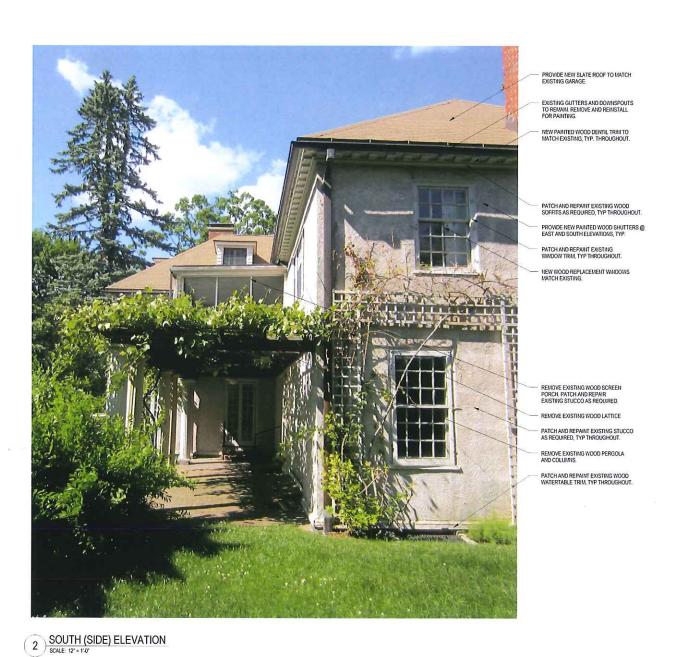

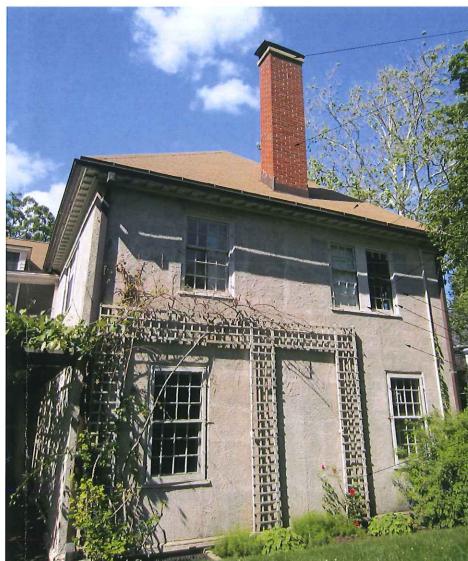

1 SOUTH (SIDE) ELEVATION
SCALE: 12' = 1'-0'

STERNER RESIDENCE

NEW WOOD REPLACEMENT WINDOWS MATCH EXISTING

REMOVE EXISTING WOOD PERGOLA AND COLUMNS.

LDa Architecture & Interiors, LLP 222 Third Street, Suite 3212 Cambridge, MA 02142 617 621-1455 fax 617 621-1477 www.LDa-Architects.com

REVISION:

ISSUANCE: HISTORIC SET

SCALE: 12' = 1'-0' DRAWN: CHECKED: Checker

SHEET INFO.
EXISTING EXTERIOR ELEVATION - WEST
(REAR)

A202



EXISTING WOOD FENCE TO REMAIN

1 WEST (REAR) ELEVATION
SCALE: 12" = 1"-0"

PATCH AND REPAINT EXISTING CLAPBOARD SIDING, TYP. THROUGHOUT.

EXISTING GUTTERS AND DOWNSPOUTS TO REMAIN. REMOVE AND REINSTALL FOR PAINTING. NEW PAINTED WOOD DENTIL TRIM TO MATCH EXISTING, TYP. THROUGHOUT PATCH AND REPAINT EXISTING WOOD SOFFITS AS REQUIRED, TYP THROUGHOUT

PATCH AND REPAINT EXISTING WOOD TRIM, TYP. THROUGHOUT.

PATCH AND REPAINT EXISTING WOOD WINDOWS @ KITCHEN, TYP.

PATCH AND REPAINT EXISTING STUCCO AS REQUIRED, TYP THROUGHOUT.

PATCH AND REPAINT EXISTING WOOD TRIM, TYP. THROUGHOUT.

REPOINT EXISTING STONE FOUNDATION AS REQUIRED.

EXISTING BASEMENT WINDOWS TO REMAIN, TYP.

ISSUANCE: HISTORIC SET

REVISION:

SCALE: 12" = 1'-0" DRAWN: Author

CHECKED: Checker

SHEET INFO.

EXISTING EXTERIOR ELEVATION - NORTH (SIDE)

PATCH AND REPAINT EXISTING WOOD TRIM, TYP. THROUGHOUT.


NEW WOOD REPLACEMENT WINDOWS MATCH EXISTING.

PATCH AND REPAINT EXISTING STUCCO AS REQUIRED, TYP THROUGHOUT.

PATCH AND REPAINT EXISTING WOOD COLUMNS, RAILING, AND WATERTABLE, TYP THROUGHOUT.

EXISTING METAL RAILING TO REMAIN. EXISTING BRICK WALKWAY TO REMAIN. EXISTING WINDOW GRATES TO REMAIN



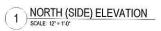

A203