






CAMBRIDGE HISTORICAL COMMISSION
831 Massachusetts Avenue, 2<sup>nd</sup> Fl., Cambridge, Massachusetts 02139
Telephone: 617 349 4683 Fax: 617 349 3116 TTY: 617 349 6112
E-mail: histcomm@cambridgema.gov URL: http://www.cambridgema.gov/Historic

CAMBRIDGE HISTORICAL COMMISSION

#### **APPLICATION FOR CERTIFICATE**

1.	. The undersigned hereby applies to the Cambridge Historical Commission for a Certificate of <a href="(check one box)">(check one box)</a> :					
2.	Address of property: 47 Brattle Street , Cambridge, Massachusetts					
3.	Describe the proposed alteration(s), construction or demolition in the space provided below: An additional page can be attached, if necessary).					
	Demolition and replacement of existing wood storefront with new insulated glazed storefront. Demolition and reinforcement of existing masonry and stucco wall along Church Street facade. Reconstruction of wall with new storefront openings and precast concrete trim to match existing.					
bel	ertify that the information contained herein is true and accurate to the best of my knowledge and ief. The undersigned also attests that he/she has read the statements printed on the reverse.					
Nai	ne of Property Owner of Record: George Wyner Realty Brattle Street LLC, C/O Myer Dana & Sons, Inc.					
	iling Address: 1340 Centre Street #101 Newton, MA 02459					
Sign	ephone/Fax: 617-928-1700  E-mail: jnfo@mdana.com  Street, LC  mature of Property Owner of Record: Ry My It Dena, pres. Myel Dana and Sons We.— quired field; application will not be considered complete without property owner's signature) Managing Cogent					
Nai	me of proponent, if not record owner: Corinna Wan, Sr. V.P., Facilities & Admin. Services, First Republic Bank					
Ma	iling Address: 111 Pine Street San Francisco, CA 94111					
Tel	ephone/Fax: 415-288-7559 E-mail: cwan@firstrepublic.com					
Dat	office use only): te Application Received: 11417 Case Number: 3865 Hearing Date: 12/7/17 the of Certificate Issued:					

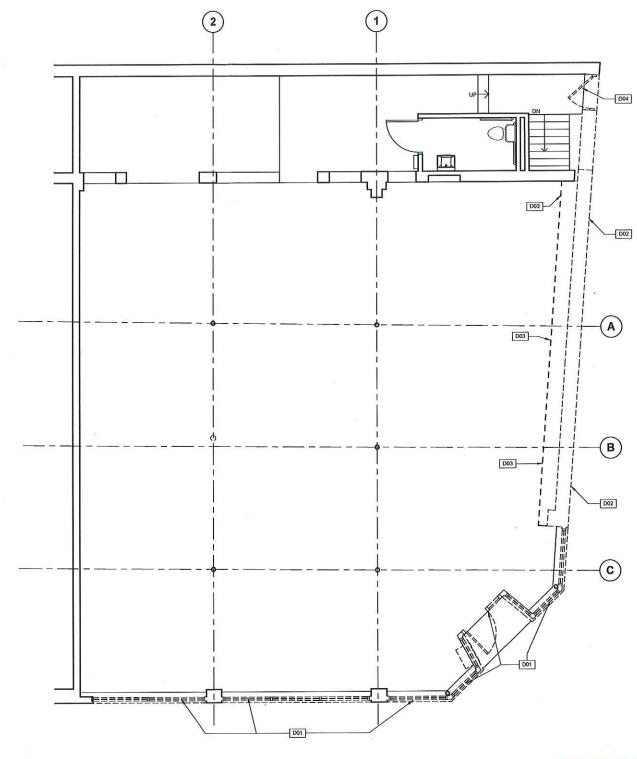

NOV 14 2017

CAMBRIDGE HISTORICAL COMMISSION

#### DEMOLITION NOTES

HATCH INDICATES AREAS OUTSIDE OF PROJECT SCOPE



DASHED LINES INDICATE EXISTING CONSTRUCTION TO BE REMOVED



SOLID LINES INDICATE EXISTING CONSTRUCTION TO REMAIN

#### KEYNOTES - DEMOLITION


NO. DESCRIPTION

DOI DEMOLISH EXISTING WOOD STOREFRONT, KNEEWALL AND MASONRY BELOW DOWN TO FOUNDATION WALL AS REC'D

DO2 REMOVE EXISTING MASONRY WALL AS REC'D. REFER TO STRUCTURAL DRAWNIGS

DO3 PARTIAL DEMOLITION OF EXISTING FLOOR AS REC'D FOR CONSTRUCTION OF NEW WALL AND STRUCTURAL ELEMENTS

DO4 DEMOLISH EXISTING DOOR

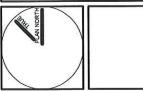

### ANALOGUE STUDIO


### FRB - BRANCH BANK

47 BRATTLE ST, CAMBRIDGE, MA 02138

DELTA DES	CRIPTION	DATE
		-
	VI. 100 - 100 - 100 - 100 - 100 - 100 - 100 - 100 - 100 - 100 - 100 - 100 - 100 - 100 - 100 - 100 - 100 - 100 -	
HIS	TORIC COMMISSION SUBMISSION	2017-

#### **DEMOLITION PLAN**

DATE: 2017-11-09 A 1 . 00

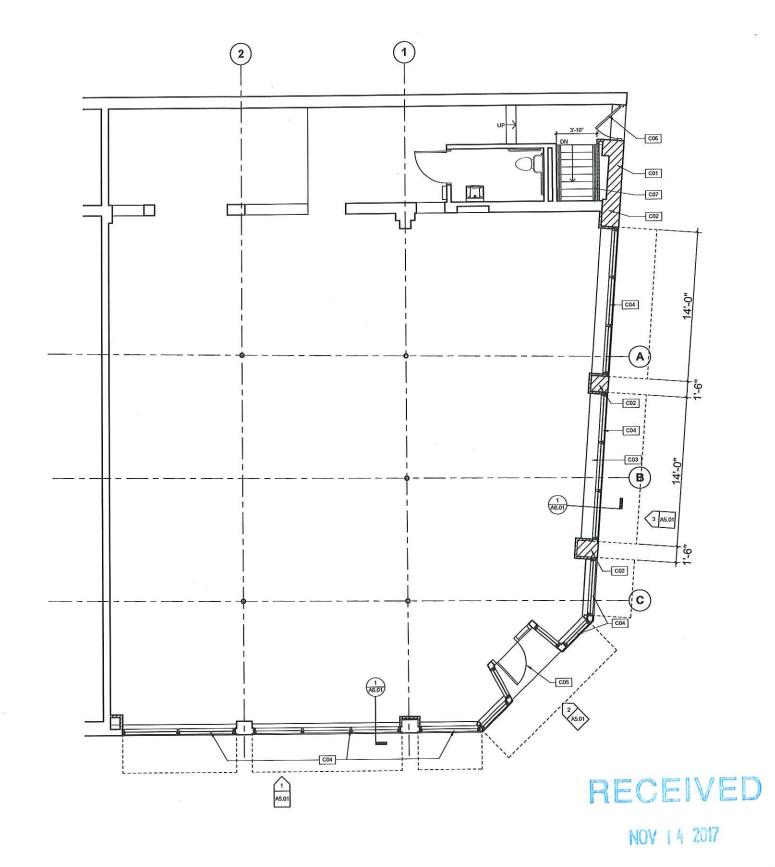

CONSTRUCTION NOTES

HATCH INDICATES AREAS OUTSIDE OF PROJECT SCOPE



- CONSTRUCTION TO REMAIN

  A. SEE DWG ADD FOR ADDITIONAL NOTES AND ABBERMATIONS.

  B. ALL PARTITIONS TO BE TYPE AT U.O.N.

  D. ALL PARTITIONS TO BE TYPE AT U.O.N.

  DO NOT ADJUST DIMENSIONS INDICATED AS CLEAR WITHOUT WRITTEN DIRECTION FROM ARCHITECT, DRAWINGS SHALL NOT BE SCALED, VERIFY ALL DIMENSIONS AND EXISTING AS BUILT FIELD CONDITIONS, INCLUDING FIELD WORK, MCAUGHETT FRIOR TO STARCHES OCCUR.

  D. USE TYPE "Y GWB ON FIRE RATED PARTITIONS.

  E. USE CEMENTITIOUS BACKER BOARD (DUROCK) OR EQUAL AT PARTITIONS SCHEDULED TO RECEIVE CERAMIC TILE (U.O.N.). SEE FINISH PLAN FOR LOCATION OF TILE.

  F. FIRE SASE PREMERATIONS AT FIRE RESISTANT RATED ASSEMBLES FOR ALL PENTITATIONS.

  H. PROVIDE BLOCKING AS REQUIRED AT LOCATIONS INCLUDING, BUT NOT LIMITED TO: GRAB BARS, SHELVING, OVERHEAD CABINETS, SIGNAGE, TOLET ROOM ACCESSORIES, WALL MOUNT. EQUIPMENT, LOCATIONS, BUT AND THATED TO: GRAB BARS, SHELVING, OVERHEAD CABINETS, SIGNAGE, TOLET ROOM ACCESSORIES, WALL MOUNT. EQUIPMENT, LOCATIONS OF THE ALL PARTITIONS TO RECEIVE WILL COVERING/MINH, GRAPHICS, REFER TO FINISH PLANS FOR LOCATIONS AND ADDITIONAL INFORMATION.

  J. PATCH H. LOOR AND WALL AREAS DAMAGED DUE TO NEW CONSTRUCTION OR WHERE PENETRATIONS.

  H. PROVIDE LEVEL 4 FINISH U.O.N. PROVIDE LEVEL 5 FINISH PLANS FOR LOCATIONS TO RECEIVE WALL COVERING/MINH, GRAPHICS, REFER TO FINISH PLANS FOR LOCATIONS AND ADDITIONAL INFORMATION.

  J. PATCH H. LOOR AND WALL AREAS DAMAGED DUE TO NEW CONSTRUCTION OR WHERE PENETRATIONS.

  H. PROVIDE LEVEL A FINISH U.O.N. PROVIDE LEVEL 5 FINISH PLANS FOR LOCATIONS AND ADDITIONS.

  H. PROVIDE LEVEL A FINISH U.O.N. PROVIDE LEVEL 5 FINISH PLANS FOR LOCATIONS AND ADDITIONS.


  H. PROVIDE LEVEL A FINISH U.O.N. PROVIDE LEVEL 5 FINISH PLANS FOR LOCATIONS AND ADDITIONS.

  H. PROVIDE LEVEL A FINISH U.O.N. PROVIDE LEVEL 5 FINISH PLANS FOR LOCATIONS AND ADDITIONS.

  H. PROVIDE LEVEL A FINISH U.O.N. PROVIDE LEVEL 5 FINISH PLANS FOR LOCATIONS AND ADDITIONS.

  H. PROVIDE LEVEL A FINISH U.O.N. PROVIDE LEVEL 5 FINISH PLANS FOR LOCATIONS OF THE PROVIDE SECRET TO FINISH PLANS FOR LO

KEYNOTES - CONSTRUCTION

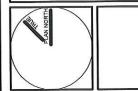

## ANALOGUE STUDIO


FRB - BRANCH BANK


47 BRATTLE ST, CAMBRIDGE, MA 02138

DELTA	DESCRIPTION	DATE
		_
-		-
		1
	HISTORIC COMMISSION SUBMISSION	2017-11-1

CONSTRUCTION PLAN

SCALE: 1/4" = 1"40"
DATE: 2017-11-09
DRAWN BY: EE A 1.01 CHECKED BY: EE

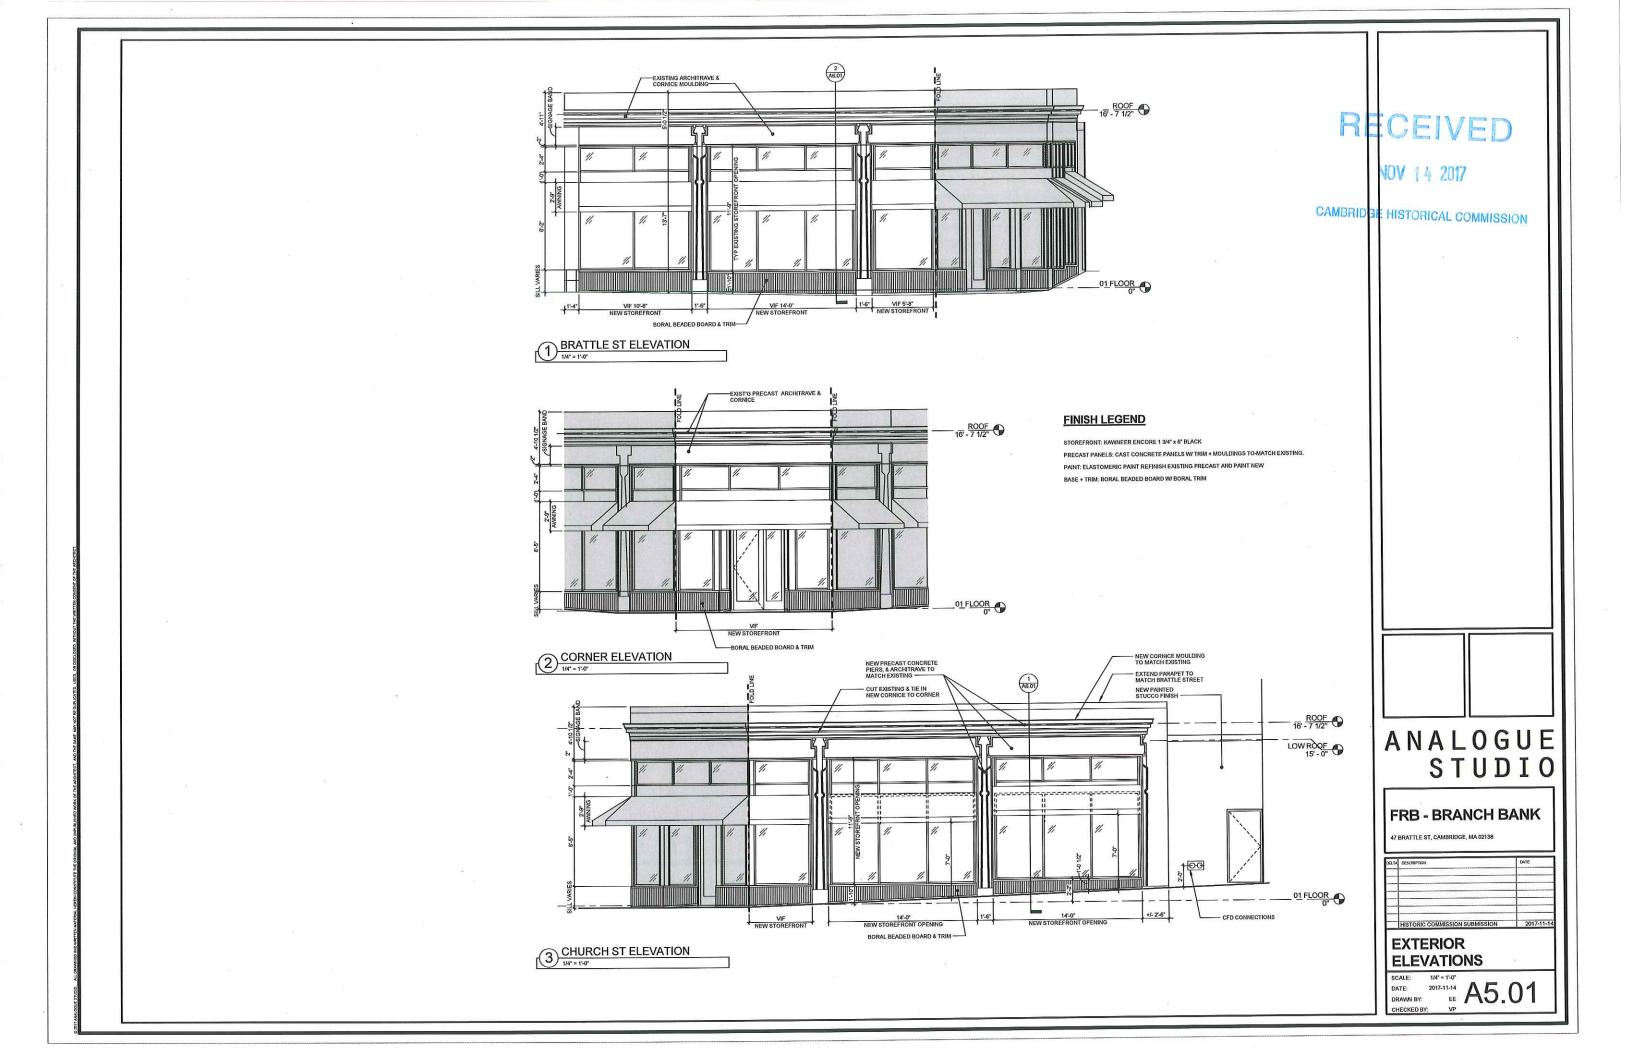

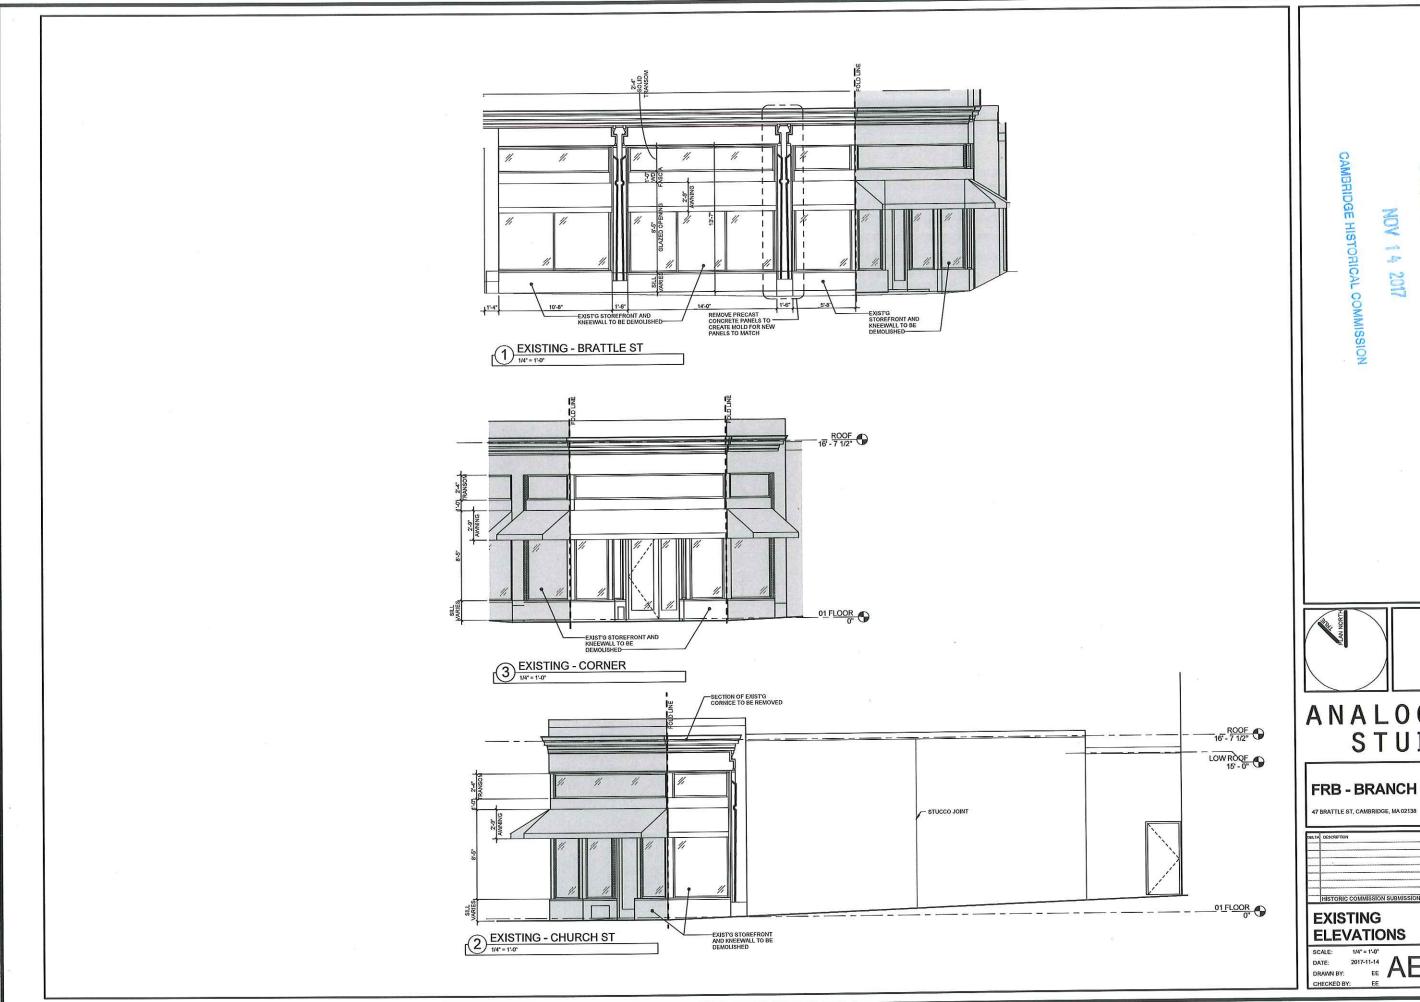




ANALOGUE STUDIO

FRB - BRANCH BANK

DELTA	DESCRIPTION	DATE
-		
	HISTORIC COMMISSION SUBMISSION	2017-11-1

EXISTING ELEVATIONS

SCALE: 1/4" = 1'-10"
DATE: 2017-11-14
DRAWN BY: EE
CHECKED BY: EE

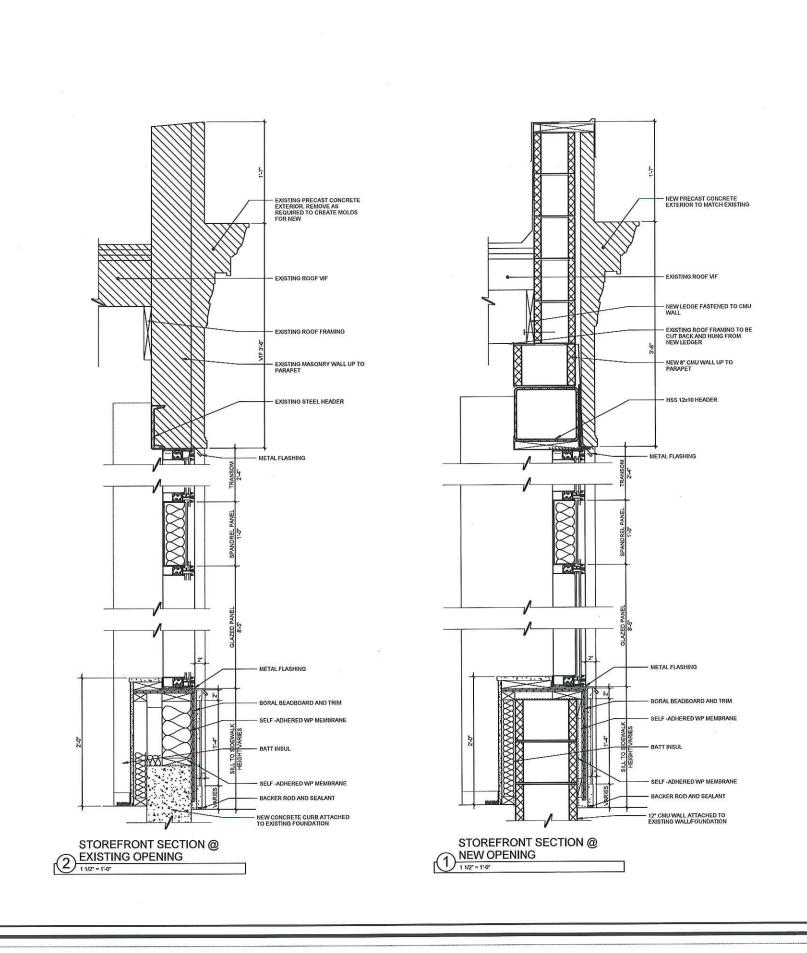

CAMBRIDGE HISTORICAL COMMISSION

ANALOGUE STUDIO

FRB - BRANCH BANK

47 BRATTLE ST, CAMBRIDGE, MA 02138

DELTA	DESCRIPTION	DATE
	HISTORIC COMMISSION SUBMISSION	2017-11-14

WALL SECTIONS

SCALE: 11/2"=1"-0"
DATE: 2017-11-14
DRAWN BY: EE A6.01


NOV 1 4 2017





NOV 14 2017




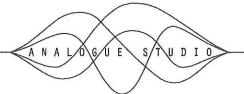

NOV 14 2017





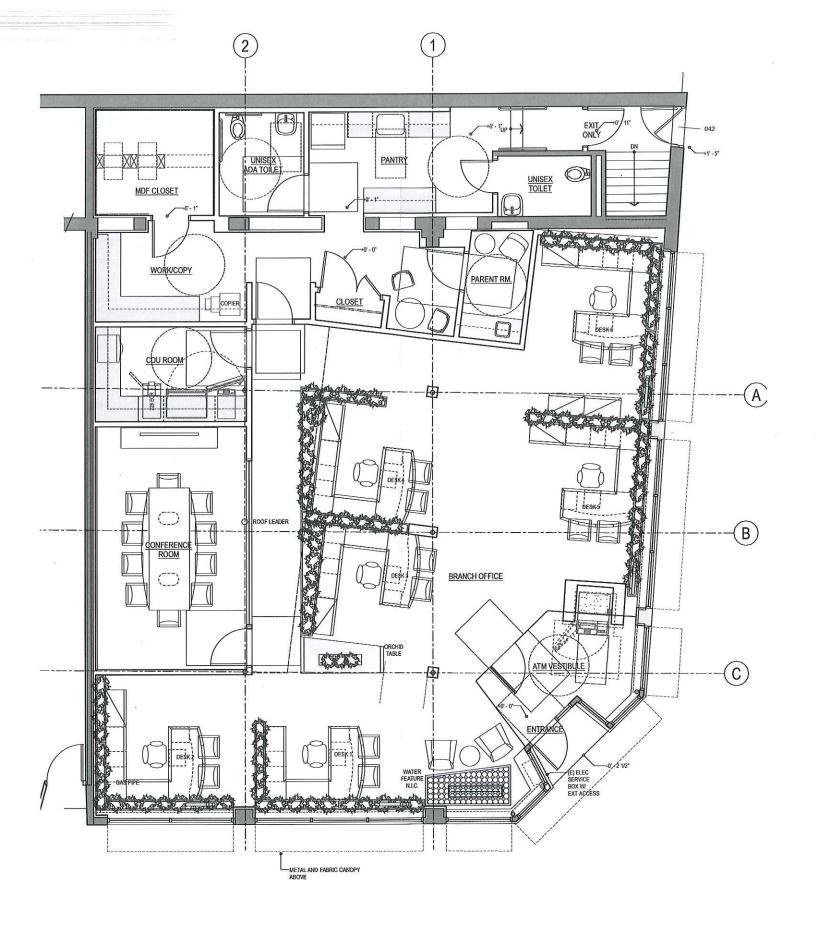

# PROPOSED FIRST FLOOR PLAN U9/U1/17 SCALE: 1/4"=1'-0" 09/15/17 REVISION 1 09/26/17 REVISION 2 09/27/17 REVISION 3 09/28/17 REVISION 4

## RECEIVED

NOV 14 2017