








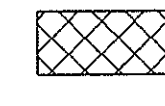
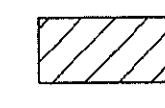


ABBREVIATIONS

APPROX	APPROXIMATE
AVE	AVENUE
BLDG	BUILDING
BWV	BACKWATER VALVE
CO	CLEANOUT
CONC	CONCRETE
D	DRAIN
DI	DUCTILE IRON
DS	DOWNSPOUT
DW	DRY WELL
ELEC	ELECTRICAL PANEL
EM	ELECTRICAL METER
EXIST	EXISTING
F	DS TO FOUNDATION DRAIN
F&C	FRAME AND COVER
FD	FLOOR DRAIN
FRD	FLAT ROOF DRAIN
G	DS INTO GROUND
GM	GAS METER
LN	LANE
MH	MANHOLE
NO	NUMBER
OE	OPEN ELBOW
PE	POLYETHYLENE
PROP	PROPOSED
PVC	POLYVINYL CHLORIDE
RB	RAIN BARRELL
PLBG	PLUMBING
RC OR RCP	REINFORCED CONCRETE PIPE
R&D	REMOVE AND LEGALLY DISPOSE OF
RD	ROAD / ROOF DRAIN
RL	ROOF LEADER
R&R	REMOVE AND REPLACE
S	DS TO SURFACE
SAN	SANITARY SEWER
SD	STORM DRAIN
SMH	SEWER MANHOLE
SP	SUMP PUMP
SS	SANITARY STACK
STA	STATION
ST	STREET
WG	WATER GATE
WM	WATER METER

EXISTING LEGEND

DOWNSPOUT - INTO FOUNDATION	o F
DOWNSPOUT - DIVERTED FROM FOUNDATION ONTO SURFACE	o F/S
DOWNSPOUT - INTO GROUND	o G
DOWNSPOUT - DIVERTED FROM GROUND ONTO SURFACE	o G/S
DOWNSPOUT - ONTO SURFACE	o S
DOWNSPOUT - OPEN ELBOW INTO FOUNDATION	o OE
WATER METER	Ø WM
GAS METER	Ø GM
ELECTRIC METER	Ø EM
DRY WELL	
BUILDING LATERAL EXTENSION (EXTERIOR DRAIN)	
BUILDING DRAIN PIPE (INTERIOR DRAIN)	

PROPOSED LEGEND

BUILDING LATERAL EXTENSION (EXTERIOR DRAIN)	
BUILDING DRAIN PIPE (INTERIOR DRAIN)	
SEWER LATERAL (PUBLIC)	
DRAIN LATERAL (PUBLIC)	
RESTORATION OF WALKWAY OR DRIVEWAY DISTURBED	
RESTORATION OF LANDSCAPING AND VEGETATION AREAS DISTURBED	
CAPPED PIPE	
DRY WELL	


GENERAL NOTES

- CONTRACTOR SHALL NOT ENTER A PRIVATE PROPERTY UNTIL A WRITTEN AGREEMENT HAS BEEN SIGNED BETWEEN THE CONTRACTOR, BUILDING OWNER, AND CITY OF CAMBRIDGE. REFER TO SPECIFICATION SECTION 02534 FOR REQUIREMENTS.
- CONTRACTOR SHALL PROVIDE A LICENSED PLUMBER TO PERFORM BUILDING INFLOW REMOVAL WORK GOVERNED BY 248 CMR 10.00: UNIFORM STATE PLUMBING CODE. CONTRACTOR SHALL PROVIDE ALL COUPLINGS, FITTINGS, BACKWATER VALVES AND CLEANOUTS AS REQUIRED BY 248 CMR 10.00.
- ALL EXISTING SEWER SERVICES SHALL REMAIN OPERATIONAL THROUGHOUT CONSTRUCTION. CONTRACTOR SHALL PREPARE A CONSTRUCTION SEQUENCE PLAN TO ENSURE THAT ALL SEWER CUSTOMERS HAVE CONTINUOUS SEWER SERVICE DURING CONSTRUCTION. CONTRACTOR SHALL COORDINATE WITH BUILDING OWNERS AS NECESSARY TO COORDINATE CONSTRUCTION DURING LOW FLOW TIMES. CONTRACTOR IS RESPONSIBLE FOR ALL BYPASS PUMPING TO MAINTAIN CONTINUOUS SERVICE. CONTRACTOR SHALL SET UP BYPASS PUMPING PIPING TO ALLOW BUILDING OWNER ACCESS TO THEIR DRIVEWAYS. CONSTRUCTION SEQUENCE AND BYPASS PUMPING PLANS SHALL BE SUBMITTED TO THE ENGINEER FOR REVIEW PRIOR TO ANY EXCAVATION.
- THE OUTLINES OF EXISTING VERTICAL STRUCTURES ARE SHOWN PER CITY OF CAMBRIDGE GIS MAPPING PUBLISHED 2012. SEWER, DRAIN, AND OTHER SERVICE LOCATIONS ARE SHOWN AT APPROXIMATE LOCATIONS ON THE DRAWINGS BASED ON TELEVISION INSPECTION AND OWNER RECORDS. WHERE NO RECORDS WERE AVAILABLE, SERVICE LOCATIONS WERE APPROXIMATED. SEWER, DRAIN, AND OTHER SERVICE LOCATIONS AND PRIVATE STRUCTURES SHALL BE VERIFIED BY THE CONTRACTOR. CONTRACTOR SHALL INSTALL SEWER SERVICES (AS A MINIMUM) TO THE PROPERTY WHERE INDICATED. INACTIVE OR ABANDONED SERVICES SHALL BE CUT AND CAPPED.
- UTILITY WORK INFORMATION SHOWN WAS BASED ON FIELD SURVEY DATA AND RECORD INFORMATION. THE LOCATIONS OF UNDERGROUND UTILITIES HAVE BEEN ESTABLISHED FROM SURFACE FEATURES OBSERVED DURING THE SURVEY. THE LOCATIONS OF UNDERGROUND STRUCTURES ARE APPROXIMATE ONLY AND MAY VARY FROM THE LOCATIONS SHOWN. ADDITIONAL UNDERGROUND UTILITIES AND/OR STRUCTURES MAY BE ENCOUNTERED.
- NOT ALL OF THE STORM, SANITARY, WATER, GAS, TELEPHONE, CABLE, ELECTRICAL SERVICES, AND OTHER OVERHEAD OR UNDERGROUND UTILITY SERVICES TO BUILDINGS ARE SHOWN. THE CONTRACTOR SHALL ANTICIPATE THAT EACH PROPERTY WILL HAVE SERVICE CONNECTIONS FOR THE VARIOUS UTILITIES. SIZE, MATERIAL, AND LOCATION OF EXISTING UTILITIES AND SERVICES IN PROJECT VICINITY SHALL BE VERIFIED OR DETERMINED BY THE CONTRACTOR. RECORD DRAWINGS PREPARED BY THE CONTRACTOR FOR THIS PROJECT SHALL INCLUDE THIS FIELD VERIFIED INFORMATION. THE OWNER ASSUMES NO RESPONSIBILITY FOR THE ACCURACY OF THE EXISTING UTILITY INFORMATION.
- ALL NEW AND RECONNECTED SANITARY SEWER SERVICES WITHIN THE PUBLIC RIGHT-OF-WAY SHALL BE A MINIMUM OF 6" PVC OR SHALL MATCH THE EXISTING SERVICE SIZE, UNLESS OTHERWISE NOTED. WHERE THE EXISTING SERVICE SIZE IS 5" OR SMALLER, CONTRACTOR SHALL TRANSITION TO 6" PVC. REMOVE AND DISPOSE OF SECTIONS OF SERVICES REPLACED. CONTRACTOR TO PROVIDE FITTINGS AS REQUIRED FOR COMPLETE INSTALLATION.
- ALL NEW AND RECONNECTED DRAIN LATERALS WITHIN THE PUBLIC RIGHT-OF-WAY SHALL BE A MINIMUM OF 6" PVC OR SHALL MATCH THE EXISTING SERVICE SIZE, UNLESS OTHERWISE NOTED. WHERE THE EXISTING SERVICE IS 5" OR SMALLER, CONTRACTOR SHALL TRANSITION TO A 6" PVC. REMOVE AND DISPOSE OF SECTIONS OF SERVICES REPLACED. CONTRACTOR TO PROVIDE FITTINGS AS REQUIRED FOR COMPLETE INSTALLATION.
- CONTRACTOR SHALL REMOVE AND REPLACE DISTURBED SIDEWALKS, LANDSCAPING, DRIVEWAYS, DRIVEWAY APRONS, CURBS, AND BUILDING INTERIORS WITH LIKE MATERIALS.
- REFER TO SHEETS CP-9, CP-10 AND CP-11 FOR INFLOW REMOVAL DETAILS.
- SUGGESTED SEQUENCE OF WORK:
 - INSTALL NEW SEWER OR DRAIN IN STREET BEGINNING AT THE DOWNSTREAM TERMINUS OF PROJECT AREA.
 - PERFORM SEWER CIPP LINING AND/OR SECTIONAL REPAIRS OF EXISTING SEWER OR DRAIN.
 - RECONNECT EXISTING AND INSTALL NEW SERVICES FROM MAIN IN STREET TO PROPERTY LINE.
 - ABANDON OR REMOVE EXISTING COMBINED SEWERS (NOTE: IN SOME LOCATIONS, THIS WORK WILL COINCIDE WITH THE INSTALLATION OF NEW SEWER OR DRAIN LINES).
 - INSTALL BUILDING DRAIN LATERALS FROM PROPERTY LINE TO BUILDING. PROCEED STREET BY STREET BEHIND THE INSTALLATION OF NEW SEWER OR DRAIN IN STREET.
 - ON STREETS WHERE THE EXISTING COMBINED PIPE BECOMES A DRAIN, ALL SANITARY FLOWS MUST BE REMOVED PRIOR TO COMPLETION OF THE CONTRACT. THIS MEANS THAT ANY NON-RESPONSIVE PROPERTY MUST HAVE ITS COMBINED LATERAL REDIRECTED TO THE NEW SANITARY SEWER. A STORM LATERAL WILL BE CAPPED AT THE PROPERTY LINE FOR FUTURE CONNECTION BY PROPERTY OWNER.
- REFER TO APPENDIX F IN THE SPECIFICATIONS FOR BUILDING INSPECTION INFORMATION PREVIOUSLY OBTAINED.


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CONFIRMED SET



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Date	JANUARY 27, 2014			
Job No.	20120256.001A			
Designed by	MTD			
Drawn by	PBR			
Checked by	AML	No.	Description	Date
Approved by	EO		REVISIONS	

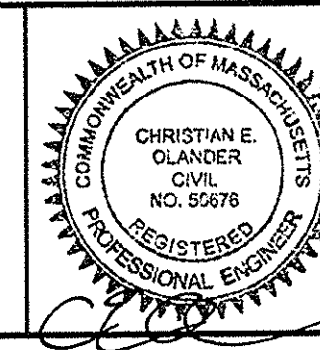

Client	CITY OF CAMBRIDGE, MASSACHUSETTS	Sheet	
Project	CONCORD (CONTRACT 9) SEWER SEPARATION AND SURFACE IMPROVEMENTS PROJECT		CP-1
Drawing	CIVIL - PRIVATE INFLOW REMOVAL LEGEND AND GENERAL NOTES	File No.	

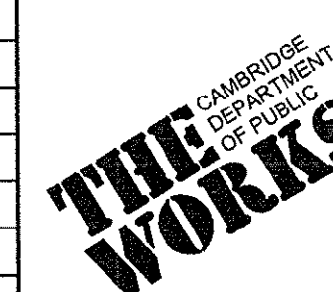


NOTES:
 1. REFER TO OTHER CIVIL, UTILITY AND ROADWAY KEY PLANS FOR ADJACENT PROJECTS WITHIN THE PUBLIC RIGHT-OF-WAY.




PRIVATE INFLOW REMOVAL KEY PLAN INDEX:

PLAN NO. 1 (CP-3)	1	445 CONCORD AVE
PLAN NO. 2 (CP-4)	2	450 CONCORD AVE
PLAN NO. 3 (CP-5)	3A	489 CONCORD AVE
	3B	413 CONCORD AVE
	3C	415 CONCORD AVE
	3D	31 CORPORAL BURNS RD
PLAN NO. 4 (CP-6)	3E	16 CORPORAL BURNS RD
	3F	20-22 ALPINE ST
	3G	56 ALPINE ST
	4A	80 ALPINE ST
PLAN NO. 5 (CP-7)	4B	369 CONCORD AVE
	4C	360 CONCORD AVE
	4D	118 CHILTON ST
	4E	153-155 CHILTON ST
PLAN NO. 6 (CP-8)	4F	163 CHILTON ST
	4G	162-164 CHILTON ST
	5A	1 FIELD ST
	5B	8 FIELD ST
PLAN NO. 5 (CP-7)	5C	172 FAYERWEATHER ST
	5D	339-341 CONCORD AVE
	5E	335 CONCORD AVE
	5F	327-329 CONCORD AVE
PLAN NO. 6 (CP-8)	5G	320-322 CONCORD AVE
	5H	312 CONCORD AVE
	6A	204-206 GARDEN ST
	6B	325 WALDEN ST
PLAN NO. 6 (CP-8)	6C	329 WALDEN ST
	6D	328 WALDEN ST
	6E	316-318 WALDEN ST
	6F	280-282 CONCORD ST
	6G	46 SAVILLE ST

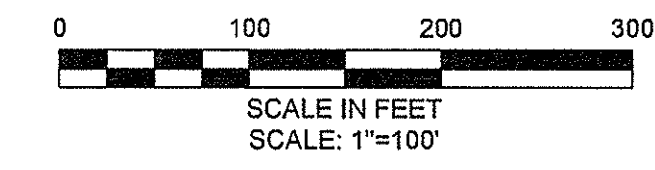


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Designed by	MTD		
Drawn by	PBR		
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Approved by	EO		REVISIONS

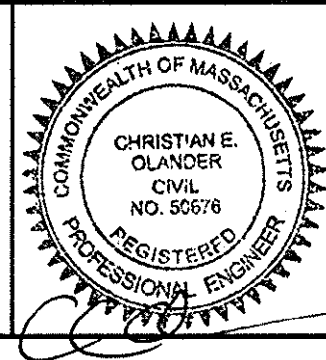


Client	CITY OF CAMBRIDGE, MASSACHUSETTS
Project	CONCORD (CONTRACT 9) SEWER SEPARATION AND SURFACE IMPROVEMENTS PROJECT
Drawing	CIVIL - PRIVATE INFLOW REMOVAL KEY PLAN

Sheet	CP-2
File No.	

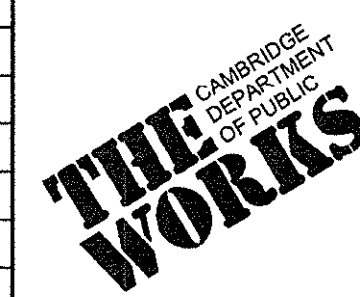NOTES FOR 445 CONCORD AVE.

1. RADIO TOWER POSITIONED ON TOP OF BUILDING.
2. POSSIBLE SOIL AND GROUNDWATER CONTAMINATION ON OR NEAR SITE WITH VOLATILE ORGANIC COMPOUNDS. REFER TO SPECIFICATION SECTION 02080-SOIL AND WASTE MANAGEMENT FOR ADDITIONAL SOIL AND GROUNDWATER INFORMATION.

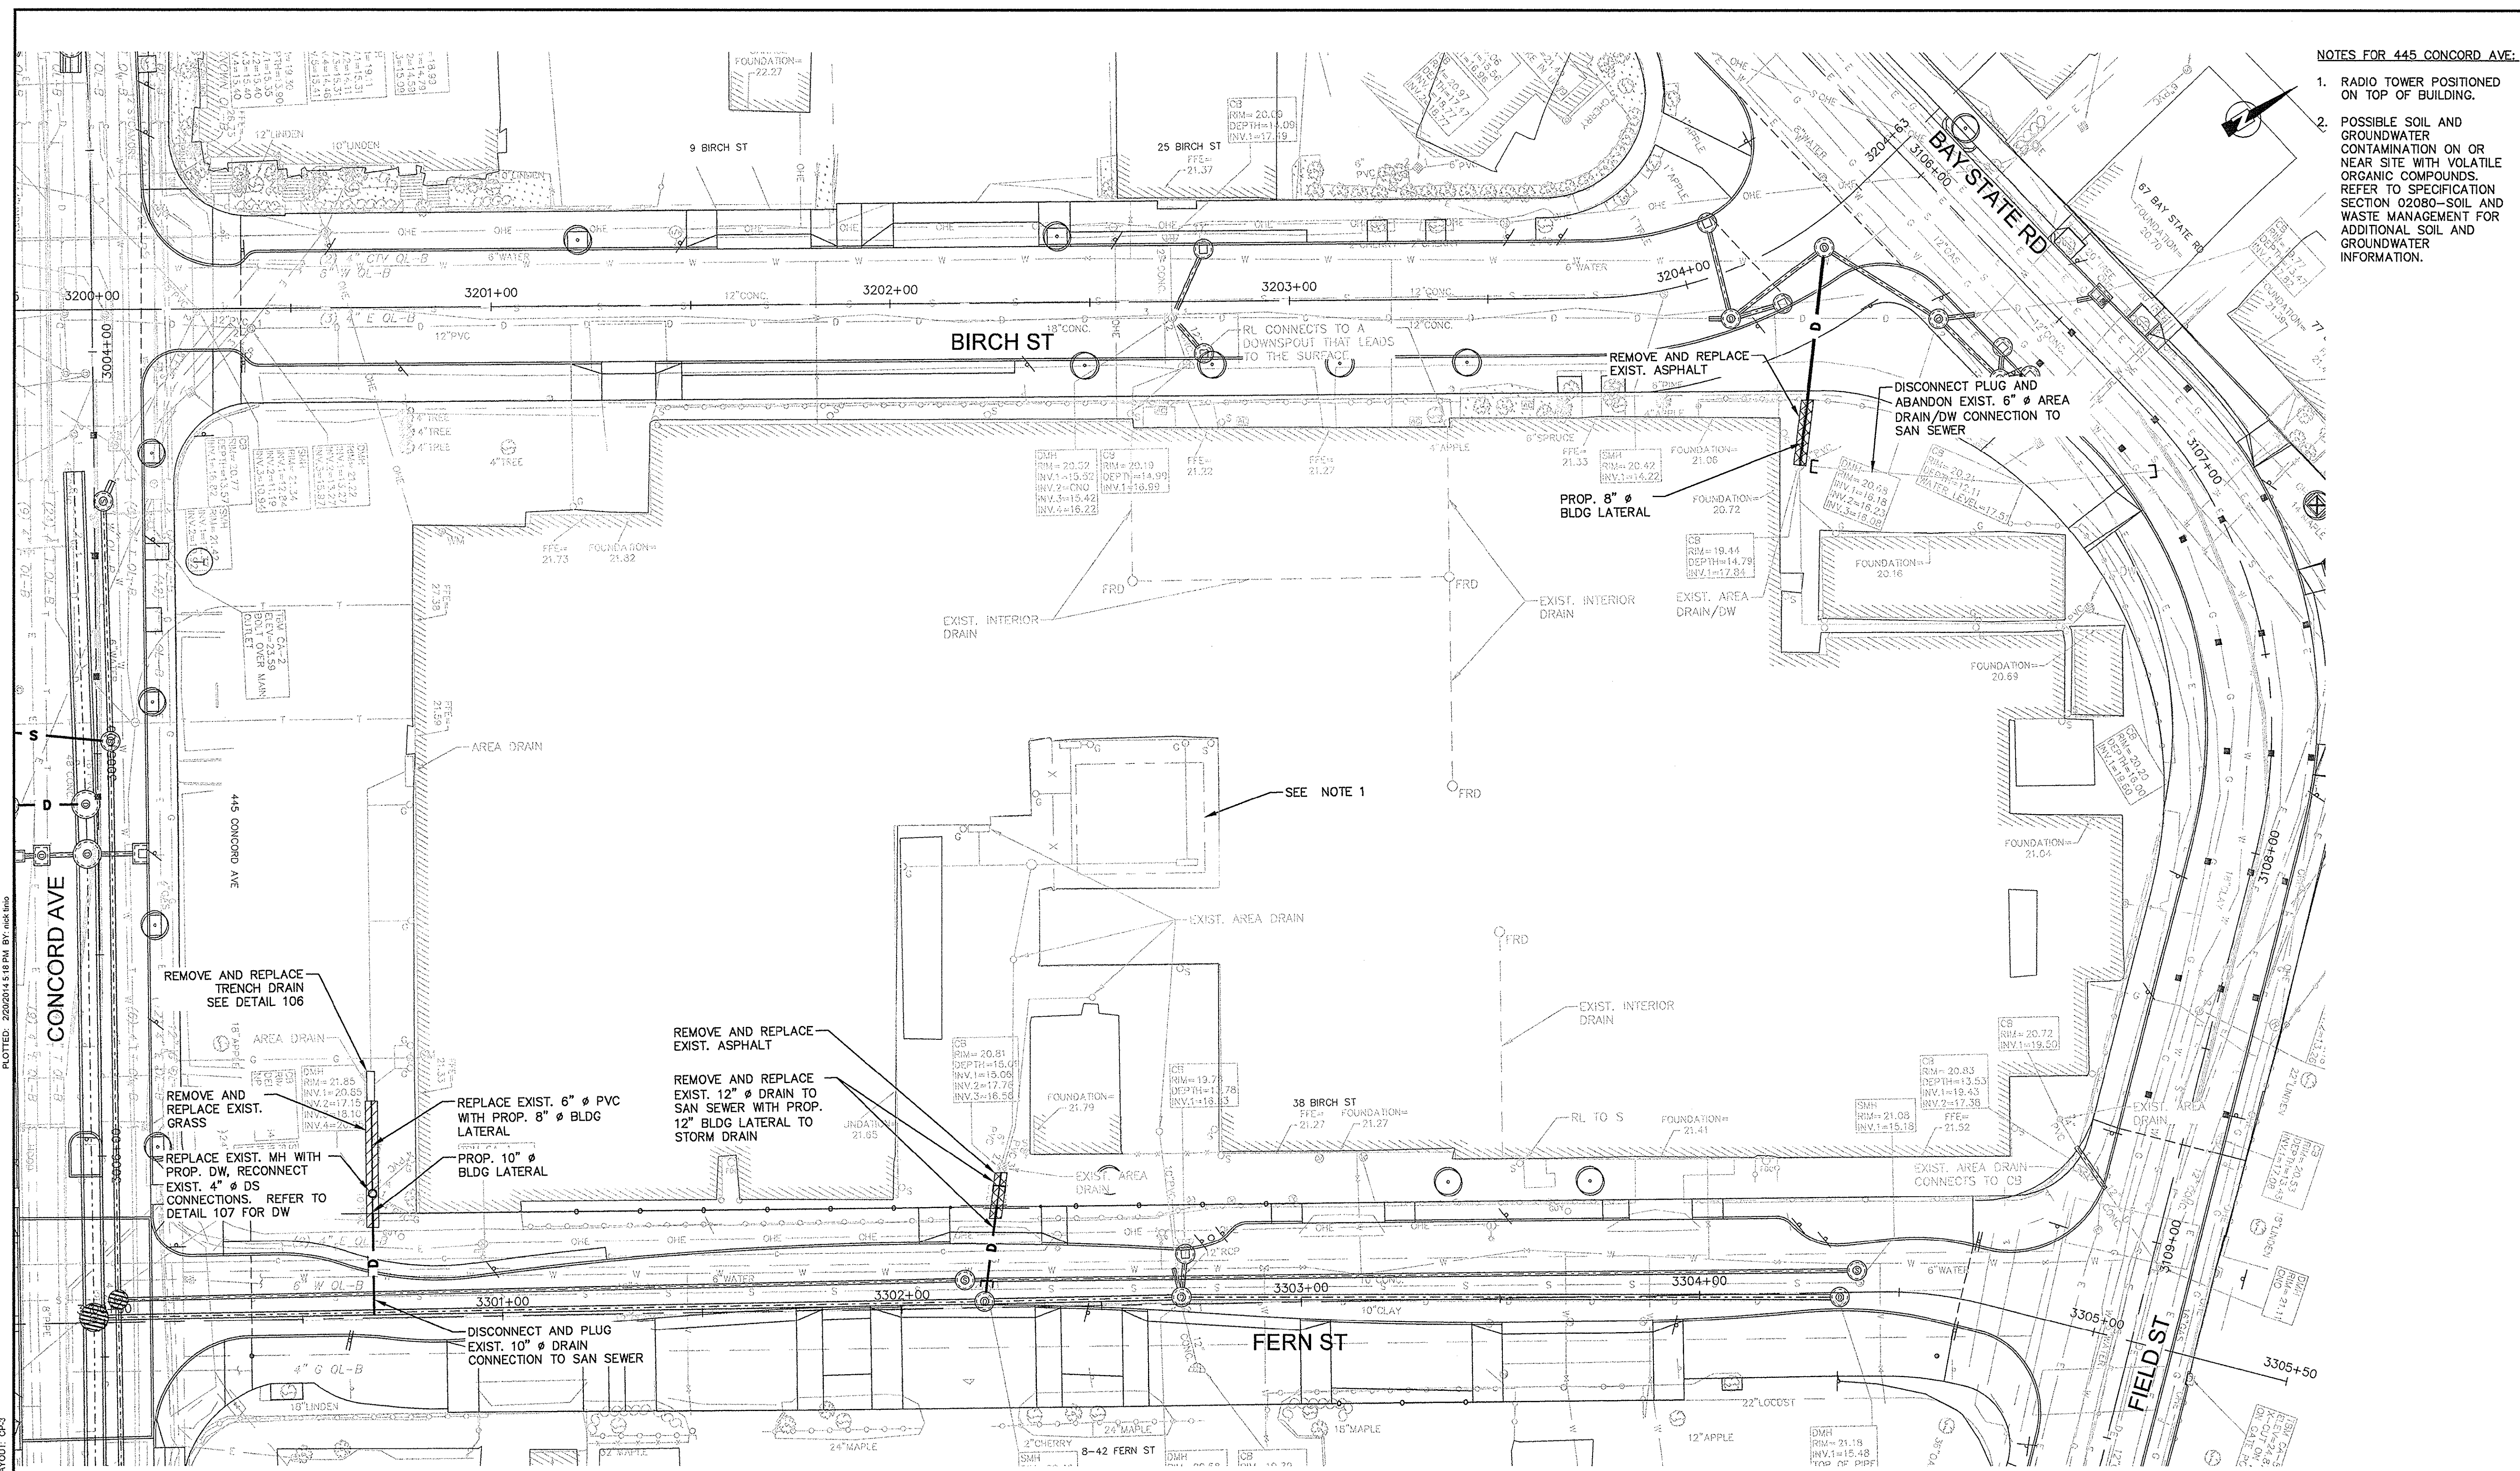


PLAN NO. 1
445 CONCORD AVE



CONFORMED SET

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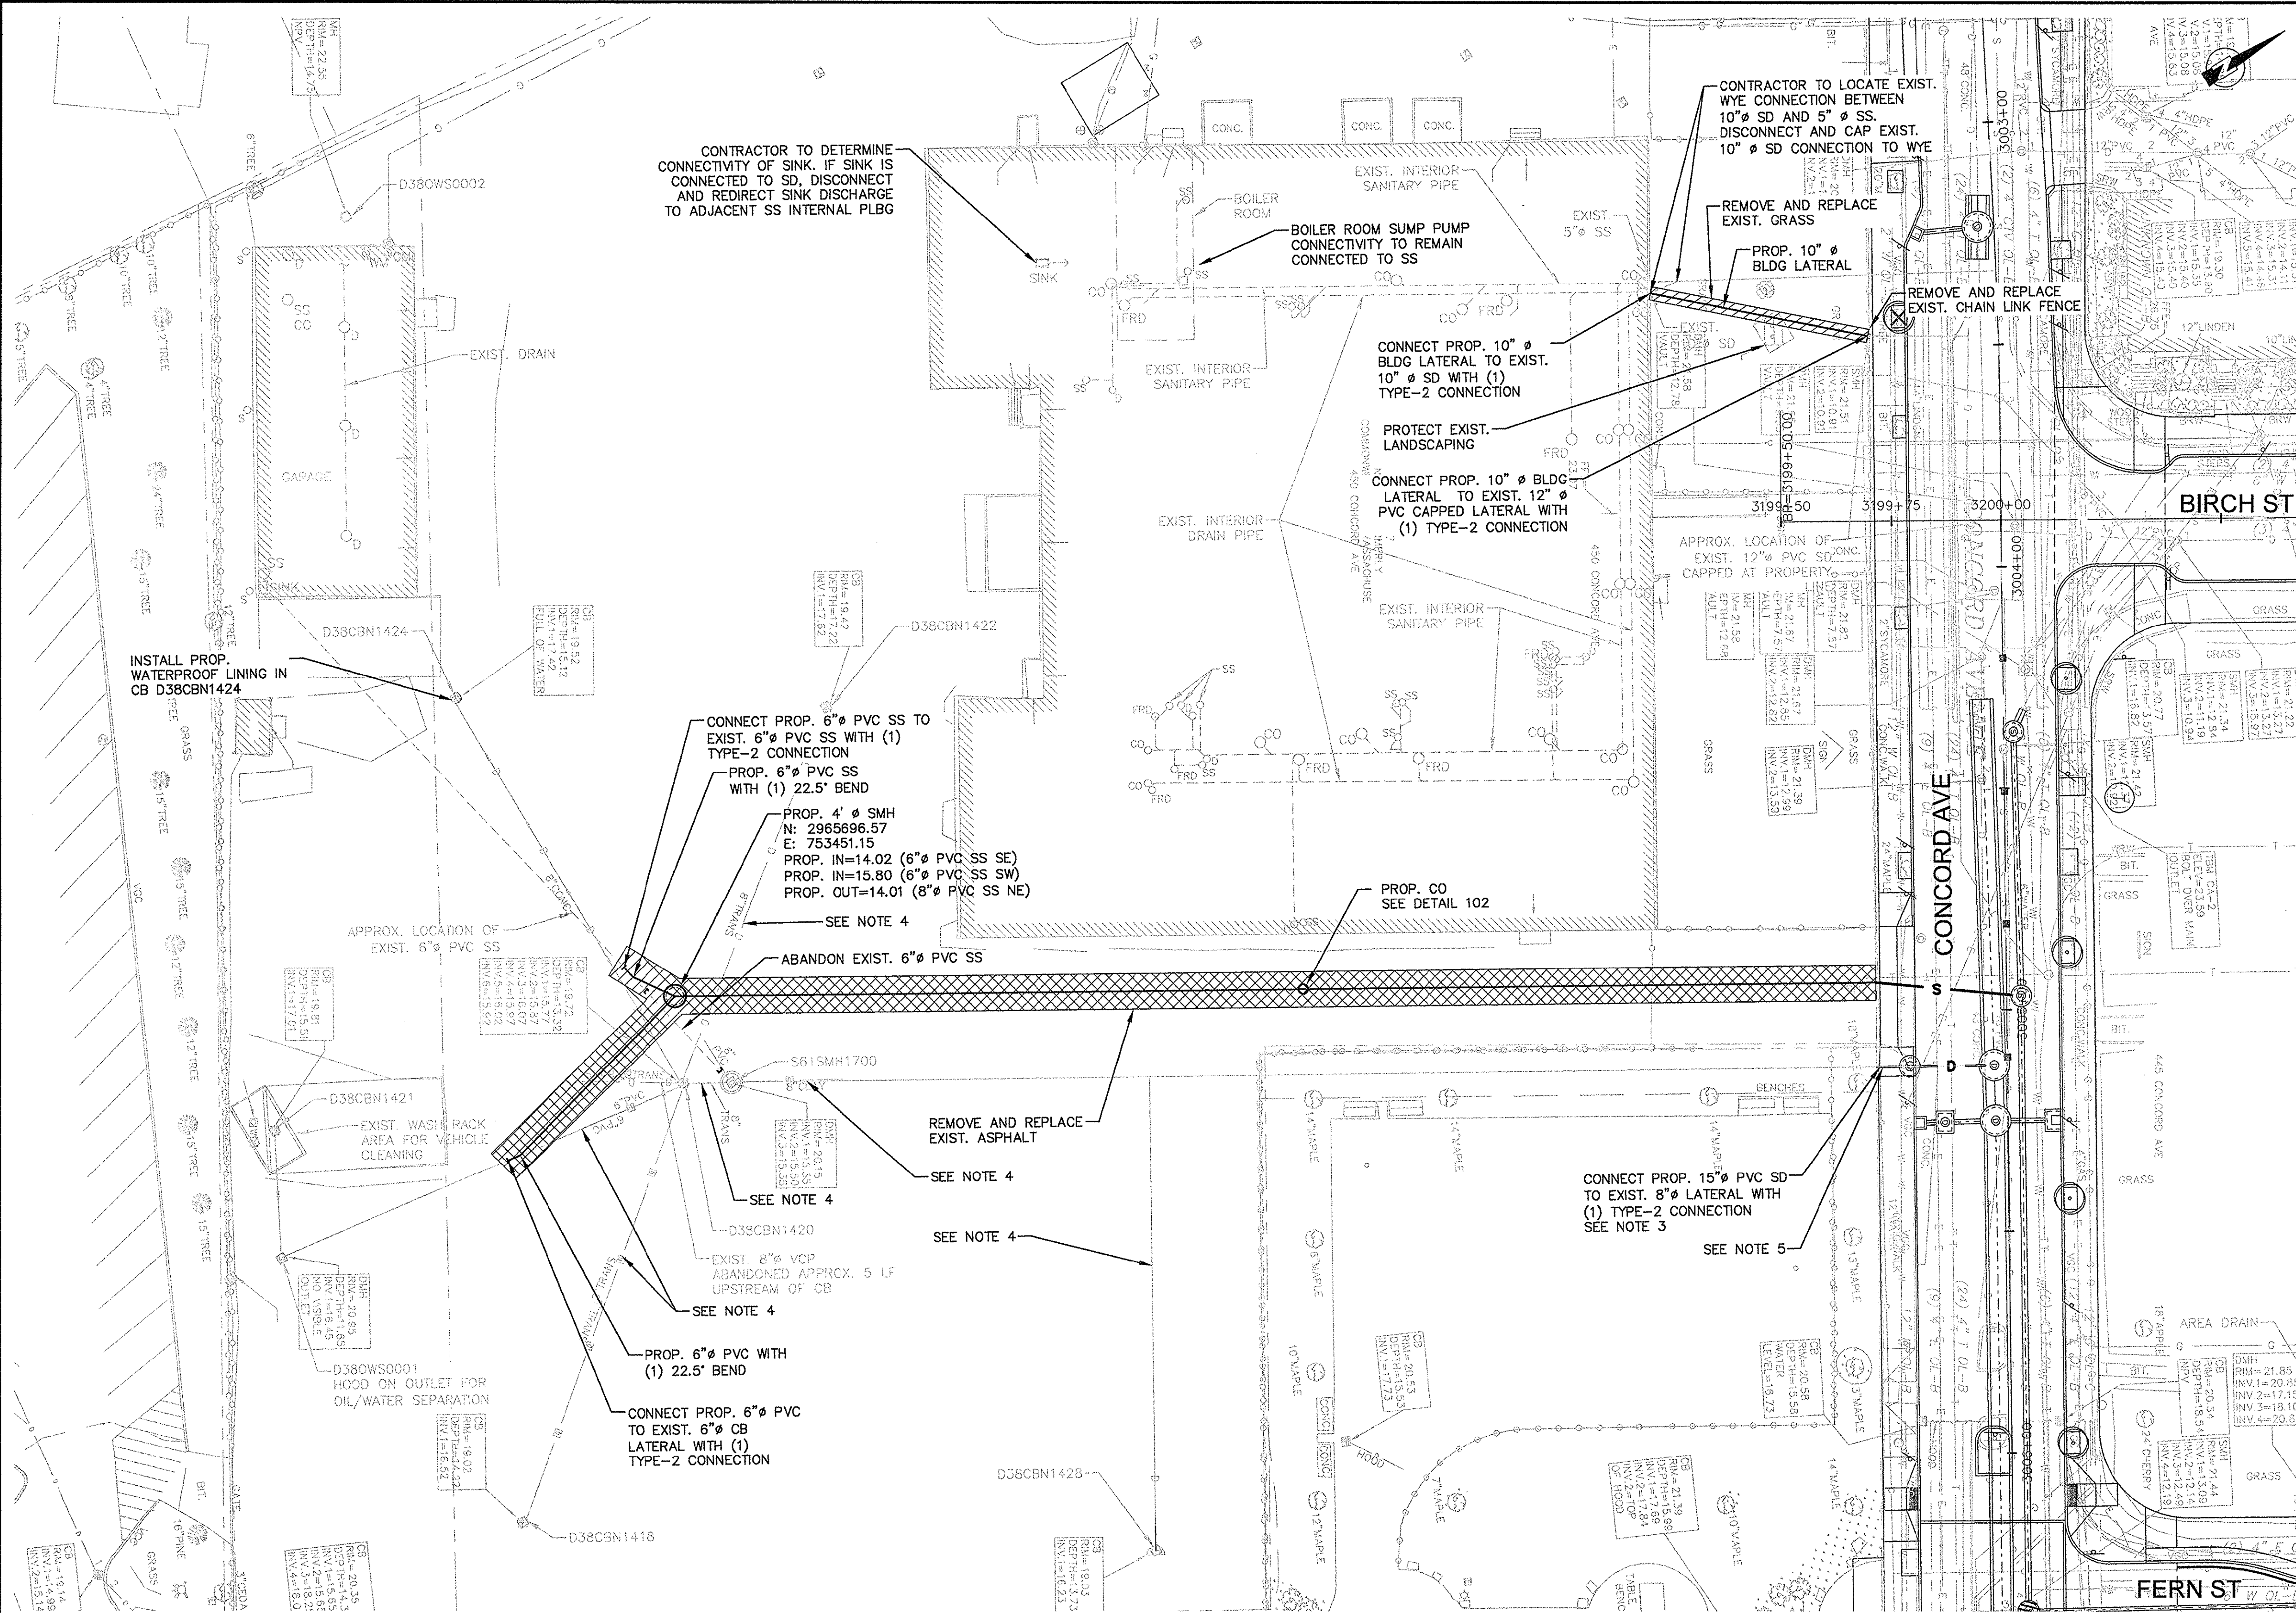

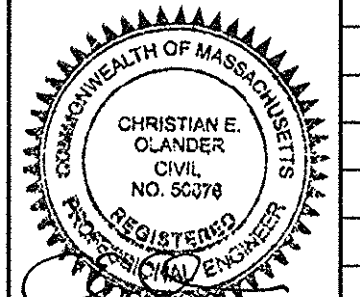
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Job No.	20120256.001A
Designed by	MTD
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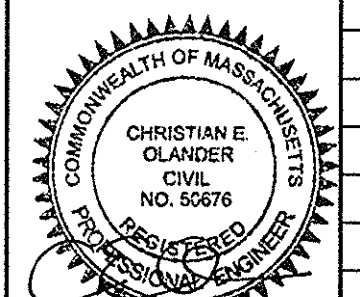
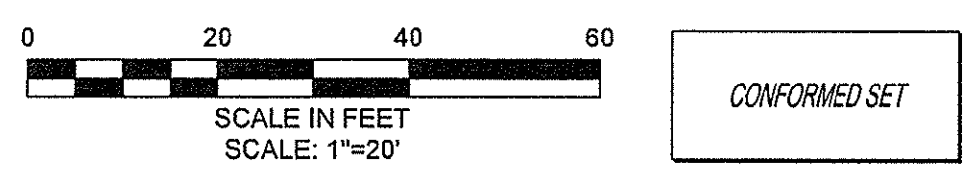
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Project	CONCORD (CONTRACT 9) SEWER SEPARATION AND SURFACE IMPROVEMENTS PROJECT	File No.	
Drawing	CIVIL - PRIVATE INFLOW REMOVAL PLAN NO. 1		

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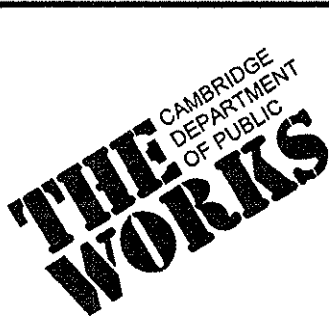


- NOTES FOR 450 CONCORD AVE:**
- CONTRACTOR TO DYE TEST ALL INTERIOR PLUMBING FIXTURES AND CONFIRM MAIN BUILDING IS FULLY SEPARATED PRIOR TO CONNECTING TO DRAIN LATERAL AT PROPERTY LINE.
 - FOR WORK WITHIN THE RIGHT-OF-WAY REFER TO C-1 & C-2.
 - CONTRACTOR TO TEST PIT EXIST. 8" BLDG LATERAL WITHIN PUBLIC RIGHT-OF-WAY TO DETERMINE DEPTH OF PIPE PRIOR TO ORDERING DMH-02.
 - CCTV INSPECTIONS IDENTIFIED PIPE AS ASBESTOS CEMENT (AC) CONTRACTOR TO FIELD VERIFY.
 - CUT AND REMOVE EXIST. PIPE IN ACCORDANCE WITH SPECIFICATION SECTION 02076.

PLAN NO. 2
450 CONCORD AVE










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Job No.	20120256.001A
Designed by	MTD
Drawn by	PBR
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Approved by	EO




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Project	CONCORD (CONTRACT 9) SEWER SEPARATION AND SURFACE IMPROVEMENTS PROJECT
Drawing	CIVIL - PRIVATE INFLOW REMOVAL PLAN NO. 2

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File No.	

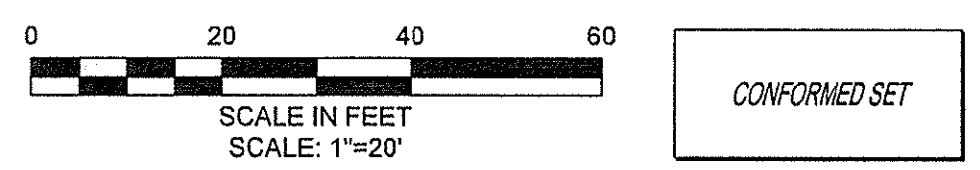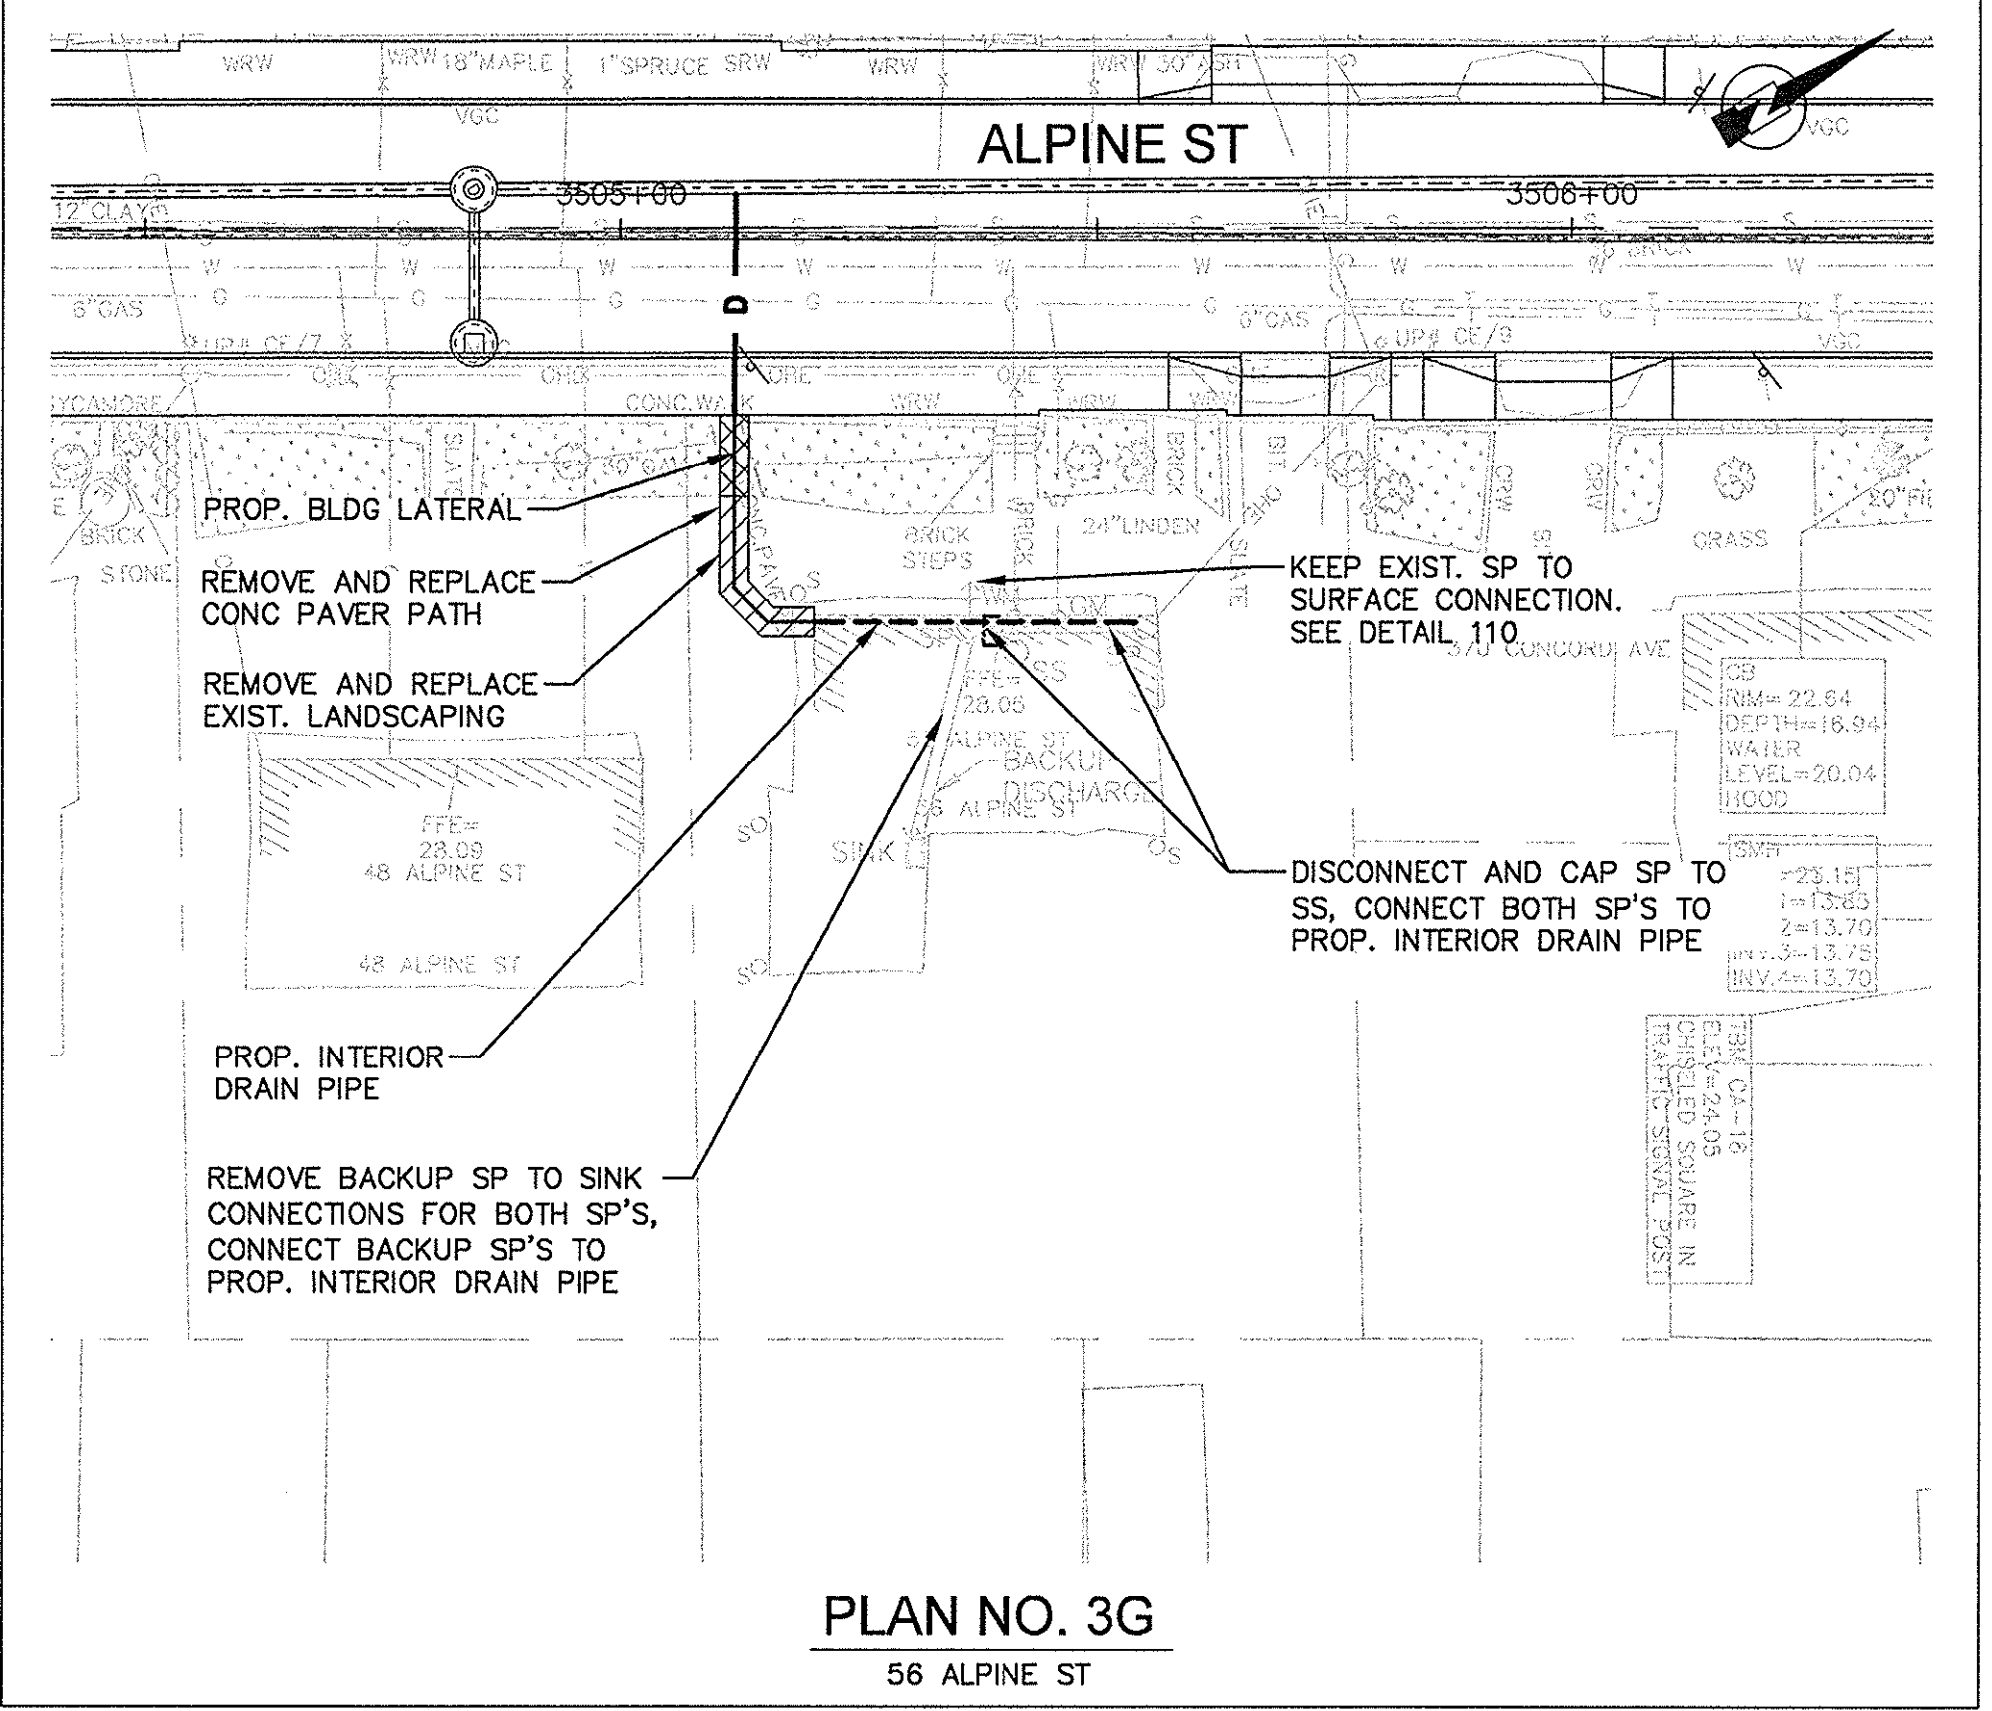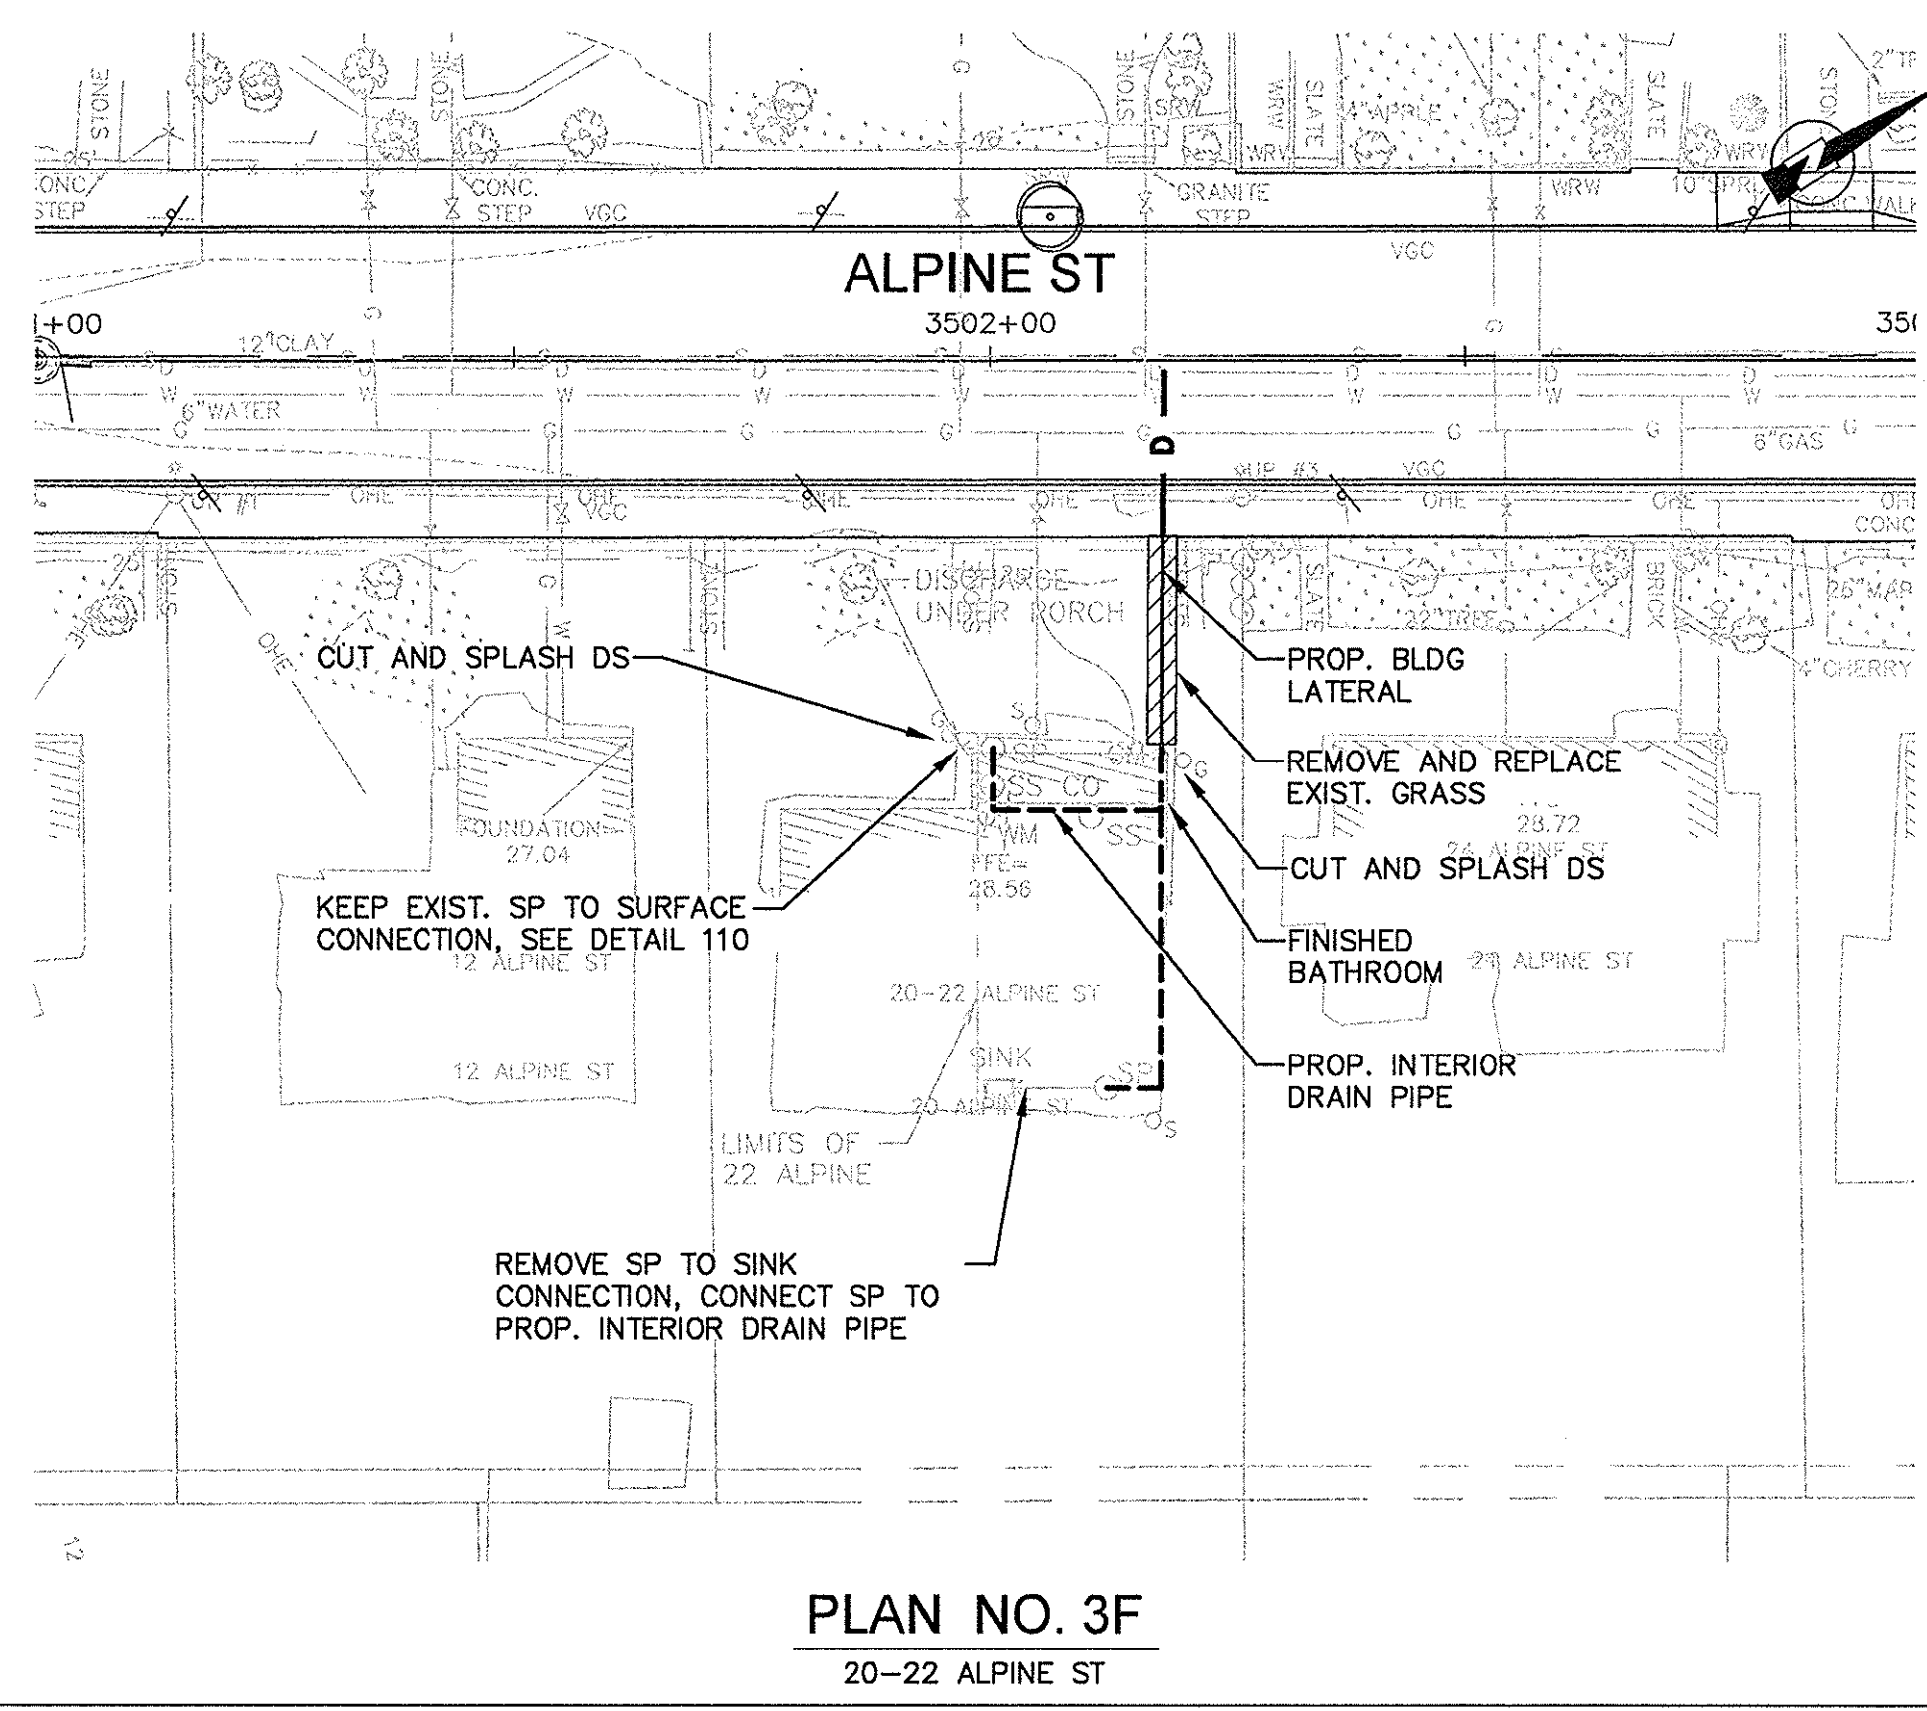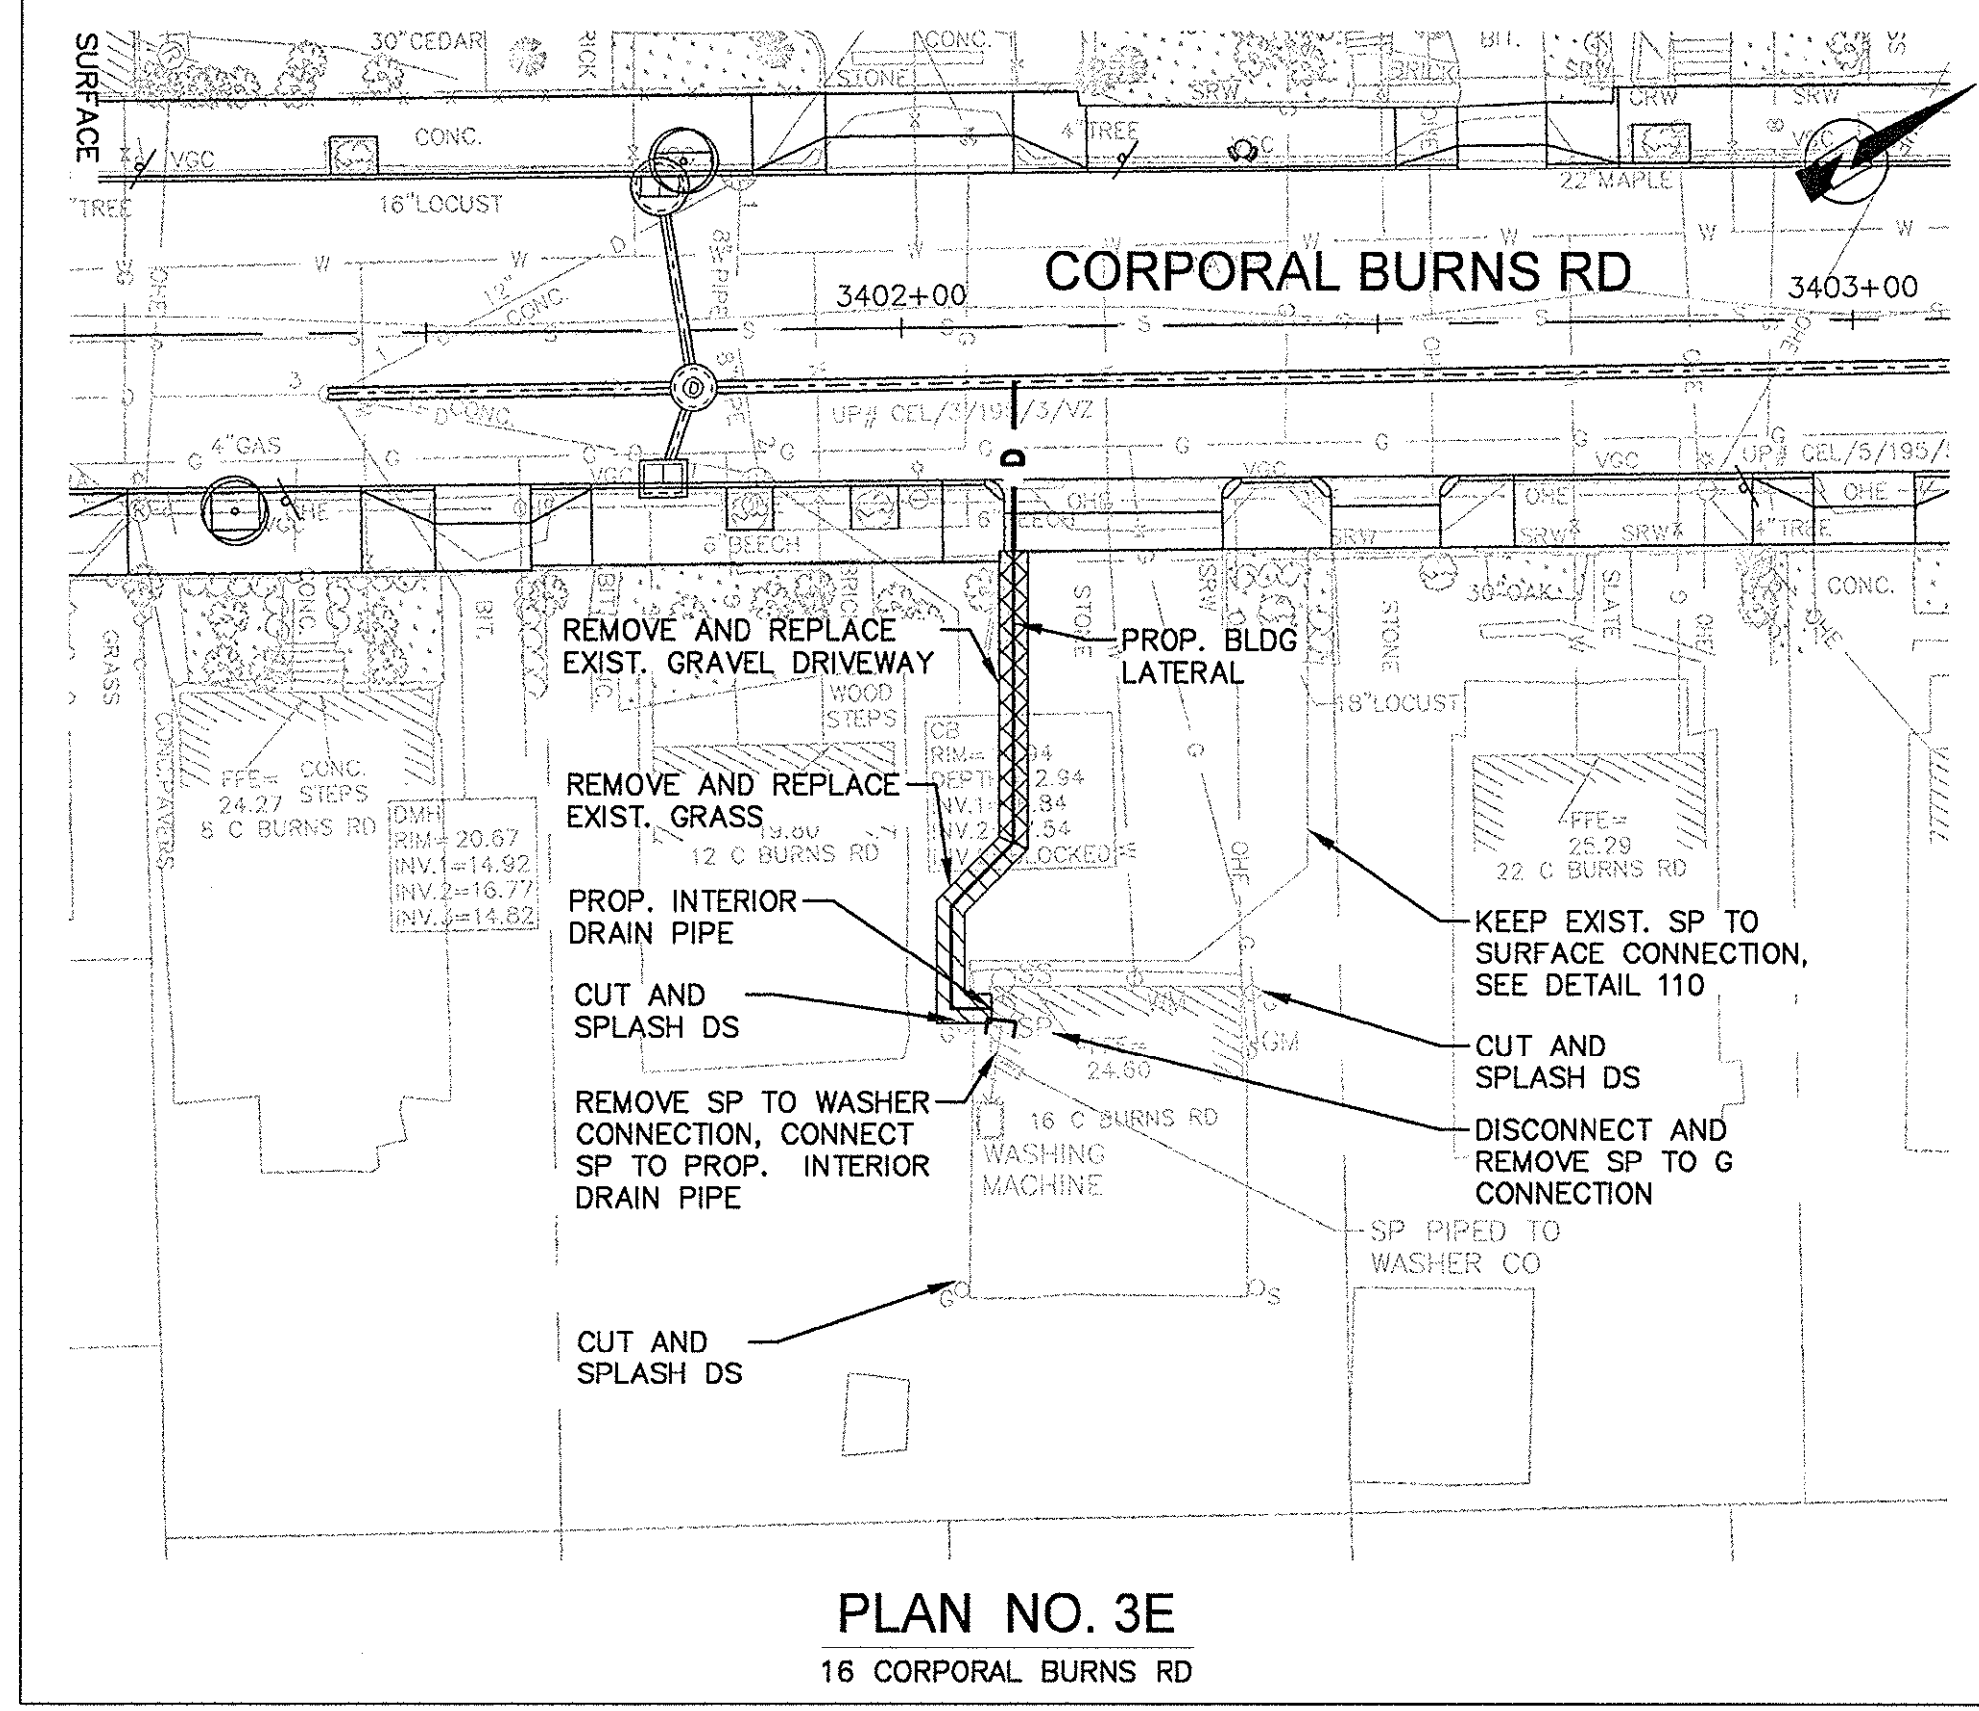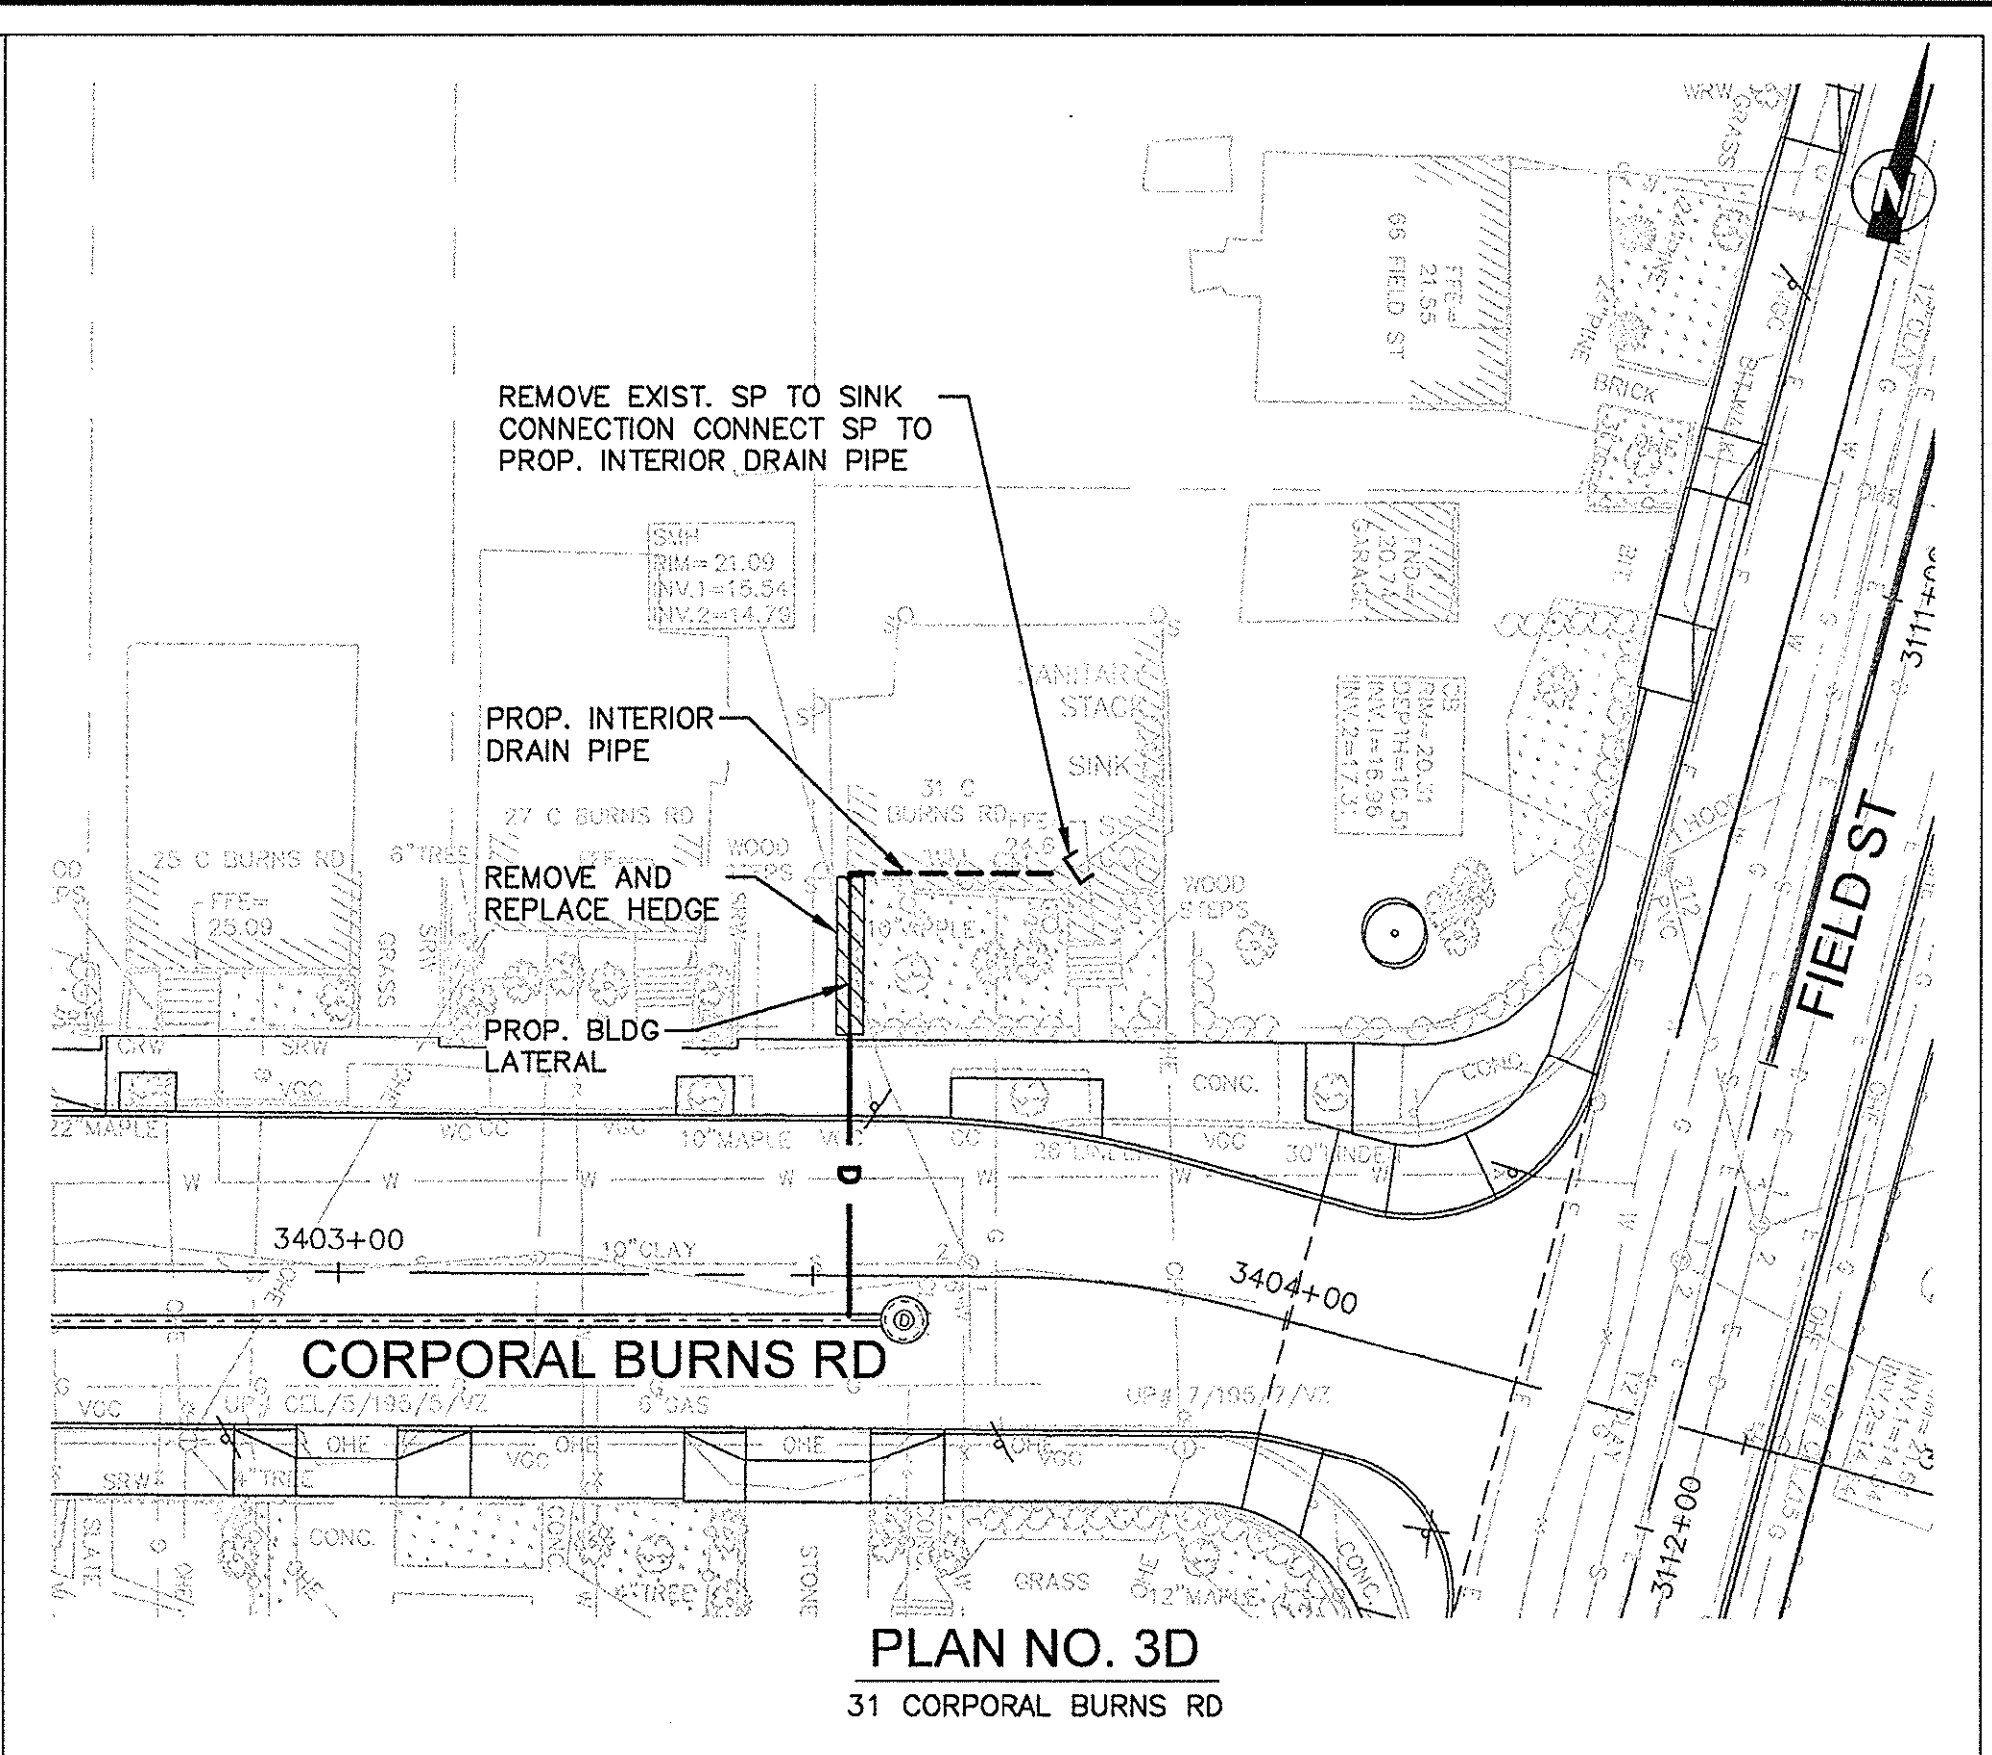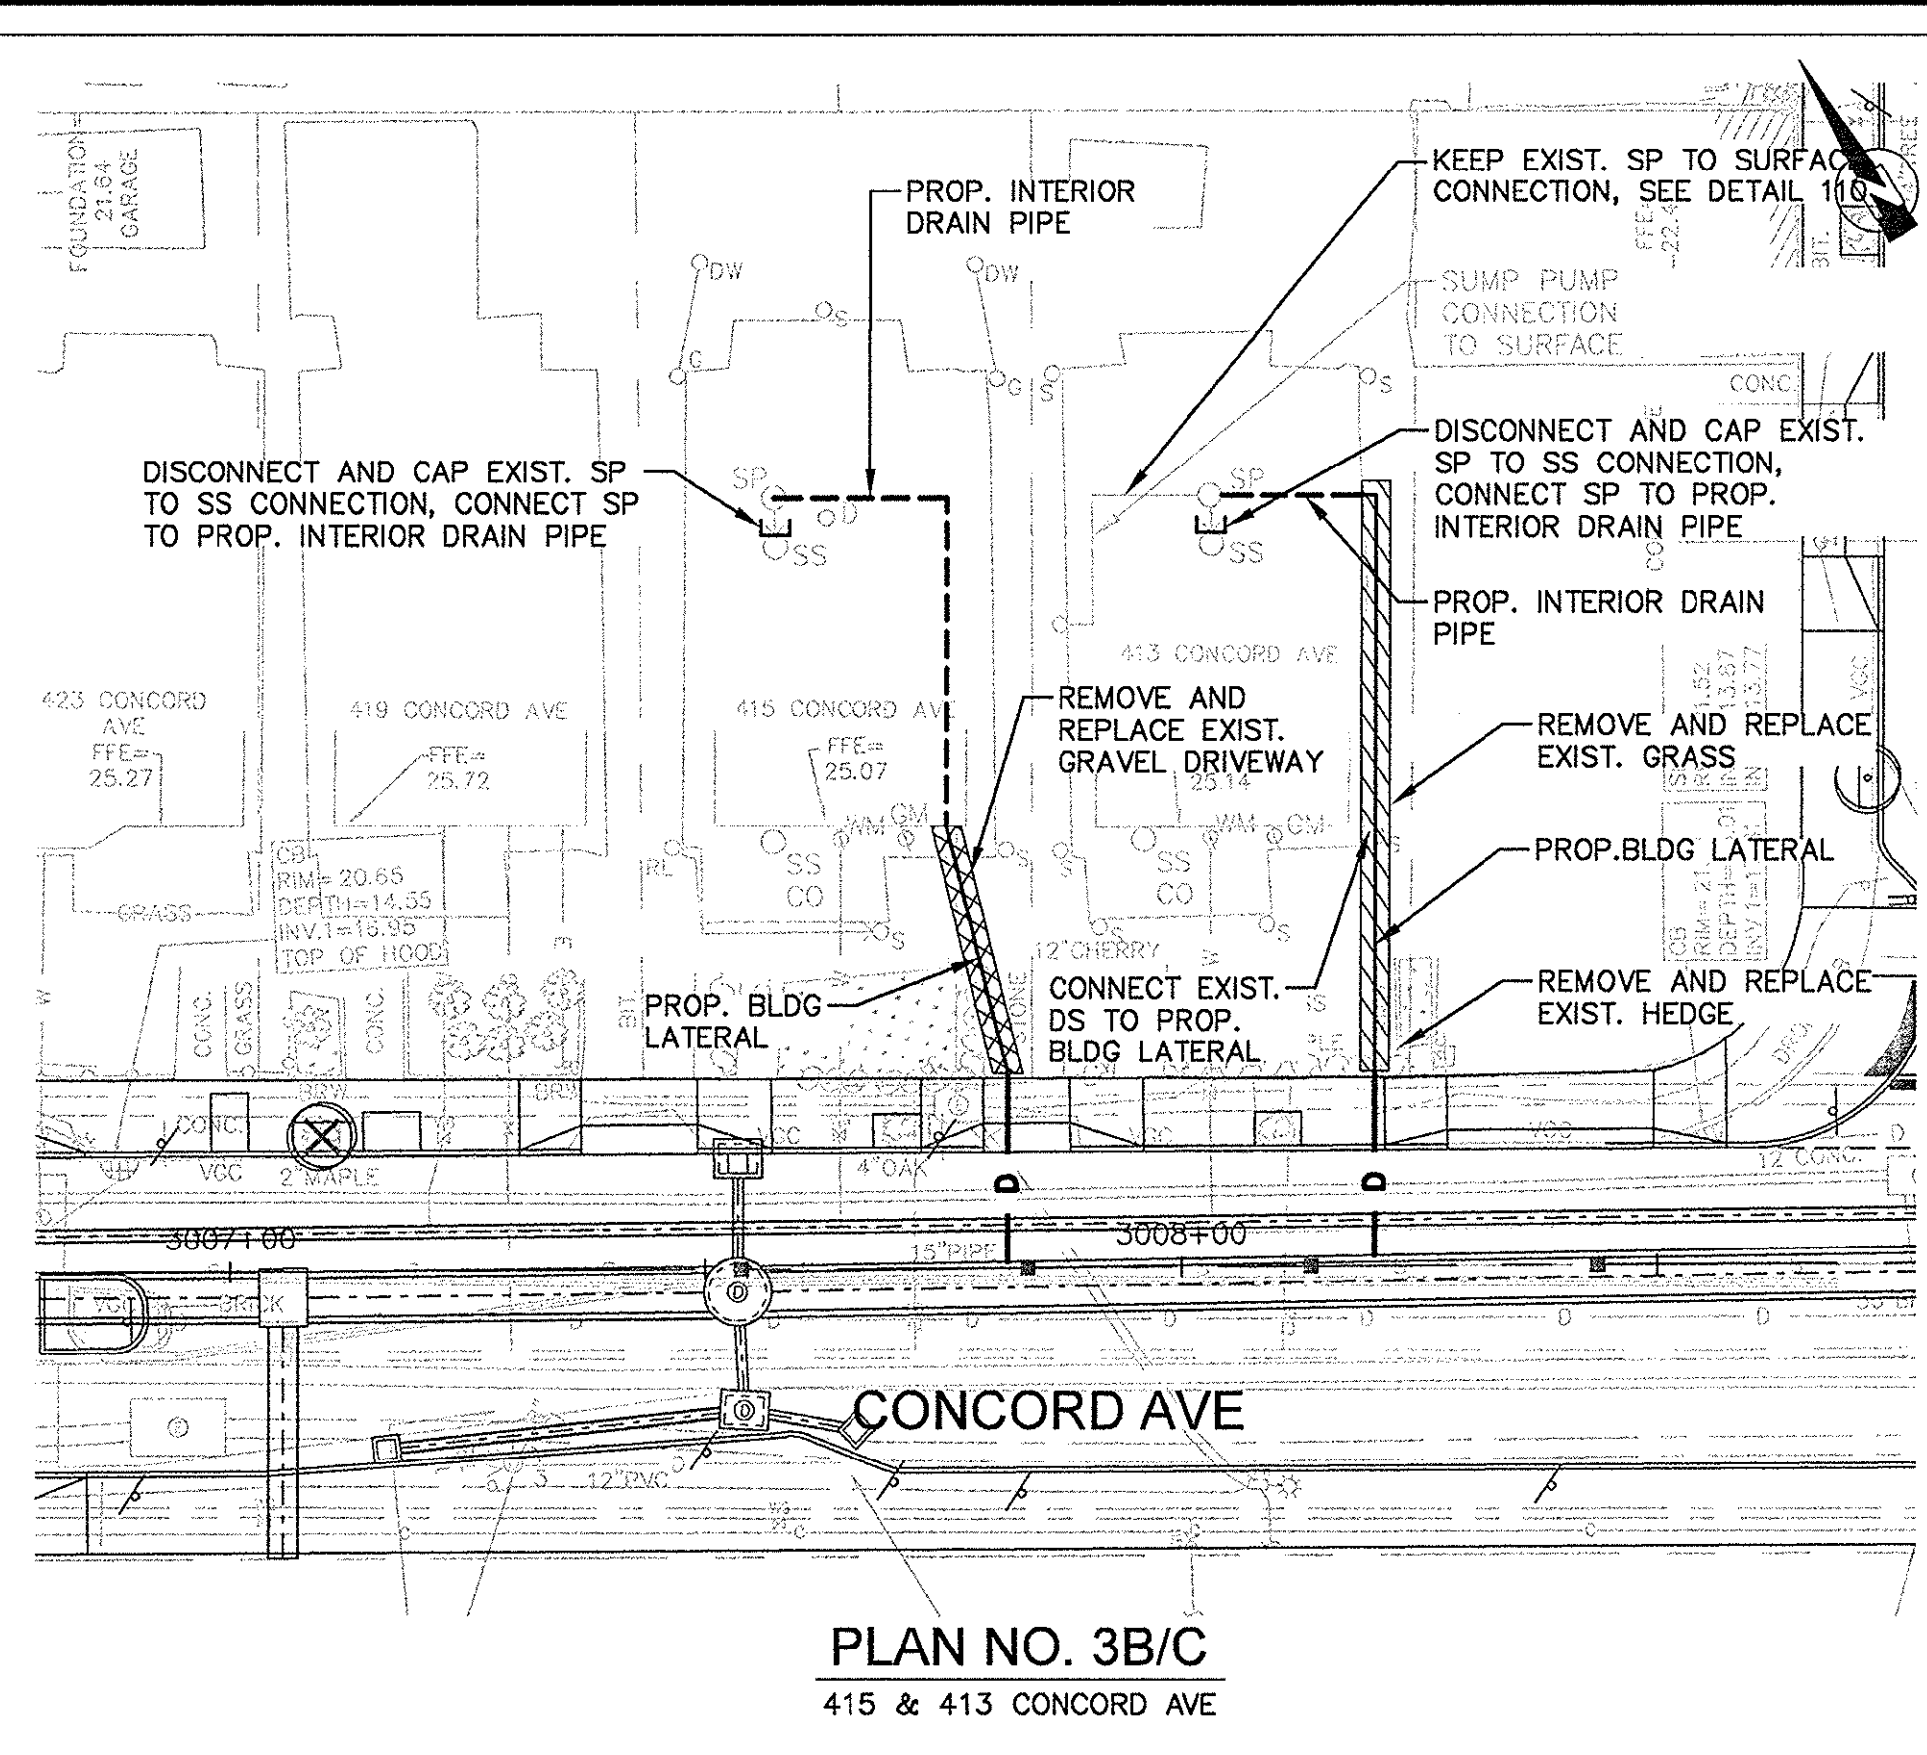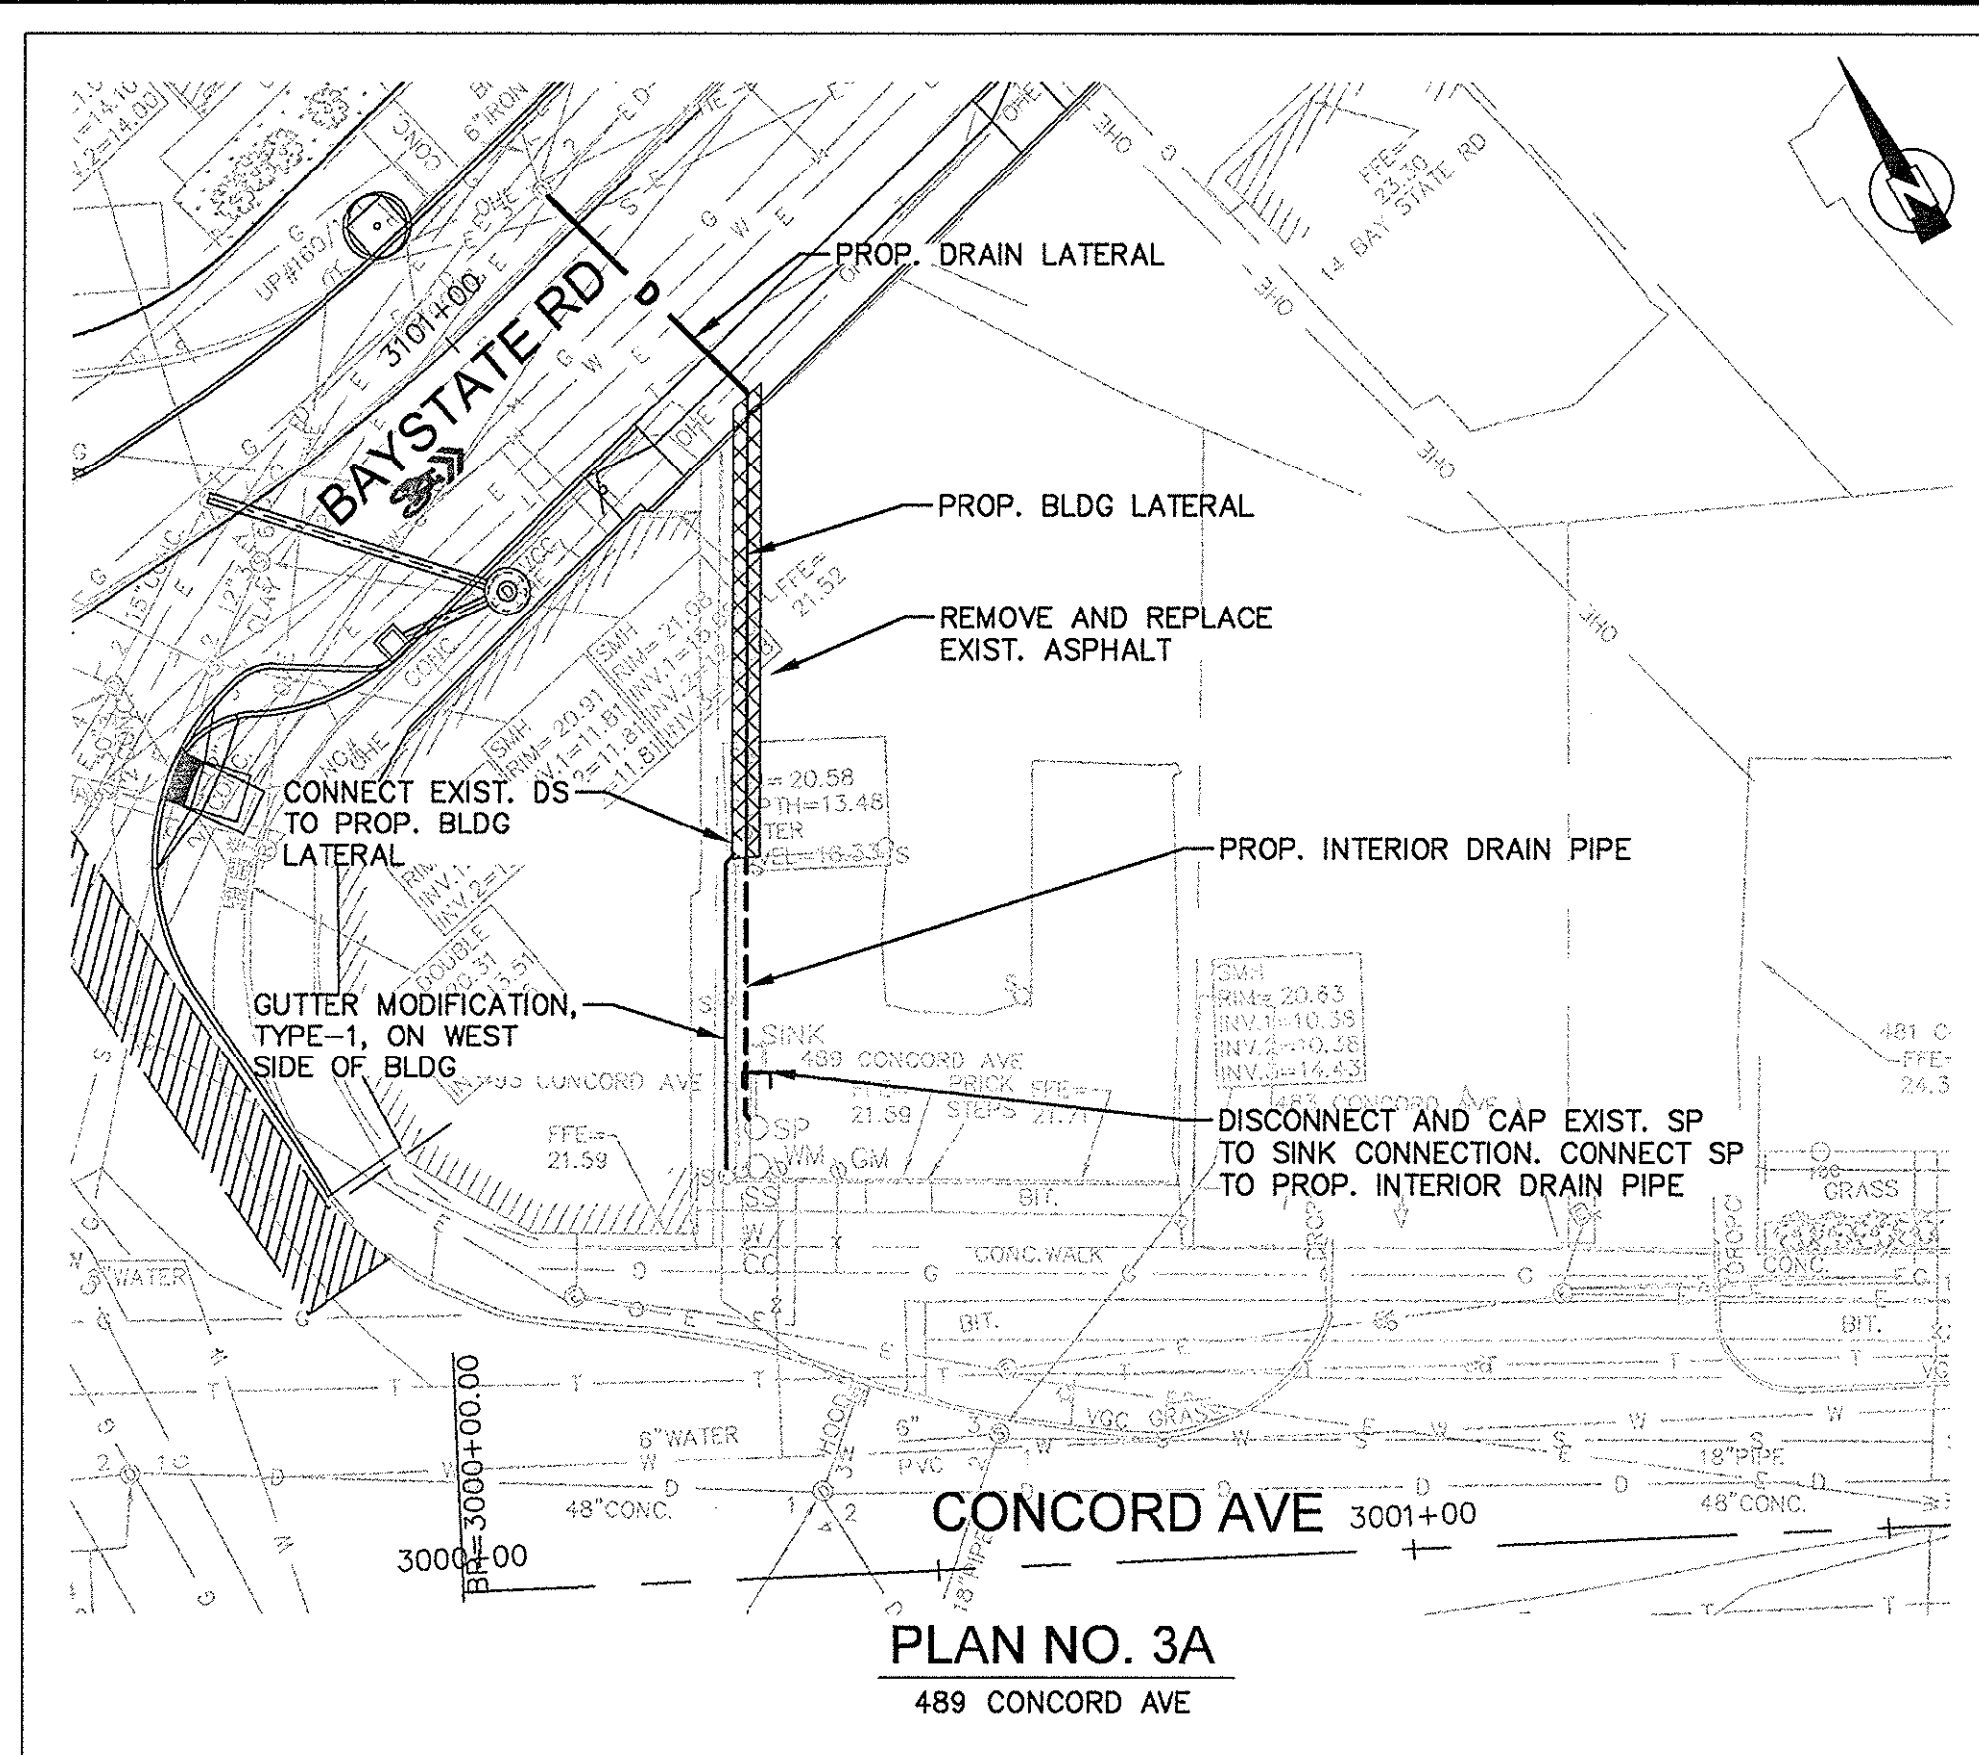

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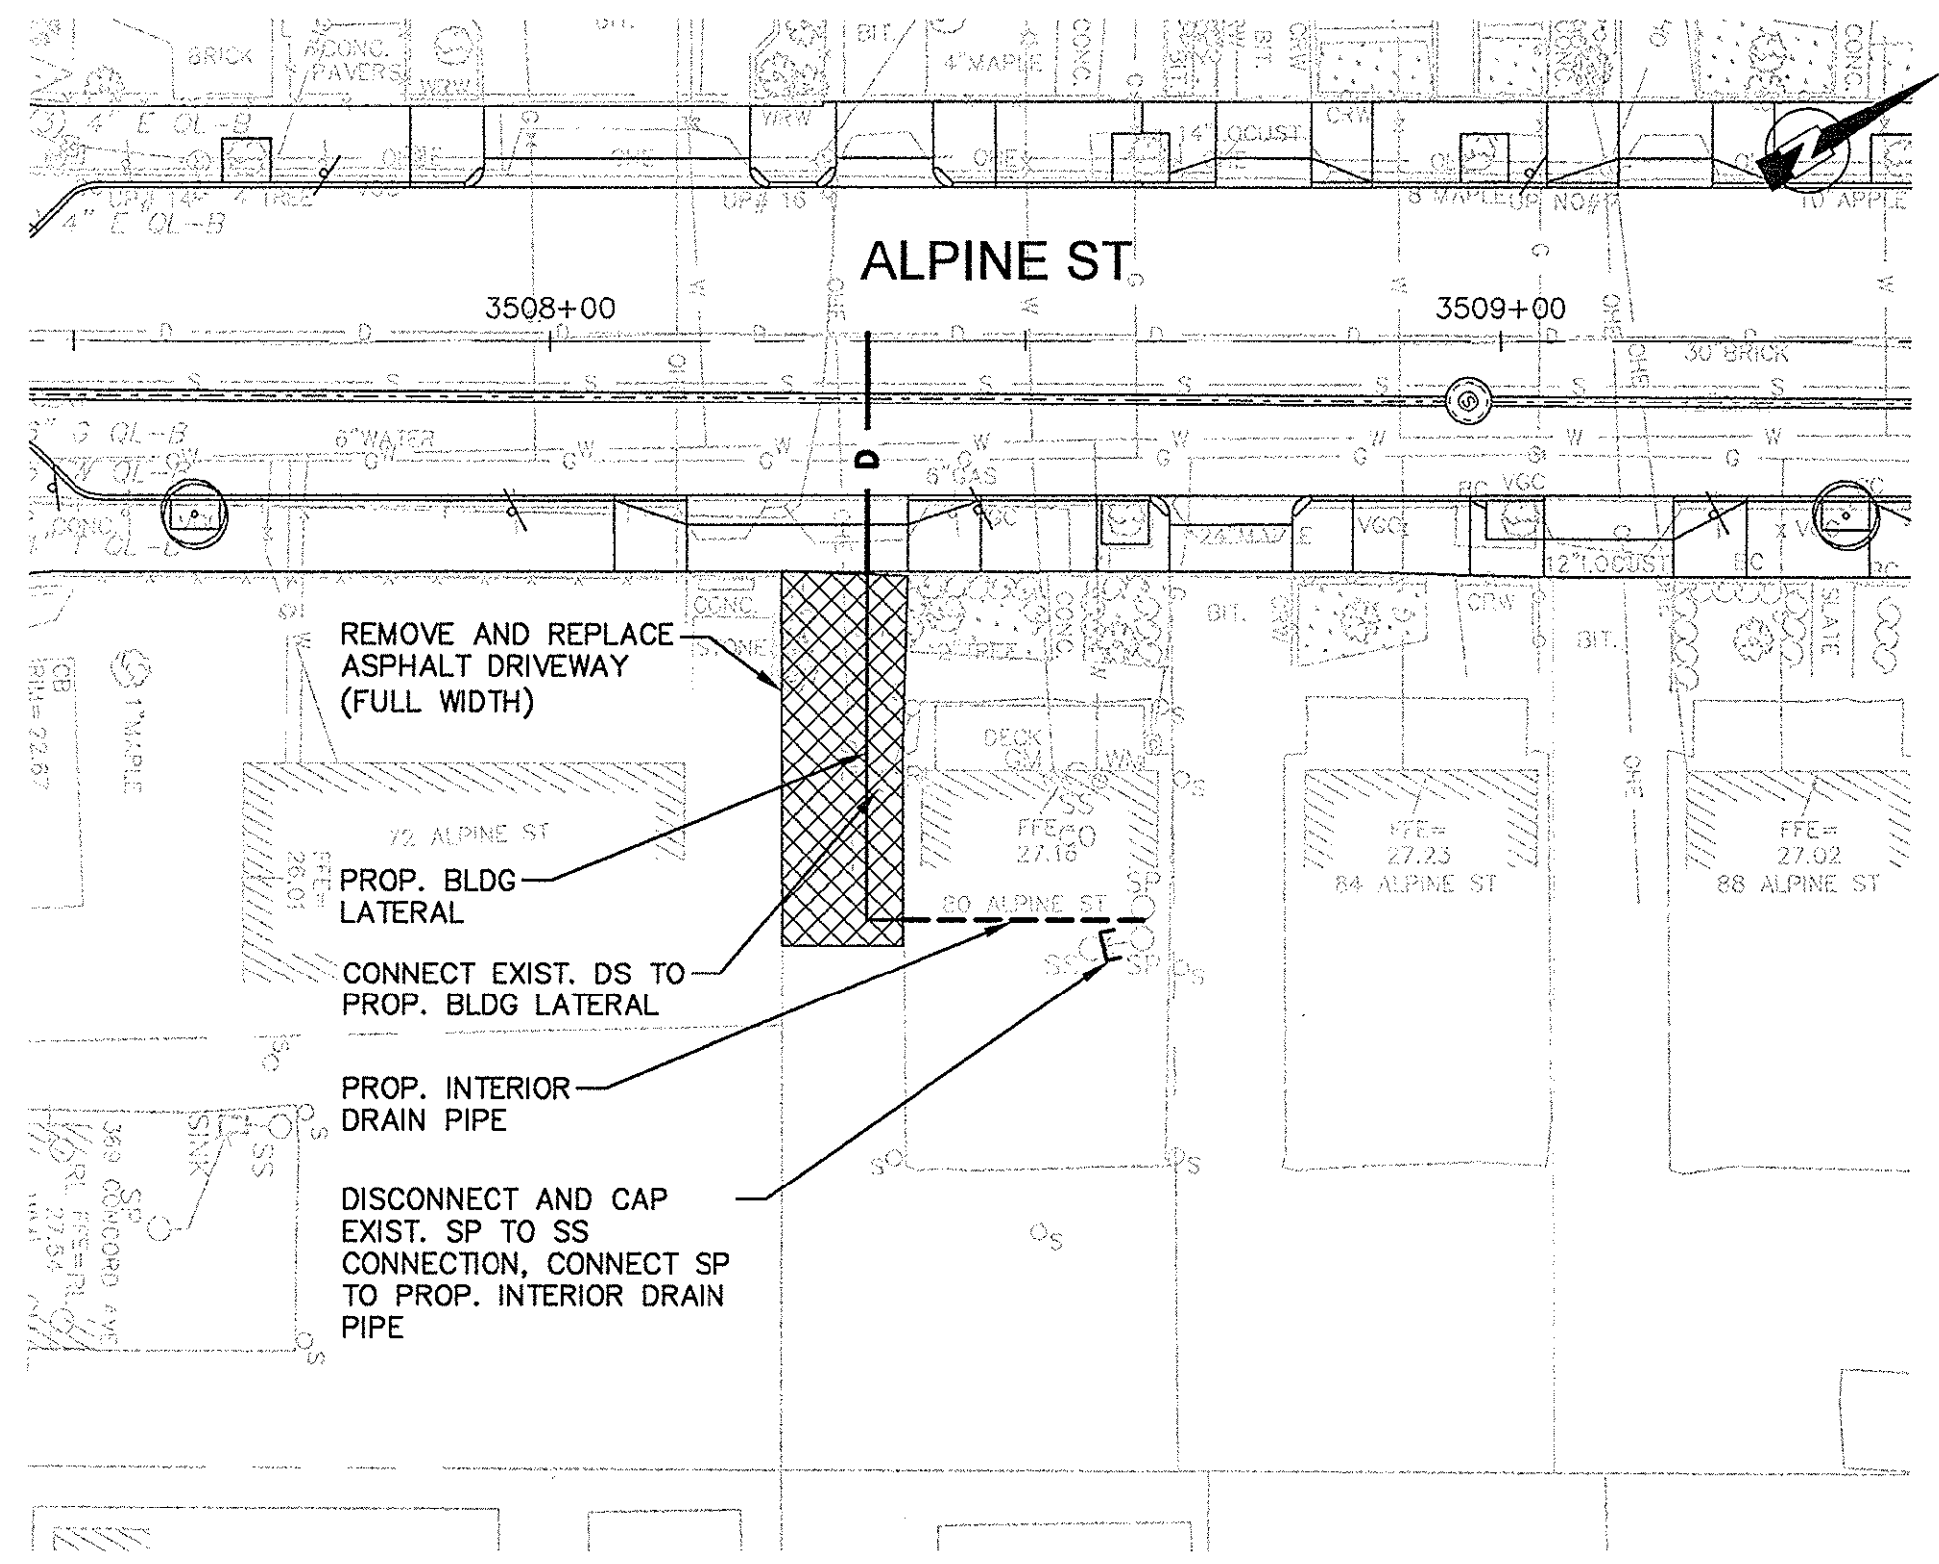


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REVISIONS		
No.	Description	Date

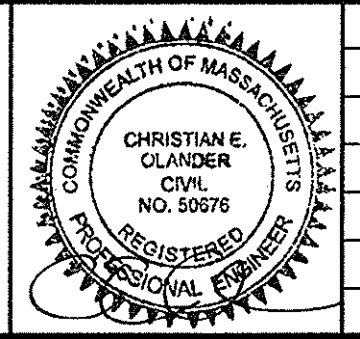


Client	CITY OF CAMBRIDGE, MASSACHUSETTS
Project	CONCORD (CONTRACT 9) SEWER SEPARATION AND SURFACE IMPROVEMENTS PROJECT
Drawing	CIVIL - PRIVATE INFLOW REMOVAL PLAN NO. 3


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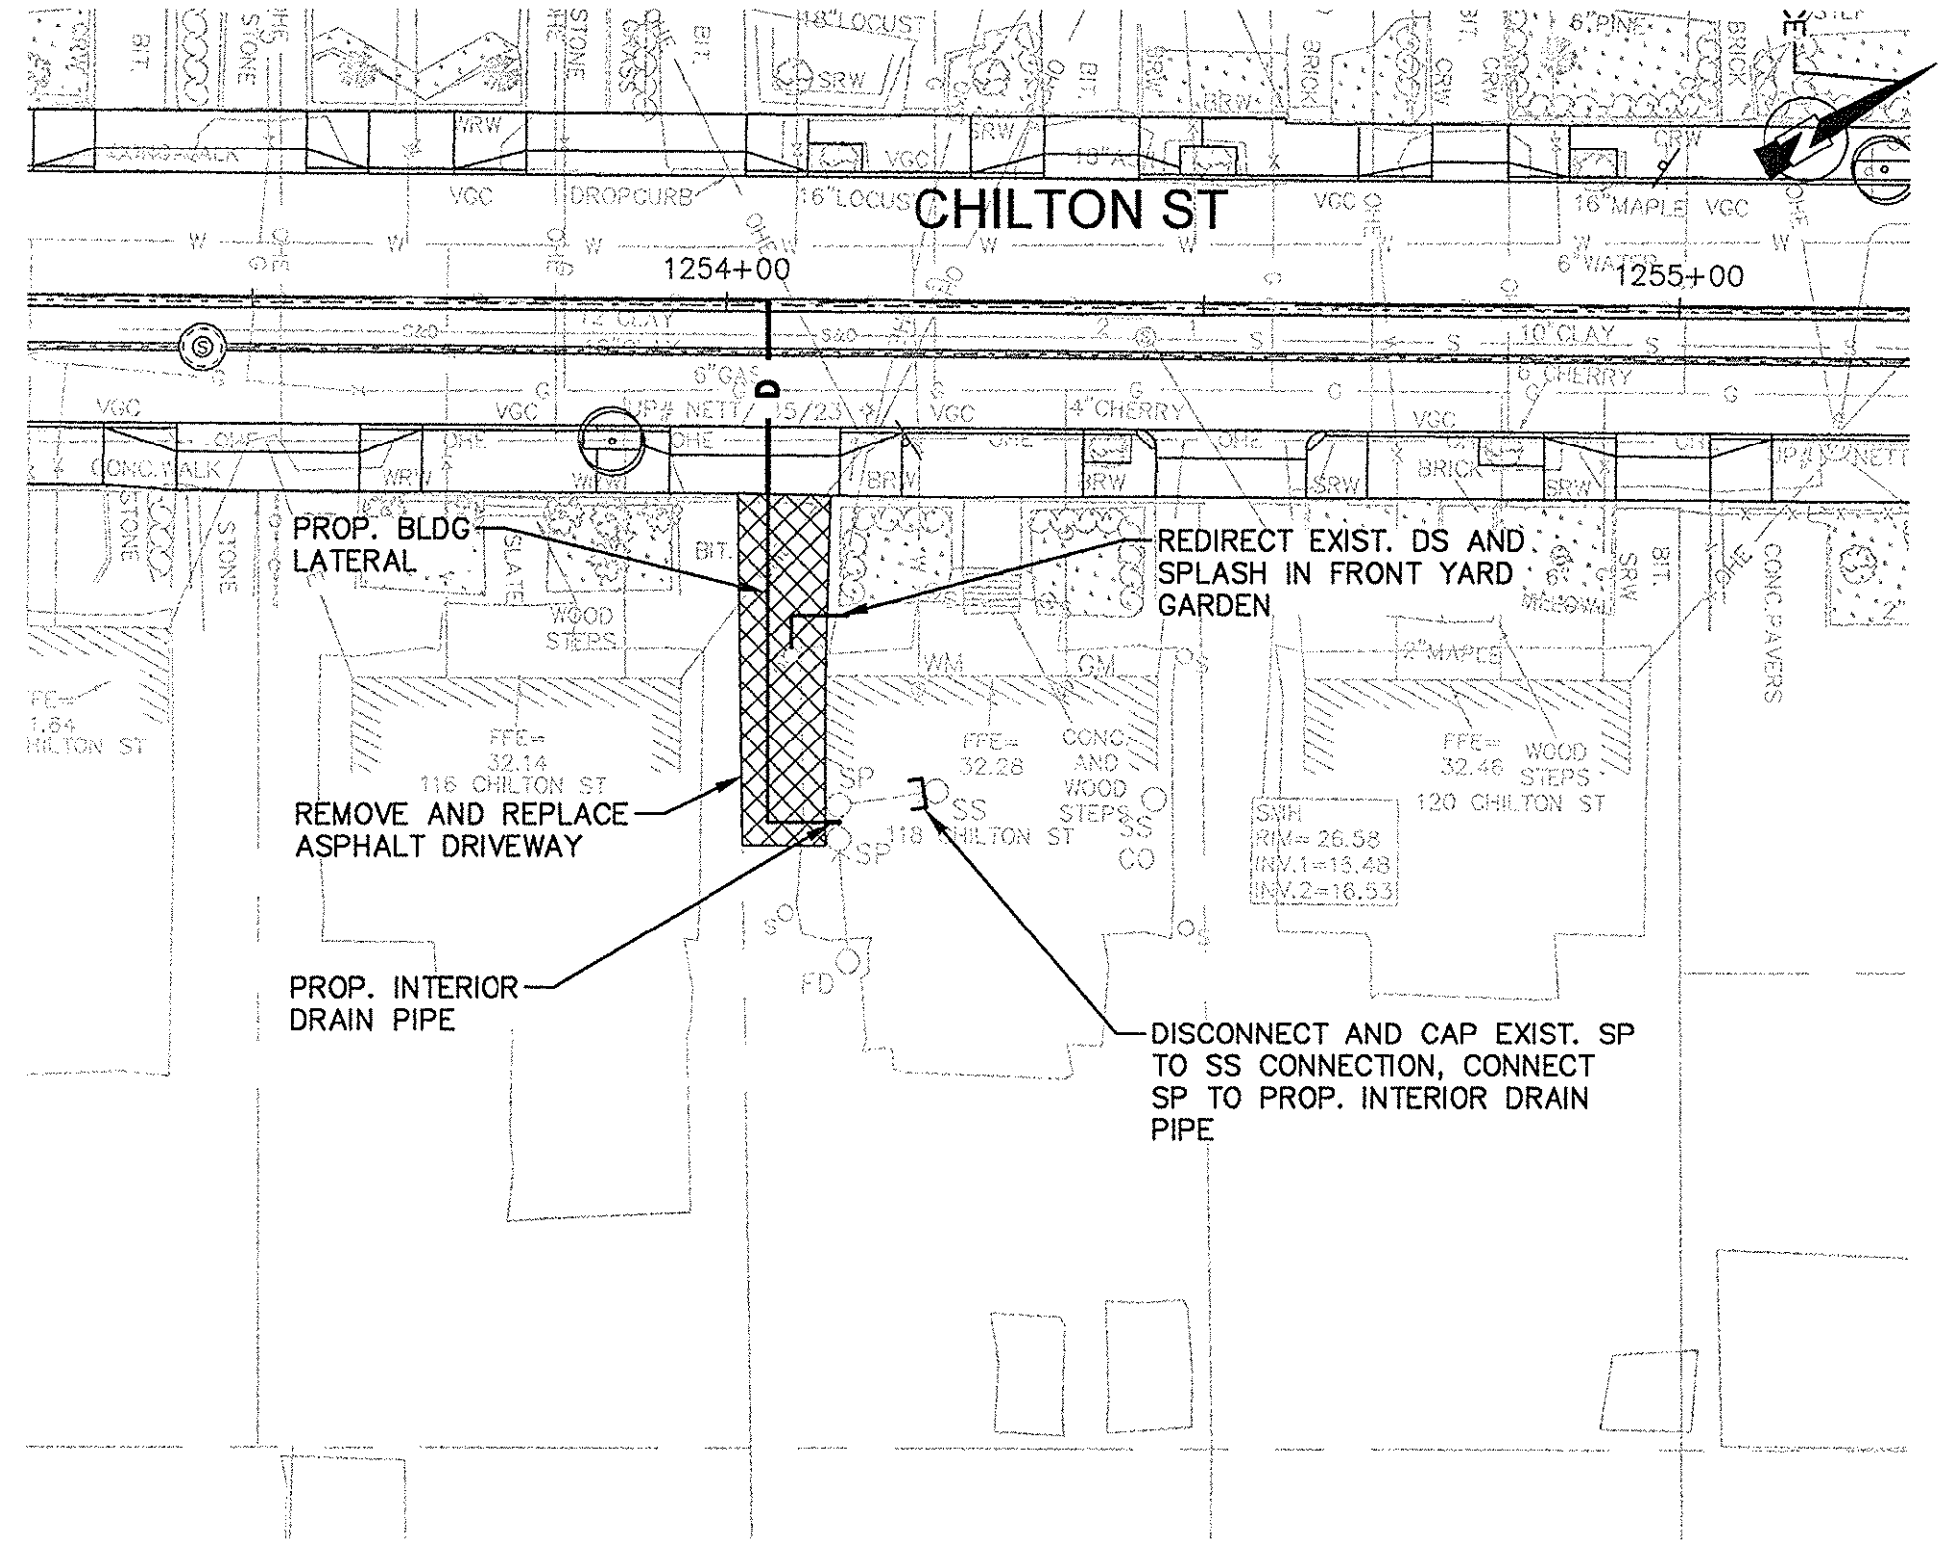
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80 ALPINE ST




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369 CONCORD AVE

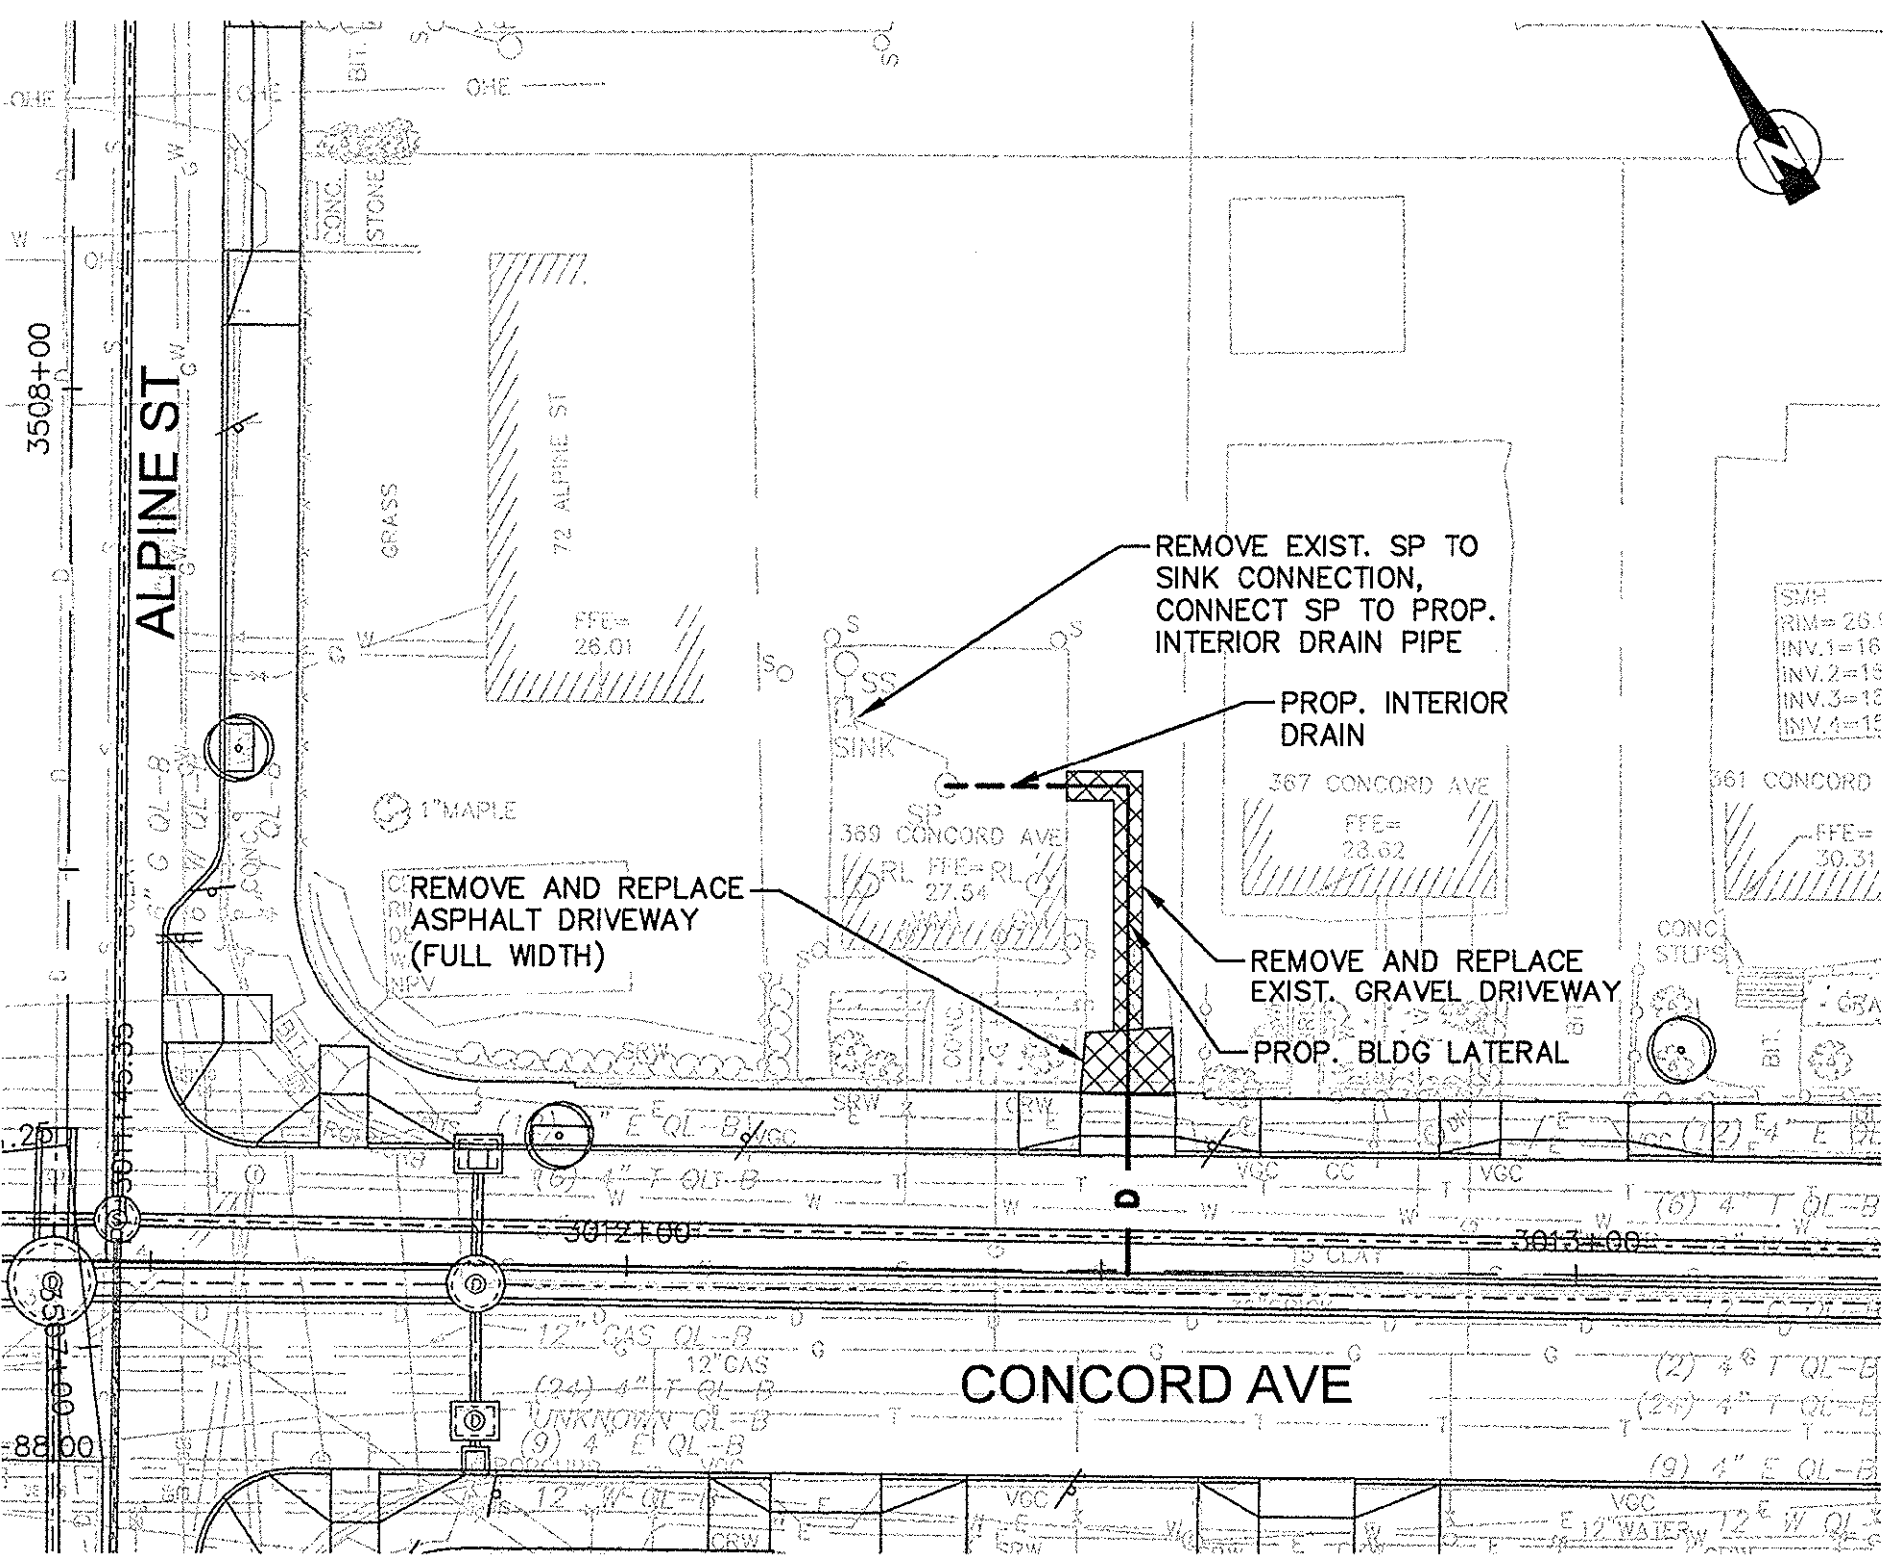


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360 CONCORD AVE

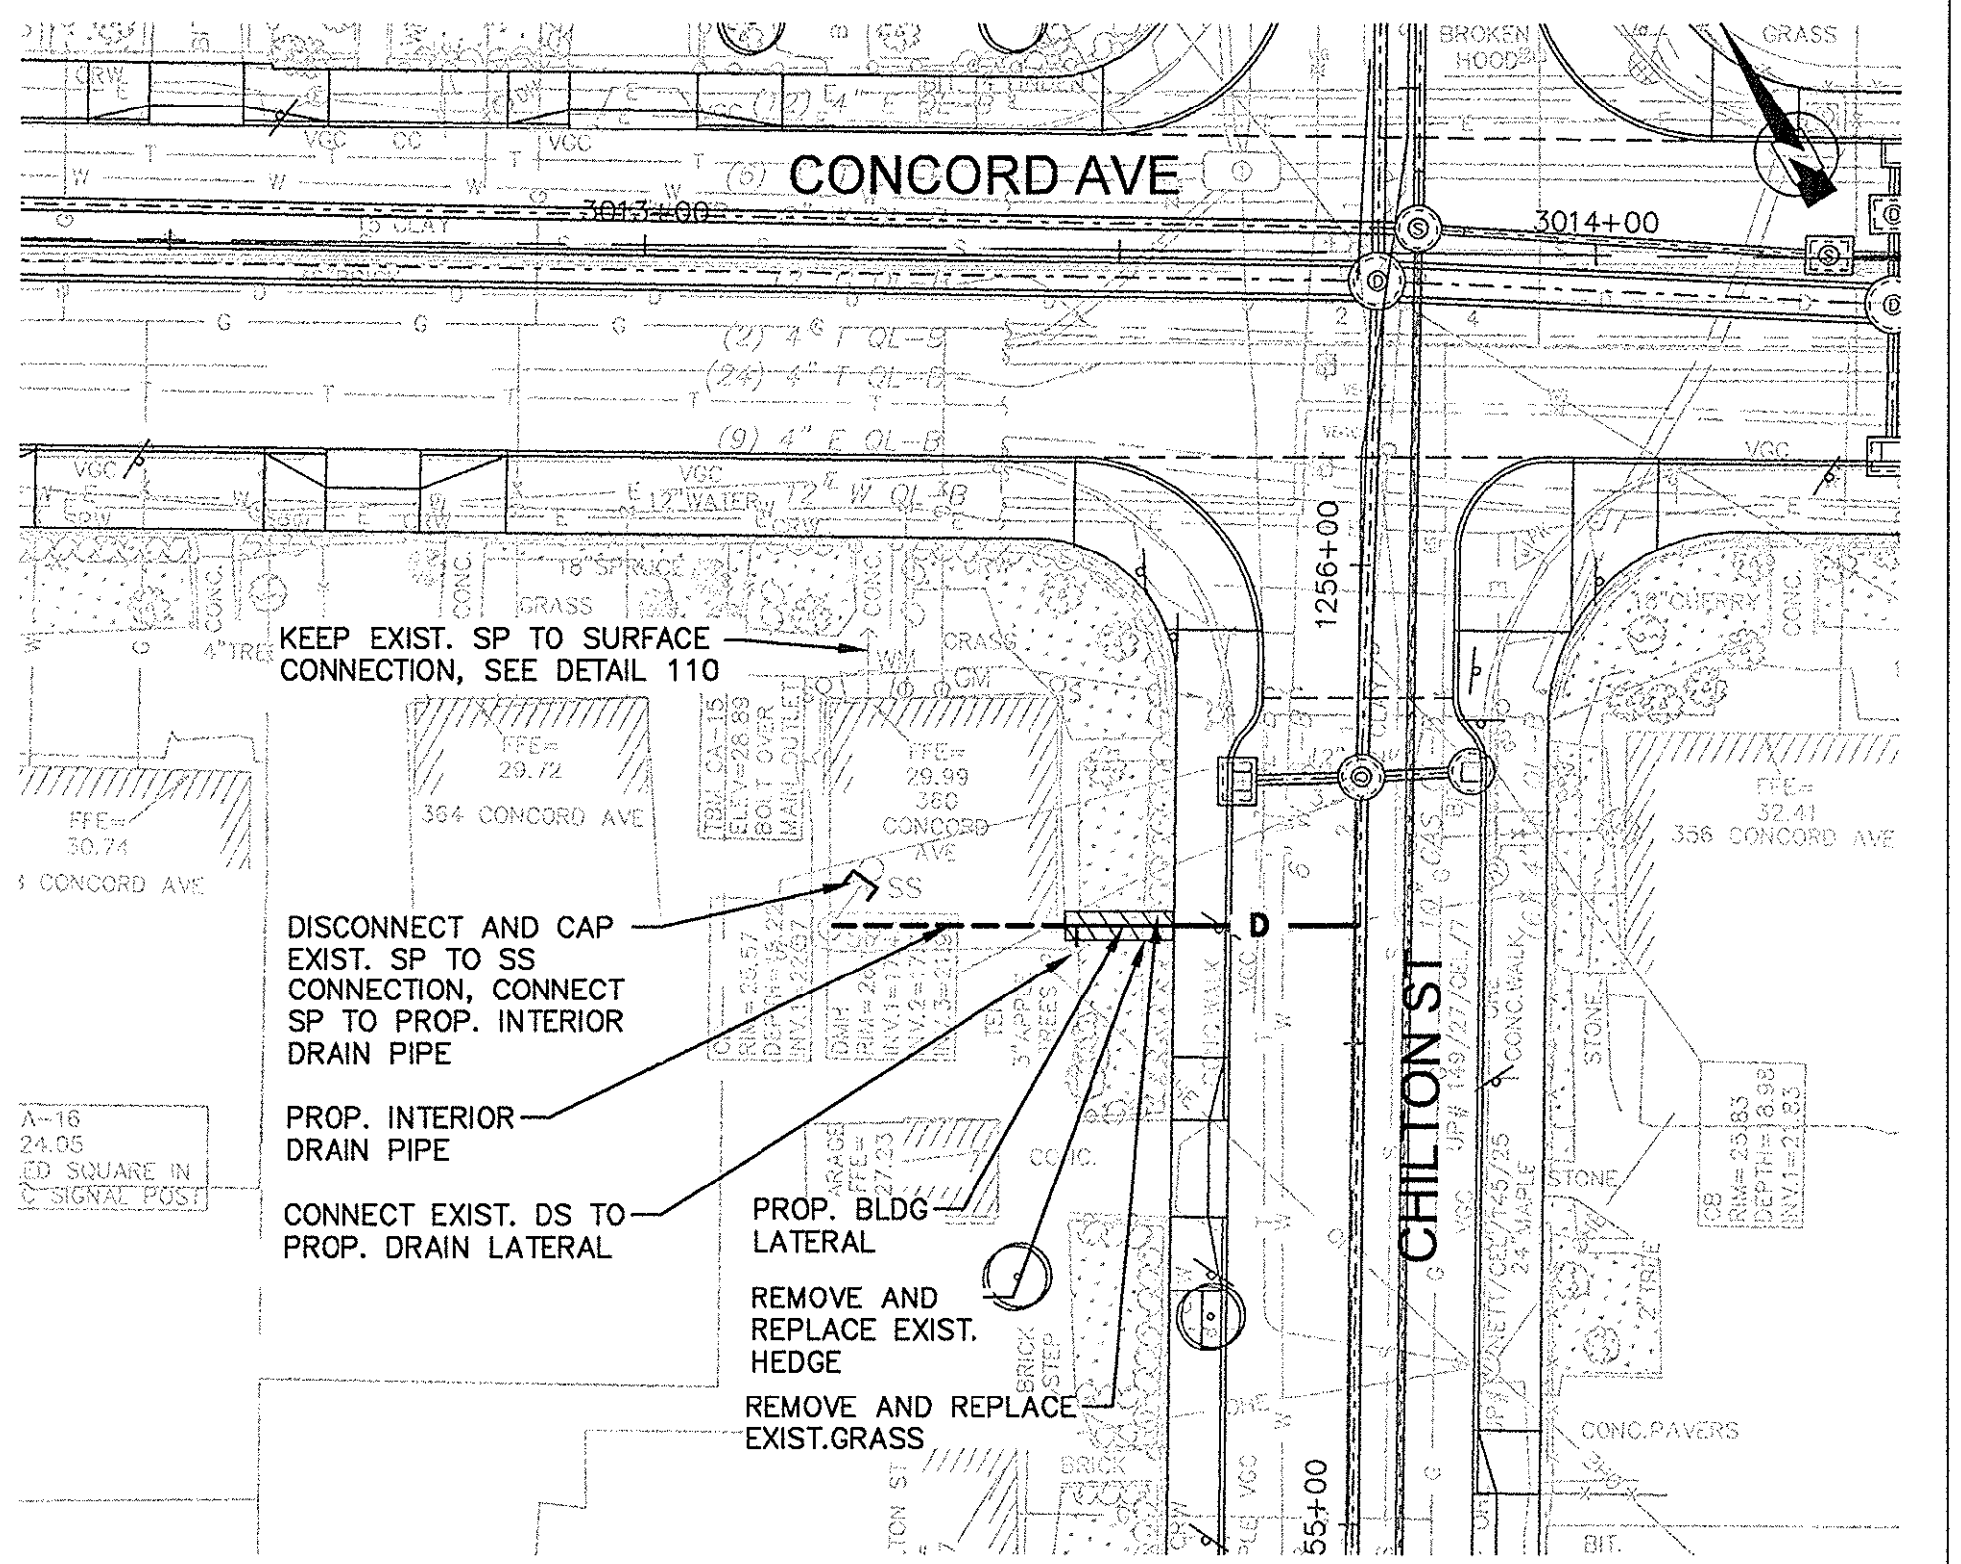


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118 CHILTON ST

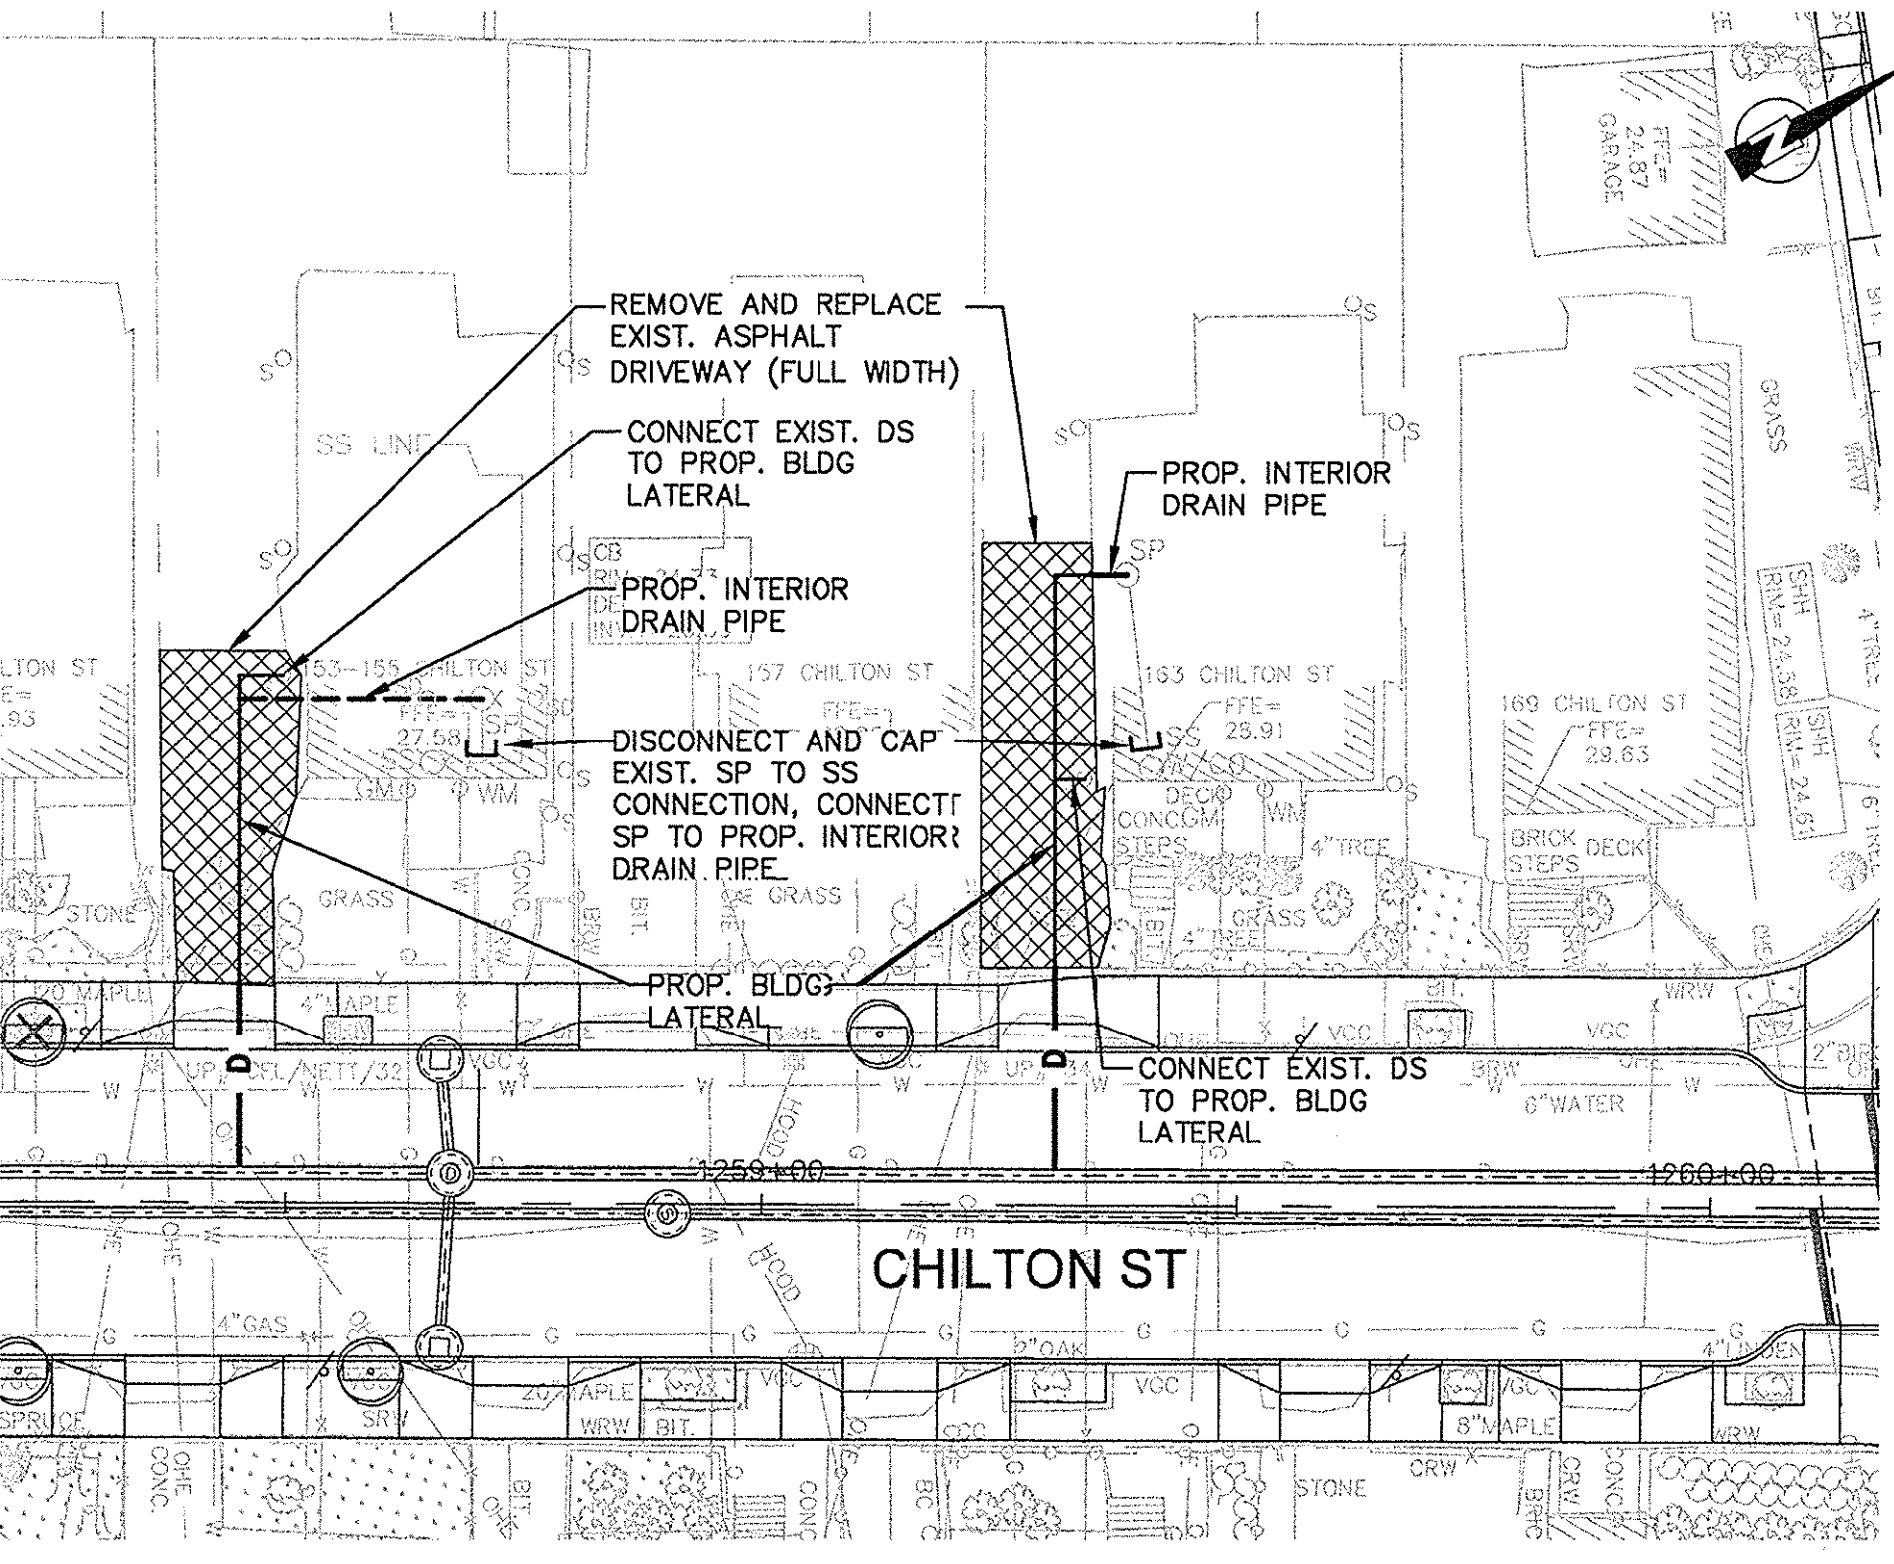


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153-155, 163 CHILTON ST

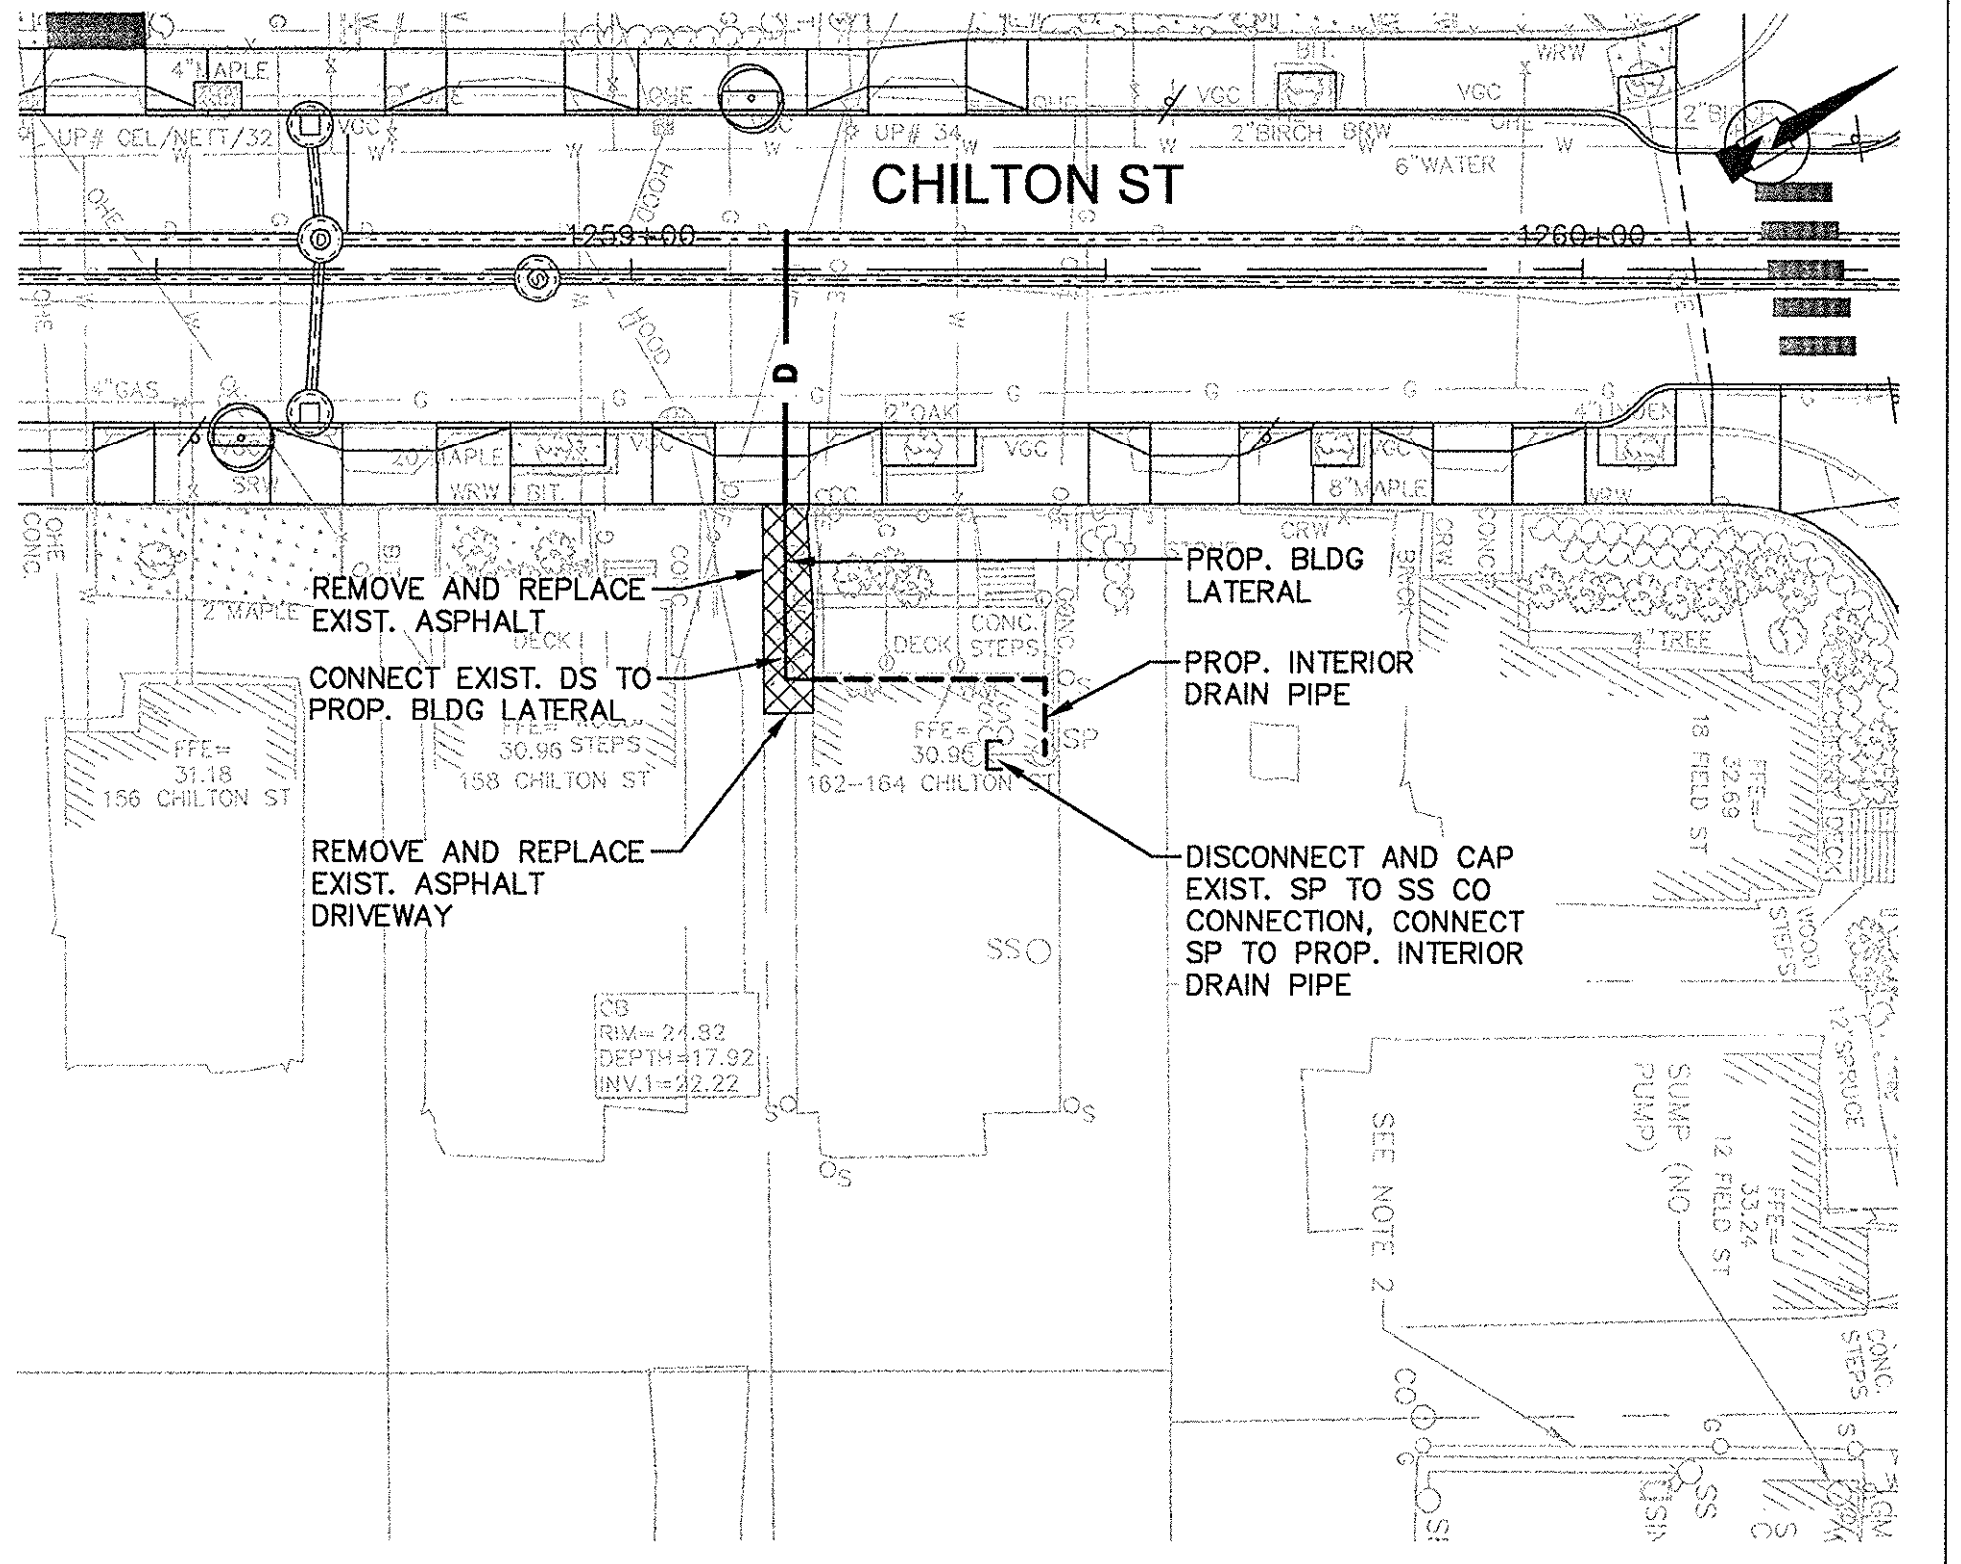

PLAN NO. 4G
162-164 CHILTON ST

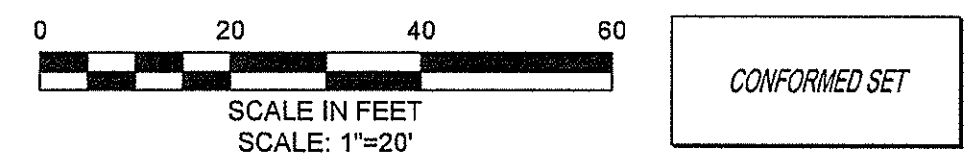

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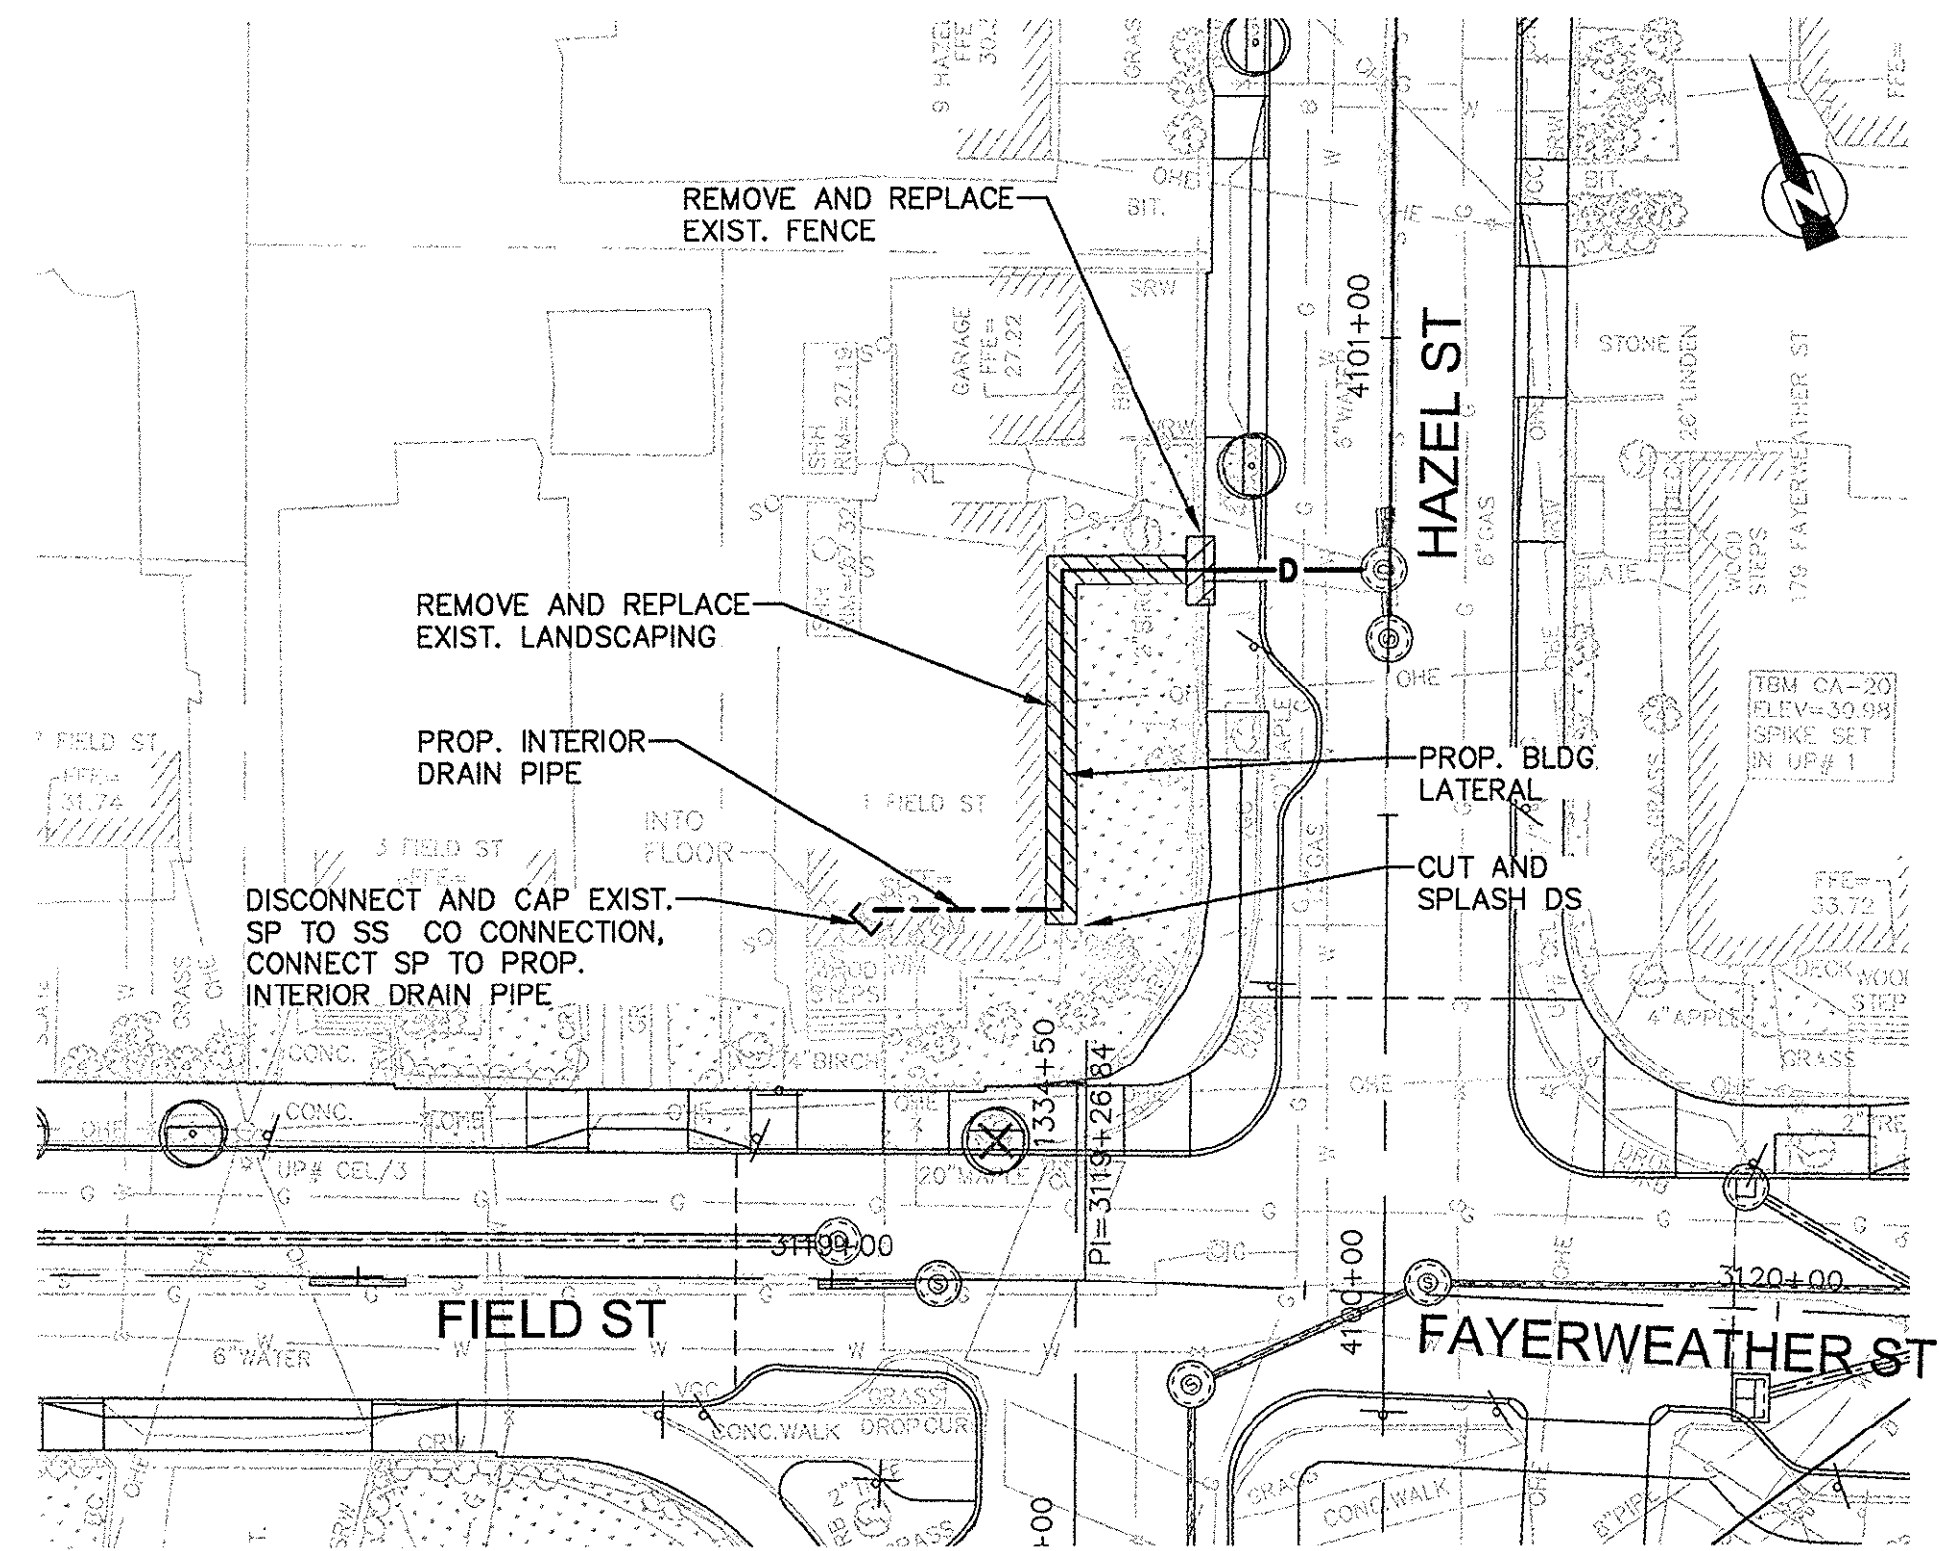

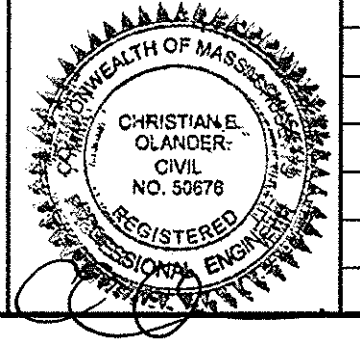
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Job No.	20120256.001A
Designed by	MTD
Drawn by	PBR
Checked by	AML
Approved by	EO




Client	CITY OF CAMBRIDGE, MASSACHUSETTS
Project	CONCORD (CONTRACT 9) SEWER SEPARATION AND SURFACE IMPROVEMENTS PROJECT
Drawing	CIVIL - PRIVATE INFLOW REMOVAL PLAN NO. 4


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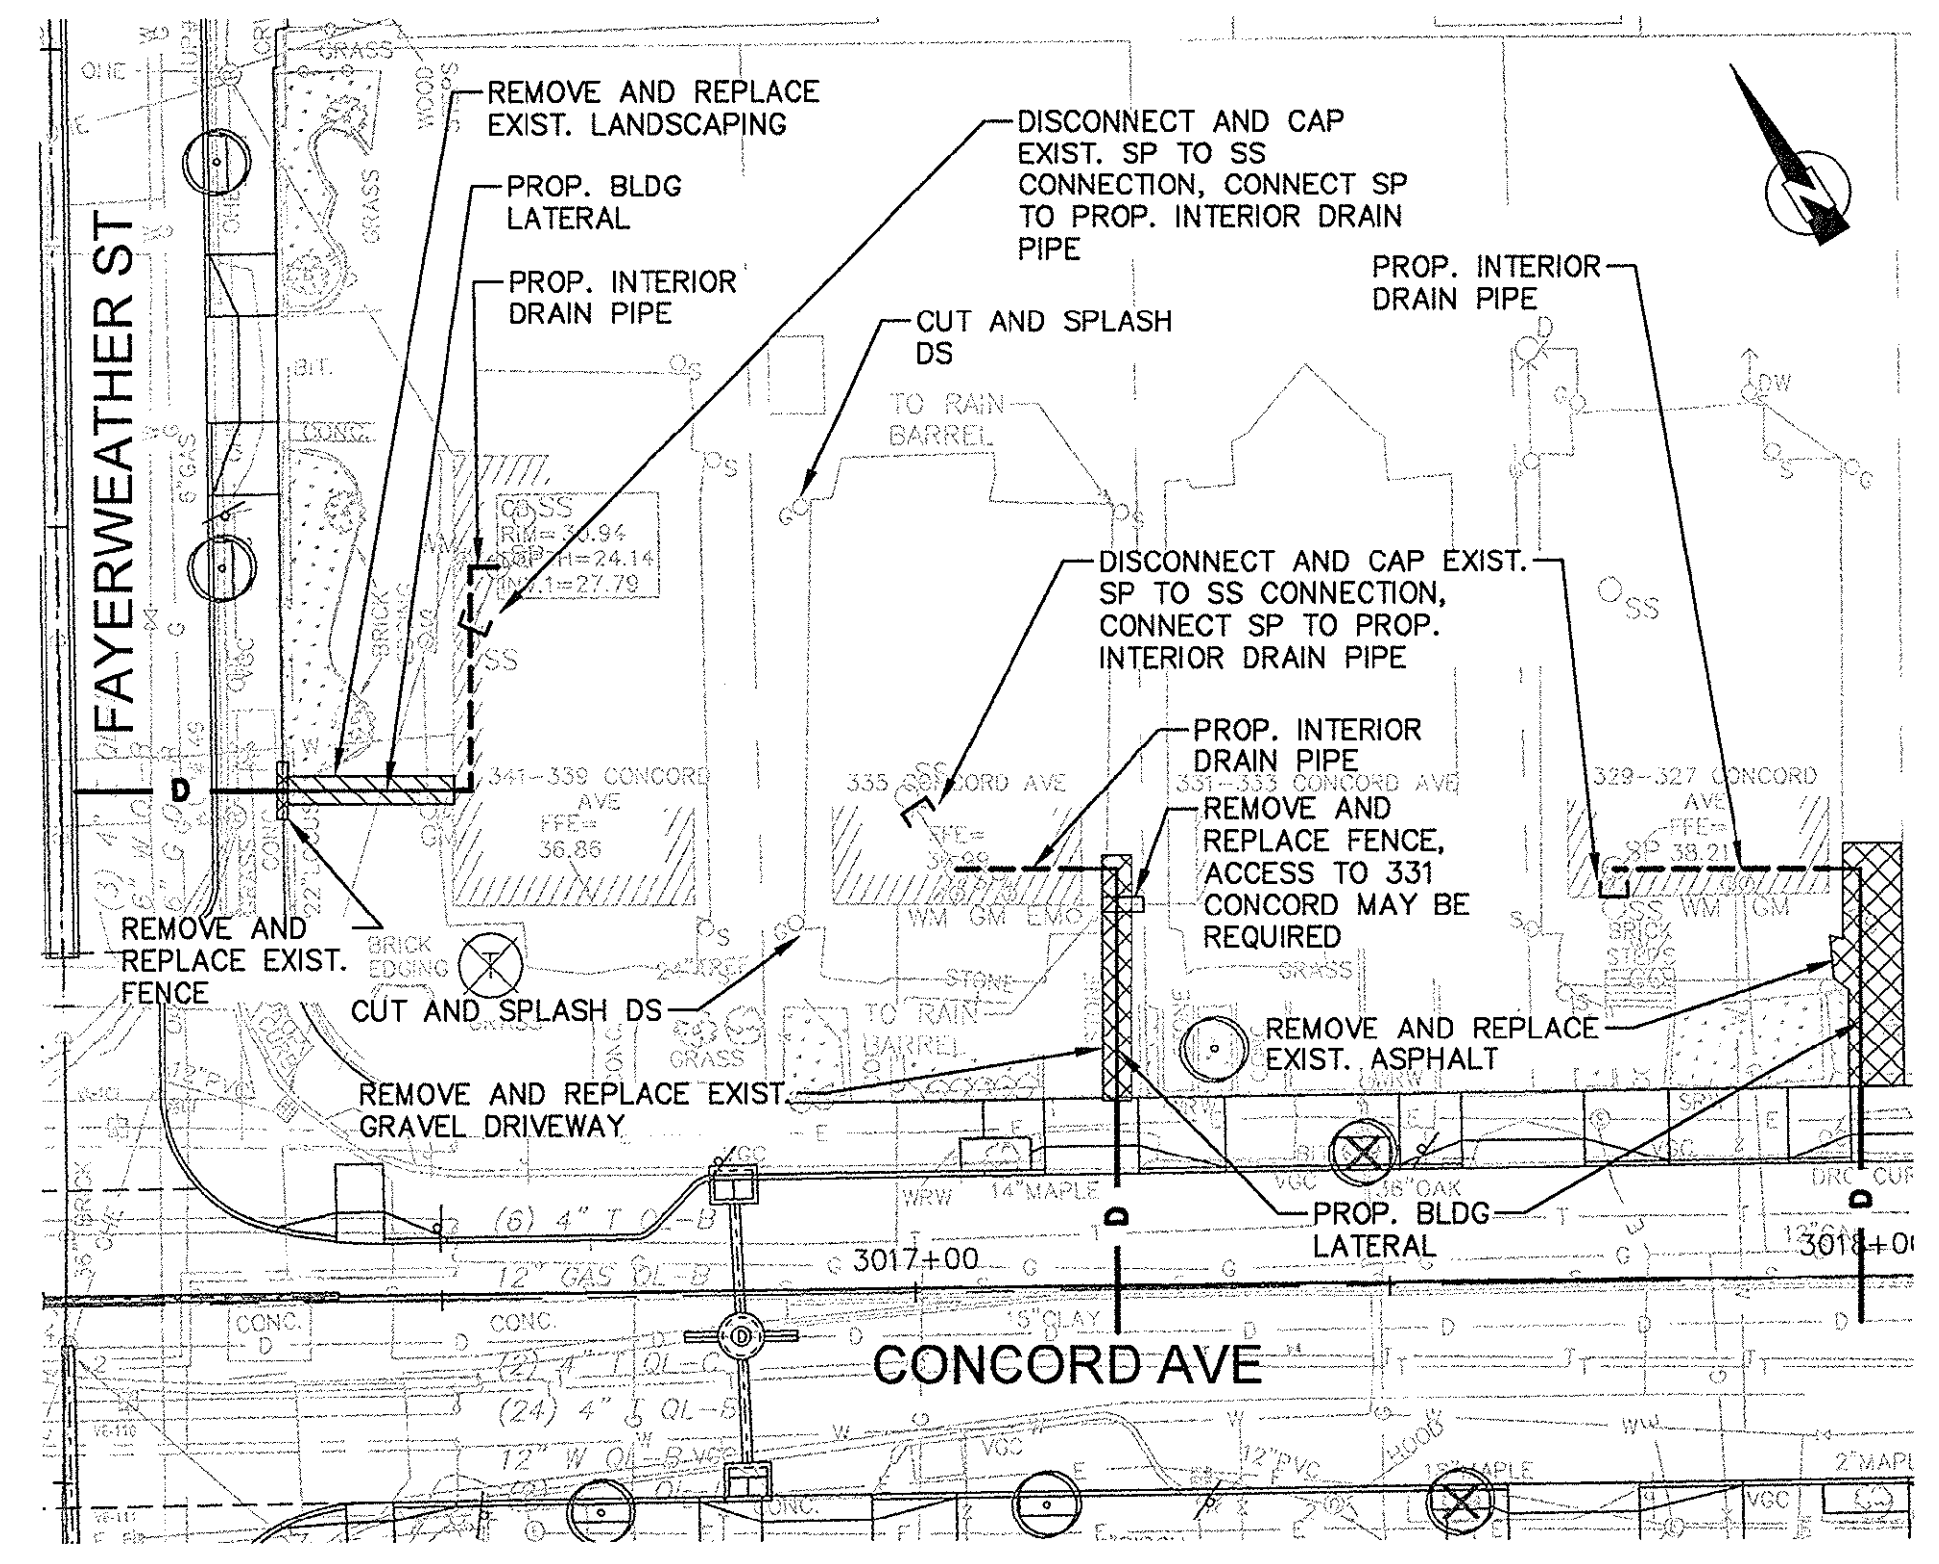
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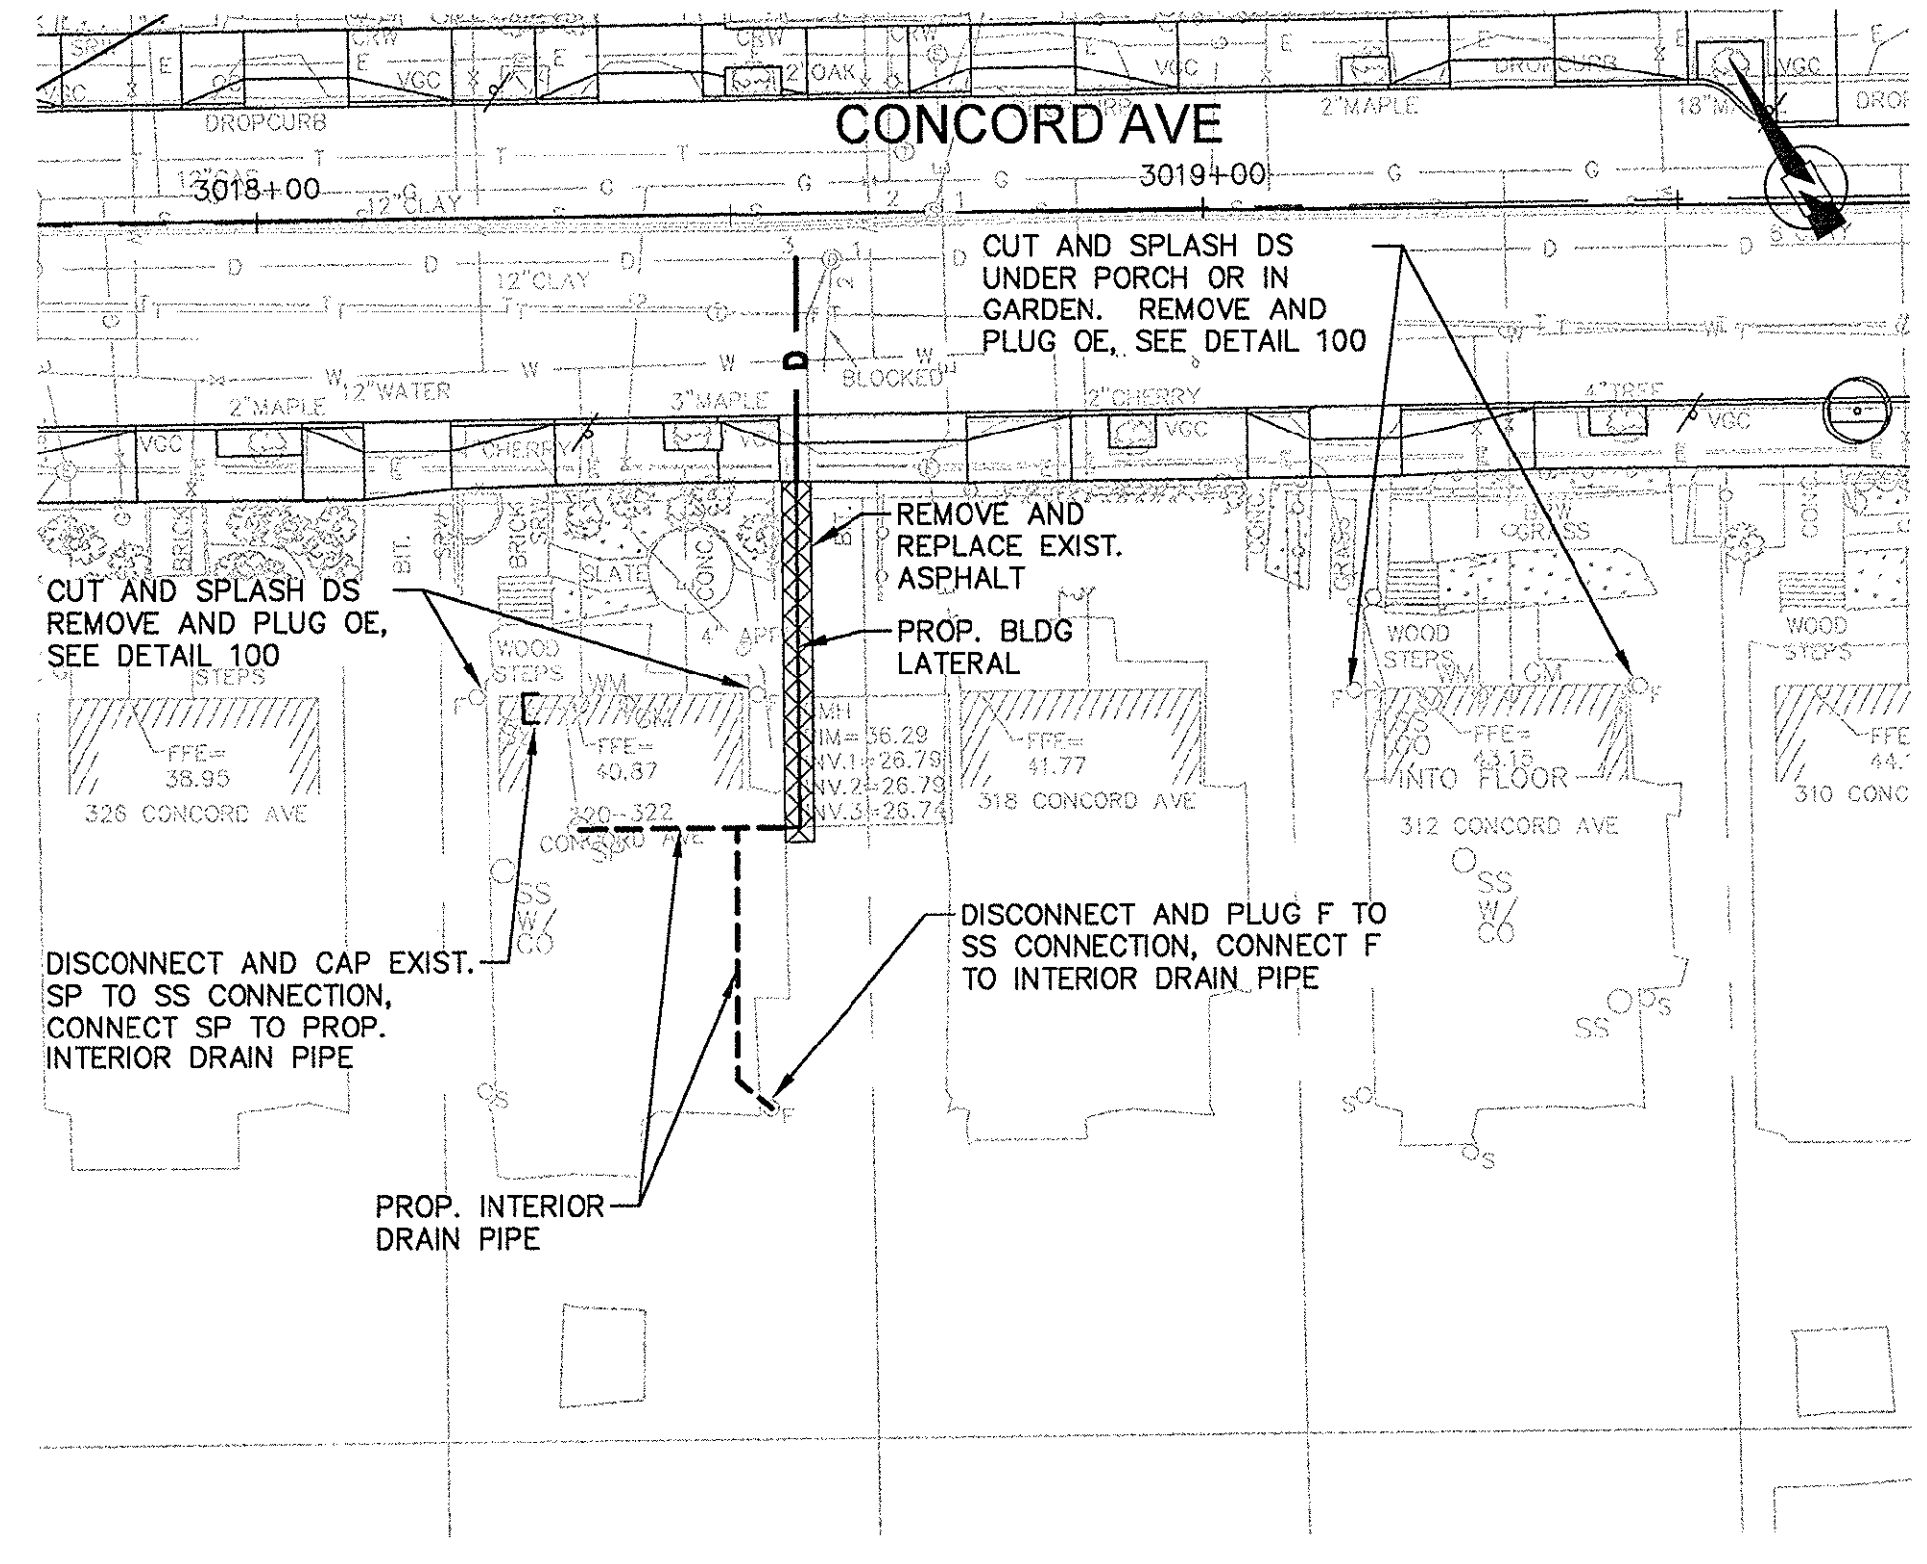
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8 FIELD ST




PLAN NO. 5C
172 FAYERWEATHER ST

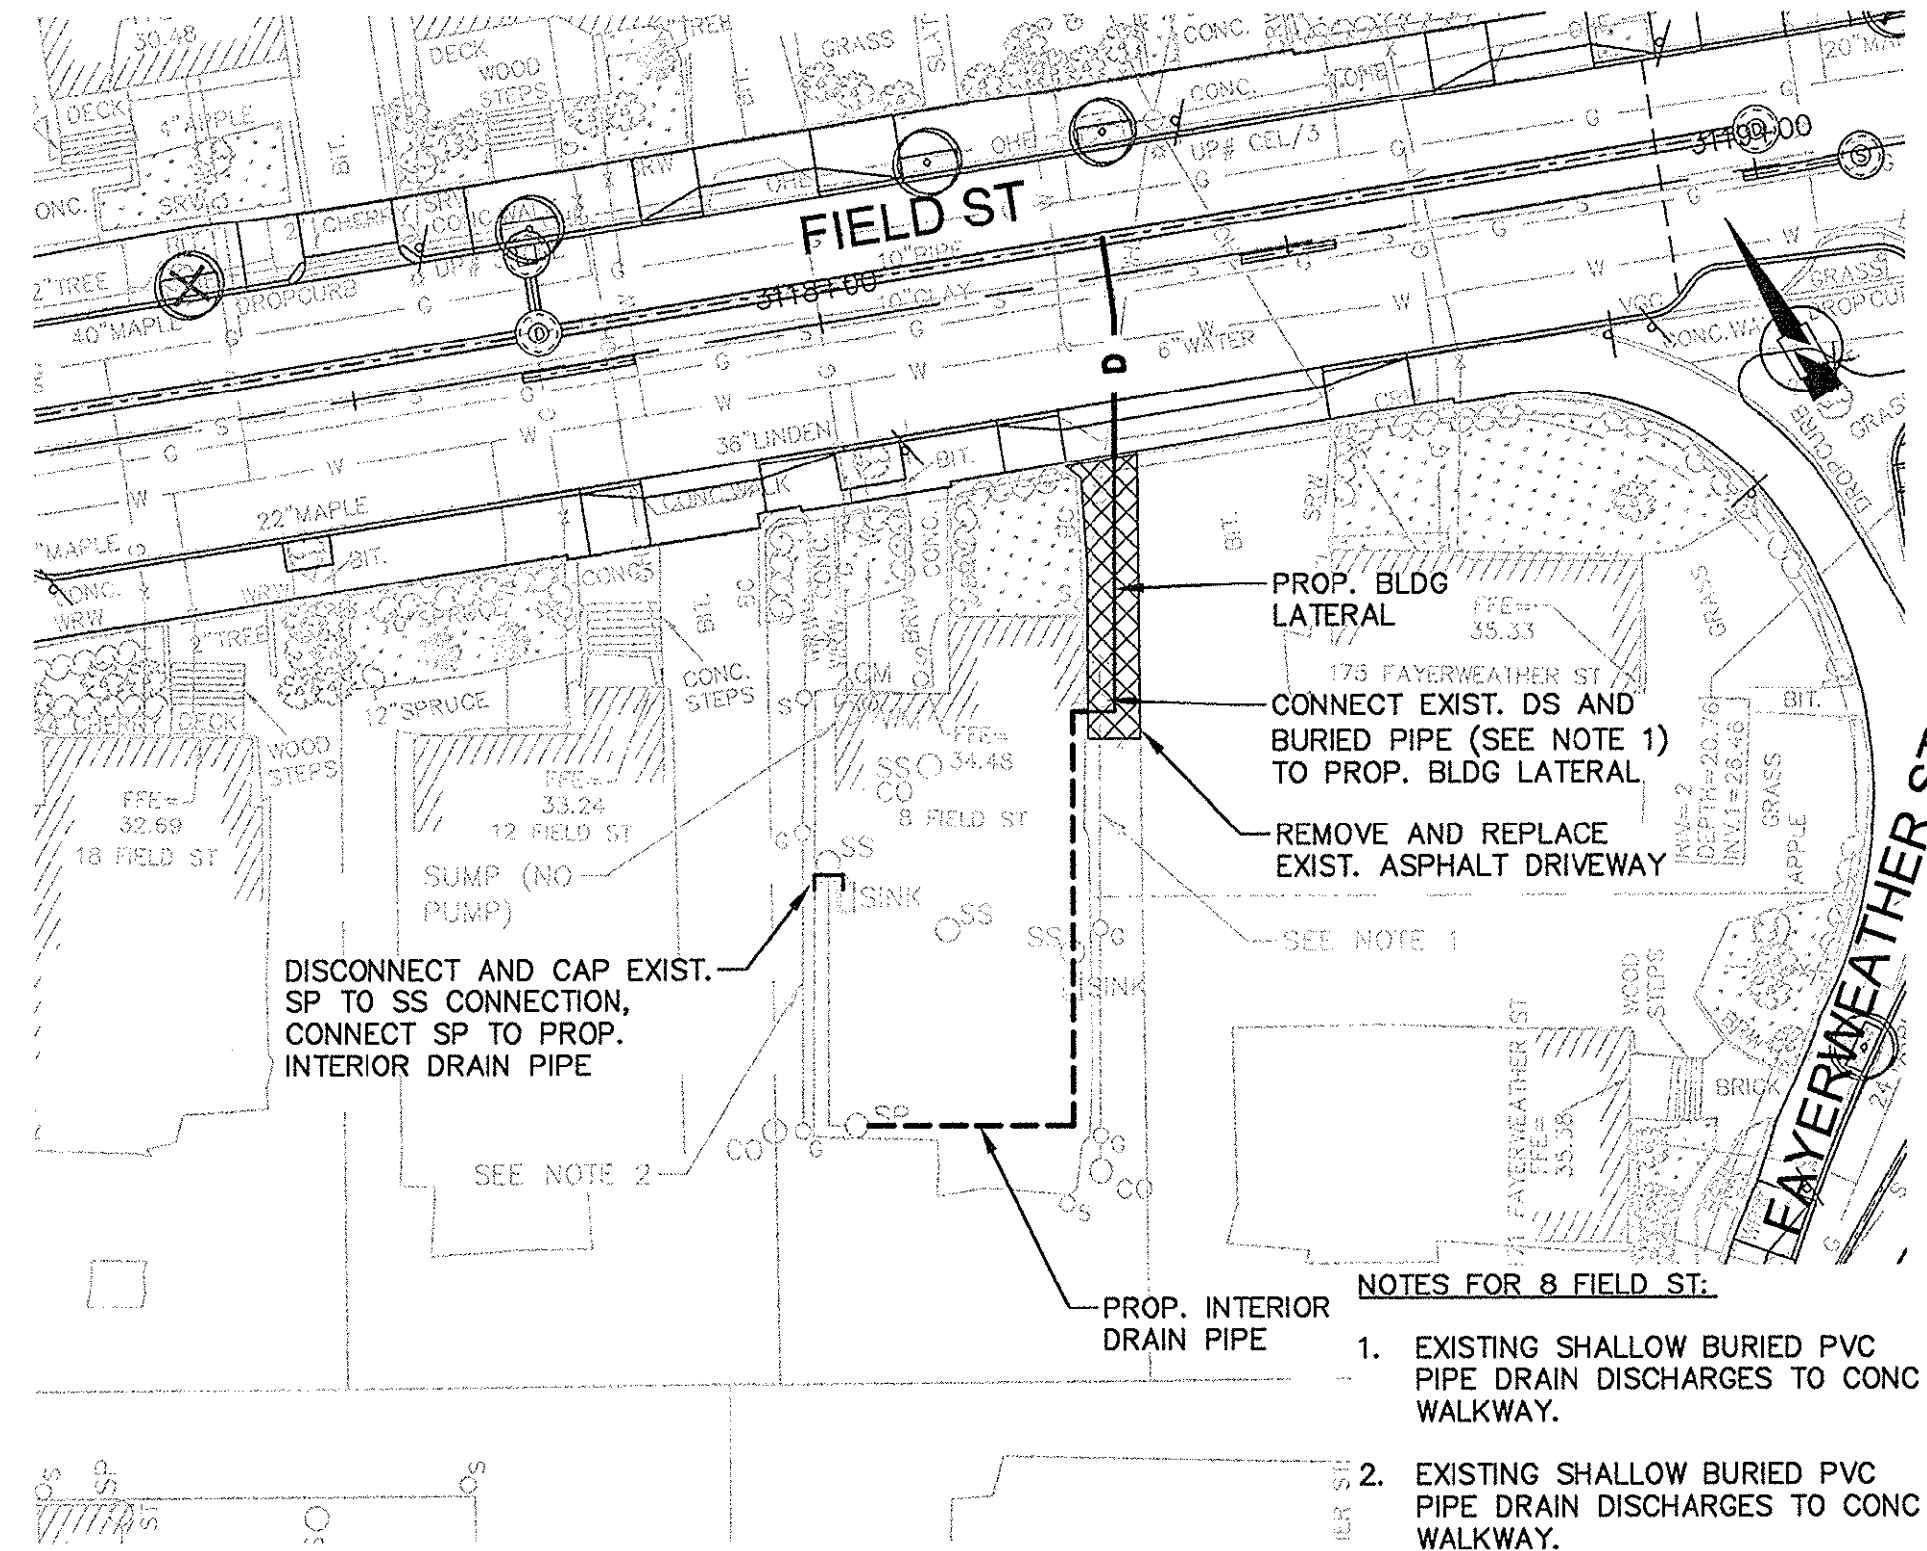

PLAN NO. 5D/E/F
339-341, 335, 327-329 CONCORD AVE

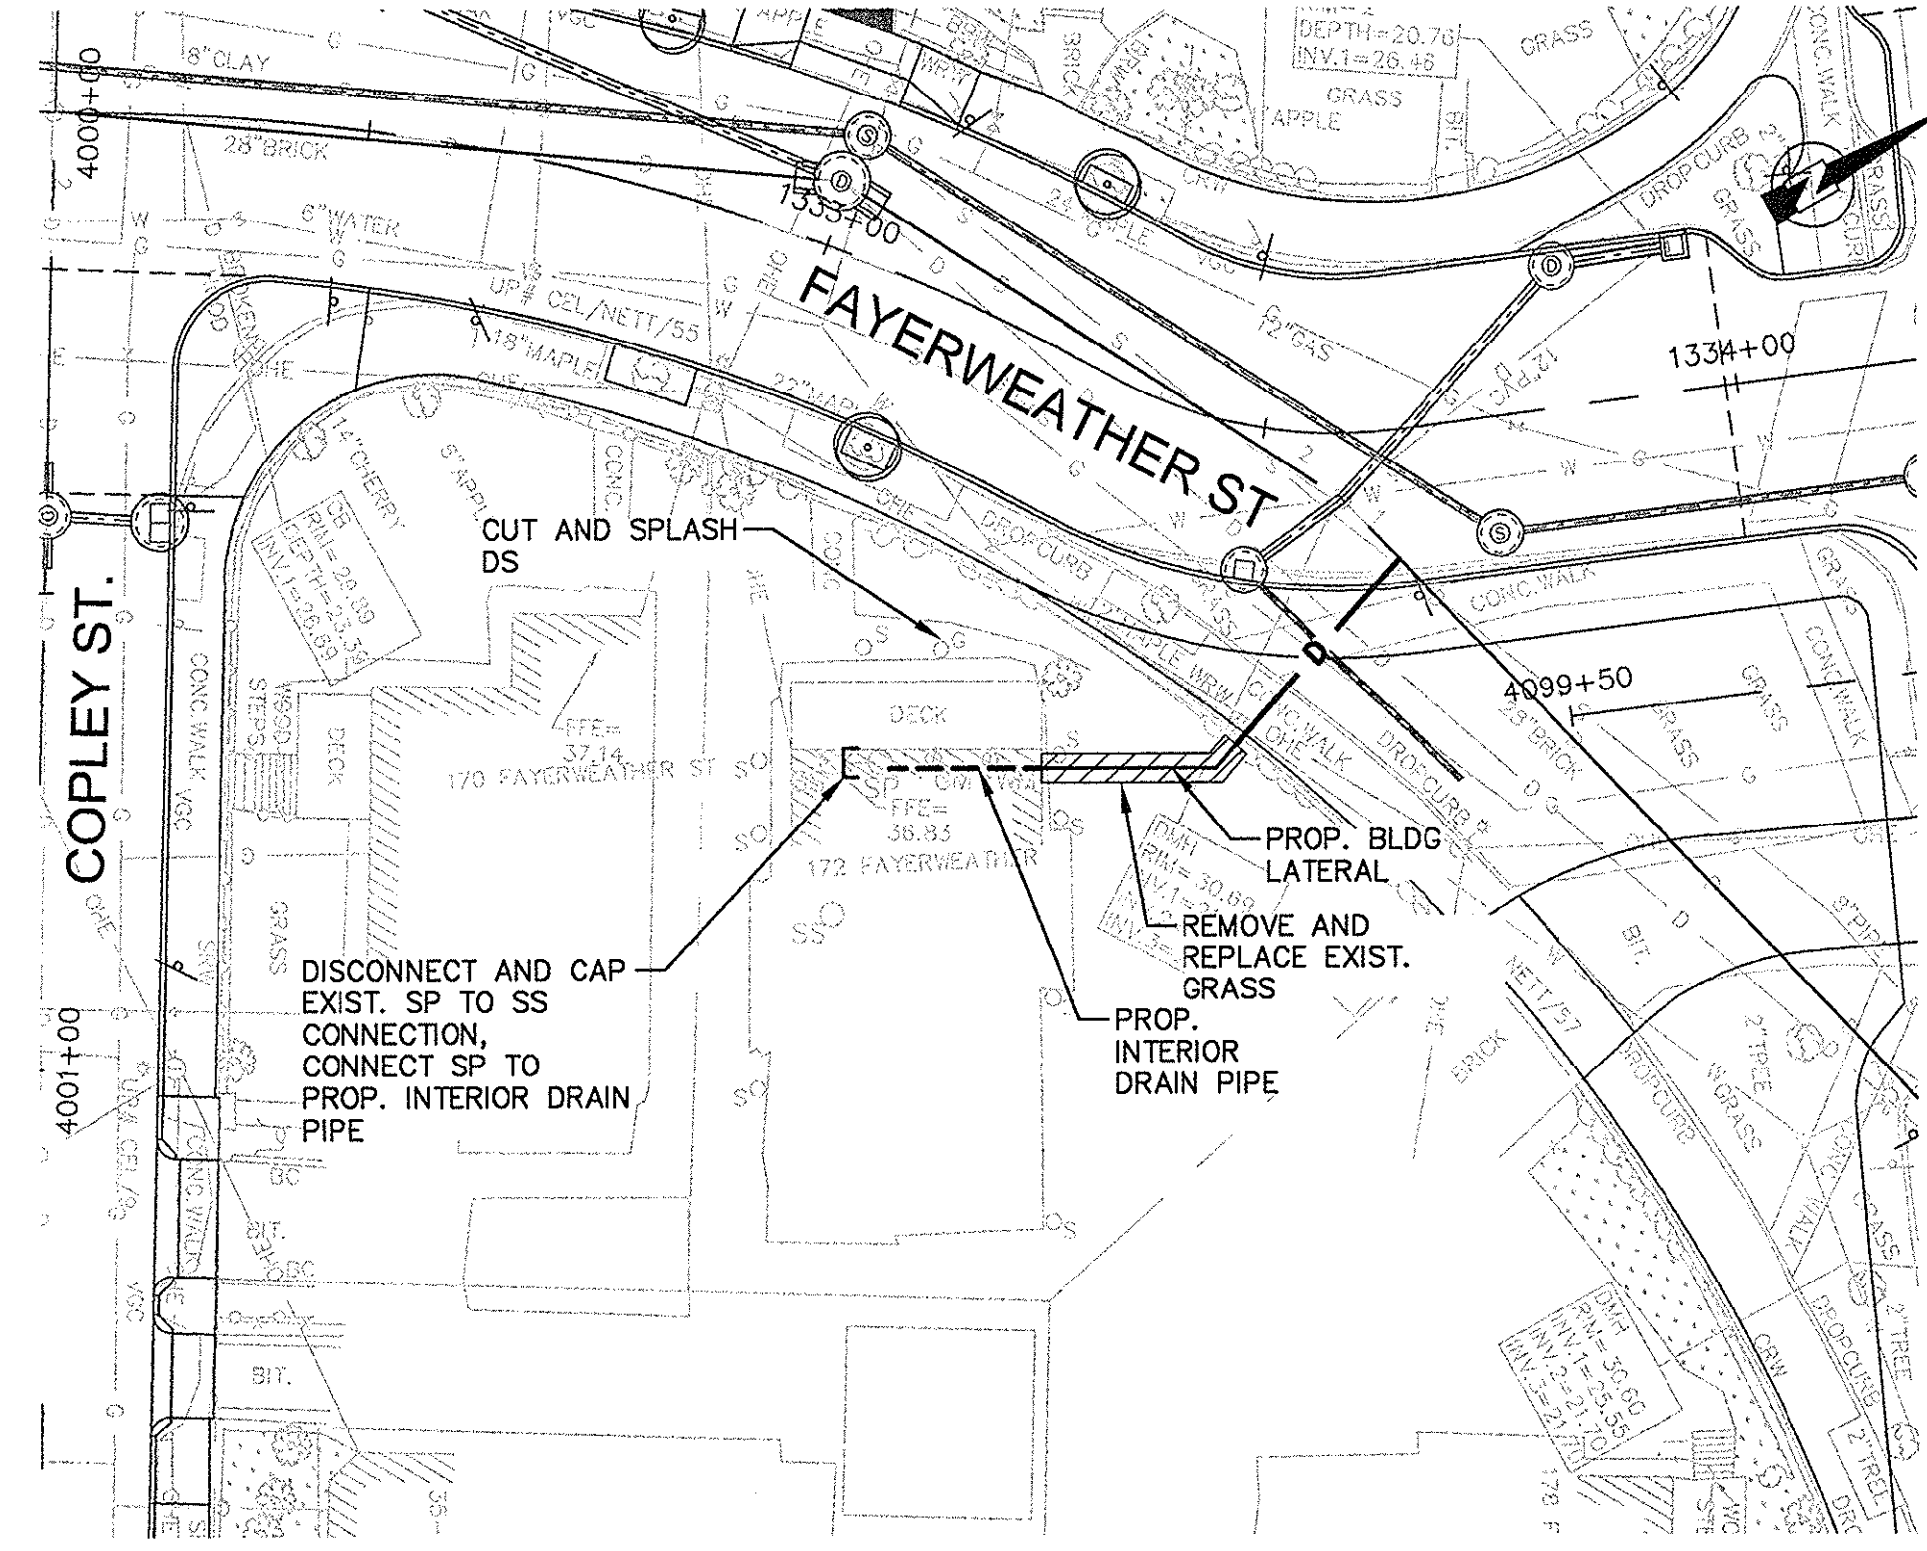


PLAN NO. 5G/H
320-322, 312 CONCORD AVE

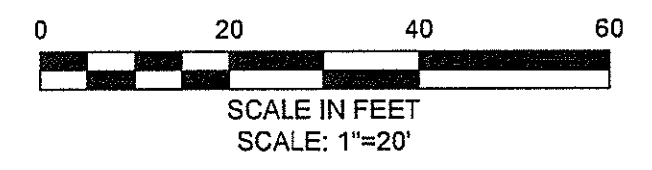


CONFORMED SET

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CAD FILE: C:\pwworking\1030830209_CP07.dwg LAYOUT: CP-7

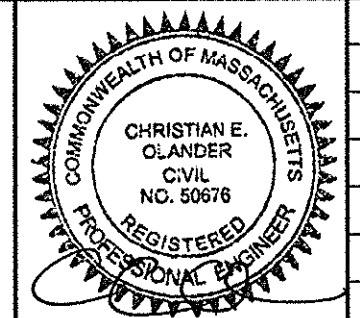


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Date	JANUARY 27, 2014		
Job No.	20120256.001A		
Designed by	MTD		
Drawn by	PBR		
Checked by	AML	No.	Description
Approved by	EO		REVISIONS

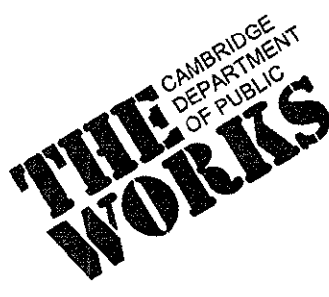

Client	CITY OF CAMBRIDGE, MASSACHUSETTS
Project	CONCORD (CONTRACT 9) SEWER SEPARATION AND SURFACE IMPROVEMENTS PROJECT
Drawing	CIVIL - PRIVATE INFLOW REMOVAL PLAN NO. 5


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File No.	

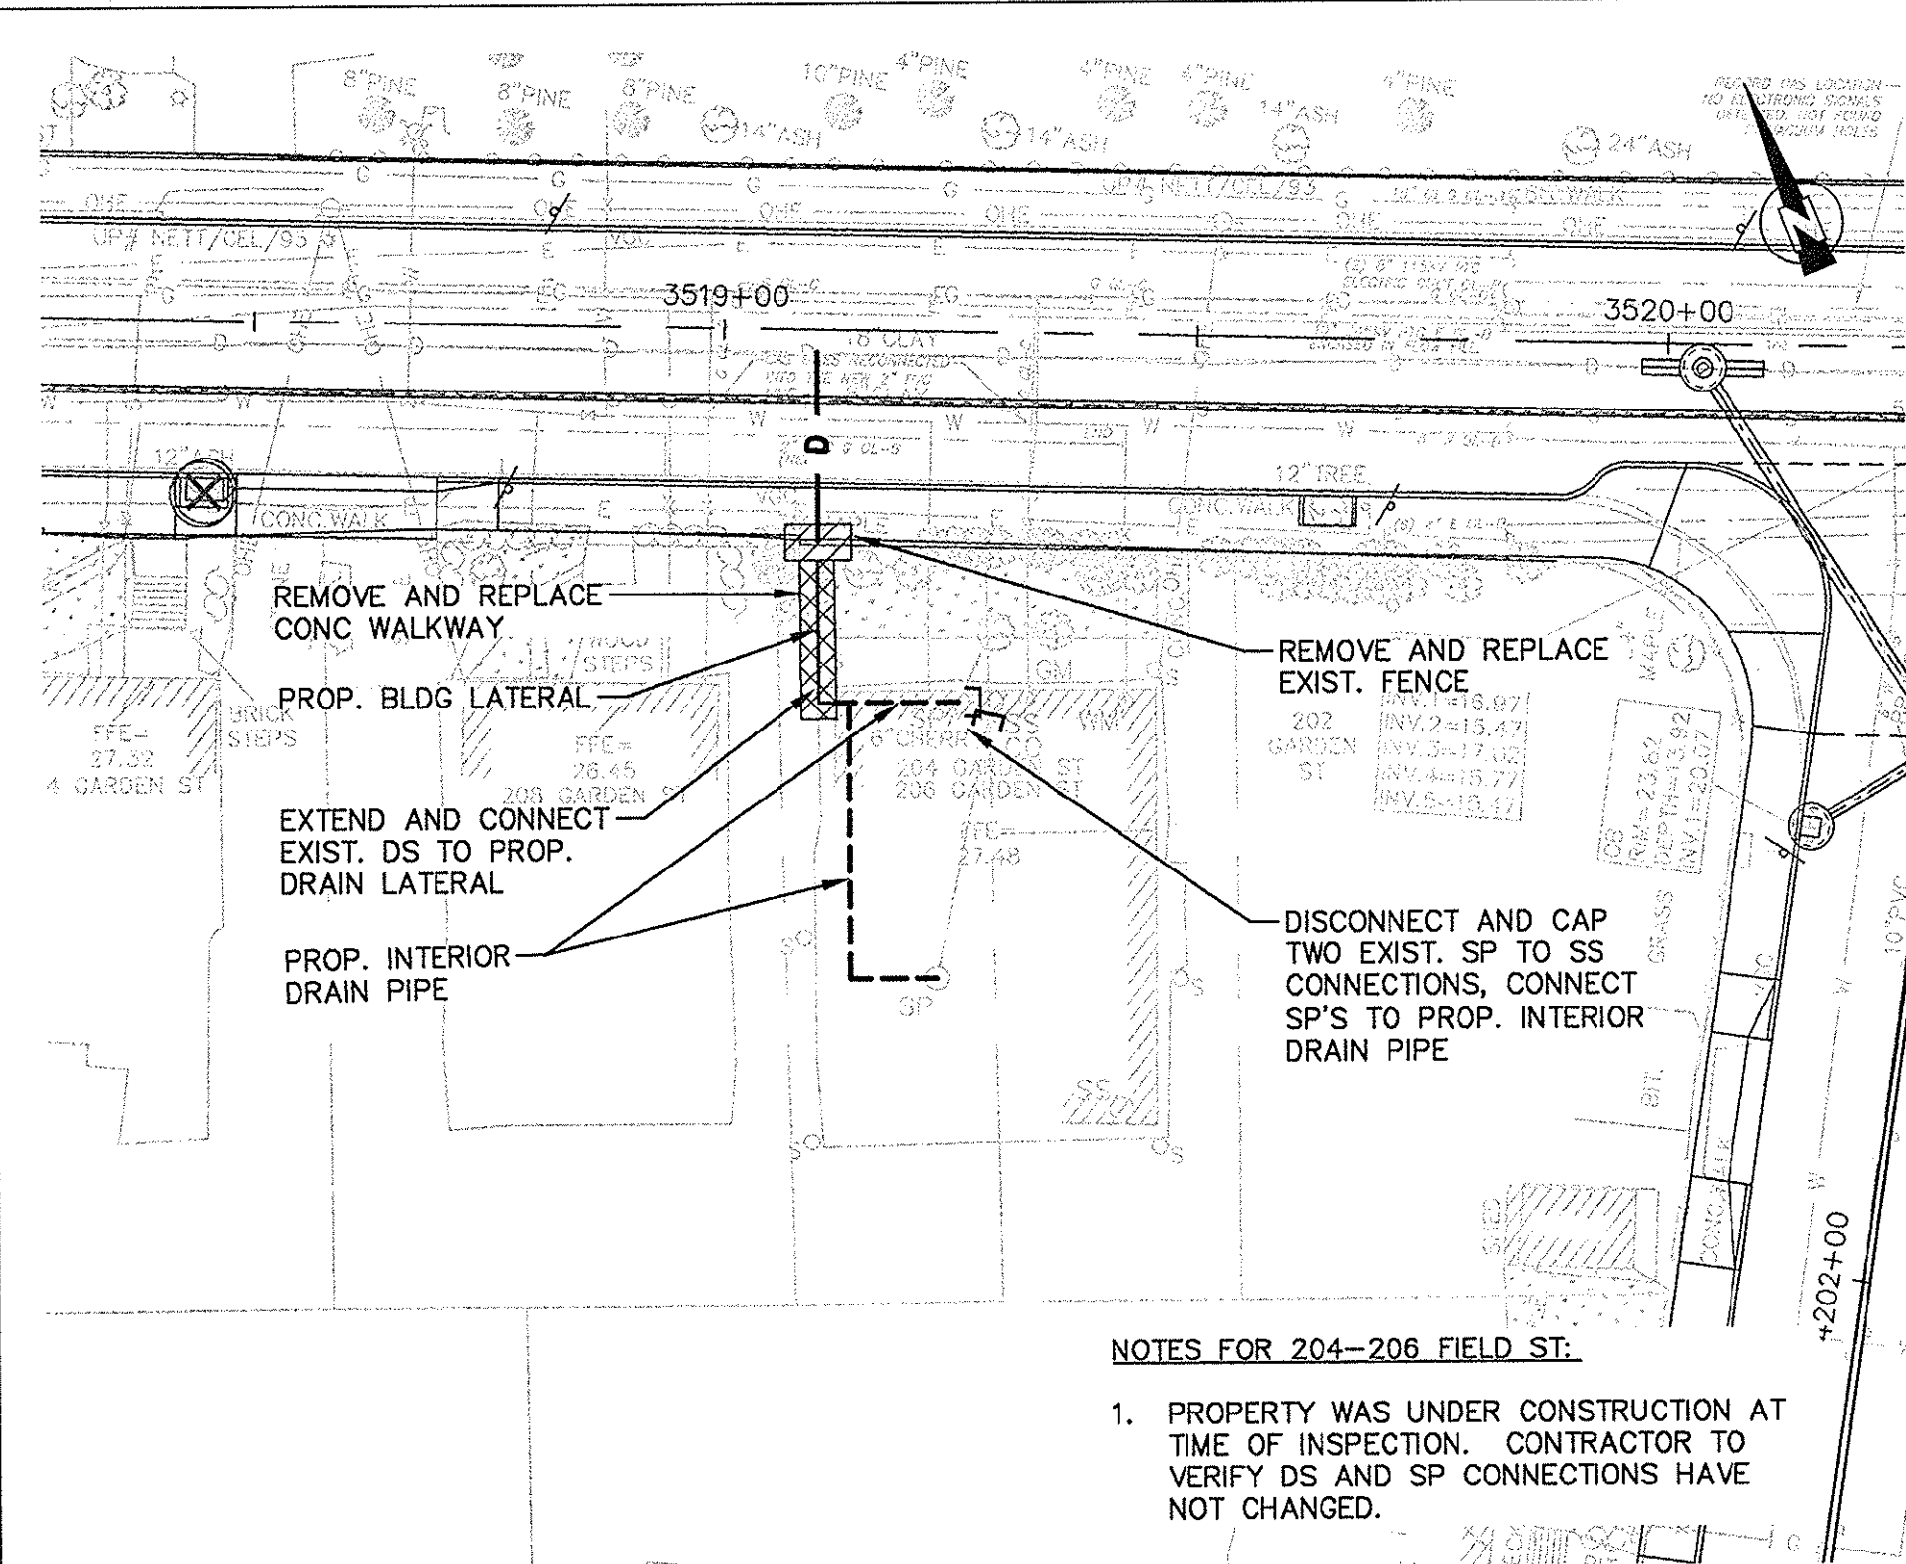


NOTES FOR 204-206 FIELD ST.

- PROPERTY WAS UNDER CONSTRUCTION AT TIME OF INSPECTION. CONTRACTOR TO VERIFY DS AND SP CONNECTIONS HAVE NOT CHANGED.

PLAN NO. 6A
204-206 GARDEN ST

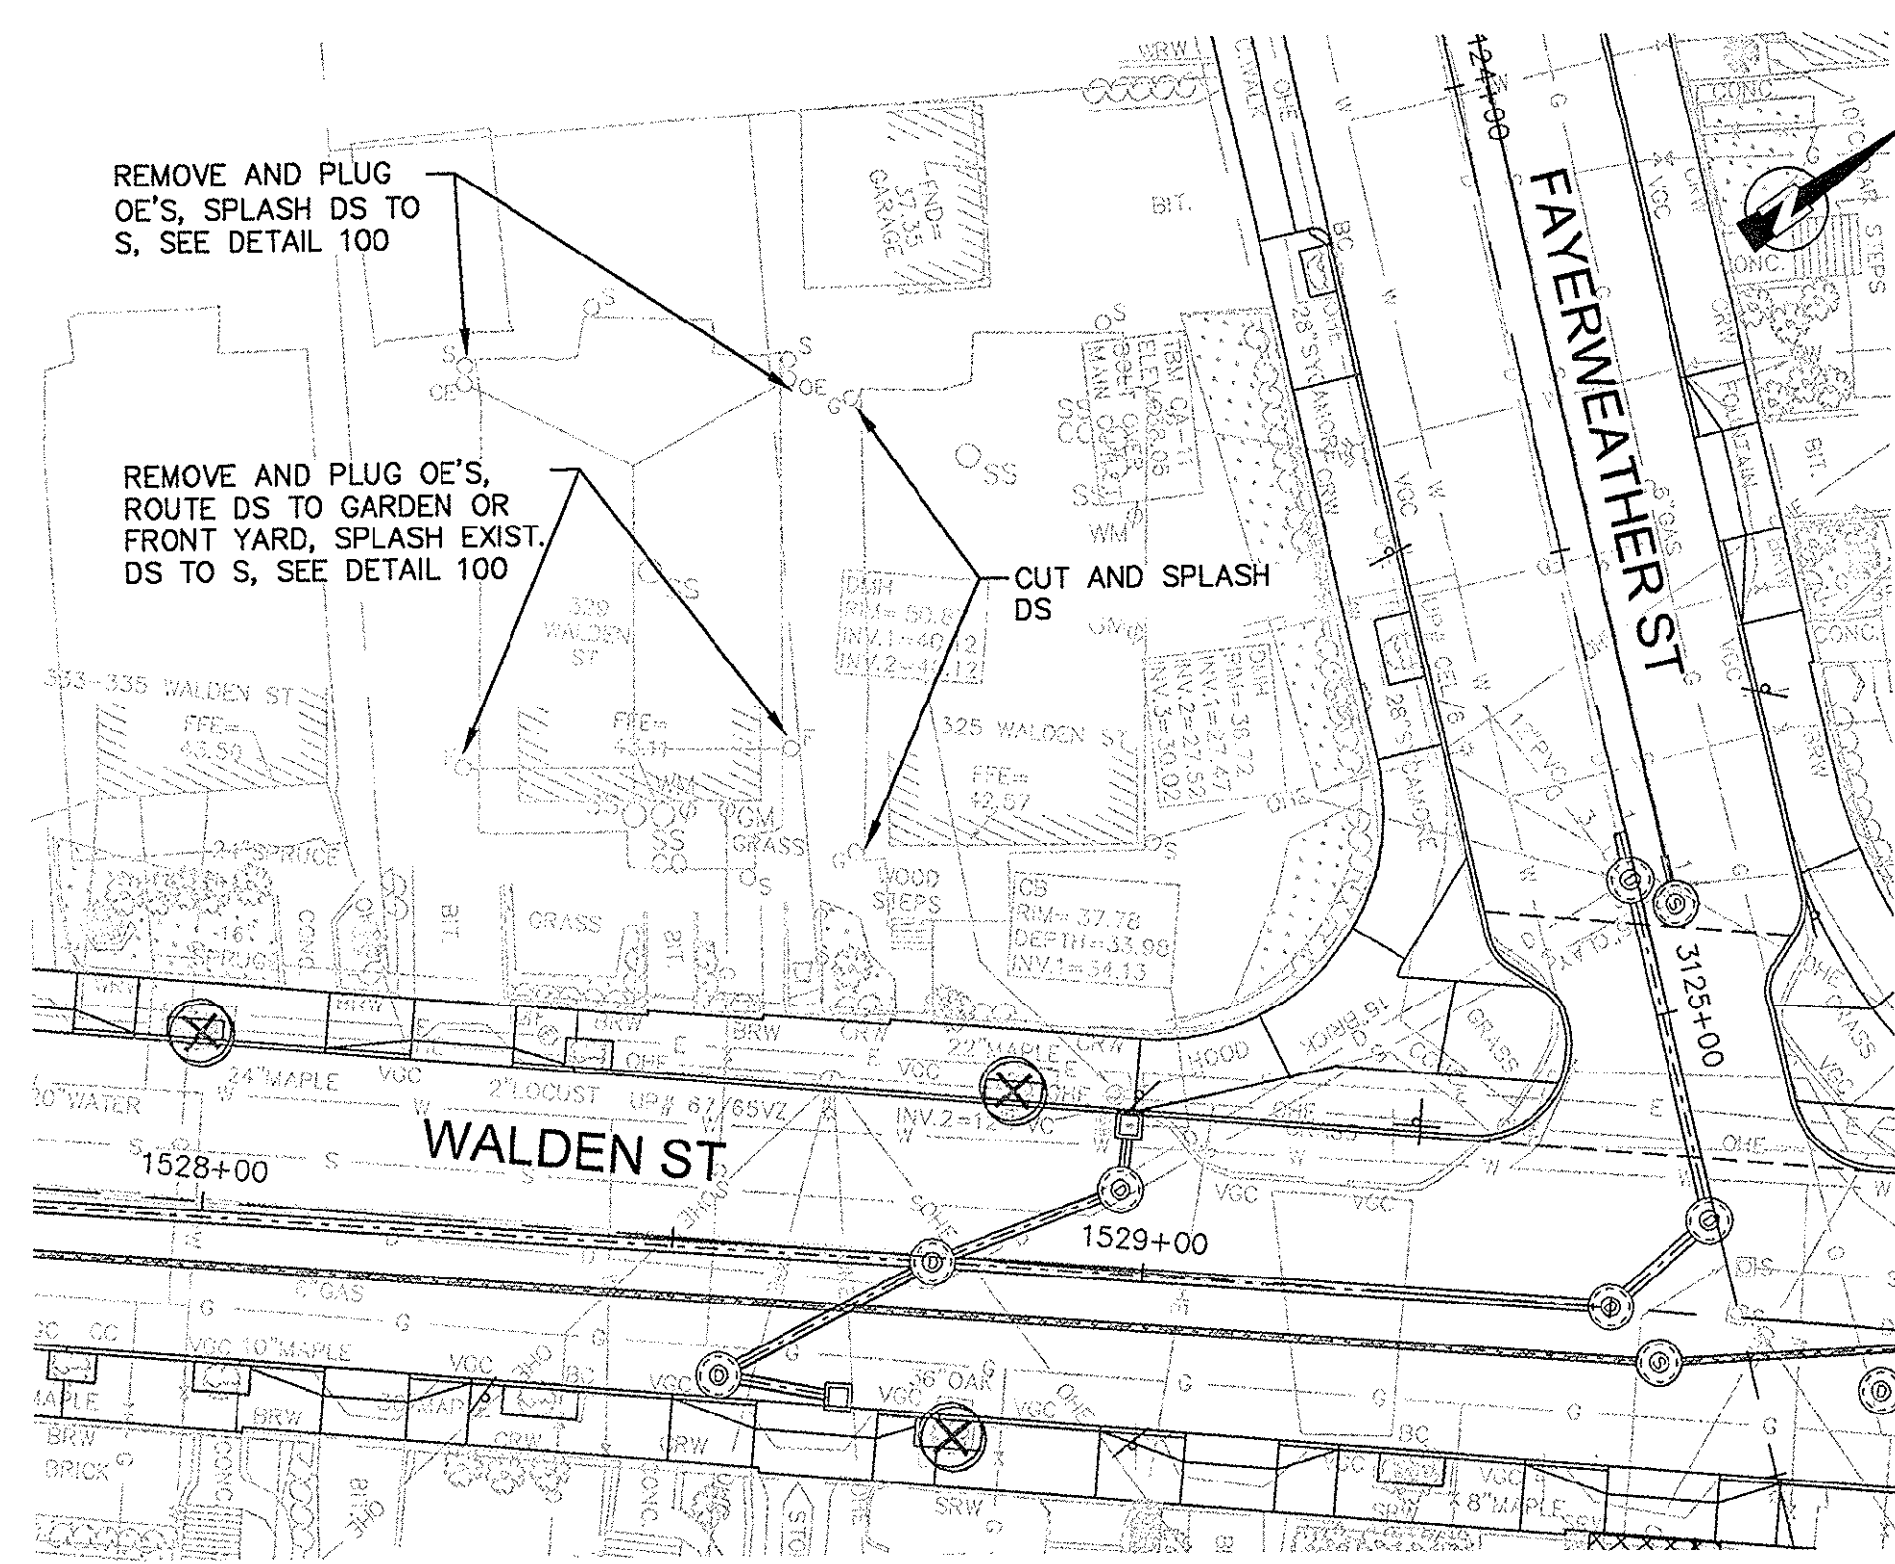


PLAN NO. 6B/C
325 & 329 WALDEN ST

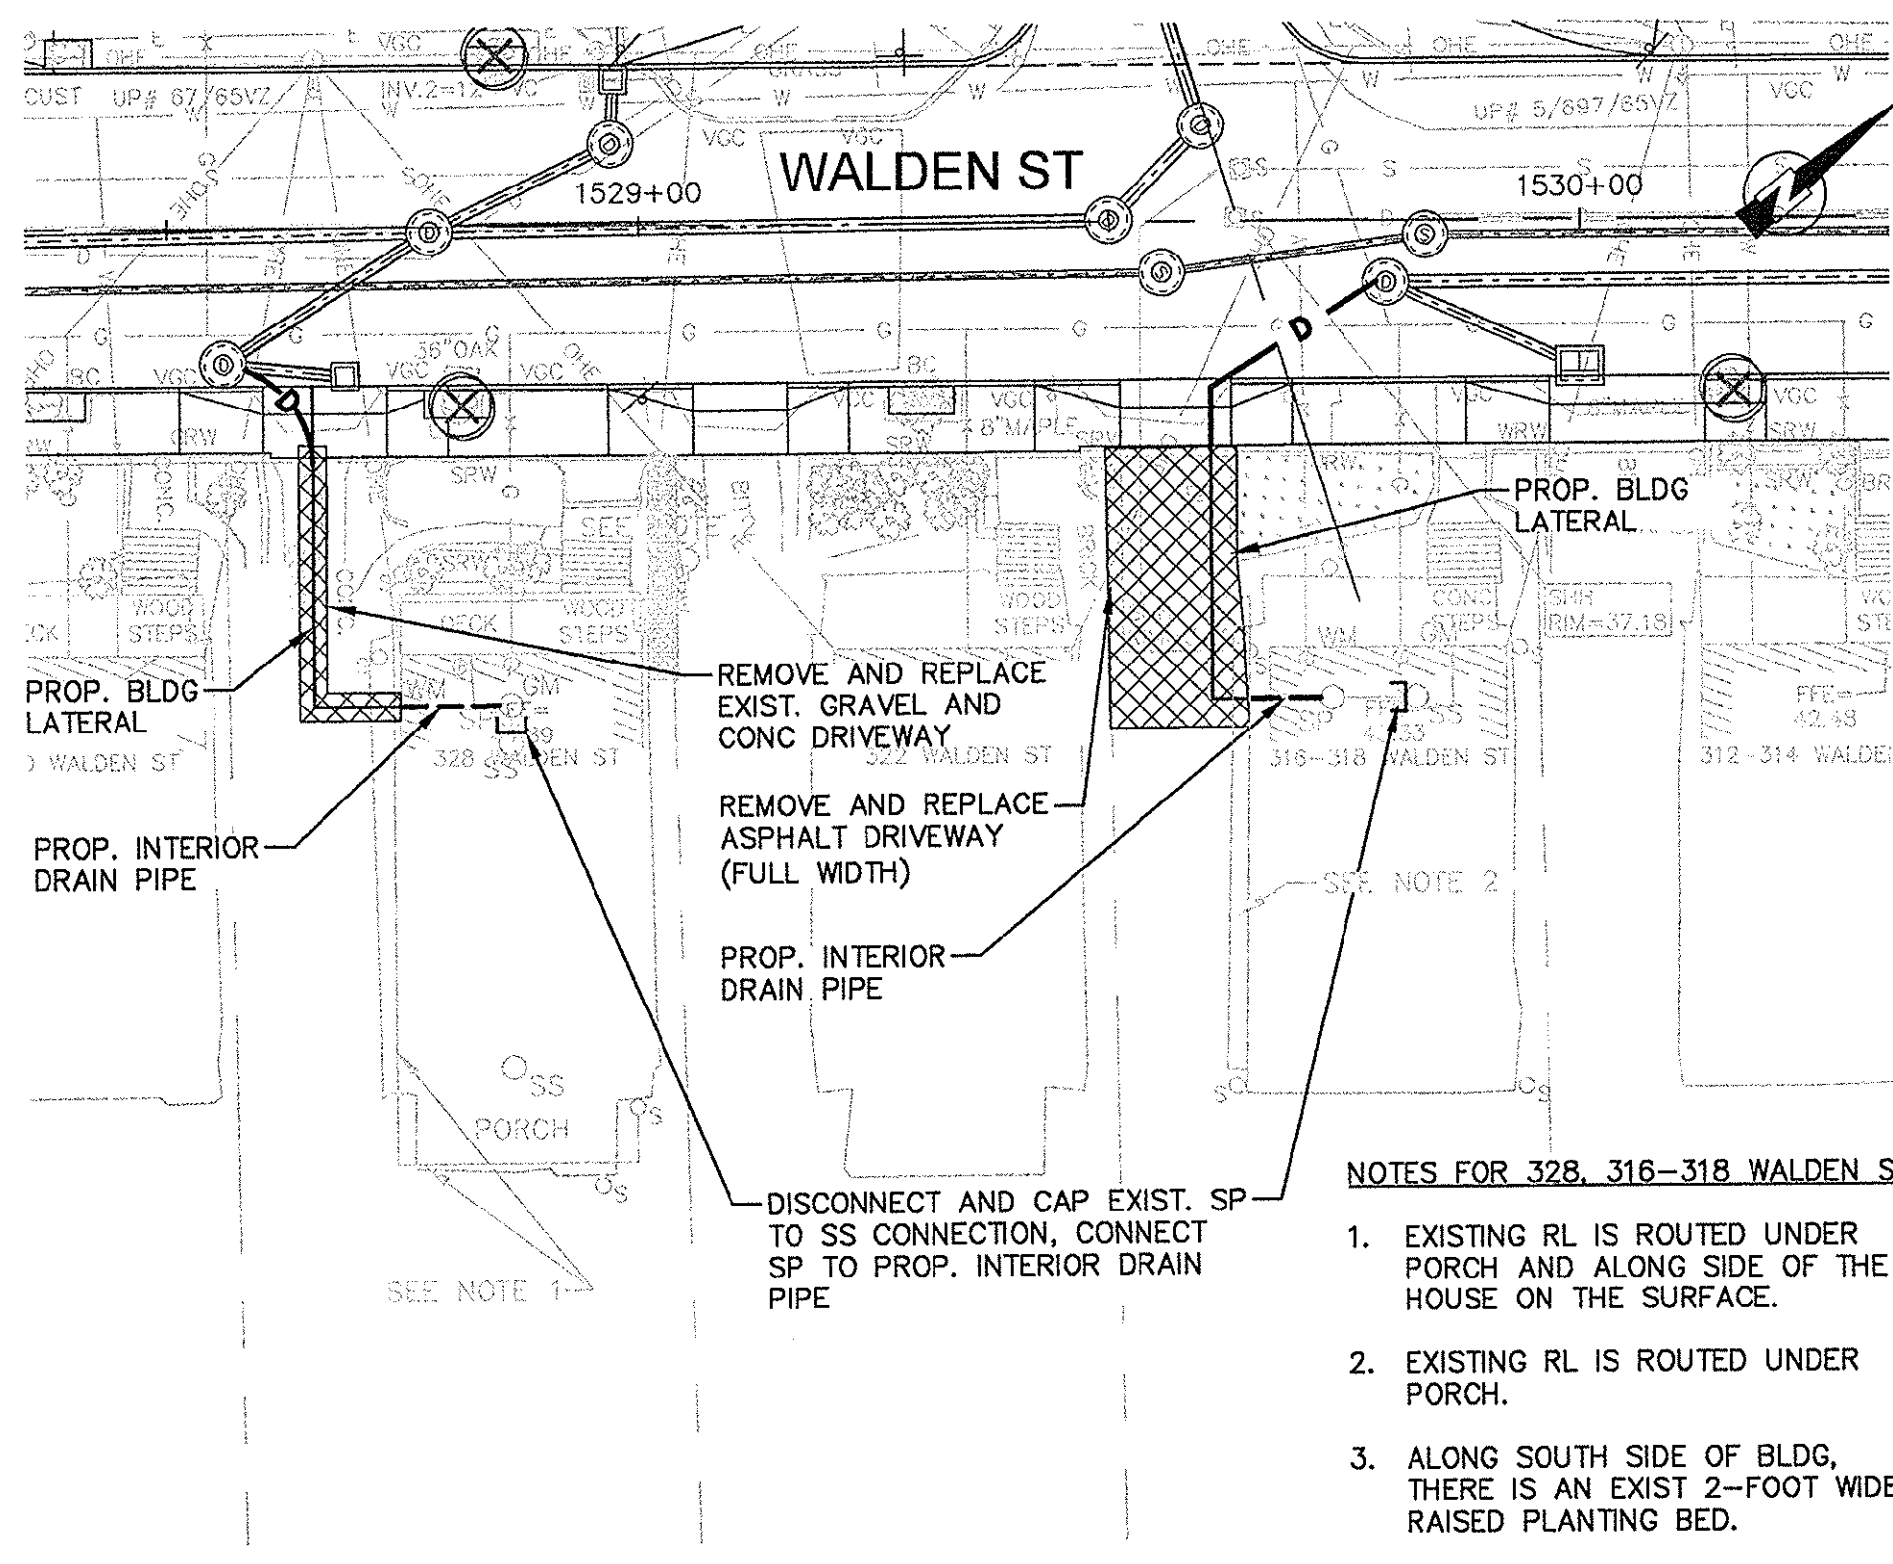


NOTES FOR 328, 316-318 WALDEN ST.

- EXISTING RL IS ROUTED UNDER PORCH AND ALONG SIDE OF THE HOUSE ON THE SURFACE.
- EXISTING RL IS ROUTED UNDER PORCH.
- ALONG SOUTH SIDE OF BLDG, THERE IS AN EXIST 2-FOOT WIDE RAISED PLANTING BED.


PLAN NO. 6D/E
328, 316-318 WALDEN ST

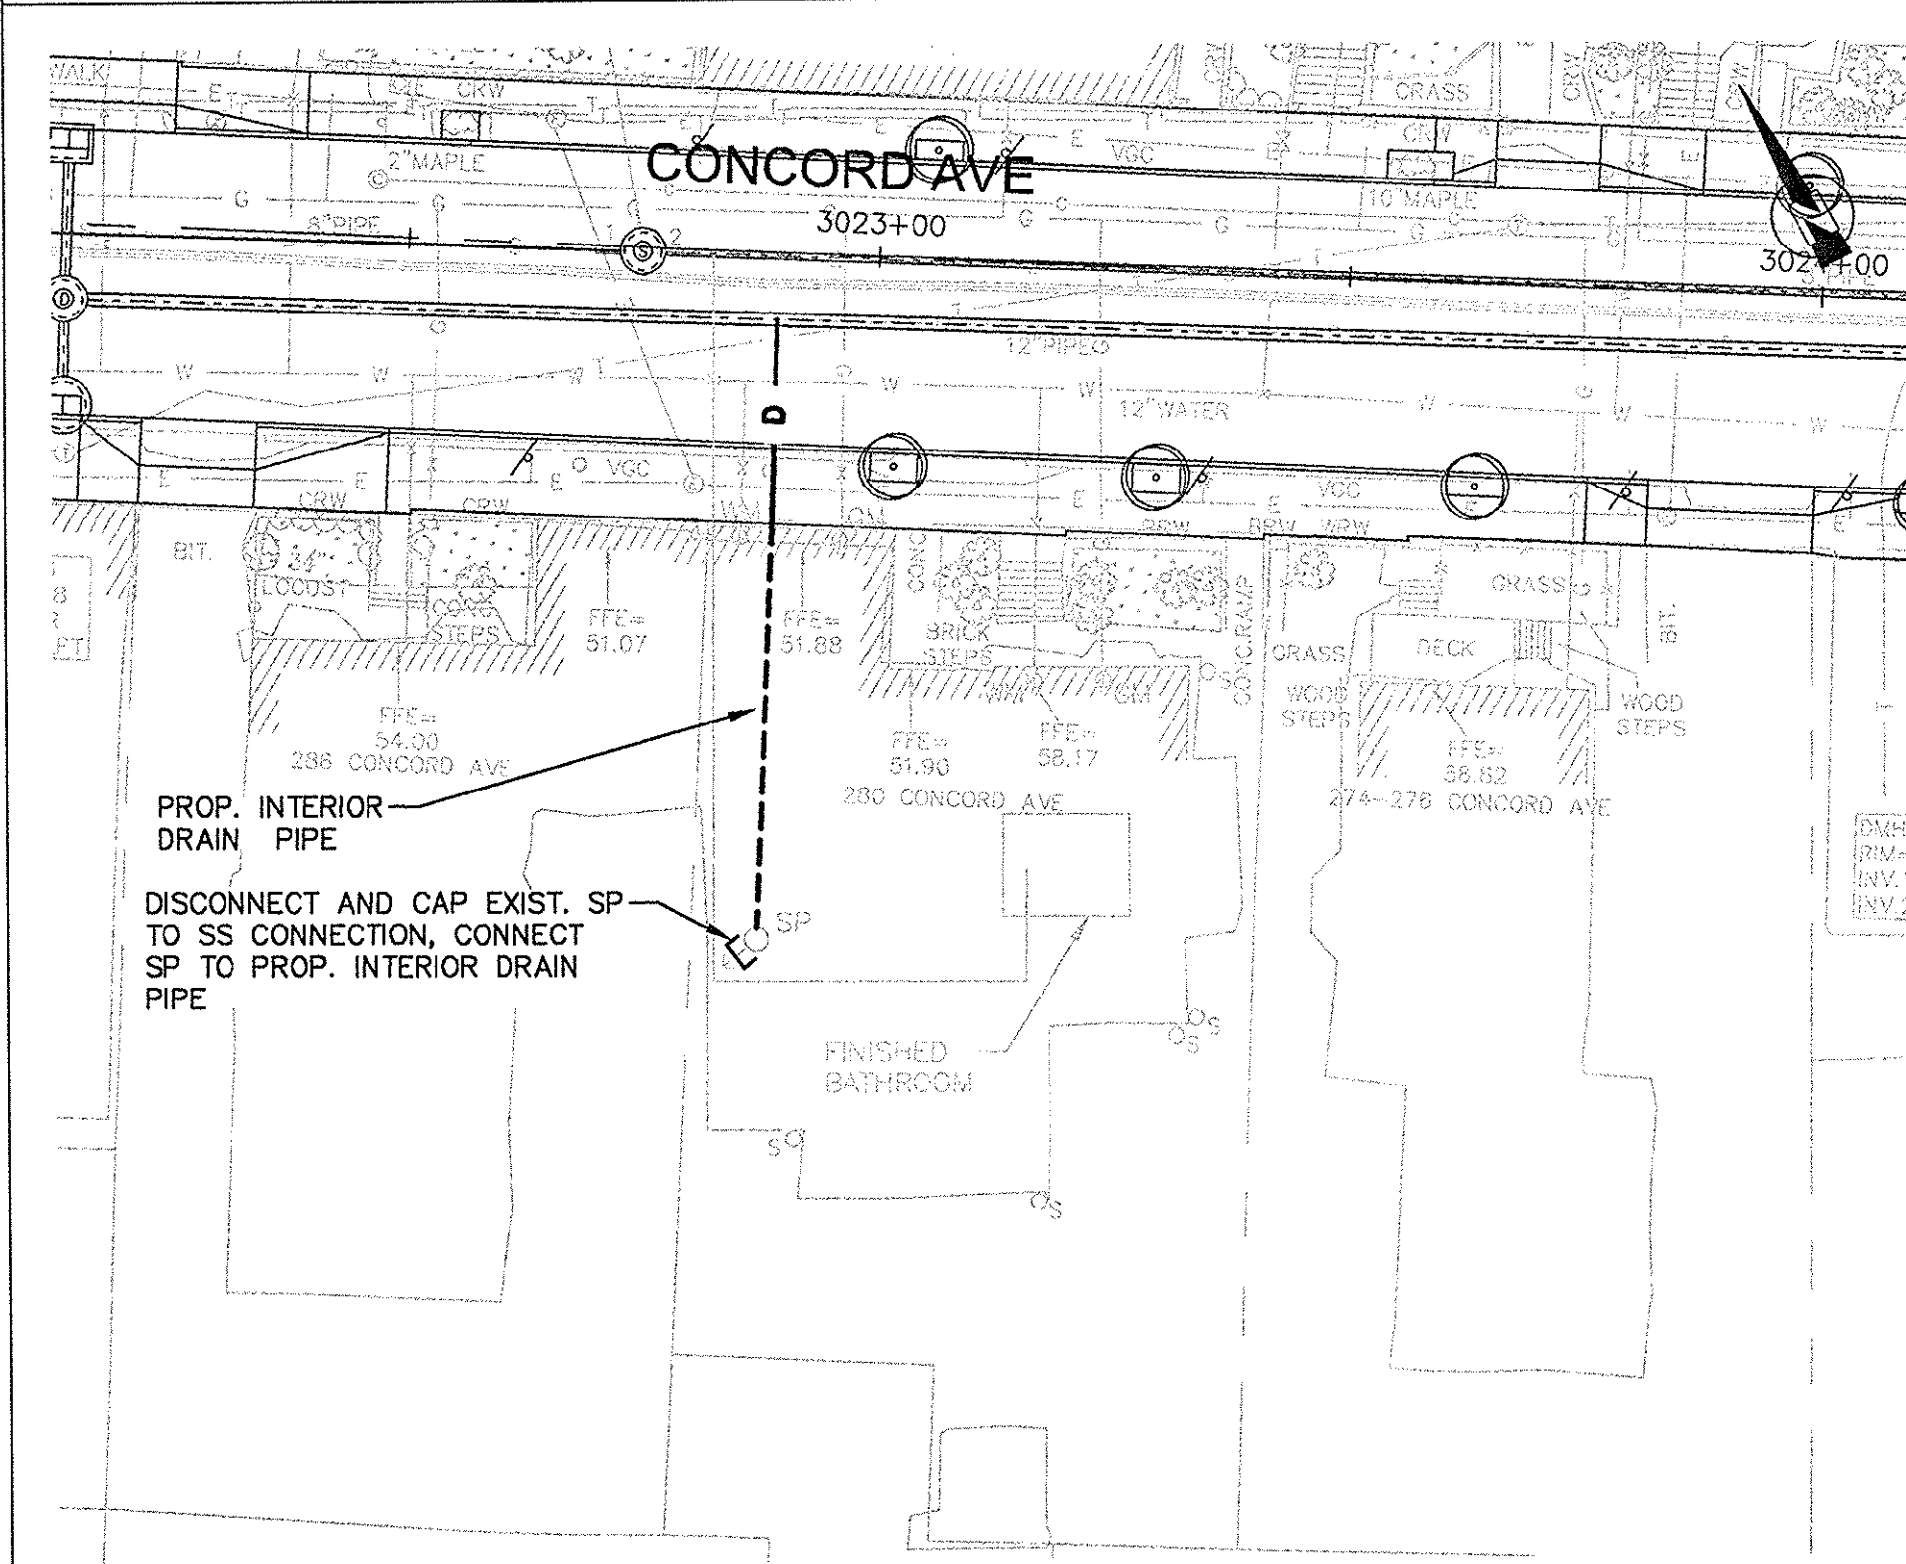


PLAN NO. 6F
280-282 CONCORD AVE

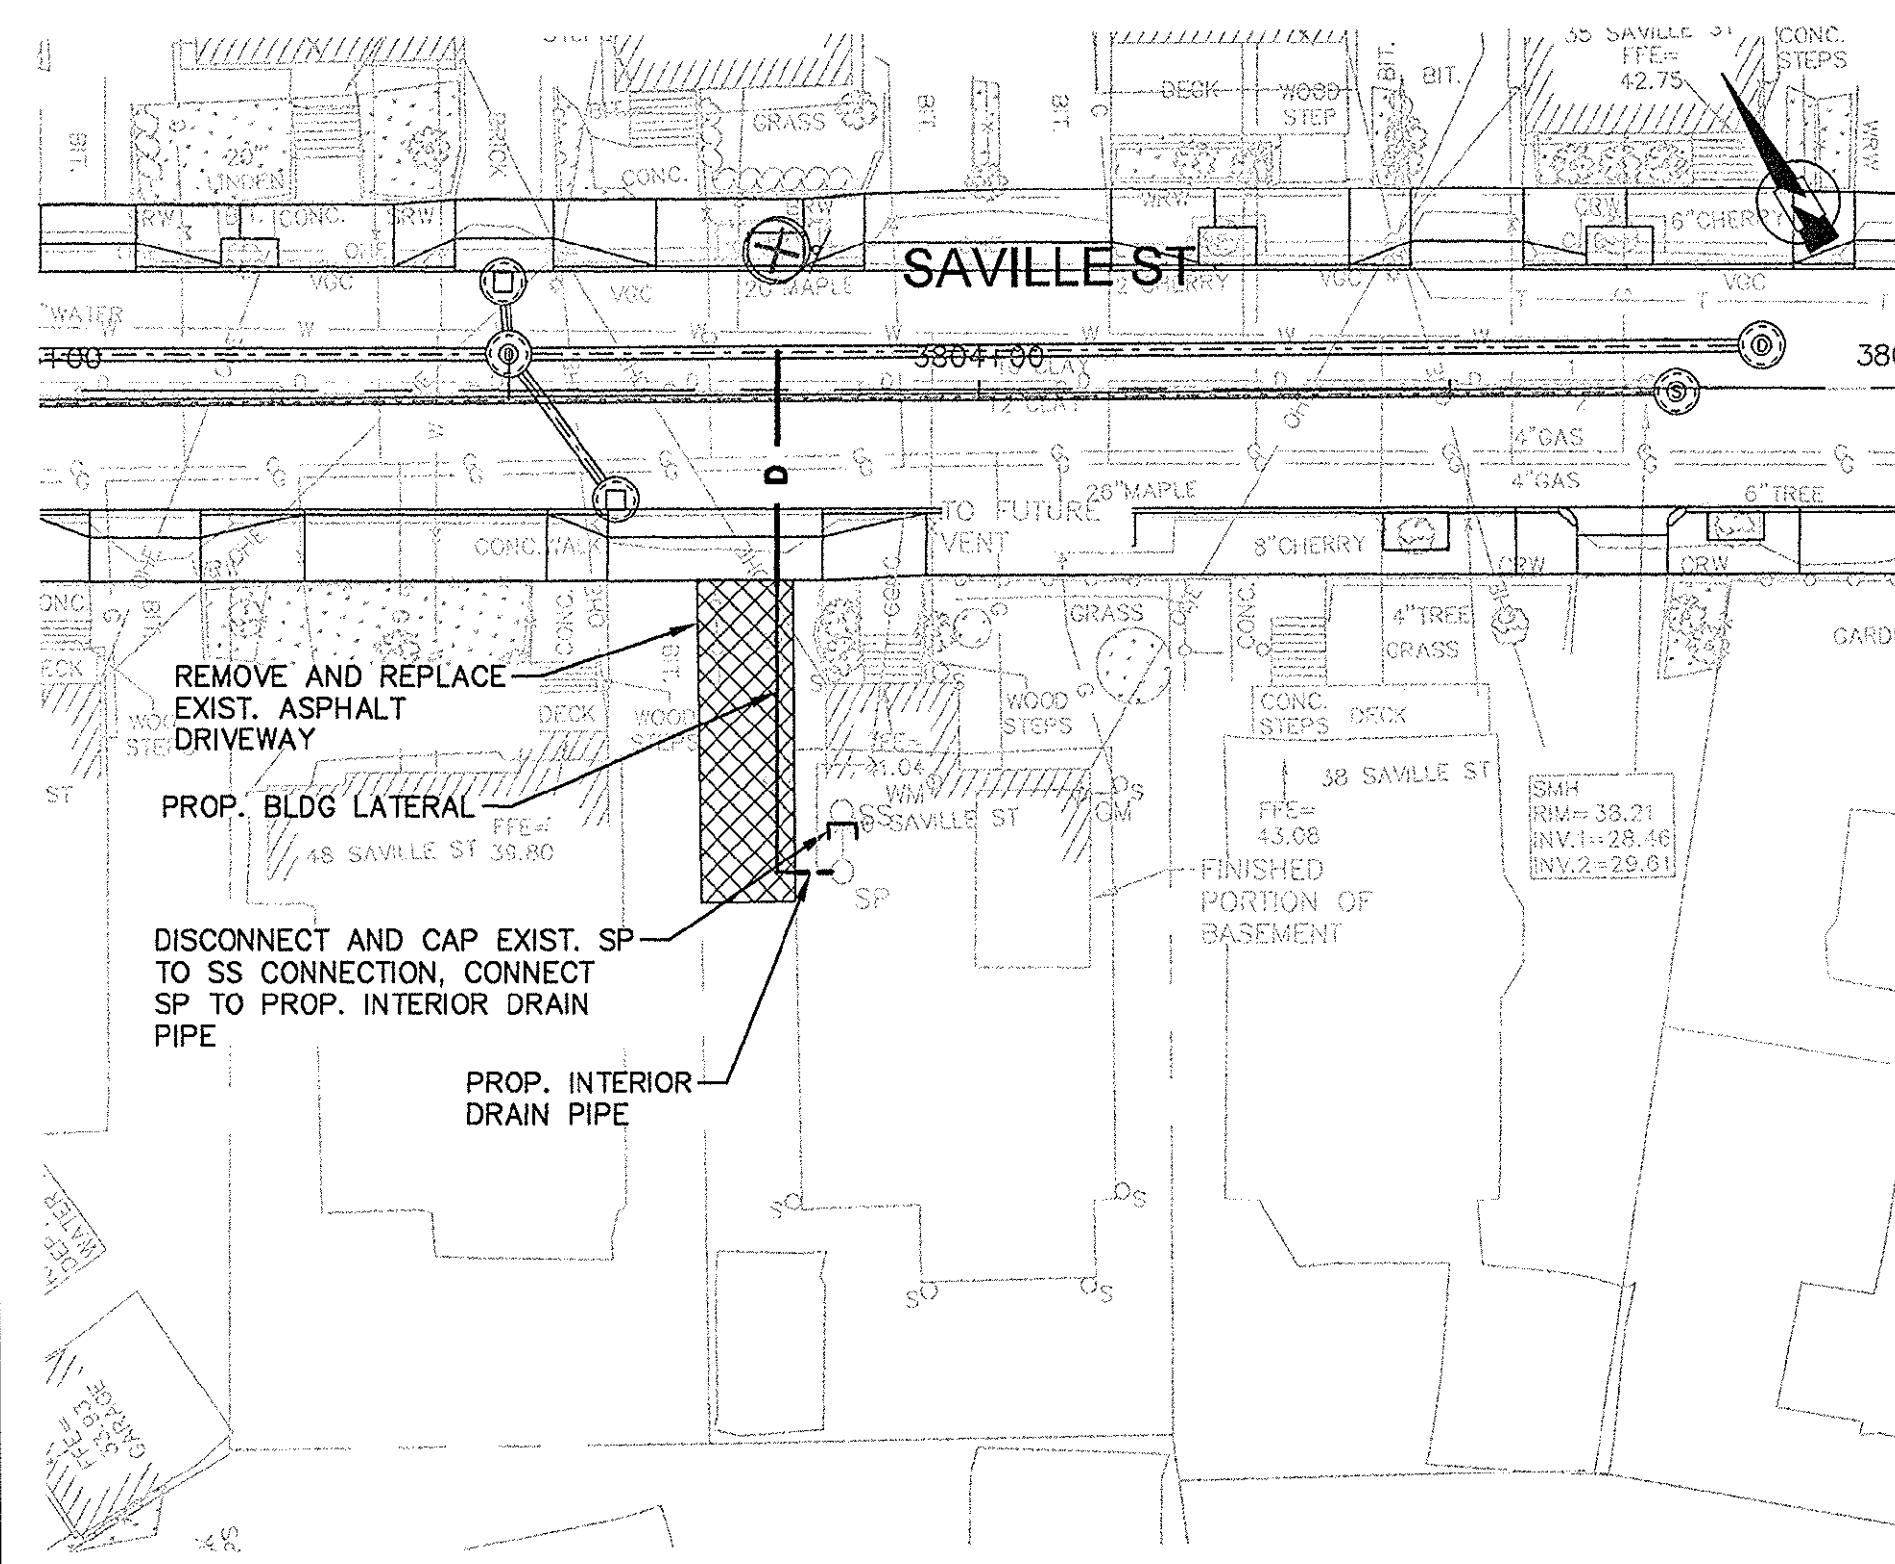


PLAN NO. 6G
46 SAVILLE ST

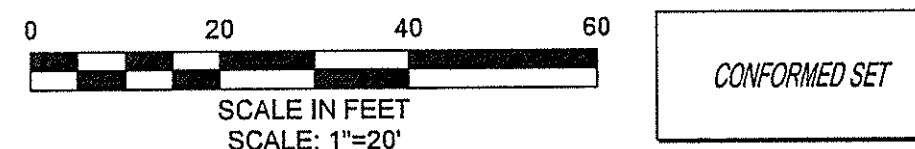

PLOTTED: 2/20/2014 8:15 PM BY: nck, lmo
LAYOUT: CP-8
CAD FILE: C:\pwworking\10263\CONCORD_CP08.dwg

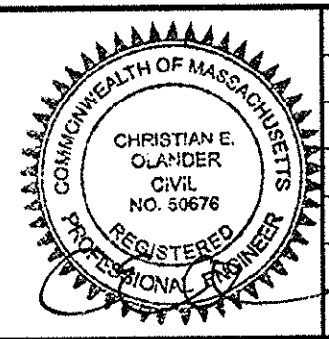


Scale	1"=20'		
Date	JANUARY 27, 2014		
Job No.	20120286.001A		
Designed by	MTD		
Drawn by	PBR		
Checked by	AML	No.	Description
Approved by	EO		Date

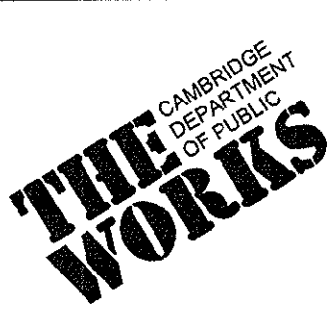


Client	CITY OF CAMBRIDGE, MASSACHUSETTS
Project	CONCORD (CONTRACT 9) SEWER SEPARATION AND SURFACE IMPROVEMENTS PROJECT
Drawing	CIVIL - PRIVATE INFLOW REMOVAL PLAN NO. 6


Sheet	CP-8
File No.	

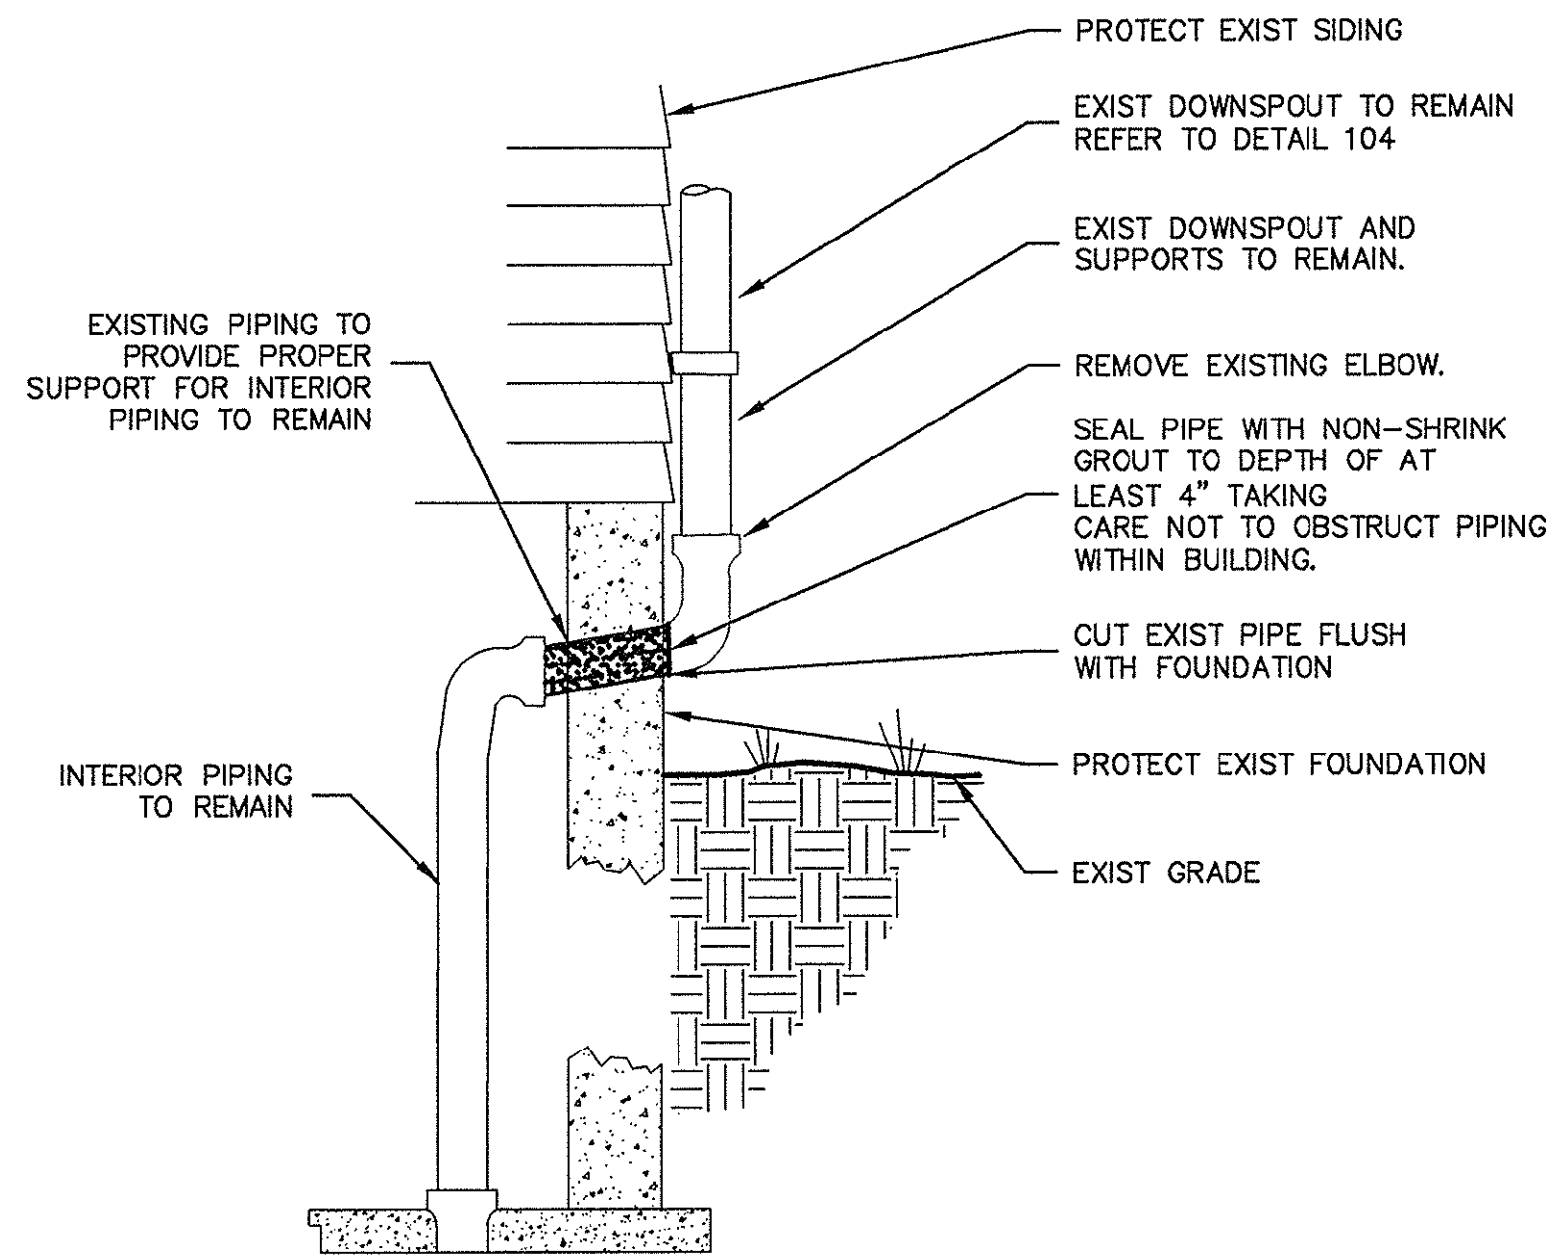

REMOVE ELBOW / PLUG OPEN ELBOW 100

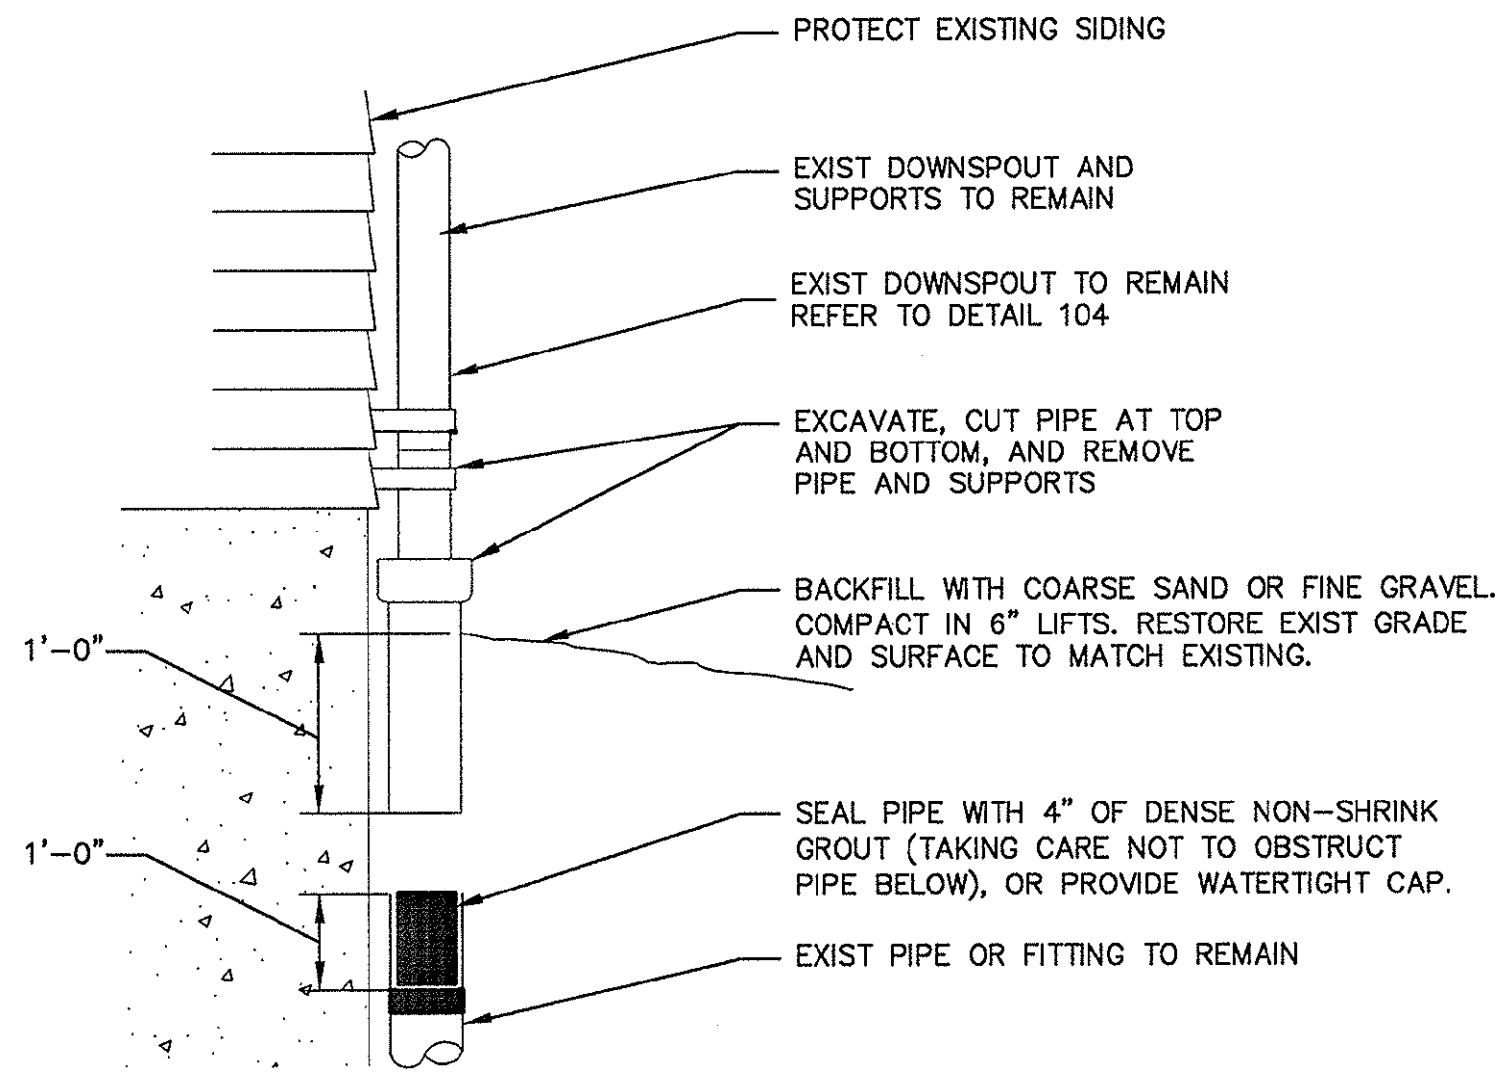


ABANDON (UNDERGROUND) DOWNSPOUT CONNECTION 101

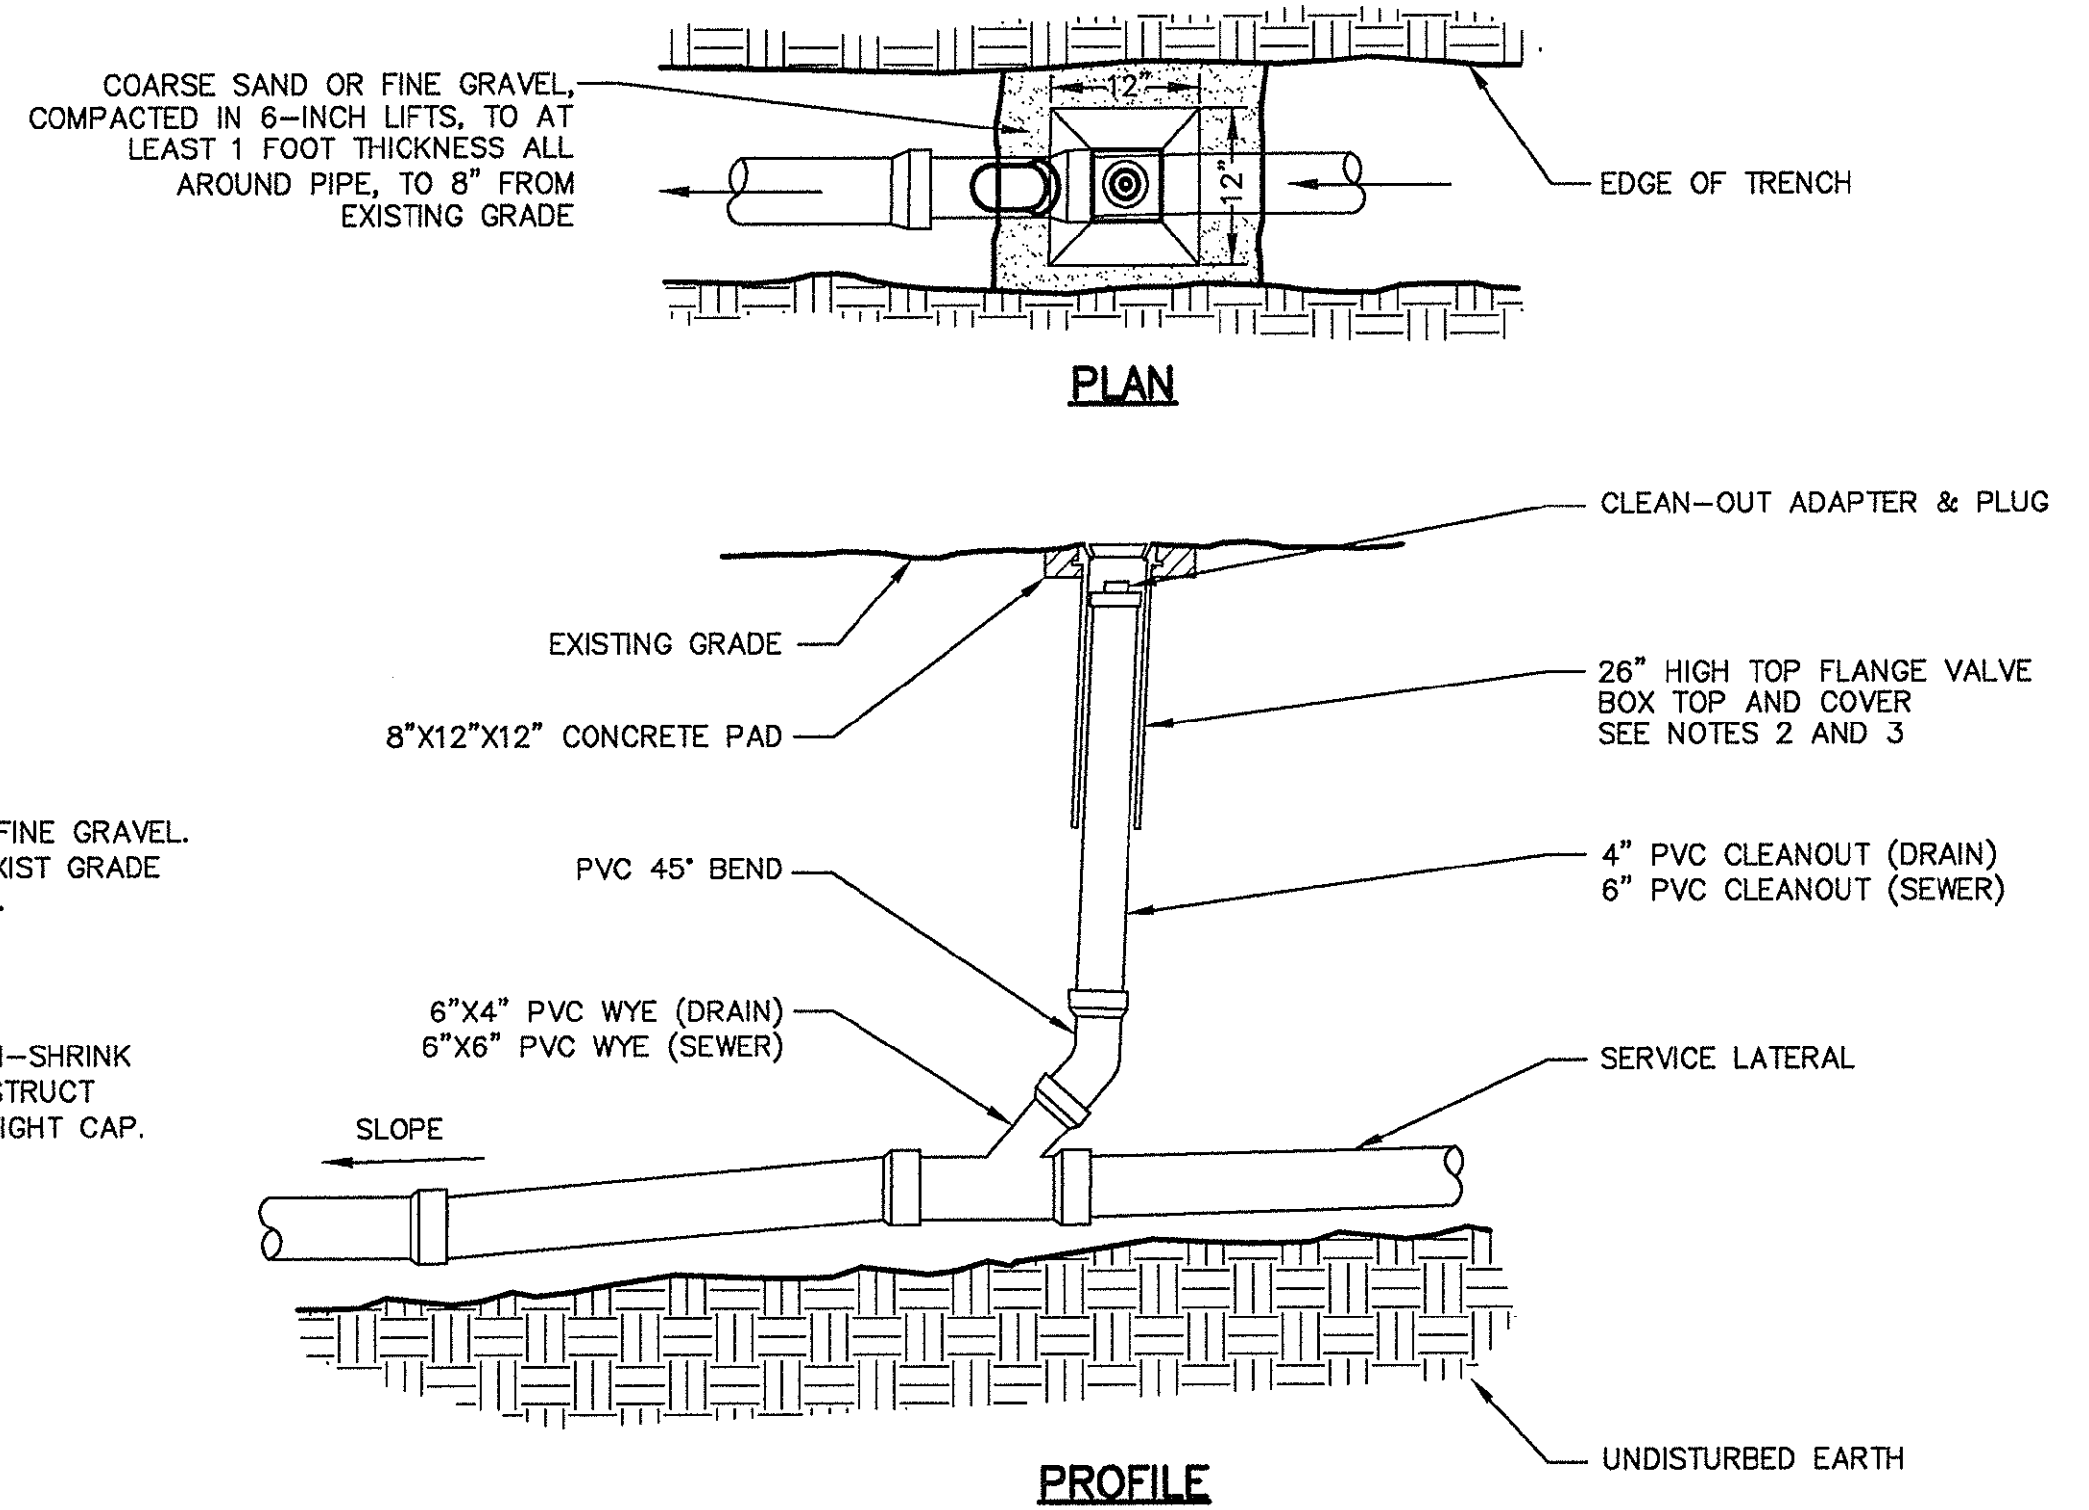


DRAIN COLLECTOR CLEAN-OUT 102


- DRAIN COLLECTOR CLEAN-OUT NOTES:**
- IF THE DISTANCE BETWEEN THE STORM DRAIN MAIN AND THE TERMINAL CLEANOUT ALONG THE LATERAL IS GREATER THAN 100 FEET, THEN A CLEANOUT IS TO BE INSTALLED AT APPROXIMATELY THE HALFWAY POINT AT A LOCATION APPROVED BY THE PROPERTY OWNER.
 - IF THE CLEANOUT IS TO BE LOCATED IN A LAWN AREA, THE TOP OF THE CLEANOUT CAN BE BURIED 6 INCHES BELOW THE SURFACE TO OFFER PROTECTION FROM DAMAGE. MARK CLEANOUT LOCATION WITH DETECTABLE METAL.
 - IF THE CLEANOUT IS TO BE LOCATED IN A PAVED AREA, THE TOP OF THE CLEANOUT SHOULD BE PROTECTED BY A WELLHEAD COVER BOX (PREFERRED) OR A GATE BOX COVER.

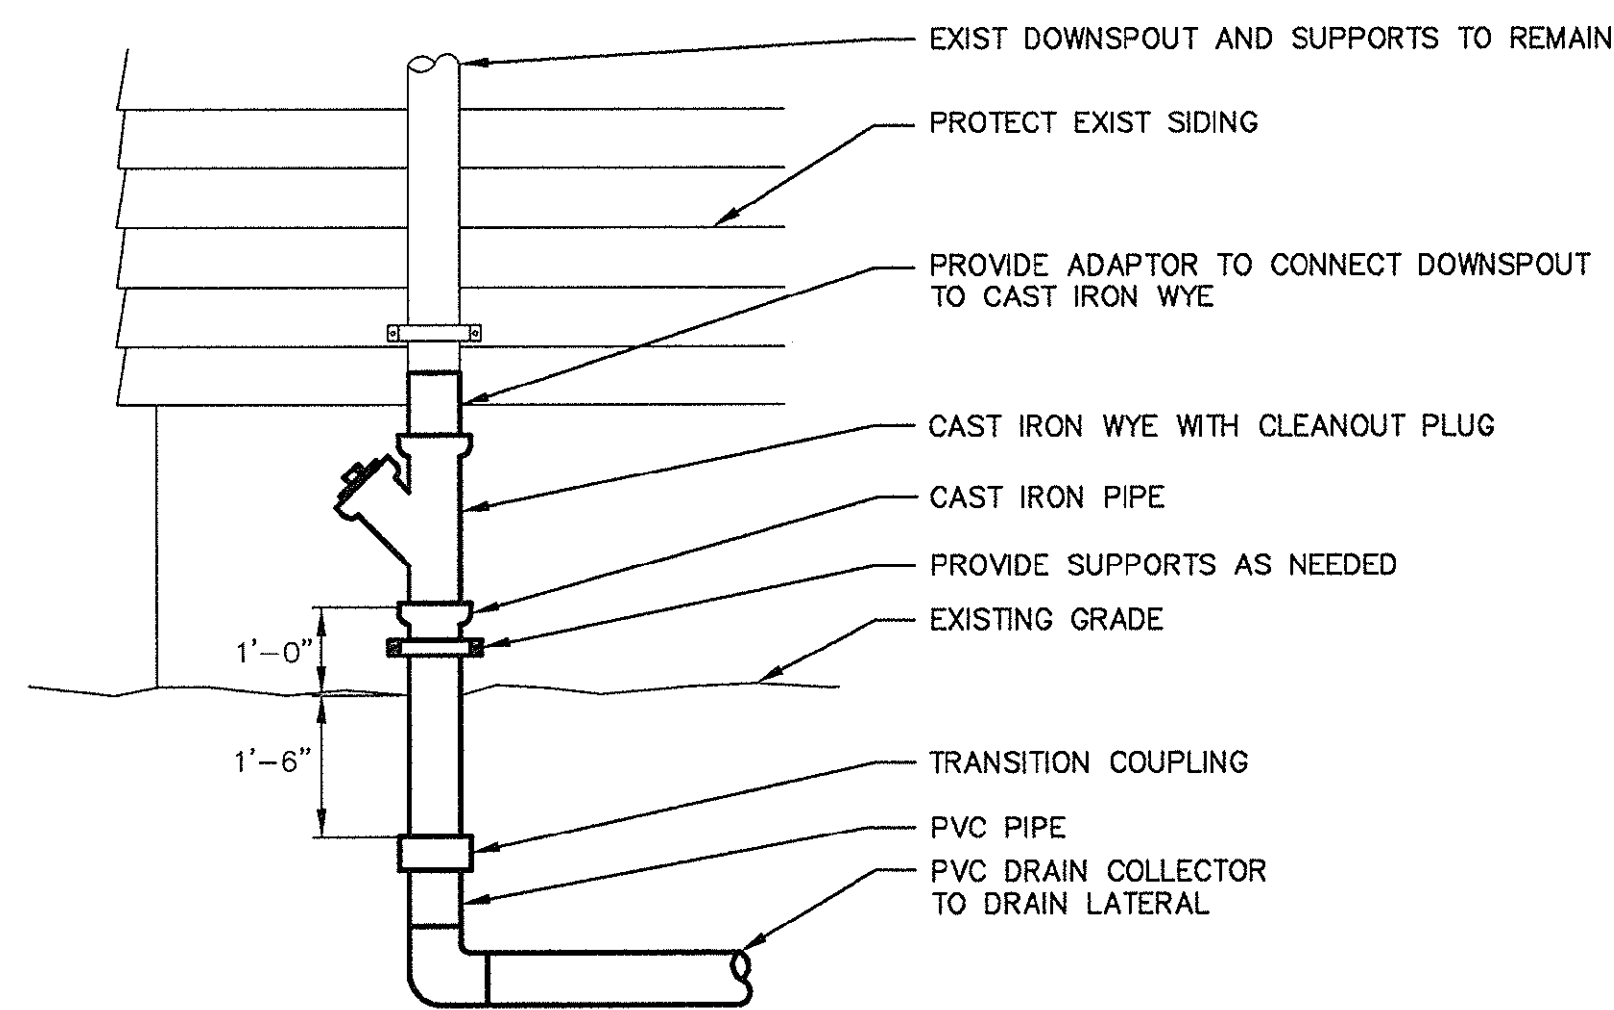

DOWN SPOUT TO DRAIN LATERAL 103

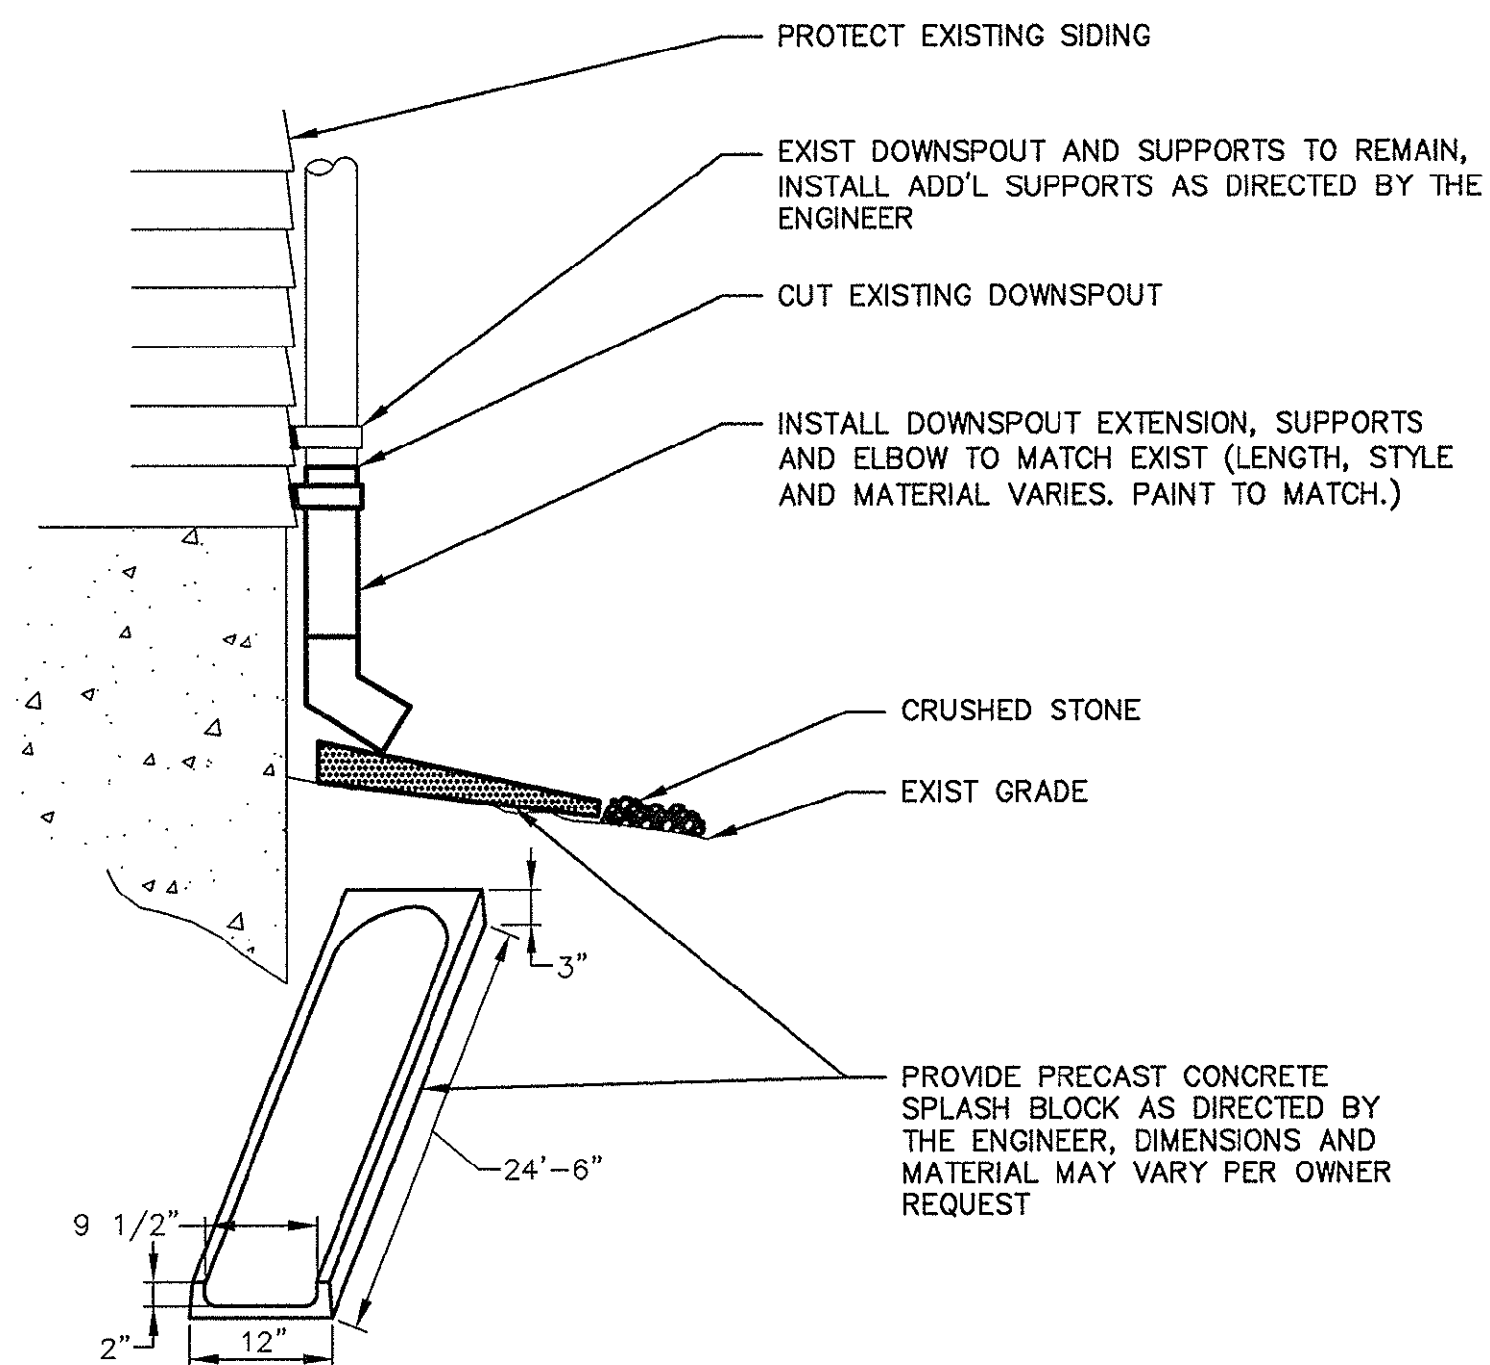

CUT DOWNSPOUT AND REDIRECT TO SPLASH PAD 104

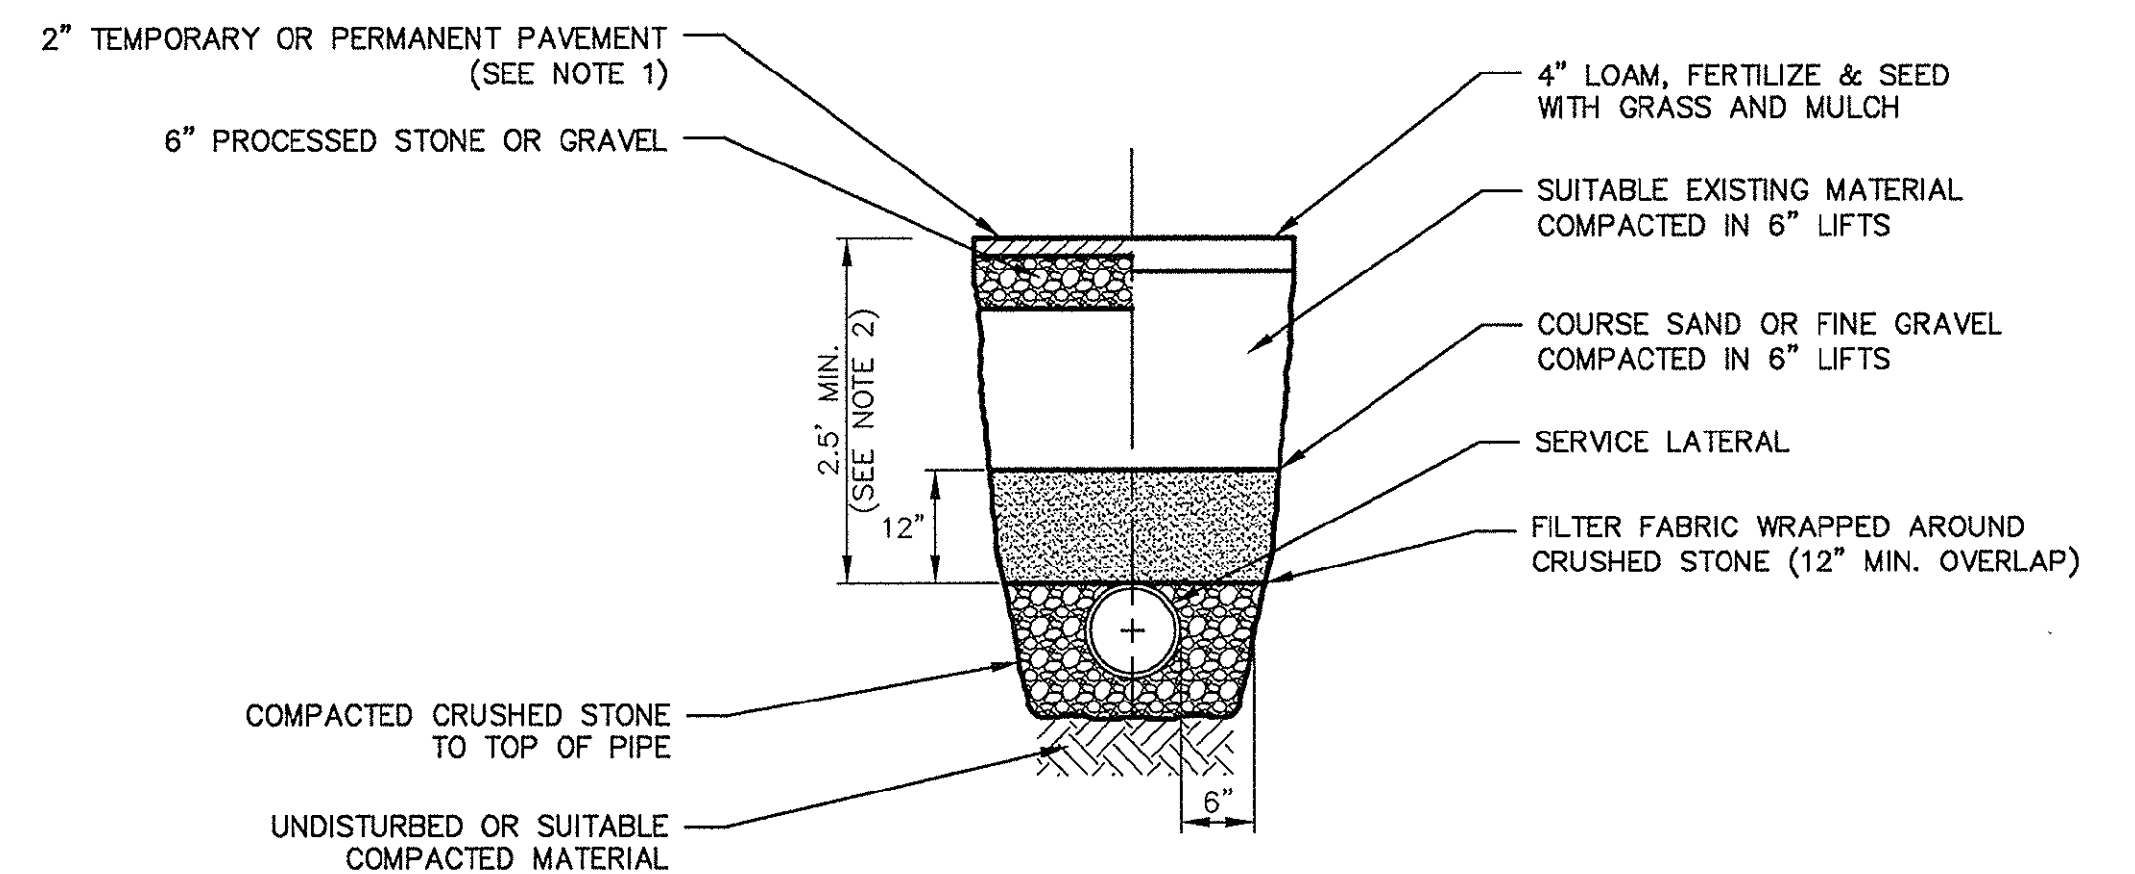


SANITARY AND DRAIN LATERAL TRENCH OUTSIDE ROAD RIGHT-OF-WAY 105


- PAVEMENT NOTES:**
- TEMPORARY PAVEMENT RESTORATION EXTENDS WIDTH OF TRENCH IN PAVED AREAS. PERMANENT PAVEMENT RESTORATION EXTENDS WIDTH OF DRIVEWAY OR WALKWAY AS SHOWN ON PLANS.
 - WHERE MINIMUM DEPTH OF COVER CANNOT BE MET UNDER PAVED AREAS, PROVIDE CDF ENCASEMENT 6" ALL AROUND THE LATERAL.

CONFORMED SET

PLOTTED: 10/10/2014 5:16 PM BY: hsk:hhg LAYOUT: CP09

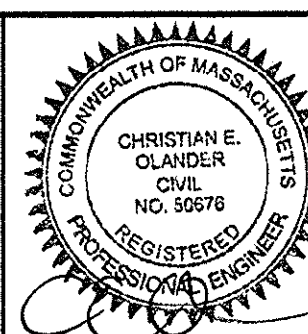


Scale	NO SCALE		
Date	JANUARY 27, 2014		
Job No.	20120256.001A		
Designed by	KWG		
Drawn by	PBR		
Checked by	AML	No.	Description
Approved by	EO		REVISIONS

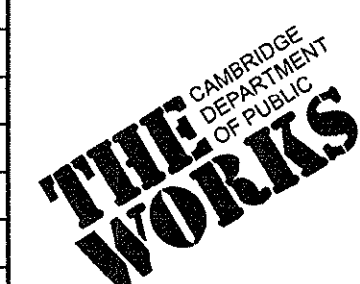



Client	CITY OF CAMBRIDGE, MASSACHUSETTS
Project	CONCORD (CONTRACT 9) SEWER SEPARATION AND SURFACE IMPROVEMENTS PROJECT
Drawing	PRIVATE INFLOW REMOVAL DETAILS I

Sheet	CP-9
File No.	

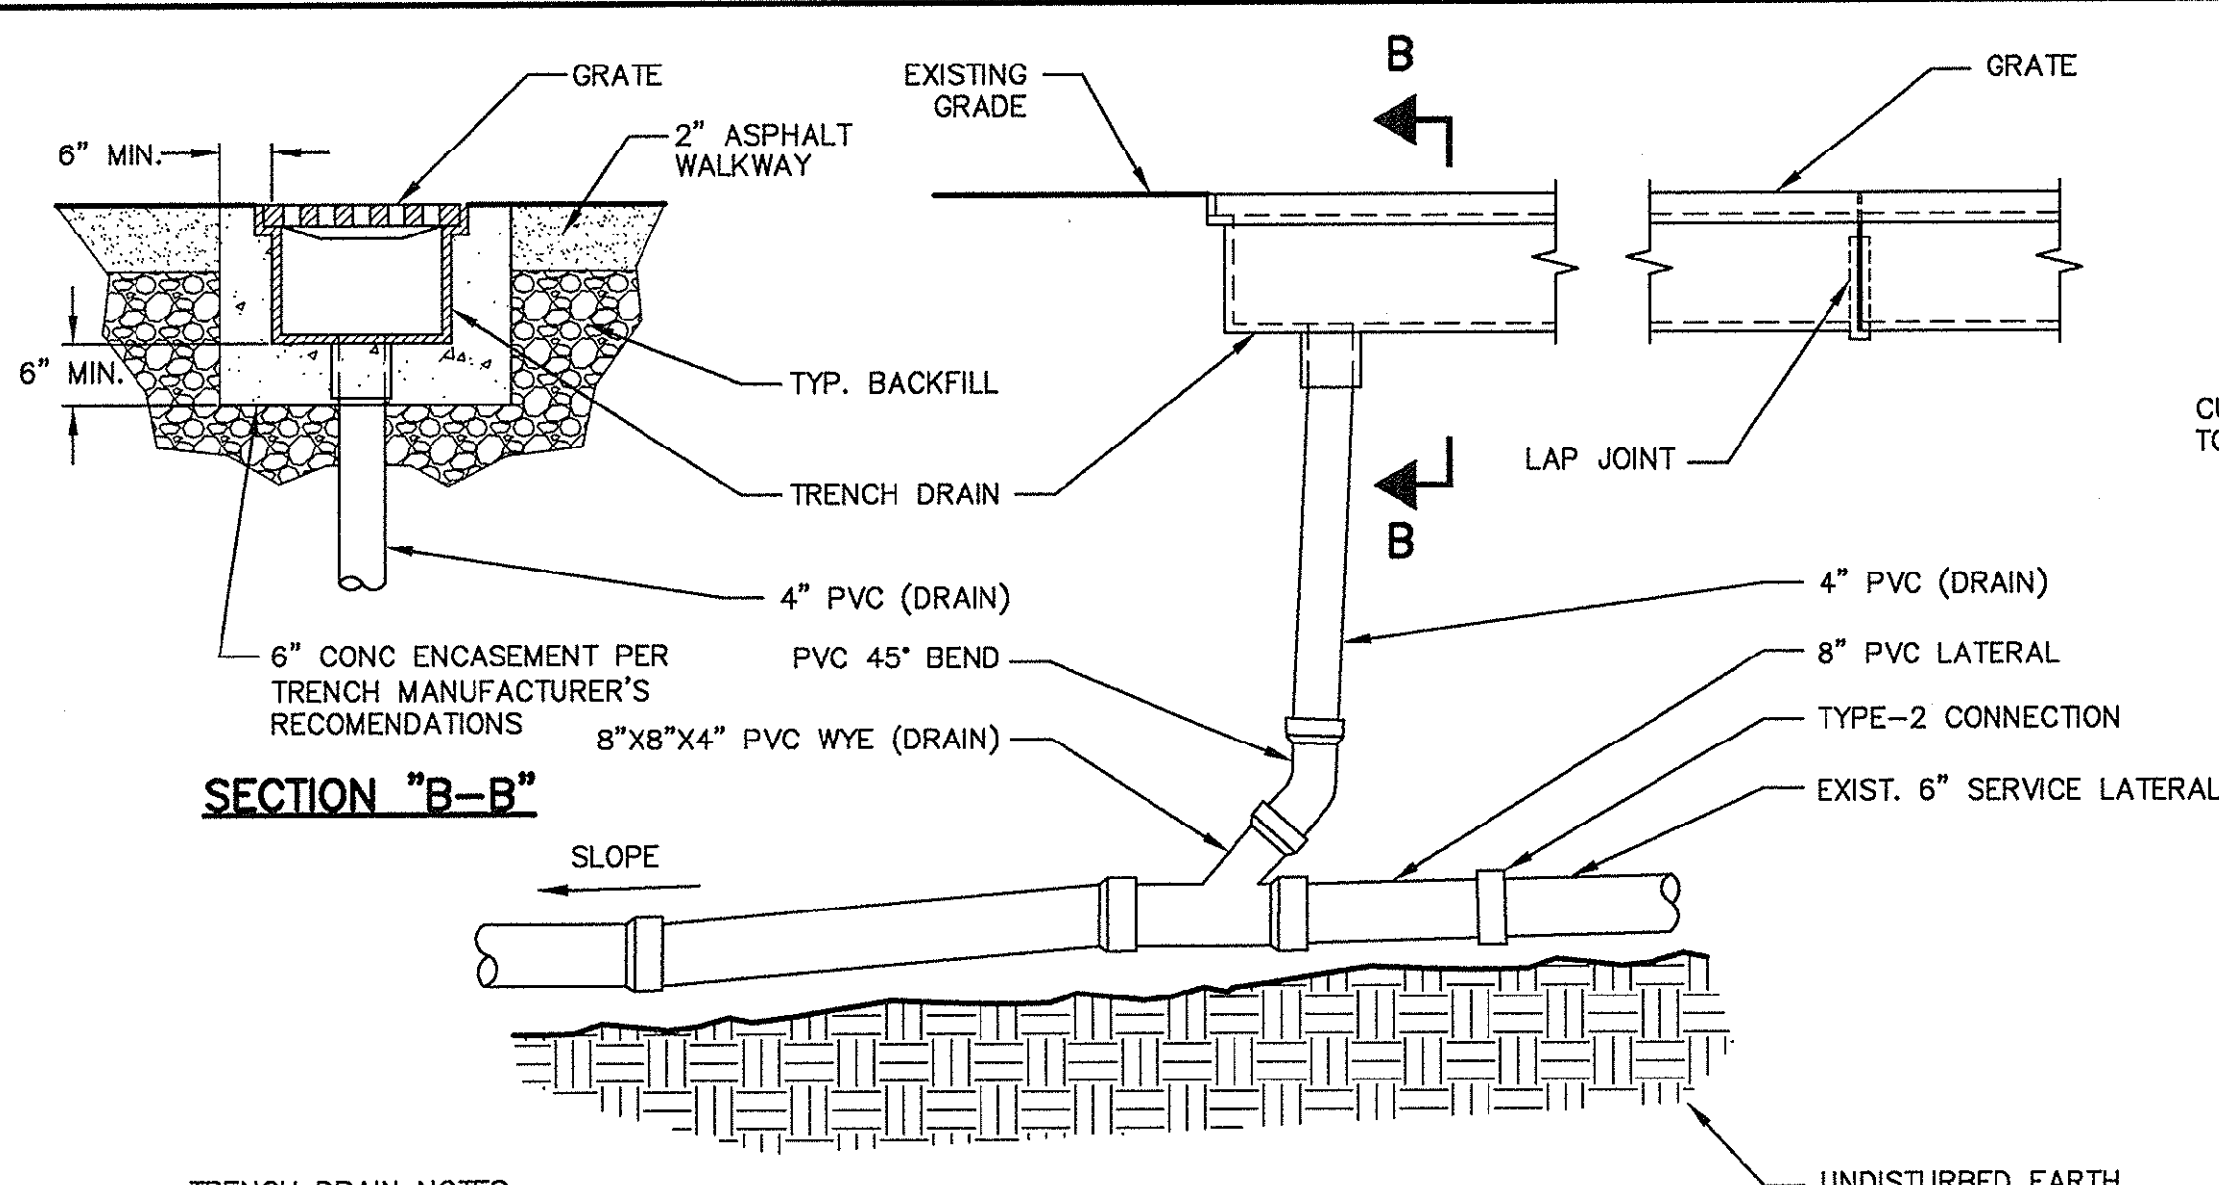

TRENCH DRAIN NOTES:
 1. CHANNELS TO BE INSTALLED WITH GRATE. GRATE TO BE PROTECTED FROM CONCRETE POUR.
 2. WIDTH OF TRENCH DRAIN IS TO BE EQUAL TO OR GREATER THAN WIDTH OF ASPHALT SIDEWALK.

TRENCH DRAIN @ 445 CONCORD AVE 106

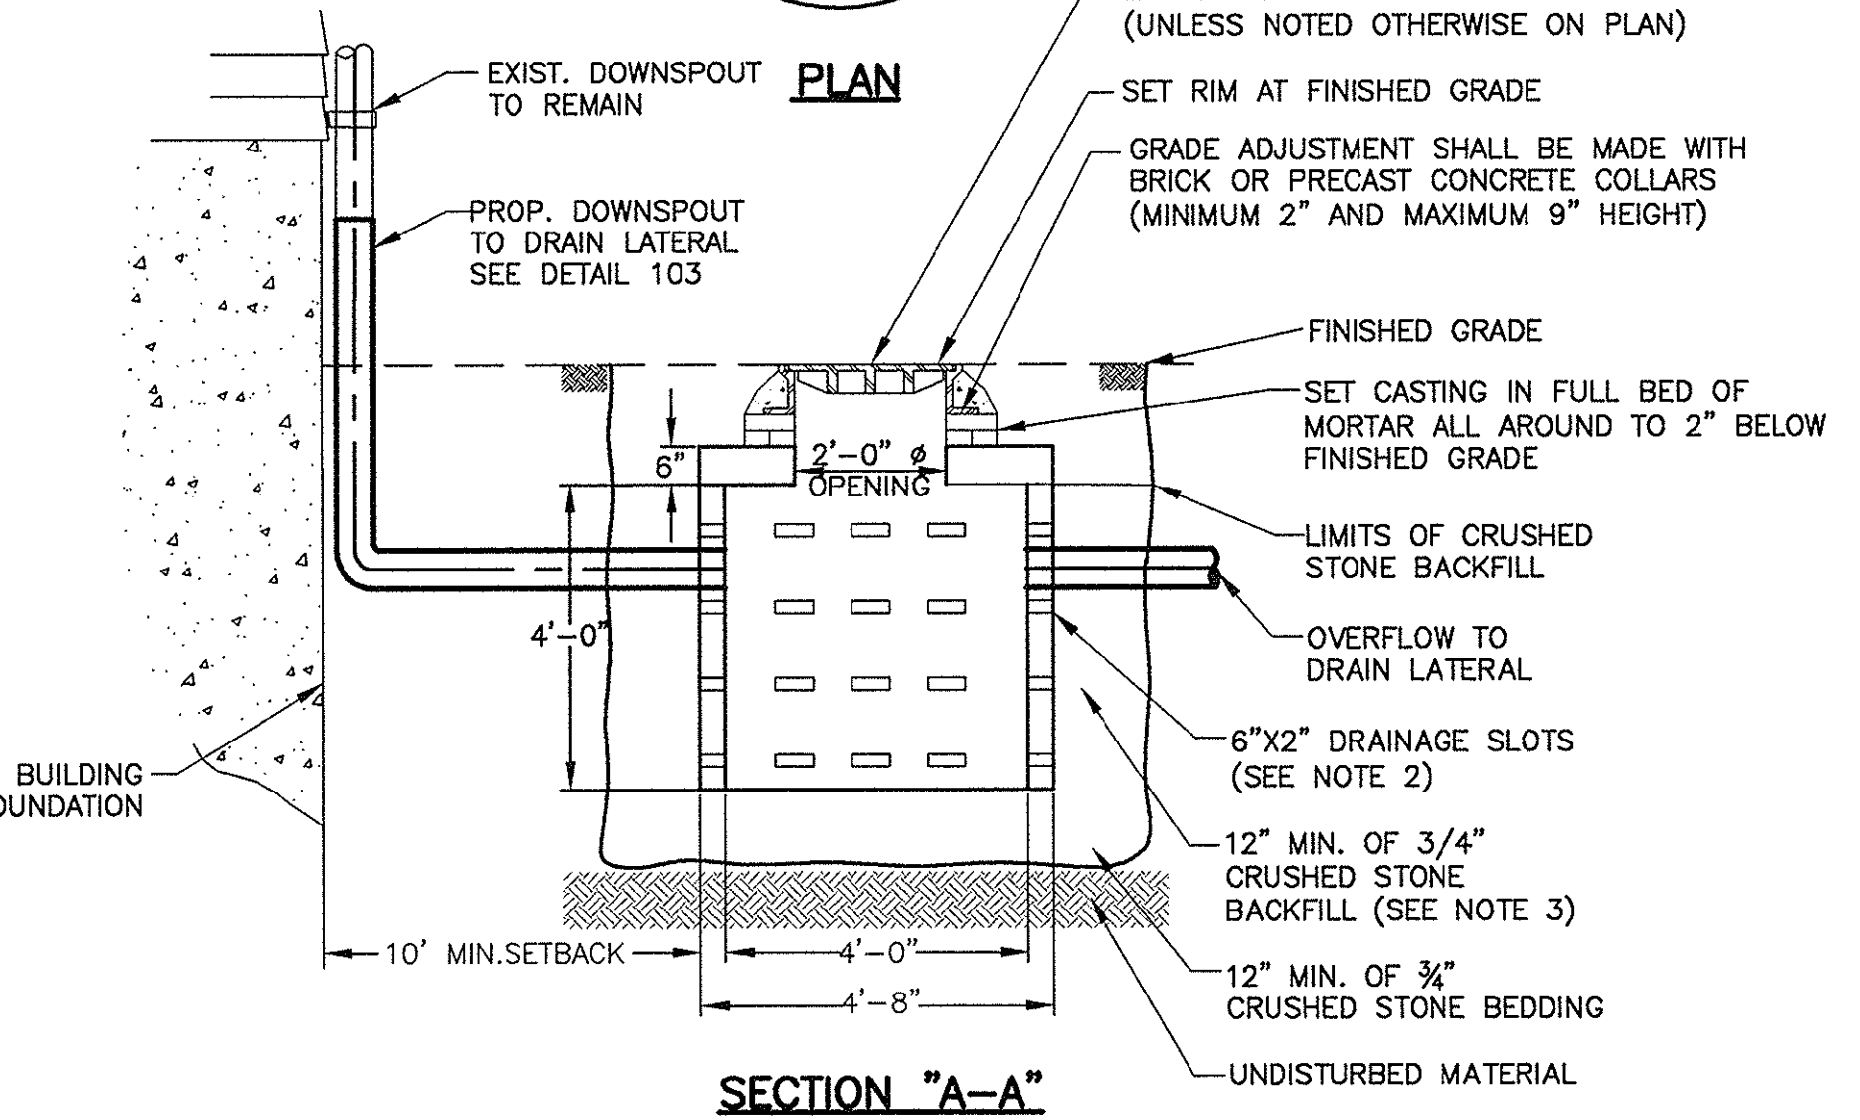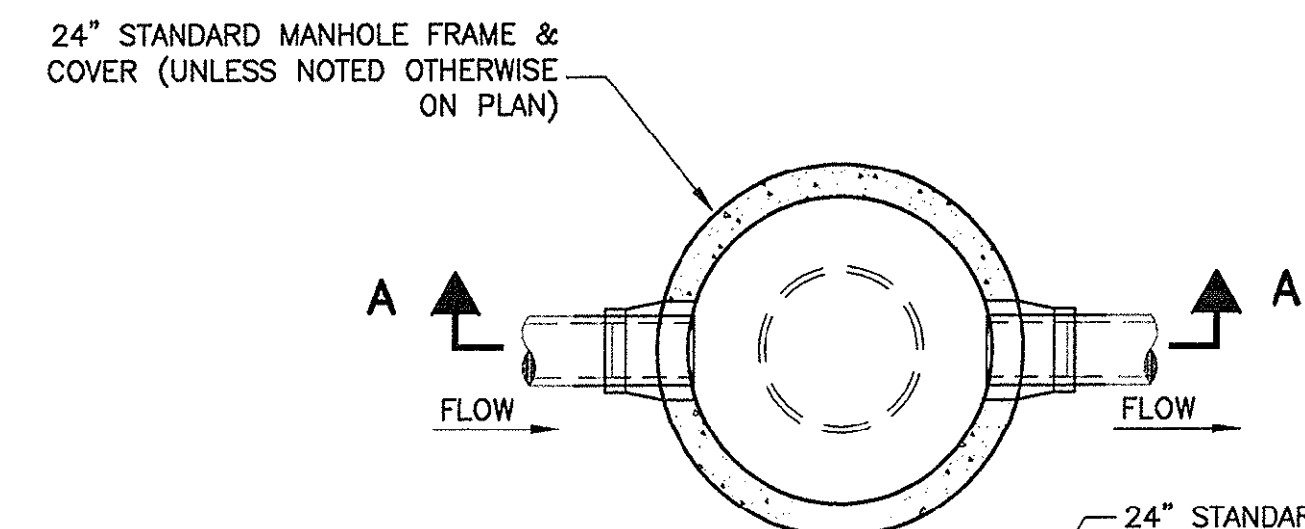

DRY WELL TO LATERAL OVERFLOW 107

DRY WELL NOTES:
 1. PROVIDE MANUFACTURER SUPPLIED SUMPS AND OPENINGS WHERE SHOWN ON THE DRAWINGS.
 2. DRAINAGE SLOTS SHALL BE COVERED WITH 1/2" MESH 23 GAGE GALVANIZED WIRE SCREEN.
 3. PROVIDE FILTER FABRIC WRAP AROUND CRUSHED STONE BEDDING AND BACKFILL.
 4. DURING EXCAVATION, CONFIRM GROUNDWATER LEVEL IS 3 FT (MIN) BELOW BOTTOM OF DRYWELL.

CUT EXIST ROOF LEADER AND CONNECT TO PROP HORIZONTAL DOWNSPOUT WITH TEE OR ELBOW (TYP.)

REMOVE EXISTING ROOF LEADER AND PROVIDE NEW DOWNSPOUT SIZED TO SCHEDULE


CONNECT ROOF LEADER TO DRAIN COLLECTOR (SEE DETAIL 102)

CONTRACTOR TO ASSUME MINIMAL CHANGES TO THE EXISTING EAVES IS INCLUDED

PROVIDE NEW GUTTER AND SUPPORTS (OR PROVIDE NEW SUPPORTS TO REINSTALL EXISTING GUTTER, IF SERVICABLE). SLOPE GUTTER AT 1/16" PER FOOT. SUPPORT AT LEAST EVERY 36 INCHES. PROVIDE EXPANSION JOINTS EVERY 40 FEET MAXIMUM SPACING. MAXIMUM LENGTH OF GUTTER FEEDING A SINGLE DOWNSPOUT SHALL BE 60 FEET.

REMOVE EXISTING ROOF LEADER AND PROVIDE NEW DOWNSPOUT SIZED TO SCHEDULE

CONNECT ROOF LEADER TO DRAIN COLLECTOR (SEE DETAIL 102)

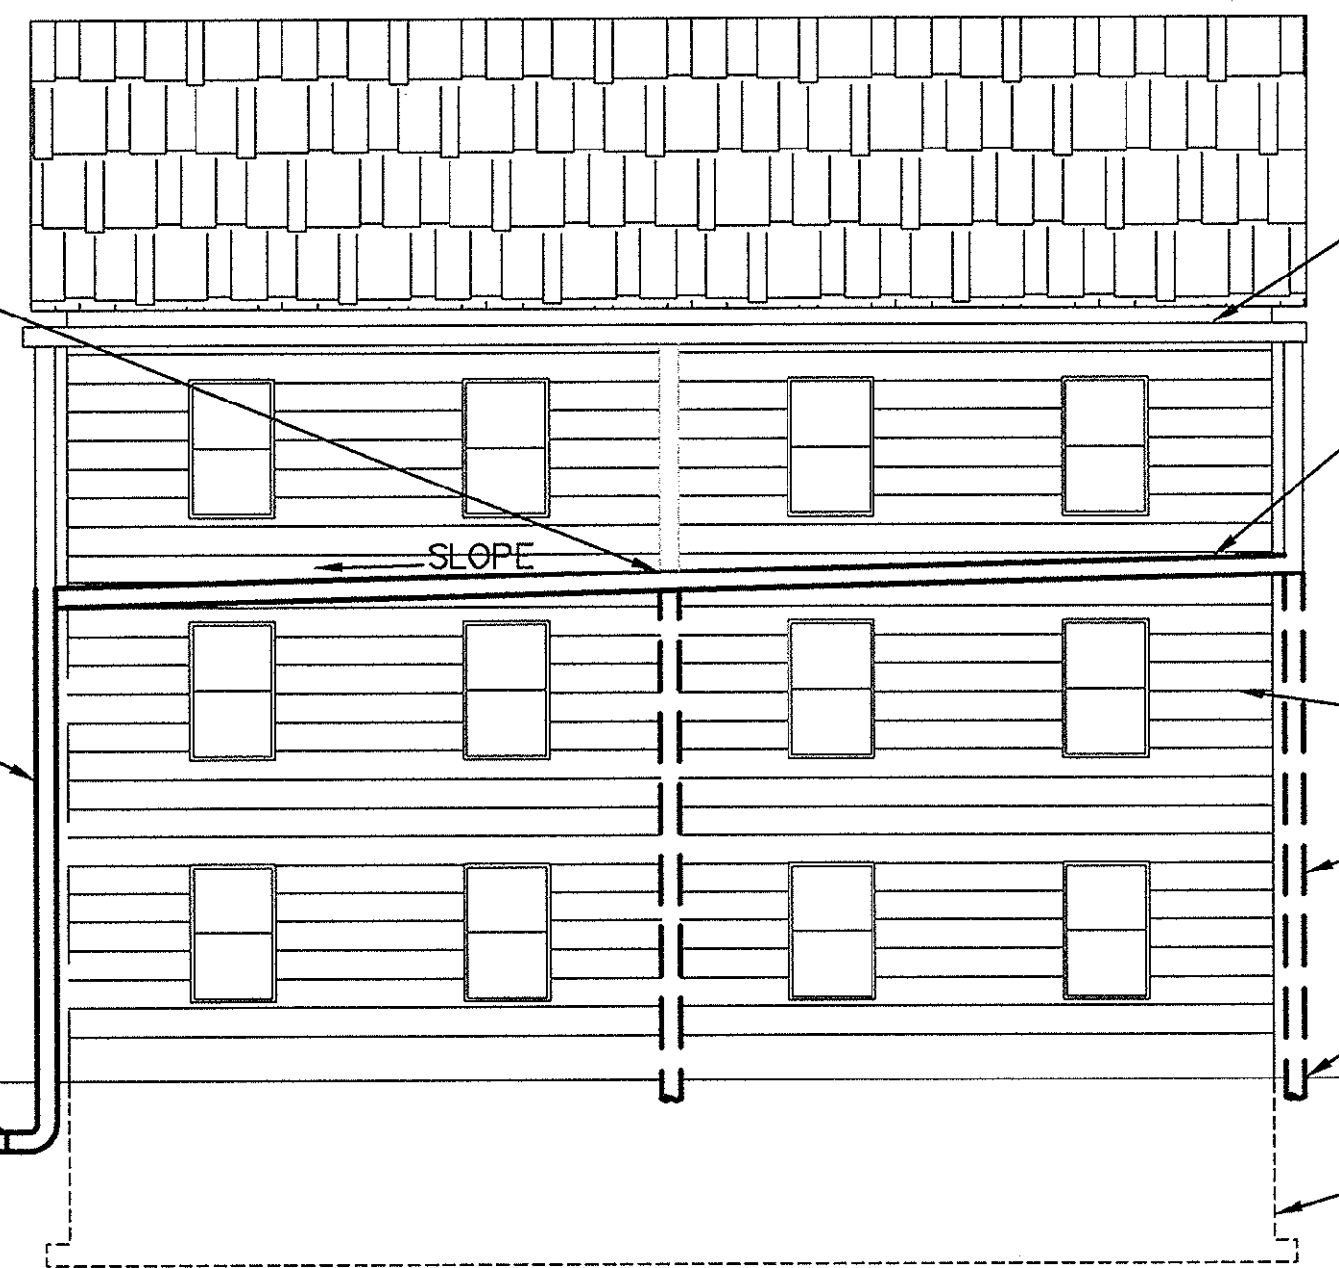

TYPE I - HORIZONTAL DOWNSPOUTS

EXISTING GUTTER TO REMAIN


PROVIDE HORIZONTAL DOWNSPOUT TO REDIRECT FLOW. SUPPORT AT LEAST EVERY 36 INCHES. PROVIDE EXPANSION JOINTS EVERY 40 FEET MAXIMUM SPACING. MINIMUM SLOPE FOR HORIZONTAL DOWNSPOUT SHALL BE 1/4" INCH PER FOOT (2%). DO NOT BLOCK WINDOWS OR DOORS. HORIZONTAL DOWNSPOUT SHALL BE CONSTRUCTED OF CAST IRON IF INSTALLED WITHIN 3 FEET OF EXISTING GRADE. SEE SCHEDULE FOR SIZING.

PROTECT SIDING

REMOVE ROOF LEADER AND SUPPORTS BELOW PROP HORIZONTAL DOWNSPOUT (TYP.)

ABANDON ROOF LEADER PENETRATION (TYP.) SEE DETAIL 102 OR 101.

EXISTING FOUNDATION

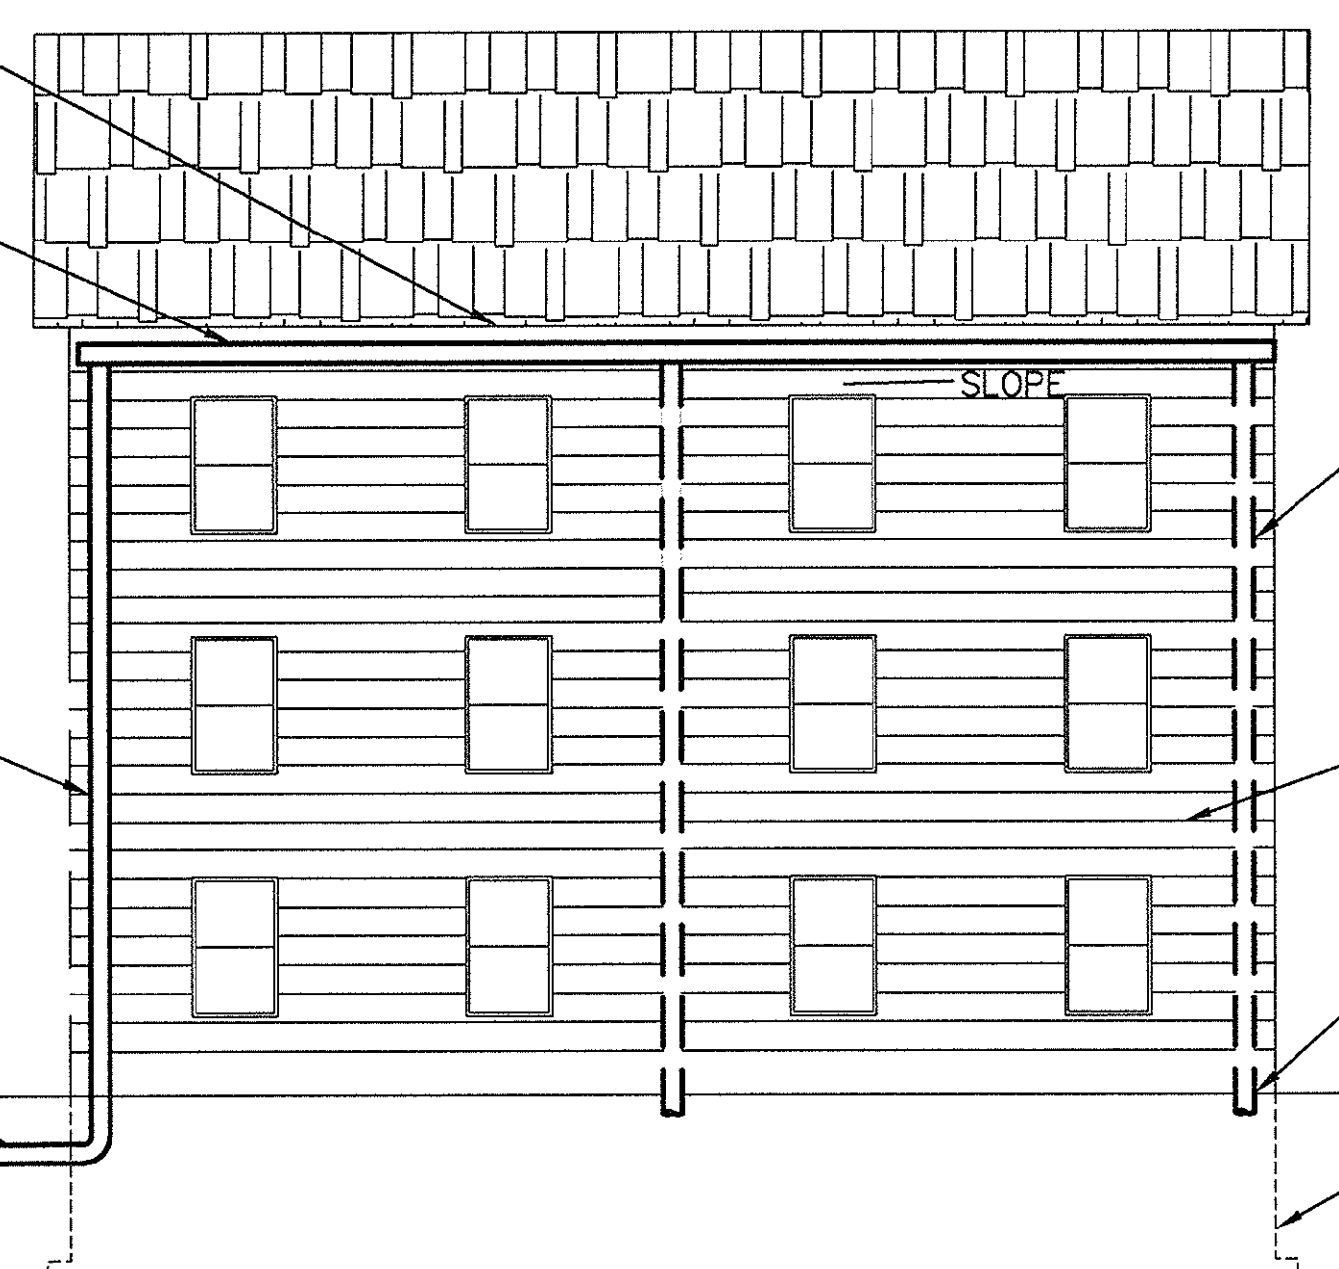

TYPE II - REPITCHING GUTTER

REMOVE ROOF LEADER AND SUPPORTS (TYP.)

PROTECT SIDING

ABANDON ROOF LEADER PENETRATION (TYP.) SEE DETAIL 100 OR 101.

EXISTING FOUNDATION


DOWNSPOUT SCHEDULE		
NOMINAL SIZE (VERTICAL)	NOMINAL SIZE (HORIZ)	MAX HORIZ. ROOF AREA SERVED
2" X 3"	2" X 3"	600 SF
3" X 4"	2.5" X 3"	800 SF
3" X 4"	3" X 4"	1400 SF

GUTTER MODIFICATIONS 108


GUTTER MODIFICATION NOTES:
 1. PROVIDE ALL MATERIALS VISIBLE ABOVE GROUND TO MATCH EXISTING, OR PAINT TO MATCH IF EXISTING MATERIALS ARE PAINTED. PROVIDE TOUCH-UP SEALANT TO SIDING TO RESTORE BUILDING APPEARANCE AFTER DEMOLITION ACTIVITIES.

CONFORMED SET

PLOTTED: 1/31/2014 6:18 PM BY: rsk/mb
 LAYOUT: CP10

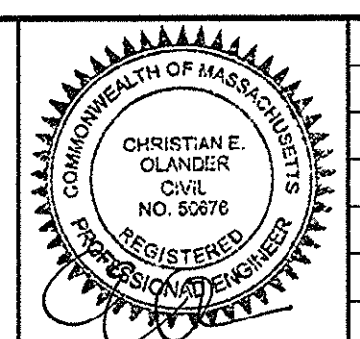


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Date	JANUARY 27, 2014		
Job No.	20120256.001A		
Designed by	KWG		
Drawn by	PBR		
Checked by	AML	No.	Description
Approved by	EO		REVISIONS

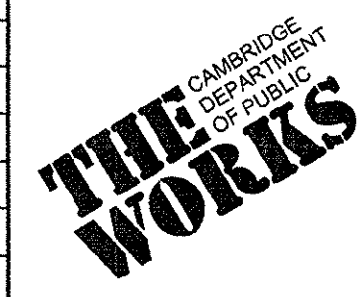


Client	CITY OF CAMBRIDGE, MASSACHUSETTS
Project	CONCORD (CONTRACT 9) SEWER SEPARATION AND SURFACE IMPROVEMENTS PROJECT
Drawing	PRIVATE INFLOW REMOVAL DETAILS II

Sheet	CP-10
File No.	

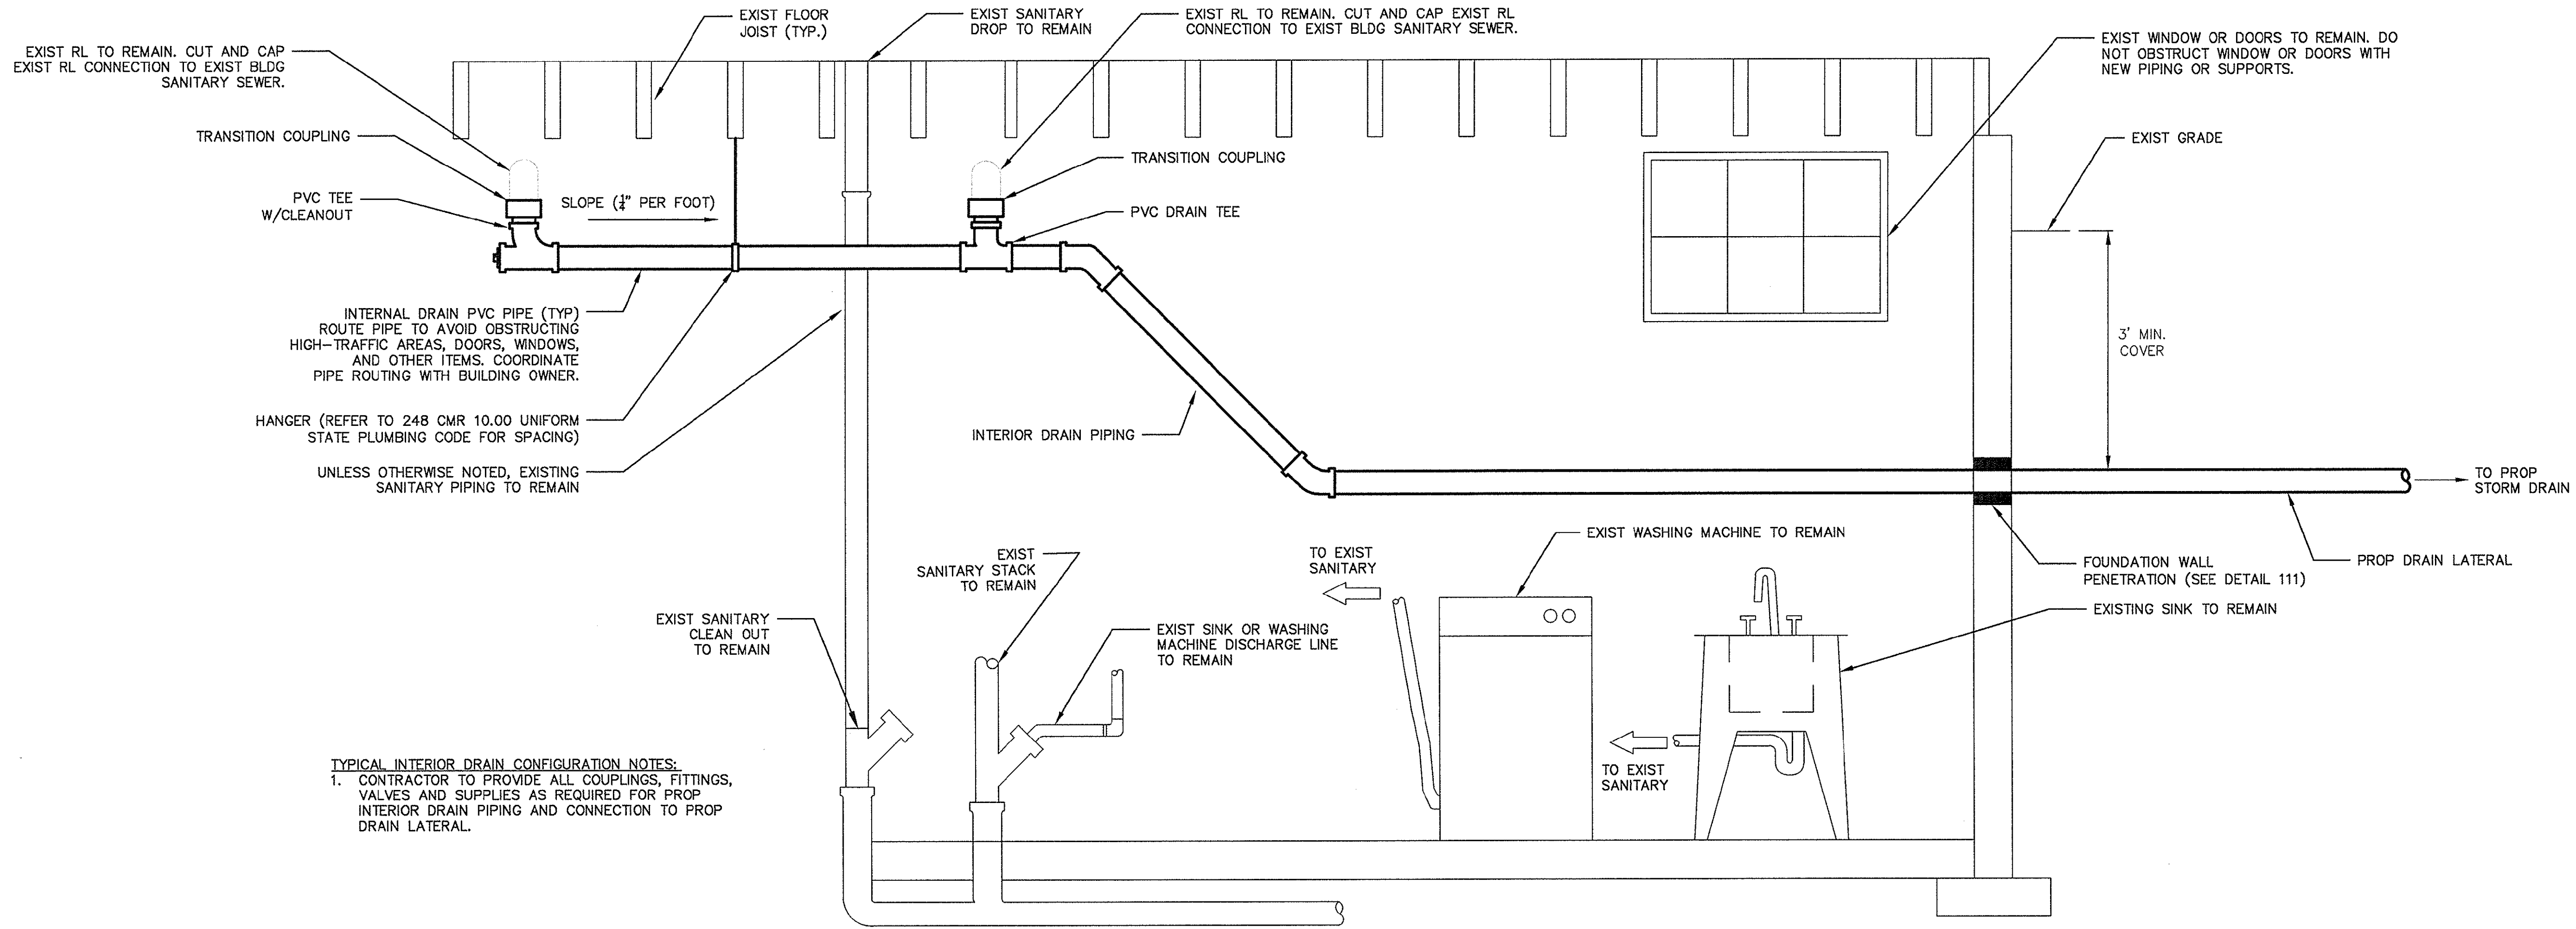


TYPICAL INTERIOR DRAIN CONFIGURATION NOTES:
 1. CONTRACTOR TO PROVIDE ALL COUPLINGS, FITTINGS, VALVES AND SUPPLIES AS REQUIRED FOR PROP INTERIOR DRAIN PIPING AND CONNECTION TO PROP DRAIN LATERAL.

TYPICAL INTERIOR DRAIN CONFIGURATION 109

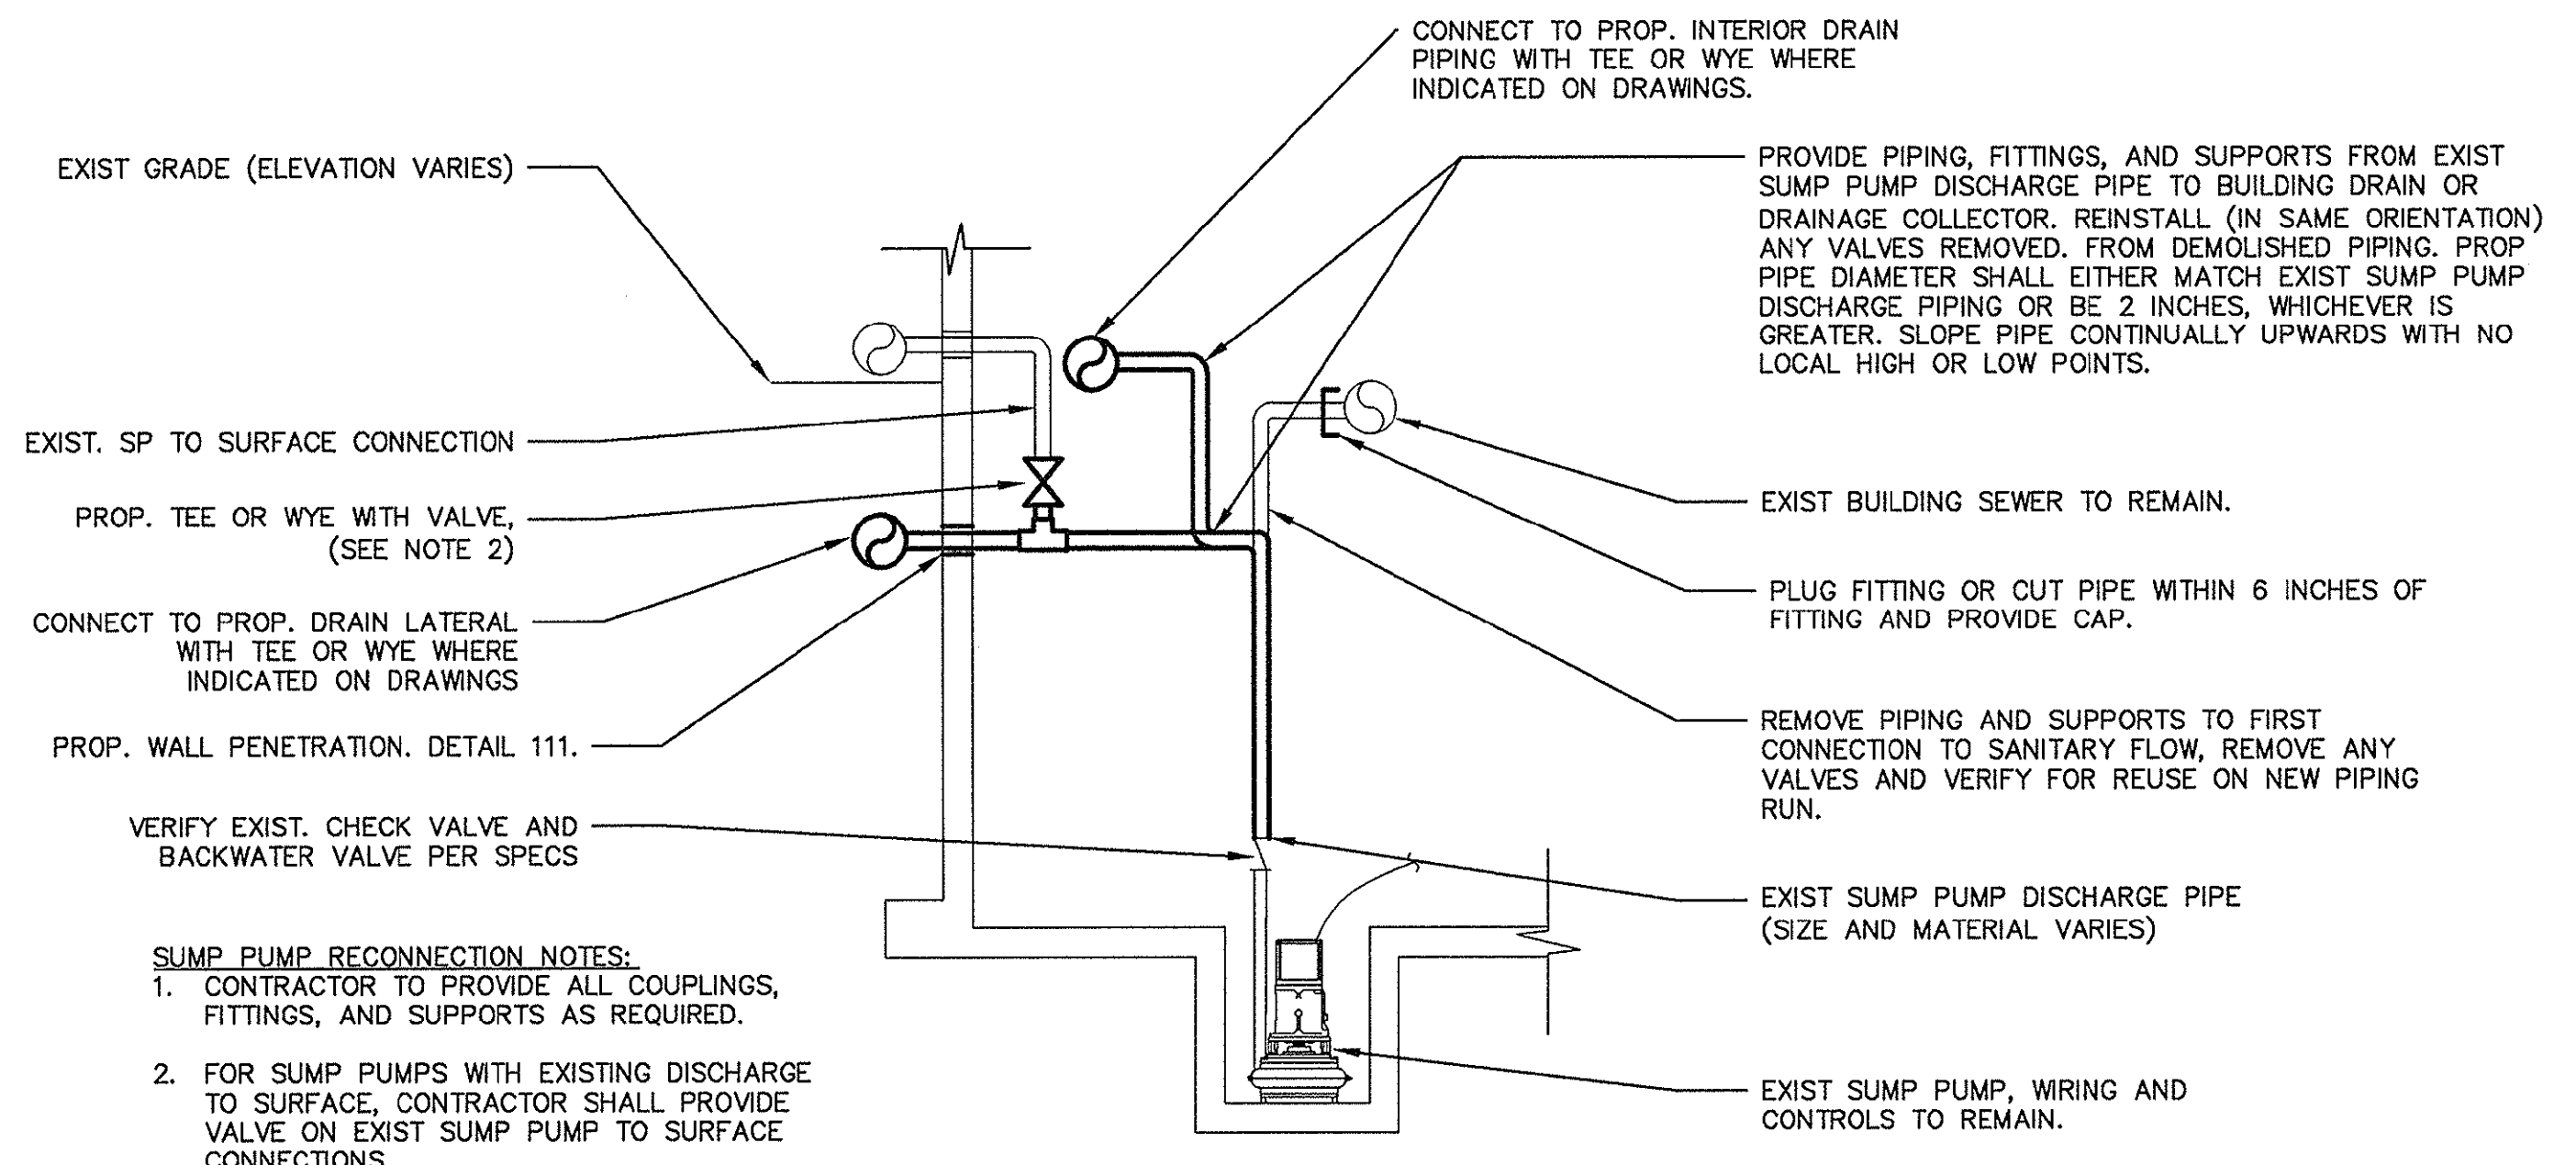

SUMP PUMP RECONNECTION NOTES:
 1. CONTRACTOR TO PROVIDE ALL COUPLINGS, FITTINGS, AND SUPPORTS AS REQUIRED.
 2. FOR SUMP PUMPS WITH EXISTING DISCHARGE TO SURFACE, CONTRACTOR SHALL PROVIDE VALVE ON EXIST SUMP PUMP TO SURFACE CONNECTIONS.

SUMP PUMP RECONNECTION 110

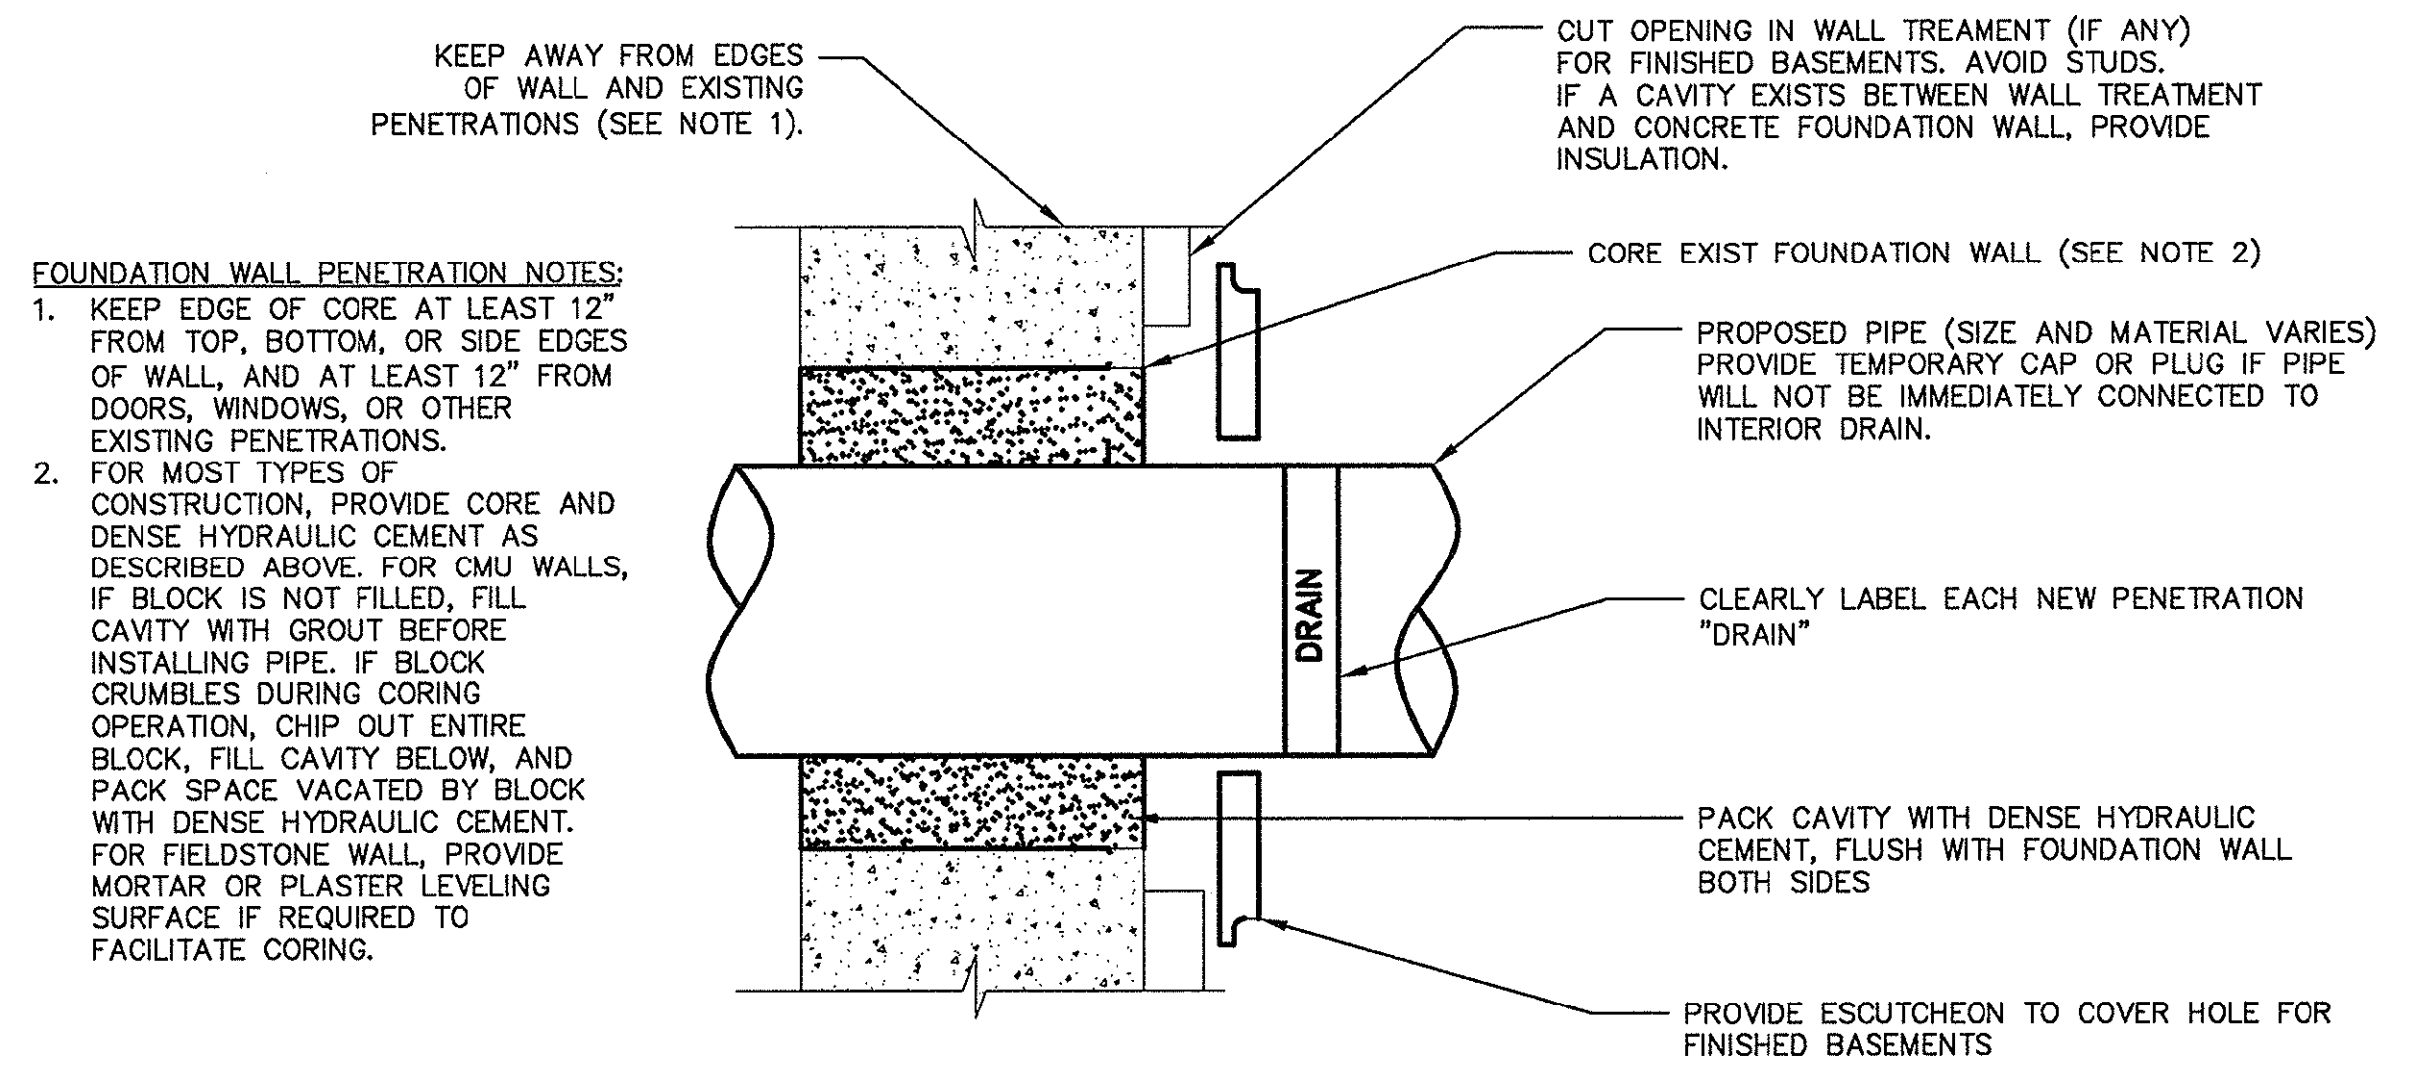


FOUNDATION WALL PENETRATION NOTES:
 1. KEEP EDGE OF CORE AT LEAST 12" FROM TOP, BOTTOM, OR SIDE EDGES OF WALL, AND AT LEAST 12" FROM DOORS, WINDOWS, OR OTHER EXISTING PENETRATIONS.
 2. FOR MOST TYPES OF CONSTRUCTION, PROVIDE CORE AND DENSE HYDRAULIC CEMENT AS DESCRIBED ABOVE. FOR CMU WALLS, IF BLOCK IS NOT FILLED, FILL CAVITY WITH GROUT BEFORE INSTALLING PIPE. IF BLOCK CRUMBLES DURING CORING OPERATION, CHIP OUT ENTIRE BLOCK, FILL CAVITY BELOW, AND PACK SPACE VACATED BY BLOCK WITH DENSE HYDRAULIC CEMENT. FOR FIELDSTONE WALL, PROVIDE MORTAR OR PLASTER LEVELING SURFACE IF REQUIRED TO FACILITATE CORING.

FOUNDATION WALL PENETRATION 111

CONFORMED SET

PLOTTED: 12/12/2014 6:16 PM BY: nick.mind LAYOUT: CP11

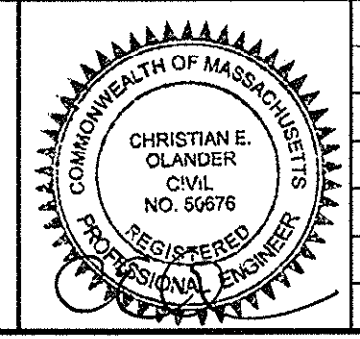

Scale	NO SCALE			
Date	JANUARY 27, 2014			
Job No.	20120256.001A			
Designed by	KWG			
Drawn by	PBR			
Checked by	AML	No.	Description	Date
Approved by	EO		REVISIONS	



Client	CITY OF CAMBRIDGE, MASSACHUSETTS
Project	CONCORD (CONTRACT 9) SEWER SEPARATION AND SURFACE IMPROVEMENTS PROJECT
Drawing	PRIVATE INFLOW REMOVAL DETAILS III

Sheet	CP-11
File No.	