# F--Mobile

T-MOBILE NORTHEAST LLC

# 01/993.2016 1/12/17 1/15/16

T-MOBILE SITE #: 4DE7040A SITE NAME: BO040/51 BRATTLE ST. 51 BRATTLE ST. CAMBRIDGE, MA 02138

#### GENERAL NOTES

- 1. THE CONTRACTOR SHALL GIVE ALL NOTICES AND COMPLY WITH ALL LAWS, ORDINANCES, RULES, REGULATIONS AND LAWFUL GREERS OF ANY PUBLIC AUTHORITY, MINICIPAL AND UTILITY COMPANY SPECIFICATIONS, AND LOCAL AND STATE JURISDICTIONAL CODES BEARING ON THE PERFORMANCE OF THE WORK, THE WORK PERFORMED ON THE PROJECT AND THE WATERIALS INSTALLED SHALL BE IN STRICT ACCORDANCE WITH ALL APPLICABLE CODES, REGULATIONS, AND ORDINANCES.
- 2. THE ARCHITECT/ENGINEER HAVE MADE EVERY EFFORT TO SET FORTH IN THE CONSTRUCTION AND CONTRACT DOCUMENTS THE COMPLETE SCOPE OF WORK. THE CONTRACTOR BIDDING THE JOB IS REVERTHELESS CAJTIONED THAT MINOR OMISSIONS OR ERRORS IN THE DRAWINGS AND OR SPECIFICATIONS SHALL NOT EXCUSE SAID CONTRACTOR FROM COMPLETING THE PROJECT AND IMPROVEMENTS IN ACCORDANCE WITH THE INTENT OF THESE DOCUMENTS.
- 3. THE CONTRACTOR OR BIDDER SHALL BEAR THE RESPONSIBILITY OF NOTIFYING (IN WRITING) THE LESSEE REPRESENTATIVE OF ANY CONFLICTS, ERRORS, OR OMISSIONS PRIOR TO THE SUBMISSION OF CONTRACTOR'S PROPOSAL OR PERFORMANCE OF WORK. IN THE EVENT OF DISCREPANCIES THE CONTRACTOR SHALL PRICE THE MORE COSTLY OR EXTENSIVE WORK, UNLESS DIRECTED IN WRITING OTHERWISE.
- 4. THE SCOPE OF WORK SHALL INCLUDE FURNISHING ALL MATERIALS, EQUIPMENT, LABOR AND ALL OTHER MATERIALS AND LABOR DEEMED NECESSARY TO COMPLETE THE WORK/PROJECT AS DESCRIBED HEREIN.
- THE CONTRACTOR SHALL VISIT THE JOB SITE PRIOR TO THE SUBMISSION OF BIDS OR PERFORMING WORK TO FAMILIARIZE HIMSELF WITH THE FIELD CONDITIONS AND TO VERIFY THAT THE PROJECT CAN BE CONSTRUCTED IN ACCORDANCE WITH THE CONTRACT DOCUMENTS.
- 6, THE CONTRACTOR SHALL OBTAIN AUTHORIZATION TO PROCEED WITH CONSTRUCTION PRIOR TO STARTING WORK ON ANY ITEM NOT CLEARLY DEFINED BY THE CONSTRUCTION DRAWINGS / CONTRACT DOCUMENTS.
- THE CONTRACTOR SHALL INSTALL ALL EQUIPMENT AND MATERIALS ACCORDING TO THE MANUFACTURER'S / VENDOR'S SPECIFICATIONS UNLESS NOTED OTHERWISE OR WHERE LOCAL CODES OR ORDINANCES TAKE PRECEDENCE.
- THE CONTRACTOR SHALL PROVIDE A FULL SET OF CONSTRUCTION DOCUMENTS AT THE SITE UPDATED WITH THE LATEST REVISIONS AND ADDERNOUMS OR CLARIFICATIONS AVAILABLE FOR THE USE BY ALL PERSONNEL INVOLVED WITH THE PROJECT.
- THE CONTRACTOR SHALL SUPERVISE AND DIRECT THE PROJECT DESCRIBED HEREIN. THE CONTRACTOR SHALL BE SOLELY RESPONSIBLE FOR ALL CONSTRUCTION MEANS, METHODS, TECHNIQUES, SEQUENCES AND PROCEDURES AND FOR COORDINATING ALL PORTIONS OF THE WORK UNDER THE CONTRACT.

- 10. THE CONTRACTOR SHALL BE RESPONSIBLE FOR PROVIDING ALL NECESSARY CONSTRUCTION CONTROL SURVEYS, ESTABLISHING AND MAINTAINING ALL LINES AND GRADES REQUIRED TO CONSTRUCT ALL IMPROVEMENTS AS SHOWN HEREIN.
- THE CONTRACTOR SHALL BE RESPONSIBLE FOR OBTAINING ALL PERMITS AND INSPECTIONS WHICH MAY BE REQUIRED FOR THE WORK BY THE ARCHITECT/PENIBLER, THE STATE, COUNTY OR LOCAL GOVERNMENT AUTHORITY.
- 12. THE CONTRACTOR SHALL MAKE NECESSARY PROVISIONS TO PROTECT EXISTING IMPROVEMENTS, EASEMENTS, PAYING, CURBING, ETC. DURING, CONSTRUCTION. UPON COMPLETION OF WORK, THE CONTRACTOR SHALL REPAIR ANY DAWAGE THAT MAY HAVE OCCURED DUE TO CONSTRUCTION ON OR ABOUT THE PROPERTY.
- 13. THE CONTRACTOR SHALL KEEP THE GENERAL WORK AREA CLEAN AND HAZARD FREE DURING CONSTRUCTION AND DISPOSE OF ALL DIRT, DEBRIS, RUBBISH AND REMOVE EQUIPMENT NOT SPECIFIED AS REMAINING ON THE PROPERTY. PREMISES SHALL BE LEFT IN CLEAN CONDITION AND FREE FROM PAINT SPOTS, DUST, OR SMUDGES OF ANY NATURE.
- THE CONTRACTOR SHALL COMPLY WITH ALL OSHA REQUIREMENTS AS THEY APPLY TO THIS PROJECT.
- 15. THE CONTRACTOR SHALL NOTIFY THE LESSEE REPRESENTATIVE WHERE A CONFLICT DOCUMEN ON ANY OF THE CONTRACT DOCUMENTS. THE CONTRACTOR IS NOT TO ORDER MATERIAL OR CONSTRUCT ANY PORTION OF THE WORK THAT IS IN CONFLICT UNTIL CONFLICT IS RESOLVED BY THE LESSEE REPRESENTATIVE.
- THE CONTRACTOR SHALL VERIFY ALL DIMENSIONS, ELEVATIONS, PROPERTY LINES, ETC. ON THE JOB.
- 17. ALL UNDERGROUND UTILITY INFORMATION WAS DETERMINED FROM SURFACE INVESTIGATIONS AND EXISTING PLANS OF RECORD. THE CONTRACTOR SHALL LOCATE ALL UNDERGROUND UTILITIES IN THE FIELD PRIOR TO ANY SITE WORK. CALL THE FOLLOWING FOR ALL PRE-CONSTRUCTION NOTIFICATION 72—HOURS PRIOR TO ANY EXCAVATION ACTIVITY. DIG SAFE SYSTEM (MA, ME, NH, RI, VT): 1—888—344—7233 CALL BEFORE YOU DIG
- 18. PER FCC MANDATE, ENHANCED EMERGENCY (E911)
  SERVICE IS REQUIRED TO MEET NATIONWIDE
  STANDARDS FOR WIRELESS COMMUNICATIONS
  SYSTEMS. PROJECT OWNER IMPLEMENTATION
  REQUIRES DEPLOYMENT OF EQUIPMENT AND
  AMTENNAS GENERALLY DEPICTED ON THIS PLAN,
  ATTACHED TO OR MOUNTED IN CLOSE PROXIMITY TO
  THE BTS RADIO CASINETS. THE PROJECT OWNER
  RESERVES THE RIGHT TO MAKE REASONABLE
  MODIFICATIONS TO E911 EQUIPMENT AND LOCATION
  AS TECHNOLOGY EVOLVES TO MEET REQUIRED

# Church St VICINITY MAP VICINITY MAP

SHT. NO.	DESCRIPTION	REV.
T-1	TITLE SHEET	2
A-1	ROOF PLAN	2
A-2	ELEVATION	2
A-3	CONSTRUCTION DETAILS I	2
A-4	CONSTRUCTION DETAILS II	2
E-1	GROUNDING DETAILS, PARTIAL DIAGRAM & NOTES	2
		E
		+

SHEET INDEX

Ì	PROJECT SUM	MARY		
1	SITE NUMBER:	4DE7040A		
1	SITE NAME:	BOO40/51 BRATTLE STREET		
1	SITE ADDRESS:	51 BRATTLE STREET CAMBRIDGE, MA 02138		
1	ZONING DISTRICT:	BA		
1	MAP/LOT NO .:	169/14		
1	CONSTRUCTION TYPE:	ROOF TOP		
	PROPERTY OWNER:	PRESIDENT & FELLOWS OF HARVARD COLLEGE C/O HARVARD REAL ESTATE, INC. HOLYOKE CENTER ROOM 1000 1350 MASSACHUSETTS AVE. CAMBRIDGE, MA 02138		
	APPLICANT, LESSEE/LICENSEE, PROJECT OWNER:	T-MOBILE NORTHEAST LLC, 15 COMMERCE WAY, SUITE B NORTON, MA 02766		

THIS DOCUMENT WAS DEVELOPED TO REFLECT A SPECIFIC SITE AND ITS SITE CONDITIONS AND IS NOT TO BE USED FOR ANOTHER SITE OR WHEN OTHER CONDITIONS PERTAIN. REUSE OF THIS DOCUMENT IS AT THE SOLE RISK OF THE USER,

A.D.A. COMPLIANCE: FACILITY IS UNMANNED AND NOT FOR HUMAN HABITATION.

T - Mobile -

15 COMMERCE WAY, RUITE B HORTON, MA 63740 PHONE: (508) 286-2760 FAX: (508) 286-2893

## Dewberry\*

Dewberry Engineers Inc. 280 SUMMER STREET 10TH FLOOR BOSTON, MA 02210 PHONE: 817.895.3400 FAX: 817.895.3410



_	SITE OF NEIGUIATION:
	702CU
	APPROVALS
LAN	DLORD
LEAS	SING
R.F.	
ZON	ING
CON	STRUCTION
A/E	

PROJECT NO: 50063157

JOB NO: 50063193

DRAWN BY: SK

CHECKED BY: OAS

Г	SUB	MITTALS
2	11/09/16	FOR CONSTRUCTION
-1	11/08/16	FOR CONSTRUCTION
0	08/04/15	FOR CONSTRUCTION
В	07/27/15	FOR REVIEW
A	06/25/15	FOR REVIEW

4DE7040A
51 BRATTLE STREET
51 BRATTLE STREET
CAMBRIDGE, MA 02138

CUEET THE

TITLE SHEET


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T-1

#### DO NOT SCALE DRAWINGS

CONTRACTOR SHALL VERIFY ALL PLANS AND EXISTING DIMENSIONS AND CONDITIONS ON THE JOB SITE AND SHALL IMMEDIATELY NOTIFY THE T.-MOBILE NORTHEAST LLC, REPRESENTATIVE IN WRITING OF DISCREPANCIES BEFORE PROCEEDING WITH THE WORK OR BE RESPONSIBLE FOR SAME.

THIS DOCUMENT IS THE CREATION, DESIGN, PROPERTY AND COPYRIGHTED WORK OF T-MOBILE NORTHEAST LLC. ANY DUPLICATION OR USE WITHOUT EXPRESS WRITTEN CONSENT IS STRICTLY PROHIBITED. DUPLICATION AND USE BY GOVERNMENT AGENCIES FOR THE PURPOSES OF CONDUCTING THEIR LAWFULLY AUTHORIZED REGULATORY AND ADMINISTRATIVE FUNCTIONS IS SPECIFICALLY ALLOWED.

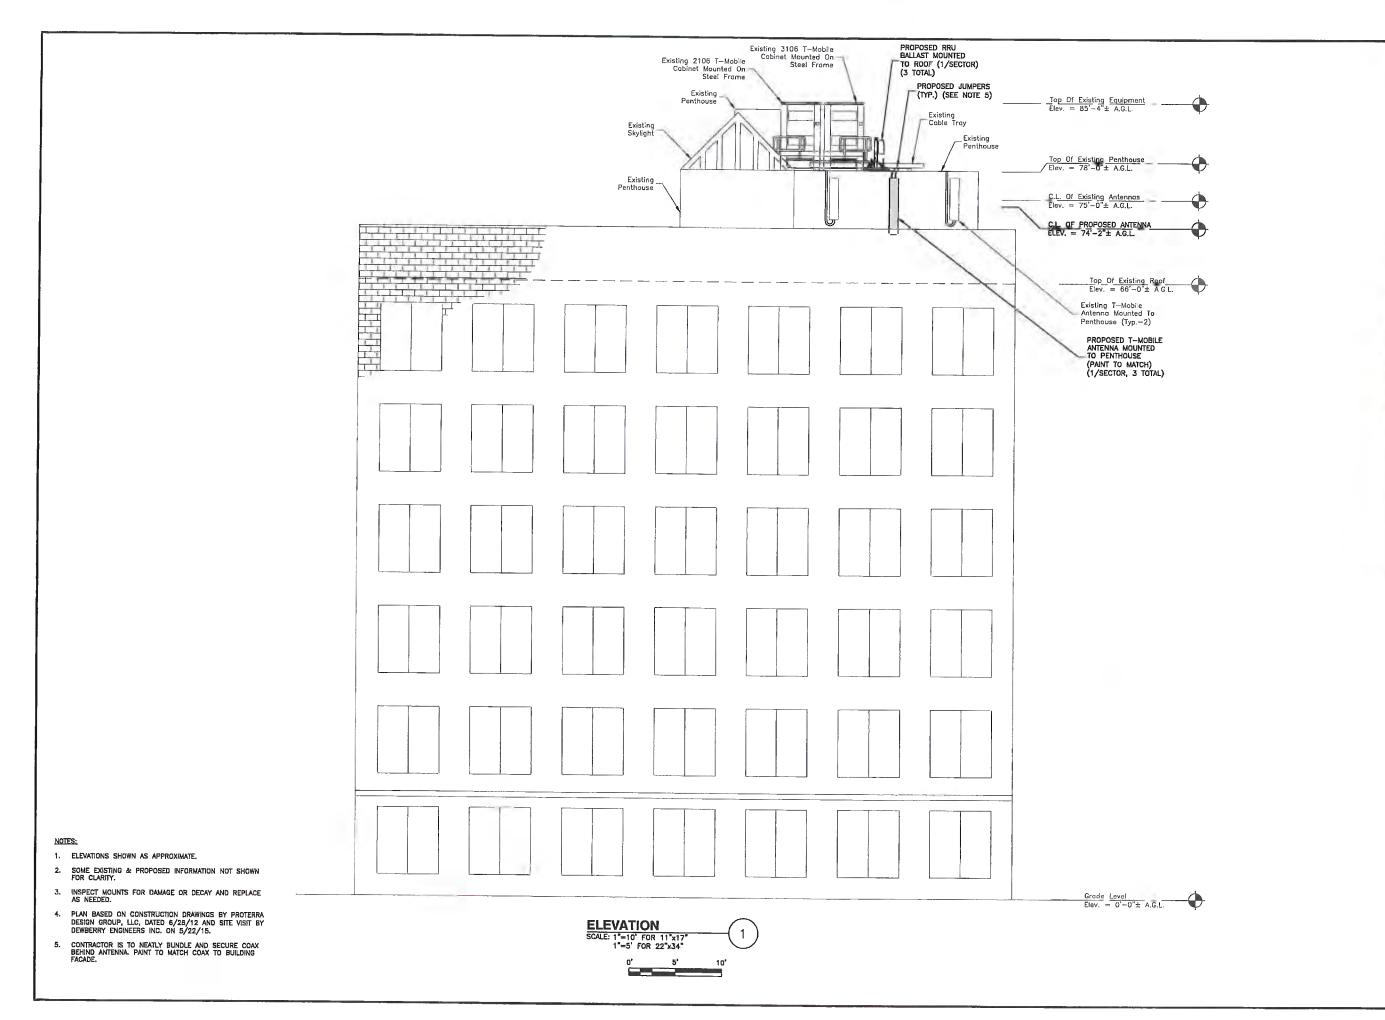

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A DELAWARE LIMITED LIABILITY CO

15 COMMERCE WAY, SUITE B NORTON, MA 02766 PHONE: (508) 285-2700



Dewberry Engineers Inc. 280 SUMMER STREET 10TH FLOOR BOSTON, MA 02210 PHONE: 617.695,3400 FAX: 617.695,3310



SITE CONFIGURATION: 702CU APPROVALS LANDLORD

LEASING R.F.

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PROJECT NO: 50063157

JOB NO: 50063193

DRAWN BY: SK

OAS

CHECKED BY:

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51 BRATTLE STREET

51 BRATTLE STREET CAMBRIDGE, MA 02138


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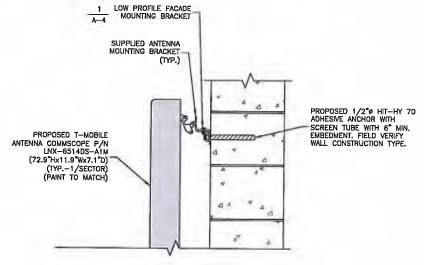
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#### \*NOTES:

- VERIFY VERTICAL CENTER TO CENTER MEASUREMENT WITH ANTENNA MANUFACTURER.
- CONTRACTOR IS TO NEATLY BUNDLE AND SECURE COAX BEHIND ANTENNA. PAINT TO MATCH COAX TO BUILDING FACADE.





#### \*NOTES:

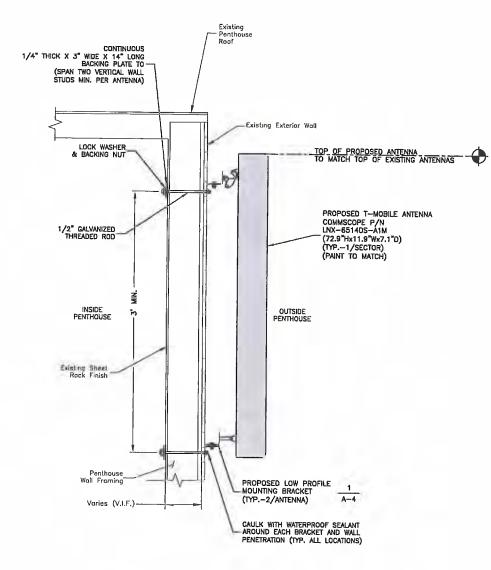- 1. NO MORE THAN 1 ANCHOR PER CELL.
- 2. MIN. DESISTANCE TO FREE EDGE 12".
- 3. ANCHORS TO BE INSTALLED THROUGH THE CMU BLOCK AND NOT AT THE GROUTS JOINTS.
- 4. CONTRACTOR IS TO NEATLY BUNDLE AND SECURE COAX BEHIND ANTENNA. PAINT TO MATCH COAX TO BUILDING FACADE.

ANCHOR DETAIL FOR HOLLOW MASONRY
SCALE: N.T.S. 2

T-MOBILE RF SYSTEM SCHEDULE*					
	EXISTING ANTENNA		EXI	EXISTING/PROPOSED ANTENNA	
SECTOR	QTY.	ANTENNA MODEL & DIMENSIONS	QTY.	ANTENNA MODEL & DIMENSIONS	
	1	ERICSSON AIR21 B2A/B4P (56"Hx12"Wx7.9"D)	1	ERICSSON AIR21 B2A/B4P (56"Hx12"Wx7.9"D)	
ALPHA	1	ERICSSON AIR21 B4A/82P (56"Hx12"Wx7.9"D)	1	COMMSCOPE LNX-6514DS-A1M (72.9"Hx11.9"Wx7.1"D)	
	_		1	ERICSSON AIR21 B4A/B2P (56"Hx12"Wx7.9"D)	
	1	ERICSSON AIR21 B2A/B4P (56"Hx12"Wx7.9"D)	1	ERICSSON AIR21 B2A/B4P (56"Hx12"Wx7.9"D)	
BETA	1	ERICSSON AIR21 B4A/B2P (56"Hx12"Wx7.9"D)	1	COMMSCOPE LNX-6514DS-A1M (72.9"Hx11.9"Wx7.1"D)	
	_	-	1	ERICSSON AIR21 B4A/B2P (56"Hx12"Wx7.9"D)	
	1	ERICSSON AIR21 B2A/B4P (56"Hx12"Wx7 9"D)	1	ERICSSON AIR21 B2A/B4P (56"Hx12"Wx7.9"D)	
GAMMA	1	ERICSSON AIR21 B4A/B2P (56"Hx12"Wx7.9"D)	1	COMMSCOPE LNX-6514DS-A1M (72.9"Hx11.9"Wx7.1"D)	
			1	ERICSSON A:R21 B4A/B2P (56"Hx12"Wx7.9"D)	
*VERIFY ALL INFORMATION WITH LATEST RF DATA SHEET AND T-MOBILE RF PRIOR TO CONSTRUCTION					

RF SCHEDULE SCALE: N.T.S.

(3)

T - Mobile-

T-MOBILE NORTHEAST LLC A DELAWARE LIMITED LIABILITY COMPA

> 15 COMMERCE WAY, SUITE B HORTON, MA 02766 PHONE: (508) 286-2700

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SITE CONFIGURATION:
702CU
APPROVALS
LANDLORD

LEASING \_\_\_\_\_\_\_\_\_R.F. \_\_\_\_\_\_ZONING \_\_\_\_\_\_

CONSTRUCTION \_

JOB NO:

PROJECT NO: 50063157

50063193

DRAWN BY: SK

CHECKED BY: OAS

SUBMITTALS

2 11/09/16 FOR CONSTRUCTION
1 11/08/16 FOR CONSTRUCTION
0 08/04/15 FOR CONSTRUCTION
B 07/27/15 FOR REVIEW
A 06/25/15 FOR REVIEW

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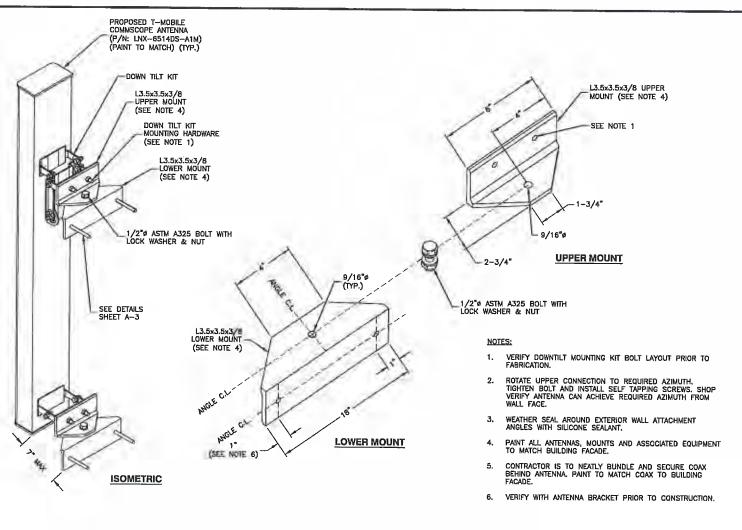
51 BRATTLE STREET
51 BRATTLE STREET
CAMBRIDGE, MA 02138

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CONSTRUCTION DETAILS

SHEET NUMBER


A-3



LOW PROFILE FACADE MOUNT

CABLE TRAY DETAIL
SCALE: N.T.S.

3

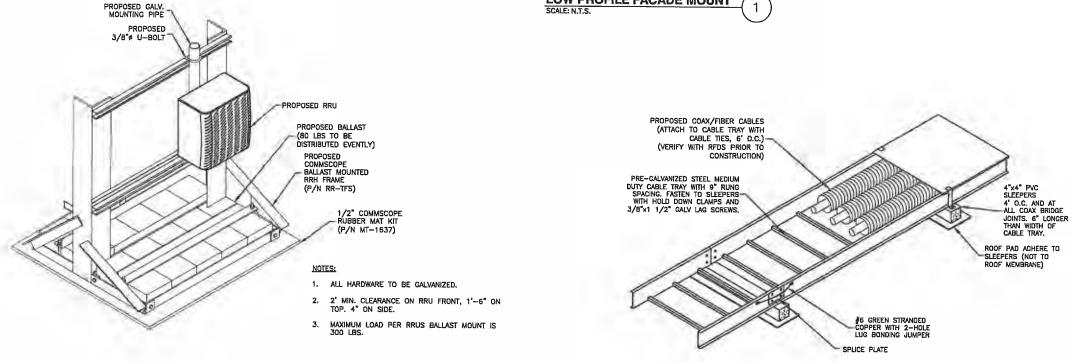

RRH BALLAST FRAME DETAIL
SCALE: N.T.S.

2

**T**--Mobile-

T-MOBILE NORTHEAST LLC
A DELAWARE LIMITED LIABILITY COMPANY

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1	SITE CONFIGURATION:		
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	CONSTRUCTION		
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PROJECT	NO:	50063157
JOB NO:		50063193

SK

CHECKED	BY:	OAS

DRAWN BY:

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51 BRATTLE STREET


51 BRATTLE STREET CAMBRIDGE, MA 02138

CONSTRUCTION DETAILS


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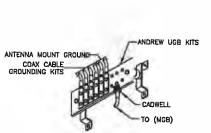
#### **ELECTRICAL & GROUNDING NOTES**


- ALL ELECTRICAL WORK SHALL CONFORM TO THE REQUIREMENTS
  OF THE NATIONAL ELECTRICAL CODE (NEC) AS WELL AS APPLICABLE
  STATE AND LOCAL CODES.
- ALL ELECTRICAL ITEMS SHALL BE U.L. APPROVED OR LISTED AND PROCURED PER SPECIFICATION REQUIREMENTS.
- THE ELECTRICAL WORK INCLUDES ALL LABOR AND MATERIAL DESCRIBED BY DRAWINGS AND SPECIFICATION INCLUDING INCIDENTAL WORK TO PROVIDE COMPLETE OPERATING AND APPROVED ELECTRICAL SYSTEM.
- GENERAL CONTRACTOR SHALL PAY FEES FOR PERMITS, AND IS RESPONSIBLE FOR OBTAINING SAID PERMITS AND COORDINATION OF INSPECTIONS.
- ELECTRICAL AND TELCO WIRING OUTSIDE A BUILDING AND EXPOSED TO WEATHER SHALL BE IN WATER TIGHT GALVANIZED RIGID STEEL CONDUITS OR SCHEDULE BO PVC (AS PERMITTED BY CODE) AND WHERE REQUIRED IN LIQUID TIGHT FLEXIBLE METAL OR NONMETALLIC CONDUITS.
- 6. RIGID STEEL CONDUITS SHALL BE GROUNDED AT BOTH ENDS.
- ELECTRICAL WIRING SHALL BE COPPER WITH TYPE XHHW, THWN, OR THIN INSULATION.
- RUN ELECTRICAL CONDUIT OR CABLE BETWEEN ELECTRICAL UTILITY
  DEWARCATION POINT AND LESSEE/LICENSEE CELL SITE PPC AS INDICATED
  ON THIS DRAWING. PROVIDE FULL LENGTH PULL ROPE. COORDINATE
  INSTALLATION WITH UTILITY COMPANY.
- RUN TELCO CONDUIT OR CABLE BETWEEN TELEPHONE UTILITY
  DEMARCATION POINT AND LESSEE/LICENSEE CELL SITE TELCO CABINET
  AND BTS CABINET AS INDICATED ON THIS DRAWING PROVIDE FULL LENGTH
  PULL ROPE IN INSTALLED TELCO CONDUIT. PROVIDE GREENLEE CONDUIT
  MEASURING TAPE AT EACH END.
- 10. ALL EQUIPMENT LOCATED OUTSIDE SHALL HAVE NEMA 3R ENCLOSURE.
- 11. GROUNDING SHALL COMPLY WITH NEC ART. 250.
- 12. GROUND COAXIAL CABLE SHIELDS MINIMUM AT BOTH ENDS USING MANUFACTURER'S COAX CABLE GROUNDING KITS SUPPLIED BY
- 13. USE #6 COPPER STRANDED WIRE WITH GREEN COLOR INSULATION FOR GROUNDING (UNLESS OTHERWISE SPECIFIED) AND #2 SOLID TINNED BARE COPPER WIRE FOR BELOW GRADE GROUNDING AS INDICATED ON THE
- ALL GROUND CONNECTIONS TO BE BURNDY HYGROUND COMPRESSION TYPE CONNECTORS OR CADWELD EXOTHERMIC WELD, DO NOT ALLOW BARE COPPER WIRE TO BE IN CONTACT WITH GALVANIZED STEEL.
- 15. ROUTE GROUNDING CONDUCTORS ALONG THE SHORTEST AND STRAIGHTEST PATH POSSIBLE, EXCEPT AS OTHERWISE INDICATED. GROUNDING LEADS SHOULD NEVER BE BENT AT RIGHT ANGLE. ALWAYS MAKE AT LEAST 12" RADIUS BENDS. #6 WIRE CAN BE BENT AT 6" RADIUS WHEN NECESSARY.
  BOND ANY METAL OBJECTS WITHIN 6 FEET OF LESSEE/LICENSEE
  EQUIPMENT OR CABINET TO MASTER GROUND BAR OR GROUNDING RING.
- CONNECTIONS TO GROUND BARS SHALL BE MADE WITH TWO HOLE COMPRESSION TYPE COPPER LUGS. APPLY OXIDE INHIBITING COMPOUND TO ALL LOCATIONS.
- 17. APPLY OXIDE INHIBITING COMPOUND TO ALL COMPRESSION TYPE GROUND CONNECTIONS.
- BOND ANTENNA MOUNTING BRACKETS, COAXIAL CABLE GROUND KITS, AND ALNA TO EGB PLACED NEAR THE ANTENNA LOCATION.
- 19. BOND ANTENNA EGBS AND MGB TO GROUND RING.
- TEST COMPLETED GROUND SYSTEM AND RECORD RESULTS FOR PROJECT CLOSE—OUT DOCUMENTATION. 5 OHMS MINIMUM RESISTANCE REQUIRED.
- BOND ANY METAL OBJECT WITHIN 7 FEET OF THE PROPOSED EQUIPMENT OR CABINET TO MASTER GROUND BAR.
- 22. VERIFY PROPOSED SERVICE UPGRADE WITH LOCAL UTILITY COMPANY PRIOR TO CONSTRUCTION.

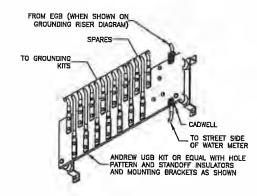

MASTER GROUND BAR (MGB)/



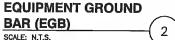


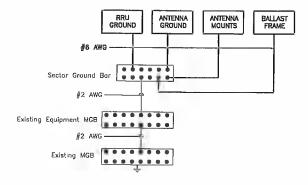

- 1. ALL PROPOSED EQUIPMENT TO BE GROUNDED TO SECTOR
- 2. TYPICAL FOR FOR ALL SECTORS.
- 3. GROUNDING SHALL COMPLY WITH NEC ART. 250 & T-MOBILE

**SCHEMATIC GROUNDING DIAGRAM** 


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#### NOTES:

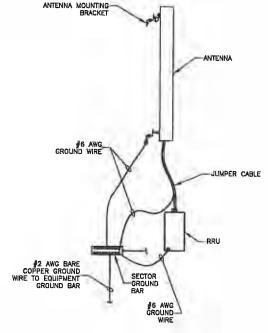- DO NOT INSTALL CABLE GROUND KIT AT A BEND, ALWAYS DIRECT GROUND WIRE DOWN TO GROUND BAR.
- 2. GROUNDING KIT LOCATION & QUANTITY PER CARRIER SPECIFICATIONS.
- 3. WEATHER PROOFING SHALL BE PER CARRIER REQUIREMENTS.

**TYPICAL ANTENNA GROUNDING DETAIL** 



VERIFY REQUIRED BREAKER SIZE WITH T-MOBILE CM FOR UPGRADE. CONTRACTOR TO VERIFY EXISTING PANEL CONDITIONS AND ALL EXISTING WIRNING PRIOR TO INSTALLATION. CONTRACTOR TO CONFIRM EXISTING PANEL HAS CAPACITY FOR BREAKER REQUI

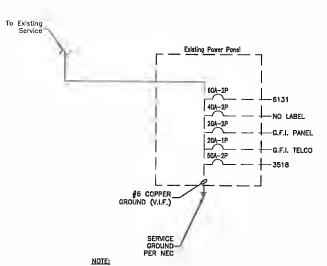**ONE LINE POWER DIAGRAM** SCALE: N.T.S.

# T -- Mobile-

T-MOBILE NORTHEAST LLC



Dewberry Engineers Inc. 280 SUMMER STREET 10TH FLOOR BOSTON, MA 02210 PHONE: 617.695.3400 FAX: 617.695.3310



SITE CONFIGURATION: 702CU **APPROVALS** LANDLORD LEASING **ZONING** CONSTRUCTION A/E

50063157 PROJECT NO:

JOB NO: 50063193

DRAWN BY: CHECKED BY:

OAS SUBMITTALS 2 11/09/16 FOR CONSTRUCTION 1 11/08/16 FOR CONSTRUCTION 0 08/04/15 FOR CONSTRUCTION B 07/27/15 FOR REVIEW A 06/25/15 FOR REVIEW

4DE7040A

51 BRATTLE STREET 51 BRATTLE STREET CAMBRIDGE, MA 02138

GROUNDING DETAILS. PARTIAL DIAGRAM & NOTES

# **Photographic Simulation Package**

Proposed Upgrade to Existing Wireless Telecommunications Facility:

4DE7040A - BO0040 51 Brattle Street Cambridge, MA 02140

- proposed changes to existing Rooftop Mount Antenna Structure
- documentation photographs taken 10/14/16

Simulation package prepared by:

Virtual Site Simulations, LLC 9 walts way Narragansett, Rhode Island 02882


www.VirtualSiteSimulations.com









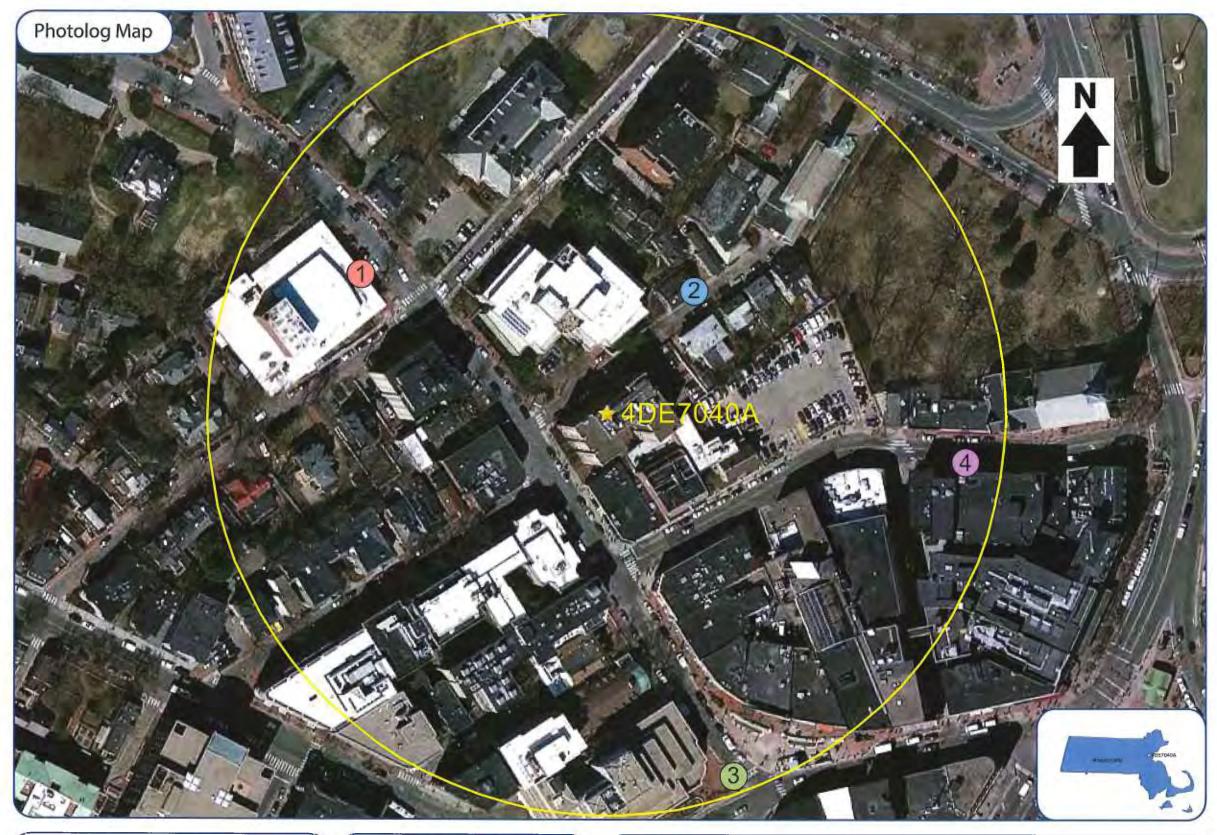

Proposed Upgrade to Existing Wireless Telecommunications Facility:

4DE7040A - BO0040 51 Brattle Street Cambridge, MA 02140

### Legend:



Facility Location



Photo Documentation location









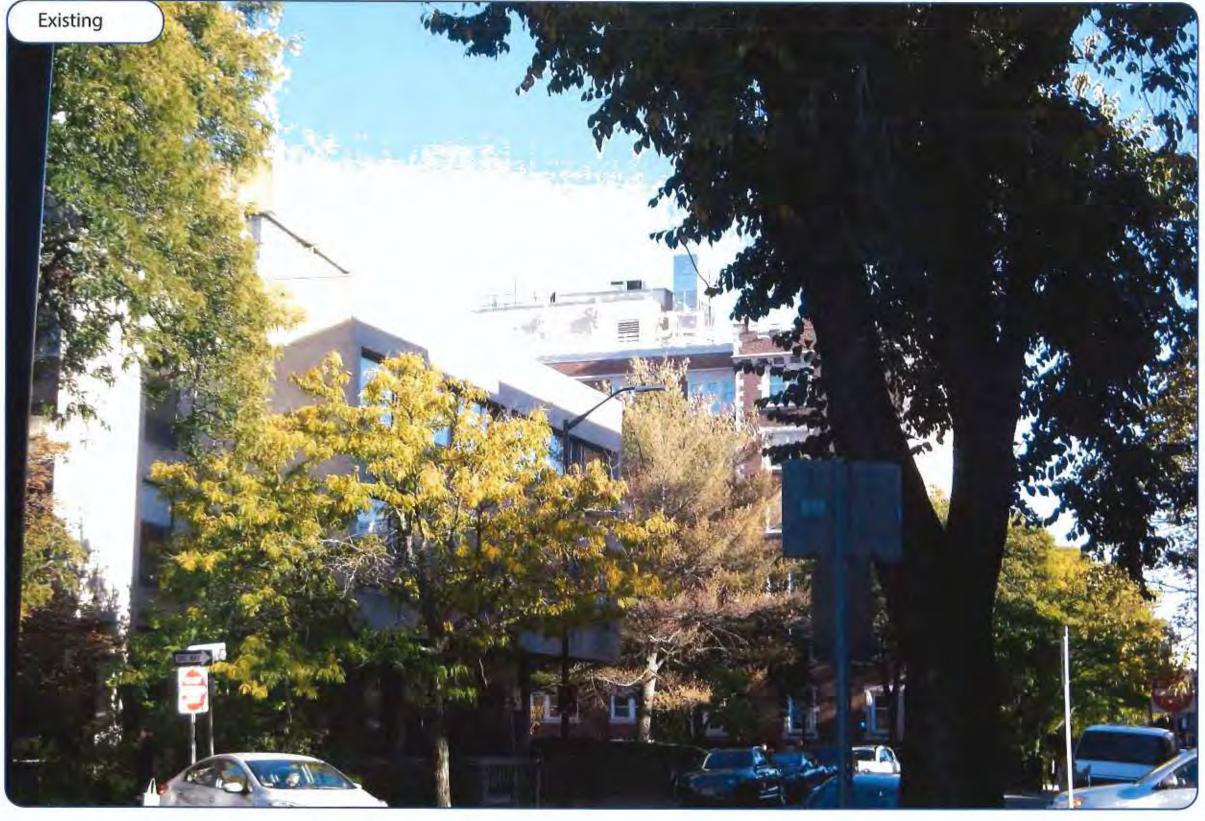


Photo #LocationGps CoordinatesDistance to siteOrientationBearing to siteVisibility1Brattle St. North42.37497 -71.12265+/- 0.07 MilesNorth East115.1Year Round

Site: 4DE7040A - BO0040 51 Brattle Street







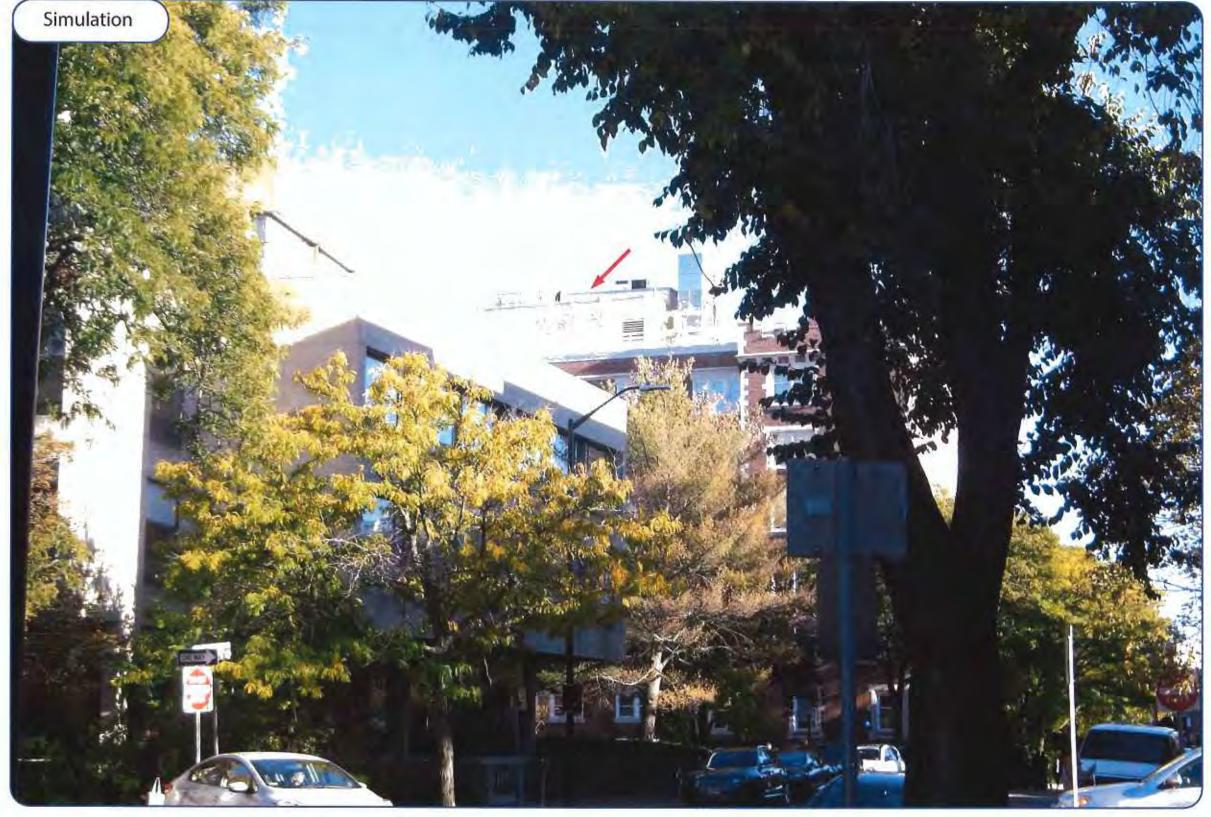


Photo #LocationGps CoordinatesDistance to siteOrientationBearing to siteVisibility1Brattle St. North42.37497 -71.12265+/- 0.07 MilesNorth East115.1Year Round

Site: 4DE7040A - BO0040 51 Brattle Street









Photo #LocationGps CoordinatesDistance to siteOrientationBearing to siteVisibility2Farwell Pl.42.37492 -71.12111 +/- 0.04 MilesNorth West227.74Year Round

Site: 4DE7040A - BO0040 51 Brattle Street







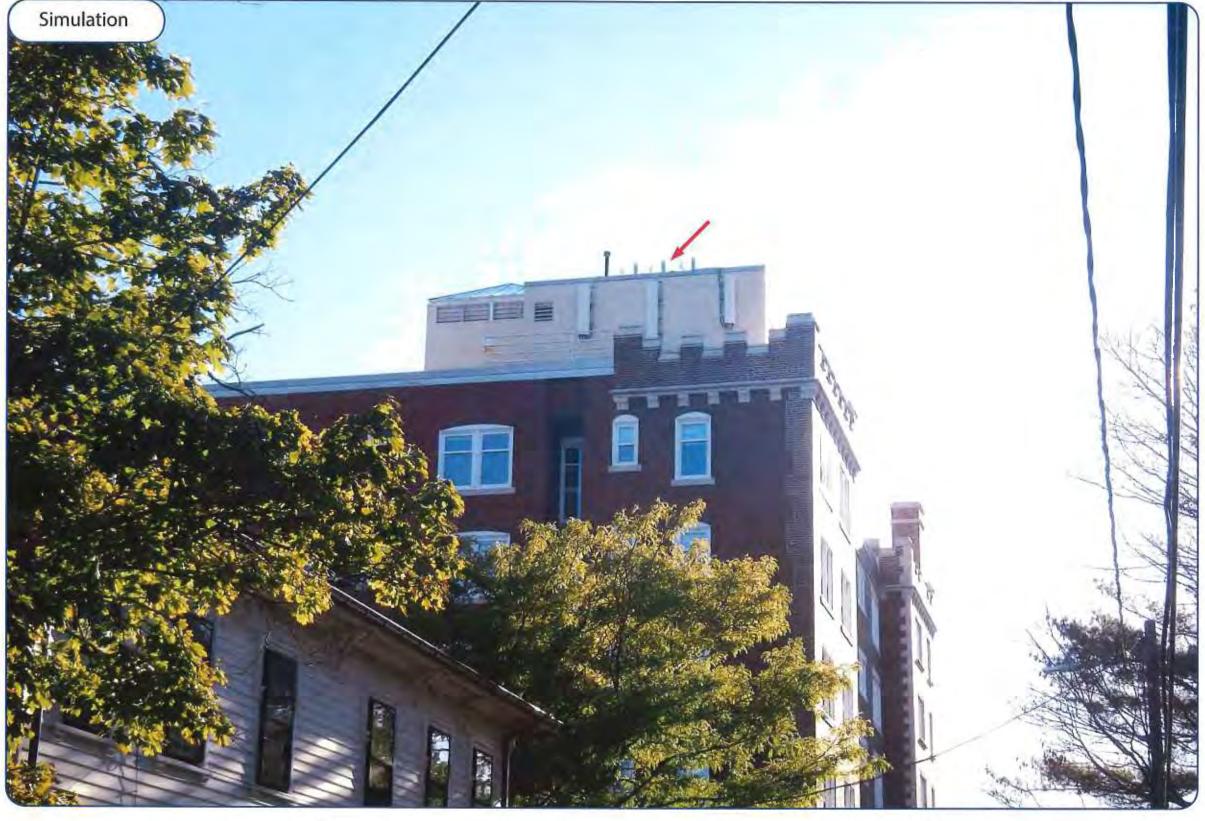


Photo #LocationGps CoordinatesDistance to siteOrientationBearing to siteVisibility2Farwell Pl.42.37492 -71.12111+/- 0.04 MilesNorth West227.74Year Round

Site: 4DE7040A - BO0040 51 Brattle Street









Photo #	Location	Gps Coordinates	Distance to site	Orientation	Bearing to site	Visibility
3	Brattle St. South	42.37326 -71.12091	+/- 0.09 Miles	South West	337.43	Year Round









Photo #	Location	Gps Coordinates		Distance to site	Orientation	Bearing to site	Visibility
3	Brattle St. South	42.37326	-71.12091	+/- 0.09 Miles	South West	337.43	Year Round









Photo #	Location	Gps Coordinates	Distance to site	Orientation	Bearing to site	Visibility
4	Chruch St.	42.37433 -71.11985	+/- 0.09 Miles	West	279.86	Year Round









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Photo #	Location	Gps Coordinates	Distance to site	Orientation	Bearing to site	Visibility	
4	Chruch St.	42.37433 -71.11985	+/- 0.09 Miles	West	279.86	Year Round	





