0-Cove	r Sheet		
A-000	Cover Sheet	08/11/2021	
1- Civil			
C-1	Drainage Plan	08/10/2021	
C-2	Details	08/10/2021	
C-3	Details	08/10/2021	

2- Landso	ape		
L-1	Landscape Plan	09/03/2021	

L-1	Landscape Plan	09/03/2021	
3-Archite	ectural		
A-001	General Notes & Abbreviations	08/11/2021	
A-010	Code Review & Egress Calculations	08/11/2021	
A-015	Fenestration Diagram	08/11/2021	
A-016	Bike Path Layout	08/31/21	09/08/2021
A-020	Architectural Site Plan	08/11/2021	09/08/2021
A-021	Area Plans	08/11/2021	
A-100	Basement, First & Second Floor Plans	08/11/2021	
A-100.1	Foundation Plan	08/11/2021	
A-101	Third Floor & Roof Plans	08/11/2021	
A-110	Enlarged Basement Plan	08/11/2021	
A-111	Enlarged First Floor Plans	08/11/2021	
A-112	Enlarged Second Floor Plan	08/11/2021	
A-113	Enlarged Third Floor Plan	08/11/2021	
A-200	Basement & 1ST Floor RCP	08/11/2021	
A-201	2nd & 3rd Floor RCP	08/11/2021	
A-300	Exterior Elevations	08/11/2021	
A-400	Longitudinal Section Left	08/11/2021	
A-401	Longitudinal Section Right	08/11/2021	
A-402	Cross Section 1	08/11/2021	
A-403	Cross Section 2	08/11/2021	
A-500	Section Details	08/11/2021	
A-520	Typical Roof Details	08/11/2021	
A-530	Typ. Hardie Lap Siding Details	08/11/2021	
A-531	Typ. Hardie Panel Siding details	08/11/2021	
A-532	Typ. Firestop & Penetration Details	08/11/2021	
A-610	Common Toilets Plans & Interior Elevations	08/11/2021	
A-701	Lula Lift Section	08/11/2021	
A-710	Stair Details	08/11/2021	

Drawing List			
Sheet Number	Sheet Name	Sheet Issue Date	Current Revision Date
A-800	Door & Window Schedule	08/11/2021	
A-801	Window Details	08/11/2021	
A-802	Door & Finish Floor Details	08/11/2021	
A-810	Partition Types	08/11/2021	
AV-3	PROPOSED RENDERING FROM PARK	09/07/21	09/08/2021

S-001	Foundation Plan	08/05/21
S-002	First Floor Framing	08/05/21
S-003	Second Floor Framing	08/05/21
S-004	Third Floor Framing	08/05/21
S-005	Roof Plan	08/05/21
S-006	Typical Details	08/05/21

5-Mecha	anical		
H-100	Basement, First & Second Floor HVAC Plans	02/08/21	
H-101	Third Floor & Roof HVAC Plans	02/08/21	
H-200	HVAC Notes & Schedules	02/08/21	
H-201	HVAC Schedules	02/08/21	
H-202	HVAC Details	02/08/21	
H-203	HVAC Details	02/08/21	

6-Electrica	al		
E-100	Power Plans	02/08/21	
E-101	Power Plans	02/08/21	
E-200	Lighting Plans	02/08/21	
E-201	Lighting Plans	02/08/21	
E-300	Electrical Notes	02/08/21	
E-301	Electrical Notes	07/15/21	

FA-200	Fire Alarm Notes	02/08/21	
8-Fire Pro	tection		
FP-100	Fire Protection Plans	02/08/21	
FP-101	Fire Protection Plans	02/08/21	
FP-200	Fire Protection Details	02/08/21	

02/08/21

	9-Plumbing		
	P-100	Basement, First & Second Floor Plumbing Plans	02/08/21
	P-101	Third Floor & Roof Plumbing Plans	02/08/21
	P-200	Plumbing Notes & Schedules	02/08/21
	P-201	Plumbing Notes	02/08/21
L COLIC MAD	P-202	Plumbing Details	02/08/21
LOCUS MAP	P-203	Plumbing Details	02/08/21
	P-204	Plumbing Risers	02/08/21

FP-201 Fire Protection Legend, Schedule and Specification 02/08/21

FA-100 Fire Alarm Plans FA-101 Fire Alarm Plans





PROJECT: ONE CEDAR ST MIXED-USE

PROJECT ADDRESS:
1 CEDAR STREET
CAMBRIDGE, MASSACHUSETTS

ARCHITECT
KHALSA DESIGN INC.
ADDRESS:
17 IVALOO STREET, SUITE 400

SOMERVILLE, MA 02143 T:(617) 591-8682

<u>CIVIL ENGINEER</u> **SPRUHAN ENGENEERING, P.C.**

ADDRESS: 80 JEWETT STREET, SUITE 2 NEWTON, MA 02458 T: (617) 816-0722 EMAIL: edmond@spruhaneng.com

MEP ENGINEER
ZADE ASSOCIATES LLC
ADDRESS:
140 BEACH STREET
BOSTON, MA
T: (617) 338-4406
F: (617) 451-2540

F: (617) 451-2540 W: ZADECO@AOL.com OWNER
1 CEDAR ST., LLC.
ADDRESS:
1 CEDAR STREET
CAMBRIDGE, MA 02140

STRUCTURAL ENGINEER
SPRUHAN ENGENEERING, P.C.
ADDRESS:

80 JEWETT STREET, SUITE 2 NEWTON, MA 02458 T: (617) 816-0722 EMAIL: edmond@spruhaneng.com

PERMIT SET 08/11/2021 REV 1: DESIGN REVIEW 09/08/2021 PROJECT NAME 1 Cedar St Residences PROJECT ADDRESS 1 Cedar Street Cambridge, MA 02140 1 CEDAR ST., LLC. ARCHITEC KHALSA 17 IVALOO STREET SUITE 400 SOMERVILLE, MA 02143 TELEPHONE: 617-591-8682 CONSULTANTS:

PPYRIGHT KOI © 2020
ISSEE DRAWINGS ARE NOW AND DO
ISSEE DRAWINGS ARE NOW AND DO
ISMAN THE SOLE PROPERTY OF KHALSA
ISSIGN INC. USE OF THESE PLANS OR ANY
IRM OF REPRODUCTION OF THIS DESIGN
WHOLE OR IN PART WITHOUT EXPRESS
RITTEN CONSENT IS PROHIBITED AND
IALL RESULT IN THE FULLEST EXTENT
PROSECUTION UNDER LAW

EGISTRATION


Project number 20012			
	SIONS	B.41	
No.	Description	Date	
I	Cayor Cha	٥ŧ	


Cover Sheet


A-000

8/20214:11:12 F



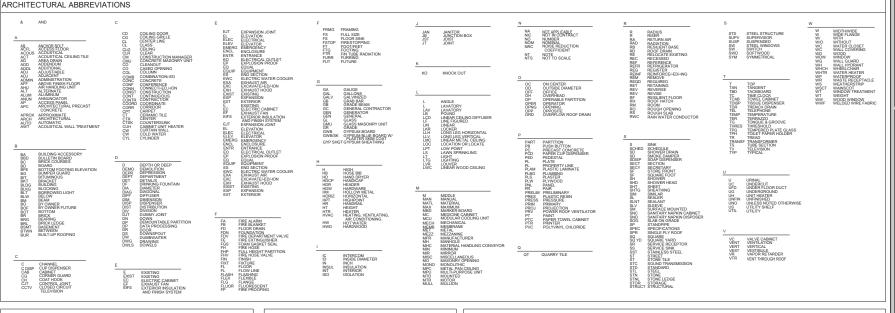

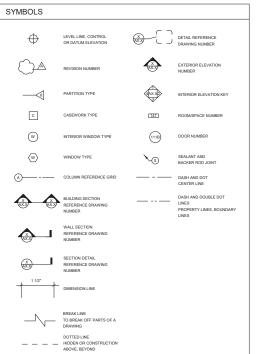

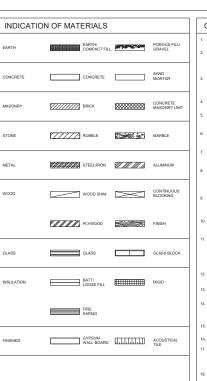

GENERAL NOTES

- GENERAL CONDITIONS: THE GENERAL CONDITIONS FOR THIS CONTRACT SHALL BE AIA DOCUMENT A201 (1987 EDITION) EXCEPT AS HEREIN AMENDED.
- SCOPE: WORK TO INCLUDE DEMOLITION AND CONSTRUCTION AS INDICATED ON THE DRAWINGS NECESSARY FOR A COMPLETE INSTALLATION. EACH CONTRACTOR SHALL RESPECT THE WORK OF OTHER CONTRACTORS AND ARE RESPONSIBLE FOR AND LIABLE TO REPAIR OR REPLACE ANY DAMAGE CAUSED BY THEIR WORK.
- CODES: ALL WORK SHALL BE PERFORMED IN STRICT COMPLIANCE WITH LOCAL AND STATE CODES AND REGULATIONS HAVING JURISDICTION. THE CONTRACTOR SHALL PROTECT AND INDEMNIFY THE OWNER AND ARCHITECT AGAINST. ANY CLAIM OR LIABILITY ARISING FROM ANY SLICH CODE OR REGULATION
- THE CONTRACTOR SHALL OBTAIN AND PAY FOR ALL REQUIRED PERMITS, INSPECTIONS AND
- QUALITY: WORKMANSHIP SHALL BE OF THE HIGHEST TYPE, AND MATERIALS USED OR SPECIFIED OF THE BEST QUALITY THAT THE MARKET AFFORDS. ALL INSTALLATIONS AND APPLICATIONS SHALL CONFORM TO THE MANUFACTURERS SPECIFICATIONS.
- COORDINATION OF THE WORK: THE GENERAL CONTRACTOR SHALL COORDINATE THE WORK CONTRACT FROM THE CONTRACTOR OR THE OWNER. THE CONTRACTORS INSTRUCTIONS SHALL BE FOLLOWED BY
- EXAMINATION OF THE SITE AND DOCLIMENTS: THE CONTRACTOR REFORE SUBMITTING HIS PROPOSAL
- EXAMINATION OF HIS TABLE AND EXAMINE FOR HINSELF ALL CONDITIONS AND LIMITORS WHICH EFFECT THE CONTRACT. THE CONTRACTOR SHALL CAREFULLY EXAMINE ALL CONTRACT DOCUMENTS. TITLES AND SUBDIVISIONS IN THESE DOCUMENTS ARE FOR CONVENIENCE, AND NO REAL OR ALLEGED ERRORS AND SUBDIVISIONS IN THESE DOCUMENTS ARE FOR CONVENIENCE, AND NO REAL OR ALLEGED ERRORS IN ARRANGEMENT OF MATTER SHALL BE REASON FOR OMISSION OR DUPLICATION BY ANY CONTRACTOR SEPARATE CONTRACTS: THE OWNER RESERVES THE RIGHT TO LET OTHER CONTRACTS IN CONNECTION WITH THE WORK. THE GENERAL CONTRACTOR SHALL AFFORD OTHER CONTRACTORS REASONABLE OPPORTUNITY FOR THE EXECUTION OF THEIR WORK AND SHALL PROPERTY CONNECT AND CORDINATE
- HIS WORK WITH THEIRS. GUARANTEE : ALL MATERIALS AND WORKMANSHIP SHALL BE GUARANTEED FOR A PERIOD OF ONE YEAR FROM THE DATE OF FINAL ACCEPTANCE UNLESS SPECIFIED OTHERWISE FOR A LONGER PERIOD OF TIME ON CERTAIN ITEMS.
- TRASH REMOVAL: PRIOR TO STARTING WORK, THE GENERAL CONTRACTOR SHALL PROVIDE A CONSTRUCTION DUMPSTER AND PICKUP SERVICE FOR ALL CONSTRUCTION DEBRIS COLUMPSTER LOCATION TO BE COORDINATED WITH THE OWNER). AT THE END OF EACH DAY, THE GENERAL CONTRACTOR SHALL REMOVE ALL TRASH AND DEBRIS FROM THE SITE AND OR MAY (AT HIS OPTION) PAY FOR THE REMOVAL AND BACK CHARGE THE CONTRACTOR.
- THE CONTRACTOR SHALL VERIFY ALL DIMENSIONS AND CONDITIONS AT THE SITE AND REPORT ANY DISCREPANCIES TO THE ARCHITECT BEFORE PROCEEDING WITH THE WORK.
- 3. ALL SECTIONS, DETAILS, MATERIALS, METHODS, ETC. SHOWN AND/OR NOTED ON ANY PLAN OR SECTION SHALL APPLY TO ALL OTHER SIMILAR LOCATIONS UNLESS OTHERWISE NOTED.
- 4. THE GENERAL CONTRACTOR SHALL SAFELY SHORE, BRACE, OR SUPPORT ALL WORK AS REQUIRED OR REVIEW OF ANY SYSTEM OR METHOD BY THE ARCHITECT SHALL RELIEVE THE CONTRACTOR OF THIS RESPONSIBILITY.
- 15. IT IS NOT THE INTENT OF THESE DRAWINGS TO SHOW NOR INDICATE ANY OR ALL FASTENING OR FRAMING TECHNIQUES /DEVICES, NOR BE ABLE TO SHOW ALL CONDITIONS PRESENT.
- 16. ALL WORK IS NEW UNLESS OTHERWISE NOTED.
- ALL WALLS AND CEILINGS TO BE 5/8 in FIRE CODE OR 1/2 in GYPSUM BOARD, 5/8 in MOISTURE RESISTANT TYPE X OR 5/8h CEMENT BOARD. FINISH AND TEXTURE TO BE SELECTED BY OWNER. MATERIAL AS MANUFACTURED BY U.S. GYPSUM OR EQUAL FINISH (CEMENT ACCESSORIES AND TAFE OR SKIM COAT). ALL JOINTS AND NAIL HEADS READY FOR PAINT, TILE, WOOD TRIM, VWC, OR PANELING.
- STORAGE: THE CONTRACTOR SHALL PROVIDE ON SITE WEATHER PROTECTED STORAGE SPACE I TRAILER. STORAGE OF CONSTRUCTION MATERIALS IN THE EXISTING BUILDING WILL NOT BE PERMITTED

- PROTECTION: THE CONTRACTOR SHALL PROTECT ALL PUBLIC AND ADJACENT AREAS FROM DAMAGE
- TEMPORARY SERVICES: THE CONTRACTOR WILL PAY FOR EXISTING SERVICES (WATER, TELEPHONE AND ELECTRICITY) AND WILL TURN OVER THESE SERVICES TO THE OWNER UPON FINAL ACCEPTANCE OF THIS PROLECT.
- THE CONTRACTOR SHALL VERIFY LOCATION AND ACTUAL DEPTH OF ALL EXISTING SANITARY PIPING,
- 23. ALL WORK IS NEW UNLESS OTHERWISE NOTED.
- 24. DAMAGE: THE GENERAL CONTRACTOR IS RESPONSIBLE FOR ANY DAMAGE TO EXISTING BUILDING, WALLS, CELINGS, FLOORS, FURNITURE AND FURNISHINGS. DAMAGED SURFACES DUE TO CONSTRUCTION TO BE PATCHED. REPAIRED ANDIOR REPUGED ANS DECIDED AND DISCORDED AND OR DEVICED AND FOLKING DAY DELINE TO MATCH EXISTING ADJACENT SURFACES AT NO ADDITIONAL COST TO OWNER.
- THE GENERAL CONTRACTOR SHALL PREPARE A BOOKLET CONTAINING : LIST OF SUBCONTRACTORS USED ON THIS JOB WITH NAMES, ADDRESSES AND TELEPHONE NUMBERS. ALL WARRANTIES AND INSTRUCTION MANUALS FOR EQUIPMENT AND MATERIALS INSTALLED WILL BE ISSUED TO THE OWNER PRIOR TO FINAL ACCEPTANCE OF BUILDING, AND PRESENT BOOKLET TO OWNER PRIOR TO FINAL ACCEPTANCE OF OWNER.
- CARPET AND/OR TILE: CARPET AND/OR TILE AS SELECTED AS PER DRAWINGS.
- HANDICAPPED REQUIREMENTS: THE GENERAL CONTRACTOR WILL ACQUAINT HIMSELF WITH THE ARCHITECTURAL ACCESS BOARD (AAB) CODE FOR THE STATE OF MASSACHUSETTS AND THE ADA (AMERICANS WITH DISABILITIES ACT) TO ENSURE THAT THIS FACILITY WILL BE ACCESSIBLE.
- SPRINKLER HEAD LOCATION: REFER TO N.F.P.A. STANDARDS. SPRINKLER HEADS TO BE LOCATED PER CODE. SHOP DRAWINGS ARE REQUIRED TO BE SUBMITTED TO THE CONTRACTOR FOR APPROVAL PRIOR TO INSTALLATION.
- THE GENERAL CONTRACTOR SHALL COORDINATE THE LOCATION AND SIZE OF OPENINGS FOR VENTS, PIPES, INSERTS, BOXES, HANGERS, ETC.
- 30. ALL INTERIOR FINISHES AND FURNISHINGS FOR CEILINGS, WALL AND FLOORS SHALL BE CLASS 1in
- 31. SUBMIT SAMPLES OF ALL PAINTS AND STAINS FOR APPROVAL PRIOR TO APPLICATION.
- BEFORE COMMENCING WORK, THE GENERAL CONTRACTOR WILL MEET WITH THE APPOINTED COMPANY REPRESENTATIVE TO OUTLINE PHASING OF CONSTRUCTION AND DISPOSITION OF EXISTING CONSTRUCTION MATERIALS AND/OR EQUIPMENT.
- 33. ALL WOODS BLOCKING TO BE PRESSURE TREATED, FIRE RETARDANT.

1 Cedar St Residences

PROJECT ADDRESS 1 Cedar Street

Cambridge, MA 02140

1 CEDAR ST., LLC.

ARCHITECT



17 IVALOO STREET SLIITE 400 SOMERVILLE, MA 02143 TELEPHONE: 617-591-8682

CONSULTANTS:

COPYRIGHT KDI © 2020
THESE DRAWINGS ARE NOW AND DO
REMAIN THE SOLE PROPERTY OF KHALS/
JESIGN INC. USE OF THESE PLANS OR AND
ORDIN OF BERBOON OF THESE PLANS OR AND
ADMIN OF BERBOON OF THESE PLANS OR AND FORM OF REPRODUCTION OF THIS DESI IN WHOLE OR IN PART WITHOUT EXPRES WRITTEN CONSENT IS PROHIBITED AND SHALL RESULT IN THE FULLEST EXTENT OF PROSECUTION UNDER LAW





20012

Checke	d by	Checker
Scale12" = 1'-0		12" = 1'-0"
REVISIONS		
No.	Description	Date
\rightarrow		
\rightarrow		
\rightarrow		-
\rightarrow		-
\neg		-
\neg		
$\neg \neg$		

General Notes & Abbreviations

A-001 1 Cedar St Residence

GENERAL NOTES THE CONTRACTOR SHALL REPORT TO THE OWNER AND ENGINEER OF ANY SIGNIFICANT VARIATIONS IN EXISTING SITE CONDITIONS FROM HIGGS SIGNIFICANT VARIATIONS IN EXISTING OPENING PROBLEM OF A STATE OF THE CONDITIONS, SHALL IN ORDER TO PROTECT THE PUBLIC SAFETY DURING CONSTRUCTION, THE CONTRACTOR IS RESPONSIBLE FOR INSTALLING AND MAINTAINING AT ALL TIMES ALL NECESSARY SAFETY DEVICES AND P ERSONNEL, WARNING LIGHTS, BARCAGES, AND POLICE OFFICERS. ALL WORK SHALL CONFORM TO CITY OF CAMBRIDGE GENERAL CONSTRUCTION STANDARDS. THE CONTRACTOR SHALL REGULARLY INSPECT THE PERIMETER OF THE PROPERTY TO CLEAN UP AND REMOVE LOOSE CONSTRUCTION DEBRIS SEFORE IT LEAVES THE SITE. ALL DEMOLITION DEBRIS SHALL BE PROMPILY REMOVED FROM THE SITE TO A LEGAL DUMP SITE. ALL TRUCKS LEAVING THE SITE SHALL BE COVERED. IT SHALL BE THE RESPONSIBILITY OF THE CONTRACTOR TO INSTITUTE EROSION CONTROL MEASURES ON AN AS NECESSARY BASIS, SUCH THAT EXCESSIVE SOIL EROSION DOES NOT OCCUR. PAGE STATE SOIL ENGINE DUES NOT COUNTINES AS REPRESENTED ON THESE PLANS IS BASED UPON PLANS AND INFORMATION PROVIDED BY THE RESPECTIVE. UTILITY COMPANIES OF MINNIOPAL DEPARTMENTS IN ON WARRANTY IS MADE AS TO THE ACQUIRACY OF THESE LOCATIONS OR HART ALL LUNGERGOUND UTILITIES ARE SHOWN. THE CONTRACTOR SHALL CONTRACT DIG SAFE AT LEAST 72 HOURS PRIGHT OT THE STATE OF CONSTRUCTION. DIG SAFE LEHEPHONE NUMBER IS 1-800-522-4844

THE CONTRACTOR SHALL VERIFY THE LOCATION, SIZE AND DEPTH OF EXISTING UTILITIES PRIOR TO TAPPING INTO, CROSSING OR EXTENDING HELM. IF THE NEW WORK POSES A CONFLICT WITH EXISTING UTILITIES, THE ENGINEER SHALL BE NOTIFIED PRIOR TO THE CONTRACTOR CONTINUING.

NO LEDGE, BOULDERS, OR OTHER UNYIELDING MATERIALS ARE TO BE LEFT WITHIN 6" OF THE WATER IN THE TRENCH, NOR ARE THEY TO BE USED FOR BACKFILL FOR THE FIRST 12" ABOVE THE PIPES.

PAVEMENT AREA SHALL BE PAVED TO A THICKNESS AS SHOWN ON THE PLANS MEASURED AFTER COMPACTION, WITH A BINDER COURSE AND TOP COURSE OF CLASS I BITUMINOUS CONCRETE PAVEMENT, TYPE I-1.

BASE MATERIAL SHALL BE CLEAN BANK RIN GRAVEL, CONFORMING TO M.D.P.W. MI.O.S.Y., WITH NO STONES LARGER THAN THREE (3) NOVES IN TO THE CONFORMING TO M.D.P.W. MI.O.S.Y. WITH NO STONES LARGER THAN THREE (3) NOVES TO THE CONFORMING ROLLING TO BIND ROLLING TO BIND THE MATERIAL. ALL STONES OF 4" DIAMETER OR LARGER SHALL BE KET DOORS DAYS MATERIAL. ALL STONES OF 4" DIAMETER OR LARGER SHALL BE KENOVED FROM THE SUB-BASE PRIOR TO FLACKING BASE MATERIAL.

ALL EXISTING PAVING TO BE DISTURBED SHALL BE CUT ALONG A STRAIGHT LINE THROUGH ITS ENTIRE THICKNESS. BUTT THE NEW PAVING INTO THE EXISTING PAVIMENT TO REMAIN.

ANY PAVEMENT REMOVED FOR UTILITY TRENCH EXCAVATION OR OTHERWISE DAMAGED DURING CONSTRUCTION SHALL BE REPLACED WITH A PAVEMENT SECTION CONSTRUCTION SHALL BE REPLACED WITH 1/2" BINDER COURSE OVERLYING A 8" COMPACTED GRAVEL BASE COURSE.

 THE CONTRACTOR SHALL APPLY FOR A STREET OPENING AND UTILITY CONNECTION PERMITS AND SIDEWALK CROSSING PERMIT WITH THE CITY OF CAMBRIDGE DPW. CONTRACTOR TO ENSURE THAT ALL SURFACE WATER IS DIVERTED AWAY FROM BUILDING FOUNDATION DURING FINAL GRADING.

*FLOOD ELEVATIONS (CAMBRIDGE FLOODVIEWER V2.1) 2030-100 YEAR STORM = 29'
2070-100 YEAR STROM =29.1'
PRESENT DAY - 100 YEAR STORM = 28.9

DRAINAGE AREA SUMMARY PROPOSED ROOF AREA =2,401.8 S.F.
PROPOSED PAYED AREA= 3,965.2 S.F.
PROPOSED UNCONNECTED IMPERVIOUS= 158.5 S.F.
PROPOSED PERMEABLE PAYERS= 557.1 S.F.
PROPOSED LANDSCAPE AREA = 507.6 S.F.

OTAL PROPOSED IMPERVIOUS AREA = 6,525.5 S.I

STOROWATER MANAGEMENT CALCULATIONS

Dogo for the house Storage Coloni Rogaline

 $V_{N}=\{1^{l}: l(l)\in J_{N}(\mathbb{R}^{N}): |M|=|M|-1^{l}(l)\in l(l)$

CAPACITY OF PROPOSITE STORM DECEMBERS.

Vest base 10.0

Signate for 6 feets (but Child - 2015)

or a closed from - Chad Volume - Cigardy of the closed - 29(y) 47 - 46(2) 27 Final Stronger Provided * Carports in Franchis Strong + Strong Stronger in St 404, 2 CF + 204 CF + 700 CF

GRAPHIC SCALE

Spruhan

Engineering, P.C.

Tel: 617-816-0722

EXISTING D.M.H. RIM=31.74 INV=21.50

1 CEDAR STREET CAMBRIDGEMASSACHUSETTS

CIVIL PLANS

REVISION BLOCK

Calculation by EF Balo: April 15, 2621

SURVEY NOTES:

1. INFORMATION SHOWN ON THIS PLAN IS THE RESULT OF A FIELD SURVEY PERFORMED BY SPRUHAN ENGINEERING, P.C. AS OF 02-01-2020.

2. DEED REFERENCE: BOOK 73154 PAG468 PLAN REFERENCE: BOOK 78 PAGE 3 MIDDLESEX SOUTH REGISTRY OF DEEDS.

3. THIS PLAN IS NOT INTENDED TO BE RECORDED.

4. I CERTIFY THAT THE DWELLING SHOWN IS NOT LOCATED WITHIN A SPECIAL FLOOD HAZARD ZONE. IT IS LOCATED IN ZONE X, ON FLOOD HAZARD BOUNDARY MAP NUMBER 25017C0419E, PANEL NUMBER 0554E, COMMUNITY NUMBER: 0419E, DATED 06/04/2010.

5. THIS PLAN DOES NOT SHOW ANY UNPECORDED OR UNWRITTEN EASEMENTS WHICH MAY EXIST. A REASONABLE AND DILIGENT ATTEMPT HAS BEEN MADE TO OBSERVE ANY APPARENT USES OF THE LAND; HOWEVER THIS NOT CONSTITUTE A GUARANTEE THAN NO SUCH AESEMENTS EXIST.


6. FIRST FLOOR ELEVATIONS ARE TAKEN AT THRESHOLD.

7. THE ELEVATIONS SHOWN ARE BASED ON CITY OF CAMBRIDGE MA. DATUM


LEGEND		
- 22	SEWER LINE	
	DRAIN LINE	
8	SEWER MANHOLE	
	WATER LINE	
G	GAS LINE	
e e	UTILITY POLE	
Š.	GAS VALVE	
— Е —	OVERHEAD ELECTRIC SERVICE	
W	WATER VALVE	
	CATCH BASIN	
-0-	FENCE	
205	CONTOUR LINE (MJR)	
195	CONTOUR LINE (MNR)	
×	SPOT GRADE	
0	DRAIN MANHOLE	
553	TREE	

DRAINAGE PLAN

SHEET 1 OF 3

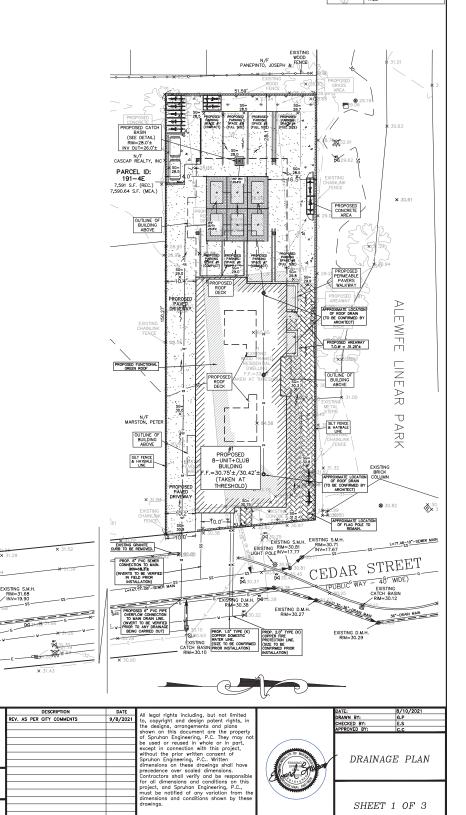





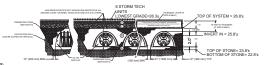



STORMTECH GENERAL NOTES

- THE CONTRACTOR MUST APPLY EROSION AND SEDMENT CONTROL MEASURES TO PROTECT THE STORMMATER SYSTEM DURING ALL PHASES OF SITE CONSTRUCTION PER LOCAL CODES AND DESIGN ENGINEERS SPECIFICATIONS.

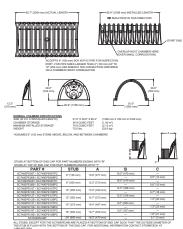


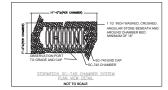

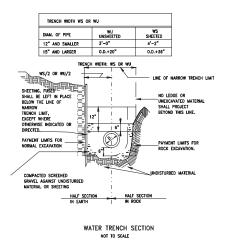

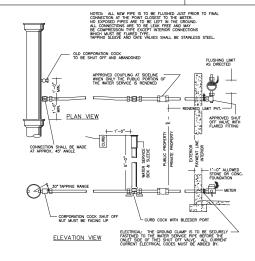

TYPICAL WATER SERVICE CONFIGURATIONS

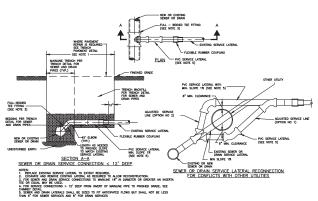

REVISION BLOCK





	DESCRIPTION	DATE
1 CEDAR STREET		
CAMBRIDGE MASSACHUSETTS		
a D. 1112		
CIVIL PLANS		
	•	1


All legal rights including, but not limited to copyright and design potent rights, in copyright and design potent rights, in the control of Seruhan Engineering, P.C. They may not be used or reused in whole or in part except in connection with this project, without the prior written consent of Spruhan Engineering, P.C. written dimensions on these drawings shall have precedence over social dimensions. Southern Engineering, P.C., must be notified of any variation from the dimensions and conditions shown by these drawings.




DATE: DRAWN BY: CHECKED BY:	8/10/2021
DRAWN BY:	G.P
CHECKED BY:	E.S
APPROVED BY:	c.c

DETAILS

SHEET 2 OF 3

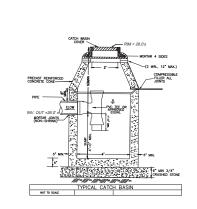

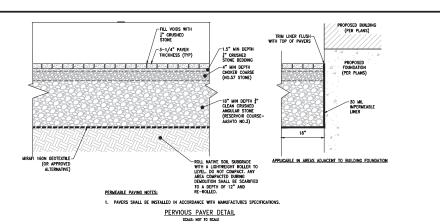

SEE WOITS BELOW

ARE-TIGHT THREADED MPT

CAP

AND TAMPSEED

MAND TAMPSEED

BACKFRIAT TO

BOOK RELATIVE

COMPACTION

BOSTALL VERICALLY &

OUT TO LINGHI/SOR 35

ASSIGNATION

ASSIGNATION

ASSIGNATION

TERMINAS ONLY

FLEXIBLE TRANSITION


COUPLING (RIM 3.5' FROM

WYE)

NOTES:

- 1. RECTANGULAR OR CIRCULAR BOXES ARE PERMITTED.
- CONCRETE/FIBERLYTE LIDS ARE ACCEPTABLE IN NON-VEHICULAR AREAS. H-20 CAST IRON TRAFFIC LIDS AND BOXES IN VEHICULAR AREAS.
- 3. ALL CLEANOUT LIDS SHALL BE MARKED WITH AM "S" OR THE WORD "SEWER" FOR SANITARY SEWER CLEANOUTS
- 4. CLEANOUT PIPE SHALL BE THE SAME DIAMETER AS THE CONNECTED SITE PIPE.
- TERMINATE C.O. AT CLOSEST JOINT TO SURFACE WITH TEMPORARY PLUG. AFTER ALL BACKFILL IS COMPLETE AND SUB-GRADE MADE IM AREAS TO BE PAYED, THE FINAL RISER PIPE AND BOX SHALL BE INSTALLED AS SHOWN.

CLEANOUT TO GRADE

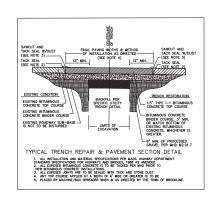

S
Spruhan
Engineering, P.C.
80 JEWETT ST, (SUITE 2) NEWTON, MA 02458
Tel: 617-816-0722

	DESCRIPTION	DATE
1 CEDAR STREET		
CAMBRIDGE		
MASSACHUSETTS		
CIVIL PLANS		

REVISION BLOCK


All legal rights including, but not limited to, copyright and design potent rights, in the copyright and design potent rights, in the copyright of the copyright of Spruha Engineering, P.C. They may not be used or reused in whole or in part except in connection with this project, without the prior written consent of Spruhan Engineering, P.C. Written dimensions on these drawings shall be projected error ever social dimensions. Spruhan Engineering, P.C., must be notified of any variation from the dimensions and conditions on this project, and Spruhan Engineering, P.C., must be notified of any variation from the dimensions and conditions shown by these drawings.

TO T MODELLE CONTROL OF MANAGEMENT OF MANAGE
S/ONL SE

DATE:	8/10/2021
DRAWN BY:	G.P
CHECKED BY:	E.S
APPROVED BY:	C.C


DETAILS

SHEET 3 OF 3

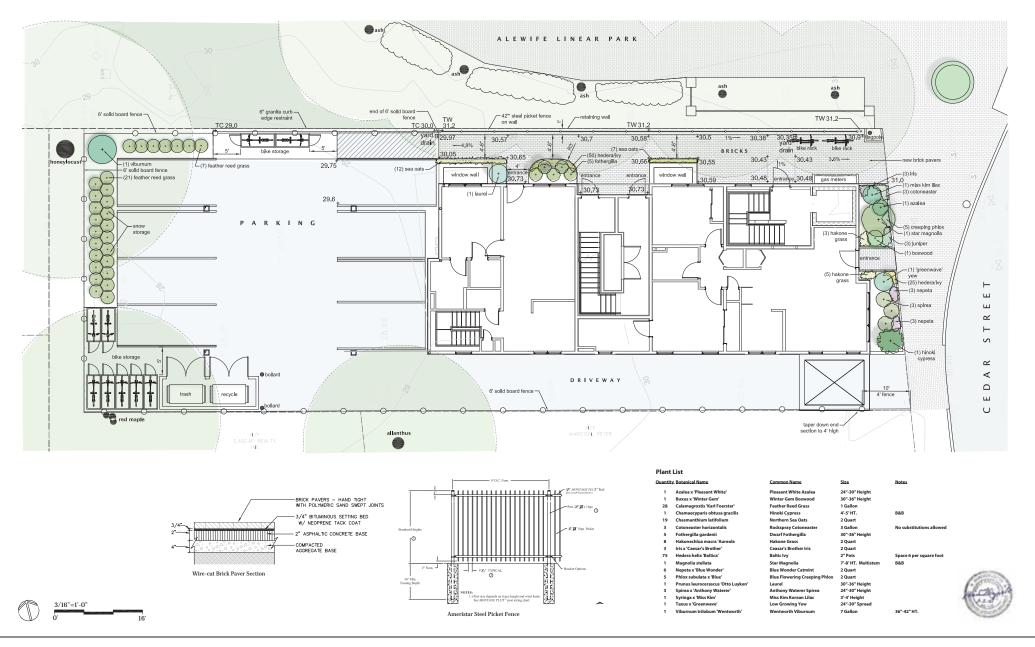





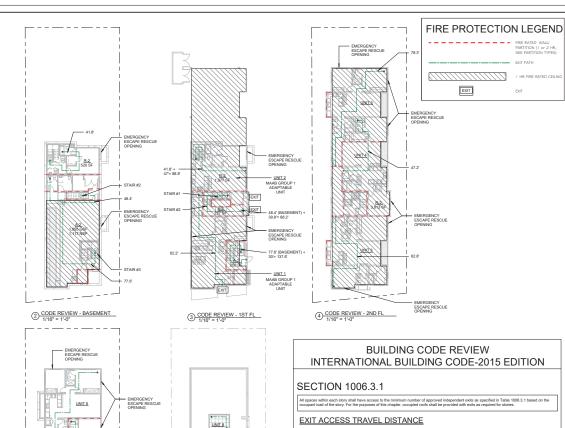

21.3' (ROOF LEVEL) + 31.2' = 53.5'

UNIT 7

UNIT 6

6 CODE REVIEW- ROOF PLAN 1/16" = 1'-0"

UNIT 7

UNIT 6

5 CODE REVIEW - 3RD FL 1/16" = 1'-0"

TABLE 1006.3.2: STORIES WITH ONE EXIT OR ACCESS TO ONE EXIT FOR R-2 OCCUPANCIES

STORY	OCCUPANCY	MAXIMUM OCCUPANTS (OR DWELLING UNITS) PER FLOORAND TRAVEL DISTANCE
BASEMENT	A-2	NOT PERMITTED
BASEMENT	R-2 FOOTNOTE A	4 DWELLING UNITS AND 125 FEET TRAVEL DISTANCE
FIRST, SECOND & THIRD STORY	R-2 FOOTNOTE A	4 DWELLING UNITS AND 125 FEET TRAVEL DISTANCE
FOURTH STORY ABOVE GRADE PLANE AND HIGHER	R-2	NOT PERMITTED

PECTION 100E 1

a. Buildings classified as Group R-2 equipped throughout with an automatic sprinkler system in accords 903.3.1.2 and provided with emergency escape and rescue openings in accordance with Section 1030.

EGRESS CALCULATIONS:

TABLE 1004.1.1: RESIDENTIAL 1/200 SF GROSS

#	FLOOR USE GROUP	AREA/200	OCCUPANT/ FLOOR	
0	BASEMENT/ A2	1,117/ 15	75	
0	BASEMENT/ R2	520/ 200	3	
1	FIRST/R2	1,977/200	10	
2	SECOND/R2	3,813/200	20	
3	THRD/R2	3,733/200	19	
	TOTAL #0,1,2,3		127	

#	STAIR	EGRESS CAPACITY	WIDTH IN INCH	WIDTH PROVID
	SIMIK	0.3 * OCCUPANTS	ALLOWED	
1	STAIR- R2	15.6"	44*	44"
2	STAIR- A2	22.5"	44*	44"
3 E0	STAIR- A2 GRESS WIDTH (22.5" OTHER THAN STAIR	44* S)	44"
EG		OTHER THAN STAIR		44"
EG	GRESS WIDTH (OTHER THAN STAIR		
W	SRESS WIDTH (I IDTH IN INCHES 2/OCCUPANT	OTHER THAN STAIR	<u>s)</u>	WIDTH PROVIDE

BUILDING CODE REVIEW INTERNATIONAL BUILDING CODE-2015 EDITION

USE GROUP - RESIDENTIAL R-2

TYPE OF CONSTRUCTION

_		_		_						
_	UILDING A					ALLO	OWED	PRO	VIDED	
NO	FLOOR	USE	GROUP			AREA	STORIES/	AREA S.F.	STORIES/ HEIGHT	REMARKS
						S.F.	HEIGHT			
0	BASEMENT	"A2"	ADDIMEN	"VB"	COMBUSTIBLE UNPROTECTED	18,000	2/60 FT	1,895	0	DEE NOTE #1.3.3.4.6.6 BELOW FOR NUMBERS OF ORBITS N
0	BASEMENT	"R2"	RESOURSE, MATPARKY	"VB"	COMBUSTIBLE UNPROTECTED	21,000	3/ 60 FT	520	0	DEE NOTE #1.33.4.64 BELOW FOR NOTEARS SPORMFON
1	FIRST	"A2"	RESOURCE MATERIALY	"VB"	COMBUSTIBLE UNPROTECTED	21,000	3/ 60 FT	477	1	DEE NOTE #1.3.3.4.6.6 BELOW FOR NUMBERS OF ORBITS N
1	FIRST	"R2"	RESOURSE, MATERIALY	"VB"	COMBUSTIBLE UNPROTECTED	21,000	3/ 60 FT	1,977	1	DEE NOTE #1.33.4.64 BELOW FOR NOTEARS SPORMFON
2	SECOND	"R2"	RESOURSE, MATERIALY	"VB"	COMBUSTIBLE UNPROTECTED	21,000	3/ 60 FT	3,813	1	DEE NOTE #1.3.3.4.6.6 BELOW FOR NUMBERS OF ORBITS N
3	THIRD	"R2"	RESOURSE, MATERIALY	"VB"	COMBUSTIBLE UNPROTECTED	21,000	2/60 FT	3,733	1	DEE NOTE #1.3.3.4.6.6 BELOW FOR NUMBERS OF ORBITS N
Т	TOTAL					21,000	3	12,415	3	
		BUILD	ING "A2"	ASSE	/BLY AREA = 2,372 S.	F.				
		BUILD	ING "R2"	RESID	ENTIAL AREA = 10.04:	3SF		1	OTAL BUI	I DING AREA = 12 415 S E

SECTION 508.4

Fire Resistance Rating Requirements for Fire Separation Assemblies Between Fire Areas (in Hours)

OCCUPANCY	A	R ^a .	
A	N	1	
R2 a.		N	

N= NO SEPARATION REQUIREMENT a. SEE SECTION 420.

SECTION 506.3

USE GROUP "R2"=10,043 S.F., USE GROUP "A2"= 2,372 SF

5. ALLOWABLE AREA INCREASE DUE TO STREET FRONTAGE- SECTION - 506.2 - (NOT USED)

6. AREA ANALYSIS ALLOWABLE AREA INCREASE (NOT USED) DUE TO COMPLIANCE WITH BASIC REQUIREMENTS OF TABLE 503

NOTE: BUILDING IS FULLY FIRE SUPPRESSED

FIRE RESISTANCE OF STRUCTURAL ELEMENTS:

STRUCTURAL FLEMENTS	TYPE OF CO	INSTRUCTION	FIRE RATING FILE #
STRUCTURAL ELEMENTS		VB	FIRE RATING FILE#
1. EXTERIOR FRAME:			
INCLUDING COLUMNS, GIRDERS, TRUSSES		0HR	
2. BEARING WALLS			
EXTERIOR		0HR	
INTERIOR		0HR	
3. NONBEARING WALLS AND PARTITIONS:			
EXTERIOR (ta	ble 602)	OHR	
4. NONBEARING WALLS AND PARTITIONS:			
INTERIOR		0HR	
FLOOR CONSTRUCTION			
INCLUDING SUPPORTING BEAMS AND JOISTS		0HR	
6. ROOF CONSTRUCTION:			
INCLUDING SUPPORTING BEAMS AND JOISTS		0HR	

FIRE RESISTANCE RATING REQUIREMENTS FOR EXTERIOR WALLS

	TABLE 602:			
	Fire Separation Distance = X (feet)	TYPE OF CONSTRUCTION	NOT USED	Occupancy R, S-2 & U Type VA,B
	x < 5 (c)	VB		1
	5 ≤ x <10)	VB		1
	10 ≤ x <30	VB		0
	x ≥ 30	VB		0

Dwelling Unit Separations

Dwelling units must be separated from each other (horizontally and vertically) and the rest of the building by construction that provides at least a one half (1/2) hour FRR (780 CMR Sections 709.3 & 712.3). Corridors in Use Group R-2 are required to provide a 30 minute FRR per Table 1018.1. Concealed Spaces
Fire-blocking and draft-stopping shall be installed in combustible concealed locations in accordance with 780 CMR 717.0








Drawn	Dy	Author				
Check	ed by	Checker				
Scale	As	indicated				
REVI	SIONS					
No.	Description	Date				
Code Review &						

Egress Calculations

A-010

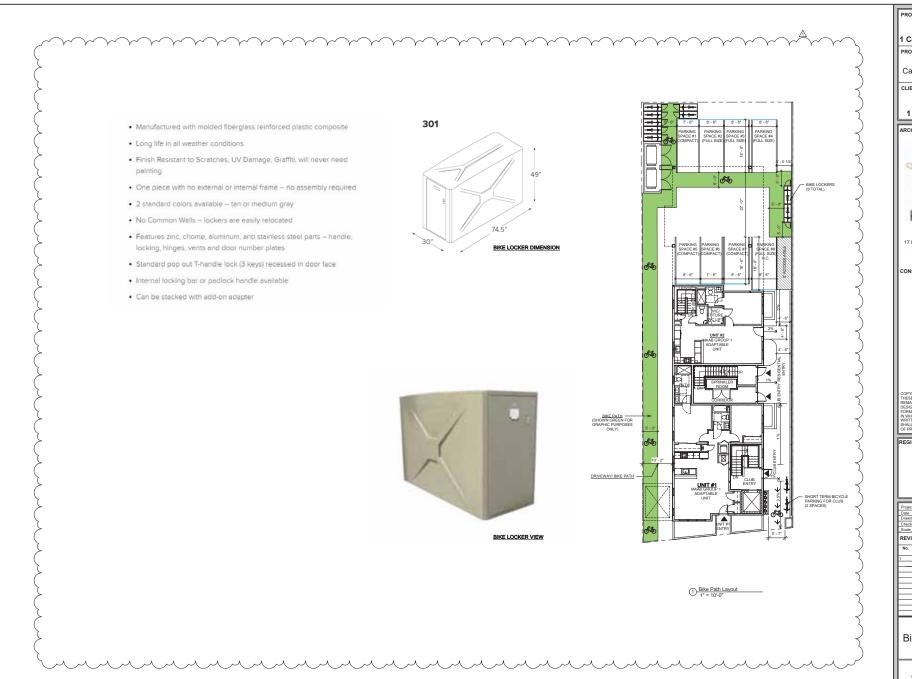

PROJECT NAME 1 Cedar St Residences PROJECT ADDRESS 1 Cedar Street Cambridge, MA 02140 1 CEDAR ST., LLC. ARCHITECT KHALSA 17 IVALOO STREET SUITE 400 SOMERVILLE, MA 02143 TELEPHONE: 617-591-8682 CONSULTANTS:



HECK	eu by	CHECKEL			
cale		1" = 10'-0"			
EVISIONS					
No.	Description	Date			
	Design Reveiw	09/08/2021			
_					
_		+			
_		_			

Bike Path Layout

A-016

1 Cedar St Residences

WTKG-SERVERID ata \2012_Repucci_1 (







1 CEDAR ST., LLC. ARCHITECT KHALSA 17 IVALOO STREET SUITE 400 SOMERVILLE, MA 02143 TELEPHONE: 617-591-8682 CONSULTANTS: HESE DRAWINGS ARE NOW AND DO EMAIN THE SOLE PROPERTY OF KHALS ESIGN INC. USE OF THESE PLANS OR A

PROJECT NAME

PROJECT ADDRESS 1 Cedar Street

1 Cedar St Residences


Cambridge, MA 02140



REVISIONS

Area Plans


A-021 1 Cedar St Residences

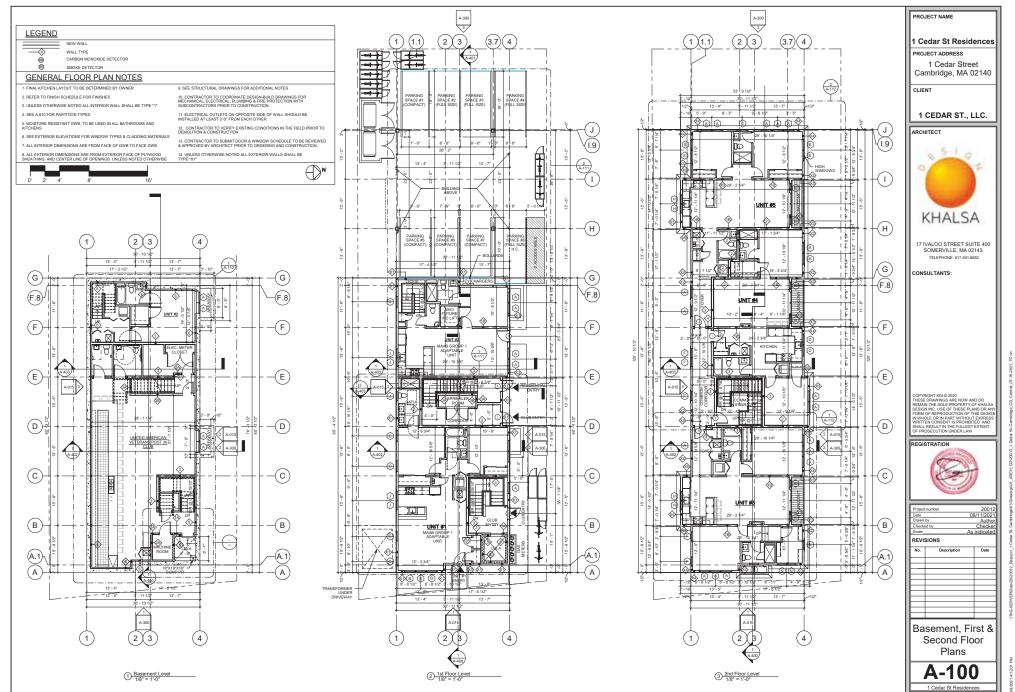

oxod _1 Cedar St. Cambridge103 Dewings101_ARCH_CD1000112_1 Oxder St. Cambridge_CD_Central_CF-16-2021_TC zn

PM VTKG-SERVERD as (20)2 (Septical)

9/8/2021 4:12:01 PM

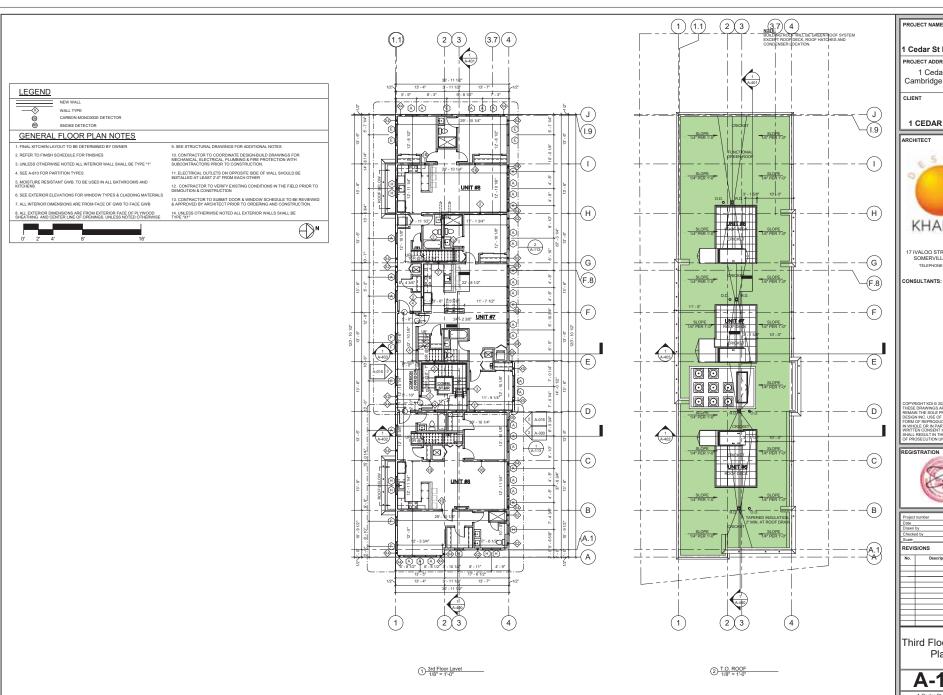

1 Cedar St Residences PROJECT ADDRESS

1 Cedar Street Cambridge, MA 02140

1 CEDAR ST., LLC.

ARCHITECT



17 IVALOO STREET SUITE 400 SOMERVILLE, MA 02143 TELEPHONE: 617-591-8682


CONSULTANTS:



roject	roject number 20012					
ate		08/11/2021				
rawn	by	Author				
heck	ed by	Checker				
cale_		As indicated				
EVISIONS						
No.	Description	Date				

Third Floor & Roof Plans

> A-101 1 Cedar St Residences

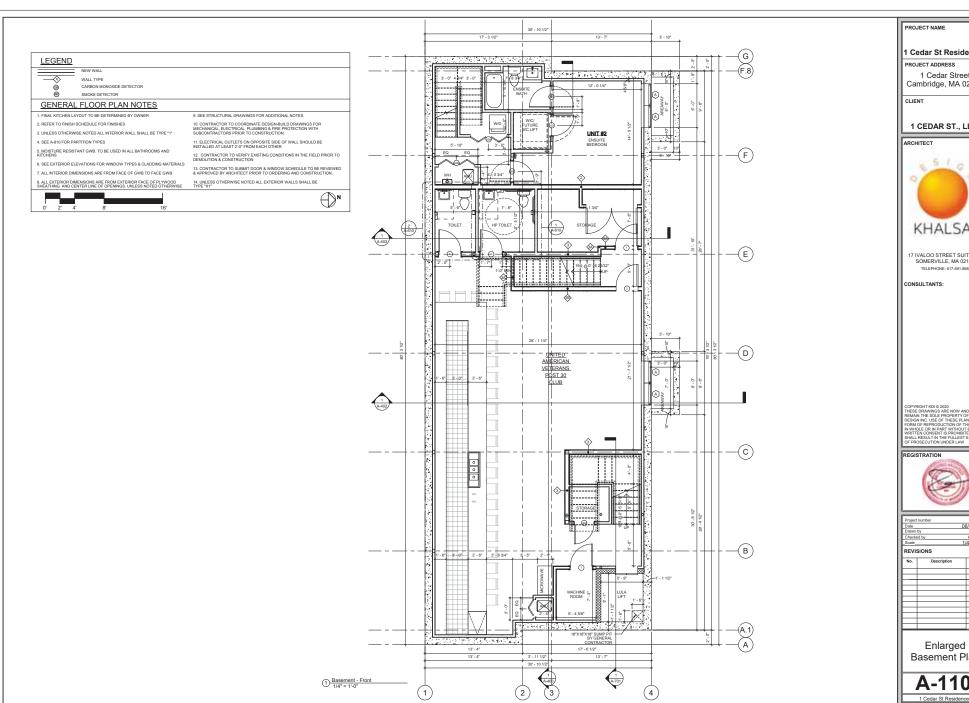



1 Cedar St Residences PROJECT ADDRESS 1 Cedar Street Cambridge, MA 02140 1 CEDAR ST., LLC. KHALSA 17 IVALOO STREET SUITE 400 SOMERVILLE, MA 02143 TELEPHONE: 617-591-8682 CONSULTANTS:

Checker 1/4" = 1'-0"

Enlarged Basement Plan


A-110

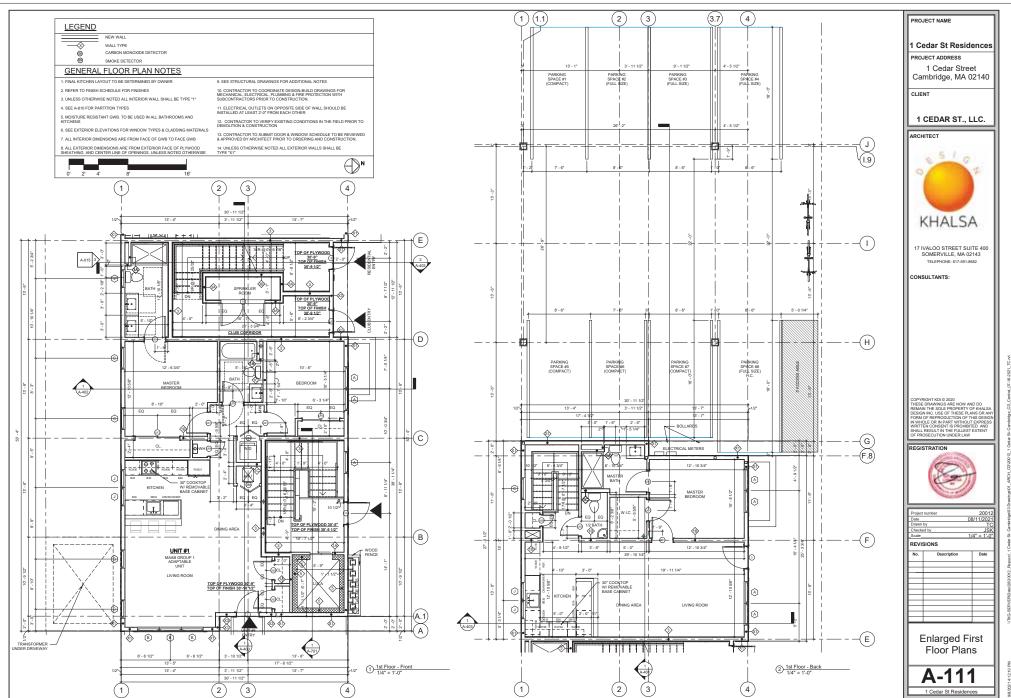


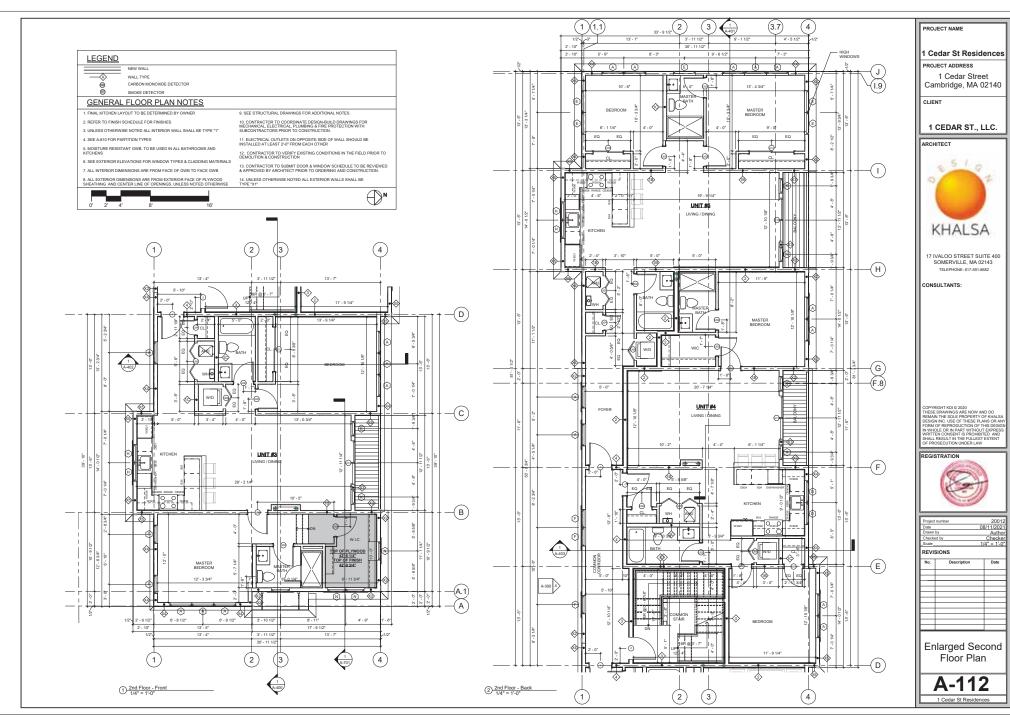

8Daal0200012_Pepudo_i 1 Cedar St. Cambridgel03 Drawingel01_ARCH_CD1000112_1 Cedar St. Cambridge_CD_Central_07-16-202_i TC m


/20214:12:15 PM

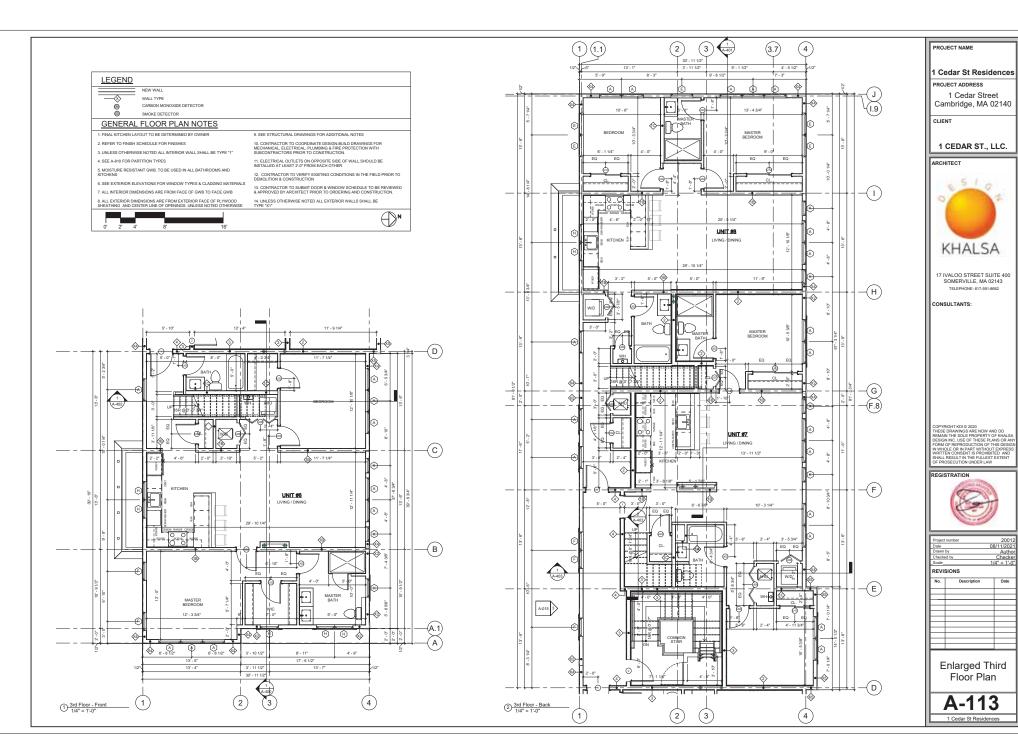

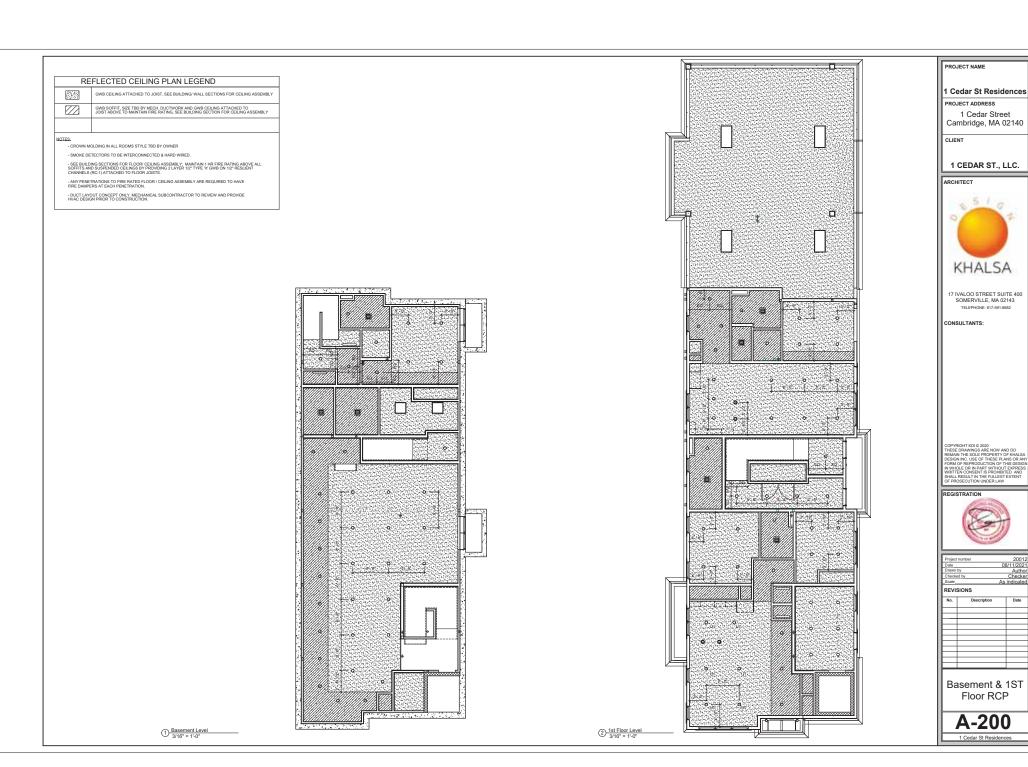

SERVERDael 2020012, Pepusa, 1 Cedar St. Cambridgid 3 Dawingid LARCH, CO100012, 1 Cedar St. Cambridge, CD. Central, 07-16-2021, TC nn

98530214:12:31 PM

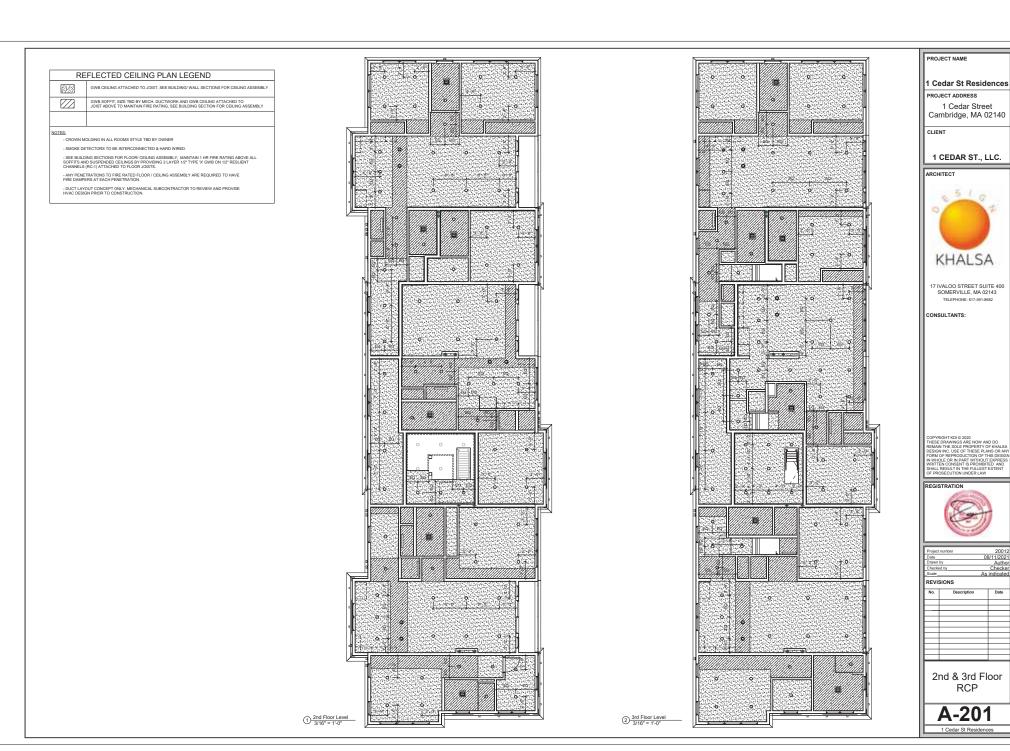

Author Checker

RCP





4 SOUTH (LEFT) ELEVATION
1/8" = 1'-0"

1 Cedar St Residences PROJECT ADDRESS

1 Cedar Street Cambridge, MA 02140



17 IVALOO STREET SUITE 400 SOMERVILLE, MA 02143



Project number	20012		
Date	08/11/2021		
Drawn by	Author		
Checked by	Checker		
Scale	1/8" = 1'-0"		
REVISIONS			


No.	Description	Date

Exterior Elevations

A-300

Author Checker

1 Cedar St Residence

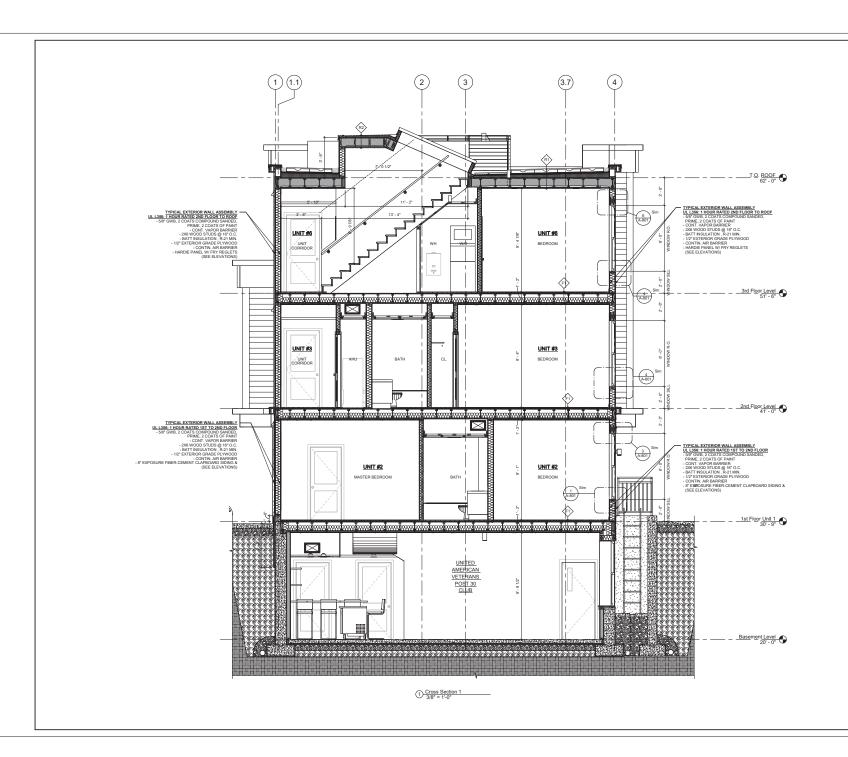

1 Cedar St Residences

PROJECT ADDRESS 1 Cedar Street

PROJECT NAME



SOMERVILLE, MA 02143 TELEPHONE: 617-591-8682





Date		08/11/2021	
Drawn by		Author	
Checked	by	Checker	
Scale		3/8" = 1'-0"	
REVIS	IONS		
No.	Description	Date	

ı	No.	Description	Date
П			
П			
П	$\overline{}$		

Cross Section 1

A-402

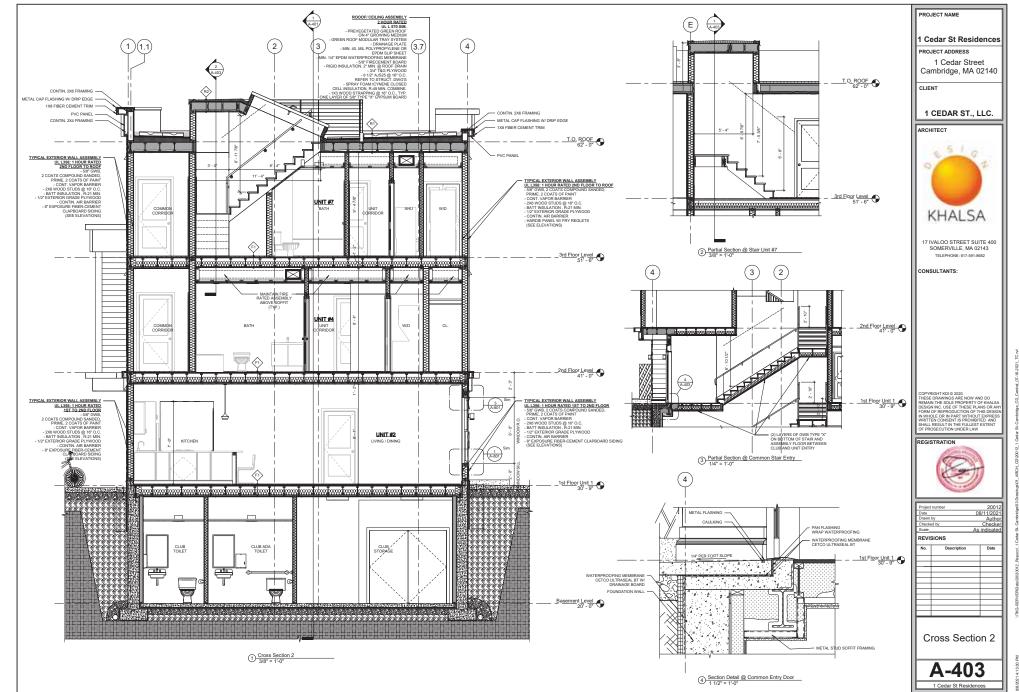

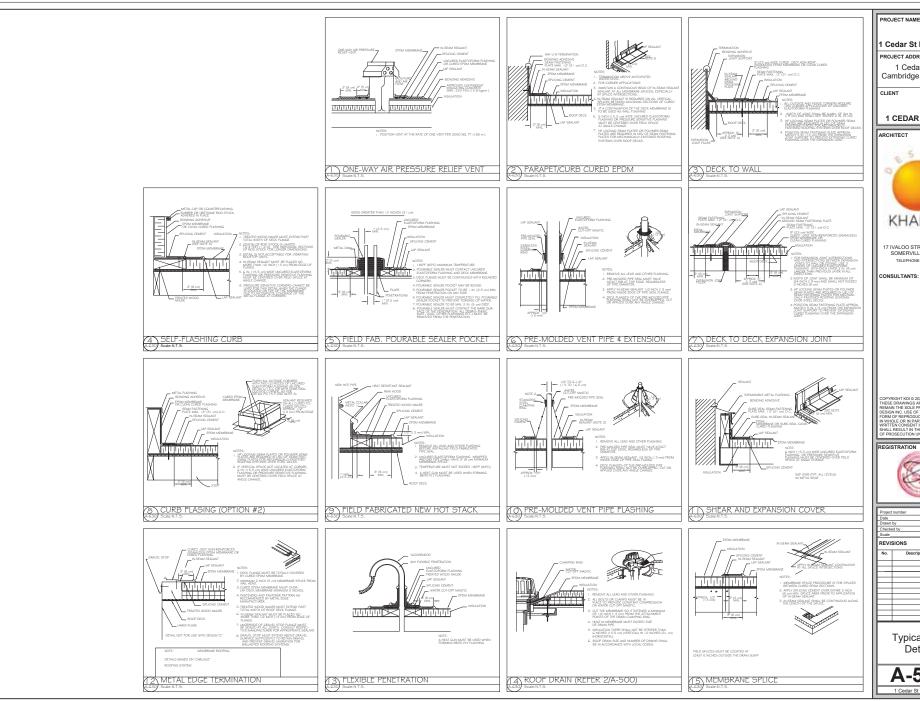

1 Cedar St Residences PROJECT ADDRESS 1 Cedar Street Cambridge, MA 02140 1 CEDAR ST., LLC. KHALSA 17 IVALOO STREET SUITE 400 SOMERVILLE, MA 02143 TELEPHONE: 617-591-8682


THESE DRAWINGS ARE NOW AND DO REMAIN THE SOLE PROPERTY OF KHALS DESIGN INC. USE OF THESE PLANS OR A



Date		0/11/2021					
Drawn by		DM					
Checked		Checker					
Scale		/8" = 1'-0"					
REVISI	REVISIONS						
No.	Description	Date					
\vdash							
\rightarrow							
-							
\rightarrow							
\vdash		_					
\vdash		_					
\rightarrow		-					
\rightarrow		_					
\rightarrow		_					
\rightarrow		_					
\rightarrow		_					
\vdash							
Tomical Deef							


Typical Roof Details

A-520

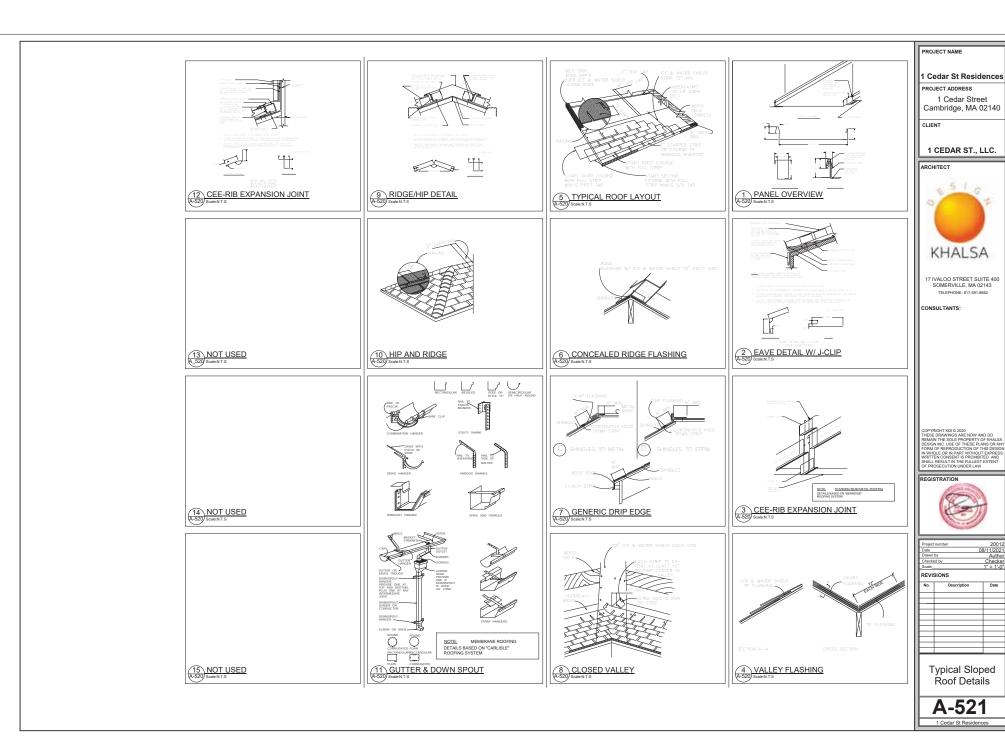


TRG-SERVERDaek0202012 Repusod 1 Codar St. Cambridge03 Develoge01_ARCH_CD100012_1 Codar St. Cembridge_CD_Central_U7-16-2021_TD_rM

9/8/2021 4:13:39 PM

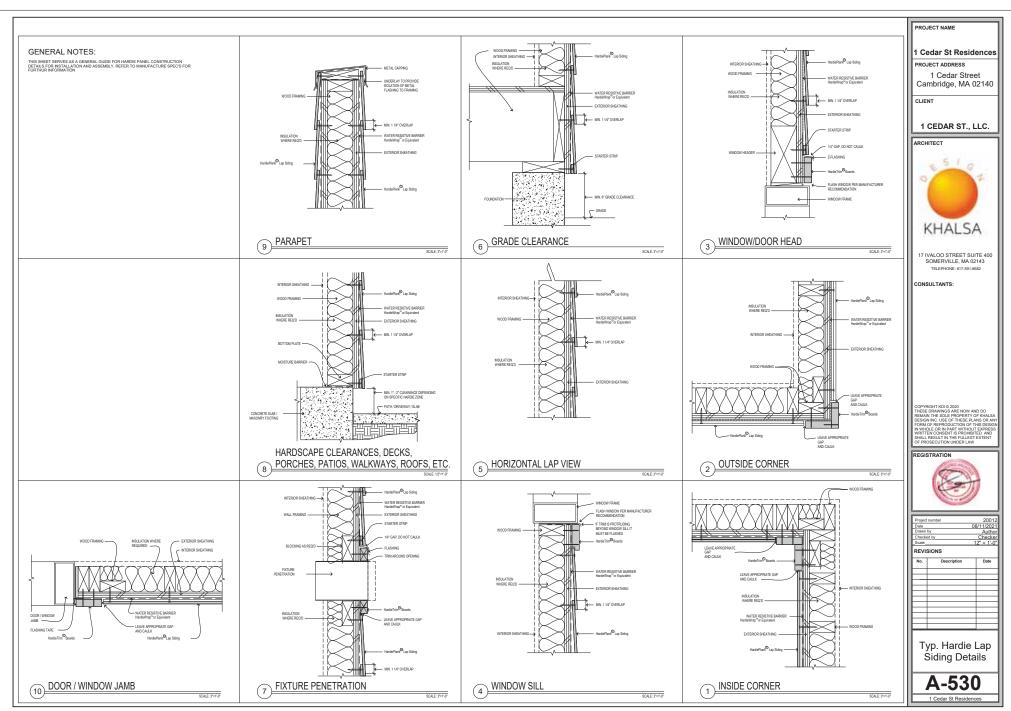

3-SERVERD at 2020 0012_Papusol_1 Codar St. Cambridgeld 3 Drawings/01_ARCH_CD 000 12_1 Octar St. Cambridge_CD_Central_07-16-2/02_1 TC nrt

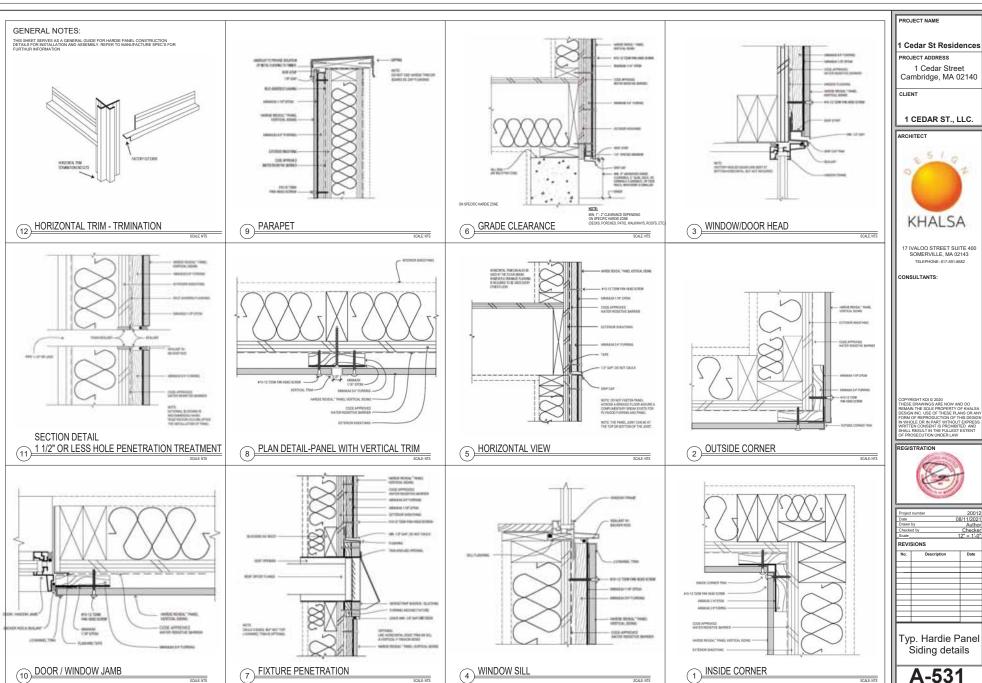




Typ. Hardie Panel

Siding details

A-531


1 Cedar Street

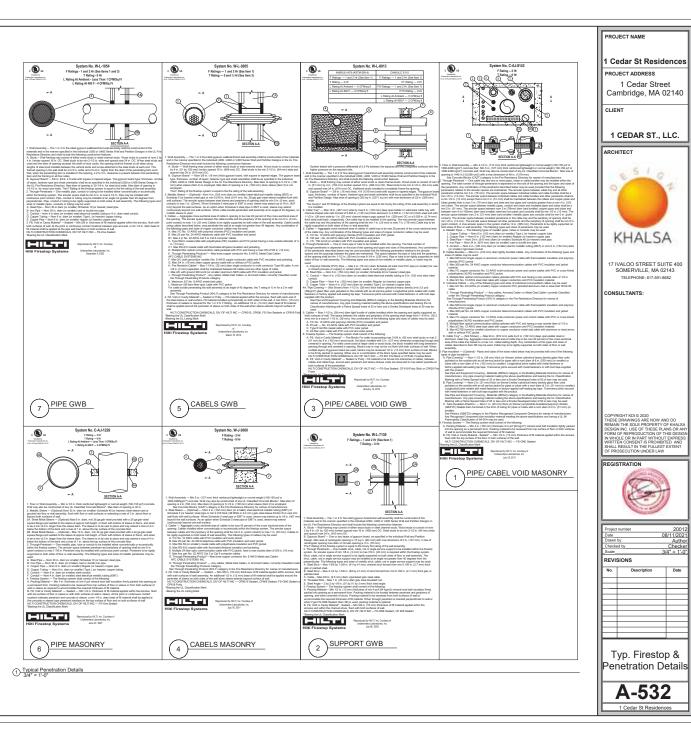



Plans & Interior Elevations A-610 1 Cedar St Residences

3. SEE PLANS FOR VANITY DIMENSIONS.

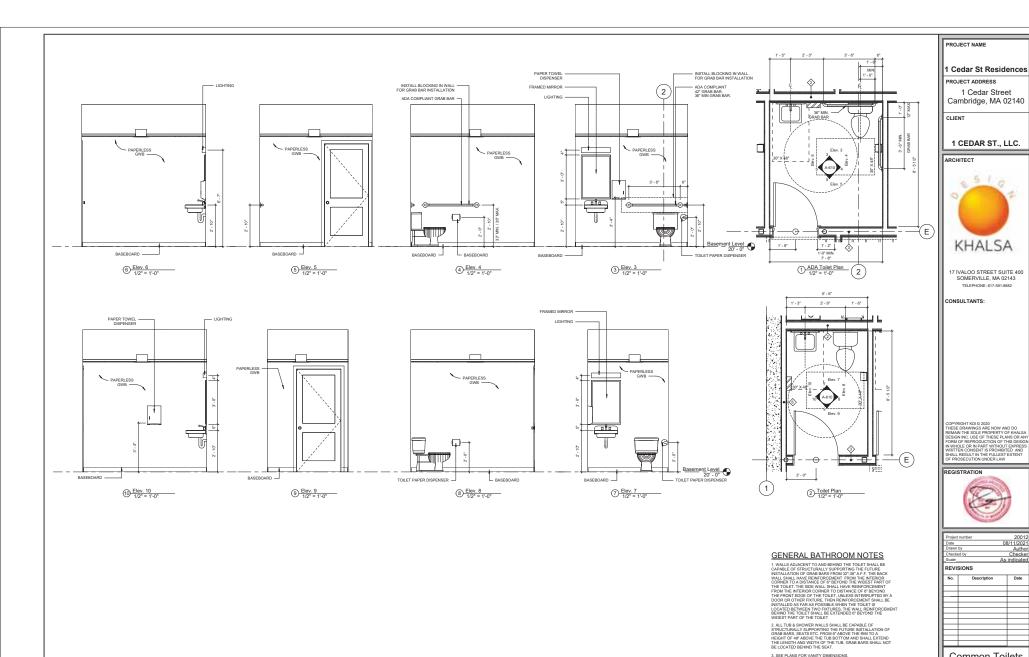


Author Checker 1/2" = 1'-0"





Stair Details

A-710


1 Cedar St Residences

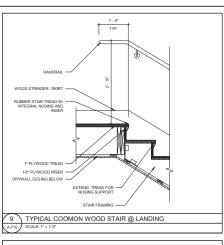


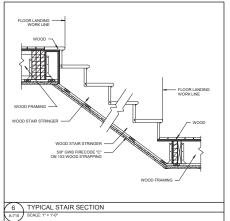


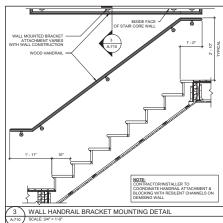



WOOD STRINGER / SIGRET
1-PLYWOOD TREAD
1-PLYWO

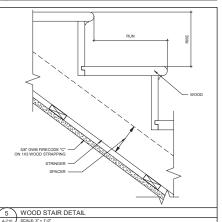


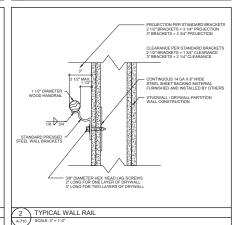

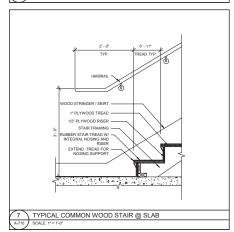


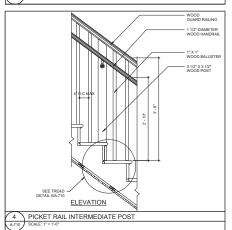

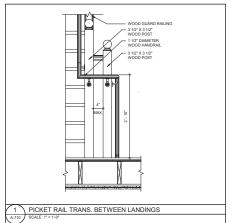

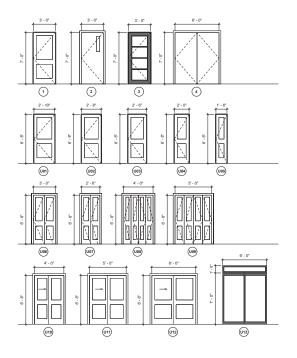

WINDOW SCHEDULE										
ROUGH OPENING HEAD SILL DETAIL										
Type Mark	TYPE	STYLE	WIDTH	HEIGHT	MATERIAL	HEIGHT	HEIGHT	HEAD	JAMB	SILL
A	36" X 72"	DOUBLE-HUNG	3' - 0"	6' - 0"				3/A-801 & 6/A-801	2/A-801 & 5/A-801	1/A-801 & 4/A-801
В	36" X 66"	DOUBLE-HUNG	3' - 0"	5' - 6"		8' - 0"	2' - 6"	3/A-801	2/A-801	1/A-801
C	36" X 60"	DOUBLE-HUNG	3' - 0"	5' - 0"		8' - 0"	3' - 0"	3/A-801	2/A-801	1/A-801
D	36" X 54"	DOUBLE-HUNG	3' - 0"	4' - 6"		8' - 0"	3' - 6"	6/A-801	5/A-801	4/A-801
E	36" x 36"	AWNING	3' - 0"	3' - 0"		8' - 0"	5' - 0"	6/A-801	5/A-801	4/A-801
F	30" X 72"	DOUBLE-HUNG	2' - 6"	6' - 0"		8' - 0"	2' - 0"	3/A-801 & 6/A-801	2/A-801 & 5/A-801	1/A-801 & 4/A-801
G	30" x 60"	DOUBLE-HUNG	2' - 6"	5' - 0"		8' - 0"	3' - 0"	3/A-801	2/A-801	1/A-801
Н	30" X 54"	DOUBLE-HUNG	2' - 6"	4' - 6"		8' - 0"	3' - 6"	3/A-801 & 6/A-801	2/A-801 & 5/A-801	1/A-801 & 4/A-801
J	30" X 42"	DOUBLE-HUNG	2' - 6"	3' - 6"		8' - 0"	4' - 6"	3/A-801	2/A-801	1/A-801
K	24" X 72"	DOUBLE-HUNG	2' - 0"	6' - 0"		8' - 0"	2' - 0"	6/A-801 & 9/A-801	5/A-801 & 8/A-801	4/A-801 & 7A-801
L	1'x36	FIXED TRANSOM	3' - 2"	1' - 0"		8' - 4"	7' - 4"	3/A-801 & 9/A-801	2/A-801 & 8/A-801	
И	1'4x36	FIXED TRANSOM	3' - 2"	1' - 4"		8' - 0"	6" - 8"	3/A-801 & 9/A-801	2/A-801 & 8/A-801	
N	30" X 48"	DOUBLE-HUNG	2' - 6"	4' - 0"		8' - 0"	2' - 0"	3/A-801 & 6/A-801	2/A-801 & 5/A-801	1/A-801 & 4/A-801

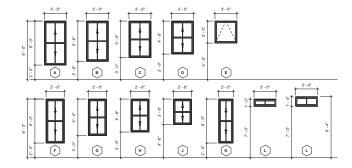

WINDOW NOTES:

CONTRACTOR TO VERIFY SIZES OF EXISTING WINDOW OPENINGS TO REMAIN, PRIOR TO ORDERING OF WINDOWS

 BEDROOM WINDOWS TO COMPLY WITH EMERGENCY ESCAPE AND RESCUE MINIMUM OPENING AREA, HEIGHT & WIDTH AS REQUIRED BY THE IBC 2015 (MA AMENDMENTS).

3). ALL WINDOWS THAT HAVE OPENINGS LESS THAN 35' ABOVE THE FINISHED FLOOR AND MORE THAN 72' ABOVE THIS RESIDENCE GRANES SHALL HAVE A WINDOW OPENING CONTROL DEVICE. THAN 72' ABOVE THIS RESIDENCE AND THE WINDOW OPENING CONTROL DEVICE ALL OWNER THE WINDOW OF LILLY OPEN. SHALL NOT ESSUE CHE HAVE AND THE AREA REQUIRED FOR EMPRISED. THE SHALL OF SHALL AND THE AREA REQUIRED FOR EMPRISED. THE SHOPE AND RESIDENCE OPENING.

4) WINDOWS SHALL HAVE EXTERIOR MUNTINS AS SHOWN ON THE ELVATIONS & HALF SCREENS ON ALL WINDOWS.

PROJECT NAME

1 Cedar St Residences

PROJECT ADDRESS

1 Cedar Street Cambridge, MA 02140

CLIENT

1 CEDAR ST., LLC.

ARCHITECT



17 IVALOO STREET SUITE 400 SOMERVILLE, MA 02143 TELEPHONE: 617-591-8682

CONSULTANTS:

COPYRIGHT KDI © 2020
THESE DRAWINGS ARE NOW AND DO
TREMIN THE SOLE PROPERTY OF KHALSA
DESIGN INC. USE OF THESE FLANS OR ANY
FORM OF REPRODUCTION OF THIS DESIGN
IN WHOLE OR IN PART WITHOUT DYPRESS
WRITTEN CONSENTS ROPHISTED AND
SHALL RESULT IN THE FULLEST EXTENT
OF PROSECULTION UNDER LAW

REGISTRATION



20012 08/11/2021

nawn		Author			
heck	ed by	Checker			
cale	1	/4" = 1'-0"			
REVISIONS					
No.	Description	Date			
		-			
_					
_					

Door & Window Schedule

A-800
1 Cedar St Residences

PROJECT NAME

1 Cedar St Residences
PROJECT ADDRESS
1 Cedar Street
Cambridge, MA 02140

CLIENT

1 CEDAR ST., LLC.

ARCHITECT

ARCHITECT

ARCHITECT

ARCHITECT

ARCHITECT

17 IVALOO STREET SUITE 400 SOMERVILLE, MA 02143 TELEPHONE: 617-591-8682

KHALSA

CONSULTANTS:

COPYRIGHT KDI © 2020

MESE DRAWINGS ARE NOW AND DO

REMAIN THE SOLE PROPERTY OF KHALSA
SESICN INC. USE OF THESE PLANS OR ANY
ORM OF REPRODUCTION OF THIS DESIGN
WHOLE OR IN PART WITHOUT EMPRESS
WRITTEN CONSENT IS PROHIBITED AND
MALL RESULT IN THE FULLEST EMTERS.

FGISTRATION



Project number 200					
ate	08/11/2021				
rawn by	Author				
hecked by	Checker				
icale	3" = 1'-0"				
REVISIONS					
No. Descript	tion Date				
_					
_					

Window Details

A-801

1 Cedar St Residences

10 FINISH FLOOR DETAILS

A-802 Scale: 3"=1"-0"

PROJECT NAME 1 Cedar St Residences PROJECT ADDRESS 1 Cedar Street Cambridge, MA 02140 1 CEDAR ST., LLC. ARCHITECT KHALSA 17 IVAI OO STREET SUITE 400


SOMERVILLE, MA 02143 TELEPHONE: 617-591-8682

CONSULTANTS:

COPYRIGHT KDI © 2020
THESE DRAWINGS ARE NOW AND DO
REMAIN THE SOLE PROPERTY OF KHALSA
JESIGN INC. USE OF THESE PLANS OR AN



Date	0	8/11/2021
Drawn		Author
Check	ed by	Checker
Scale		3" = 1'-0"
REVI	SIONS	
No.	Description	Date
_		_
_		
	Door & Fini Floor Detai	

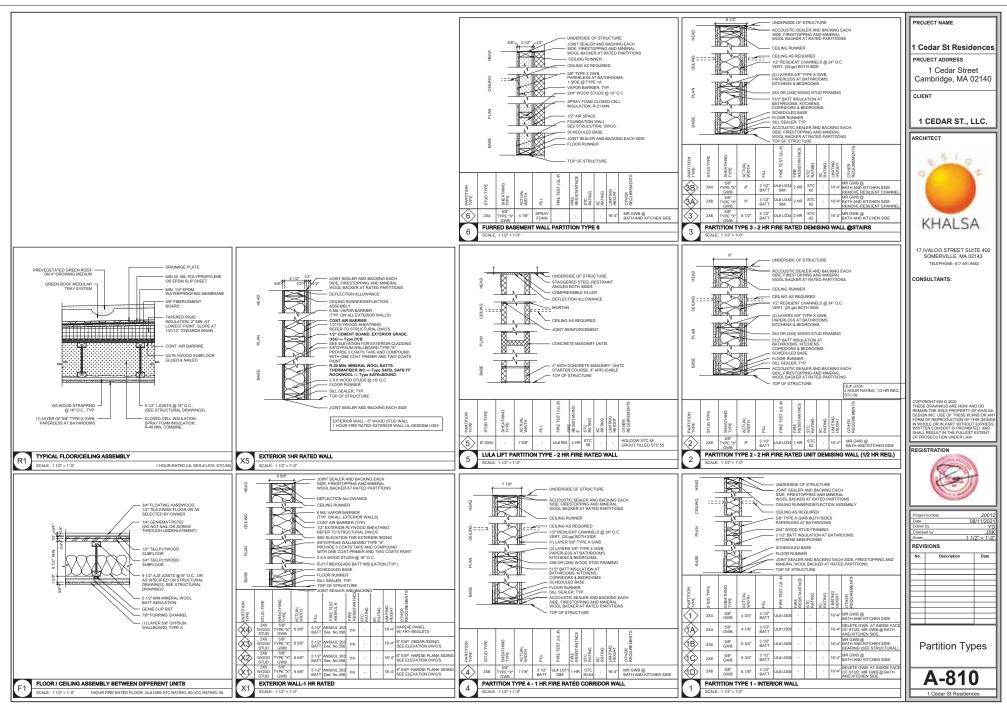



Cedar St Residences

1 Cedar Street Cambridge, MA 02140

CLIENT

1 CEDAR ST., LLC.

ARCHITECT



17 IVALOO STREET SUITE 400 SOMERVILLE, MA 02143 TELEPHONE: 617-591-8682

ONSULTANTS:

COPYRIGHT KDI © 2020
THESE DRAWINGS ARE NOW AND DO
REMAIN THE SOLE PROPERTY OF KHALSA
DESIGN INC. USE OF THESE PLANS OR ANY
FORM OF REPRODUCTION OF THIS DESIGN
IN WHOLE OR IN PART WITHOUT EXPRESS
WRITTEN CONSENT IS PROHBITED AND
SHALL RESULT IN THE FULLEST EXTENT
OF PROSECTION INDIPED.

REGISTRATION

Date		08/14/2020
Drawn by		Author
Checked I	Checked by Checker	
Scale	1" = 50'-0"	
REVISION	ONS	
No.	Description	Date
-		_
-		_
		-
_		

PROPOSED SHADOW STUDY

AV-00

1 Cedar St Residences



FRONT VIEW (CEDAR STREET)



SIDE VIEW (ALONG LINEAR PARK)



REAR VIEW



SIDE VIEW (ALONG DRIVEWAY)

PROJECT NAME

1 Cedar St Residences

PROJECT ADDRESS

1 Cedar Street
Cambridge, MA 02140

CLIENT

1 CEDAR ST., LLC.

ARCHITECT



17 IVALOO STREET SUITE 400 SOMERVILLE, MA 02143 TELEPHONE: 617-591-8682

CONSULTANTS:

COPYRIGHT KDI © 2020

INTESE DRAWINGS ARE NOW AND DO

REMAIN THE SOLE PROPERTY OF KHALSA

DESIGN INC. USE OF THESE PLANS OR ANY

ORAL OF REPRODUCTION OF THIS DESIGN

NU WHOLE OR IN PART WITHOUT EXPRESS

WRITTEN CONSENT IS PROHIBITED AND

SHALL RESULT IN THE FULLEST EXTENT

OF PROSECUTION UNDER LAW

REGISTRATION



REVISIONS			
No.	Description	Date	
1	Design Reveiw	09/08/2021	
=			
\vdash			
⊢			

RENDERED VIEWS

AV-1

1 Cedar St Residences

WTKG-SERVERD asa (2012)001





PROJECT NAME

1 Cedar St Residences

PROJECT ADDRESS 1 Cedar Street Cambridge, MA 02140

1 CEDAR ST., LLC.

ARCHITECT



17 IVALOO STREET SUITE 400 SOMERVILLE, MA 02143 TELEPHONE: 617-591-8682

CONSULTANTS:



Check		Checker
REVISIONS		
No.	Description	Date
1	Design Reveiw	09/08/2021
		_
_		
-		_

PROPOSED **RENDERINGS**

1 Cedar St Residences

AV-2



VIEW FROM LINEAR PARK

PROJECT NAME

1 Cedar St Residences

PROJECT ADDRESS 1 Cedar Street Cambridge, MA 02140

CLIENT

1 CEDAR ST., LLC.

ARCHITECT



17 IVALOO STREET SUITE 400 SOMERVILLE, MA 02143 TELEPHONE: 617-591-8682

CONSULTANTS:



Date Drawn		08/11/2021 Author
Checked by Checke Scale		
REVISIONS		
No.	Description	Date
No.	Description Design Reveiw	Date 09/08/2021

	Description	Dutte
	Design Reveiw	09/08/2021
_		

PROPOSED RENDERING FROM PARK

AV-3 1 Cedar St Residences