
2017 JUL -6 AM 11: 22

BZA APPLICATION FORM

GENERAL INFORMATION

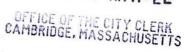

The undersigned hereby petiti	ons the Board	of Zoning Appeal for the following:
Special Permit:X_	Variance:	Appeal:
PETITIONER: Cellco Partnership de	b/a Verizon Wireles	ss
PETITIONER'S ADDRESS: 118 Flan	ders Road, 3d Floor	, Westborough, MA 01581
LOCATION OF PROPERTY: 1815 Mass	sachusetts Avenue	
TYPE OF OCCUPANCY: Institutional/	Retail/Mobile Tel	ZONING DISTRICT: BC, Mass Ave Overlay, Lesley Porter Overlay
REASON FOR PETITION:		
Additions		New Structure
Change in Use/Oc	cupancy	Parking
Conversion to Ad	di'l Dwelling	Unit's Sign
Dormer		Subdivision
X Other Mobile Commo	unication Facility m im Act)	nodification (Eligible Facilities request under Section 6409 of the
DESCRIPTION OF PETITIONER'S P	ROPOSAL:	
The proposal includes four sectors of three	panel antennas ea s. Antennas will be CITED: (1) and Footnote 49 rough10.46	
Applicants for a Variance must Applicants for a Special Permit Applicants for an Appeal t	complete Page t must complete to the BZA ent must attac gnature(s): Address:	ete Pages 1-4 and 6 of a Zoning determination by the ch a statement concerning the reasons (Petitioner(s)/Owner) * Michael S. Giaimo, attorney for Cellco Partnership d/b/a/ Verizon Wireless (Print Name) Verizon Wireless, Attn: Ellen Dalmus 118 Flanders Road, 3rd Floor Westborough, MA (508) 330-3300
Date: 6/22/2017		* Robinson & Cole One Boston Place, 25th Floor, Boston, MA
¥		(617) 557-5959

BZA APPLICATION FORM - OWNERSHIP INFORMATION

To be completed by OWNER, signed before a notary and returned to The Secretary of the Board of Zoning Appeals.

I/We_	Lesley University
	(OWNER)
Addre	s: 29 Everett Street, Cambridge MA 02138
State	that I/We own the property located at
which	is the subject of this zoning application.
The r	cord title of this property is in the name of Lesley University
*Purs	ant to a deed of duly recorded in the date4/5/1995, Middlesex South
Count	Registry of Deeds at Book 25269 , Page 543 ; or
Middl	sex Registry District of Land Court, Certificate No
Book	Page
	SIGNATURE BY JAND OWNER OR
Writ	AUTHORIZED TRUSTEE, OFFICER OR AGENT en evidence of Agent's standing to represent petitioner may be requested.
Commo	wealth of Massachusetts, County of
The a	ove-name Maylou Batt personally appeared before me,
this	2) of $\int V V V = 0$, 20 (7) , and made oath that the above statement is true.
My co	LISA M. KROUCH (Notary Seal). COMMONWEALTH OF MASSACHUSETTS My Commission Expires October 10, 2019



SN LISA M. RROUCH
NOTOTY PUBLIC
ONMOTWEATHORNASION France
October 10, 2019

Sec. 20 2.4

SUPPORTING STATEMENT FOR A SPECIAL PERMIT

Please describe in complete detail how you meet each of the following criteria referring to the property and proposed changes or uses which are requested in your application. Attach sheets with additional information for special permits which have additional criteria, e.g.; fast food permits, comprehensive permits, etc., which must be met.

Granting the Special Permit requested for 1815 Massachusetts Avenue (location) would not be a detriment to the public interest because:

A) Requirements of the Ordinance can or will be met for the following reasons:

As demonstrated by the documents and information provided with this application, and as will be further demonstrated at the hearing on this matter, the modification constitutes an Eligible Facilities Request which must be allowed and cannot be denied, pursuant to Section 6409 of the Federal Spectrum Act and regulations thereunder.

B) Traffic generated or patterns of access or egress would not cause congestion hazard, or substantial change in established neighborhood character for the following reasons:

The upgraded facility will not change existing traffic demand or effect ingress or egress. The facility will generate only about one to two vehicle trips per month by a standard passenger vehicle during normal business hours for routine maintenance.

C) The continued operation of or the development of adjacent uses as permitted in the Zoning Ordinance would not be adversely affected by the nature of the proposed use for the following reasons:

The facility will have no adverse effects on the operation or development of adjacent uses. The facility will emit no light, odor, dust or glare and generates no unusual noise or other adverse impacts.

Nuisance or hazard would not be created to the detriment of the health, safety and/or welfare of the occupant of the proposed use or the citizens of the City for the following reasons:

The facility will generate no additional traffic or other negative impacts on surrounding properties or within the City of Cambridge. The facility requires no water or sewer service and emits no light, odor, dust, or glare and generates no unusual noise or other adverse impacts. The facility will be unoccupied, with no employees or customers. The availability of wireless communication enhances the health, safety, and welfare of the community.

E) For other reasons, the proposed use would not impair the integrity of the district or adjoining district or otherwise derogate from the intent or purpose of this ordinance for the following reasons:

The facility has been designed to minimize its visual impact and is in harmony with the general purpose of the Zoning Ordinance and in accordance with the requirements for an Eligible Facilities Request under Federal Law.

(ATTACHMENT B - PAGE 6)

DIMENSIONAL INFORMATION

Cellco Partnership

APPLICANT: d/b/a Ver	rizon Wireless	PF	RESENT USE/OCCUPAN	ICY: Institutional/Ro	etail
LOCATION: 1815 M	lassachusetts Aven	ue	zone:B(2	
PHONE: (617)557-595	59	_ requested use/	OCCUPANCY: Mobil	e Communications	
		EXISTING CONDITIONS	REQUESTED CONDITIONS	ORDINANCE REQUIREMENTS	3 ¹
TOTAL GROSS FLOOR	AREA:	N/A	No Change	N/A	(max.)
LOT AREA:		N/A	No Change	None	(min.)
RATIO OF GROSS FLO	OR AREA	N/A	No Change	1.25/2.00	(max.)
LOT AREA FOR EACH	DWELLING UNIT:	N/A	No Change	N/A	(min.)
SIZE OF LOT:	WIDTH	N/A	No Change	N/A	(min.)
	DEPTH			_	-
Setbacks in	FRONT	29' +/-	No Change	None	(min.)
Feet:	REAR	401' +/-	No Change	20'	(min.)
	LEFT SIDE	N/A	No Change	None	(min.)
	RIGHT SIDE	80' +/-	No Change	None	(min.)
SIZE OF BLDG.:	HEIGHT	78'0" (top of antenn	na) No Change	55'	_(max.)
	LENGTH	99' 10" (top of towe	r)		
	WIDTH				
RATIO OF USABLE OP	EN SPACE				
TO LOT AREA: 3)		N/A	N/A	N/A	_(min.)
NO. OF DWELLING UN	ITS:	N/A	N/A	N/A	_(max.)
NO. OF PARKING SPAC	CES:	N/A	N/A	<u>N/A</u> (mi	n./max)
NO. OF LOADING AREA	<u> 45</u> :	N/A	N/A	N/A	(min.)
DISTANCE TO NEAREST	BLDG.	N/A	No Change	N/A	(min.)
Describe where appoint same lot, and steel, etc. Not applicable					

^{1.} SEE CAMBRIDGE ZONING ORDINANCE ARTICLE 5.000, SECTION 5.30 (DISTRICT OF DIMENSIONAL REGULATIONS).

^{2.} TOTAL GROSS FLOOR AREA (INCLUDING BASEMENT 7'-0" IN HEIGHT AND ATTIC AREAS GREATER THAN 5') DIVIDED BY LOT AREA.

^{3.} OPEN SPACE SHALL NOT INCLUDE PARKING AREAS, WALKWAYS OR DRIVEWAYS AND SHALL HAVE A MINIMUM DIMENSION OF 15'.

CHECK LIST

PROPERTY LOCATION: 1815 Massachuse	etts Avenue	DATE:	6/22/2017	-
PETITIONER OR REPRESENTATIVE:	ael S. Giaimo attorney fo	r Cellco Partne	ership d/b/a Ve	rizon Wireless
ADDRESS & PHONE: One Boston Place,	25th Floor, Boston, MA 0	2108 (617) 5	57-5959	
BLOCK: 152		OT: 51E		
PLEASE CHECK THAT YOU HAVE INCLUDE WILL NOT BE ACCEPTED FOR PROCESS PROVIDED.			PPLICATION. L REQUIRED	APPLICATION DOCUMENTS AF
PLEASE INCLUDE THIS CHECKLIST WITH ALL DOCUMENTS ARE TO BE TYPED OR WA				
DOCUMENTS		REQUIRED		ENCLOSED
Application Form 3 Forms with Original Signatures		<u>X</u>		X
Supporting Statements - 2 Copies		X		X .
Application Fee (\$) (SEE ATTACHED FEE SCHEDULE))	X		X
Assessor's Plat (Available at Engir Dept 147 Hampshire Street)	neering	<u> </u>		X
Dimensional Form - Refer to Cambrid Zoning Ordinance - 2 Copies (Subject to further review by Zoning		X		X
Ownership Certificate, Notarized -	_	Х		Χ
Floor Plans - 2 Sets		N/A		
Elevations - 2 Sets *		X		X
Certified Plot Plan - 2 Copies (By Registered Land Surveyor)		X		X
Photographs of Property - 2 Copies		Х		X
Parking Plan (if relevant to your a 2 Copies	application)	N/A		
FOR SUBDIVISION ALSO INCLUDE: **				
Proposed Deeds				410/410/4149744
Evidence of Separate Utilities ***				***************************************
Proposed Subdivision Plan		4		
Petitioners are advised to refer t of Zoning Appeal) & consult zoning		ocedures f	or applying	to the Board

It is advisable for the Petitioner to discuss the petition with the abutters as listed in the Zoning BZA Case file.

 $[\]mbox{*}$ For Special Permits under Art. 4.32.G.1 (Communication Towers and Antennas), include a photo simulation.

^{**} See attachment G.

^{***} Can be submitted after subdivision has been approved.

GENERAL INFORMATION

The undersigned hereby petitions the Board	d of Zoning Appeal for the following:
Special Permit:X Variance:	Appeal:
PETITIONER: Cellco Partnership d/b/a Verizon Wirele	ess
PETITIONER'S ADDRESS: 118 Flanders Road, 3d Floor	or, Westborough, MA 01581
LOCATION OF PROPERTY: 1815 Massachusetts Avenue	
TYPE OF OCCUPANCY: <u>Institutional/Retail/Mobile Tel</u>	ZONING DISTRICT: BC, Mass Ave Overlay, Lesley Porter Overlay
REASON FOR PETITION:	
Additions	New Structure
Change in Use/Occupancy	Parking
Conversion to Addi'l Dwelling	g Unit's Sign
Dormer	Subdivision
Other Mobile Communication Facility (Federal Spectrum Act)	modification (Eligible Facilities request under Section 6409 of the
DESCRIPTION OF PETITIONER'S PROPOSAL:	
Addition of wireless communications facility to an existing but	ilding housing previously approved wireless communications facilities.
The proposal includes four sectors of three panel antennas e equipment mounted to existing steel frames. Antennas will be	ach, located on the face of the tower portion of the building and rooftop e painted to match the facade.
SECTIONS OF ZONING ORDINANCE CITED:	
Article 4 Section 4.32(g)(1) and Footnote 4	49 (4.40.49)
Article 10 Section 10.40 through 10.46	
Article 6409(a) Section Middle Class Tax Relief Ac	t (Spectrum Act)
Applicants for a Variance must complete Pa Applicants for a Special Permit must complete Applicants for an Appeal to the BZA Inspectional Services Department must attained the appeal	nges 1-5 Lete Pages 1-4 and 6 of a Zoning determination by the
Original Signature(s):	(Petitioner(s)/Owner)
	* Michael S. Giaimo, attorney for Cellco Partnership d/b/a/ Verizon
Address:	Wireless (Print Name) Verizon Wireless, Attn: Ellen Dalmus
	118 Flanders Road, 3rd Floor
	Westborough, MA
Tel. No.:	(508) 330-3300
E-Mail Addre	
Date: 6/22/2017	* Robinson & Cole One Boston Place, 25th Floor, Boston, MA (617) 557-5959

DIMENSIONAL INFORMATION

Cellco Partnership

APPLICANT: d/b/a Ver	rizon Wireless	PF	ESENT USE/	OCCUPANCY:	Institutional/R	etail
LOCATION: 1815 M	Sachusetts Aver	nue	zor	NE: BC		
PHONE : (617)557-595	9	_ REQUESTED USE/	OCCUPANCY:	Mobile Co	mmunications	
		EXISTING CONDITIONS	REQUESTE CONDITIO		ORDINANCE REQUIREMENTS	${m s}^1$
TOTAL GROSS FLOOR	AREA:	N/A	No Chai	nge	N/A	- (max.)
LOT AREA:		N/A	No Char	ige	None	(min.)
RATIO OF GROSS FLOTO LOT AREA: 2	OR AREA	N/A	No Cha	nge	1.25/2.00	_ (max.)
LOT AREA FOR EACH	DWELLING UNIT:	N/A	No Cha	nge	N/A	(min.)
SIZE OF LOT:	WIDTH	N/A	No Char	nge	N/A	_ (min.)
	DEPTH					
Setbacks in	FRONT	29' +/-	No Cha	nge	None	(min.)
Feet:	REAR	401' +/-	No Cha	nge	20'	_ (min.)
	LEFT SIDE	N/A 	No Cha	nge	None	_ (min.)
	RIGHT SIDE	80' +/-	No Cha	nge	None	(min.)
SIZE OF BLDG.:	HEIGHT	78'0" (top of antenn		nge	55'	(max.)
	LENGTH	99' 10" (top of towe	r)			
	WIDTH					
RATIO OF USABLE OPI	EN SPACE					
TO LOT AREA: 3)		N/A	N/A		N/A	(min.)
NO. OF DWELLING UNI	ITS:	N/A	N/A		N/A	(max.)
NO. OF PARKING SPAC	CES:	N/A	N/A_		<u>N/A</u> (mi	n./max)
NO. OF LOADING AREA	<u>\S</u> :	N/A	N/A		N/A	(min.)
DISTANCE TO NEARESTON SAME LOT:	BLDG.	N/A	No Chan	ge	N/A	(min.)
Describe where applon same lot, and steel, etc. Not applicable						

^{1.} SEE CAMBRIDGE ZONING ORDINANCE ARTICLE 5.000, SECTION 5.30 (DISTRICT OF DIMENSIONAL REGULATIONS).

^{2.} TOTAL GROSS FLOOR AREA (INCLUDING BASEMENT 7'-0" IN HEIGHT AND ATTIC AREAS GREATER THAN 5') DIVIDED BY LOT AREA.

^{3.} OPEN SPACE SHALL NOT INCLUDE PARKING AREAS, WALKWAYS OR DRIVEWAYS AND SHALL HAVE A MINIMUM DIMENSION OF 15'.

SUPPORTING STATEMENT FOR A SPECIAL PERMIT

Please describe in complete detail how you meet each of the following criteria referring to the property and proposed changes or uses which are requested in your application. Attach sheets with additional information for special permits which have additional criteria, e.g.; fast food permits, comprehensive permits, etc., which must be met.

Granting the Special Permit requested for 1815 Massachusetts Avenue (location) would not be a detriment to the public interest because:

A) Requirements of the Ordinance can or will be met for the following reasons:

As demonstrated by the documents and information provided with this application, and as will be further demonstrated at the hearing on this matter, the modification constitutes an Eligible Facilities Request which must be allowed and cannot be denied, pursuant to Section 6409 of the Federal Spectrum Act and regulations thereunder.

B) Traffic generated or patterns of access or egress would not cause congestion hazard, or substantial change in established neighborhood character for the following reasons:

The upgraded facility will not change existing traffic demand or effect ingress or egress. The facility will generate only about one to two vehicle trips per month by a standard passenger vehicle during normal business hours for routine maintenance.

C) The continued operation of or the development of adjacent uses as permitted in the Zoning Ordinance would not be adversely affected by the nature of the proposed use for the following reasons:

The facility will have no adverse effects on the operation or development of adjacent uses. The facility will emit no light, odor, dust or glare and generates no unusual noise or other adverse impacts.

D) Nuisance or hazard would not be created to the detriment of the health, safety and/or welfare of the occupant of the proposed use or the citizens of the City for the following reasons:

The facility will generate no additional traffic or other negative impacts on surrounding properties or within the City of Cambridge. The facility requires no water or sewer service and emits no light, odor, dust, or glare and generates no unusual noise or other adverse impacts. The facility will be unoccupied, with no employees or customers. The availability of wireless communication enhances the health, safety, and welfare of the community.

E) For other reasons, the proposed use would not impair the integrity of the district or adjoining district or otherwise derogate from the intent or purpose of this ordinance for the following reasons:

The facility has been designed to minimize its visual impact and is in harmony with the general purpose of the Zoning Ordinance and in accordance with the requirements for an Eligible Facilities Request under Federal Law.

(ATTACHMENT B - PAGE 6)

CITY OF CAMBRIDGE, MASSACHUSETTS BOARD OF ZONING APPEAL

STATEMENT IN SUPPORT OF ELIGIBLE FACILITIES REQUEST UNDER SECTION 6409 and SPECIAL PERMIT, IN THE ALTERNATIVE

Applicant:

Cellco Partnership d/b/a Verizon Wireless

Property:

1815 Massachusetts Avenue

Zoning:

BC-Business C

Massachusetts Avenue Overlay District Lesley Porter Zoning Overlay District

Proposed Use:

Mobile Communications Facility (Collocation on Existing Facility)

BACKGROUND

The Applicant, Cellco Partnership, d/b/a Verizon Wireless ("Applicant" or "Verizon Wireless"), is licensed by the Federal Communications Commission ("FCC") to provide personal wireless services within the market area that includes the City of Cambridge. Pursuant to Section 6409 of the federal Middle Class Tax Relief and Job Creation Act of 2012, Verizon Wireless proposes to collocate its antennas and supporting equipment on and within an existing building at 1815 Massachusetts Avenue (the "Subject Property"). The Cambridge Board of Zoning Appeal ("Board") has previously authorized the use of the Subject Property as a base station for equipment associated with wireless communications services operated by other wireless service providers. Accordingly, Verizon Wireless is submitting this application as an "eligible facilities request." As documented below, and in the additional materials submitted by the Applicant, this request satisfies the applicable standards under Federal law for an eligible facilities request, and therefore Verizon Wireless is entitled to approval on that basis.

The existing facility and the proposed Verizon Wireless mobile communications facility are personal wireless services facilities within the meaning of the Federal Telecommunications Act ("TCA"), 47 U.S.C. § 332(c)(7)(C)(ii). The proposed Verizon Wireless installation is also a mobile communications facility within the meaning of the Cambridge Zoning Ordinance ("Ordinance"). This application is submitted with full reservation of the Applicant's rights under federal, state, and local law.

DESCRIPTION OF PROJECT

The Subject Property is improved with a building currently owned by Lesley University. The ground floor is occupied by retail space and the upper floors are used by the University. The building includes a central tower feature that rises above the roof to a height of 99' 10". As shown on the plans and photographs submitted with this application (Exhibits A and B) Verizon Wireless proposes to install four sectors of three antennas (a total of 12 antennas) on the façade of the tower portion of the building at a centerline height of 74'-10". The antennas will be

mounted using low profile mounts and painted to match the building façade. Remote radioheads and surge protectors will be mounted behind the facade. Verizon Wireless also proposes to install equipment, including a natural gas fueled emergency generator, and a small GPS antenna on an existing steel frame on the roof of the building, and to use an existing cable tray for its equipment.

The Board has authorized the installation and modification of wireless communications equipment on the Subject Property several times in the past. Special Permit #8358, dated September 20, 2001 allowed Sprint to install 12 antennas and accessory rooftop equipment. Special Permit #9885, dated April 9, 2010 authorized the addition of antennas and equipment for Clear Wireless. Special Permit #10072, dated April 15, 2011, allowed New Cingular Wireless to add and relocate antennas and equipment. Special Permit #10252, dated June 21, 2012 authorized Sprint Spectrum to modify its installation and, Special Permit #5263-2014, dated December 22, 2014, allowed Sprint to further modify its installation.

Verizon Wireless now proposes to add four sectors (one per each façade) of three panel antennas each to the tower feature. Rooftop equipment including a natural gas generator and a GPS antenna will be added to the rooftop on an existing steel frame and will be largely invisible from ground level.

SECTION 6409(a) OF THE MIDDLE CLASS TAX RELIEF AND JOB CREATION ACT OF 2012 ("SPECTRUM ACT")

Under the Spectrum Act and the implementing regulations adopted by the Federal Communications Commission on January 8, 2015 (the "FCC Regulations"), the proposed modification to the Existing Facility constitutes an eligible facilities request that can and should be authorized by your office and should not require any zoning approvals from any City of Cambridge board or commission. The reasons for this are as explained below.

The Spectrum Act states, in pertinent part: "[n]otwithstanding section 704 of the Telecommunications Act of 1996² or any other provision of law, a state or local government may not deny, and shall approve, any eligible facilities request for a modification of an existing wireless tower or base station that does not substantially change the physical dimensions of such tower or base station." The rules for implementing this requirement of the Spectrum Act (i.e., the FCC Regulations) went into effect on April 8, 2015.

Pursuant to the FCC Regulations, an "eligible facilities request" means "any request for modification of an existing wireless tower or *base station* that does not *substantially change* the physical dimensions of such tower or base station, involving ... collocation of new *transmission equipment* ... or replacement of transmission equipment." The FCC Regulations define "base station" to mean:

¹ See 47 C.F.R. 1.40001 (Wireless Facility Modifications).

² The Telecommunications Act of 1996 is codified as 47 U.S.C. § 332(c)(7).

³ 47 U.S.C. 1455(a)(1) (emphasis added).

⁴ 47 C.F.R. § 1.40001(b)(3) (emphasis added).

- (i) A structure or equipment at a fixed location that enables Commission-licensed or authorized wireless communications between user equipment and a communications network.
- (iii) The term includes any structure other than a tower that, at the time the relevant application is filed with the State or local government under this section, supports or houses [equipment associated with wireless communications services] that has been reviewed and approved under the applicable zoning or siting process, or under another State or local regulatory review process, even if the structure was not built for the sole or primary purpose of providing such support.⁵

"Transmission equipment" is defined to include not only antennas but also all "equipment that facilitates transmission" for a FCC-licensed or authorized wireless communication service, including but not limited to "radio transceivers, antennas, coaxial or fiber-optic cable, and regular and backup power supply."

The proposed Verizon Wireless collocation on the Subject Property is an "eligible facilities request" under the Spectrum Act because:

- (1) the Subject Property constitutes a "base station" and an "eligible support structure" in that it currently exists and "supports or houses" wireless communications equipment that has been reviewed and approved under the City's zoning ordinance namely, the existing antennas and equipment installed pursuant to prior approvals of the Board including Special Permit #8358, #9885, #10072, #10252, and #5263-2014.
- (2) the proposed addition by Verizon Wireless of antennas, RRHs and other transmission equipment on the Subject Property for the purpose of transmitting and receiving radio frequency signals for communication purposes constitutes a "collocation of new transmission equipment."
- (3) the proposed modification does not "substantially change the physical dimensions" of the base station. The proposed modification does not constitute a "substantial change" as defined under the FCC Regulations because it:
 - (i) does not involve the installation of more than the standard number of equipment cabinets (*Verizon Wireless proposes to install 2 equipment cabinets*);
 - (ii) does not entail excavation or deployment outside of the current site (all changes are taking place on the building itself);
 - (iii) does not defeat the concealment elements of the Existing Facility (The prior decisions allowing wireless facilities at the Subject Property have required that antennas be painted to match the building, which Verizon Wireless intends to do. They have also required that mounts not exceed the length of the antenna, which would also be the case for the proposed Verizon Wireless installation. The rooftop equipment will be located where equipment of a prior wireless carrier was formerly

⁵ 47 C.F.R. § 1.40001(b)(1).

⁶ 47 C.F.R. § 1.40001(b)(8).

located and will largely be screened from view by the fence enclosing the rooftop walking track.);

- (iv) does not increase the height of the building by more than 10% or ten feet (there will be no increase in height);
- (v) does not add any appurtenances that would protrude from the edge of the building by more than six feet (new antennas and mounts will protrude no more than approximately two feet from the building façade); and
- (vi) complies with the conditions imposed by the BZA Decision (the conditions imposed in the BZA Decision that would be relevant to this upgrade request are satisfied, in that the antennas will be painted to match the building and low profile mounts will be used that will not exceed the length of the antennas. See Photosimulation study attached as **Exhibit B**.⁷

Pursuant to Section 1.40001(c)(1) of the FCC Regulations, an applicant asserting that a request for modification is covered by the Spectrum Act may be required to submit "documentation or information only to the extent reasonably related to determining whether the request meets the requirements of [the Spectrum Act]." Section 1.40001(c)(1) further states that a state or local government "may <u>not</u> require an applicant to submit any other documentation, including but not limited to documentation intended to illustrate the need for such wireless facilities or to justify the business decision to modify such wireless facilities."

An Eligible Facilities Request should not require a special permit.

There is no legal basis for the Commissioner to require Verizon Wireless to submit an application to modify the existing special permits in the BZA Decision in order to obtain approval of this Eligible Facility Request. First, the federal statute itself states that a municipality "may not deny and shall approve" a qualifying Eligible Facilities Request. 47 U.S.C. 1455(a)(1). Requiring that the party presenting an Eligible Facilities Request submit to a zoning special permit process is inconsistent with the federal statute because the special permit process is one that allows a municipal board to exercise discretion in determining whether to grant relief. In contrast, the federal statute is clear that a municipality reviewing an eligible facilities request shall approve the request if it meets the standards of the statute. There is no provision for the exercise of discretion. It is well established under Massachusetts law that "a use allowed as of right cannot be made subject to the grant of a special permit inasmuch as the concepts of a use as of right and a use dependent on discretion are mutually exclusive."10 Moreover, as noted in the Verizon Wireless EFR, the Massachusetts Attorney General, in reviewing municipal bylaw amendments addressing wireless communications facilities, has interpreted Section 6409(a) as it relates to municipal zoning provisions and has ruled, repeatedly, that eligible facilities requests shall not be subject to a the special permit process. 11

⁹ See MacGibbon v. Board of Appeals, 356 Mass.635, 638 (1970)(Special permit granting authority "is not compelled to grant the permit. It has discretionary power in acting thereon.")

¹⁰ Prudential Ins. Co. v. Board of Appeals, 23 Mass. App. Ct. 278, 281 (1986), citing SCIT, Inc. v. Planning Bd. of Braintree, 19 Mass. App. Ct. 101 (1984).

⁷ See 47 C.F.R. § 1.40001(b)(7)(i)-(vi) (definition of "substantial change").

⁸ 47 C.F.R. § 1.40001(c)(1) (emphasis added).

¹¹ See e.g. letter dated November 28, 2016 to Town of Clarksburg Town Clerk, at pp 2-3, available at http://www.mlu.ago.state.ma.us/Default.aspx?sectionYear=1&year=2016.

Furthermore, as a matter of state and local law, the Board lacks authority under the Cambridge Zoning Ordinance to review Eligible Facilities Requests through a special permit process. Even if federal and state law did permit local governments to require that Eligible Facilities Requests be reviewed as a special permit, Cambridge has not done so. Section 10.13 of the Zoning Ordinance specifies the powers and duties of the Board as they relate to special permits, those powers are specifically "[t]o hear and decide applications for special permits upon which the Board is empowered to act under Section 10.30 of this Article." (emphasis added). Section 10.41 provides that special permits "may be granted [by] the Board of Zoning Appeal . . . as specified elsewhere in this Ordinance." No provision of the Ordinance authorizes the Board to review modifications of existing wireless facilities that qualify as "Eligible Facilities Requests" under Federal Law, let alone to do so through the special permit process. Moreover, the procedural and substantive standards set forth in the balance of Section 10.40 through 10.46 and in G.L. c. 40A are wholly inconsistent with the intent and substance of Section 6409(a) and its implementing regulations.

SATISFACTION OF SPECIAL PERMIT STANDARDS

The Applicant is confident that all of the standards for the approval of this petition as an Eligible Facilities Request under Section 6409(a) have been met. Nonetheless, this petition also satisfies the requirements of the Cambridge Zoning Ordinance for the grant of a special permit pursuant to Sections 4.32.(g).1, 4.40 (Footnote 49) and 10.40 through 10.46 of the Cambridge Zoning Ordinance, and if the Board determines that the proposed installation does not qualify as an Eligible Facilities Request, the Board should approve the proposed facility and grant a special permit under these provisions.

In reviewing a special permit application for a mobile communications facility, the BZA considers the standards set forth at Footnote 49 to the Table of Use Regulations (Zoning Ordinance section 4.40.49). The following analysis demonstrates that the proposed modification of the existing wireless installation meets these standards.¹³

1. The scope of or limitations imposed by any license secured from any state or federal agency having jurisdiction over such matters.

As documented at Exhibit D, Verizon Wireless is licensed by the Federal Communications Commission ("FCC") to provide personal wireless services within the market area that includes the City of Cambridge. There are no limitations imposed on Verizon Wireless' licenses that would prevent it from installing and operating a mobile communications facility on the Subject Property as proposed in this application.

¹² Zoning Ordinance Section 10.13(b). Section 10.30 of the Ordinance pertains only to Variances – presumably the intended reference is to Section 10.40, captioned "Special Permits."

¹³ In providing information addressing the standards set forth in the Ordinance that concern the proposed wireless communications use, Verizon Wireless does not concede, and expressly reserves all of its rights with respect to, any attempt by the City to exercise jurisdiction over matters concerning Verizon Wireless's license or the technical performance of the proposed site or its network.

2. The extent to which the visual impact of the various elements of the proposed facility is minimized: (1) through the use of existing mechanical elements on a building's roof or other features of the building as support and background; (2) through the use of materials that in texture and color blend with the materials to which the facilities are attached; or (3) other effective means to reduce the visual impact of the facility from off the site.

As depicted on the Plans, the proposed Verizon Wireless installation satisfies these standards. The proposal includes the addition of twelve panel antennas mounted below existing antenna arrays of other carriers on the tower portion of the building, and painted to match, thereby minimizing visual impact. The proposal also includes the installation of rooftop equipment on an existing steel frame that will be largely screened from view at ground level.

3. Where it is proposed to erect such a facility in any residential zoning district, the extent to which there is a demonstrated public need for the facility at the proposed locations, the existence of alternative, functionally suitable sites in nonresidential locations, the character of the prevailing uses in the area, and the prevalence of other, existing mechanical systems and equipment carried on or above the roof of nearby structures. The Board of Zoning Appeal shall grant a special permit to erect such a facility in a residential zoning district only upon a finding that nonresidential uses predominate in the vicinity of the proposed facility's location and that the telecommunication facility is not inconsistent with the character that does prevail in the surrounding neighborhood.

Not applicable. The Subject Property is not located in a residential zoning district.

The proposed modification of the existing wireless communications installation also satisfies the criteria of Section 10.43 of the Ordinance relating to the granting of special permits. The project conforms to the standards of Section 4.40.49 as discussed above. It will not have any traffic impacts and will not affect the operation or development of adjacent uses. It will not be detrimental to the health, safety or welfare of the City, and indeed the availability of reliable wireless communications enhances health, safety and welfare. The proposed modification of the existing installation will also not impair the integrity of the district or adjoining districts, or derogate from the intent and purpose of the Ordinance. The availability of reliable wireless communications service for both voice and data communications benefits businesses and residents which increasingly rely on these services for a wide variety of purposes. Reliable wireless service also enhances community safety, because it is used by public safety officials as well as the public in times of crisis, natural disaster, inclement weather, and similar circumstances.

Because the proposed Verizon Wireless installation satisfies the criteria for granting a special permit, the applicant respectfully requests that if the Board determines that this collocation proposal does not qualify as an Eligible Facilities Request under federal law, it grant a special permit to allow the proposed Verizon Wireless facility.

CONCLUSION

For all of the foregoing reasons, Verizon Wireless respectfully requests that the Board determine that the proposed Verizon Wireless collocation on the Subject Property, as described in the Plans and other submittals, constitutes an Eligible Facility entitled to the Board's approval. In the alternative, Verizon Wireless requests that the Board grant a special permit and any other relief that may be appropriate or necessary, to authorize the proposed wireless communications facility.

Respectfully submitted,

Cellco Partnership d/b/a Verizon Wireless

By its attorney,

Michael S. Giaimo, Esq.

Robinson & Cole LLP

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Boston, MA 02108

(617) 557-5959


Dated: June 26, 2017

verizon

CAMBRIDGE 5 MA

(LESLEY UNIVERSITY) **1815 MASSACHUSETTS AVENUE CAMBRIDGE, MA 02140**

SITE NAME:

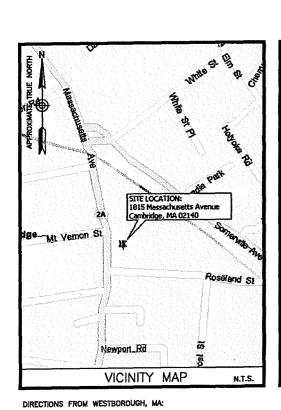

TAKE TO 1-90 E. TAKE EXIT 14 TOWARD S

IARE IU 1-90 E. IAKE EXII 14 IOWARD S
SHORE/N.H-MAIN/1-95/MA-128, TALE EXIT 29A TO MERGE ONTO
MA-2 E TOWARD ARLINGTON/CAMBRIDGE. SLIGHT RIGHT ONTO
ALEWIFE BROOK PKWY. TURN RIGHT ONTO BAY STATE RD. CONTINUE
ONTO FIELD ST. FIELD ST. TURN LEFT AND BECOMES GARDEN ST.
TURN LEFT ONTO LINNAEAN ST. TURN LEFT ONTO MASSACHUSETTS
AVE. THE SITE WILL BE ON THE RIGHT.

ENGINEER DEWRERRY ENGINEERS INC. BOSTON, MA 02210 PHONE # (617) 531-0819 FAX # (617) 695-3310 CONTACT: BENJAMIN REVETTE P.E. CONSTRUCTION VERIZON WIRELESS 118 FLANDERS ROAD WESTBOROUGH, MA 01581-3956 PHONE # (617) 921-9716 CONTACT: ERIC WAINWRIGHT

CONSULTANT TEAM

CAMBRIDGE 5 MA (LESLEY UNIVERSITY) LESLEY REALTY CORP. 29 EVERETT ST. APPLICANT:
BELL ATLANTIC MOBILE OF MASSACHUSETTS
CORPORATION LTD D/B/A
VERIZON WIRELESS
118 FLANDERS ROAD WESTBOROUGH, MA 01581-3956 ELECTRIC UTILITY: NSTAR (800) 592-2000 TELEPHONE UTILITY: VERIZON (800) 941-9980 COORDINATES*: LATITUDE: 42" 23" 13.67" N. LONGITUDE: 71" 07' 7.80" W.

PROJECT SUMMARY

THIS DOCUMENT WAS DEVELOPED TO REFLECT A SPECIFIC SIT AND ITS SITE CONDITIONS AND IS NOT TO BE USED FOR ANOTHER SITE OR WHEN OTHER CONDITIONS PERTAIN, REUSE OF THIS DOCUMENT IS AT THE SOLE RISK OF THE USER. FACILITY IS UNMANNED AND NOT FOR HUMAN HABITATION

SITE ADDRESS:

ZONING DISTRICT:

BC - BUSINESS C

1815 MASSACHUSETTS AVENUE CAMBRIDGE, MA 02140

PROJECT DIRECTORY

PROJECT DESCRIPTION

NO. A-6 THE SITE CONSIST OF INSTALLING NEW EQUIPMENT CABINETS ON AN EXISTING STEEL FRAME. TWELEVE (12) ANTENNAS
(3/SECTOR) ARE TO BE INSTALLED ON THE AN EXISTING
BUILDING TOWER FACADE. ASSOCIATED RRH AND SURGE
PROTECTION ARE TO BE INSTALLED INSIDE EXISTING BUILDING
TOWER, POWER AND TELCO TO COME FROM EXISTING
SOURCES ON SITE. F-1 E-2 P-2

SHT DESCRIPTION T-1 TITLE SHEET GENERAL NOTES 7-1 ARITTERS & PLOT PLANS A-1 ROOF PLAN A-2 WEST ELEVATION A-3 NORTH & SOUTH ELEVATIONS A-4 CONSTRUCTION DETAILS-I A-5 CONSTRUCTION DETAILS-II CABINET & GENERATOR DETAILS FRAMING PLAN & STRUCTURAL DETAILS RISER DIAGRAMS GROUNDING DIAGRAM & DETAILS P-1 NATURAL GAS DETAILS NATURAL GAS PIPING NOTES & DETAILS SHEET INDEX

118 FLANDERS ROAD WESTBOROUGH, MA 01581-3956

CAMBRIDGE 5 MA (LESLEY UNIVERSITY)

	Ç	ONSTRUC	TION	DRAWINGS
	1	04/14/17	FOR	SUBMITTAL
1				
	Α	04/12/16	FOR	REVIEW

Dewberrv•

Dewberry Engineers Inc. 280 SUMMER STREET 10TH FLOOR BOSTON, MA 02210 PHONE: 617,695,3400



DRAWN BY:	MR
REVIEWED BY:	MFT
CHECKED BY:	BBR
PROJECT NUMBER:	50002925
JOB NUMBER:	50069466
SITE ADDRESS:	

1815 MASSACHUSETTS AVENUE CAMBRIDGE, MA 02140

SHEET TITLE

TITLE SHEET

SHEET NUMBER

T-1

GENERAL CONSTRUCTION NOTES:

- ALL WORK SHALL CONFORM TO ALL CURRENT APPLICABLE FEDERAL, STATE, AND LOCAL CODES, AND COMPLY WITH VERIZION WIRELESS SPECIFICATIONS.
- CONTRACTOR SHALL CONTACT "DIG SAFE" (888-344-7233) FOR IDENTIFICATION OF UNDERGROUND UTILITIES PRIOR TO START OF CONSTRUCTION.
- 3. CONTRACTOR IS RESPONSIBLE FOR COORDINATING ALL REQUIRED INSPECTIONS.
- ALL DIMENSIONS TO, OF, AND ON EXISTING BUILDINGS, DRAINAGE STRUCTURES, AND SITE IMPROVEMENTS SHALL BE VERIFIED IN FIELD BY CONTRACTOR WITH ALL DISCREPANCIES REPORTED TO THE ENGINEER.
- 5. DO NOT CHANGE SIZE OR SPACING OF STRUCTURAL ELEMENTS.
- 6. DETAILS SHOWN ARE TYPICAL; SIMILAR DETAILS APPLY TO SIMILAR CONDITIONS UNLESS OTHERWISE NOTED.
- THESE DRAWINGS DO NOT INCLUDE NECESSARY COMPONENTS FOR CONSTRUCTION SAFETY WHICH IS THE SOLE RESPONSIBILITY OF THE CONTRACTOR.
- CONTRACTOR SHALL BRACE STRUCTURES UNTIL ALL STRUCTURAL ELEMENTS NEEDED FOR STABILITY ARE INSTALLED. THESE ELEMENTS ARE AS FOLLOWS: LATERAL BRACING, ANCHOR BOLTS, ETC.
- 9. CONTRACTOR SHALL DETERMINE EXACT LOCATION OF EXISTING UTILITIES, DRAIN PIPES, VENTS, ETC. BEFORE COMMENCING
- INCORRECTLY FABRICATED, DAMAGED, OR OTHERWISE MISFITTING OR NONCONFORMING MATERIALS OR CONDITIONS SHALL BE REPORTED TO THE OWNER PRIOR TO REMEDIAL OR CORRECTIVE ACTION. ANY SUCH REMEDIAL ACTION SHALL REQUIRE WRITTEN APPROVAL BY THE OWNER'S REPRESENTATIVE PRIOR TO PROCEEDING.
- 11. EACH CONTRACTOR SHALL COOPERATE WITH THE OWNER'S REPRESENTATIVE, AND COORDINATE HIS WORK WITH THE WORK OF OTHERS.
- 12. CONTRACTOR SHALL REPAIR ANY DAMAGE CAUSED BY CONSTRUCTION OF THIS PROJECT TO MATCH EXISTING PRE-CONSTRUCTION CONDITIONS TO THE SATISFACTION OF THE VERIZON WIRELESS CONSTRUCTION MANAGER.
- 13. ALL CABLE/CONDUIT ENTRY/EXIT PORTS SHALL BE WEATHERPROOFED DURING INSTALLATION USING A SILICONE SEALANT.
- 14. WHERE EXISTING CONDITIONS DO NOT MATCH THOSE SHOWN IN THIS PLAN SET, CONTRACTOR WILL NOTIFY ENGINEER, VERIZON WIRELESS PROJECT CONSTRUCTION MANAGER, AND LANDLORD IMMEDIATELY.
- 15. CONTRACTOR SHALL ENSURE ALL SUBCONTRACTORS ARE PROVIDED WITH A CURRENT SET OF DRAWINGS AND SPECIFICATIONS FOR THIS PROJECT.
- ALL ROOF WORK SHALL BE DONE BY A QUALIFIED AND EXPERIENCED ROOFING CONTRACTOR IN COORDINATION WITH ANY CONTRACTOR WARRANTING THE ROOF TO ENSURE THAT THE WARRANTY IS MAINTAINED.
- 17. CONTRACTOR SHALL REMOVE ALL RUBBISH AND DEBRIS FROM THE SITE AT THE END OF EACH DAY.
- 18. CONTRACTOR SHALL COORDINATE WORK SCHEDULE WITH LANDLORD AND TAKE PRECAUTIONS TO MINIMIZE IMPACT AND DISRUPTION OF OTHER OCCUPANTS OF THE FACILITY.
- 19. CONTRACTOR SHALL FURNISH VERIZON WIRELESS WITH THREE AS-BUILT SETS OF DRAWINGS UPON COMPLETION OF WORK.
- 20. ANTENNAS AND CABLES ARE TYPICALLY PROVIDED BY VERIZON WIRELESS. PRIOR TO SUBMISSION OF BID, CONTRACTOR SHALL COORDINATE WITH VERIZON WIRELESS PROJECT MANAGER TO DETERMINE WHAT, IF ANY, ITEMS WILL BE PROVIDED BY VERIZON WIRELESS. ALL ITEMS NOT PROVIDED BY VERIZON WIRELESS. ALL ITEMS PROVIDED BY VERIZON WIRELESS.
- 21. PRIOR TO SUBMISSION OF BID, CONTRACTOR WILL COORDINATE WITH VERIZON WIRELESS PROJECT MANAGER TO DETERMINE IF ANY PERMITS WILL BE OBTAINED BY VERIZON WIRELESS. ALL REQUIRED PERMITS NOT OBTAINED BY VERIZON WIRELESS MUST BE OBTAINED, AND PAID FOR, BY THE CONTRACTOR.
- 22. GENERAL CONTRACTOR SHALL HAVE A LICENSED HVAC CONTRACTOR START THE HVAC UNITS, SYNCHRONIZE THE THERMOSTATS, ADJUST ALL SETTINGS ON EACH UNIT ACCORDING TO VERIZON WIRELESS CONSTRUCTION MANAGER'S SPECIFICATIONS, AND THOROUGHLY TEST AND BALANCE EACH UNIT TO ENSURE PROPER OPERATION PRIOR TO TURNING THE SITE OVER TO DWINER.
- 23. CONTRACTOR SHALL INSTALL ALL SITE SIGNAGE IN ACCORDANCE WITH VERIZON WIRELESS SPECIFICATIONS AND REQUIREMENTS.
- 24. CONTRACTOR SHALL SUBMIT ALL SHOP DRAWINGS TO ENGINEER FOR REVIEW AND APPROVAL PRIOR TO FABRICATION.
- 25. UNLESS OTHERWISE NOTED VERIZON WIRELESS SHALL PROVIDE ALL REQUIRED RF MATERIAL FOR CONTRACTOR TO INSTALL, INCLUDING ANTENNAS, THA'S, BIAS-T'S, COMBINERS, PDU, DC BLOCKS, SURGE ARRESTORS, GPS ANTENNA, GPS SURGE ARRESTOR, COAXIAL CABLE.
- 26. PRIOR TO SUBMISSION OF BID, CONTRACTOR SHALL VERIFY ALL EQUIPMENT TO BE PROVIDED BY VERIZON WIRELESS FOR INSTALLATION BY CONTRACTOR.
- 27. ALL EQUIPMENT SHALL BE INSTALLED ACCORDING TO MANUFACTURER'S SPECIFICATIONS AND LOCATED ACCORDING TO VERIZON MIRELESS SPECIFICATIONS, AND AS SHOWN IN THESE PLANS.
- 28. DETAILS SHOWN ARE TYPICAL; SIMILAR DETAILS APPLY TO SIMILAR CONDITIONS UNLESS OTHERWISE NOTED.
- THE CONTRACTOR SHALL SUPERVISE AND DIRECT THE PROJECT DESCRIBED HEREIN. THE CONTRACTOR SHALL BE SOLELY RESPONSIBLE FOR ALL THE CONSTRUCTION MEANS, METHODS, TECHNIQUES, SEQUENCES AND PROCEDURES AND FOR COORDINATING ALL PORTIONS OF THE WORK UNDER THE CONTRACT.
- 30. CONTRACTOR SHALL NOTIFY THE ENGINEER A MINIMUM OF 48 HOURS IN ADVANCE PRIOR TO CONSTRUCTION START, MORE SPECIFICALLY BEFORE; SEALING ANY FLOOR, WALL OR ROOF PENETRATION, FINAL UTILITY CONNECTIONS, POURING CONCRETE, BACKFILLING UTILITY TRENCHES AND STRUCTURAL POST OR MOUNTING CONNECTIONS, FOR ENGINEERING REVIEW AND REPORTS.
- 31. SEAL PENETRATIONS THROUGH FIRE RATED AREAS WITH UL LISTED D FIRE CODE APPROVED MATERIALS.
- 32. REPAIR ANY DAMAGE DURING CONSTRUCTION TO MATCH EXISTING PRE—CONSTRUCTION CONDITIONS TO THE SATISFACTION OF THE CONSTRUCTION MANAGER AND LANDLORD.
- 33. ALL DISRUPTIVE WORK AND WORK WITHIN TENANT SPACES TO BE COORDINATED WITH BUILDING REPRESENTATIVE.

CODE SPECIFICATIONS:

- 1. ALL GENERAL WORK TO BE DONE IN ACCORDANCE WITH THE MASSACHUSETTS STATE BUILDING CODE, 8TH EDITION (780 CMR).
- 2. ALL ELECTRICAL WORK TO BE DONE IN ACCORDANCE WITH THE NATIONAL ELECTRICAL CODE 2014 (NEC 2014).
- 3. ALL STRUCTURAL WORK TO BE DONE IN ACCORDANCE WITH THE AMERICAN INSTITUTE OF STEEL CONSTRUCTION MANUAL, 13TH EDITION (AISC 13TH ED.)
- ALL CONCRETE WORK TO BE DONE IN ACCORDANCE WITH THE AMERICAN CONCRETE INSTITUTE (ACI 301) SPECIFICATIONS FOR STRUCTURAL CONCRETE FOR BUILDINGS (ACI 318) AND BUILDING CODE REQUIREMENTS FOR
- ALL REINFORCING STEEL WORK TO BE DONE IN ACCORDANCE WITH THE (ACI 315) MANUAL OF STANDARD PRACTICE FOR DETAILING REINFORCED CONCRETE STRUCTURES.

GENERAL ELECTRICAL NOTES:

- SUBMITTAL OF BID INDICATES CONTRACTOR IS COGNIZANT OF ALL JOB SITE CONDITIONS AND WORK TO BE PERFORMED UNDER THIS CONTRACT.
- CONTRACTOR SHALL PERFORM ALL VERIFICATION OBSERVATION TESTS, AND EXAMINATION WORK PRIOR TO THE ORDERING OF THE ELECTRICAL EQUIPMENT AND THE ACTUAL CONSTRUCTION. CONTRACTOR SHALL ISSUE A WRITTEN NOTICE OF ALL FINDINGS TO THE ARCHITECT LISTING ALL MALFUNCTIONS, FAULTY
- 3. HEIGHTS SHALL BE VERIFIED WITH OWNER PRIOR TO INSTALLATION.
- 4. THESE PLANS ARE DIAGRAMMATIC ONLY, FOLLOW AS CLOSELY AS POSSIBLE.
- EACH CONDUCTOR OF EVERY SYSTEM SHALL BE PERMANENTLY TAGGED IN EACH PANELBOARD, PULLBOX, J-BOX, SWITCH BOX, ETC., IN COMPLIANCE WITH OCCUPATIONAL SAFETY AND HEALTH ACT (O.S.H.A.)
- CONTRACTOR SHALL PROVIDE ALL LABOR, MATERIALS, INSURANCE, EQUIPMENT, INSTALLATION, CONSTRUCTION TOOLS, TRANSPORTATION, ETC., FOR A COMPLETE AND PROPERLY OPERATIVE SYSTEM EMERGIZED THROUGHOUT AND AS INDICATED ON DRAWINGS, AS SPECIFIED HEREIN AND/OR AS OTHERWISE
- ALL MATERIALS AND EQUIPMENT SHALL BE NEW AND IN PERFECT CONDITION WHEN INSTALLED AND SHALL BE OF THE BEST GRADE AND OF THE SAME MANUFACTURER THROUGHOUT FOR EACH CLASS OR GROUP OF EQUIPMENT, MATERIALS SHALL BE LISTED AND APPROVED BY UNDERWRITER'S LABORATORY AND SHALL BEAR THE INSPECTION LABEL "J" WHERE SUBJECT TO SUCH APPROVAL MATERIALS SHALL MEET WITH APPROVAL OF THE DIVISION OF INDUSTRIAL SAFETY AND ALL GOVERNING BODIES HAVING JURISDICTION. MATERIALS SHALL BE MANUFACTURED IN ACCORDANCE WITH APPLICABLE STANDARDS ESTABLISHED BY ANSI, NEWA AND MEDIA AND MEDIA
- B. ALL CONDUIT INSTALLED MAY BE SURFACE MOUNTED UNLESS OTHERWISE NOTED.
- CONTRACTOR SHALL CARRY OUT HIS WORK IN ACCORDANCE WITH ALL GOVERNING STATE, COUNTY AND LOCAL CODES AND O.S.H.A.
- 10. CONTRACTOR SHALL SECURE ALL NECESSARY BUILDING PERMITS AND PAY ALL REQUIRED FEES.
- COMPLETE JOB SHALL BE GUARANTEED FOR A PERIOD OF ONE (1) YEAR AFTER THE DATE OF JOB ACCEPTANCE BY OWNER, ANY WORK, MATERIAL OR EQUIPMENT FOUND TO BE FAULTY DURING THAT PERIOD SHALL BE CORRECTED AT ONCE, UPON WRITTEN NOTIFICATION, AT THE EXPENSE OF THE CONTRACTOR.
- 12. ALL CONDUIT ONLY (C.O.) SHALL HAVE A PULL WIRE OR ROPE.
- PROVIDE PROJECT MANAGER WITH ONE SET OF COMPLETE ELECTRICAL "AS INSTALLED" DRAWINGS AT THE COMPLETION OF THE JOB, SHOWING ACTUAL DIMENSIONS, ROUTINGS, AND CIRCUITS.
- 14. ALL BROCHURES, OPERATING MANUALS, CATALOGS, SHOP DRAWINGS, ETC. SHALL BE TURNED OVER TO OWNER AT JOB COMPLETION.
- 15. USE T-TAP CONNECTIONS ON ALL MULTI-CIRCUITS WITH COMMON NEUTRAL CONDUCTOR FOR LIGHTING FIXTURE.
- 16. ALL CONDUCTORS SHALL BE COPPER.
- 17. ALL CIRCUIT BREAKERS, FUSES AND ELECTRICAL EQUIPMENT SHALL HAVE AN INTERRUPTING RATING NOT LESS THE MAXIMUM SHORT CIRCUIT CURRENT TO WHICH THEY MAY BE SUBJECTED, AND A MINIMUM OF
- 18. THE ENTIRE ELECTRICAL INSTALLATION SHALL BE GROUNDED AS REQUIRED BY ALL APPLICABLE CODES.
- 19. PATCH, REPAIR AND PAINT ANY AREA THAT HAS BEEN DAMAGED IN THE COURSE OF THE ELECTRICAL
- 20. IN DRILLING HOLES INTO CONCRETE WHETHER FOR FASTENING OR ANCHORING PURPOSES, OR PENETRATIONS THROUGH THE FLOOR FOR CONDUIT RUNS, M PIPE RUNS, ETC., IT MUST BE CLEARLY UNDERSTOOD THAT TENDONS AND/OR REINFORCING STEEL WILL NOT BE DRILLED INTO, CUT OR DAMAGED UNDER ANY CIRCUMSTANCES.
- 21. LOCATION OF TENDONS AND/OR REINFORCING STEEL ARE NOT DEFINITELY KNOWN AND, THEREFORE, MUST BE SEARCHED FOR BY APPROPRIATE METHODS AND EQUIPMENT VIA X-RAY OR OTHER DEVICES THAT CAN ACCURATELY LOCATE THE REINFORCING AND/OR STEEL TENDONS.
- 22. PENETRATIONS IN FIRE RATED WALLS SHALL BE FIRE STOPPED IN ACCORDANCE WITH SECTION NO. 4305
- 23, WIRE AND CABLE CONDUCTORS SHALL BE COPPER \$12 AWG MINIMUM UNLESS SPECIFICALLY STATED OTHERWISE ON DRAWINGS.
- 24. VERIFY ALL CONDUIT ROUTING W/OWNER REP. & VERIZON C.M. 25. ALL MATERIALS SHALL BE U.L. LISTED.
- 26. CONDUIT:

 a. RIGID CONDUIT SHALL BE U.L. LABEL GALVANIZED ZINC COATED WITH ZINC INTERIOR AND SHALL BE USED WHEN INSTALLED IN OR UNDER CONCRETE SLABS, IN CONTACT WITH THE EARTH, UNDER PUBLIC ROADWAYS, IN MASONRY WALLS OR EXPOSED ON BUILDING EXTERIOR.RIGID CONDUIT IN CONTACT WITH EARTH SHALL BE 1/2 LAPPED WRAPPED WITH HUNTS WRAP

 - CONDUIT IN CONTACT WHITE EARTH SHALL BE 1/2 DAPPED WROPPED WHITE HAVES WARD PROCESS NO. 3.
 ELECTRICAL METALLIC TUBING SHALL HAVE U.L. LABEL, FITTINGS SHALL BE GLAND RING COMPRESSION TYPE. EMT SHALL BE USED ONLY FOR INTERIOR RUNS.
 FLEXIBLE METALLIC CONDUIT SHALL HAVE U.L. LISTED LABEL AND MAY BE USED WHERE PERMITTED BY CODE. FITTINGS SHALL BE "ALKE" OR "SOURCEZE" TYPE, SEAL TIGHT FLEXIBLE CONDUIT. ALL CONDUIT IN EXCESS OF SIX FEET IN LENGTH SHALL HAVE FULL SIZE GROUND
 - THE CONDUIT RUNS MAY BE SURFACE MOUNTED IN CEILINGS OR WALLS UNLESS INDICATED OTHERWISE. CONDUIT INDICATED SHALL RUN PARALLEL OR AT RIGHT ANGLES TO CEILING, FLOOR OR BEAMS. VERIEY EXACT ROUTING OF ALL EXPOSED CONDUIT WITH ARCHITECT PRIOR TO INSTALLING.
- 27. ALL ELECTRICAL EQUIPMENT SHALL BE LABELED WITH PERMANENT ENGRAVED PLASTIC LABELS.
- 28. COORDINATE THE ELECTRICAL SERVICE WITH BUILDING OWNER.
- 29. GROUNDING SYSTEM RESISTANCE SHALL NOT EXCEED 5 OHMS. IF THE RESISTANCE VALUE IS EXCEEDED, NOTIFY THE OWNER FOR FURTHER INSTRUCTION ON METHODS FOR REDUCING THE RESISTANCE VALUE. SUBMIT TEST REPORTS AND FURNISH TO DISPATCH COMMUNICATIONS ONE COMPLETE SET OF PRINTS SHOWING "INSTALLED WORK".
- 30. UPON COMPLETION OF WORK, CONDUCT CONTINUITY, AND FALL POTENTIAL GROUNDING TESTS FOR APPROVAL SUBMIT TEST REPORTS TO PROJECT MANAGER. CLEAN PREMISES OF ALL DEBRIS RESULTING FROM WORK AND LEAVE WORK IN A COMPLETE AND UNDAMAGED CONDITION.
- 31. ALL WALL PENETRATIONS SHALL BE FIRE STOPPED WITH FS-ONE HIGH PERFORMANCE INTUMESCENT FIRE STOP BY HILTI OR APPROVED EQUAL INSTALL PER MANUFACTURERS RECOMMENDATIONS.

GROUNDING NOTES:

- 1. GROUNDING SHALL COMPLY WITH NEC ART, 250.
- GROUNDING CONDUCTORS SHALL BE #6 COPPER STRANDED WIRE WITH GREEN COLOR INSULATION
- ALL GROUND CONNECTIONS TO BE BURNDY HYGROUND COMPRESSION TYPE CONNECTORS OR CADWELD EXOTHERMIC WELD DO NOT ALLOW BARE COPPER WIRE TO BE IN CONTACT WITH
- 4. ROUTE GROUNDING CONNECTORS ALONG THE SHORTEST AND STRAIGHTEST PATH POSSIBLE, EXCEPT AS OTHERWISE INDICATED. GROUNDING LEADS SHOULD NOT BE BENT AT RIGHT ANGLE. ALWAYS MAKE 12" RADIUS BENDS. #6 WIRE CAN BE BENT AT 6" RADIUS WHEN NECESSARY.
- 5. CONNECTIONS TO GROUNDING BAR SHALL BE MADE WITH TWO HOLE COMPRESSION TYPE COPPER LUGS. APPLY OXIDE INHIBITING COMPOUND TO ALL LOCATIONS.
- TEST COMPLETED GROUNDING SYSTEM AND RECORD RESISTANCE VALUES FOR PROJECT CLOSE-OUT DOCUMENTATION, GROUND RESISTANCE SHALL NOT EXCEED 5 OHMS.
- 7. GROUNDING CONDUCTORS BETWEEN MGB AND WATERMAIN SHALL BE \$2/0. BONDING JUMPERS FROM METALLIC SURFACES SHALL BE \$2 MINIMUM. ALL GROUND CONDUCTORS AND BONDING JUMPERS FROM METALLIC SURFACES SHALL BE \$2 MINIMUM. ALL GROUND CONDUCTORS AND BONDING JUMPERS SHALL BE SOFT DRAWN ANNEALED, TINNED, BARE STRANDED COPPER WIRE. COAXIAL CABLES SHALL BE GROUNDED AT A MINIMUM OF TWO LOCATIONS USING VERIZON PROVIDED GROUNDING KITS. EXACT LOCATIONS SHALL BE FINALIZED IN THE FIELD BY THE CONSTRUCTION MANAGER.

STRUCTURAL STEEL NOTES:

- 1. STRUCTURAL STEEL SHALL CONFORM TO THE LATEST EDITION OF THE ASC "SPECIFICATION FOR THE DESIGN, FABRICATION AND ERECTION OF STRUCTURAL STEEL FOR BUILDINGS".
- 2. STRUCTURAL STEEL ROLLED SHAPES, PLATES, AND BARS SHALL CONFORM TO THE FOLLOWING ASTM

DESIGNATIONS:
A-582, GRADE 50
ASTM A-38
ASTM A-300, GRADE B
ASTM A-500, GRADE B
ASTM A-325, TYPE SC OR N
F1554, GRADE 38
ASTM A-53, GRADE B

ALL W SHAPES, UNLESS NOTED OR A982 OTHERWISE.
ALL OTHER ROLLED SHAPES, PLATES AND BARS UNLESS NOTED OTHERWISE.
HSS SECTION (SOURCE, RECTANGULAR, ROUND)
ALL BOLTS FOR CONNECTING STRUCTURAL MEMBERS.
ALL ANCHORS BOLTS, UNLESS NOTED OTHERWISE.
STEEL PIPE

- 3. ALL WELDING SHALL BE DONE USING E70XX ELECTRODES AND WELDING SHALL CONFORM TO AISC AND AWS D1.1 WHERE FILLET WELD SIZES ARE NOT SHOWN, PROVIDE THE MINIMUM SIZE PER TABLE JZ.4 IN THE AISC "MANUAL OF STEEL CONSTRUCTION". 14TH EDITION. WHERE WELD LENGTH IS NOT INDICATED, USE FULL LENGTH WELD. AT THE COMPLETION OF ALL WELDING, ALL DAMAGE TO GALVANIZED COATING SHALL BE REPAIRED.
- BOLTED CONNECTIONS SHALL USE BEARING TYPE GALVANIZED ASTM A325 BOLTS (3/4" DIA.) SUPPLIED WITH A
 NUT AND WASHER UNDER TURNED END AND SHALL HAVE MINIMUM OF TWO BOLTS UNLESS NOTED OTHERWISE.
- DO NOT DRILL HOLES THROUGH STRUCTURAL STEEL MEMBERS EXCEPT AS SHOWN AND DETAILED ON STRUCTURAL DRAWINGS.
- NON-STRUCTURAL CONNECTIONS FOR STEEL GRATING MAY USE 5/8° DIA. GALVANIZED ASTM A 307 BOLTS UNLESS NOTED OTHERWISE.
- 7. USE PRECAUTIONS & PROCEDURES PER AWS D1.1 WHEN WELDING GALVANIZED METALS.
- ALL EXISTING BEAM AND COLUMN DIMENSIONS SHALL BE FIELD VERIFY BY CONTRACTOR PRIOR TO FABRICATION. ANY DISCREPANCIES BETWEEN EXISTING CONDITIONS AND THOSE SHOWN SHALL BE REPORTED TO DEWBERRY ENGINEER IMMEDIATELY.
- 9. CONNECTION DESIGN BY FABRICATOR WILL BE SUBJECT TO REVIEW AND APPROVAL BY ENGINEER.
- 10. ALL EXTERIOR STEEL WORK SHALL BE GALVANIZED IN ACCORDANCE WITH SPECIFICATION ASTM A123/A123M-00 HOT-DIP GALVANIZED FINISH UNLESS OTHERWISE NOTED. GALVANIZING SHALL BE PERFORMED AFTER SHOP FABRICATION TO THE GREATEST EXTENT POSSIBLE. ALL DINGS, SCRAPES, MARS, AND WELDS IN THE GALVANIZED AREAS SHALL BE REPAIRED. REPAIR DAMAGED GALVANIZED COATINGS ON GALVANIZED ITEMS WITH GALVANIZED. REPAIR PAINT ACCORDING TO ASTM A780 AND MANUFACTURER'S WRITTEN INSTRUCTIONS, PRIOR TO COMPLETION OF WORK, TOUCHUP ALL DAMAGED GALVANIZED STEEL WITH APPROVED COLD ZINC, "GALVANOX", "DRY GALV", "ZINC—IT", OR APPROVED EQUIVALENT, IN ACCORDANCE WITH MANUFACTURERS GUIDELINES. TOUCHUP DAMAGED NON GALVANIZED STEEL, WITH SAME PAINT APPLIED IN SHOP OR FIELD.

CONSTRUCTION NOTES:

- 1. SEAL PENETRATIONS THROUGH FIRE RATED AREAS WITH UL LISTED D FIRE CODE APPROVED MATERIALS.
- REPAIR ANY DAMAGE DURING CONSTRUCTION TO MATCH EXISTING PRE-CONSTRUCTION CONDITIONS TO THE SATISFACTION OF THE CONSTRUCTION MANAGER AND LANDLORD.
- 3. THE DOOR SHALL BE A STEELCRAFT STEEL UNIT, L—SERIES TYPE, OR APPROVED EQUAL, (1) 3'x7'. THE UNIT SHALL BE INSULATED AND WEATHER—STRIPPED, WITH ALIMINIUM THRESHOLD, STANLEY 4 1/2" X 4 1/2" BALL BEARING HINGES (PARTE FIBB179), AND A "BEST" DEAD BOLT CYLINDRICAL LOCK OR AS SPECIFIED BY VERIZON WIRELESS REPRESENTATIVE. THE DOOR SHALL BE SET IN A 16 GAUGE STEEL FRAME. BOTH DOOR SHALL BE SET DEAD BOLT STRING OF 2 HOURS MINIMULIA WAWS STEEL PRACT COM HOURS, MINIMUM. WWW.STEELCRAFT.COM
- FINISH ALL DRYWALL SCREWS OR NAILS, AND JOINTS, UNLESS OTHERWISE NOTED, INTERIOR WALL FINISH SHALL BE 1/8" FRP CLASS A PANELS. INSTALL PER MANUFACTURERS RECOMMENDATIONS.
- CONTRACTOR SHALL INSTALL NEW RESILIENT FLOOR TILE WITHIN LIMITS OF PROPOSED VERIZON WIRELESS
 EQUIPMENT ROOM AS FOLLOWS: PREPARATION CONTRACTOR SHALL INSTALL NEW RESILIENT FLOOR TILE
 WHICH SHALL BE ASTN F1066 12*x12*x1/8" THICK, ARMSTRONG IMPERIAL TRUTURE TILE \$18.36,
 COLOR-SHELTER WHITE. BASE PROVIDE FS SS-W-40, TYPE II, 4" H. ROPPE VINYL COVE BASE,
- 6. TURN OVER ALL SALVAGEABLE BUILDING MATERIAL TO BUILDING MANAGER.
- ALL GYPSUM WALL BOARD SHALL BE TYPE GOLD BOND FIRE-SHIELD TYPE X HI-IMPACT WALLBOARD -FIRE RESISTANCE RATING - ANSI/UL263, TO ACHIEVE 2 HOUR FIRE RESISTANCE USE DESIGN NO. U495 FOR MATERIALS AND SCREW SPACINGS.
- ALL CABLE/CONDUIT ENTRY/EXIT PORTS SHALL BE WEATHERPROOFED DURING INSTALLATION USING A SILICONE SEALANT.
- 9. SHIM NEW SILLS, AS NECESSARY, TO LEVEL AND PLUMB WALL.
- ALL DISRUPTIVE WORK AND WORK WITHIN TENANT SPACES TO BE COORDINATED WITH BUILDING REPRESENTATIVE.
- 11. ALL ROOF PENETRATIONS SHALL BE RESTORED TO MAINTAIN ALL ROOF WARRANTIES AND ENSURE A PERMANENT WATERPROOF SEAL.




VERIZON WIRELESS 118 FLANDERS ROAD WESTBOROUGH, MA 01581-3956

CAMBRIDGE 5 MA (LESLEY UNIVERSITY)

	С	ONSTRUC [*]	TION	DRAWINGS
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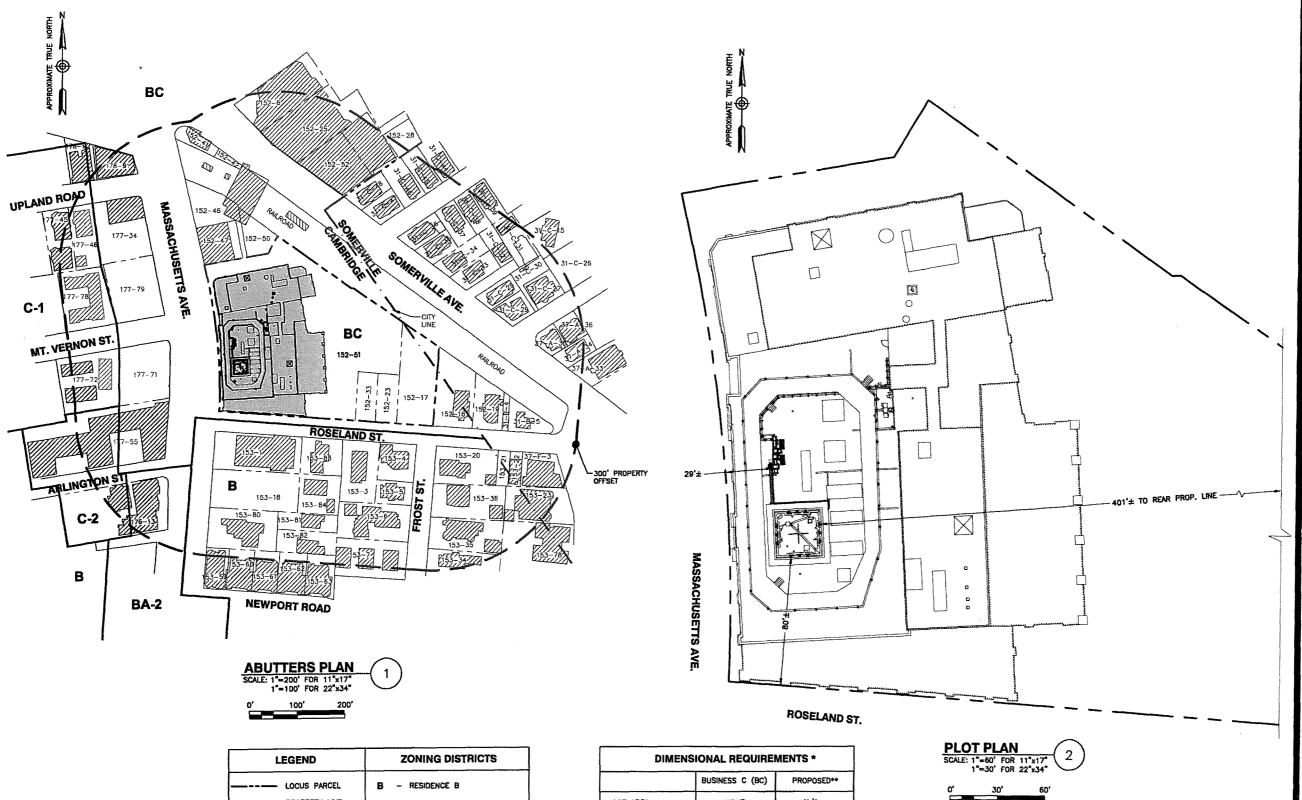
DRAWN BY:	MR
REVIEWED BY:	MFT
CHECKED BY:	BBR
PROJECT NUMBER:	50002925
JOB NUMBER:	50069466
SITE ADDRESS:	

1815 MASSACHUSETTS AVENUE CAMBRIDGE, MA 02140

SHEET TITLE

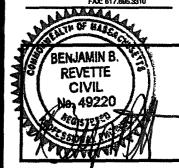GENERAL NOTES

SHEET NUMBER



- ALL BUILDINGS, PARKING LOTS, ROADS & PROPERTY LINES SHOWN AS APPROXIMATE AND HAVE NOT BEEN VERIFIED THROUGH FIELD SURVEY.
- PLOT PLAN BASED ON CITY OF CAMBRIDGE, MA ASSESSORS ON LINE INFORMATION.
- NORTH IS APPROXIMATE & SHOULD BE VERIFIED IN FIELD.

L	EGEND	ZONING DISTRICTS
	LOCUS PARCEL	B - RESIDENCE B
	PROPERTY LINE	
	SETBACK LINE	BA-2 - BUSINESS A-2
	ZONING BOUNDARY	BC - BUSINESS C
	CITY BOUNDARY	BO BOOMEDS C
	LOCUS BUILDING	C-1 - RESIDENCE C-1
	EXISTING BUILDINGS	C-2 - RESIDENCE C-2
152-51	PROPERTY MAP-LOT	

DIMENSIONAL REQUIREMENTS *			
	BUSINESS C (BC) PROPOSED++		
LOT AREA	NONE	N/A	
FRONT YARD	NONE	29'±	
SIDE YARD	NONE	80'±	
REAR YARD	20'	401°±	
HEIGHT	55'	78'± TOP OF ANTENNA	

*PER TABLE 5-2 OF THE CAMBRIDGE BYLAWS.
**DIMENSION IS APPROXIMATE AND REPRESENTS DISTANCE
FROM VERIZON WIRELESS EQUIPMENT TO PROPERTY LINE.

WIRELESS

VERIZON WIRELESS

118 FLANDERS ROAD
WESTBOROUGH, MA 01581-3956

CAMBRIDGE 5 MA (LESLEY UNIVERSITY)

CONSTRUCTION DRAWINGS

1 04/14/17 FOR SUBMITTAL
0 05/24/16 FOR SUBMITTAL
A 04/12/16 FOR REVIEW

Dewberry*

Dewberry Engineers Inc.
280 SUMMER STREET
10TH FLOOR
BOSTON, MA 02210
PHONE: 617.695.3400
FAX: 617.695.3310



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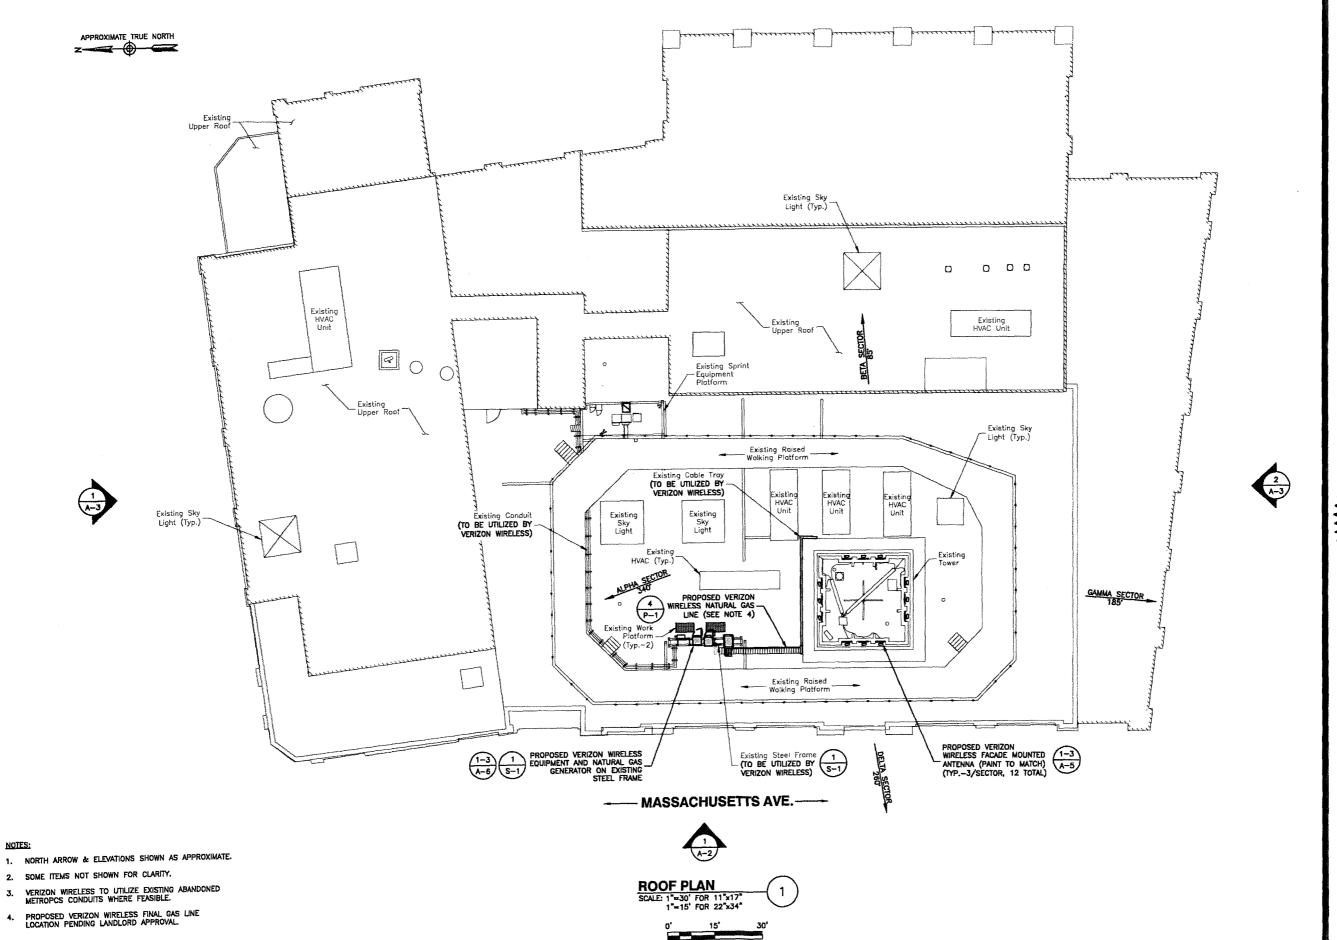
1815 MASSACHUSETTS AVENUE CAMBRIDGE, MA 02140

SHEET TITLE

ABUTTERS & PLOT PLANS

SHEET NUMBER

7 - 1





VERIZON WIRELESS 118 FLANDERS ROAD WESTBOROUGH, MA 01581-3956

CAMBRIDGE 5 MA (LESLEY UNIVERSITY)

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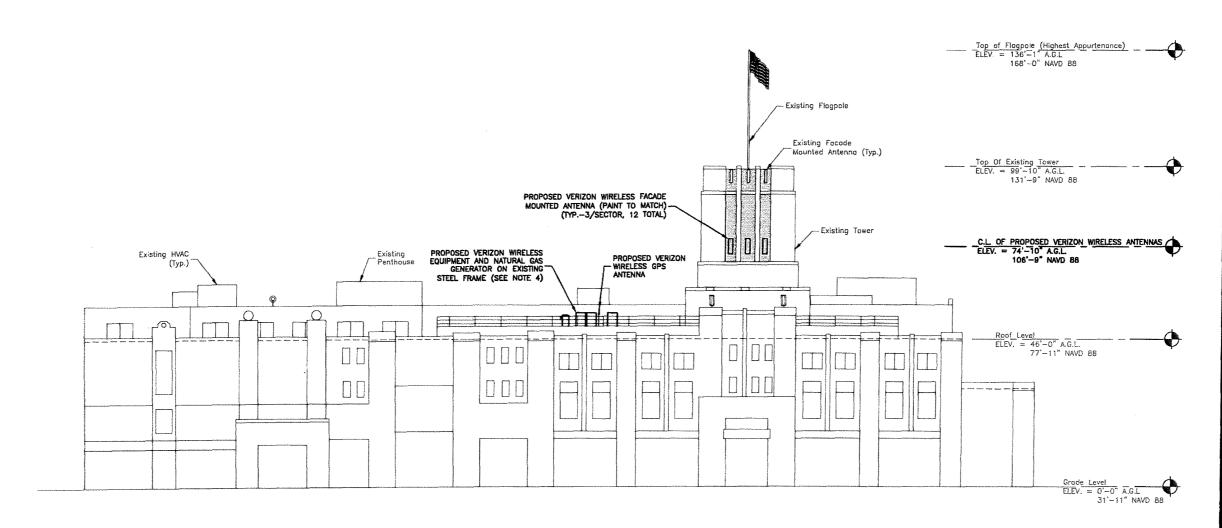
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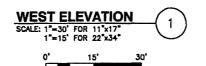
1815 MASSACHUSETTS **AVENUE** CAMBRIDGE, MA 02140

SHEET TITLE

ROOF PLAN

SHEET NUMBER





- C.L = CENTERLINE
 A.G.L = ABOVE GROUND LEVEL
 A.R.L = ABOVE ROOF LEVEL
 NAVD BB NORTH AMERICAN VERTICAL DATUM OF 1988
- 2. SOME ITEMS NOT SHOWN FOR CLARITY.
- VERIZON WIRELESS TO UTILIZE EXISTING ABANDONED METROPCS CONDUITS WHERE FEASIBLE.
- PROPOSED VERIZON WIRELESS FINAL GAS LINE LOCATION PENDING AND LANDLORD APPROVAL.




VERIZON WIRELESS 118 FLANDERS ROAD WESTBOROUGH, MA 01581-3956

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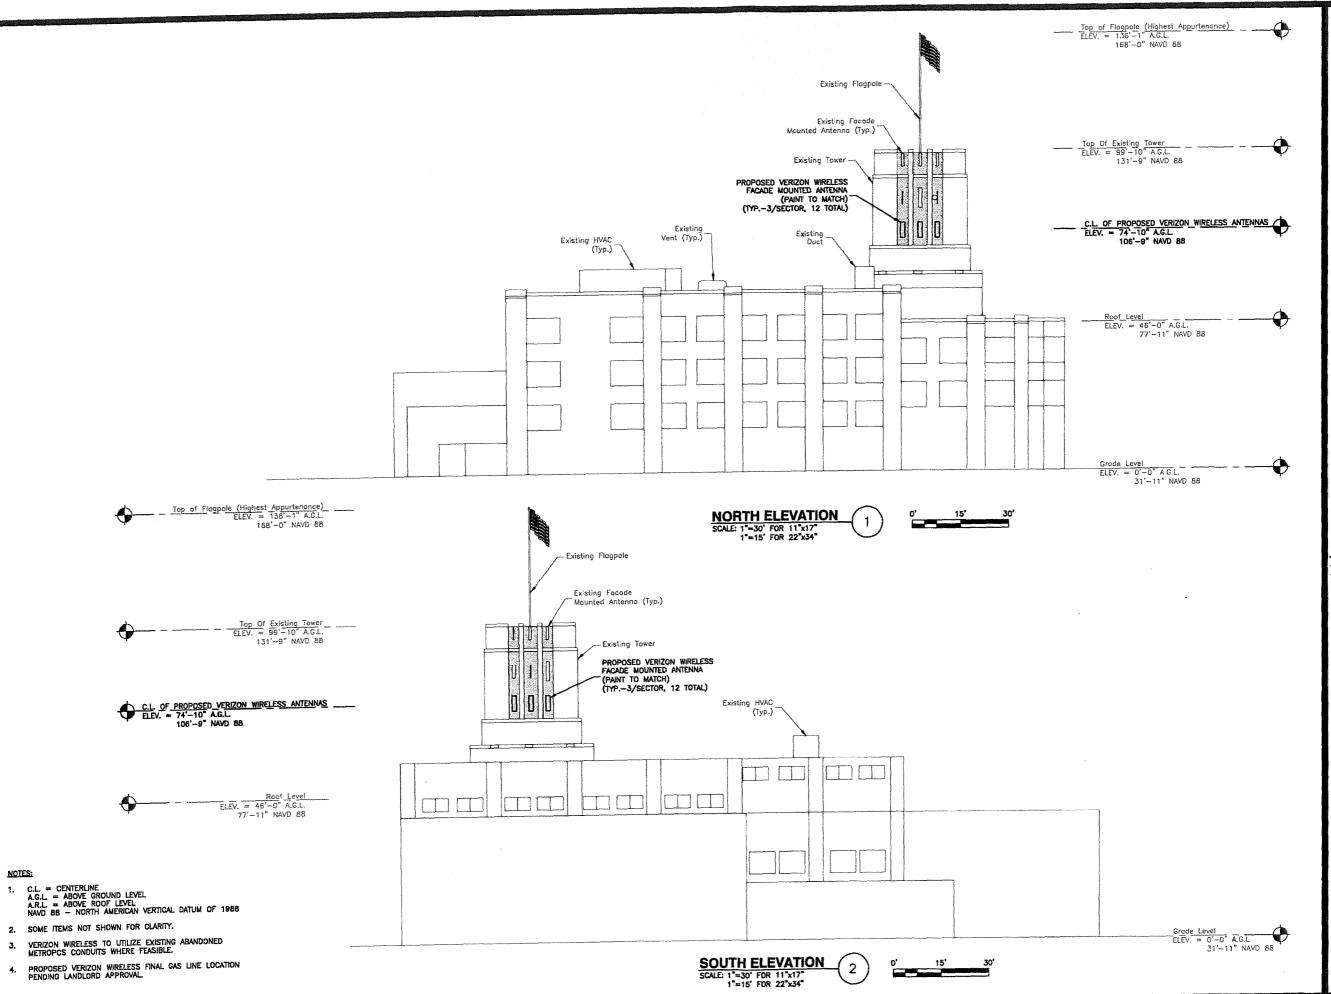
1815 MASSACHUSETTS AVENUE CAMBRIDGE, MA 02140

SHEET TITLE

WEST ELEVATION

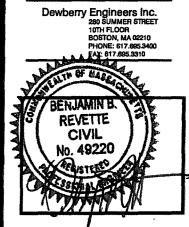SHEET NUMBER

A - 2






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CONSTRUCTION		DRAWINGS	
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REVIEWED BY:	MFT
CHECKED BY:	BBR
PROJECT NUMBER:	50002925
JOB NUMBER:	50069466
SITE ADDRESS:	
1815 MASSA	CHUSETTS


AVENUE CAMBRIDGE, MA 02140


SHEET TITLE

NORTH & SOUTH ELEVATIONS

SHEET NUMBER

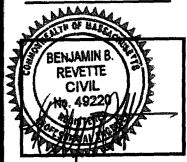
A-3

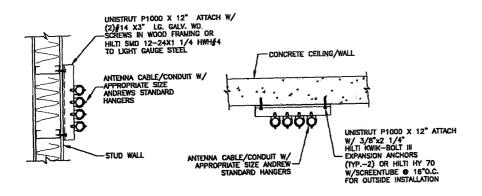

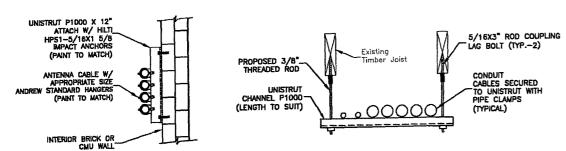

- 1. ALL COAX SUPPORT SPACING: 4'-0" MAX.
- ALL CONDUIT SUPPORT SPACING: 10'-0" MAX.

CABLE/CONDUIT SUPPORT 1

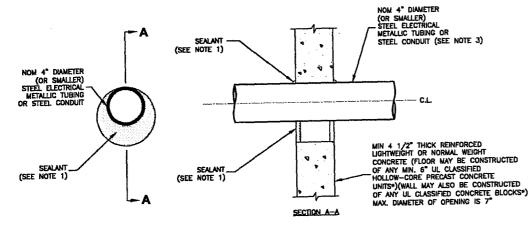


UL SYSTEM NO. C-AJ-1259 F RATING - 3 HR. T RATING - 0 HR.

NOTES:

- FILL, VOID OR CAVITY MATERIAL* SEALANT MIN. 1/2* THICKNESS OF FILL
 MATERIAL APPLIED WITHIN THE ANNULUS, FLUSH WITH BOTH SURFACES OF FLOOR
 OR WALL. AT THE POINT CONTACT LOCATION BETWEEN PENETRATING ITEM AND
 CONCRETE, A MIN. 1/4* THECK BEAD OF FILL MATERIAL SHALL BE APPLIED AT
 THE CONCRETE/ PENETRATING ITEM INTERFACE ON BOTH SIDES OF FLOOR OR WALL.
- FORMING MATERIAL (OPTIONAL, NOT SHOWN) MINERAL WOOL BATT PACKING MATERIAL OR POLYURETHANE BACKER ROD FRICTION FITTED INTO OPENING AND RECESSED FROM FLOOR OR WALL SURFACES AS REQUIRED TO ACCOMMODATE THICKNESS OF FILL MATERIAL.
- 3. ONE CONDUIT TO BE INSTALLED EITHER CONCENTRICALLY OR ECCENTRICALLY WITHIN THE FIRESTOP SYSTEM. THE ANNULAR SPACE BETWEEN THE CONDUIT AND THE PERIPHERY OF THE OPENING SHALL BE A MIN. OF O" (POINT OF CONTACT) TO A MAX. OF 3". CONDUIT TO BE RIGIDLY SUPPORTED ON BOTH SIDES OF FLOOR OR WALL ASSEMBLY.
 - . BEARING THE UL CLASSIFICATION MARK.

CORING DETAIL
SCALE: N.T.S.


3

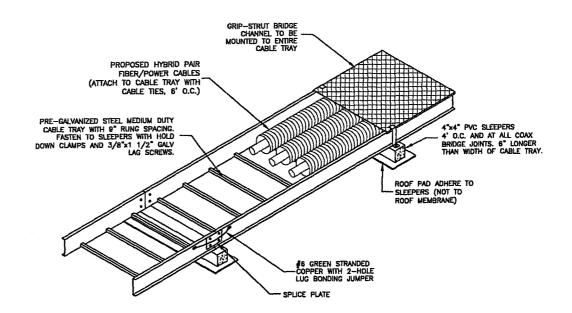

NOTE:

 PVC SLEEPERS TO BE FILLED WITH CONCRETE EVERY 4'-0" O.C.



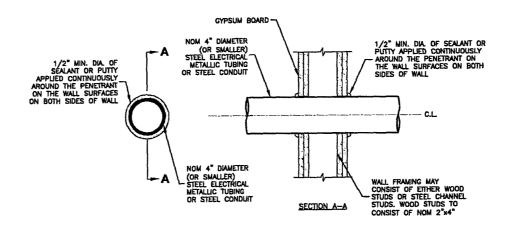

SYSTEM NO. W-L-1344
F RATINGS - 1 AND 2 HR
T RATING - 1/4 HR
L RATING AT AMBIENT - LESS THAN 1 CFM/SQ FT
L RATING AT 400 F - LESS THAN 1 CFM/SQ FT

NOTES:

- THE 1 AND 2 HOUR FIRE RATED GYPSUM WALL BOARD/STUD WALL ASSEMBLY SHALL BE CONSTRUCTED OF THE MATERIALS & MANNER SPECIFIED IN THE INDMIDUAL U300 OR U400 SERIES WALL & PARTITION DESIGNS IN THE UL FIRE RESISTANCE DIRECTORY.
- 2. 5" DIAMETER OPENING MAX.

SECTION - THROUGH PENETRATION
FIRESTOP SYSTEM
SCALE: N.T.S.




VERIZON WIRELESS 118 FLANDERS ROAD WESTBOROUGH, MA 01581-3956

CAMBRIDGE 5 MA (LESLEY UNIVERSITY)

C	CONSTRUCTION DRAWINGS				
E					
	04/14/17				
	05/24/16				
Α	04/12/16	FOR	REVIEW		

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REVIEWED BY:	MFT
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PROJECT NUMBER:	50002925
JOB NUMBER:	50069466
SITE ADDRESS:	


1815 MASSACHUSETTS AVENUE CAMBRIDGE, MA 02140

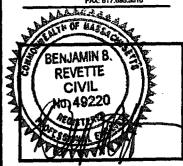
SHEET	TITLE	


CONSTRUCTION DETAILS-I


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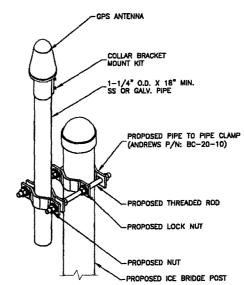
A-4



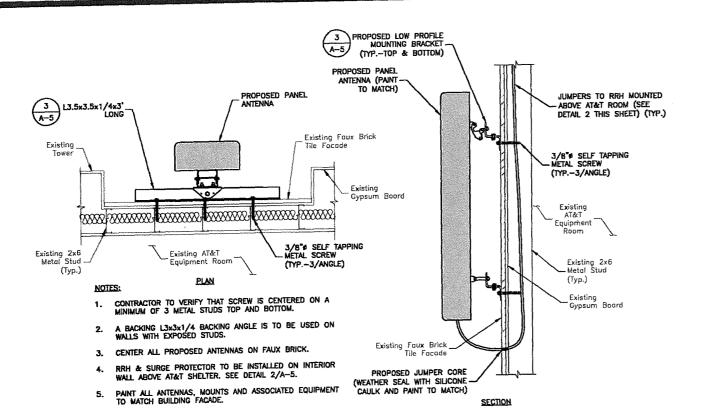

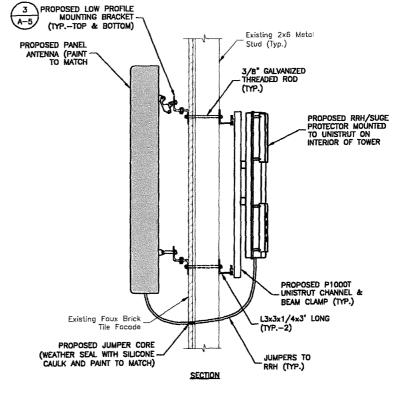

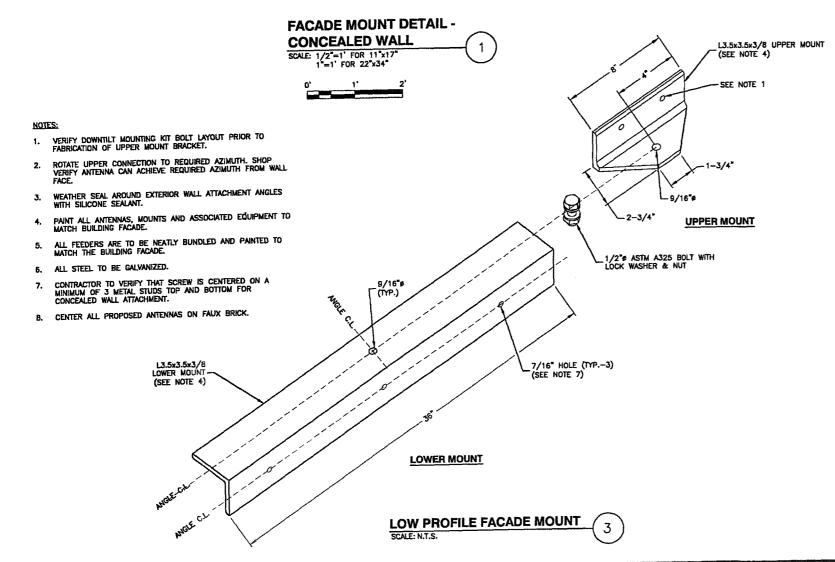

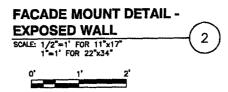

1. THE GPS ANTENNA MOUNT IS DESIGNED TO FASTEN TO A STANDARD 1"--1 1/4" DIAMETER GALVANIZED STEEL OR STAINLESS STEEL PIPE. THE PIPE MUST NOT BE THREADED AT THE ANTENNA MOUNT END. THE PIPE SHALL BE CUT TO THE REQUIRED LENGTH LISING A HAND OR ROTARY PIPE CUTTER TO ASSURE A SMOOTH AND PERPENDICULAR CUT. THE CUT PIPE END SHALL BE DEBURRED AND SMOOTH IN ORDER TO SEAL AGAINST THE NEOPRENE GASKET ATTACHED TO THE ANTENNA POST.

GPS POLE MOUNTED




VERIZON WIRELESS 118 FLANDERS ROAD WESTBOROUGH, MA 01581-3956

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CONSTRUCTION			DRAWINGS
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	05/24/16		
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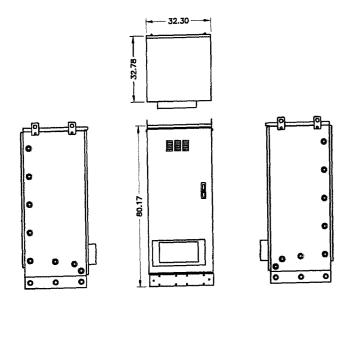


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CHECKED BY:	BBR
PROJECT NUMBER:	50002925
JOB NUMBER:	50069466
SITE ADDRESS:	
1815 MASSACHU AVENUE	JSETTS
CAMBRIDGE, MA	02140

CONSTRUCTION DETAILS-II

SHEET NUMBER

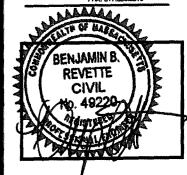SHEET TITLE





CONTRACTOR TO VERIFY WITH C.M. FOR FINAL MANUFACTURER SPECIFICATIONS PRIOR TO CONSTRUCTION.

26.60 --

CHARLES CABINET CUBE-BB48E1HN1

SCALE: 1/4"=1" FOR 11"x17" 1/2"=1" FOR 22"x34"

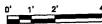

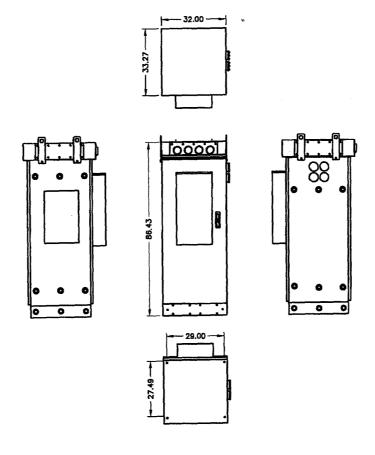


NOTE:

CONTRACTOR TO VERIFY WITH C.M. FOR FINAL MANUFACTURER SPECIFICATIONS PRIOR TO CONSTRUCTION.

CHARLES CABINET CUBE-PM63912MC1 SCALE: 1/4"=1" FOR 11"×17" 1/2"=1" FOR 22"×34"




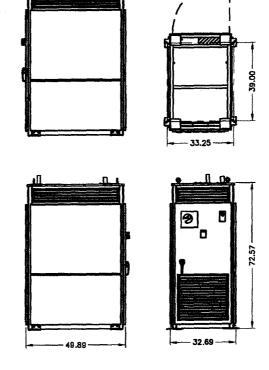

POLAR POWER 15KW

NATURAL GAS GENERATOR

SCALE: 1/4"=1" FOR 11"x17" 1/2"=1" FOR 22"x34"

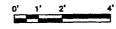




VERIZON WIRELESS 11B FLANDERS ROAD WESTBOROUGH, MA 01581-3956

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CHECKED BY:	BBR
PROJECT NUMBER:	50002925
JOB NUMBER:	50069466
SITE ADDRESS:	

1815 MASSACHUSETTS **AVENUE** CAMBRIDGE, MA 02140


SHEET TITLE

CABINET & GENERATOR **DETAILS**

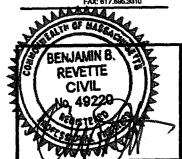SHEET NUMBER

NOTES:

- 1. ALL UNITS ARE IN INCHES.
- CONTRACTOR TO VERIFY WITH C.M. FOR FINAL MANUFACTURER SPECIFICATIONS PRIOR TO CONSTRUCTION.

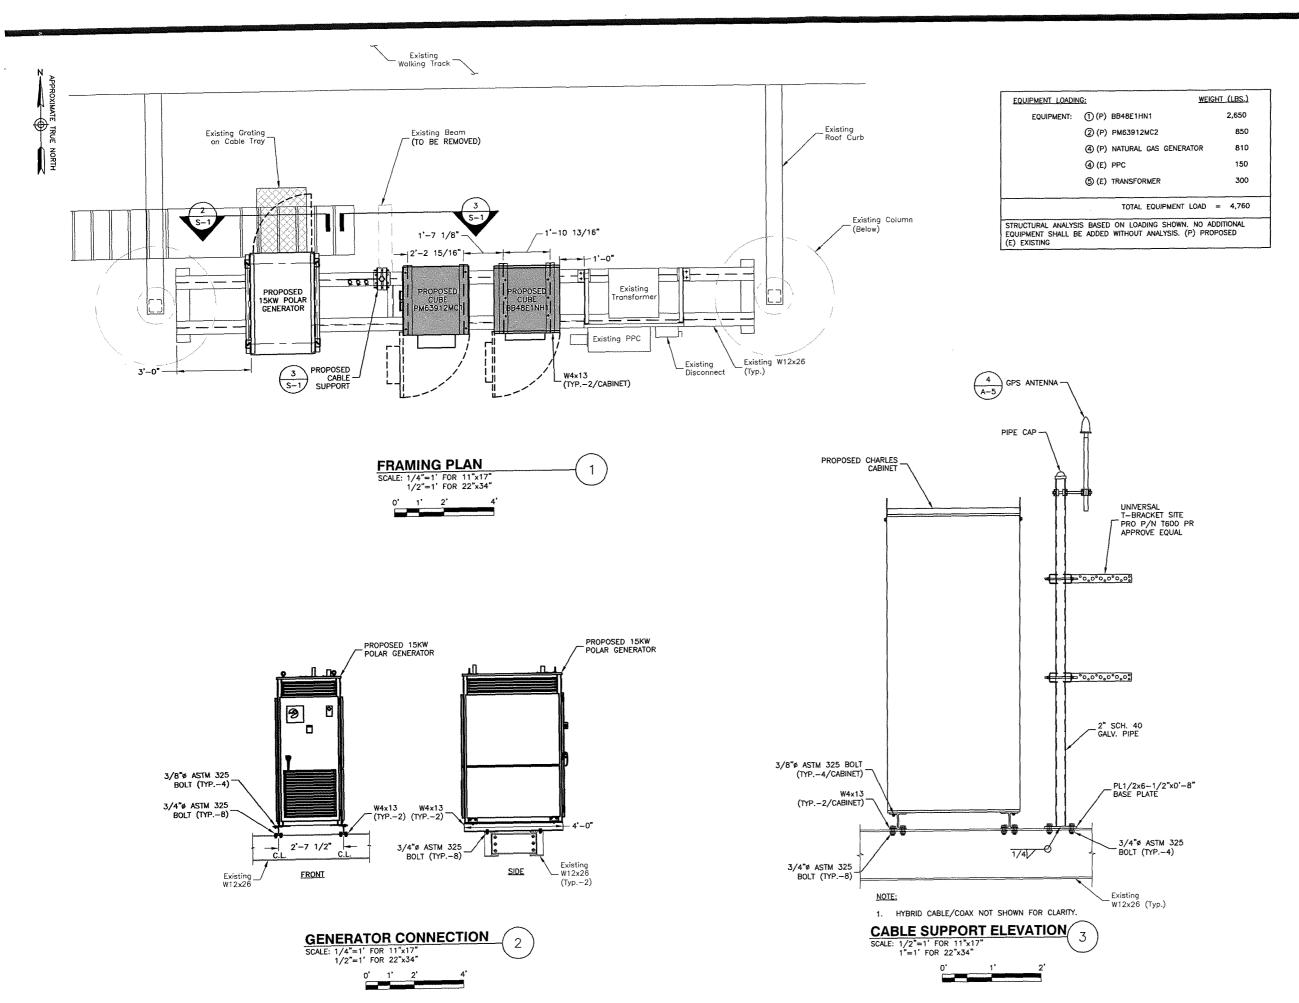



VERIZON WIRELESS 118 FLANDERS ROAD WESTBOROUGH, MA 01581-3956

CAMBRIDGE 5 MA (LESLEY UNIVERSITY)

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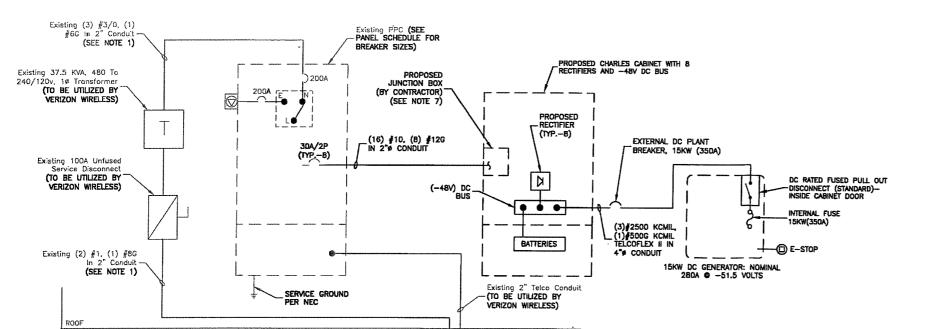
1815 MASSACHUSETTS AVENUE CAMBRIDGE, MA 02140

SHEET TITLE

FRAMING PLAN & STRUCTURAL DETAILS


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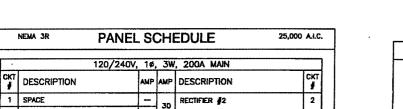
S - 1



ELECTRICAL NOTES:

- VERIFY EXISTING METROPCS ELECTRICAL FEEDERS AND CONDUIT ARE SIZED PER PLAN.
- COORDINATE TRANSFER OF UTILITY METER WITH UTILITY COMPANY AND BUILDING OWNER.
- 3. PROVIDE PULL BOXES AS REQUIRED BY CODE AND JOB CONDITIONS.
- GROUND SHALL COMPLY WITH NEC ARTICLE 250.
- 5. USE EMT FOR INTERIOR CONDUIT: USE RGS FOR EXTERIOR CONDUIT.
- LABEL EXISTING AND PROPOSED ELECTRICAL EQUIPMENT AND CONDUIT AS 'VERIZON WIRELESS'.
- INSTALL 1" LIQUID TIGHT DROPS FROM CHARLES CABINET JUNCTION BOX TO RECTIFIER.



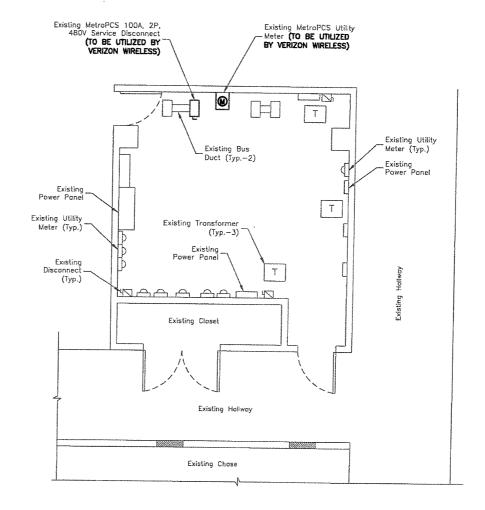

SCALE: N.T.S.

EXISTING BUS-

PROPOSED FIBER IN


TELEPHONE ROOM

TELCO DEMARK-

2ND FLOOR

1ST FLOOR

CKT	DESCRIPTION	AMP	AMP	DESCRIPTION	CKI
<u>•</u>	SPACE		<u> </u>	RECTIFIER #2	2
3	SPACE		30	RECTIFIER #4	4
5	RECTIFIER #1	30	Ī.,	RECTIFIER #6	6
7	RECTIFIER #3		30	RECTIFIER #8	8
9	RECTIFIER #5		-	SPACE	10
11	RECTIFIER #7	30	_	SPACE	12
13	PDADE	T	-	SPACE	14
15	SPARE	30	_	SPACE	16
17	SPACE	1-	-	SPACE	18
19	(E) GFI RECEPTACLE	15	10	(E) LIGHT	20
21	(-)		-	SPACE	22
23	(E) SURGE ARRESTOR	20	_	SPACE	24

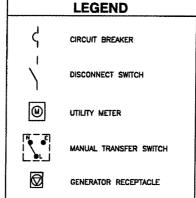

Existing MetroPCS Utility
— Meter (TO BE UTILIZED
BY VERIZON WIRELESS)

EXISTING CHASE

ELECTRICAL ROOM

POWER & TELCO RISER DIAGRAM

Existing MetroPCS 100A, 2P, 480V Service Disconnect (TO BE TAKEN OVER BY

VERIZON WIRELESS)

2nd FLOOR ELECTRICAL ROOM
SCALE: N.T.S.




VERIZON WIRELESS 118 FLANDERS ROAD WESTBOROUGH, MA 01581-3956

CAMBRIDGE 5 MA (LESLEY UNIVERSITY)

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1815 MASSACHUSETTS AVENUE

CAMBRIDGE, MA 02140


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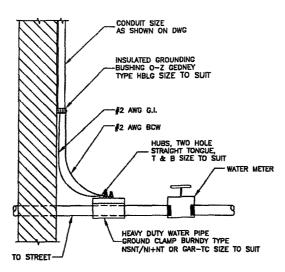
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RISER DIAGRAMS

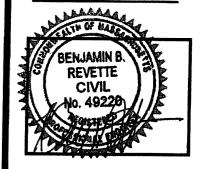SHEET NUMBER


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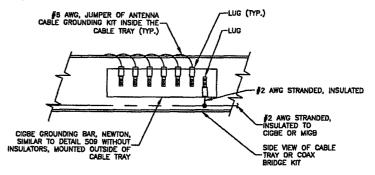
BURNDY TYPE GROUND CLAMP SHOULD BE ATTACHED ON STREET SIDE OF WATER CUT-OFF. VALVE IS INSULATED BETWEEN WATER METER & STREET GROUNDING CLAMP SHOULD BE ATTACHED TO STREET

WATER METER GROUNDING 2 SCALE: N.T.S.

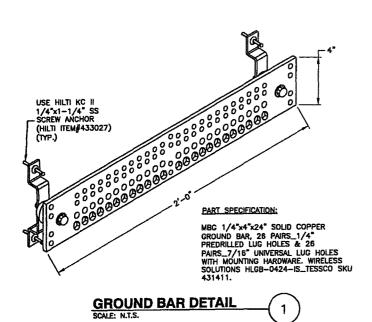

3

CONNECTION TO EQUIPMENT DETAIL

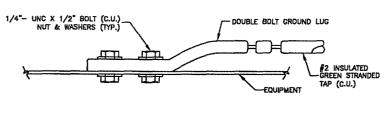

GROUND BAR MOUNTED ON CABLE TRAY SCALE: N.T.S.

Dewberry*

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118 FLANDERS ROAD WESTBOROUGH, MA 01581-3956

CAMBRIDGE 5 MA


(LESLEY UNIVERSITY)

CONSTRUCTION DRAWINGS

1 04/14/17 FOR SUBMITTAL

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A 04/12/16 FOR REVIEW

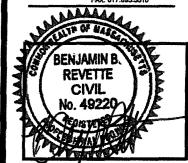

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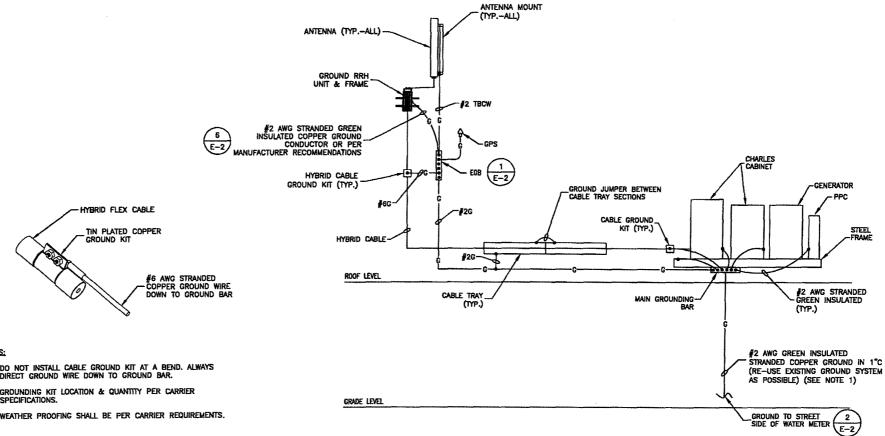
1815 MASSACHUSETTS **AVENUE** CAMBRIDGE, MA 02140


SHEET TITLE


GROUNDING DETAILS & DIAGRAM

SHEET NUMBER

E-2



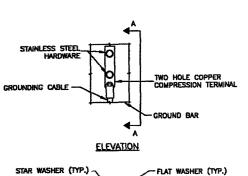

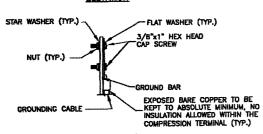

SECTION 'A-A'

NOTES:

SCALE: N.T.S.

- DOUBLING UP OR STACKING OF CONNECTIONS IS
- 2. OXIDE INHIBITING COMPOUND TO BE USED AT ALL LOCATIONS.


TYPICAL GROUND BAR MECHANICAL CONNECTION DETAIL

DO NOT INSTALL CABLE GROUND KIT AT A BEND. ALWAYS DIRECT GROUND WIRE DOWN TO GROUND BAR.

- 2. GROUNDING KIT LOCATION & QUANTITY PER CARRIER
- 3. WEATHER PROOFING SHALL BE PER CARRIER REQUIREMENTS.

HYBRID FLEX GROUNDING DETAIL SCALE: N.T.S.

SCHEMATIC GROUNDING DIAGRAM SCALE: N.T.S.

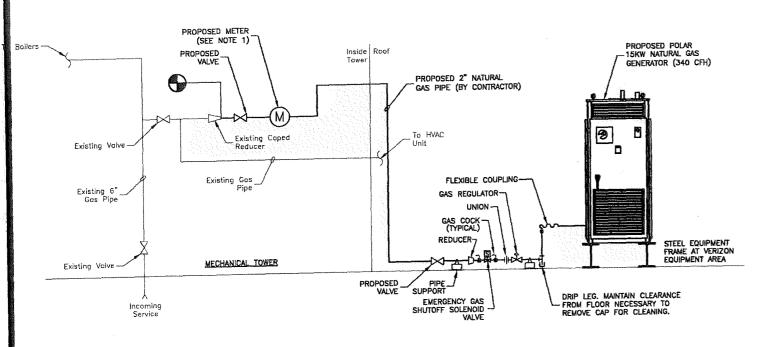


NOTES


- 1. CONTRACTOR TO INSTALL NEW METER PER REQUIREMENTS OF LESLEY UNIVERSITY.
- INSTALL EMERGENCY GLASS NATURAL GAS SHUTDOWN AT GENERATOR AREA & EGRESS AREA. COORDINATE INSTALLATION WITH THE LOCAL FIRE DEPARTMENT & BUILDING OWNER.
- 3. GENERATOR REQUIRES OPTIMUM WC LEVEL 4"-13.9" PER MANUFACTURER.
- 4. COORDINATE ALL WORK WITH LESLEY UNIVERSITY PRIOR TO CONSTRUCTION.
- 5. GENERATOR INSTALLATION SHALL COMPLY WITH NFPA37.

BACKUP GENERATOR GAS TRAIN & SCHEMATIC


LEGEND					
SYMBOL	ABBREVIATIONS	DESCRIPTION	ABBREVIATIONS	DESCRIPTION	
		BALL VALVE	AFF	ABOVE FINISH FLOOR	
		GAS COCK	AFR	ABOVE FINISH ROOF	
		SOLENOID VALVE	BÓP	BOTTOM OF PIPE	
		PIPE DROP OR PIPE THRU FLOOR PLAN SHOWN	CFH	CUBIC FEET PER HOUR	
		PIPE THRU FLOOR ABOVE	CLG	CEILING	
€	CTE	CONNECT TO EXISTING	CW	COLD WATER	
	G	GAS PIPING	DN	DOWN	
		CAP	ETR	EXISTING TO REMAIN	
_ B		gas booster	G	GAS MAIN	
Ø		REGULATOR	HW	HOT WATER	
[5]		STRAINER	IN	INCHES	
W		gas meter	NTS	NOT TO SCALE	
			RED	REDUCER	
			SS	STAINLESS STEEL	
			ST	STEEL	
			TOP	TOP OF PIPE	
			ΤΥP	TYPICAL	
:			V	VENT	
			VīR	VENT THRU ROOF	
			wc	WATER COLUMN	

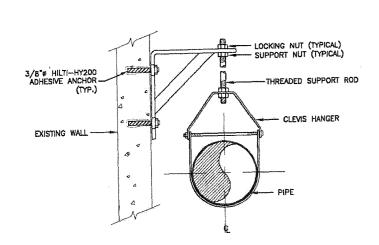

PIPE HANGER DETAIL

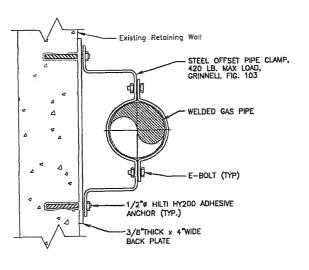

PIPE SUPPORT DETAIL

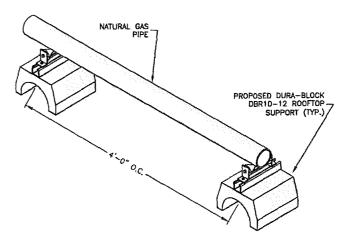

NATURAL GAS PIPE DETAIL ON SLEEPERS



VERIZON WIRELESS 118 FLANDERS ROAD WESTBOROUGH, MA 01581-3956

CAMBRIDGE 5 MA (LESLEY UNIVERSITY)

	C	ONSTRUC	DRAWINGS		
	Table 1				-
	1	04/14/17	FOR	SUBMITTAL	1
SOUTH PARTY OF THE		05/24/16			_
	A	04/12/16	FOR	REVIEW	_

Dewberry

Dewberry Engineers Inc. 280 SUMMER STREET 10TH FLOOR 10TH FLOOR BOSTON, MA 02210 PHONE: 617.695.3400 FAX: 617.695.3310



DRAWN EY:	- MR
REVIEWED BY:	MFT
CHECKED BY:	BBR
PROJECT NUMBER:	50002925
JOB NUMBER:	50069466
SITE ADDRESS:	

1815 MASSACHUSETTS **AVENUE** CAMBRIDGE, MA 02140

SHEET TITLE

NATURAL GAS DETAILS

SHEET NUMBER



INSTALLATION OF FUEL GAS PIPING SYSTEM:

- ALL PIPING AND EQUIPMENT IS SHOWN DIAGRAMMATIC. EXACT LOCATIONS TO BE DETERMINED IN FIELD. INSTALL PIPING STRAIGHT, PILIMB AND AS DIRECT AS POSSIBLE; PROVIDE RIGHT ANGLES ON LINES PARALLEL WITH BUILDING WALLS. INSTALL PIPES CLOSE TO WALLS, PARTITIONS, CEILINGS, ETC., AND OFFSET ONLY WHERE NECESSARY TO FOLLOW WALLS AS INDICATED. LOCATE GROUPS OF PIPES PARALLEL TO EACH OTHER; SPACE INDIVIDUAL PIPES IN ORDER TO PERMIT APPLICATION OF FULL INSULATION AND TO PERMIT ACCESS FOR SERVICING VALVES.
- ALL PIPING SHALL BE REAMED TO BE FREE OR BURRS. KEEP PIPING FREE FROM SCALE AND DIRT; PROTECT OPEN PIPE ENDS WHENEVER WORK IS SUSPENDED DURING CONSTRUCTION TO PREVENT FOREIGN MATERIAL ENTERING AND LODGING; USE TEMPORARY PLUG, PLASTIC, OR OTHER APPROVED MATERIAL FOR PROTECTION.
- ALL PIPE PENETRATIONS OF FIRE WALLS AND FLOORS SHALL BE PROVIDED WITH PIPE SLEEVES AND FIRE RATED SEALANT. ACCESS PANELS SHALL BE PROVIDED AT LOCATIONS WHERE ACCESSIBILITY IS LIMITED.
- 4. PIPING SHALL BE ACCURATELY CUT TO MEASUREMENTS ESTABLISHED IN THE FIELD AND INSTALLED IN PLACE WITHOUT COLD SPRINGING OR FORCING INTO ALIGNMENT. FLAME CUTTING OF BEVEL FOR WELDED JOINTS IS NOT ALLOWED, JOINTS SHALL BE FREE OF BURRS AND ALL WELD SPLATTER AND BEADS REMOVED FROM JOINTS, JOINTS SHALL EXHIBIT FULL PENETRATION OF ROOT PASS AND FINAL PASS SHALL BE FREE OF UNDER CUTTING, WELDING PROCEDURES AND WELDS SHALL BE PERFORMED IN ACCORDANCE WITH ANSI B31.1, OBTAIN LOCAL JURISDICTION FIRE DEPARTMENT FIRE WATCH DURING WELDING OF PIPE AND TIE-INS.
- 5. INSTALLATION AND TESTING SHALL COMPLY WITH NFPA 54 AND THE REQUIREMENTS OF THE APPROVING AUTHORITIES AND THIS SECTION. INSTALL PIPING PITCHED NOT LESS THAN 1/2" IN 15' SLOPE UPWARD TO RISERS AND DOWN TO METER AND EQUIPMENT. INSTALL BRANCH TEES OF THE SIDE OR TOP OF MAINS AND PROVIDE 6" MINIMUM SIZE DRIP LEGS AT LOW DOWN."
- 6. PROVIDE SHUT-OFF VALVE AND UNION OR FLANGE AT EACH EQUIPMENT CONNECTION. LOCATE VALVE WITHIN 6' OF EQUIPMENT SERVED WITH UNION DOWNSTREAM OF VALVE. PROVIDE CONTROL VALVES AND SHUT-OFF VALVES IN ACCESSIBLE LOCATIONS. DO NOT LOCATE VALVES ABOVE CEILINGS. DRIP LEG TRAPS SHALL BE READILY ACCESSIBLE. IDENTIFY EACH VALVE WITH UNIQUE TAG NUMBER. VALVES INSTALLED GREATER THAN 7'-O" AFF/AFR SHALL BE CHAIN OPERATED.
- 7. INSTALL INDEPENDENT GAS VENT PIPING FROM VENT ON GAS TRAIN AND REGULATORS TO THE BUILDING EXTERIOR (WHERE
- B. INSTALL SYSTEM COMPONENTS AS REQUIRED FOR PROPER TESTING AS SPECIFIED IN THIS SECTION. PROVIDE AUXILIARY ISOLATION AND PURGE VALVES AS REQUIRED FOR CONSTRUCTION PHASING AND SYSTEM TESTING. REMOVE VALVE HANDLES FROM ALL AUXILIARY CONSTRUCTION PHASING AND TESTING VALVES AS DIRECTED BY THE OWNER.
- e CONNECTIONS TO EXISTING GAS SYSTEM:

ISOLATE THE EXISTING SECTION OF PIPING BY CLOSING THE CLOSEST UPSTREAM SHUT-OFF VALVE. TEST THE VALVE BY REDUCING THE DOWNSTREAM PRESSURE TO ATMOSPHERIC PRESSURE AND CLOSING ALL OUTLETS. MONITOR THE SYSTEM PRESSURE FOR AT LEAST 2 HOURS TO DETECT ANY INCREASE IN PRESSURE BY LEAKAGE THROUGH THE VALVE.

BEFORE TESTING THE ZONE VALVE, VERIFY THAT OUTLETS ARE NOT LEAKING BY PRESSURIZING THE SECTION OF PIPING BETWEEN THE ZONE VALVE BOX AND THE OUTLETS AND CLOSING THE ZONE VALVE BOX. THE SYSTEM SHOULD MAINTAIN THE SAME SYSTEM PRESSURE WITHOUT A PRESSURE DROP FOR AT LEAST 5 MINUTES.

WHILE WELDING THE NEW CONNECTION, PURGE THE PIPING WITH NITROGEN BACK THROUGH THE NEW CONNECTION FROM THE CLOSEST GAS OUTLET DOWNSTREAM OF THE NEW POINT OF CONNECTION.

PRESSURIZE THE SYSTEM WITH NITROGEN TO 45 PSIG AFTER WELDING IS COMPLETED. BLOW THE EXISTING PIPING CLEAR FROM THE CLOSEST DOWNSTREAM GAS OUTLET OUT THE NEW CONNECTION INTO A CLEAN WHITE CLOTH UNTIL THERE ARE NO SIGNS OF DISCOLORATION OR PARTICULATES.

REPRESSURIZE THE SYSTEM WITH NATURAL GAS AND PURGE ALL OUTLETS IN THE SYSTEM STARTING WITH THE OUTLET CLOSEST TO THE SOURCE OF SUPPLY. REPEATEDLY PURGE THE EXISTING SYSTEM THROUGH THE EXISTING OUTLETS INTO A CLEAN WHITE CLOTH AT NORMAL SYSTEM WORKING PRESSURE TO VERIFY THAT NO PARTICULATES REMAIN IN THE SYSTEM.

DO NOT MAKE THE NEW CONNECTION TO THE NEW ROUGHED—IN PIPING SYSTEM UNTIL AFTER THE 200 PSI PARTICULATE BLOW—DOWN HAS BEEN PERFORMED.

TEST THE NEW CONNECTION JOINT WITH SOAPY WATER AT NORMAL SYSTEM WORKING PRESSURE.

C-CLAMP TOP BEAM FOR PIPING

3" & SMALLER

面

PIPING 3" & SMALLER

> SIDE BEAM CLAMP

- IDENTIFICATION OF PIPE DURING CONSTRUCTION: PROVIDE A 6"LONG COLOR—CODED SPRAY PAINT INDICATION ON THE BOTTOM OF PIPE SECTIONS DURING INSTALLATION. IDENTIFY EACH SECTION OF PIPE IMMEDIATELY AFTER INSTALLATION. DO NOT PAINT PIPE JUNITS.
- 11. FINAL IDENTIFICATION OF PIPING AND EQUIPMENT: FLOW ARROWS SHALL POINT FROM THE SOURCE TO THE OUTLETS. INSTALL MARKERS ON PAINTED PIPING ONLY AFTER PAINTING IS COMPLETE AND HAS BEEN ACCEPTED BY THE OWNER. INSTALL MARKER ADJACENT TO ACCESS PANELS IF PIPING IS CONCEALED. STENCIL EQUIPMENT SUCH AS PUMPS, COMPRESSORS, AND TANKS WITH THE NAME OF THE COUPMENT AND EQUIPMENT NUMBER. STENCILS SHALL BE AT LEAST 6" HIGH AND SHALL BE A CONTRASTING COLOR WITH THE EQUIPMENT FINISH.

STRUCTURAL STEEL OR OPEN WEB STEEL JOINTS

NOTE:

12. GAS RELIEF VENT PIPING TO BE EXTENDED TO 3'-0" MIN. ABOVE ROOF AND TERMINATED WITH INSECT SCREEN.

FUEL GAS PIPING GENERAL NOTES:

- 1. REFERENCE STANDARDS ALL MATERIALS, EQUIPMENT WORK AND INSTALLATIONS SHALL BE IN ACCORDANCE WITH THE COMMONWEALTH OF MASSACHUSETTS 780CMR STATE BUILDING CODE (6TH EDITION) AND 248CMR FUEL GAS AND PLUMBING CODES, AND THE APPLICABLE REQUIREMENTS OF THE NATIONAL FIRE PROTECTION ASSOCIATION (NFPA), AMERICAN NATIONAL STANDARDS INSTITUTE (ANSI), AMERICAN SOCIETY OF TESTING MATERIALS (ASTM), AMERICAN WELDING SOCIETY (BWS), AND CAST IRON SOIL PIPE INSTITUTE(CISPI), AND ANY PERTINENT FEDERAL, STATE LOCAL CODES, LAWS AND ORDINANCES, WHICH REQUIREMENTS HAVE PRECEDENCE OVER THE SPECIFICATIONS IN THE EVENT OF ANY CONFLICT BUT WEEN THE REQUIREMENTS HAVE PRECEDENCE OVER THE SPECIFICATIONS IN THE SENT OF THE ABOVE TIEMS ON WITH THESE SPECIFICATIONS SHALL BE REFERRED TO THE ENGINEER.
- 2. PERMITS, FEES, AND NOTICES SECURE AND PAY FOR THE BUILDING PERMITS AND FOR ALL OTHER PERMITS OR GOVERNMENTAL FEES, LICENSES, INSPECTIONS, AND NOTICES NECESSARY FOR THE EXECUTION AND COMPLETION OF THE WORK, WHICH ARE CUSTOMARILY SECURED AFTER EXECUTION OF THE CONTRACT, WHICH ARE LEGALLY REQUIRED AT THE TIME THE BIDS ARE RECEIVED. GIVE ALL NOTICES AND COMPLY WITH ALL LAWS, ORDINANCES, REGULATIONS AND LAWFUL ORDERS OF ANY PUBLIC AUTHORITY BEARING ON THE PERFORMANCE OF THE WORK, GIVE SUFFICIENT NOTICE OF ITS READINESS FOR INSPECTION.
- PROJECT RECORD DOCUMENTS MAINTAIN A SET OF DRAWINGS AT THE SITE ON WHICH SHALL BE ACCURATELY SHOWN THE
 ACTUAL INSTALLATION OF ALL WORK INDICATING THEREON ANY VARIATIONS FROM THE CONTRACT DRAWINGS, INCLUDING
 CHANGES IN SIZES, LOCATION AND DIMENSIONS. PROVIDE A COMPLETE SET OF AS-BUILT DRAWINGS TO OWNER AND
 ENGINEER UPON COMPLETION OF PROJECT.
- 4. OPERATING AND MAINTENANCE INSTRUCTIONS PROVIDE A COMPETENT ENGINEER OR TECHNICIAN TO INSTRUCT THE OPERATING PERSONNEL IN THE OPERATION AND MAINTENANCE OF EQUIPMENT AND SYSTEMS. A COPY OF THE OPERATING AND MAINTENANCE MANUAL SHALL BE PROVIDED AT THIS TIME. PROVIDE A MINIMUL OF 40 HOURS TRAINING ON MECHANICAL SYSTEMS, OR AS SPECIFIED IN EACH MECHANICAL SECTION OF THESE SPECIFICATIONS.
- 5. CLEANING KEEP THE WORK AREAS, INCLUDING ANY FABRICATION, AND STORAGE AREAS, FREE FROM ACCUMULATION OF WASTE MATERIALS OR RUBBISH CAUSED BY THIS OPERATION. AT THE COMPLETION OF THE WORK REMOVE ALL CONSTRUCTION DEBRIS, TEMPORARY FACILITIES AND EQUIPMENT FROM THE WORK AREA, AS WELL AS ALL TOOLS, CONSTRUCTION EQUIPMENT, MACHINERY, AND SURPLUS MATERIALS, IF THE CONTRACTOR FAILS TO CLEAN UP AT THE COMPLETION OF THE WORK, THE OWNER MAY DO SO AND THE COST THEREOF SHALL BE CHARGED TO THE CONTRACTOR.
- CUITING AND PATCHING PERFORM ALL CUITING, FITTING OR PATCHING REQUIRED TO COMPLETE THE WORK OR MAKE ITS SEVERAL PARTS FIT TOGETHER PROPERLY.
- ELECTRICAL WORK MOTORS, COMBINATION MAGNETIC MOTOR STARTERS, SWITCHES AND CONTROLS SHALL BE FURNISHED FOR ALL ELECTRICALLY DRIVEN EQUIPMENT SPECIFIED HEREIN AND SHALL BE IN ACCORDANCE WITH THE PROVISIONS OF THE ELECTRICAL SPECIFICATIONS. ELECTRICAL POWER WIRING SHALL BE FURNISHED AND INSTALLED AS INDICATED ON THE ELECTRICAL DRAWNINGS.
- 8. CONTRACTOR SHALL BE RESPONSIBLE FOR THE COORDINATION AND PROPER RELATIONSHIP OF HIS WORK TO THE BUILDING STRUCTURE AND OTHER TRADES. PARTICULAR ATTENTION IS DIRECTED TO WORK IN CONGESTED AREAS SUCH AS EQUIPMENT ROOMS, FURRED SPACES ABOVE HUNG CEILING, ETC. ALL CONFLICTS SHALL BE RESOLVED BY THE GENERAL CONTRACTOR AND APPROVED BY THE ENGINEER. ALL WORK SHALL BE COORDINATED WITH ALL TRADES INVOLVES. OFFSETS FOR PIPING TO ACCOMMODATE OBSTRUCTIONS AND TRANSITIONS AROUND OBSTRUCTION SHALL BE PROVIDED WITH NO ADDITIONAL COST TO VERIZON WIRELESS.


FUEL GAS PRODUCTS:


CONCRETE FLOOR OR ROOF SLAB

WASHER


METAL CHANNEL STRUT

- BOLTS, ANCHOR BOLTS AND NUTS -- ALL NECESSARY BOLTS, ANCHOR BOLTS, NUTS, WASHERS, PLATES
 AND BOLT SLEEVES SHALL BE PROVIDED IN ACCORDANCE HEREWITH. ANCHOR BOLTS SHALL HAVE
 SUITABLE WASHERS, LOCK WASHERS AND HEXAGONAL NUTS. BOLTS, ANCHOR BOLTS, NUTS AND
 WASHERS SPECIFIED TO BE GALVANIZED, SHALL BE ZINC COATED AFTER BEING THREADED BY THE
 HOT—DID PROFESS
- PIPE HANGERS & SUPPORTS PIPE HANGERS AND SUPPORTS, HANGER RODS, PROTECTION SADDLES
 AND INSERTS SHALL BE TYPE NUMBERS BASED ON MANUFACTURER'S STANDARDIZATION SOCIETY SP-69,
 UNLESS OTHERWISE INDICATED. PIPE COVERING PROTECTION SADDLES: TYPES 39 OR 40. PIPE
 HANGERS: TYPES 1, 41, AND 43, OR FEE AND MASON #212 SPLIT RING HANGERS WITH SUPPORTING
 RODS. SPRING HANGERS: TYPES 49, 51, OR 53. ANCHORS: GRINNELL FIG. 197 OR FEE & MASON FIG.
 159. PIPE GUIDES: GRINNELL FIG. 256, C & P FIG. 1007, OR ELCEN FIG. 411.
- ALL PIPING SYSTEMS SHALL BE SEISMICALLY BRACED IN ACCORDANCE WITH THE APPLICABLE SECTIONS OF THE MASSACHUSETTS STATE BUILDING CODE AND NATIONAL FIRE PROTECTION ASSOCIATION (NFPA) CURRENT EDITION. REFER TO DETAILS FOR SEISMIC PIPE BRACING.
- FUEL GAS PIPE INSIDE BUILDING: SIZES 3" AND SMALLER SHALL BE SCHEDULE 40 CARBON STEEL PIPE WITH MALLEABLE IRON SCREWED FITTINGS.
- FUEL GAS PIPE OUTSIDE OF BUILDING SHALL BE POLYMER COATED, SCHEDULE 40 BLACK PIPE AND FITTINGS WITH WELDED JOINTS. ALL HANGER MATERIALS OUTSIDE OF BUILDING TO BE HOT DIPPED GALVANIZED. ALL NUTS, WASHERS & BOLTS TO BE STAINLESS STEEL.
- FUEL GAS SHUT-OFF VALVES 2-1/2" AND SMALLER: APOLLO 77.100 FULL PORT BRONZE BODY WITH TEE HANDLE. 2-1/2" AND LARGER: NORDSTORM 143, SERCK AUDCO LSW-133-GG, OR WALWORTH 175 PSI WORKING PRESSURE IRON BODY LUBRICATED PLUG VALVE WITH FLANGED ENDS.

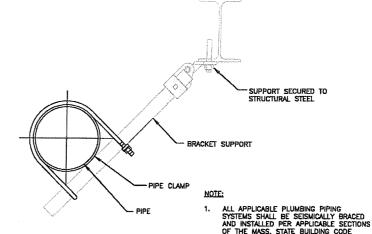


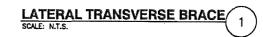

LATEST EDITIONS.

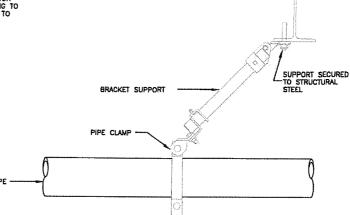

LONG SEISMIC BRACING
SCALE: N.T.S.

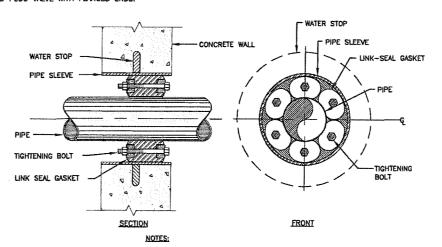

- LINK SEAL PIPE SLEEVE TO BE GALVANIZED STEEL FOR UNDERGROUND OR EXTERIOR APPLICATIONS.
- 2. PIPE SLEEVE TO BE STEEL OR PLASTIC FOR INTERIOR

WATERTIGHT LINK SEAL
SCALE: N.T.S.

4



VERIZON WIRELESS 118 FLANDERS ROAD WESTBOROUGH, MA 01581-3956

CAMBRIDGE 5 MA (LESLEY UNIVERSITY)

	С	CONSTRUCTION DRAWINGS				
ı						
ı	1	04/14/17	FOR	SUBMITTAL		
ı		05/24/16	FOR	SUBMITTAL		
	Α	04/12/16	FOR	REVIEW		



Dewberry Engineers Inc. 280 SUMMER STREET 10TH FLOOR BOSTON, MA 02210 PHONE: 617-685-3400 FAX: 617-685-3310



DRAWN BY:	MR
REVIEWED BY:	мғт
CHECKED BY:	BBR
PROJECT NUMBER:	50002925

	11/2/11/19
SITE ADDRESS:	
	- 1
4545 11466461116	

50069466

1815 MASSACHUSETTS AVENUE CAMBRIDGE, MA 02140

SHEET TITLE

JOB NUMBER:

NATURAL GAS PIPING NOTES & DETAILS

SHEET NUMBER

P-2

PIPE HANGER
SCALE: N.T.S.


-DOUBLE SIDED

EQUIPMENT PROVIDE MIN. 3/8" DIA. HANGER ROD (REFER TO MANUFACTURERS INSTALLATION INSTRUCTIONS).

(TYP.) (SEE NOTE 1)





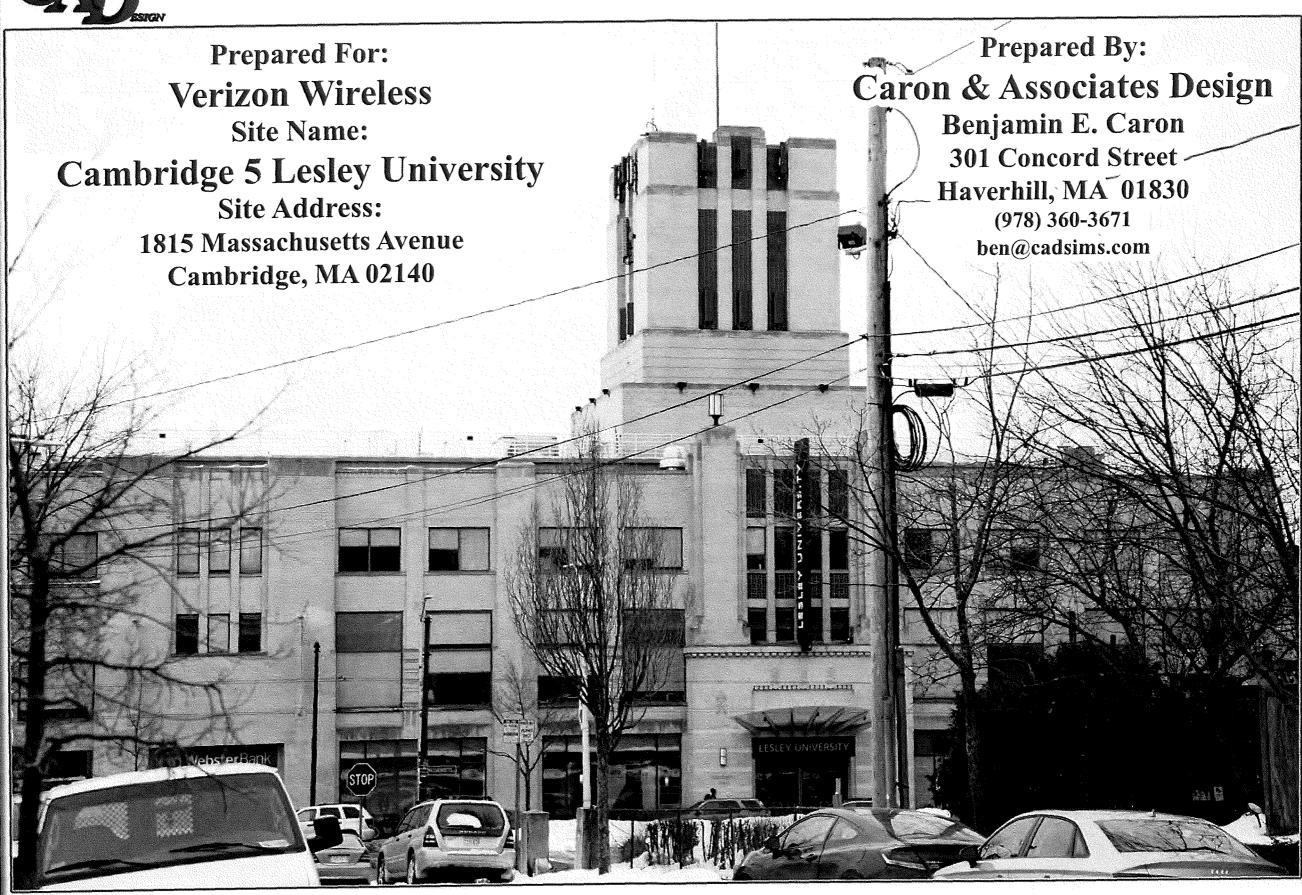

For visual reference only. Actual visibility is dependent upon weather conditions, season, sunlight, and viewer location.


Based upon Rev. 1 LE by Dewberry dated: 11/09/2015 & Antenna Design by VZW dated 3/18/2015

Cambridge 5 ~ Lesley University ~ (2/26/2016)
Photographic Renderings

Created By: Ben Caron & Mike Barreiros
Caron & Associates Design
(978) 360-3671 info@cadsims.com





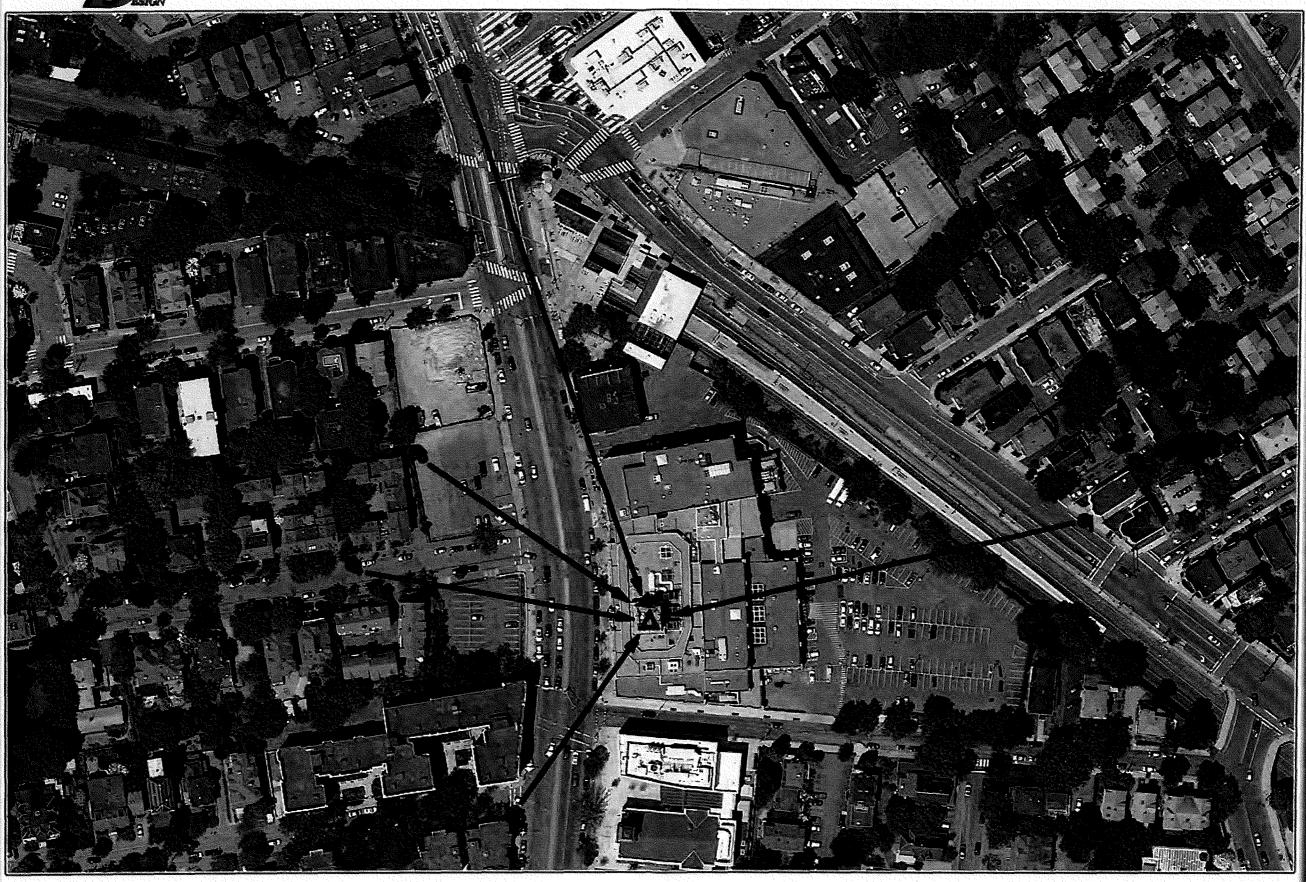

For visual reference only. Actual visibility is dependent upon weather conditions, season, sunlight, and viewer location.

Based upon Rev. 1 LE by Dewberry dated: 11/09/2015 & Antenna Design by VTW dated 3/18/2015

Cambridge 5 ~ Lesley University ~ (2/26/2016)
Photo Location Map

Created By: Ben Caron & Mike Barreiros


Caron & Associates Design

(978) 360-3671 info@cadsims.com

BZA APPLICATION FORM - OWNERSHIP INFORMATION

To be completed by OWNER, signed before a notary and returned to The Secretary of the Board of Zoning Appeals.

 If ownership is not shown in recorded deed, e.g. if by court order, recent deed, or inheritance, please include documentation.

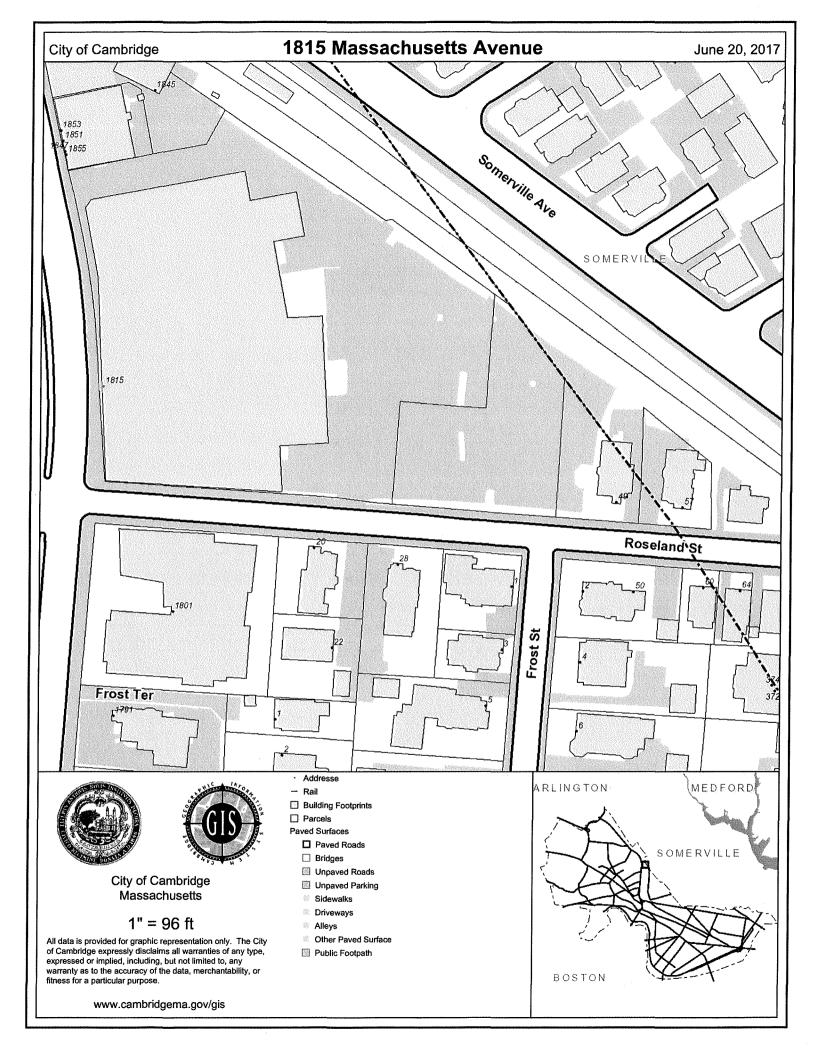



For visual reference only. Actual visibility is dependent upon weather conditions, season, sunlight, and viewer location.

Based upon Rev. 1 LE by Dewberry dated: 11/09/2015 & Antenna Design by V7W dated 3/18/2015

Cambridge 5 ~ Lesley University ~ (2/26/2016)
Photo Location 1 ~ 85mm ~ 500'+/- (0.09mi) Away

Created By: Ben Caron & Mike Barreiros

Caron & Associates Design

(978) 360-3671 info@cadsims.com





For visual reference only. Actual visibility is dependent upon weather conditions, season, sunlight, and viewer location.

Based upon Rev. 1 LE by Develor y dated: 11/09/2015 & Antenna Desion by VTW dated 3/18/2015

Cambridge 5 ~ Lesley University ~ (2/26/2016)
Photo Location 5 ~ 50mm ~ 236'+/- (0.04mi) Away

Created By: Ben Caron & Mike Barreiros

Caron & Associates Design

(978) 360-3671 info@cadsims.com

Cellular License - KNKA201 - Cellco Partnership

Call Sign

KNKA201

Radio Service

CL - Cellular

Status

Active

Auth Type

Regular

Market

Market

CMA006 - Boston-Lowell-Brockton-Lawrence-Haverhill, MA-NH

Channel Block

В

Submarket

0

Phase

2

Dates

Grant

08/26/2014

Expiration

10/01/2024

Effective

11/01/2016

Cancellation

Five Year Buildout Date

08/27/1989

Control Points

3

500 W. Dove Rd., TARRANT, Southlake, TX

P: (800)264-6620

Licensee

FRN

0003290673

Type

General Partnership

Licensee

Cellco Partnership

5055 North Point Pkwy, NP2NE Network Engineering

Alpharetta, GA 30022

ATTN Regulatory

P:(770)797-1070

F:(770)797-1036

E:LicensingCompliance@VerizonWireless.com

Contact

Cellco Partnership

Licensing Manager

5055 North Point Pkwy, NP2NE Network Engineering Alpharetta, GA 30022

ATTN Regulatory

P:(770)797-1070

F:(770)797-1036

E:LicensingCompliance@VerizonWireless.com

Ownership and Qualifications

Radio Service Type

Mobile

Regulatory Status Common Carrier Interconnected

Yes

Alien Ownership

The Applicant answered "No" to each of the Alien Ownership questions.

Basic Qualifications

The Applicant answered "No" to each of the Basic Qualification questions.

Demographics

Race

Ethnicity

Gender

PCS Broadband License - KNLH242 - Cellco Partnership

Call Sign

KNLH242

Radio Service

CW - PCS Broadband

Status

Active

Auth Type

Regular

Market

Market Submarket BTA051 - Boston, MA

Associated

Channel Block

Frequencies (MHz)

001890.000000000-001895.00000000 001970.00000000-

001975.00000000

Dates

Grant

07/23/2007

Expiration

06/27/2017

Effective

11/01/2016

Cancellation

Buildout Deadlines

06/27/2002

2nd

Notification Dates

1st

05/17/2002

2nd

Licensee

FRN

0003290673

Type

Joint Venture

Licensee

Cellco Partnership

5055 North Point Pkwy, NP2NE Network Engineering

Alpharetta, GA 30022

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5055 North Point Pkwy, NP2NE Network Engineering

Alpharetta, GA 30022 ATTN Regulatory

E:LicensingCompliance@VerizonWireless.com

Ownership and Qualifications

Radio Service Type

Mobile

Regulatory Status Common Carrier Interconnected

Yes

Alien Ownership

Is the applicant a foreign government or the representative of any

No

foreign government?

No

Is the applicant an alien or the representative of an alien?

No

Is the applicant a corporation organized under the laws of any foreign government?

No

Is the applicant a corporation of which more than one-fifth of the capital stock is owned of record or voted by aliens or their representatives or by a foreign government or representative thereof or by any corporation organized under the laws of a foreign country?

AWS (1710-1755 MHz and 2110-2155 MHz) License - WQGA900 - Cellco Partnership

Call Sign

WQGA900

Radio Service

AW - AWS (1710-1755 MHz and

2110-2155 MHz)

Status

Active

Auth Type

Regular

Market

Market

BEA003 - Boston-Worcester-

Channel Block

ck B

Lawrence-Lowell-Brockton, MA-NH-RI-VT

Submarket

1

Associated

001720.00000000-001730.00000000

Frequencies (MHz)

002120.000000000 002130.00000000

Dates

Grant

11/29/2006

Expiration

11/29/2021

Effective

11/01/2016

Cancellation

Buildout Deadlines

1st

2nd

Notification Dates

1st

2nd

Licensee

FRN

0003290673

Type

General Partnership

Licensee

Cellco Partnership

5055 North Point Pkwy, NP2NE Network Engineering

Alpharetta, GA 30022

ATTN Regulatory

P:(770)797-1070

F:(770)797-1036

E:LicensingCompliance@VerizonWireless.com

Contact

Cellco Partnership

Licensing Manager

5055 North Point Pkwy, NP2NE Network Engineering

Alpharetta, GA 30022 ATTN Regulatory P:(770)797-1070 F:(770)797-1036

E:LicensingCompliance@VerizonWireless.com

Ownership and Qualifications

Radio Service Type

Mobile

Regulatory Status

Common Carrier

Interconnected

Yes

Alien Ownership

The Applicant answered "No" to each of the Alien Ownership questions.

Basic Qualifications

The Applicant answered "No" to each of the Basic Qualification questions.

Tribal Land Bidding Credits

This license did not have tribal land bidding credits.

AWS (1710-1755 MHz and 2110-2155 MHz) License - WQGB266 -Cellco Partnership

Call Sign

WQGB266

Radio Service

AW - AWS (1710-1755 MHz and

2110-2155 MHz)

Status

Active

Auth Type

Regular

Market

Market

CMA006 - Boston-Lowell-Brockton-Lawrence-Haverhill, MA-NH

Channel Block

Submarket

Associated

001710.00000000-

Frequencies (MHz)

001720.00000000 002110.00000000-

002120.00000000

Dates

Grant

11/29/2006

Expiration

11/29/2021

Effective

11/01/2016

Cancellation

Buildout Deadlines

1st

2nd

Notification Dates

1st

2nd

Licensee

FRN

0003290673

Type

General Partnership

Licensee

Cellco Partnership

5055 North Point Pkwy, NP2NE Network Engineering

Alpharetta, GA 30022

ATTN Regulatory

P:(770)797-1070 F:(770)797-1036

E:LicensingCompliance@VerizonWireless.com

Contact

Cellco Partnership

Licensing Manager

5055 North Point Pkwy, NP2NE Network Engineering

Alpharetta, GA 30022

ATTN Regulatory

P:(770)797-1070

F:(770)797-1036

E:LicensingCompliance@VerizonWireless.com

Ownership and Qualifications

Radio Service Type

Mobile

Regulatory Status Common Carrier Interconnected

Yes

Alien Ownership

Is the applicant a foreign government or the representative of any

foreign government?

No

Is the applicant an alien or the representative of an alien?

Is the applicant a corporation organized under the laws of any

foreign government?

No No

Is the applicant a corporation of which more than one-fifth of the

700 MHz Upper Band (Block C) License - WQJQ689 - Cellco Partnership

This license has pending applications: 0007581227

Call Sign

WQJQ689

Radio Service

WU - 700 MHz Upper Band (Block

C)

Status

Active

Auth Type

Regular

Market

Market

REA001 - Northeast

Channel Block

lock C

Submarket

Ω

Associated Frequencies

(MHz)

000746.00000000-000757.00000000 000776.00000000-

000787.00000000

Dates

Grant

11/26/2008

Expiration

06/13/2019

Effective

01/31/2017

Cancellation

Buildout Deadlines

1st

06/13/2013

2nd

06/13/2019

Notification Dates

1st

06/20/2013

2nd

Licensee

FRN

0003290673

Type

General Partnership

Licensee

Cellco Partnership

5055 North Point Pkwy, NP2NE Network Engineering

Alpharetta, GA 30022

ATTN Regulatory

P:(770)797-1070

F:(770)797-1036

E:LicensingCompliance@VerizonWireless.com

Contact

Verizon Wireless

Licensing Manager

P:(770)797-1070 F:(770)797-1036

5055 North Point Pkwy, NP2NE Network Engineering

E:LicensingCompliance@VerizonWireless.com

Alpharetta, GA 30022

ATTN Regulatory

Ownership and Qualifications

Radio Service Type

Mobile

Regulatory Status

Common Carrier

Interconnected

Yes

Alien Ownership

The Applicant answered "No" to each of the Alien Ownership questions.

Basic Qualifications

The Applicant answered "No" to each of the Basic Qualification questions.

Tribal Land Bidding Credits

This license did not have tribal land bidding credits.

1815 Mass Ave

	1019	191100 1100		
178-21 Porter Rd 1 White St			160	
1920 Massachusetts Ave	170.07	CX 26 V	Vhite St	(6)*
12 Porter Rd 178-79	179-87	White St 26 V	/hite St	
178-80 178-34 1912 Massachusetts Ave 36 White S	t35 White St	152-1		
1902 Massachusetts Ave		18 White St 152-9 6	White Street PI	
178-133 1900 Massachusetts			3 7.	P. 181
176-133		152-7	180	
	10	orter Sa	White Street PI	A 1
	Massachusetts Ave 1 F	152-25	OF TO	100
200-100			12	17.0
178-52	99 Massachusetts Ave	320 Somerville Ave		200
178-93 1890 Massachusetts	Ave152-41	822 Somerville Ave	and the same of th	
178-94 178-92 178-91 1880 Massach		152-52		
	er Square 815	Somerville Ave		- 100
Upland Rd	chusetts Ave	Somerville Ave		
16 Upland Rd	152-53	"enille		1.48
22 Upland Rd	1845 Massachusetts A	ve-		
177-34 1853 Massachusetts A				6,7
177-42 177-45 177-46 1853 Massachusetts A	152-47			
177-41 1840 Massach	usetts Avo		A)	
			P. J.	
177-75			Ben Baile	
177-78			las /	7
177-77 15 Mt Vernon St				ed V
24 844 1/2000 04		152-51		i
Mt Vernon St 1826-Massa	nusetts Ave	102-01	71-B1	2
177-84	1815 Massac	husatts Ava	31-B	2
177-85 177-80 177-71	1010 Wassac	ridocito Ave	3/-	Bay Ex
177-177177-81			152-17	5/-1825
177-48 ¹⁷⁷ -47 177-83 ¹⁷⁷ -82				31-85 A
177-8	Massac Jusetts Ave		152-18 49 Roseland	
1810	Massachusetts Ave	Roseland St	45 17036lall	57-Roseland St
177-55 ⁵ Arlington St 1808	Massachusetts Ave 2	O'Resoland St	Roseland-St	
7 Arlington St		153-83	1 Frost St ₂ Fr	root St
	452.05		153-4	3-20 153-21
Arlington St	153-85	153 22 Rosela		64 Roseland St
2 Arlington St	1	153-84	153-5 4 Fr	rost St
8 Arlington St 4 Arlington St 6 Arlington St	Frost Ter		5 Frost St	53-36 153-23
176-13 1791 Massach	usetts Ave	153-81		ost St
176-69 Stone Ct	153-80			53-35
The state of the s		153-82	st St ₇ Frost St to	153-78
1792 Massachusetts Ave	1783 Massachus	SALEST CONTROL OF THE	St Frost St to	3-34
13-B Lancaster St 176-15	2 Newport Rd	3-59	153-7	153-79
176-69 Stone Ct 792 Massachusetts Ave 393 Ma	2 Newport Rd	6 Newport Rd 153-	54 18 Frost St	
176-75 176-83	3 Newport	Rd 12	Newport Rd 153	3-87
	1 Newport	Rd 5 Newport Rd 2	153-56 ²¹ Frost St	
Lancaster St	153-	66	153-56 Forest St 24 Frost St 153-37	
	44	Rd7 Newport Rd P Rd5 Newport Rd L 66 9-AF	OLEST OF THE OUT OF	
16 Lancaster St 1773 Massachuse	155-14	100-12	153-58 153-41153-	153-71
8 Lancaster St	1-B Forest St 153-	77 153-11 9 Fo	prest St 15 Forest St	19 Forest St
1704 Wass	auliusells AVE	The state of the s		



18/5 Mass De Petitiner

176-13 CROWLEY, STEPHEN A. 2 ARLINGTON ST., UNIT #1 CAMBRIDGE, MA 02139 176-13 COLLINS, MARGARET R. 2-6 ARLINGTON ST., #2 CAMBRIDGE, MA 02140 ROBINSON & COLE C/O MICHAEL S. GIAIMO, ESQ. ONE BOSTON PLACE, 25TH FL. BOSTON, MA 02108

176-13 WFB FUTURAMA RENTALS LLC. C/O RESOURCE CAPITAL GROUP 17 IVALOO ST SOMERVILLE, MA 02143

LIU, HUI & KE SHEN 4 ARLINGTON ST. UNIT#1 CAMBRIDGE, MA 02140

176-13

176-13 THEALL, STEPHEN J. JR. 4 ARLINGTON ST., UNIT #2 CAMBRIDGE, MA 02140

176-13 SPILKER, HAROLD D. III & KIRSTEN OLSON SPILKER 11 CAMPBELL PARK SOMERVILLE, MA 02144 177-55
THAYER DOUGLAS & DONALD THAYER
ARLINGTON ST REAL ESTATE
C/O THAYER & ASSOCIATES
1812 MASS AVE
CAMBRIDGE, MA 02140

177-55 MORSE, PHILIP TRUSTEE OF PHILIP MORSE TRUST 7 ARLINGTON ST. UNIT# 7/57 CAMBRIDGE, MA 02140

176-13 SMITH, JULIA 4 ARLINGTON ST., UNIT #6 CAMBRIDGE, MA 02139 176-13 BERKELEY, JEROME 4 ARLINGTON ST. UNIT#4/7 CAMBRIDGE, MA 02139 176-13 CROWLEY, JR. , STEPHEN ANTHONY & ANGELA MARIE BISANTI 2610 MARINE AVE., SW, UNIT A SEATTLE, WA 98116

177-55
OXFORD COURTS REALTY INC. ARLINGTON
STREET REAL ESTATE TRUST
C/O THAYER & ASSOCIATES
1812 MASSACHUSETTS AVE
CAMBRIDGE, MA 02140

176-13 WEJKSNORA, RUTH & LILA GARROTT 46 VINAL AVE #1 SOMERVILLE, MA 02143

176-13 LIGRESTI, LEONARDO & SILVA SPRINGOLO VIA MILAZZO 7, 35139 PADOVA, _ _

176-13 PALMER, DOUGLAS J., C/O OXFORD STREET REALTY, INC. 1644 MASS AVE CAMBRIDGE, MA 02138 176-13 SCHILLER, LAUREN E. 5421 S. CORNELL AVE #9 CHICAGO, IL 60615 176-13 NEELY, CLAIRE G. 2 ARLINGTON ST #11 CAMBRIDGE, MA 02140

176-13 RUHELA, VIJAY & ARUN BHATIA 2 ARLINGTON ST. UNIT#12 CAMBRIDGE, MA 02140 176-13 CHU, ANDREW C. 10849 N STERLING ROAD CUPERTINO, CA 95014

176-13 CHANG, CHRISTINE Z. & PATRICK C. MCLEAN 2-6 ARLINGTON ST., #2/21 CAMBRIDGE, MA 02140

176-13 KEIFER, SUSAN MARGARET 1216 CONGRESSIONAL LANE WILMINGTON, NC 28411 176-13 WHITE, ROSEMARY D. & MARY H. WHITE 2 ARLINGTON ST. UNIT#23 CAMBRIDGE, MA 02140 176-13 LEE, HYEJIN 1 EARHART ST #506 CAMBRIDGE, MA 02141

176-13 RABB, INTISAR 2 ARLINGTON ST. UNIT#32 CAMBRIDGE, MA 02140 176-13 BOARDMAN, RICHARD B. & LYNNE A. STANTON 2 ARLINGTON ST. UNIT#33 CAMBRIDGE, MA 02140 176-13 POWELL, MARTHA 4 ARLINGTON ST. UNIT#10 CAMBRIDGE, MA 02139

176-13 HOFFMAN, JANICE 64 BETTS RD BELMONT, MA 02478 176-13 WFB FUTURAMA RENTALS LLC. C/O ALEX STEINBERGH & R. STANLEY BOWDEN 17 IVALOO ST. SUITE #100 SOMERVILLE, MA 02143 176-13 STUART, SEBASTIAN & STEPHEN D. MCCAULEY 4 ARLINGTON ST #21 CAMBRIDGE, MA 02140 176-13 LANDERS, DEBORAH D. 4 ARLINGTON ST., UNIT #22 CAMBRIDGE, MA 02140

176-13 PODBELSKI, JANA J. 334 PROVIDENCE RD SO. GRAFTON, MA 01560

176-13 BOWDEN, SHAREN K. C/O R C G 17 IVALOO ST, STE 100 SOMERVILLE, MA 02143

176-13 JI, XIAOAN & ZHAODIAN JI 4 ARLINGTONST. UNIT#11A CAMBRIDGE, MA 02140

177-55 1812 MASSACHUSETTS AVENUE LLC, C/O W.T. PHELAN INS. AGENCY 63 TRAPELO ROAD BELMONT, MA 02478

176-13 LIN, ALEXANDER & CHUN PI LIN HUANG 1800 MASSACHUSETTS AVE. - UNIT 800/5 CAMBRIDGE, MA 02140

176-13 AZABU, LL¢ 1-3-15 MINAMI AZABU, MINATOKI, _ _

176-13 CHAO, HUNG-HSING 1800 MASSACHUSETTS AVE., #11 CAMBRIDGE, MA 02140

176-13 LIFSEY, ANGELA 1800 MASS AVENUE, UNIT 80021 CAMBRIDGE, MA 02140

176-13 SHIUE, REN-JYE & CHIH-WEI CHANG 1800 MASSACHUSETTS AVE., #80031 CAMBRIDGE, MA 02140 176-13 CANNAVA, CHRISTINE M. 4 ARLINGTON ST #31 CAMBRIDGE, MA 02140

176-13 DALTON, KATHY L. 6 ARLINGTON ST #12 CAMBRIDGE, MA 02140

176-13 FREIDBERG, SUSANNE 6 ARLINGTON ST., UNIT #6/31 CAMBRIDGE, MA 02140

176-13 BROMBERGER, SYLVAIN & NANCY L. BROMBERGE 4 ARLINGTON ST., UNIT #12A CAMBRIDGE, MA 02140

176-13 SIMONS, REBECCA L. 1800 MASS AVE, #3 CAMBRIDGE, MA 02140

176-13
DANBERG, SEYMOUR A. TRUSTEE DANBERG
CAMBRIDGE REALTY TRUST
P.O. BOX 425091
CAMBRIDGE, MA 02140

176-13 GOODCHILD, ANDREW, KAYOKO TAZAWA & CITY OF CAMBRIDGE TAX TITLE 1800 MASSACHUSETTS AVE., UNIT 800/9 CAMBRIDGE, MA 02139

176-13 BOWDEN, KRISTEN M. C/O ALEX STEINBERGH & R. STANLEY BOWDEN 17 IVALOO ST., SUITE#100 SOMERVILLE, MA 02143

176-13 BOWDEN, MILISSA L. C/O RCG 17 IVALOO ST., SUITE #100 SOMERVILLE, MA 02143

176-13 MARGULIS T. N. C/O RCG LLC, 17 IVALOO ST., SUITE#100 SOMERVILLE, MA 02143 176-13 BROOKS, JAMES E. 364 SPRING ST PORTLAND, ME 04102

176-13 POPE, WILLARD R. & SYLVIA C. POPE 6 ARLINGTON ST., #21 CAMBRIDGE, MA 02140

176-13 HU, CHIA-LING & CINDY HU 6 ARLINGTON ST., #32 CAMBRIDGE, MA 02140

176-13 PARUCHURI, SRINIVAS S.K. & S.R.A. PARUCHURI 1060 OAKTREE LN BLOOMFIELD HILLS, MI 48304

176-13 TSERLIN, ELINA 1800 MASS AVE. UNIT#4 CAMBRIDGE, MA 02140

176-13 PARUCHURI, ANJUANEYULU 1060 OAKTREE LN BLOOMFIELD HILLS, MI 48304

176-13 S.R.A. PARUCHURI 1060 OAKTREE LN BLOOMFIELD HILLS, MI 48304

176-13 HARRIS, RICHARD A. & PATRICIA HARRIS 1800 MASS AVE.UNIT#14 CAMBRIDGE, MA 02140

176-13 GRAZIOSI, ANDREA VIA ISOLA MADRE 3 00141 ROMA, - --

176-13 HUANG, CHUN PI LIN 1800 MASS AVE. UNIT#33 CAMBRIDGE, MA 02140 176-13
PERDIKOLOGOS, CONSTANTINA &
FOTINI PERDIKOLOGOS
1802 MASS AVE., #11
CAMBRIDGE, MA 02139

177-71-79 /152-17-18-51 /153-85 LESLEY COLLEGE 29 EVERETT STREET CAMBRIDGE, MA 02138

177-34 1868 MASS AVE LLC 109 SCHOOL ST WATERTOWN, MA 02472

177-55 KNOLL, VANESSA 3 ARLINGTON ST., #3/3 CAMBRIDGE, MA 02140

177-55 WU, FEI 3 ARLINGTON ST., #3/6 CAMBRIDGE, MA 02140

177-55 BHADURI, SHAHANA 5 ARLINGTON ST. APT 1 CAMBRIDGE, MA 02140

177-55 PLAYFAIR, SUSAN R. 249 JERUSALEM RD. COHASSET, MA 02025

177-55 FILENE, JACOB F. 1460 BLUE JAY CIRCLE WESTON, FL 33327

177-55 MYERS, ALAN G. 7 ARLINGTON ST #4 CAMBRIDGE, MA 02140

177-55 ASHLEY, GISELA 7 ARLINGTON ST #7 CAMBRIDGE, MA 02140 176-13 LIU, HONG, TR. 1802 MASSACHUSETTS AVE REALTY TR. 1673 CAMBRIDGE ST. CAMBRIDGE, MA 02138

176-13 WEISS, JUDITH 21 ORCHARD ST., #2 CAMBRIDGE, MA 02140

177-55 JALAL, AYESHA 92 ORCHARD ST. SOMERVILLE, MA 02144

177-55 CARTAGINE, CARLOS 3 ARLINGTON ST. UNIT#3/4 CAMBRIDGE, MA 02139

177-55
ABID, ZEHRA & CITY OF CAMBRIDGE TAX TITLE
1-7 ARLINGTON ST.,UNIT #3/7
CAMBRIDGE, MA 02140

177-55 SHAO, MIN & YING CHEN C/O PHILIP TSENG 51 PETTEE ST #16 NEWTON, MA 02464

177-55
DURSO, JAMES E & ELIZABETH L. FOSNIGHT
C/O OXFORD STREET REALTY
1644 MASS AVE
CAMBRIDGE, MA 02138

177-55 JAMES, WILLIAM D. & NANCY B. JAMES 7 ARLINGTON ST #2 CAMBRIDGE, MA 02140

177-55 ORFALI, MERCEDES 3333 NE 34TH ST #1505 FT. LAUDERDALE, FL 33308

177-55 TERWILLIGER,CYNTHIA J. 7 ARLINGTON ST #8 CAMBRIDGE, MA 02140 177-55 MCDONAGH, JOHN P 5 ARLINGTON ST. CAMBRIDGE, MA 02140

152-47 MAYER, EDWARD A. & LOUISE M. MAYER 140 TREBLE COVE RD BILLERICA, MA 01821

177-55 UCHIDA, YOKO 4348 WAIALAE AVE - 923 HONOLULU, HI 96816

177-55 SORRENTINO, MARIE SANDY SORRENTINO REAL ESTATE LLC 262 COLLAMER RD HILTON, NY 14468

177-55 FERNANDEZ, MERCEDES 3333 NE 34TH ST #1505 FT. LAUDERDALE, FL 33308

177-55 SCOTT, LAURIE A. 5 ARLINGTON ST #3 CAMBRIDGE, MA 02140

177-55 LOCSIN, JEAN LOUIS. 5 ARLINGTON ST. UNIT#22 CAMBRIDGE, MA 02140

152-19 RICCI, DOMENICK & JOSEPHINE RICCI C/O MAREK JITKA 57 ROSELAND STREET #3 SOMERVILLE, MA 02143

177-55 MARENTES LUIS A. & NEGAR TARADJI 31 WILLOW ST CONCORD, MA 01742

177-55 TOBIN, SUSANNAH BARTON 3 ARLINGTON ST. UNIT# 21 CAMBRIDGE, MA 02140 177-55 DONG, HUI, TR. THE ARLINGTON PORTER TRUST PO BOX 456

TR. THE ARLINGTON PORTER TRUST PO BOX 456 WINCHESTER, MA 01890

177-55 THORNE, NELL 3 ARLINGTON ST., UNIT #3/25 CAMBRIDGE, MA 02140

177-55 PAGE,PATRICK G. & KAREN J. PAGE 3 ARLINGTON STREET #3-31 CAMBRIDGE, MA 02140

177-55 ALTMAN, ALISON 3 ARLINGTON STREET UNIT #3-34 CAMBRIDGE, MA 02140

177-55 JI, XIAOAN & ZHAODIAN JI 4 ARLINGTON ST., #11A CAMBRIDGE, MA 02139

177-55 SUTHERLAND, LUCY R. TR.THE SUTHERLAND ARLINGTON STREET REALTY TRUST 3 ARLINGTON ST., UNIT #43 CAMBRIDGE, MA 02140

177-55
CHANG, NANCY T. TRUSTEE OF NANCY T.
CHANG REVOCABLE TRST REVOCABLE TRUST
1644 MASS AVE
CAMBRIDGE, MA 02138

177-55
THAYER DOUGLAS G. & DONALD THAYER
ARLINGTON ST REAL ESTATE TRUST
C/O THAYER & ASSOCIATES
1812 MASSACHUSETTS AVE
CAMBRIDGE, MA 02140

177-55 MCNULTY, JAMES P. 3 ARLINGTON ST #55 CAMBRIDGE, MA 02140

177-55 BENNETT, MONICA M. & MICHAEL F. BENNETT TRUSTEE OF M.M.B. LIVING TRUST 5 ARLINGTON ST. UNIT5/21 CAMBRIDGE, MA 02140 177-55 LU, CHENCHEN & QIHAN LIU 3 ARLINGTON ST., #23 CAMBRIDGE, MA 02140

177-55 ROVINELLI, H. PAUL 3 ARLINGTON ST. UNIT#26 CAMBRIDGE, MA 02140

LOI, SALLY 3 ARLINGTON ST. UNIT#32 CAMBRIDGE, MA 02140

177-55

177-55 SAVAGE, ELIZABETH B. 3 ARLINGTON ST., #3/35 CAMBRIDGE, MA 02140

177-55 GOPINATH, DINESH 3 ARLINGTON STREET #3/41 CAMBRIDGE, MA 02140

177-55 BRAV, JULIA, PETER BRAV & JANET BRAV 3 ARLINGTON ST., UNIT #3/44 CAMBRIDGE, MA 02140

177-55 ORFALI,MERCEDES 3333 NE 34TH ST #1505 FT. LAUDERDALE, FL 33308

177-55 SIMMONS, ALFRED M. 3 ARLINGTON ST., UNIT #3 CAMBRIDGE, MA 02140

177-55 DAHER, SALEH JR. & JONE ABOITIZ DAHER 3 ARLINGTON ST., UNIT #57 CAMBRIDGE, MA 02140

177-55 YU, KONGJIAN 5 ARLINGTON ST. UNIT#22 CAMBRIDGE, MA 02140 177-55 HUGHES, ELISABETH 3 ARLINGTON ST., UNIT #24 CAMBRIDGE, MA 02140

177-55 LAW, MICHAEL 3 ARLINGTON STREET UNIT #3-27 CAMBRIDGE, MA 02140

177-55 WELCH, RYAN P. & KATHERINE J. WELCH 27 PINE ST. MELROSE, MA 02176

177-55 JI, XIAOAN & ZHAODIAN JI 4 ARLINGTON ST., #11A CAMBRIDGE, MA 02139

177-55 HUANG, IRENE C. & ANDREW WANG 166 WOODCLIFF ROAD NEWTON, MA 02161

177-55 PAOLINI, ELENA L. 3 ARLINGTON ST. UNIT#45 CAMBRIDGE, MA 02140

177-55 HOFMANN, ANDREAS G., TR. OF THE ROSEMARIE HOFMANN IRREVOCABLE TRS 3 ARLINGTON ST., UNIT 3/51 CAMBRIDGE, MA 02140

177-55 MURPHY, KATHLEEN M., TRUSTEE THE MOLLY SOLOMON TRUST P.O. BOX 427 MARBLEHEAD, MA 01945

153-83 FARRINGTON, SARAH M., SAMUEL F. & JOHN L. FARRINGTON 28 ROSELAND ST., #1 CAMBRIDGE, MA 02140

177-55 COLLINS, JOHN A. C/O ANDY ZWICK 350 WEST 42ND ST #37C NEW YORK, NY 10036 177-55 SOLOMON, LESLIE J. 5 ARLINGTON ST UNIT #24 CAMBRIDGE, MA 02140

177-55 MOORES, MARJORIE J. 5 ARLINGTON ST #31 CAMBRIDGE, MA 02140

177-55 BANKLER, BETH A. 5 ARLINGTON ST #34 CAMBRIDGE, MA 02140

177-55 BUFFUM, TIMOTHY A. 5 ARLINGTON ST. UNIT#41 CAMBRIDGE, MA 02140

177-55 RUBINSKY, MELISSA B. 5 ARLINGTON ST #44 CAMBRIDGE, MA 02140

177-55 FANTASIA, MEREDITH 5 ARLINGTON ST., #5/51 CAMBRIDGE, MA 02140

177-55 LICUANAN, FRANCISCO & VICTORIA LICUANAN 5 ARLINGTON ST., UNIT #54 CAMBRIDGE, MA 02140

177-55 JOYCE, MARYBETH M. 5 ARLINGTON ST #B1 CAMBRIDGE, MA 02140

177-55 BRAND, SUSAN F. 7 ARLINGTON ST #23 CAMBRIDGE, MA 02140

177-55 MILBOUER, LANCE E. 7 ARLINGTON ST #26 CAMBRIDGE, MA 02140 177-55 PETERS, ANNE C. 5 ARLINGTON ST #25 CAMBRIDGE, MA 02140

177-55 THAYER, JR., DONALD F. & DOUGLAS G. THAYER, TRS OF THE D-M REALTY TRUST P.O. BOX 196400 CAMBRIDGE, MA 02140

177-55 SCORDATO, CHRISTINE A. 5 ARLINGTON ST. UNIT#5/35 CAMBRIDGE, MA 02141

177-55 MATTHEWS, DAVID LEE & TERRI HUME OLIVER 5 ARLINGTON ST. UNIT#42 CAMBRIDGE, MA 02140

177-55 FLANNERY, SUSAN M. & STEPHEN A. COREN 5 ARLINGTON ST #45 CAMBRIDGE, MA 02140

177-55 JAMES, DAVID L. & SHEILA F. JAMES TRS. OF THE JAMES ADVANTAGE TRUST 229 BRANNAN ST., APT#4J SAN FRANCISCO, CA 94107

177-55 LENIHAN, WINIFRED 5 ARLINGTON ST #55 CAMBRIDGE, MA 02140

177-55 DUONG, LOC 7 ARLINGTON ST., UNIT #7/21 CAMBRIDGE, MA 02140

177-55 BANG, YOONSHIN 7 ARLINGTON ST. UNIT#24 CAMBRIDGE, MA 02138

177-55 KIMBALL, WILLIAM S. 7 ARLINGTON ST #27 CAMBRIDGE, MA 02140 177-55 BISHKO, ADRIANE 5 ARLINGTON ST. UNIT#5/26 CAMBRIDGE, MA 02140

GILES, RICHARD H. AND SUZANNE E. LAKE, TRS OF ARLINGTON OXFORD REALTY TRUST 36 SPRING ST CONCORD, MA 01742

177-55 BORINS, LAWRENCE A. 5 ARLINGTON ST #36 CAMBRIDGE, MA 02140

177-55 COLLINS, HALSEY B 150 LINCOLN ST., UNIT #4A BOSTON, MA 02111

177-55 HAYES, KATHLEEN M. 5 ARLINGTON ST #46 CAMBRIDGE, MA 02140

177-55 FOGEL, TERRI D. 5 ARLINGTON STREET UNIT #5-53 CAMBRIDGE, MA 02140

177-55 LICUANAN, ANA 5 ARLINGTON ST., #5/56 CAMBRIDGE, MA 02140

177-55 BRAND, SUSAN F. 7 ARLINGTON ST #22 CAMBRIDGE, MA 02140

177-55 KNAPP, MARY M 9 SHEFFIELD WAY WESTBOROUGH, MA 01581

177-55 KINDER, PETER D. P.O. BOX 400167 CAMBRIDGE, MA 02140 177-55 KINDER, PETER D. PO BOX 400167

CAMBRIDGE, MA 02140

177-55
THAYER, MARJORIE E. & DOUGLAS G. THAYER,
TRS OF THE M-D REALTY TRUST
P.O. BOX 196400
CAMBRIDGE, MA 02140

177-55 THUMM, ANGELIKA REINSBURG STR 129 70197 STUTTGART, _ _

177-55 CARDELLICHIO, PETER A 7 ARLINGTON ST #44 CAMBRIDGE, MA 02140

177-55 YANG, CHIANHWA 7 ARLINGTON ST #47 CAMBRIDGE, MA 02140

177-55 EKSTROM, GORAN A. 7 ARLINGTON ST #52 CAMBRIDGE, MA 02140

177-55 STONEWELL, CAROLYN & BRIAN STONEWELL 7 ARLINGTON ST #56 CAMBRIDGE, MA 02140

31-B-3 & B-4 MAREK JITKA 57 ROSELAND ST. #3 SOMERVILLE, MA 02143

JEFFREY L. BROWN TR. OF SPRING MOUNTAIN REALTY TR. 691 MASS AVENUE – SUITE 3 ARLINGTON. MA 02476

31-B-5-5 & 5-6 EMILY M. BAILEY 105 LEXINGTON ST. CAMBRIDGE, MA 02138 153-3-4 FARRINGTON REALTY LLC, 28 ROSELAND ST., #1 CAMBRIDGE, MA 02140

177-55
OLBERT, STANISLAW & NORMA L. OLBERT
TRUSTEE STANISLAW & NORMA L. OLBERT TR.
7 ARLINGTON ST., UNIT #36
CAMBRIDGE, MA 02140

177-55 ROBERTS, KAY G. 7 ARLINGTON ST #42 CAMBRIDGE, MA 02140

177-55 VU, LIM DINH & NGA HONG LY 7 ARLINGTON ST. UNIT#45 CAMBRIDGE, MA 02140

177-55
GILES, RICHARD H. & SUZANNE E. LAKE, TRS OF
ARLINGTON OXFORD REALTY TRUST
36 SPRING RD
CONCORD, MA 01742

177-55 CHAN, SZE HAM 7 ARLINGTON ST. UNIT#54 CAMBRIDGE, MA 02140

MBTA C/O MARK DOYLE R.E. DIRECTOR 10 PARK PLAZA – SUITE 5720 BOSTON, MA 02116

31-B-5-1 ANTHONY DANGERFIELD 5 JOHNSON ROAD MEDFORD, MA 02155

TRINCA LLC 30 NEWBERNE ST. #1 SOMERVILLE, MA 02144

31-B-5-7 & 5-8 THEODORE P. WASIK & TRACEY A. DECHERT, MD 20 ALBION PL. CHARLESTOWN, MA 02129 177-55 MCNULTY JAMES P. & SIRI C. STEINLE 210 GARDEN ST CAMBRIDGE, MA 02138

177-55 PALMER, ALBERT S. 7 ARLINGTON ST #37 CAMBRIDGE, MA 02140

177-55 ROBERTS, KAY GEORGE 7 ARLINGTON ST #43 CAMBRIDGE, MA 02140

177-55 HYRA, BARBARA K. 7 ARLINGTON ST #46 CAMBRIDGE, MA 02140

177-55 EKSTROM, GORAN A. 7 ARLINGTON ST #52 CAMBRIDGE, MA 02140

177-55 LU, JIANJUN & YANKANG JIANG 51 AMBERWOOD DR. WINCHESTER, MA 01890

31-B-1 & B-2 LESLEY COLLEGE 29 EVERETT STREET CAMBRIDGE, MA 02138

31-B-5-10 JOHN & JENNIFER GOTTLIEB 401 WASHINGTON ST. SOMERVILLE, MA 02143

JAMES M. IGOE, III 40 SKEHAN ST. SOMERVILLE, MA 02143

ZOE LANGOSY TR. OF TN TRUST 20 CHILTON ST. #3 CAMBRIDGE, MA 02138

Location ROSELAND ST

Mblu 31/B/1/952

Acct# 19611020

Owner LESLEY COLLEGE

Assessment \$158,600

PID 328

Building Count 1

Current Value

Assessment					
Valuation Year	Improvements	Land	Total		
2017	\$1,500	\$157,100	\$158,600		

Owner of Record

Owner

LESLEY COLLEGE

Co-Owner Address

29 EVERETT ST

CAMBRIDGE, MA 02138

Sale Price \$1

Certificate

Book & Page 25269/ 543

Sale Date

04/05/1995

Instrument 1F

Ownership History

Ownership History						
Owner	Sale Price	Certificate	Book & Page	Instrument	Sale Date	
LESLEY COLLEGE	\$1		25269/ 543	1F	04/05/1995	
LESLEY REALTY CORP	\$10		24763/ 155	1F	08/05/1994	
C D I A INC TRUSTEE	\$0					

Building Information

Building 1 : Section 1

Year Built:

Living Area:

0

Replacement Cost:

Building Percent

Good:

Replacement Cost

Less Depreciation:

\$0

Building Attributes				
Field Description				
Style	Outbuildings			
Model				
Grade:				

Building Photo

Location 57 ROSELAND ST

Mblu 31/ B/ 3/ / B 4

Acct# 18572090

Owner MAREK JITKA

Assessment \$889,100

PID 6085

Building Count 1

Current Value

	Assessment		
Valuation Year	Improvements	Land	Total
2017	\$393,900	\$495,200	\$889,100

Owner of Record

Owner

MAREK JITKA

Co-Owner Address

57 ROSELAND ST 3

SOMERVILLE, MA 02143

Sale Price

\$314,000

Certificate

Book & Page 21567/ 082 Sale Date 11/27/1991

Instrument A

Ownership History

Ownership History						
Owner	Sale Price	Certificate	Book & Page	Instrument	Sale Date	
MAREK JITKA	\$314,000		21567/ 082	A	11/27/1991	
FREDERIC RAPHAEL	\$0					

Building Information

Building 1 : Section 1

Year Built:

1860

Living Area:

3,364

Replacement Cost:

\$615,494

Building Percent

Good:

Replacement Cost

Less Depreciation:

\$393,900

Building Attributes			
Field	Description		
Style	3 fam Conv		
Model	Residential		
Grade:	Average +10		
Stories:	2 3/4 Stories		

Building Photo

Location 61 ROSELAND ST #1

Mblu 31/ B/ 5/ 1/

Acct# 20131100

Owner DANGERFIELD ANTHONY

Assessment \$110,700

PID 110218

Building Count 1

Current Value

Assessment					
Valuation Year	Improvements	Land	Total		
2017	\$110,700	\$0	\$110,700		

Owner of Record

Owner

DANGERFIELD ANTHONY

Sale Price

\$99,000

Co-Owner Address

5 JOHNSON RD

Certificate

MEDFORD, MA 02155

Book & Page 56921/151

,,,

Sale Date 05/31/2011

Building Photo

Instrument 00

Ownership History

Ownership History					
Owner	Sale Price	Certificate	Book & Page	Instrument	Sale Date
DANGERFIELD ANTHONY	\$99,000		56921/ 151	00	05/31/2011
BEAUDET DOUGLAS S	\$480,000		54931/ 211	1P	07/01/2010

Building Information

Building 1: Section 1

Year Built:

2010

Living Area:

207

Replacement Cost:

\$97,569

Building Percent

100

Good:

Replacement Cost

Less Depreciation:

\$109,600

Building Attributes			
Fleld Description			
STYLE	Condo Office		
MODEL	Com Condo		
Stories:	1		
Grade	Luxurious +		

Location 61 ROSELAND ST #10

Mblu 31/B/5/10/

Acct# 20131190

Owner GOTTLIEB JENNIFER & JOHN

Assessment \$97,700

PID 110227

Building Count 1

Current Value

Assessment				
Valuation Year	Improvements Land Total			
2017	\$97,700	\$0	\$97,700	

Owner of Record

Owner

GOTTLIEB JENNIFER & JOHN

Sale Price

\$80,000

Co-Owner Address

401 WASHINGTON ST

Certificate

Book & Page 56525/ 015

SOMERVILLE, MA 02143

Sale Date 02/25/2011

Building Photo

Instrument

Ownership History

Ownership History					
Owner	Sale Price	Certificate	Book & Page	Instrument	Sale Date
GOTTLIEB JENNIFER & JOHN	\$80,000		56525/ 015	00	02/25/2011
BEAUDET DOUGLAS S	\$480,000		54931/ 211	19	07/01/2010

Building Information

Building 1: Section 1

Year Built: Living Area: 2010

124 \$58,447

Replacement Cost:

Building Percent

100

Good:

Replacement Cost

Less Depreciation:

\$97,700

Building Attributes			
Field Description			
STYLE	Condo Office		
MODEL	Com Condo		
Stories:	1		
Grade	Luxurious +		

Location 61 ROSELAND ST #3

Mblu 31/B/5/3/

Acct# 20131120

Owner BROWN JEFFREY L TRUSTEE

Assessment \$74,000

PID 110220

Building Count 1

Current Value

Assessment				
Valuation Year	Improvements	Land	Tetal	
2017	\$74,000	\$0	\$74,000	

Owner of Record

Owner

Address

BROWN JEFFREY L TRUSTEE

Co-Owner SPRING MOUNTAIN REALTY TRUST

691 MASSACHUSETTS AVE SUITE #3

ARLINGTON, MA 02476

Sale Price \$65,000

Certificate

Book & Page 57223/ 458

Building Photo

Sale Date 07/29/2011

Instrument

Ownership History

Ownership History					
Owner Sale Price Certificate Book & Page Instrument Sale Da					
BROWN JEFFREY L TRUSTEE	\$65,000		57223/ 458	CO	07/29/2011
BEAUDET DOUGLAS S	\$480,000		54931/ 211	1P	07/01/2010

Building Information

Building 1: Section 1

Year Built:

2010

Living Area:

140

Replacement Cost:

\$65,989

Building Percent

100

Good:

Replacement Cost

Less Depreciation:

\$74,000

Building Attributes				
Field Description				
STYLE	Condo Office			
MODEL	Com Condo			
Stories:	i			
Grade	Luxurious +			

Location 61 ROSELAND ST #2

Mblu 31/ B/ 5/ 2/

Acct# 20131110

Owner TRINCA LLC

Assessment \$56,300

PID 110219

Building Count 1

Current Value

. Assessment					
Valuation Year Improvements Land Total					
2017	\$56,300	\$0	\$56,300		

Owner of Record

Owner TRINCA LLC

Sale Price Certificate

e \$40,000

Building Photo

Co-Owner Address

30 NEWBERNE ST #1

Book & Page 58601/250

SOMERVILLE, MA 02144

Sale Date 03/02/2012

Instrument 00

Ownership History

Ownership History						
Owner Sale Price Certificate Book & Page Instrument Sale Da						
TRINCA LLC	\$40,000		58601/ 250	00	03/02/2012	
BEAUDET DOUGLAS S	\$480,000		54931/ 211	1P	07/01/2010	
WOMANS MENTAL HEALTH COLLECTIVE INC	\$65,000		13698/ 567	1K	05/25/1979	

Building Information

Building 1: Section 1

Year Built:

2010

Living Area:

135 \$51,224

Replacement Cost: Building Percent

100

Good:

Replacement Cost

Less Depreciation:

\$56,300

Building Attributes				
Field Description				
STYLE	Condo Office			
MODEL	Com Condo			
Stories:	1			

Location 61 ROSELAND ST #4

Mblu 31/B/5/4/

Acct# 20131130

Owner IGOE III JAMES M

Assessment \$109,900

PID 110221

Building Count 1

Current Value

Assessment					
Valuation Year	Improvements Land Total				
2017	\$109,900	\$0	\$109,900		

Owner of Record

Owner

IGOE III JAMES M

SOMERVILLE, MA 02143

Sale Price

\$100,000

Co-Owner Address

40 SKEHAN ST

Certificate

Book & Page 56675/ 068 Sale Date

Building Photo

03/31/2011

Instrument

Ownership History

Ownership History					
Owner Sale Price Certificate Book & Page Instrument Sale Date					
IGOE III JAMES M	- \$100,000		56675/ 068	00	03/31/2011
BEAUDET DOUGLAS S	\$480,000		54931/ 211	19	07/01/2010

Building Information

Building 1: Section 1

Year Built:

2010

204

Living Area: Replacement Cost:

\$96,155

Building Percent

100

Good:

Replacement Cost

Less Depreciation:

\$108,100

Building Attributes				
Field Description				
STYLE	Condo Office			
MODEL	Com Condo			
Stories:	1			
Grade	Luxurious +			

Location 61 ROSELAND ST #5

Mblu 31/B/5/5/

Acct# 20131140

Owner BAILEY EMILY H

Assessment \$102,900

PID 110222

Building Count 1

Current Value

Assessment					
Valuation Year	Improvements Land Total				
2017	\$102,900	\$0	\$102,900		

Owner of Record

Owner

BAILEY EMILY H

Sale Price

\$215,000

Co-Owner Address

105 LEXINGTON ST

Certificate

CAMBRIDGE, MA 02138

Book & Page 56813/351

Sale Date

05/03/2011

Building Photo

Instrument 1G

Ownership History

Ownership History					
Owner	Sale Price	Certificate	· Book & Page	Instrument	Sale Date
BAILEY EMILY H	\$215,000		56813/ 351	1G	05/03/2011
BEAUDET DOUGLAS S	\$480,000		54931/ 211	19	07/01/2010

Building Information

Building 1: Section 1

Year Built:

2010

Living Area:

192

Replacement Cost:

\$90,499

Building Percent

100

Good:

Replacement Cost

Less Depreciation: \$

\$101,700

Building Attributes			
Field Description			
STYLE	Condo Office		
MODEL	Com Condo		
Stories:	1		
Grade	Luxurious +		

Location 61 ROSELAND ST #6

Mblu 31/B/5/6/

Acct# 20131150

Owner BAILEY EMILY H

Assessment \$89,400

PID 110223

Building Count 1

Current Value

Assessment				
Valuation Year Improvements Land Total				
201,7	\$89,400	\$0	\$89,400	

Owner of Record

Owner

BAILEY EMILY H

Sale Price

\$215,000

Co-Owner **Address**

105 LEXINGTON ST

Certificate

Book & Page 56813/351

CAMBRIDGE, MA 02138

Sale Date 05/03/2011

Building Photo

Instrument

Ownership History

Ownership History					
Owner	Sale Price	Certificate	Bock & Page	Instrument	Sale Date
BAILEY EMILY H	\$215,000		56813/ 351	1G	05/03/2011
BEAUDET DOUGLAS S	\$480,000		54931/ 211	1P	07/01/2010

Building Information

Building 1: Section 1

Year Built:

2010

169

Living Area: Replacement Cost:

\$79,658

Building Percent

100

Good:

Replacement Cost

Less Depreciation:

\$89,400

Building Attributes			
Field Description			
STYLE	Condo Office		
MODEL Com Condo			
Stories:	1		
Grade	Luxurious +		

Location 61 ROSELAND ST #7

Mblu 31/B/5/7/

Acct# 20131160

Owner WASIK MD THEODORE P

Assessment \$46,500

PID 110224

Building Count 1

Current Value

Assessment				
Valuation Year	Improvements	Land	Total	
2017	\$46,500	\$0	\$46,500	

Owner of Record

Owner

WASIK MD THEODORE P

Sale Price

\$150,000

Address

Co-Owner DECHERT MD TRACEY A 20 ALBION PL

Certificate

Book & Page 57090/481

CHARLESTOWN, MA 02129

Sale Date

07/01/2011

Building Photo

Instrument 1V

Ownership History

Ownership History					
Owner	Sale Price	Certificate	Book & Page	Instrument	Sale Date
WASIK MD THEODORE P	\$150,000		57090/ 481	1V	07/01/2011
BEAUDET DOUGLAS S	\$480,000		54931/ 211	1P	07/01/2010

Building Information

Building 1: Section 1

Year Built:

2010

Living Area:

88

Replacement Cost: \$41,479 **Building Percent** 100

Good:

Replacement Cost

Less Depreciation:

\$46,500

Building Attributes				
Field Description				
STYLE	Condo Office			
MODEL	Com Condo			
Stories:	1			
Grade	Luxurious +			

Location 61 ROSELAND ST #8

Mblu 31/ B/ 5/ 8/

Acct# 20131170

Owner WASIK MD THEODORE P

Assessment \$114,700

PID 110225

Building Count 1

Current Value

Assessment					
Valuation Year					
2017	\$114,700	•	\$114,700		

Owner of Record

Owner

WASIK MD THEODORE P

Co-Owner DECHERT MD TRACEY A

Address

20 ALBION PL

CHARLESTOWN, MA 02129

Sale Price \$150,000

Certificate

Book & Page 57090/481

Sale Date 07/01/2011

Building Photo

Instrument 1V

Ownership History

Ownership History					
Owner	Sale Price	Certificate	Book & Page	Instrument	Sale Date
WASIK MD THEODORE P	\$150,000		57090/ 481	1V	07/01/2011
BEAUDET DOUGLAS S	\$480,000		54931/ 211	1P	07/01/2010

Building Information

Building 1: Section 1

Year Built:

2010

Living Area:

217

Replacement Cost: Building Percent \$102,283 100

Good:

Replacement Cost

Less Depreciation:

\$114,700

Building Attributes				
Field Description				
STYLE	Condo Office			
MODEL	Corn Condo			
Stories:	1			
Grade	Luxurious +			

Location 61 ROSELAND ST #9

Mblu 31/B/5/9/

Acct# 20131180

Owner LANGOSY ZOE TRUSTEE

Assessment \$98,400

PID 110226

Building Count 1

Current Value

Assessment				
Valuation Year	Improvements	Land	Total	
2017	\$98,400	\$0	\$98,400	

Owner of Record

Owner

LANGOSY ZOE TRUSTEE

Co-Owner TN TRUST

Address 20 CHIL

20 CHILTON ST #3

CAMBRIDGE, MA 02138

Sale Price

Price \$100,000

Certificate

Book & Page 58147/ 509

Sale Date 12/22/2011

Building Photo

Instrument 00

Ownership History

Ownership History					
Owner Sale Price Certificate Book & Page Instrument					
LANGOSY ZOE TRUSTEE	\$100,000		58147/ 509	co	12/22/2011
BEAUDET DOUGLAS S	\$480,000		54931/ 211	1P	07/01/2010

Building Information

Building 1: Section 1

Year Built: Living Area: 2010

186

Replacement Cost: Building Percent \$87,671 100

Good:

Replacement Cost

Less Depreciation:

\$98,400

Building Attributes			
Field	Description		
STYLE	Condo Office		
MODEL	Com Condo		
Stories:	1		
Grade	Luxurious +		

000R BEACON ST

Location 000R BEACON ST

Mblu 31/B/5/A/

Acct# 20131200

Owner MBTA

Assessment \$158,000

PID 110228

Building Count 1

Current Value

Assessment					
Valuation Year	Improvements	Land	Total		
2017	\$0	\$158,000	\$158,000		

Owner of Record

Owner

MBTA

Co-Owner C/O MARK DOYLE R E DIRECTOR

Address

10 PARK PLAZA SUITE 5720

BOSTON, MA 02116

Sale Price

Certificate

Book & Page 00000/ 000

\$0

Sale Date

01/01/1970

Ownership History

Ownership History					
Owner	Sale Price	Certificate	Book & Page	Sale Date	
мвта	\$0		00000/ 000	01/01/1970	

Building Information

Building 1 : Section 1

Year Built:

Living Area:

0

Replacement Cost:

\$0

Building Percent

Good:

Replacement Cost

Less Depreciation:

\$0

Building Attributes				
Field	Description			
Style	Vacant Land			
Model				
Grade:				
Stories:				
Occupancy				
Futuring Well 1				

Building Photo



(http://images.vgsi.com/photos/SomervilleMAPhotos//default.