

CAMBRIDGE HOUSING **AUTHORITY**

OFFICE SPACE

675 Massachusetts Avenue Cambridge, MA 02139

Finegold Alexander + Associates Inc.

Architects 77 North Washington Stre T (617) 227 9272

Richmond So Engineers,

Structural Engineers 85 Main Street Watertown, MA 02472 T (617) 926 9300

RDK Engineers, Inc.

Mechanical/Plumbing Fire Protection Enginee Seport Center 70 Fargo Street, Suite 800 Boston, MA 02210 F (978) 428-0067

ART Engineering Corp. **Electrical Engineers**

or meteors

Worcester, MA 01603 F (508) 797-5130

Beals + Thomas

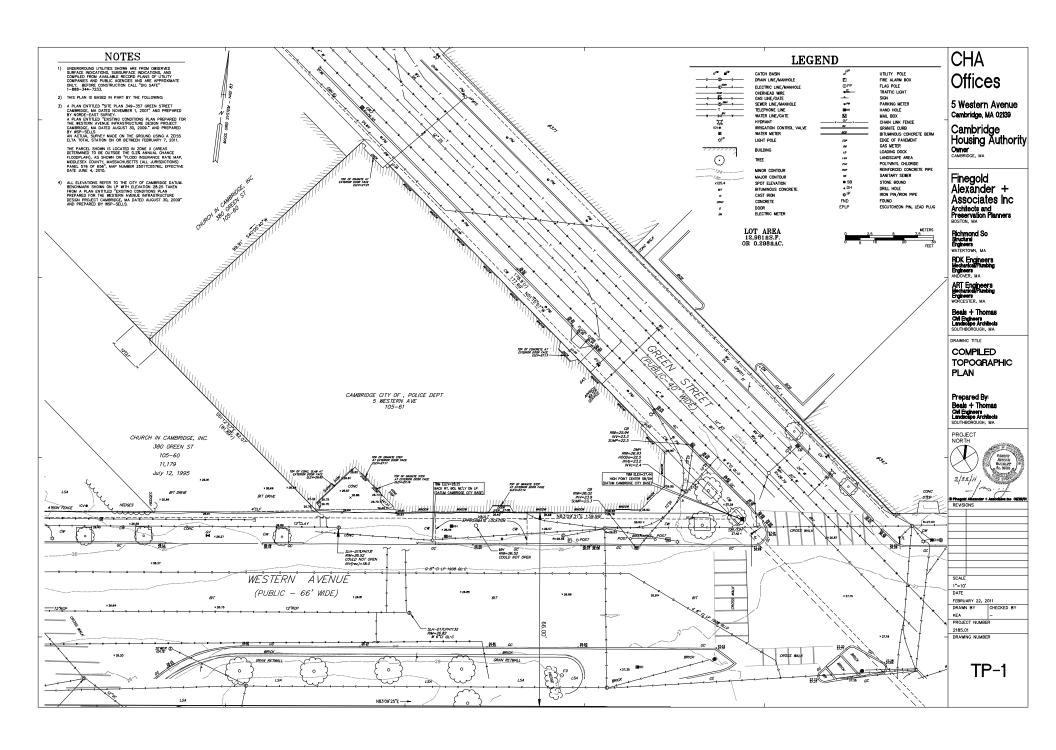
Civil Engineers/Landscape Architects Reservoir Corporate Center 144 Turnpike Road Southbarough, MA 01772 T (508) 366-0560

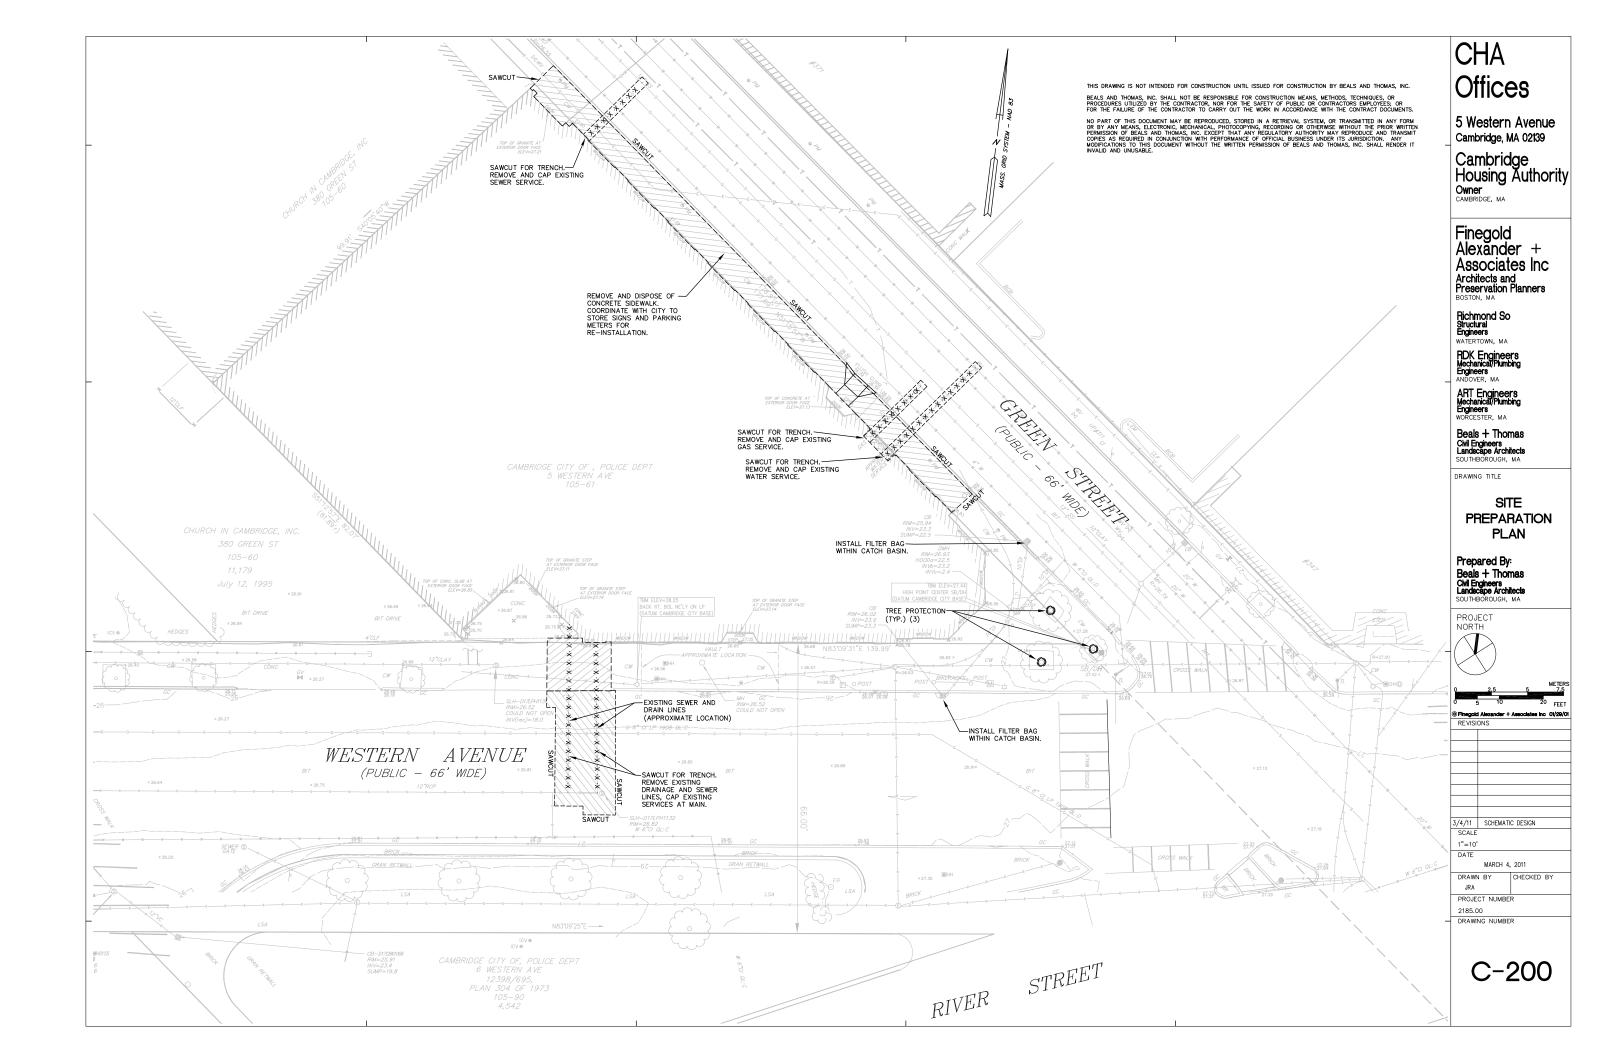
The Green Engineer, LLP

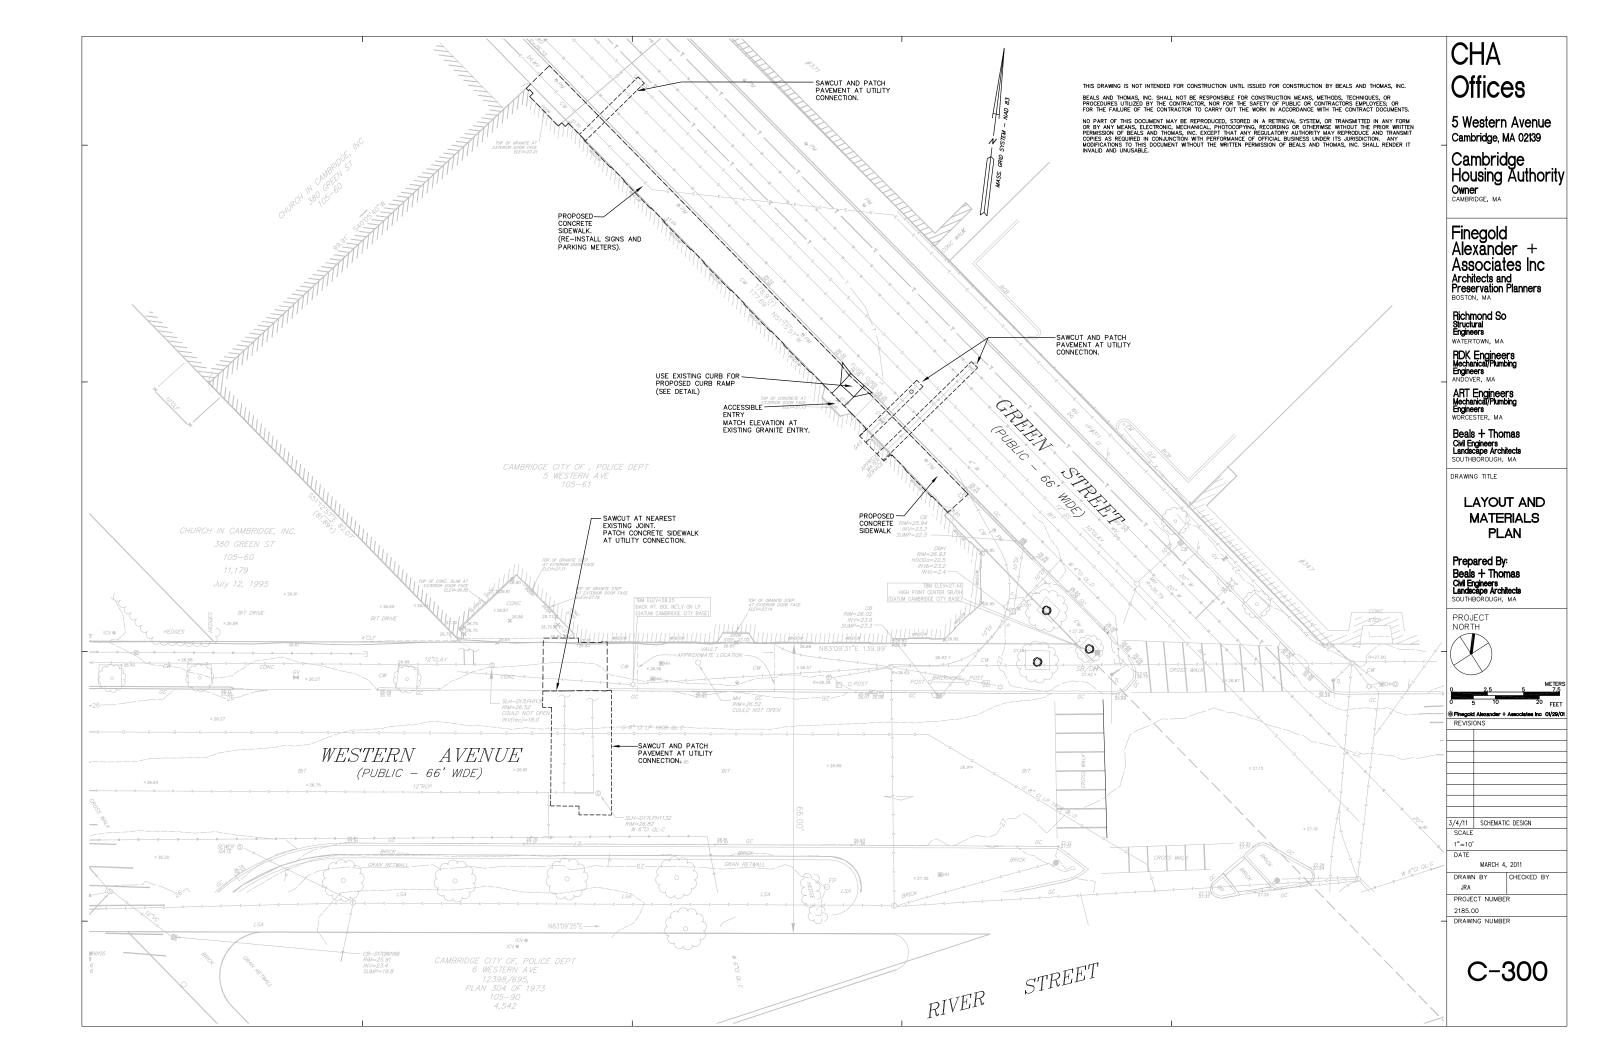
Green Design Consultant 50 Beharrell Street T (978) 369 8978

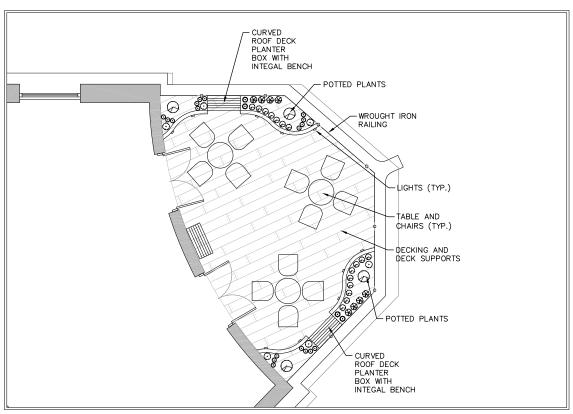






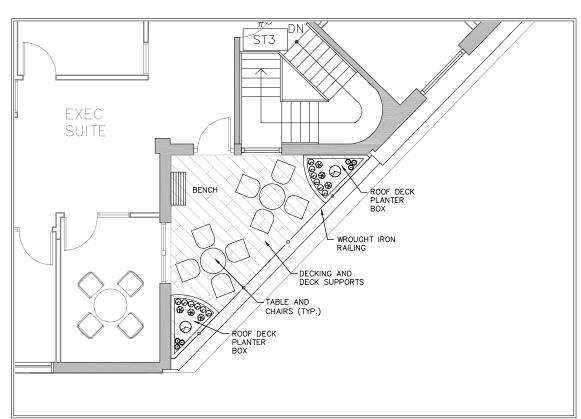






4TH. FLOOR TERRACE A





4TH. FLOOR TERRACE B





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CHA Offices

5 Western Avenue Cambridge, MA 02139

Cambridge Housing Authority

Owner CAMBRIDGE, MA

Finegold Alexander + Associates Inc Architects and Preservation Planners BOSTON, MA

Richmond So Structural Engineers WATERTOWN, MA

RDK Engineers Mechanical/Plumbing Engineers ANDOVER, MA

ART Engineers
Mechanical/Plumbing
Engineers
WORCESTER, MA

Beals + Thomas Civil Engineers Landscape Architects SOUTHBOROUGH, MA

DRAWING TITLE

LANDSCAPE PLAN 4TH. FLOOR TERRACE

Prepared By:
Beals + Thomas
Civil Engineers
Landscape Architects
SOUTHBOROUGH, MA

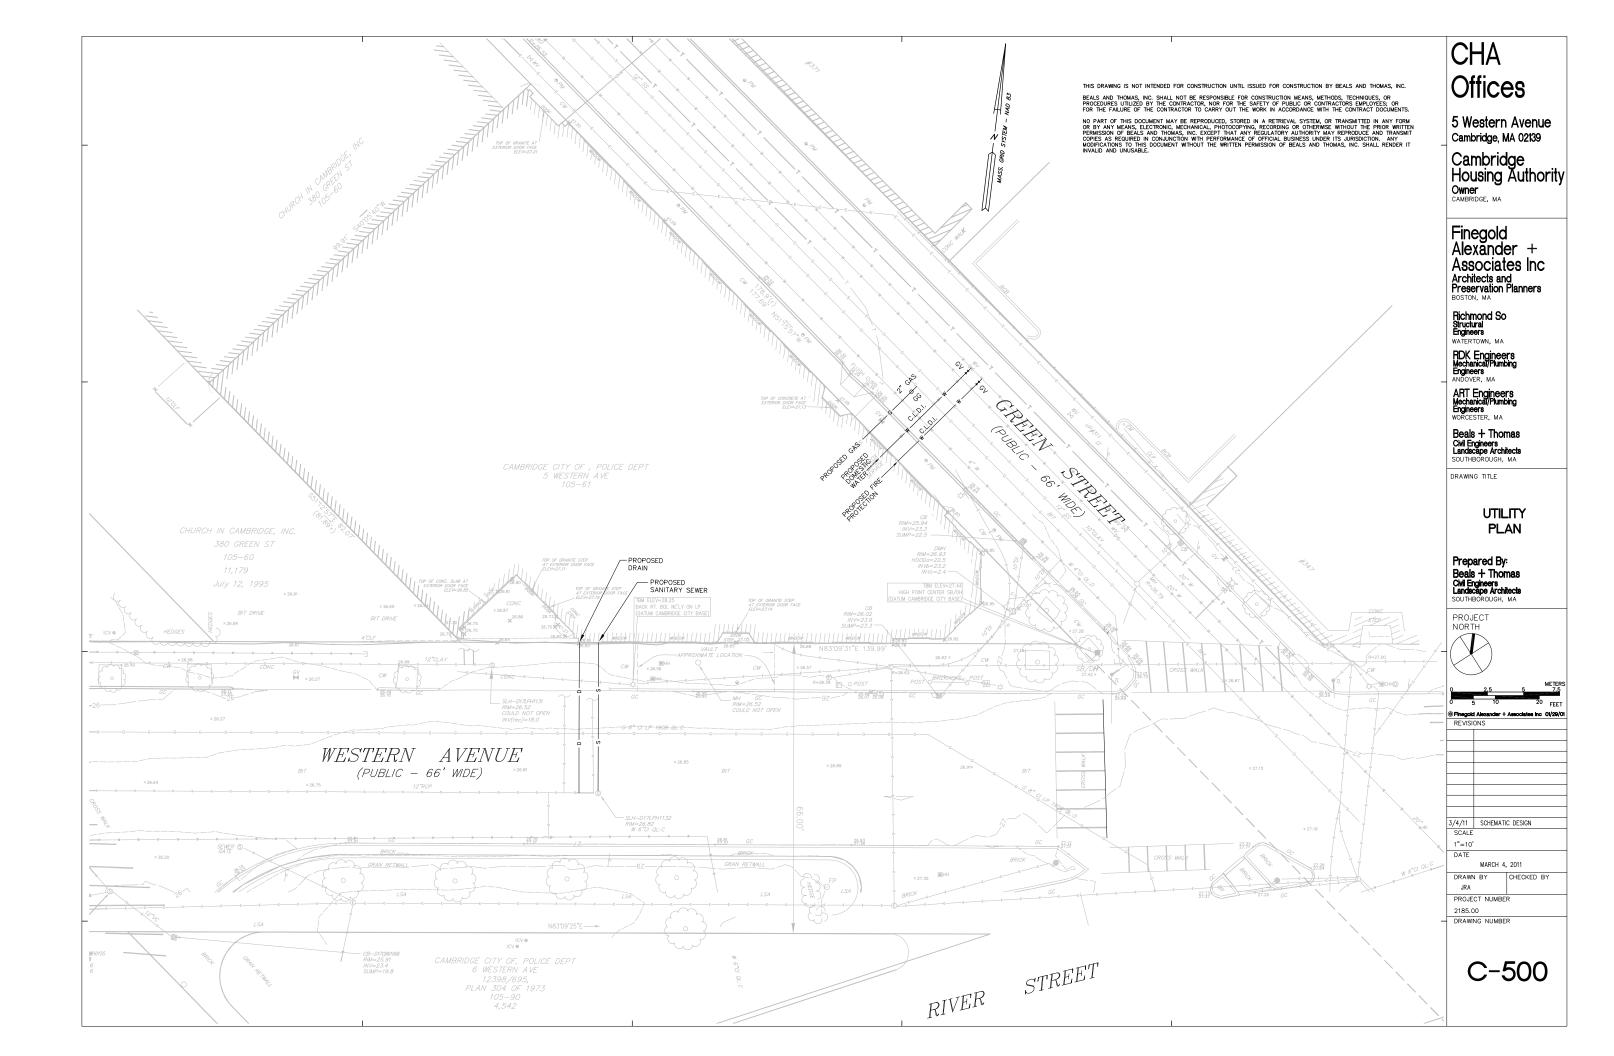
PROJECT

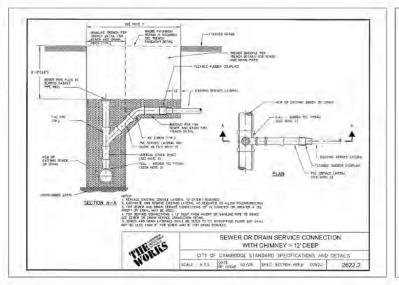
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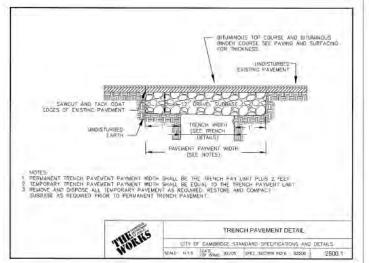
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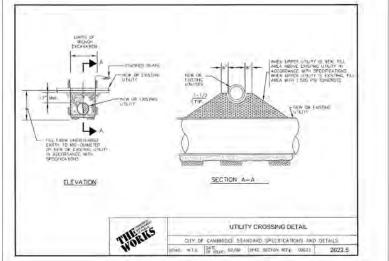
TERRACE MATERIAL SELECTION

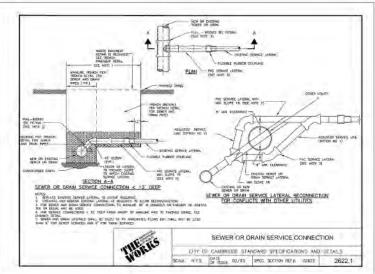
Key	Quantity	Item	Manufacturer	Description
	5	Tables	Landscape Forms, Kalamazoo, MI	Catena, Powdercoated silver, 30 Inch diameter, free standing model
	20	Chairs	Landscape Forms, Kalamazoo, MI	Catena, Powdercoated silver
	See Plan	Decking	Montreal Deck, www.montrealdeck.com	Softline, Merbeau,
	See Plan	Deck Supports	Montreal Deck, www.montrealdeck.com	Buzon, polypropylene terrace pedestal, DPH series
	4	Planter Boxes	City Decks New York, www.citydecksny.com	Custom built planter boxes and Integral bench,
	10	Planter Box Lights	Vibe Lighting, www.vibelighting.com	316 Marine Grade Stainless Steel Round LED Deck Light, Warm White
	See Plan	Ra ll ing		Wrought Iron Ralling, to be specified by Architect
	Allowance	Plantings		Potted Plants- Allowance \$1900 Corner- Corylus Avelana 'Contorta'
				Potted Plants to be Determined

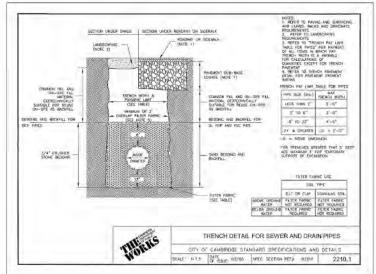


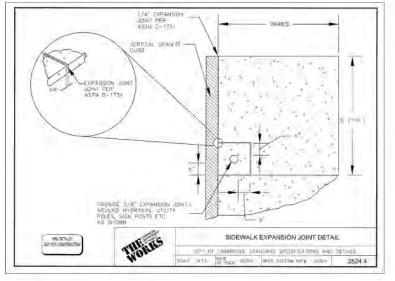


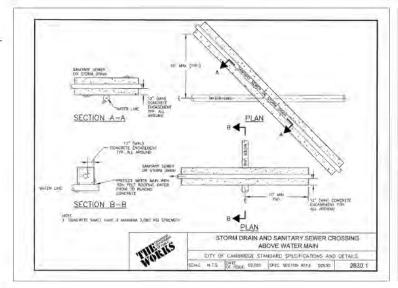


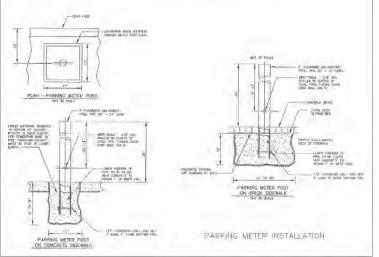














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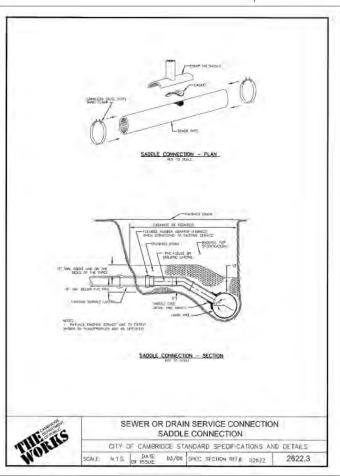
SITE DETAILS

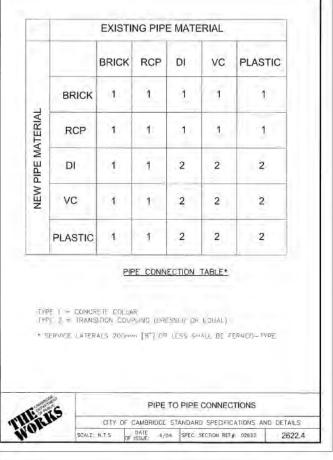
Prepared By: Beals + Thomas Civil Engineers Landscape Architects

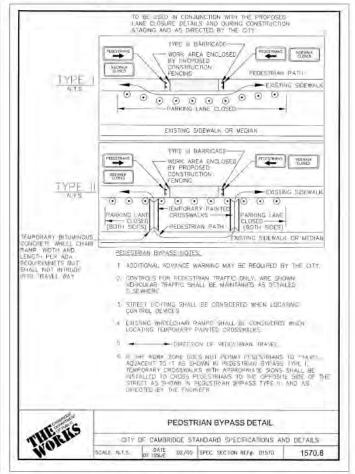


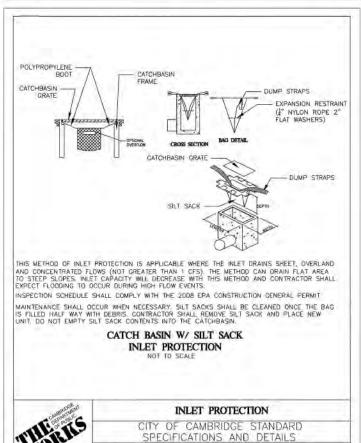
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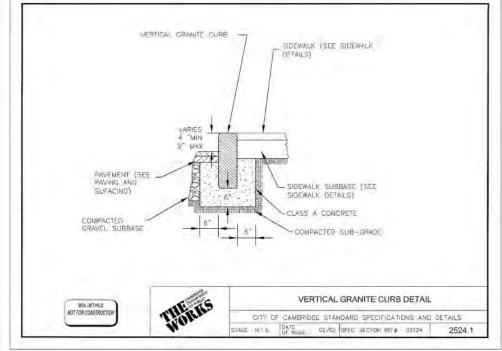








SCALE: N.T.S DATE: 07/09 DRAWN BY: McLANE



- PRIOR TO MAY LIVED DETURBANCE ACTIVITIES DOMERACING ON THE SITE THE OFFELDERS SHALL RHYDOLLY MANN LINES OF HIS LAND DETURBANCE ON HE SITE MON HAME, SEAR, OR GENARD, CONSTRUCTION FRAME, SE PART ROBOTS ON SECTION FOR THE SITE OF THE STATE, THE PHYSICAL HAPPINS SHALL REMAIN IN RIACE LAND. A CONTRICATE OF COMPACTION FACE INTO STATE, A CONTRICATE OF COMPACTION FACE INTO STATE.
- MINIST TOTAL AREA OF DISTURBANCE AND PROTECT MATERIAL FEATURES AND SO
- THE CONTRACTOR STALL SEQUENCE ALL ACTIVITIES TO ADMINISH SHALL AMERICAN OF DISTURBANCE WASS CLEARNESS AND DRADING OF THE DITING SIR SHALL HE AND OFFE.
- MANAGE SOIL ERICEION AND CONTROL SEGMENTATION DURING CONSTRUCTION
- CIVERT UNCONTAMINATED WATER ANDUNC DISTURBED WEAS
- HISTALL AND MANTAN ALL DROOM AND SERMINAY CONTING. MEASURES IN ACCORDANCE WITH THE MANNEAUTRICIES SPECIFICATIONS AND DECK DEPARTISHED. PRACTICES OF THE 2006 EVA'S CONSTITUTION COMPRAIL POWER.
- PROTECT AND MANAGE EN AND OFF-SITE MATERIAL STORAGE MEAS (CHERDUSCH AND STOCKFILLS OF BIFF, BURBOW MEAS, OR OTHER MEAS USED SOLET BY THE PERMITTED PROJECT AND CHERDUSCH A PART OF SIE
- COMPLY WITH APPLICABLE FEDERAL STATE AND ECOLAL LAWS AND SEGULATIONS INCLUDING WASTE DISPOSAL, SANIFARY SEMER ON SETTING SYSTEM REGULATIONS, AND ANI QUALITY REQUIREMENTS, MISLIGHTS DISTRICT.
- SEDMENT SHALL BE REMOVED DICKE THE VOLUME REACHES \$\(10 \) THE VERONT OF THE TROSPIN CONTROL OWNER SEDMENT SHALL BE DEMOVED FROM OUT TRUES PROPERTY OF REACHING THE LOAD-BEARING OWNERS TO SELECT MINION AND ILL LONG YEAR \$\(10 \) THE STALL TRUES MINION ON ILL LONG YEAR \$\(10 \) THE STALL TRUES MINION ON ILL LONG YEAR.
- SEDMENT TROM SEDMENT THINGS OR SEDMENTATION PONDS SHALL BE REMOVED WHEN SCHOOL DECK REMOVED BY SO PERCENT.
- SOR STOCKPLES WAST BE STABILIZED ON CONFISC AT THE END OF EACH WORKDAY, STOCKHE SIDE SLOPES SHALL NOT BE GREATER THAN 2.1 ALL STOCKPLES SHALL BE SURROUNDED BY SETMENT CONTROLS.
- TOR ACTIVE DESCRIPTION JAKEAS SUCH AS DEBROW OR STOOGREE AREAS, WORDMAY IMPROVEMENTS AND AREAS MINEN SO FEET OF A BUILDING WHOSE ONGSTRUCTION, A FERRETION REMINDER CHAMBOL STYLE IS SHALL BE RESTAULDED AND MARKETAND DE DOCUMENT.
- A THACAND PAG ON OTHER APPROVED STABLIZATION METHOD SHALL SE CONSTRUCTED AT ALL CHARACLECIST POINTS OF THE SITE TO REDUCE THE AMOUNT OF SIDE SARGED ONTO REMOMENS AND OFF THE SITE.
- IN THE CUT SDC OF ROADS, DIGITED SHALL BE STABLIZED AMEDIANELY WITH MOCK HITH HAP ON OTHER MOTHER (MARK), OR WARRE APPROPRIATE, ACCUTA NOT MEASURED SLOW AS HYDROSELLIAND ON JUTE MOTHER.
- 6. ALL SUPES STEEDED THAN ALL THE MASSES, AS WELL AS PROMETTED DIETS, STEEDER BACKS OF MENT, AND DEMONSTRATE WAS LOTED CONNECTED AT MEMORITARY OF MEASURED WITH SOO, SEED AND RECOVERED STANKING, MALCH OF CITIES APPROVED STANCESATION MEASURES AREAS CHISTED OF THE FERMATTER SCHMMIT CONTROL SYSTEM MASSES AND ASSESSMENT FOR THE FERMATTER SCHMMIT CONTROL.
- TEMPORARY SEDMENT TRAPPHOLDEWIES MUST NOT BE REMOVED UNTIL FORMARINT STABLIZATION IS INTRODUCED IN ALL CONTRIBUTIONY DRAWLASS, AREAS.
- JAL IDMONARY EROSON AND SEDMENT CONTROL MEASURES SHALL BE SEDONED AFTER FINAL SITE STABLEARING DISTURBED SOL AREAS RESELENCE FROM THE PRODUCT OF TEMPORARY MEASURES SHALL BE PROMISENCE STABLEZON STABLEZON OF THE SECOND STABLESON OF THE SECOND STAB
- 22. PREMINE DIT-SITE VEHICLE TRACKING OF SEGMENTS.
- 35 GUST SHALL HE CONTROLLED AT THE SITE
- ALL PREMODELY RESTRIBUTE LAND SHALL BE STABLUZED BY APPROVED METHODS AFTER 14 CAYS IN LEFT UNDERFORD. THE ACLURES STOCKNESS CONSTRUCTION DYTRANCES, DEAZED AFTER AND OTHER CONSTRUCTION ACTIVITY RELATED CREATING.
- S. IF MORE IS HALTED OVER WHITER MONTHS THE DONTRACTOR SHALL BE RESPONSIBLE FOR STABILIZATION THE



EROSION AND SEDIMENT CONTROL NOTES

CITY OF CAMBRIDGE STANDARD SPECIFICATIONS AND DETAILS

SCALE: N.T.S DATE: 07/09 DRAWN BY: MELANE

CHA Offices

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ART Engineers Mechanical/Plumbing Engineers WORCESTER, MA

Beals + Thomas Civil Engineers Landscape Architects

DRAWING TITLE

SITE **DETAILS**

Prepared By: Beals + Thomas Civil Engineers Landscape Architects



3/4/11 SCHEMATIC DESIGN SUALE AS NOTED MARCH 4, 2011 CHECKED BY PROJECT NUMBER J185 00. DRAWING NUMBER

C-601

LEGEND

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	ELECTRIC LINE/MANHOLE	⊙ FP	FLAG POLE		TREE	LD	LOADING DOCK
	OVERHEAD WIRE	o∏	TRAFFIC LIGHT		***************************************	LSA	LANDSCAPE AREA
- PY	GAS LINE/GATE		SIGN	124	MINOR CONTOUR	PIC	POLYVINYL CHLORIDE
sSM/_s	SEWER LINE/MANHOLE	eRf	PARKING METER		MAJOR CONTOUR	ROP	REINFORCED CONCRETE PIPE
— т — —	TELEPHONE LINE	39H	HAND HOLE	x125.4	SPOT ELEVATION	55	SANITARY SEWER
	WATER LINE/GATE	1.0	MAIL BOX	817	BITUMINOUS CONCRETE	m SB	STONE BOUND
X	HYDRANT	xGFx	CHAIN LINK FENCE	g	CAST IRON	» DH	DRILL HOLE
ICV 0	IRRIGATION CONTROL VALVE	oc .	GRANITE CURB	gawc	CONCRETE	oIP	IRON PIN/IRON PIPE
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1250	LIGHT POLE			-	ELECTRIC METER	FPI P	ESCUTCHEON PIN LEAD PLUG

NOTES

- UNDERGROUND UTILITIES SHOWN ARE FROM OBSERVED SUBFACE INDICATIONS, SUBSURFACE INDICATIONS, AND COMPALED FROM JAVILAGUE RECORD FLANS OF UTILITY COMPANIES AND PUBLIC AGENCIES AND ARE APPROXIMON. BEFORE CONSTRUCTION CALL "DIG SAFE" 1-888-344-7233.
- 2. INS POW IS DREAD IN PART OF THE PALLOWERS.

 A PLAN BUTTLED "SITE PLAN DAYS OF GREEN STREET CAMERICAE. MAD DATED MONUMER 1, 2001" AND PREPARED FOR THE RESTERN AROUN. PRANSTRUCTURE DESIGN FORCET CAMERICE. M. ACTUAL SHAPE AND PRANSTRUCTURE DESIGN PROJECT CAMERICAE. M. ACTUAL SHAPE AND ACTUAL SH
- THE PARCEL SHOWN IS LOCATED IN ZONE X (AREAS DETERMINED TO BE OUTSIDE THE 0.2% ANNUAL CHANCE FLOODPLAIN), AS SHOWN ON "FLOOD INSURANCE RATE MAP, MODILESEX COUNTY, MASSACHUSETTS (ALL JURISOCTIONS) PANEL 576 OF 656", MAP NUMBER 25017C0576E, EFFECTIVE DATE JUNE 4, 2010.
- 4) ALL ELVATONS REFER TO THE CITY OF CAMBRIDGE DATUM.
 BEICHAMNE SHORN ON IN MIT ELVATION SEZE TAKEN
 FROM A PLAN ENTITLED "ENSTRING CONDITIONS PLAY
 PREPARED FOR THE WESTERN AVERAGE INFRASTRUCTURE
 DESIGN PROJECT CAMBRIDGE, MA DATED AUGUST 30, 2009"
 AND PREPARED BY WEST-SELLS.

PROPOSED LEGEND:



GRADING, DRAINAGE AND UTILITY NOTES

UNDERGROUND UTILITIES WERE COMPLED FROM AVAILABLE RECORD PLANS OF UTILITY COMPANES AND PUBLIC ARTNOLS, ARE APPROXIMATE AND SSAURED. BEFORE COMMENDING SITE WORK IN ANY AREA, CONTACT TOIS SAFE" AT 1-888-344-7233 TO ACCURATELY LOCATE UNDERGROUND UTILITIES. ANY DAMAGE TO EXISTING UTILITIES OF STRUCTURES SHALL BE THE CONTRACTOR'S RESPONSIBILITY. NO EXCAVATION SHALL BE DONE ONLY UTULITY COMPANIES ARE PROPERTY MOTHED IN ADVANCE.

THE CONTRACTOR SHALL BE RESPONSIBLE FOR VERIFYING THAT THE PROPOSED IMPROVEMENTS SHOWN ON THE PLANS DO NOT CORFLICT WITH ANY YNOWING EXISTING OR OTHER PROPOSED IMPROVEMENTS. IF ANY CORFLICTS ARE DISCOVERED, THE CONTRACTOR SHALL NOTIFY, THE OWNER AND THE FIGHEER PRIOR TO INSTALLATION OF ANY PORTION OF THE SITE WORK WHICH WOULD BE AFFECTED.

AT ALL LOCATIONS WHERE EXISTING CURBING OR PAYMENT ABUTS NEW CONSTRUCTION, THE EDGE OF THE EXISTING CURB OR PAYMENT SHALL BE SAY CUT TO A CLEAN, SMOOTH EDGE. BLEND NEW PAYMENT, CURBS AND EARTHWORK SMOOTHLY INTO EXISTING BY WATCHING LINES, GRADES AND JOINTS. PITCH EVENLY BETWEEN SPOT GRADES. GRADE ALL AREAS TO DRAIN.

THE CONTRACTOR SHALL VERY CASHING GADES IN 16 FEILD AND REPORT ANY DISORPANCES METABOLISM TO BE DESCRIPTOR OF THE CONTRACTOR SHALL VERY CASHING GADES IN 16 FEILD AND REPORT ANY DISORPANCE IN THE CONTRACTOR OF T

ALL UTILITY COVERS, GRATES, ETC. SHALL BE ADJUSTED TO BE FLUSH WITH THE PAVEMENT FINISH GRADE UNLESS OTHERMISE NOTED. RIM ELEVATIONS OF DRAINAGE STRUCTURES AND SANITARY SEWER MANHOLES ARE APPROXIMATE.

CONTRACTOR SHALL PROTECT ALL UNDERGROUND DRAINAGE, SEWER AND UTILITY FACILITIES FROM EXCESSIVE VEHICULAR LOADS DURING CONSTRUCTION. ANY DAMAGE TO THESE FACILITIES RESULTING FROM CONSTRUCTION LOADS WILL BE RESTORED TO ORIGINAL CONDITION.

ABANDON/REMOVED UTILITY SERVICES ON SITE ACCORDING TO UTILITY COMPANY AND CITY OF CAMBRIDGE REQUIREMENTS.

EXCAVATION REQUIRED WITHIN THE PROXIMITY OF EXISTING UTILITY LINES SHALL BE DONE BY HAND. CONTRACTOR SHALL REPAIR ANY DAMAGE TO EXISTING UTILITY LINES OR STRUCTURES INCURRED DURING CONSTRUCTION OPERATIONS AT NO COST TO THE OWNER.

PITCH EVENLY BETWEEN SPOT GRADES. ALL PAVED AREAS MUST PITCH TO DRAIN AT A MINIMUM OF 1/8" PER FOOT UNLESS SPECIFIED. ANY DISCREPARIOES NOT ALLOWING THIS MINIMUM PITCH SHALL BE REPORTED TO THE ENGINEER PRIOR TO CONTINUING WORK.

THE CONTRACTOR SHALL SCHEDULE HIS MORK TO ALLOW THE INNEXED SUBGRADE ELEVATIONS. TO DRAIN PROPERLY WITHOUT PRODUNG, SPECIFICALLY, ALLOW MATER TO BESAPE WHERE PROPOSED CURR MY RETAIN RUNGEF PRIOR TO AFFLICATION OF THE FINISH SUBGRADE AND/OR SURFACE PAVING, PROVIDE TEMPORARY POSTINE DRAINAGE AS REQUIRED.

GENERAL NOTES

THE CONTRACTOR SHALL MAKE ALL NECESSARY CONSTRUCTION NOTIFICATIONS AND APPLY FOR AND OBTAIN ALL NECESSARY CONSTRUCTION PERMITS. THE CONTRACTOR SHALL ALSO PAY ALL FEES AND POST ALL BONDS ASSOCIATED WITH THE SAME, AND COORDINATE WITH THE ENSINEER AND ARCHITECT AS REQUIRED.

CONTRACTOR SHALL BE SOLELY RESPONSIBLE FOR JOB SITE SAFETY AND ALL CONSTRUCTION MEANS AND METHODS.

LIMIT OF WORK SHALL BE EROSION CONTROL BARRIERS, LIMIT OF GRADING AND SITE PROPERTY LINES AND/OR AS INDICATED ON DRAWINGS.

PORTIONS OF THE ABUTTING MULCH AREA DISTURBED BY THE CONTRACTOR'S OPERATIONS SHALL BE RESTORED TO THEIR CONDITIONS PRIOR TO DISTURBANCE. OBTAIN ABUTTER'S APPROVAL FOR WORK ON ADJACENT PROPERTY.

CONTRACTOR TO VERIFY UTILITY STUB LOCATIONS AND ELEVATIONS IN THE FIELD PRIOR TO COMMENCING

ANY ALTERATION TO THESE DRAWINGS MADE IN THE FIELD DURING CONSTRUCTION SHALL BE RECORDED BY THE CONTRACTOR ON RECORD DOCUMENTS.

FOR DRAWING LEGIBILITY, ALL EXISTING TOPOGRAPHIC FEATURES, EXISTING UTILITIES, PROPERTY BOUNDAMES, EASEMENTS, ETC. MAY NOT BE SHOWN ON ALL DRAWINGS. REFER TO ALL REFERENCED DRAWINGS AND OTHER DRAWINGS IN THIS SET FOR ADDITIONAL INFORMATION.

NEW EXCAVATION AND TRENCH SAFETY REGULATIONS ARE IN EFFECT AS OF MARCH 1, 2009.
(REFER TO 520 CMR 14.00) ALL EXCAVATORS OR CONTRACTORS MUST OBTAIN A TRENCH PERMIT
PRIOR TO ANY CONSTRUCTION RELATED TRENCHES ON SITE.

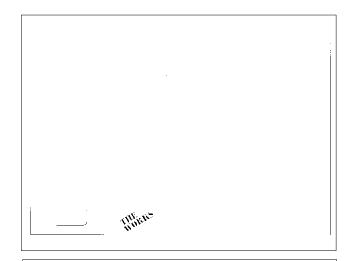
LAYOUT AND MATERIALS NOTES

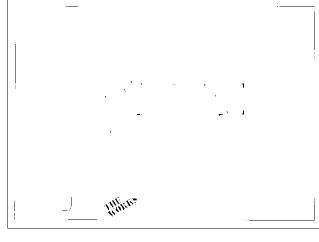
ALL LINES AND DIMENSIONS ARE PARALLEL OR PERPENDICULAR TO THE LINES FROM WHICH THEY ARE MEASURED UNLESS OTHERWISE INDICATED.

CONTRACTOR SHALL REPORT SIGNIFICANT CONFLICTS TO THE OWNER AND THE ENGINEER FOR RESOLUTION

THE CONTRACTOR SHALL NOTIFY THE ENGINEER OF ANY DISCREPANCIES BETWEEN SITE PLAN DIMENSIONS AND BUILDING PLANS BEFORE PROCEEDING WITH ANY PORTION OF SITE WORK WHICH MAY BE AFFECTED SO THAT PROPER ADJUSTMENTS TO THE SITE LAYOUT CAN BE MADE IF RECESSABLE.

ALL UTILITY WORK WITHIN THE RIGHT OF WAY SHALL COMPLY WITH THE CAMBRIDGE WATER DEPARTMENT SPECIFICATIONS, CITY OF CAMBRIDGE CONSTRUCTION AND OPERATING PROCEDURES.





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DRAWING TITLE

NOTES REFERENCES LEGEND AND DETAILS

Prepared By: Beals + Thomas Civil Engineers Landscape Architects SOUTHBOROUGH, MA

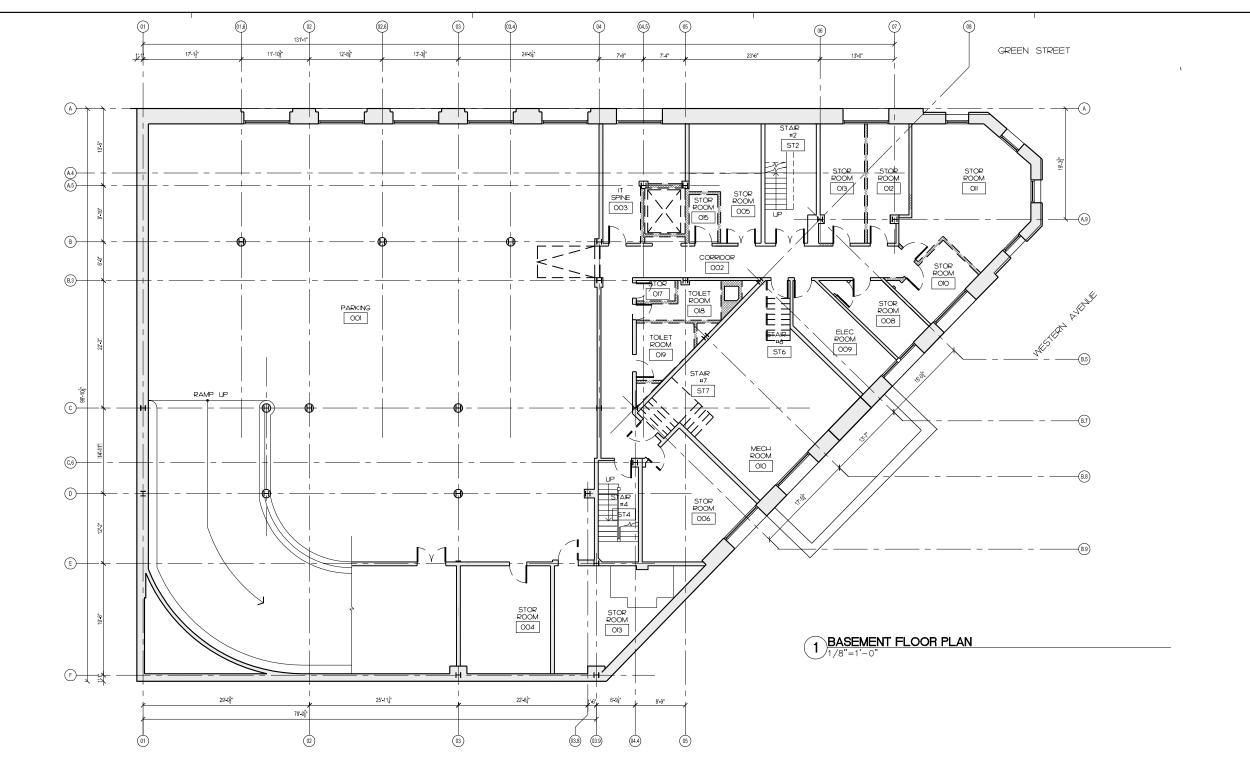
PROJECT NORTH

3/4/11 SCHEMATIC DESIGN SCALE AS NOTED MARCH 4, 2011 DRAWN BY CHECKED BY PROJECT NUMBER 2185.00 DRAWING NUMBER

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AREA OF EXIST, FLOOR SLAB TO BE DEMOLISHED FOR INSTALLATION OF NEW STAR, STRUCTURE, MECHANICAL OR PLUMBING

REMOVE EXISTING FINISHES AT DOWN TO EXISTING SUBSTRATE

DEMOLISH EXIST, STUD WALL - REFER TO DEMOLITION NOTES FOR FURTHER INFORMATION

EXIST, DOOR, FRAME, TRIM, THRESHOLD AND ASSOCIATED HARDWARE TO BE REMOVED

DEMOLISH EXIST, WINDOWS, FRAMES TRIM CASING AND ASSOCIATED HARDWARE

EXISTING MASONRY OR STUD WALL TO REMAIN

EXIST, MASONRY PARTITION OR PORTION THEREOF TO BE REMOVED

DEMOLITION GENERAL NOTES

L THE CONTRACTOR SHALL VERIFY ALL EXISTING CONDITIONS AND REVIEW 7, REMOVE ALL EXISTING MECHANICAL EQUIPMENT AND ACCESSORIES, WITH ALL TRADES THE EXTENT OF DEMOLITION REQUIRED,

2, THE CONTRACTOR SHALL PROTECT ALL MATERIALS AND EQUIPMENT NOTED TO REMAIN, ALL MATERIAL INDICATED TO BE SALVAGED OR RENSTALLED SHALL BE STORED AND PROTECTED FROM DAMAGE UNTIL READY TO BE PERMANENTLY REINSTALLED,

3. ALL MATERIAL INDICATED TO BE REMOVED SHALL BE DISPOSED OF IN ACCORDANCE WITH ALL APPLICABLE CODES AND LAWS, THE OWNER RETAINS THE RIGHT TO CLAM ANY EXISTING MATERIAL, SUCH MATERIAL SHALL BE PROTECTED FROM DAMAGE AND DELIVERED TO THE OWNER AS PER OWNER'S REQUIREMENTS.

4, PROVIDE ALL DEMOLITION WORK IN ORDER TO FACILITATE THE APPLICATION OF ALL NEW WORK, AT THE CONCLUSION OF ALL DEMOLITION LEAVE AREA FREE AND CLEAR, BROOM CLEAN FOR THE APPLICATION OF NEW WORK,

5. THE CONTRACTOR SHALL PROVIDE PROTECTION AROUND AND OVER ALL FLOOR OPENINGS, COORDINATE ALL NEW FLOOR OPENING DIMENSIONS WITH ARCHITECTURAL DRAWINGS,

6. PRIOR TO DEMOLITION ALL UTILITIES SHALL BE MADE SAFE, THEREAFTER, REMOVE ALL EXISTING ELECTRICAL EQUIPMENT AND ACCESSORIES.

- 8, REMOVE ALL EXISTING PLUMBING AND ACCESSORIES,

9. DEMOLITION REQUIRED FOR THE INSTALLATION OF MECHANICAL EQUIPMENT, PILLWBING, FRE PROTECTION AND ELECTRICAL SERVICES THROUGHOUT THE BUILDING NOT SPECIFICALLY SHOWN ON THE DEMOLITION DRAWINGS IS REQUIRED AND SHOULD BE COORDINATED WITH THE LOCATIONS OF THESE SERVICES AS SHOWN ON THEIR RESPECTIVE DRAWINGS AND IN THE PROJECT MANUAL,

IO, PROVIDE TEMPORARY STABILIZATION, SHORING AND BRACING DURINGOCOMMENCEMENT OF DEMOLITION AND NEW WORK, MAINTAIN TEMPORARY SHORING AND BRACING AS REQUIRED DURING CONSTRUCTION AND PLACEMENT OF NEW ELEMENTS, REFER TO STRUCTURAL DRAWINGS FOR ADDITIONAL NOTES AND DETAILS,

IL REMOVE ALL STUD FRAMED WALLS OR MASONRY WALLS AND ALL ATTACHED CONSTRUCTION FROM FLOOR TO UNDERSIDE OF STRUCTURE ABOVE AS INDICATED IN THE DEMOLITION PLANS,

12. REMOVE ALL EXISTING SUSPENDED/APPLIED CEILING FINISHES, SOFFITS AND ASSOCIATED HARDWARE UNLESS NOTED OTHERWISE.

13, REMOVE ALL EXISTING PLASTER, LATH, GWB ETC FINISHES AT ALL EXTERIOR WALLS DOWN TO MASONRY SUBSTRATE,

I4, ALL LOOSE FURNISHINGS AND EQUIPMENT LEFT IN PLACE PRIOR TO THE START OF DEWOLITION SHALL REMAIN THE PROPERTY OF THE OWNER UNLESS SO OTHERWISE DIRECTED,

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RDK Engineers Mechanical/Plumbing Engineers ANDOVER, MA

ART Engineers Electrical Engineers WORCESTER, MA

Beals + Thomas Civil Engineers Landscape Architects

DRAWING TITLE

BASEMENT LEVEL DEMOLITION PLAN

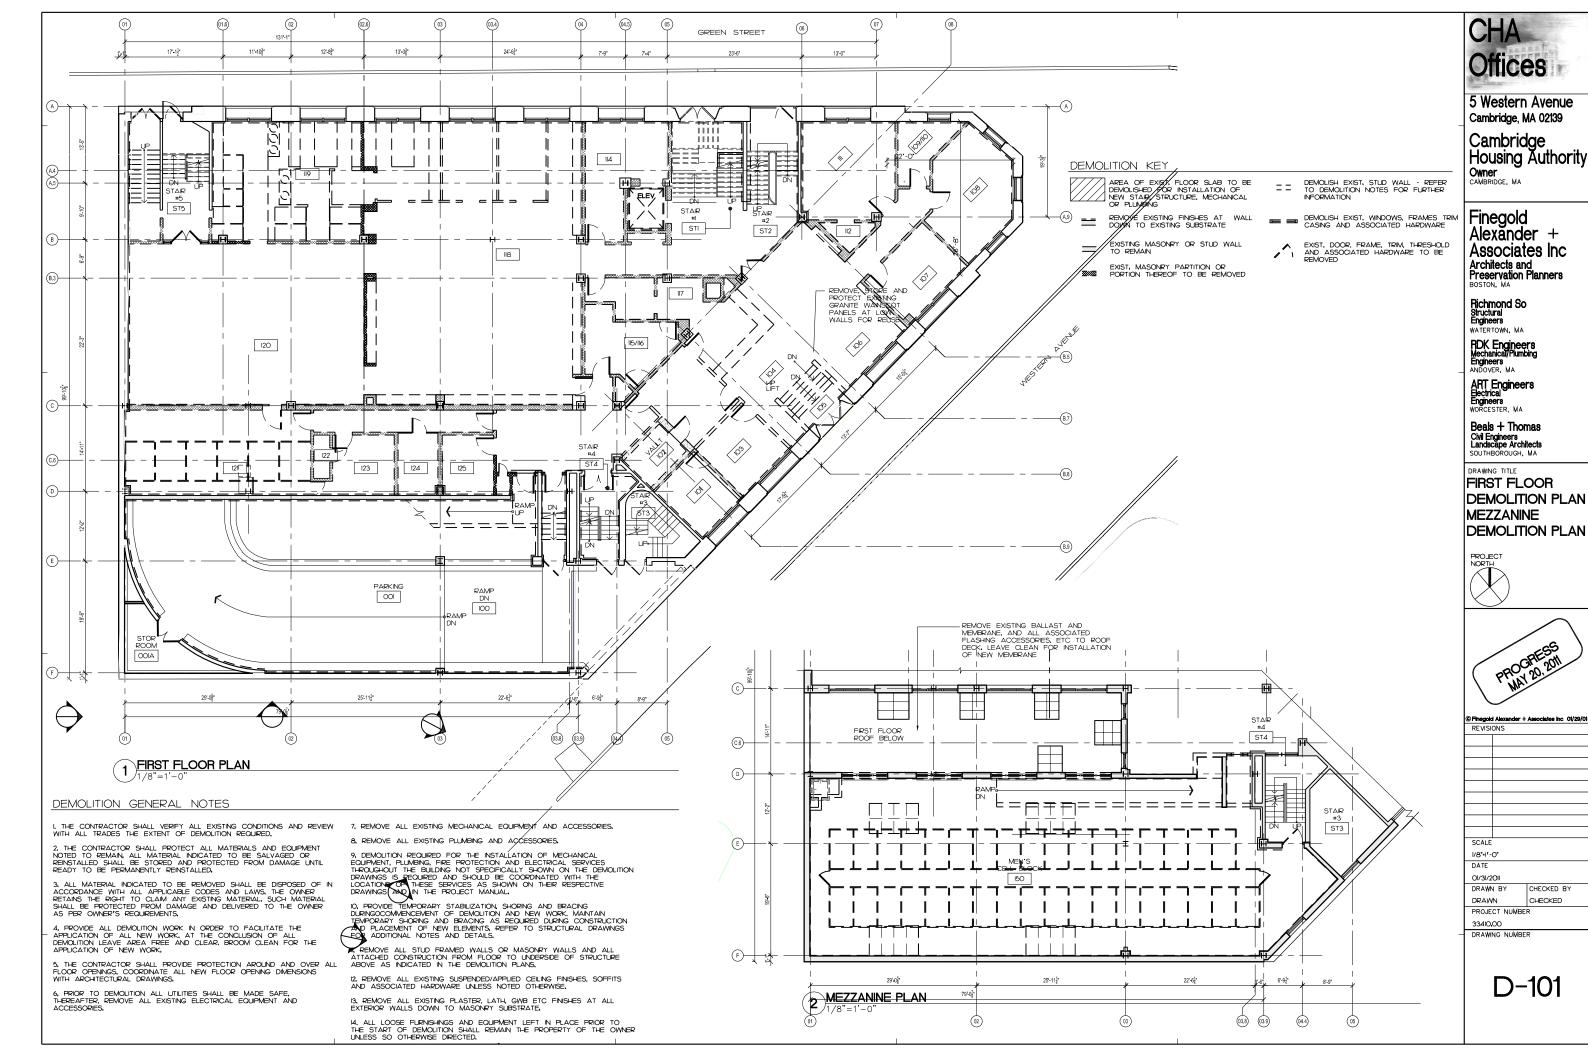


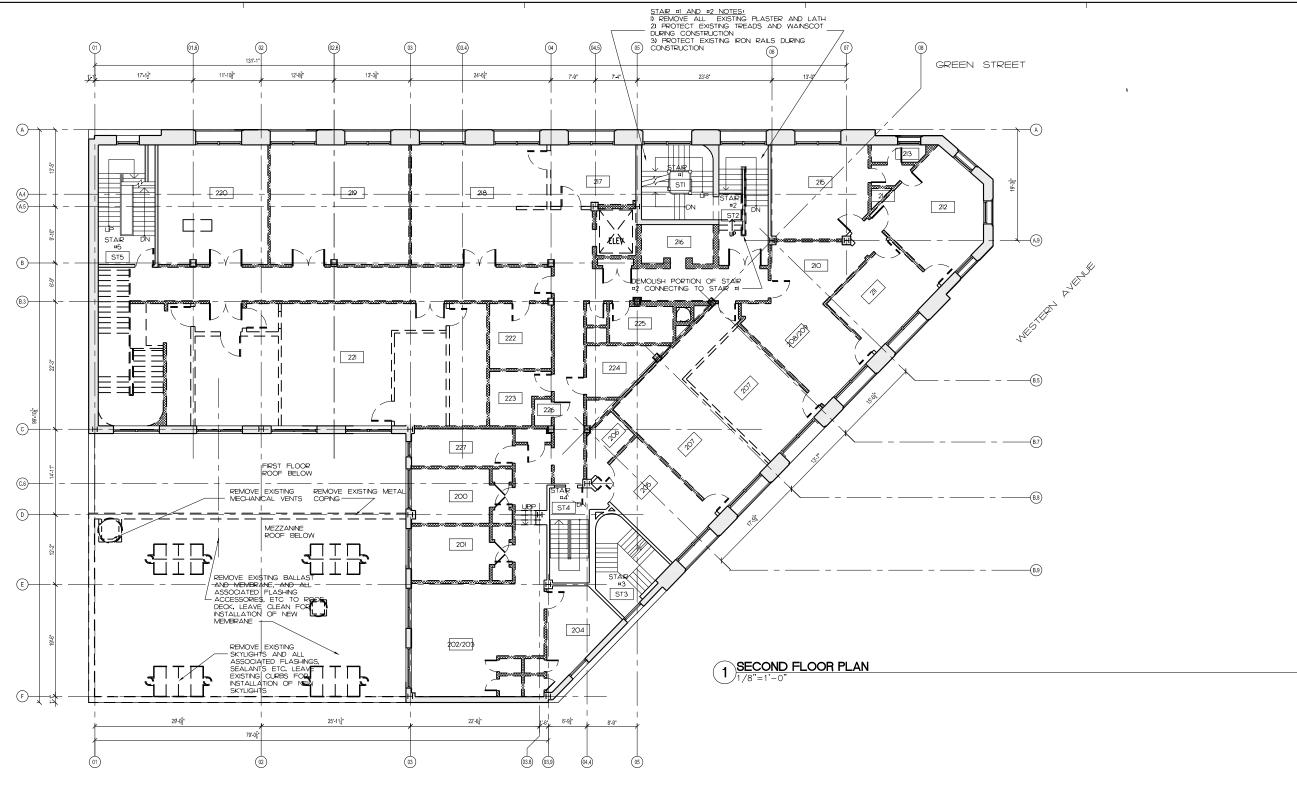


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DRAWING NUMBER





AREA OF EXIST, FLOOR SLAB TO BE DEMOLISHED FOR INSTALLATION OF NEW STAIR, STRUCTURE, MECHANICAL OR PLUMBING

REMOVE EXISTING FINISHES AT WALL DOWN TO EXISTING SUBSTRATE

EXISTING MASONRY OR STUD WALL TO REMAIN

EXIST, MASONRY PARTITION OR PORTION THEREOF TO BE REMOVED

DEMOLISH EXIST, STUD WALL - REFER TO DEMOLITION NOTES FOR FURTHER INFORMATION

DEMOLISH EXIST, WINDOWS, FRAMES TRIM CASING AND ASSOCIATED HARDWARE

EXIST, DOOR, FRAME, TRIM, THRESHOLD AND ASSOCIATED HARDWARE TO BE REMOVED

DEMOLITION GENERAL NOTES

I, THE CONTRACTOR SHALL VERIFY ALL EXISTING CONDITIONS AND REVIEW WITH ALL TRADES THE EXTENT OF DEMOLITION REQUIRED,

2. THE CONTRACTOR SHALL PROTECT ALL MATERIALS AND EQUIPMENT NOTED TO REMAIN, ALL MATERIAL INDICATED TO BE SALVAGED OR REINSTALLED SHALL BE STORED AND PROTECTED FROM DAMAGE UNTIL READY TO BE PERMANENTLY REINSTALLED,

3, ALL MATERIAL INDICATED TO BE REMOVED SHALL BE DISPOSED OF IN ACCORDANCE WITH ALL APPLICABLE CODES AND LAWS, THE OWNER RETAINS THE RIGHT TO CLAIM ANY EXISTING MATERIAL, SUCH MATERIAL SHALL BE PROTECTED FROM DAMAGE AND DELIVERED TO THE OWNER AS PER OWNER'S REQUIREMENTS,

4, PROVIDE ALL DEMOLITION WORK IN ORDER TO FACILITATE THE APPLICATION OF ALL NEW WORK, AT THE CONCLUSION OF ALL DEMOLITION LEAVE AREA FREE AND CLEAR, BROOM CLEAN FOR THE APPLICATION OF NEW WORK,

5, THE CONTRACTOR SHALL PROVIDE PROTECTION AROUND AND OVER ALL FLOOR OPENINGS, COORDINATE ALL NEW FLOOR OPENING DIMENSIONS WITH ARCHITECTURAL DRAWINGS.

6, PRIOR TO DEWOLITION ALL UTILITIES SHALL BE MADE SAFE, THEREAFTER, REMOVE ALL EXISTING ELECTRICAL EQUIPMENT AND ACCESSORIES.

7. REMOVE ALL EXISTING MECHANICAL EQUIPMENT AND ACCESSORIES.

8, REMOVE ALL EXISTING PLUMBING AND ACCESSORIES,

9. DEMOLITION REQUIRED FOR THE INSTALLATION OF MECHANICAL EQUIPMENT, PILLWIBNG, FIRE PROTECTION AND ELECTRICAL SERVICES THROUGHOUT THE BUILDING NOT SPECIFICALLY SHOWN ON THE DEMOLITION DRAWINGS IS REQUIRED AND SHOULD BE COORDINATED WITH THE LOCATIONS OF THESE SERVICES AS SHOWN ON THEIR RESPECTIVE DRAWINGS AND IN THE PROJECT MANUAL.

IO, PROVIDE TEMPORARY STABILIZATION, SHORING AND BRACING DURINGOCOMMENCEMENT OF DEMOLITION AND NEW WORK, MAINTAIN TEMPORARY SHORING AND BRACING AS REQUIRED DURING CONSTRUCTION AND PLACEMENT OF NEW BLEWENTS, REFER TO STRUCTURAL DRAWINGS FOR ADDITIONAL NOTES AND DETAILS.

II, REMOVE ALL STUD FRAMED WALLS OR MASONRY WALLS AND ALL ATTACHED CONSTRUCTION FROM FLOOR TO UNDERSIDE OF STRUCTURE ABOVE AS INDICATED IN THE DEMOLITION PLANS,

12. REMOVE ALL EXISTING SUSPENDED/APPLIED CEILING FINISHES, SOFFITS AND ASSOCIATED HARDWARE UNLESS NOTED OTHERWISE, 13, REMOVE ALL EXISTING PLASTER, LATH, GWB ETC FINISHES AT ALL EXTERIOR WALLS DOWN TO MASONRY SUBSTRATE,

I4, ALL LOOSE FURNISHINGS AND EQUIPMENT LEFT IN PLACE PRIOR TO THE START OF DEMOLITION SHALL REMAIN THE PROPERTY OF THE OWNER

Offices

5 Western Avenue Cambridge, MA 02139

Cambridge Housing Authority Owner

Finegold Alexander + Associates Inc Architects and Preservation Planners

CAMBRIDGE, MA

Richmond So Structural Engineers WATERTOWN, MA

RDK Engineers Mechanical/Plumbing

ART Engineers Electrical Engineers Worcester, Ma

Beals + Thomas Civil Engineers Landscape Architects

DRAWING TITLE

SECOND FLOOR **DEMOLITION PLAN**

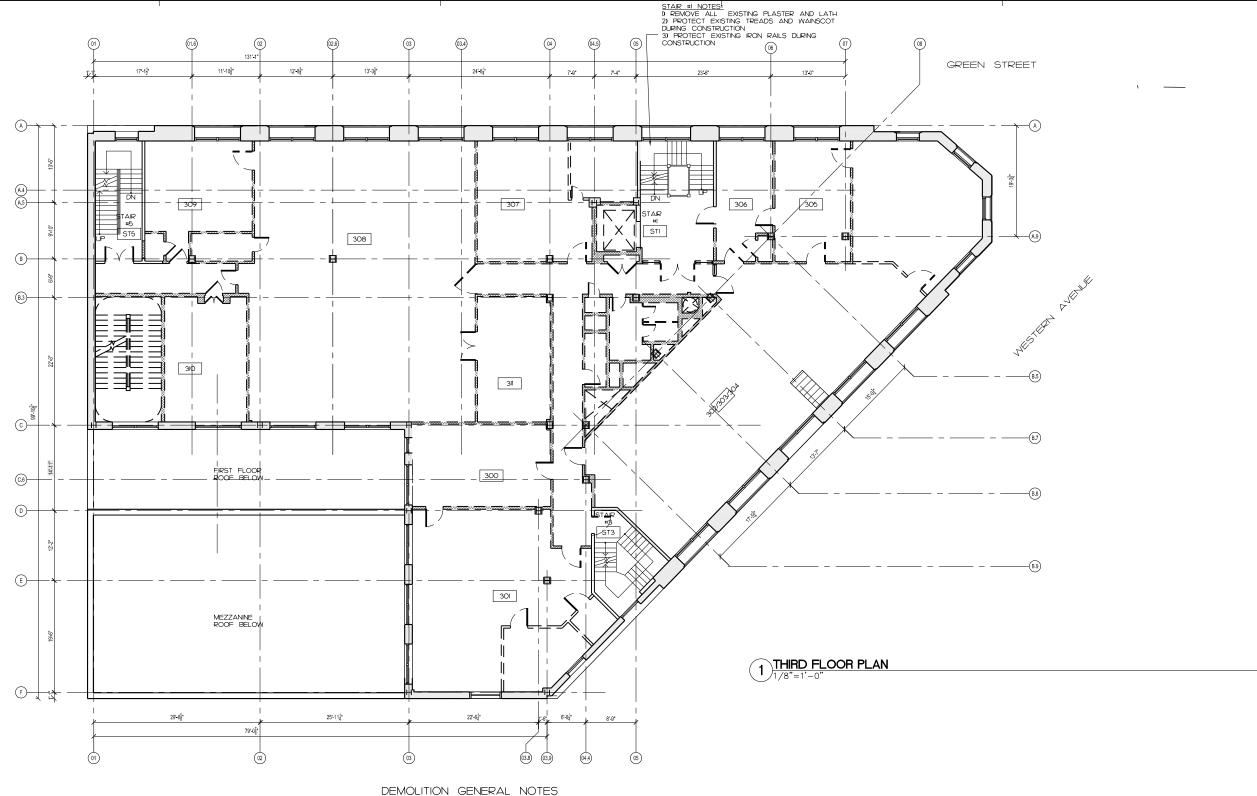




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AREA OF EXIST, FLOOR SLAB TO BE DEMOLISHED FOR INSTALLATION OF NEW STAR, STRUCTURE, MECHANICAL OR PLUMBING

REMOVE EXISTING FINISHES AT WALL DOWN TO EXISTING SUBSTRATE

EXISTING MASONRY OR STUD WALL TO REMAIN

EXIST, MASONRY PARTITION OR PORTION THEREOF TO BE REMOVED

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CHA Offices

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Cambridge Housing Authority

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Alexander +
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Architects and
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Boston, MA

Richmond So Structural Engineers WATERTOWN, MA

RDK Engineers Mechanical/Plumbing Engineers ANDOVER, MA

ART Engineers Electrical Engineers

Beals + Thomas
Civil Engineers
Landscape Architects
SOUTHBOROUGH, MA

DRAWING TITLE

THIRD FLOOR DEMOLITION PLAN



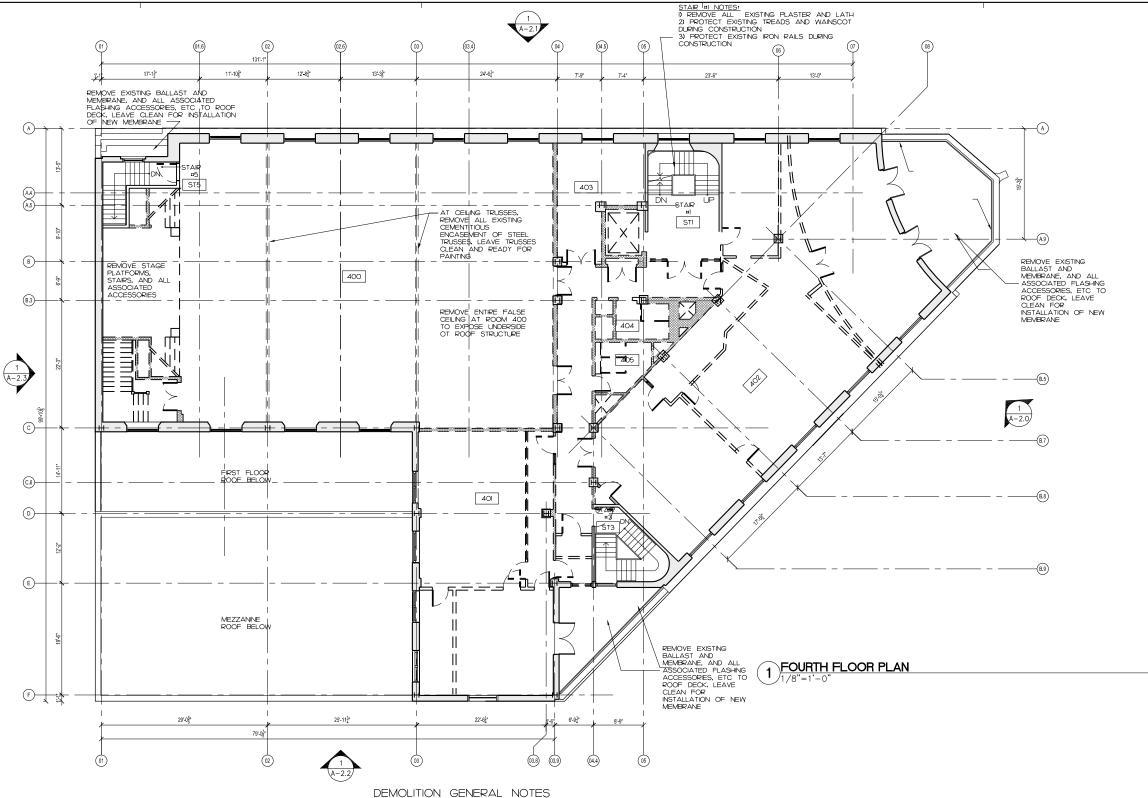


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AREA OF EXIST, FLOOR SLAB TO BE DEMOLISHED FOR INSTALLATION OF NEW STAIR, STRUCTURE, MECHANICAL OR PLUMBING

REMOVE EXISTING FINISHES AT WALL DOWN TO EXISTING SUBSTRATE

EXISTING MASONRY OR STUD WALL TO REMAIN

EXIST, MASONRY PARTITION OR PORTION THEREOF TO BE REMOVED

DEMOLISH EXIST, STUD WALL - REFER TO DEMOLITION NOTES FOR FURTHER INFORMATION

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Cambridge Housing **Authority** Owner

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WATERTOWN, MA

RDK Engineers Mechanical/Plumbing

ART Engineers Electrical Engineers WORCESTER, MA

Beals + Thomas Civil Engineers Landscape Architects

DRAWING TITLE

FOURTH FLOOR DEMOLITION **PLAN**



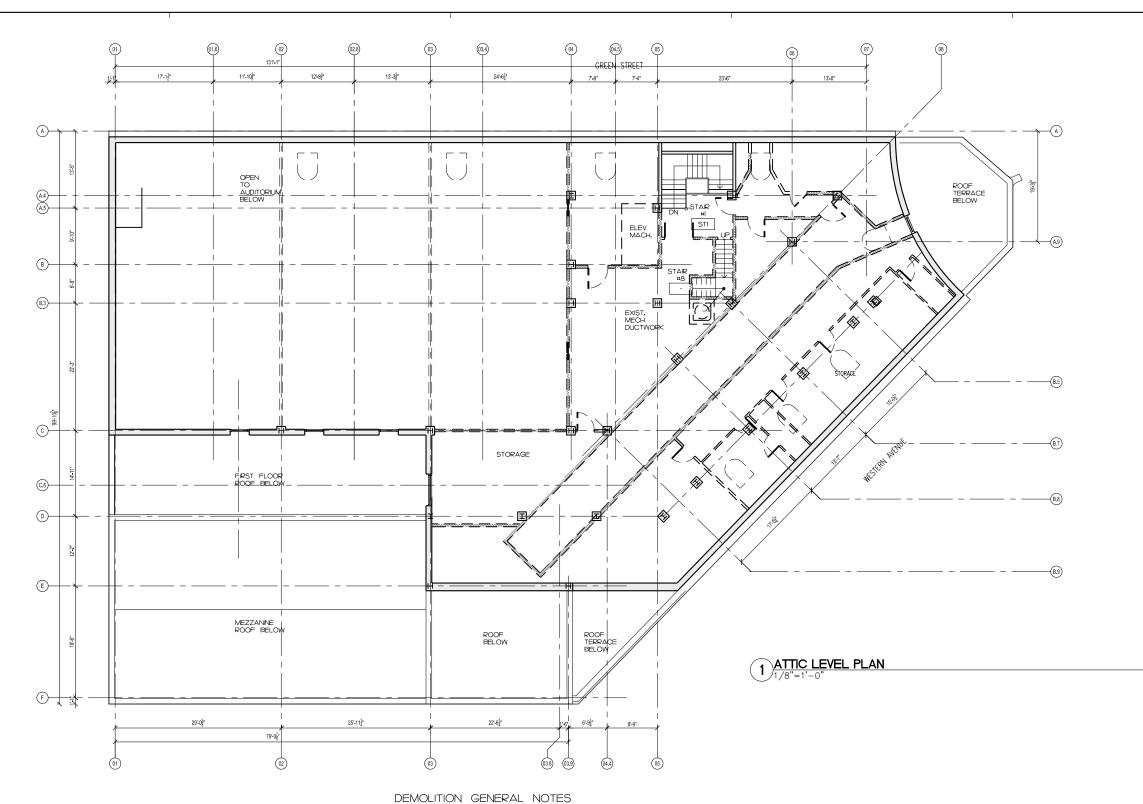


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AREA OF EXIST. FLOOR SLAB TO BE DEMOLISHED FOR INSTALLATION OF NEW STAIR, STRUCTURE, MECHANICAL

REMOVE EXISTING FINISHES AT WALL

EXISTING MASONRY OR STUD WALL TO REMAIN

EXIST, MASONRY PARTITION OR

PORTION THEREOF TO BE REMOVED

DEMOLISH EXIST, STUD WALL - REFER TO DEMOLITION NOTES FOR FURTHER

EXIST, DOOR, FRAME, TRIM, THRESHOLD AND ASSOCIATED HARDWARE TO BE REMOVED

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5 Western Avenue Cambridge, MA 02139

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CAMBRIDGE, MA

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Richmond So Structural Engineers WATERTOWN, MA

RDK Engineers Mechanical/Plumbing Engineers ANDOVER, MA

ART Engineers Electrical Engineers Worcester, Ma

Beals + Thomas Civil Engineers Landscape Architects

DRAWING TITLE

ATTIC LEVEL **DEMOLITION PLAN**

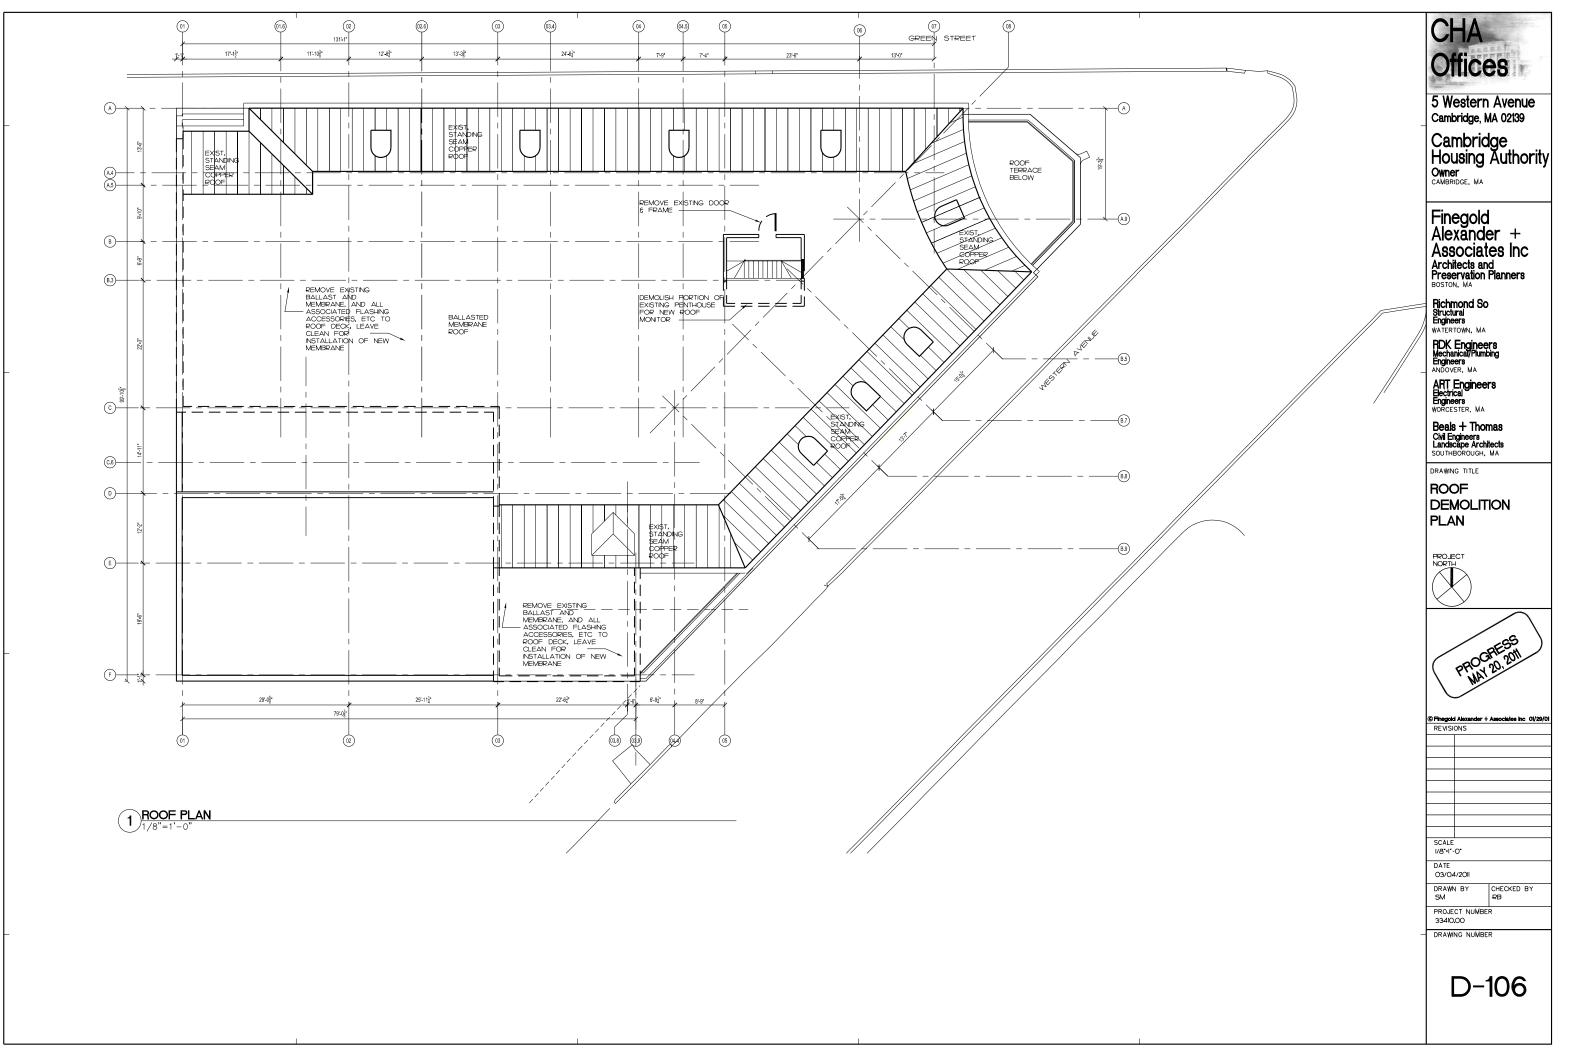


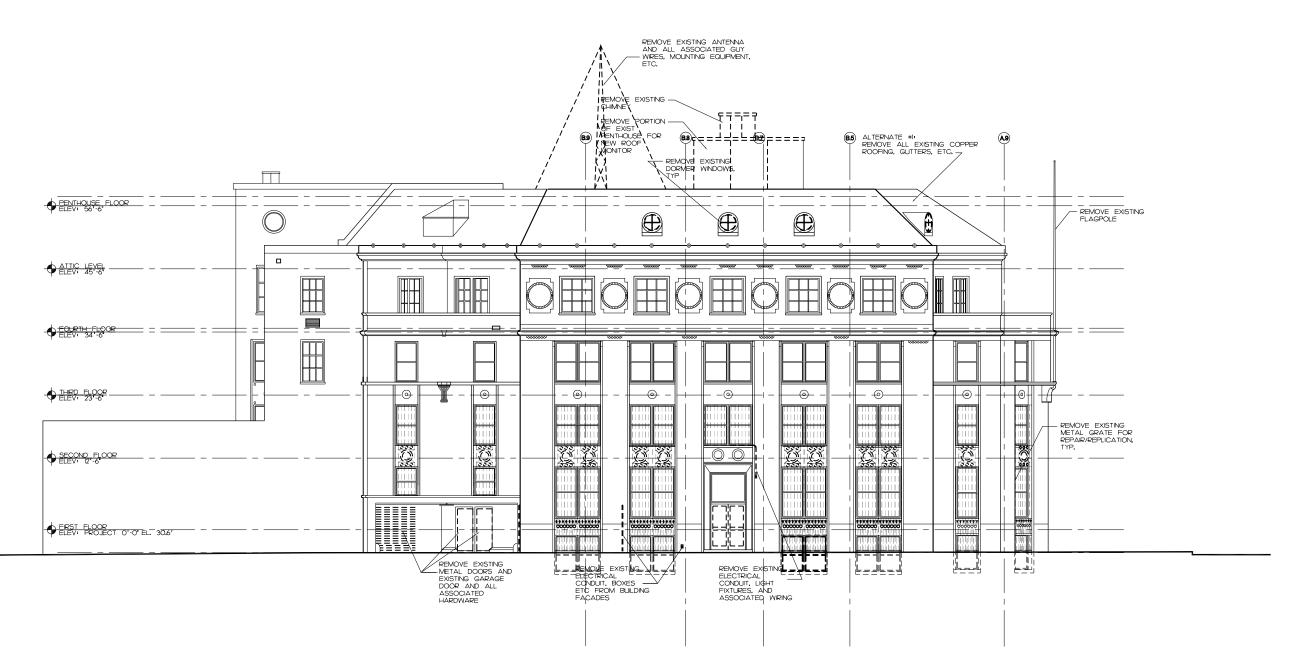


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DEMOLITION ELEVATION GENERAL NOTES

I, THE CONTRACTOR SHALL VERIFY ALL EXISTING CONDITIONS AND CONSTRUCTION REVIEW WITH ALL TRADES THE EXTENT OF DEMOLITION REQUIRED, HATCH PATTERNS ARE SHOWN FOR REPRESENTATION ONLY AND SHOULD NOT BE USED AS A MEANS FOR DETERMINING QUANTITIES.

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6, REMOVE EXISTING DOORS, FRAMES, TRIM, THRESHOLD AND ASSOCIATED HARDWARE WHERE INDICATED,

7, REMOVE EXISTING COPPER GUTTER, DOWNSPOUTS AND ASSOCIATED HARDWARE WHERE INDICATED,

8. REMOVE EXISTING DECORATIVE GRATE FOR RESTORATION/RECONSTRUCTION.

CHA Offices

5 Western Avenue Cambridge, MA 02139

Cambridge Housing Authority

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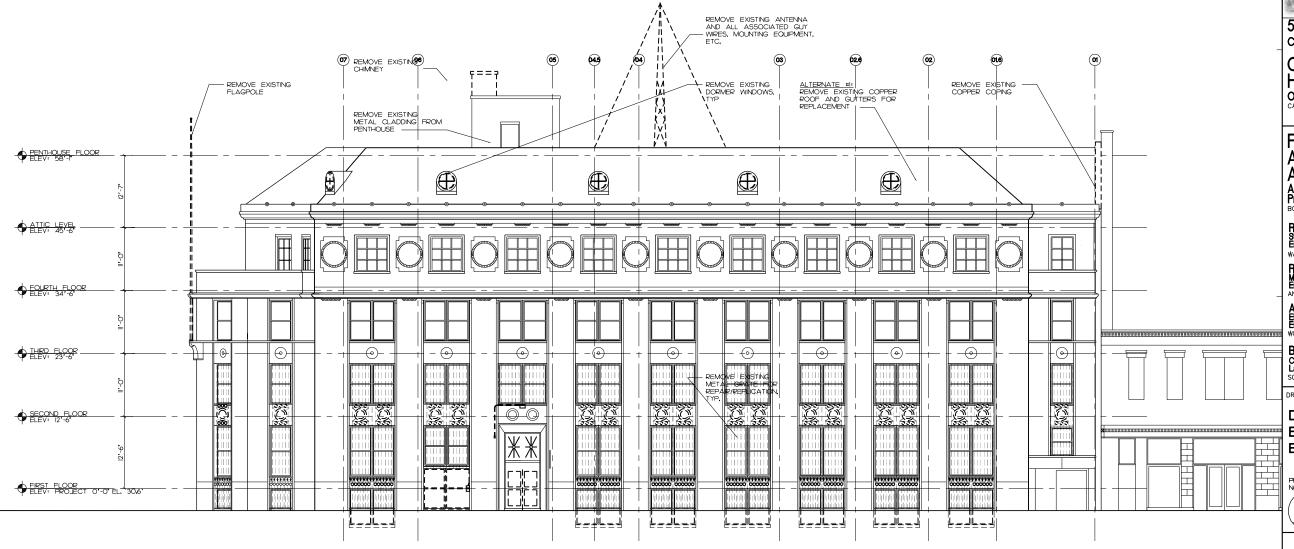
Beals + Thomas
Civil Engineers
Landscape Architects

DEMOLITION
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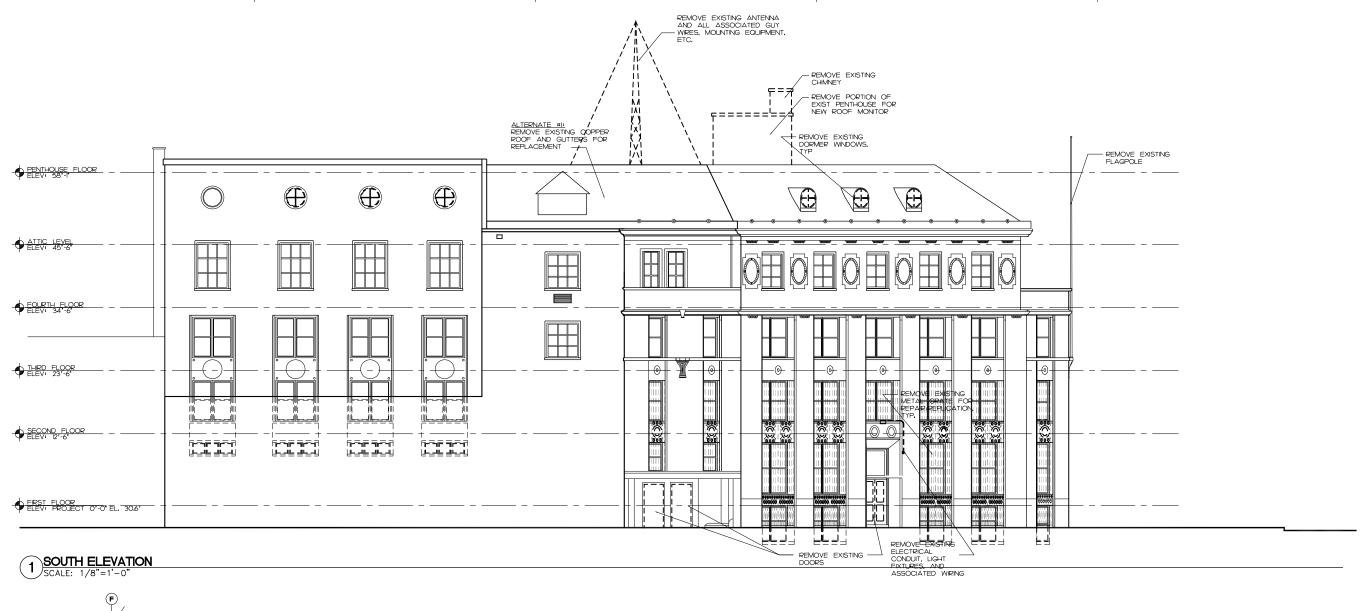
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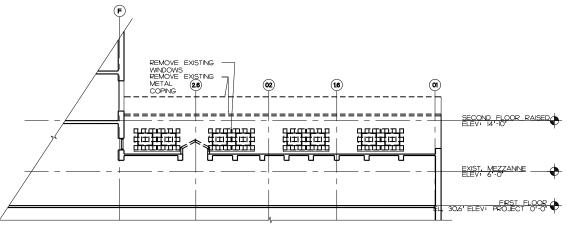
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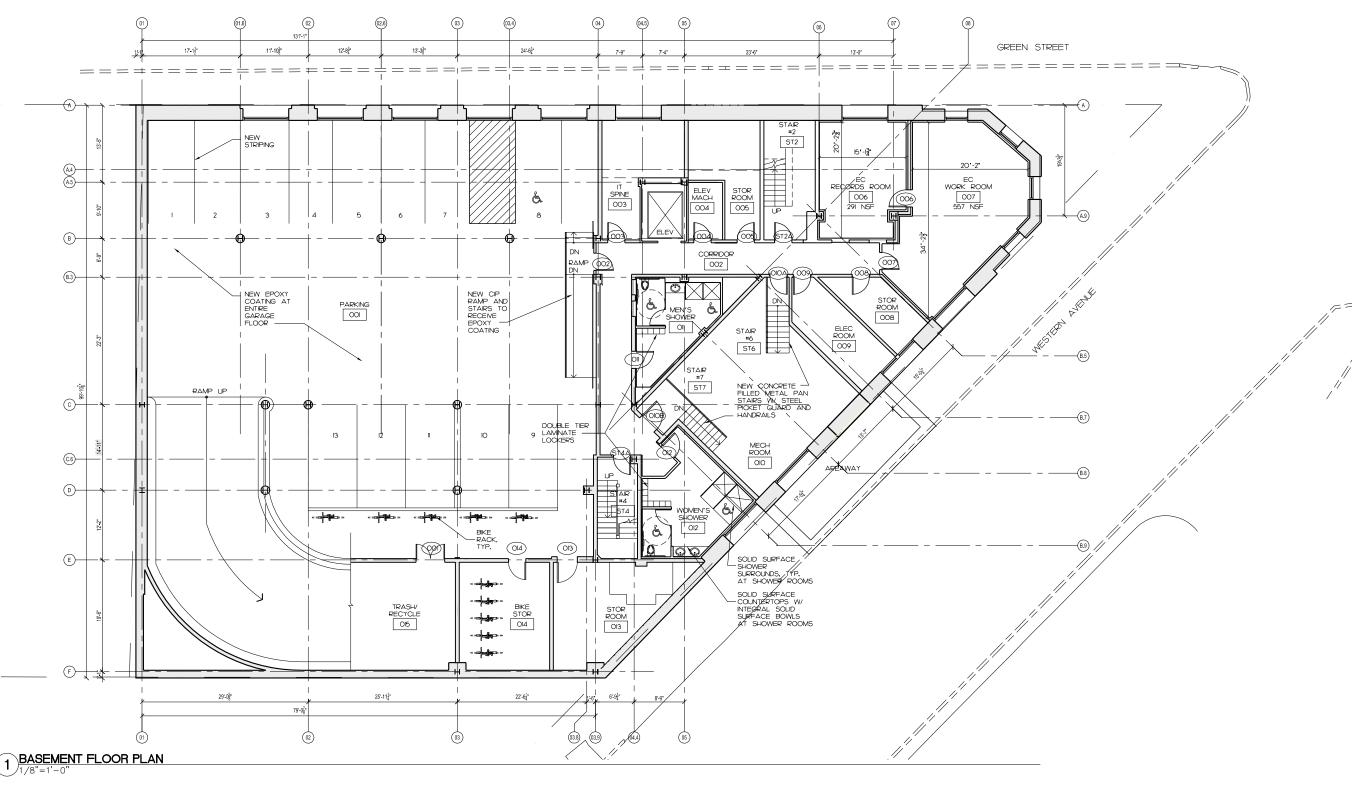
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DEMOLITION EXTERIOR ELEVATIONS





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EXISTING PARTITION W/

NEW PLAN GENERAL NOTES

I, THE CONTRACTOR SHALL VERIFY ALL EXISTING CONDITIONS AND CONSTRUCTION, REVIEW WITH ALL TRADES THE EXTENT OF DEMOLITION REQUIRED,

2, ALL LOCATIONS WHERE NFILL WALLS MEET EXISTING WALLS WITH NEW GWB, FINISH SURFACES SHALL ALIGN AT ADJACENT EDGES UNLESS OTHERWISE NOTED,

3. EXISTING (SHADED) WALLS SHOWN WITH ADDITIONAL LINES GRAPHICALLY REPRESENT NEW FINSHES, (GWB, PANT, WANSCOTTING, ETC.), AND SHOULD NOT BE SCALLED OR DIMENSIONED FROM. PARTITIONS SHOULD BE BUILT AND FINISHED ACCORDING TO PARTITION AND FINISH SCHEDULE.

4. PROVIDE MISCELLANEOUS LOOSE LINTELS AT ALL NEW OR ENLARGED MASONRY OPENINGS, REFER TO LINTEL SCHEDULE IN STRUCTURAL DRAWINGS.

5, COORDINATE AREAWAY DRAINS (AD), FLOOR DRAINS (FD) AND ROOF DRAINS (RD) WITH PLUMBING DRAWINGS.

6. ALL OFFICE DEMISING WALLS ARE 6' METAL STUDS WITH 5/8' GWB BOTH SDES, FILL CAVITY WITH SAFB, TOP AND BOTTOM OF PARTITIONS TO BE SEALED TO SLABS/BEAMS WITH ACOUSTIC SEALANT, 7. PROVIDE BLOCKING FOR GRAB BARS AT ALL ACCESSIBLE TOLET LOCATIONS,

8, MUDSET ALL FLOOR TILE WHERE INDICATED TO BE INSTALLED, SHOWERS TO RECEIVE COPPER PANS AND MUDSET,

9, REFER TO STRUCTURAL DRAWINGS FOR ALL NEW STEEL COLUMNS, BEAMS, ETC,

IO. ALL DIMENSIONS INDICATED WITH A +/- REPRESENT FIELD MEASUREMENTS TO BE PROVIDED TO ARCHITECT AND VERIFIED BY CONTRACTOR.

II, ALL COUNTERS AT KITCHENETTES ARE PAPER COMPOSITE COUNTERS, ALL COUNTERS AT TOILET ROOMS ARE SOLID SURFACE WITH INTEGRAL BOWL(S), BACKSPLASH AT KITCHENETTES TO BE SOLID SURFACE,

12, ALL GLASS WITHIN 18' A.F.F., AND/OR WITHIN 4' OF A DOOR SWING SHALL BE TEMPERED SAFETY GLASS.

13, ALL EXTERIOR WALLS TO RECEIVE NEW INTERIOR FINISH, SEE WALL SECTION DRAWINGS FOR CONSTRUCTION.

Offices

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RDK Engineers Mechanical/Plumbing Engineers ANDOVER, MA

ART Engineers Electrical Engineers WORCESTER, MA

worcester, MA

Beals + Thomas

Civil Engineers
Landscape Architects
SOUTHBOROUGH, MA

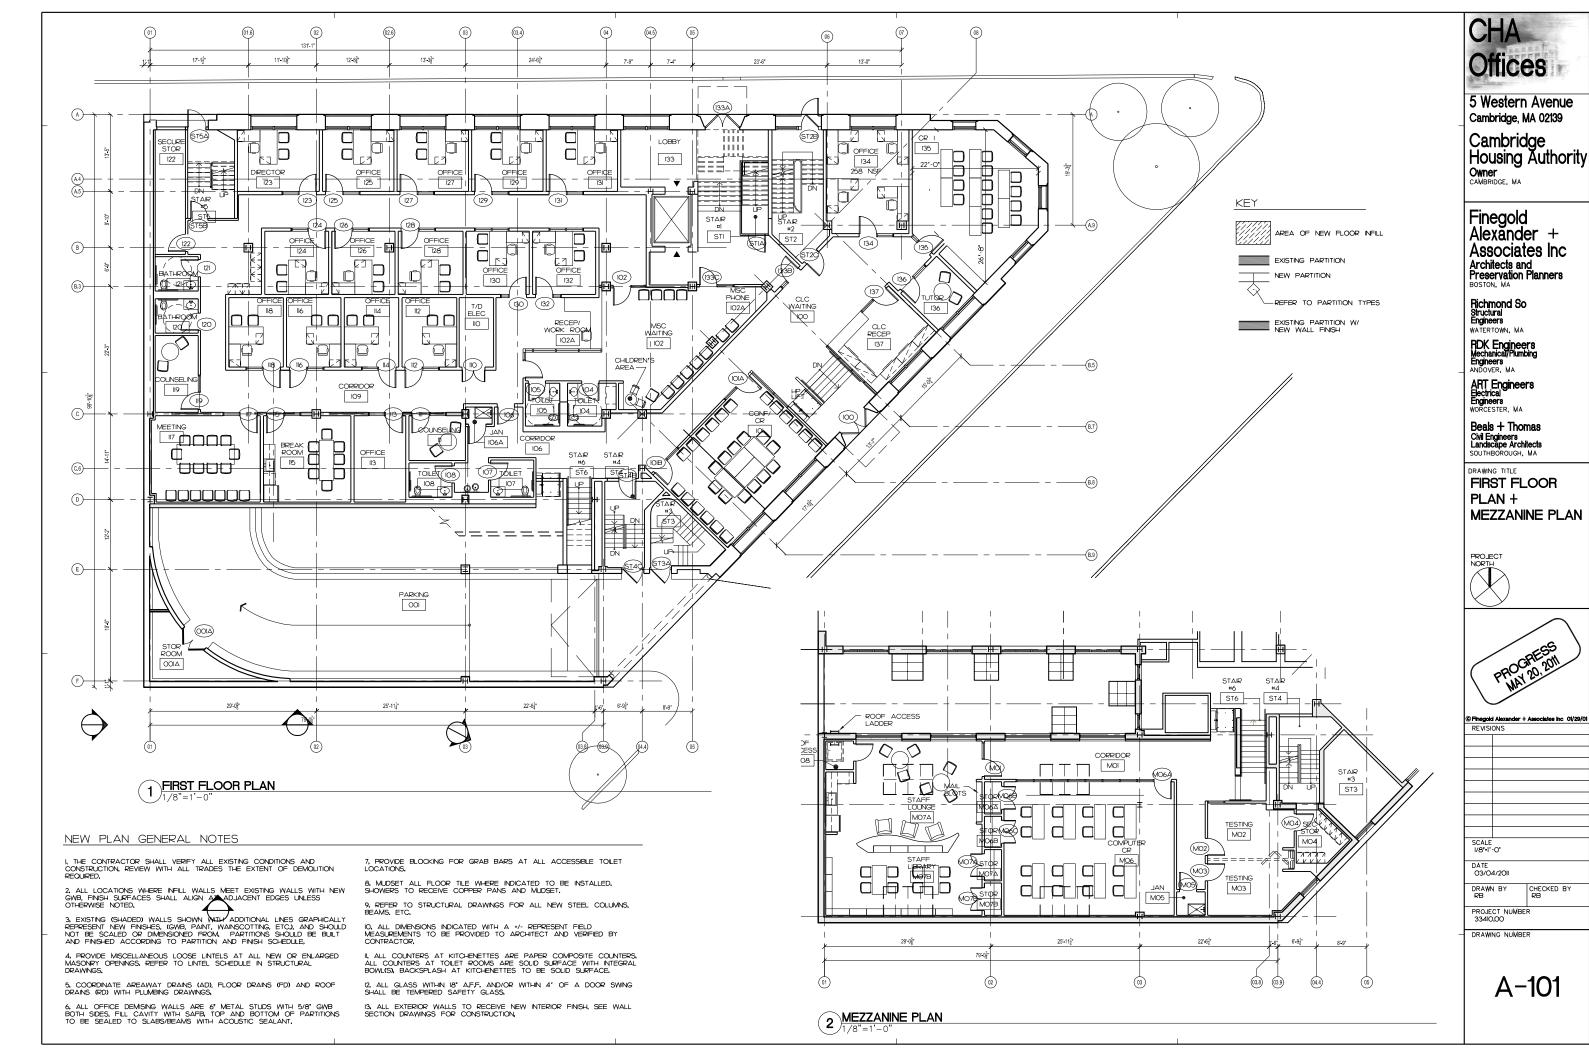
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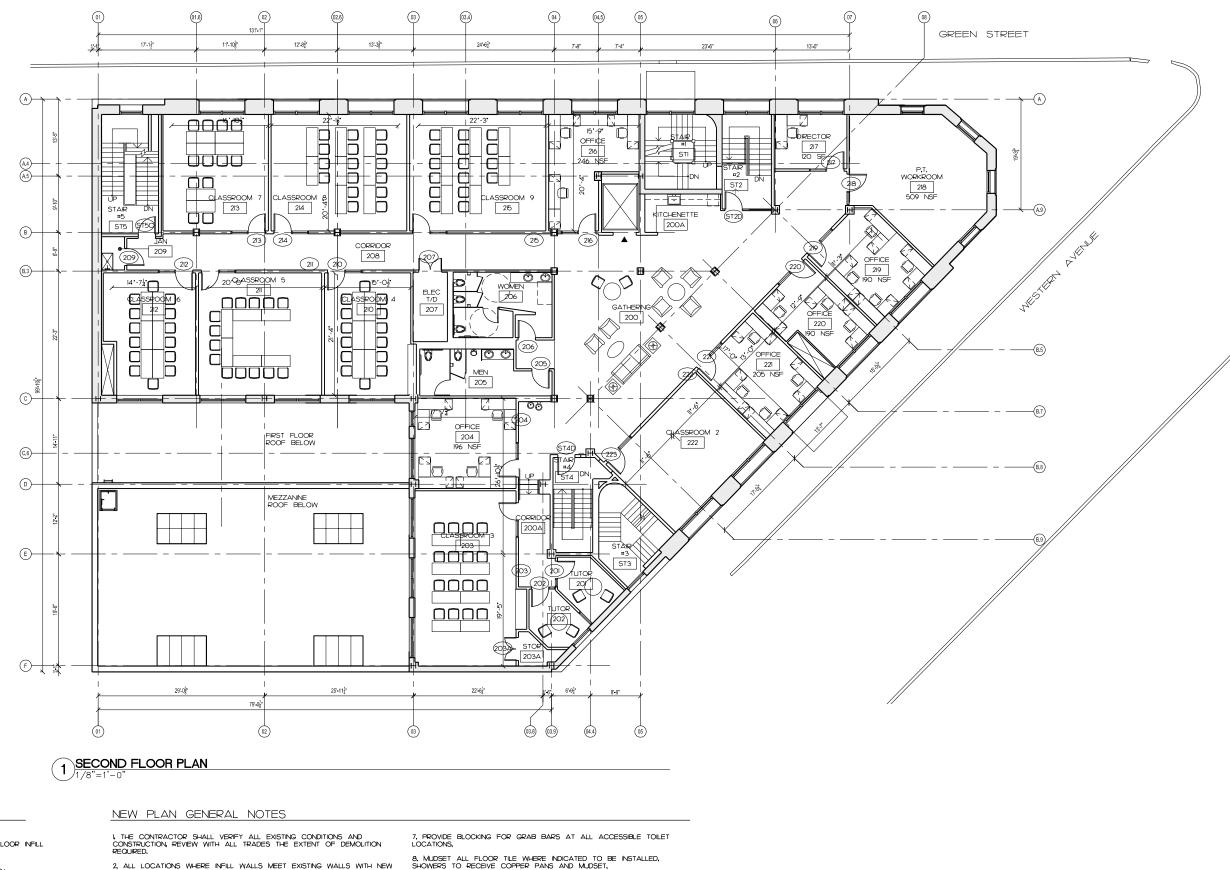
BASEMENT LEVEL PLAN



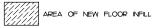


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KEY



EXISTING PARTITION

-REFER TO PARTITION TYPES

EXISTING PARTITION W/

2, ALL LOCATIONS WHERE INFILL WALLS MEET EXISTING WALLS WITH NEW GWB, FINISH SURFACES SHALL ALIGN AT ADJACENT EDGES UNLESS OTHERWISE NOTED,

3. EXISTING (SHADED) WALLS SHOWN WITH ADDITIONAL LINES GRAPHICALLY REPRESENT NEW FINSHES, (GWB. PAINT, WAINSCOTTING, ETC.), AND SHOULD NOT BE SCALED OR DIMENSIONED FROM. PARTITIONS SHOULD BE BUILT AND FINISHED ACCORDING TO PARTITION AND FINISH SCHEDULE.

4, PROVIDE MISCELLANEOUS LOOSE LINTELS AT ALL NEW OR ENLARGED MASONRY OPENINGS, REFER TO LINTEL SCHEDULE IN STRUCTURAL

5, COORDINATE AREAWAY DRAINS (AD), FLOOR DRAINS (FD) AND ROOF DRAINS (RD) WITH PLUMBING DRAWINGS,

6, ALL OFFICE DEMISING WALLS ARE 6' METAL STUDS WITH 5/8' GWB BOTH SIDES, FILL CAVITY WITH SAFB, TOP AND BOTTOM OF PARTITIONS TO BE SEALED TO SLABS/BEAMS WITH ACOUSTIC SEALANT,

9, REFER TO STRUCTURAL DRAWINGS FOR ALL NEW STEEL COLUMNS, BEAMS, ETC.

IO. ALL DIMENSIONS INDICATED WITH A */- REPRESENT FELD MEASUREMENTS TO BE PROVIDED TO ARCHITECT AND VERIFIED BY CONTRACTOR.

II. ALL COUNTERS AT KITCHENETTES ARE PAPER COMPOSITE COUNTERS, ALL COUNTERS AT TOLET ROOMS ARE SOLID SURFACE WITH INTEGRAL BOWL(S), BACKSPLASH AT KITCHENETTES TO BE SOLID SURFACE,

I2, ALL GLASS WITHIN 18 A.F.F. AND/OR WITHIN 4' OF A DOOR SWING SHALL BE TEMPERED SAFETY GLASS.

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Beals + Thomas Civil Engineers Landscape Architects SOUTHBOROUGH, MA

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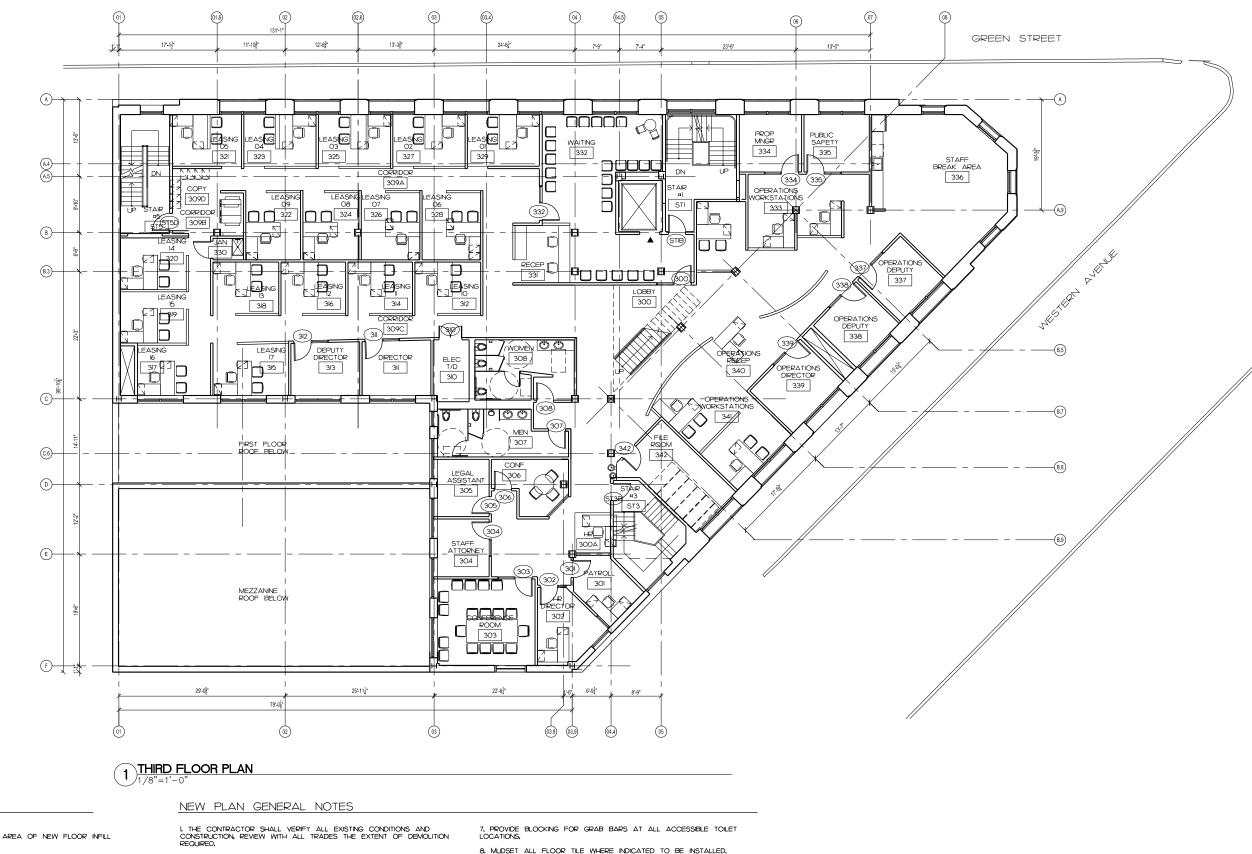
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EXISTING PARTITION W/

2, ALL LOCATIONS WHERE INFILL WALLS MEET EXISTING WALLS WITH NEW GWB, FINISH SURFACES SHALL ALIGN AT ADJACENT EDGES UNLESS OTHERWISE NOTED.

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4, PROVIDE MISCELLANEOUS LOOSE LINTELS AT ALL NEW OR ENLARGED MASONRY OPENINGS, REFER TO LINTEL SCHEDULE IN STRUCTURAL DRAWINGS.

5, COORDINATE AREAWAY DRAINS (AD), FLOOR DRAINS (FD) AND ROOF DRAINS (RD) WITH PLUMBING DRAWINGS,

6. ALL OFFICE DEMISING WALLS ARE 6" METAL STUDS WITH 5/8" GWB BOTH SIDES, FILL CAVITY WITH SAFB, TOP AND BOTTOM OF PARTITIONS TO BE SEALED TO SLABS/BEAMS WITH ACOUSTIC SEALANT,

8, MUDSET ALL FLOOR TILE WHERE INDICATED TO BE INSTALLED, SHOWERS TO RECEIVE COPPER PANS AND MUDSET,

9. REFER TO STRUCTURAL DRAWINGS FOR ALL NEW STEEL COLUMNS, BEAMS, ETC,

IO. ALL DIMENSIONS INDICATED WITH A 1/- REPRESENT FIELD MEASUREMENTS TO BE PROVIDED TO ARCHITECT AND VERIFIED BY CONTRACTOR.

II, ALL COUNTERS AT KITCHENETTES ARE PAPER COMPOSITE COUNTERS, ALL COUNTERS AT TOILET ROOMS ARE SOLID SURFACE WITH INTEGRAL BOWLIS), BACKSPLASH AT KITCHENETTES TO BE SOLID SURFACE, 12, ALL GLASS WITHIN 18' A.F.F. AND/OR WITHIN 4' OF A DOOR SWING SHALL BE TEMPERED SAFETY GLASS.

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Engineers
WORCESTER, MA

Beals + Thomas Civil Engineers Landscape Architects

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THIRD FLOOR **PLAN**





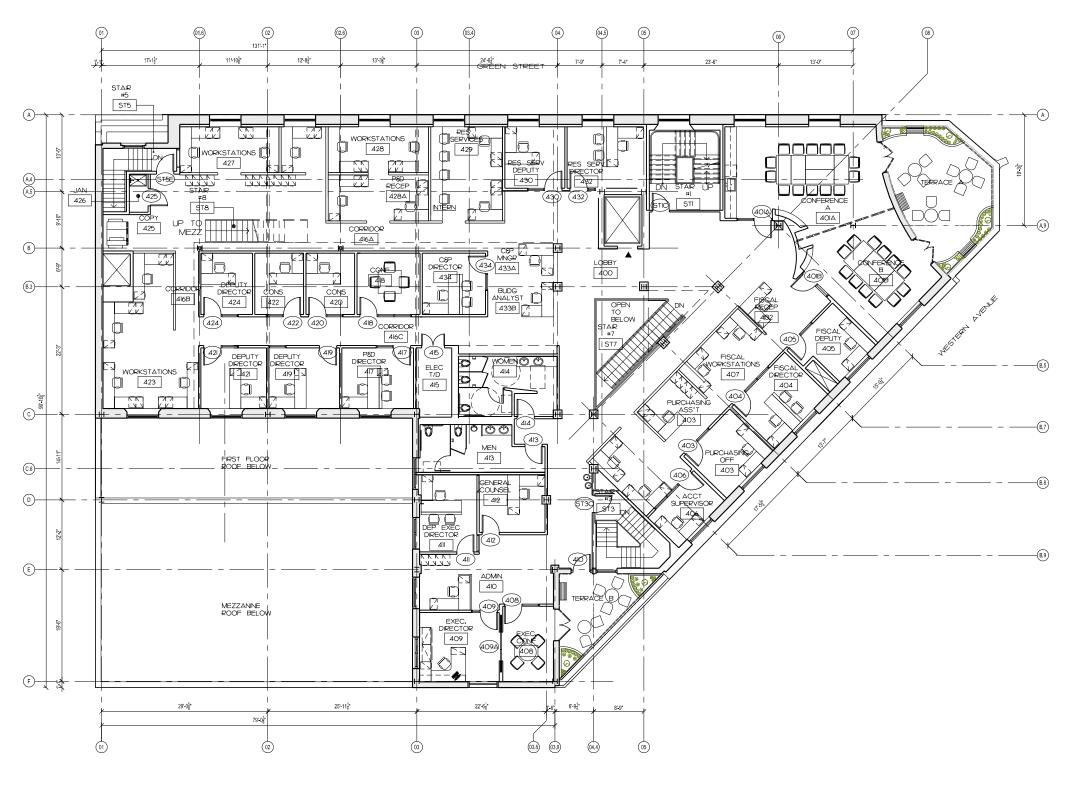
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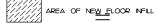
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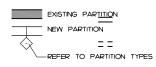
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1)FOURTH FLOOR PLAN

KEY





EXISTING PARTITION W

NEW PLAN = GENERAL NOTES

I, THE CONTRACTOR SHALL VERIFY ALL EXISTING CONDITIONS AND CONSTRUCTION, REVIEW WITH ALL TRADES THE EXTENT OF DEMOLITION REQUIRED,

2, ALL LOCATIONS WHERE INFILL WALLS MEET EXISTING WALLS WITH NEW GWB, FINSH SURFACES SHALL ALIGN AT ADJACENT EDGES UNLESS OTHERWISE NOTED $_{\rm 1}$

3. EXISTING (SHADED) WALLS SHOWN WITH ADDITIONAL LINES GRAPHICALLY REPRESENT NEW FINISHES, (GWB, PAINT, WAINSCOTTING, ETC.), AND SHOULD NOT BE SCALED OR DIMENSIONED FROM, PARTITIONS SHOULD BE BUILT AND FINISHED ACCORDING TO PARTITION AND FINISH SCHEDULE,

4. PROVIDE MISCELLANEOUS LOOSE LINTELS AT ALL NEW OR ENLARGED MASONRY OPENINGS, REFER TO LINTEL SCHEDULE IN STRUCTURAL DRAWINGS.

5, COORDINATE AREAWAY DRAINS (AD), FLOOR DRAINS (FD) AND ROOFDRAINS (RD) WITH PLUMBING DRAWNGS,

6, ALL OFFICE DEMISING WALLS ARE 6' METAL STUDS WITH 5/8' GWB BOTH SIDES, FILL CAVITY WITH SAFB, TOP AND BOTTOM OF PARTITIONS TO BE SEALED TO SLABS/BEAMS WITH ACOUSTIC SEALANT. 7, PROVIDE BLOCKING FOR GRAB BARS AT ALL ACCESSIBLE TOILET LOCATIONS,

8, MUDSET ALL FLOOR TILE WHERE INDICATED TO BE INSTALLED, SHOWERS TO RECEIVE COPPER PANS AND MUDSET,

9, REFER TO STRUCTURAL DRAWINGS FOR ALL NEW STEEL COLUMNS, BEAMS, ETC.

IO, ALL DIMENSIONS INDICATED WITH A +/- REPRESENT FIELD MEASUREMENTS TO BE PROVIDED TO ARCHITECT AND VERIFIED BY CONTRACTOR,

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FOURTH FLOOR PLAN





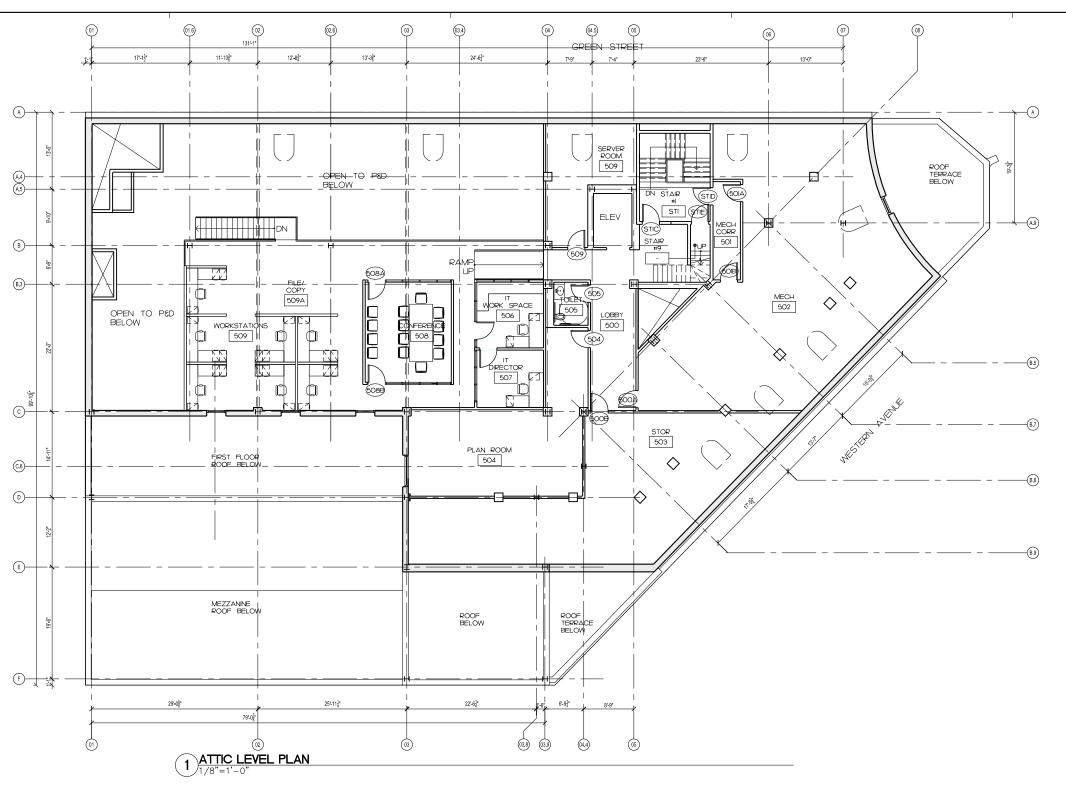
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KEY



EXISTING PARTITION W/

NEW PLAN GENERAL NOTES

I, THE CONTRACTOR SHALL VERIFY ALL EXISTING CONDITIONS AND CONSTRUCTION, REVIEW WITH ALL TRADES THE EXTENT OF DEMOLITION REQUIRED,

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8, MUDSET ALL FLOOR TILE WHERE INDICATED TO BE INSTALLED, SHOWERS TO RECEIVE COPPER PANS AND MUDSET,

9, REFER TO STRUCTURAL DRAWINGS FOR ALL NEW STEEL COLUMNS, BEAMS, ETC, $\,$

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Beals + Thomas
Civil Engineers
Landscape Architects

DRAWING TITLE

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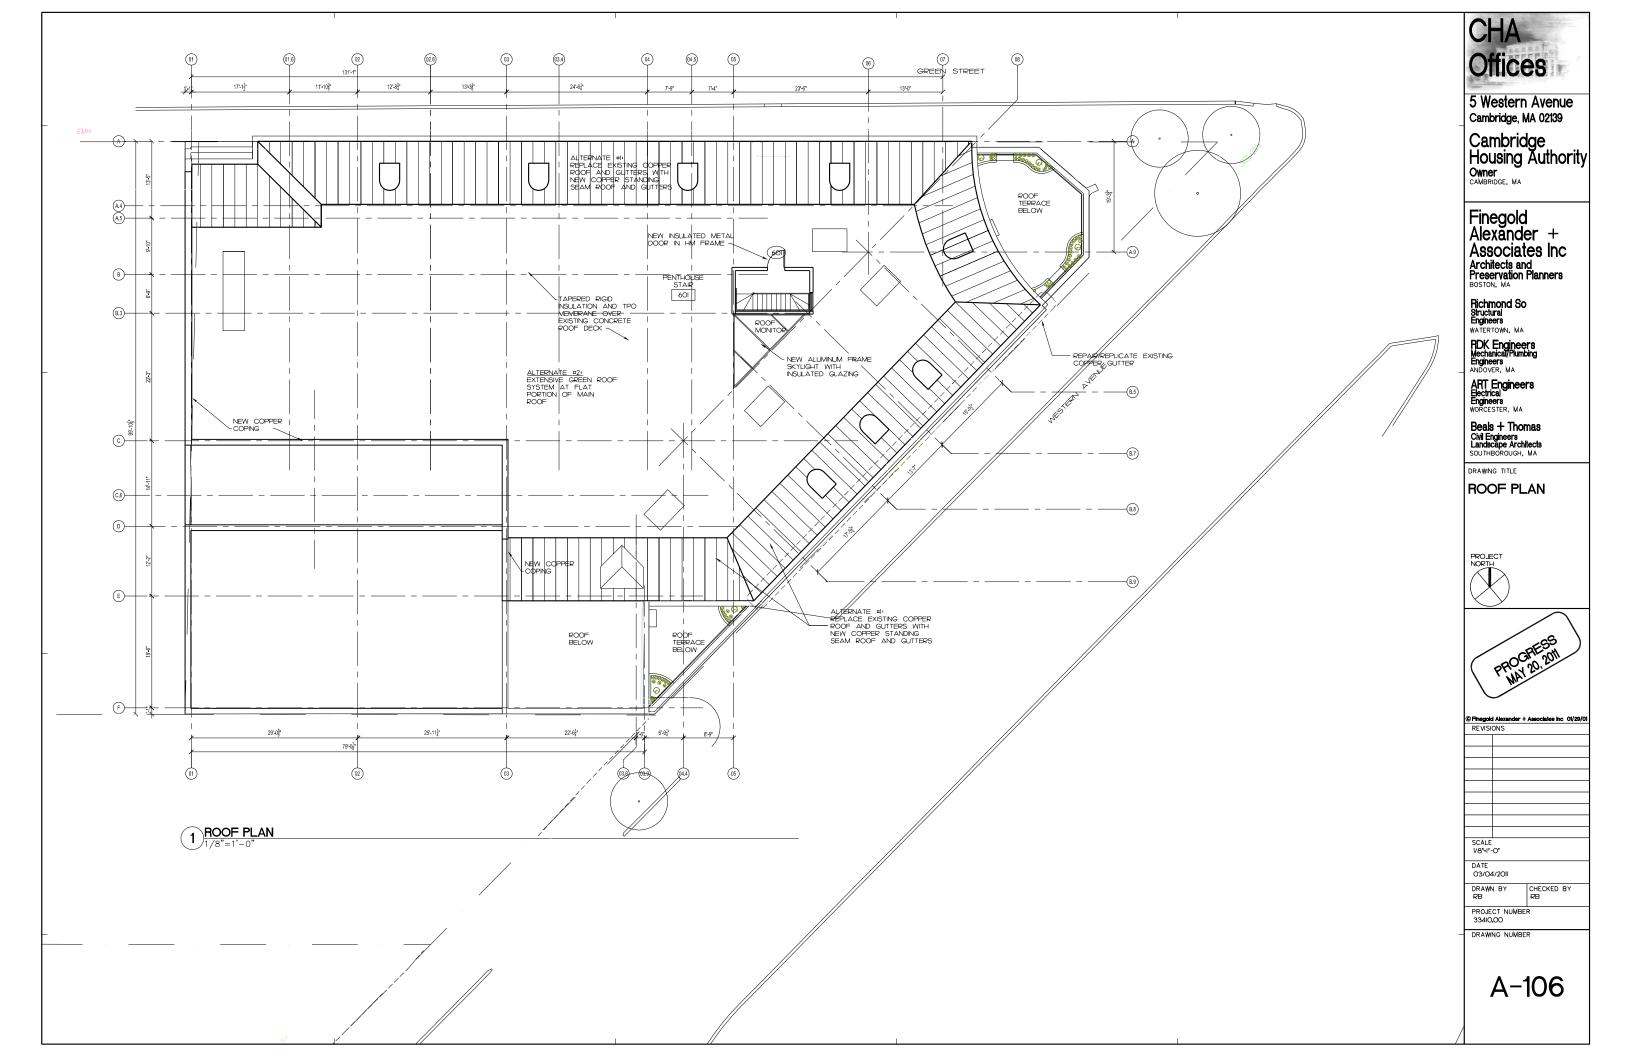


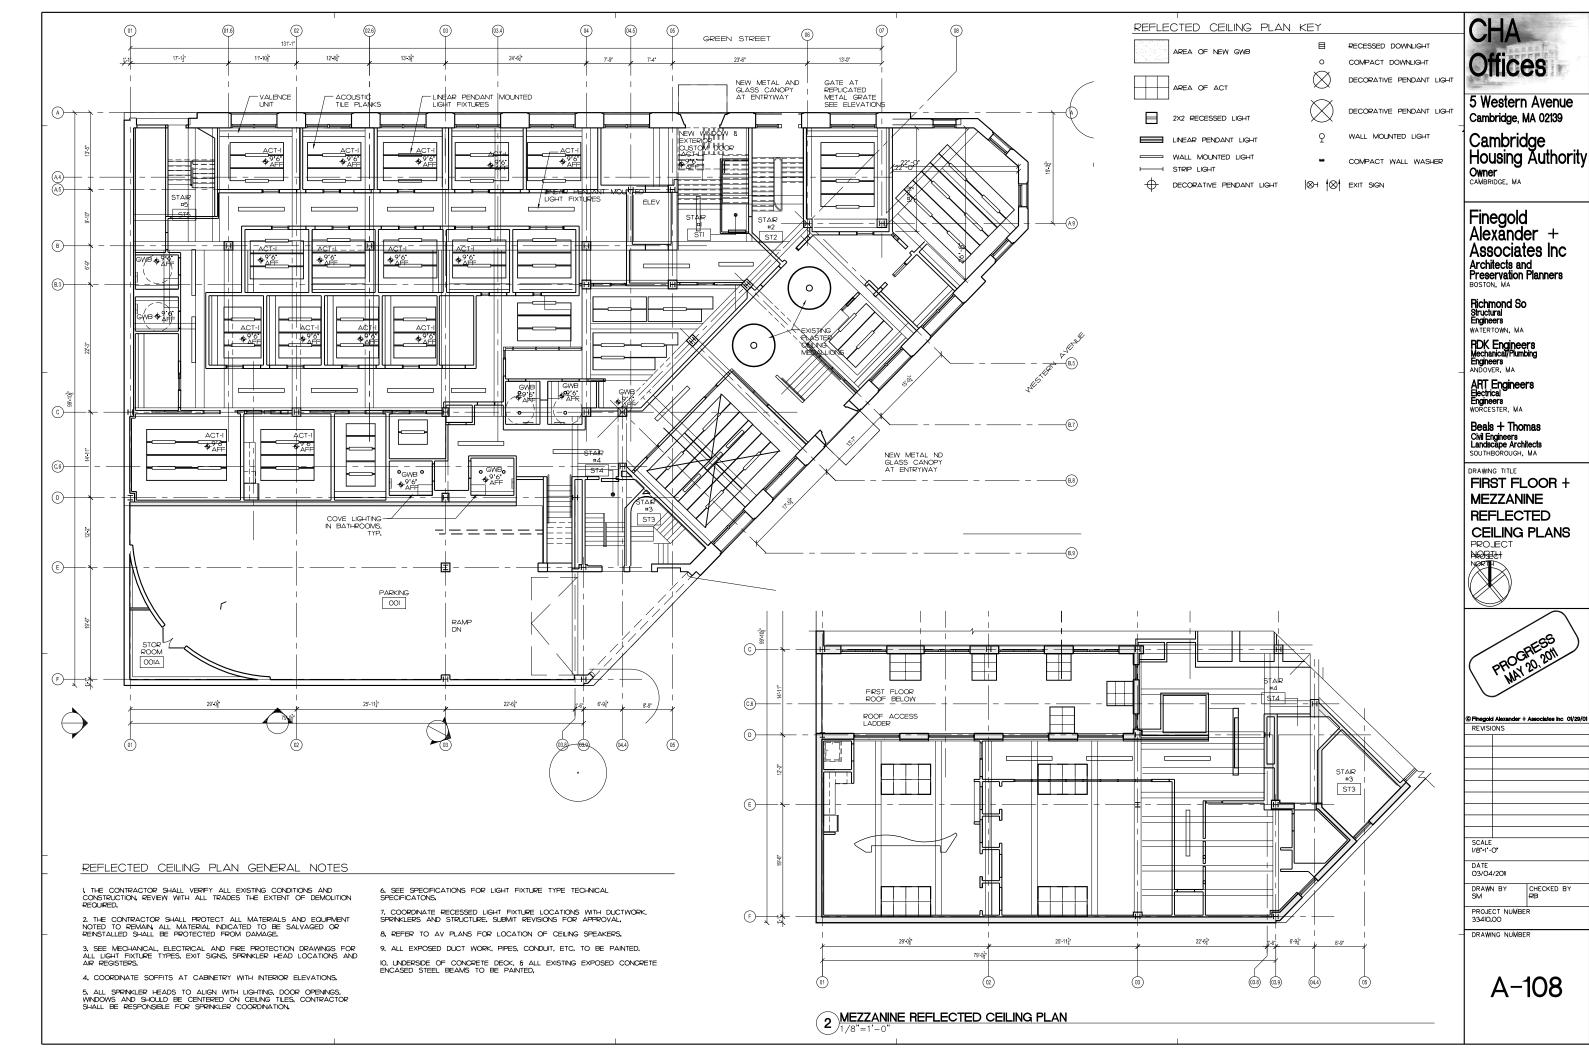


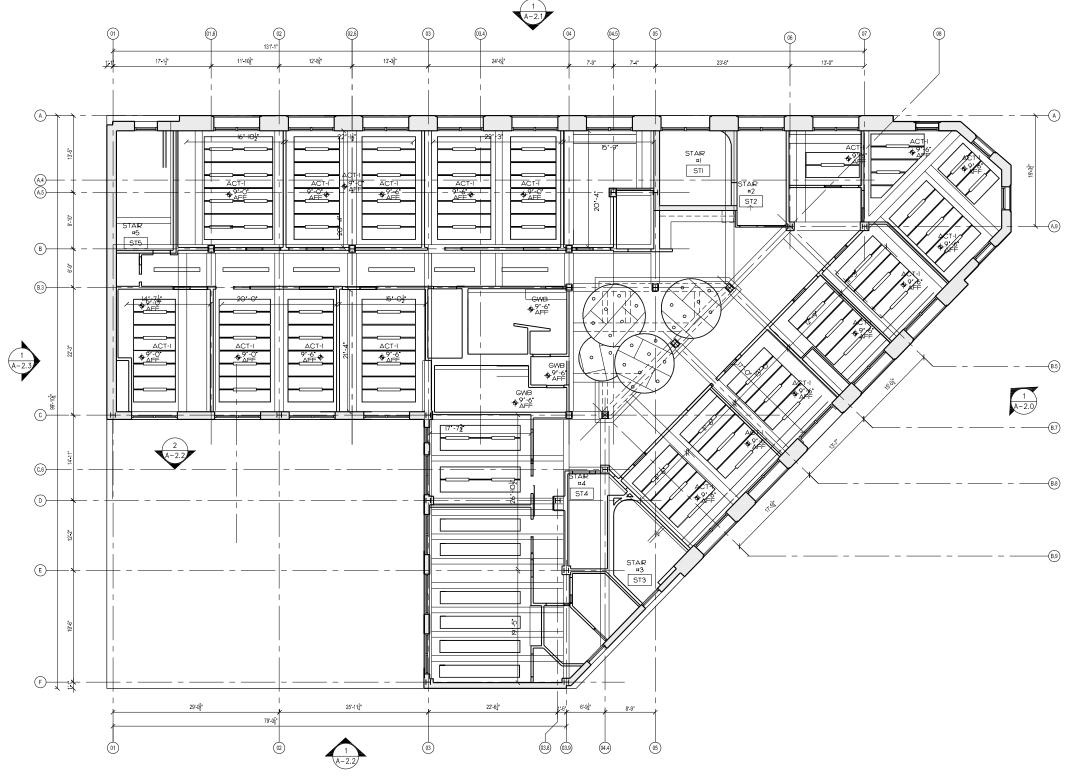
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1 SECOND FLOOR REFLECTED CEILING PLAN

REFLECTED CEILING PLAN KEY

DECORATIVE PENDANT LIGHT

AREA OF NEW GWB	B	RECESSED DOWNLIGHT
	0	COMPACT DOWNLIGHT
AREA OF ACT	\boxtimes	DECORATIVE PENDANT LIGHT

2X2 RECESSED LIGHT	\bigotimes	DECORATIVE PENDANT LIGHT
LINEAR PENDANT LIGHT	φ	WALL MOUNTED LIGHT

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$\vdash \vdash$	STRIP LIGHT		

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REFLECTED CEILING PLAN GENERAL NOTES

- L THE CONTRACTOR SHALL VERIFY ALL EXISTING CONDITIONS AND CONSTRUCTION, REVIEW WITH ALL TRADES THE EXTENT OF DEMOLITION REQUIRED,
- 2. THE CONTRACTOR SHALL PROTECT ALL MATERIALS AND EQUIPMENT NOTED TO REMAIN, ALL MATERIAL INDICATED TO BE SALVAGED OR REINSTALLED SHALL BE PROTECTED FROM DAMAGE,
- REINSTALLED SHALL BE PROTECTED FROM DAMAGE.

 3. SEE MECHANICAL, ELECTRICAL AND FIRE PROTECTION DRAWINGS FOR ALL LIGHT FIXTURE TYPES, EXIT SIGNS, SPRINKLER HEAD LOCATIONS AND AIR REGISTERS.
- AR REGISTERS,
 4. COORDINATE SOFFITS AT CABINETRY WITH INTERIOR ELEVATIONS.
- 5, ALL SPRINKLER HEADS TO ALIGN WITH LIGHTING, DOOR OPENINGS, WINDOWS AND SHOULD BE CENTERED ON CEILING TILES, CONTRACTOR SHALL BE RESPONSIBLE FOR SPRINKLER COORDINATION,
- 6, SEE SPECIFICATIONS FOR LIGHT FIXTURE TYPE TECHNICAL SPECIFICATONS.
- 7, COORDINATE RECESSED LIGHT FIXTURE LOCATIONS WITH DUCTWORK, SPRINKLERS AND STRUCTURE, SUBMIT REVISIONS FOR APPROVAL,
- 8, REFER TO AV PLANS FOR LOCATION OF CEILING SPEAKERS,
- 9. ALL EXPOSED DUCT WORK, PIPES, CONDUIT, ETC. TO BE PAINTED.
- 10, UNDERSIDE OF CONCRETE DECK, & ALL EXISTING EXPOSED CONCRETE ENCASED STEEL BEAMS TO BE PAINTED,

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ART Engineers Electrical Engineers Worcester, Ma

Beals + Thomas Civil Engineers Landscape Architects SOUTHBOROUGH, MA

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SECOND FLOOR REFLECTED CEILING PLAN



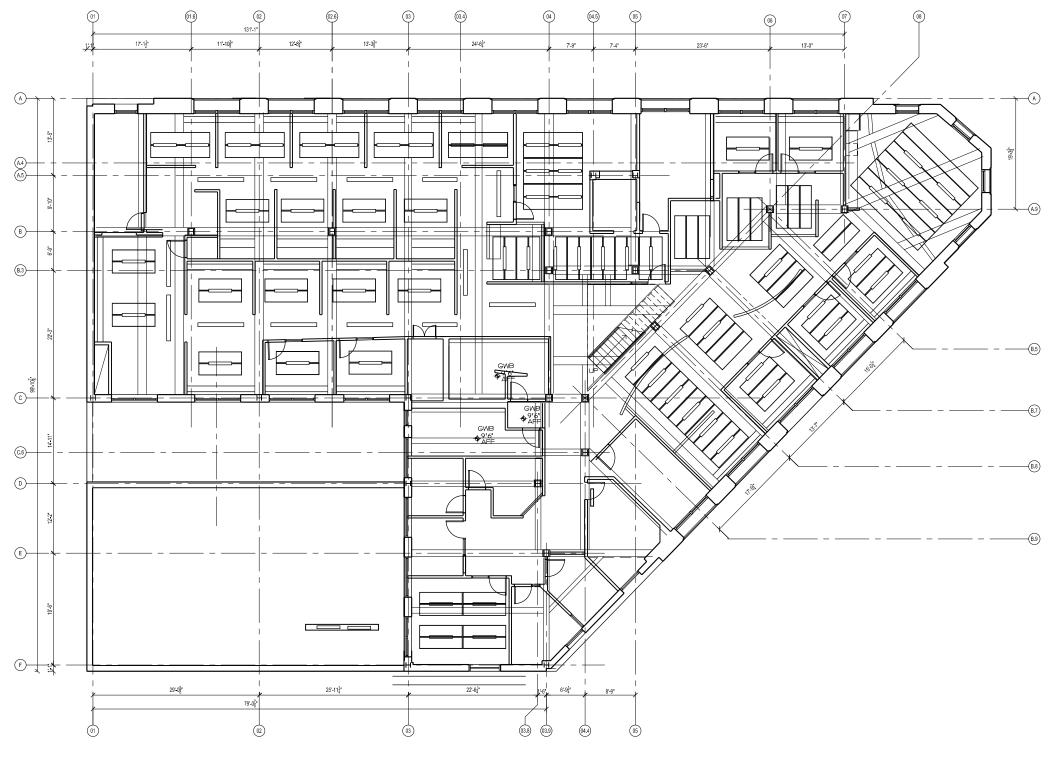


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1) THIRD FLOOR REFLECTED CEILING PLAN

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REFLECTED CEILING PLAN GENERAL NOTES

I, THE CONTRACTOR SHALL VERIFY ALL EXISTING CONDITIONS AND CONSTRUCTION, REVIEW WITH ALL TRADES THE EXTENT OF DEMOLITION REQUIRED.

2. THE CONTRACTOR SHALL PROTECT ALL MATERIALS AND EQUIPMENT NOTED TO REMAIN, ALL MATERIAL INDICATED TO BE SALVAGED OR REINSTALLED SHALL BE PROTECTED FROM DAMAGE,

3, SEE MECHANICAL, ELECTRICAL AND FIRE PROTECTION DRAWINGS FOR ALL LIGHT FIXTURE TYPES, EXIT SIGNS, SPRINKLER HEAD LOCATIONS AND AIR REGISTERS,

- 4, COORDINATE SOFFITS AT CABINETRY WITH INTERIOR ELEVATIONS.
- 5. ALL SPRINCLER HEADS TO ALIGN WITH LIGHTING, DOOR OPENINGS, WINDOWS AND SHOULD BE CENTERED ON CEILING TILES, CONTRACTOR SHALL BE RESPONSIBLE FOR SPRINCLER COORDINATION,

 $\ensuremath{\mathsf{6}}.$ SEE SPECIFICATIONS FOR LIGHT FIXTURE TYPE TECHNICAL SPECIFICATONS,

7. COORDINATE RECESSED LIGHT FIXTURE LOCATIONS WITH DUCTWORK, SPRINKLERS AND STRUCTURE, SUBMIT REVISIONS FOR APPROVAL,

- 8, REFER TO AV PLANS FOR LOCATION OF CEILING SPEAKERS.
- 9, ALL EXPOSED DUCT WORK, PIPES, CONDUIT, ETC, TO BE PAINTED,
- IO, UNDERSIDE OF CONCRETE DECK, & ALL EXISTING EXPOSED CONCRETE ENCASED STEEL BEAMS TO BE PAINTED.

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DRAWING TITLE

THIRD FLOOR REFLECTED CEILING PLAN





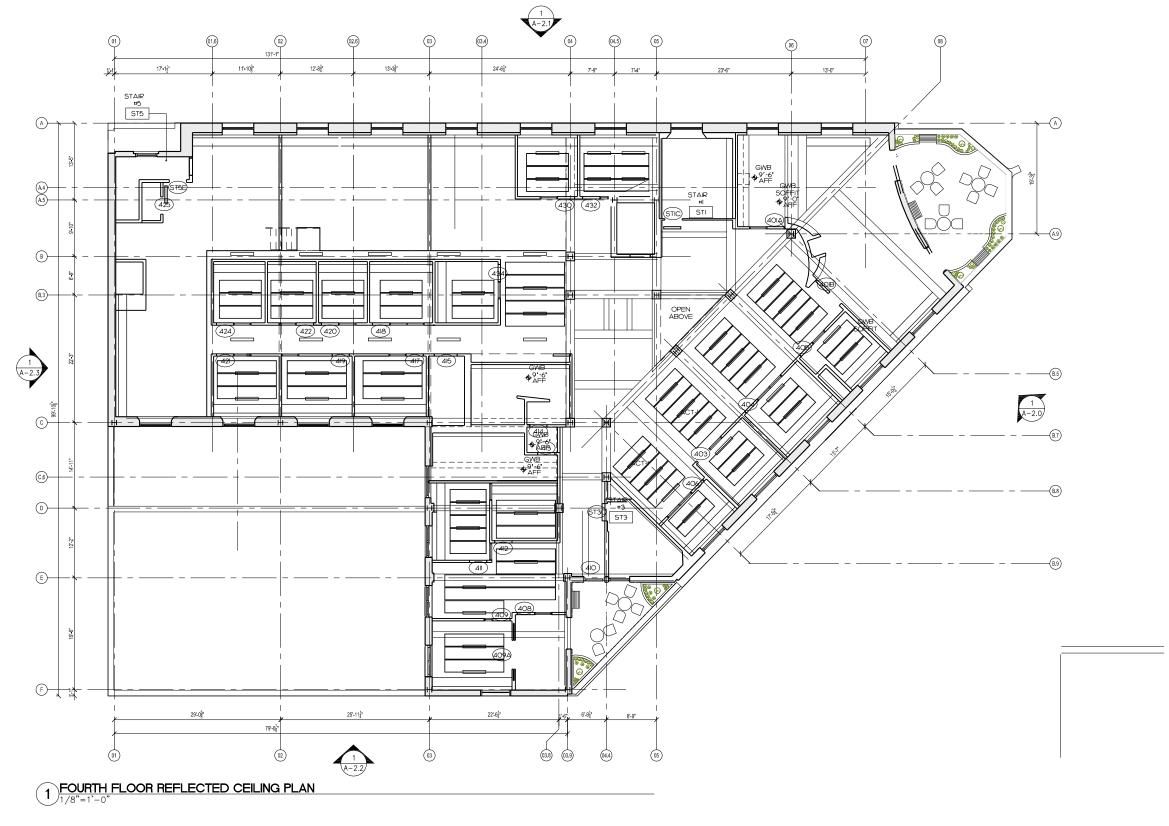
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REFLECTED CEILING PLAN KEY

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2x2 RECESSED LIGHT	\bigotimes	DECORATIVE PENDANT LIGHT
LINEAR PENDANT LIGHT	9	WALL MOUNTED LIGHT
WALL MOUNTED LIGHT	-	COMPACT WALL WASHER

REFLECTED CEILING PLAN GENERAL NOTES

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4, COORDINATE SOFFITS AT CABINETRY WITH INTERIOR ELEVATIONS,

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6, SEE SPECIFICATIONS FOR LIGHT FIXTURE TYPE TECHNICAL SPECIFICATONS,

7, COORDINATE RECESSED LIGHT FIXTURE LOCATIONS WITH DUCTWORK, SPRINKLERS AND STRUCTURE, SUBMIT REVISIONS FOR APPROVAL,

8, REFER TO AV PLANS FOR LOCATION OF CEILING SPEAKERS,

9, ALL EXPOSED DUCT WORK, PIPES, CONDUIT, ETC, TO BE PAINTED, 10, UNDERSIDE OF CONCRETE DECK, ξ ALL EXISTING EXPOSED CONCRETE ENCASED STEEL BEAMS TO BE PAINTED,

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Landscape Architects
SOUTHBOROUGH, MA

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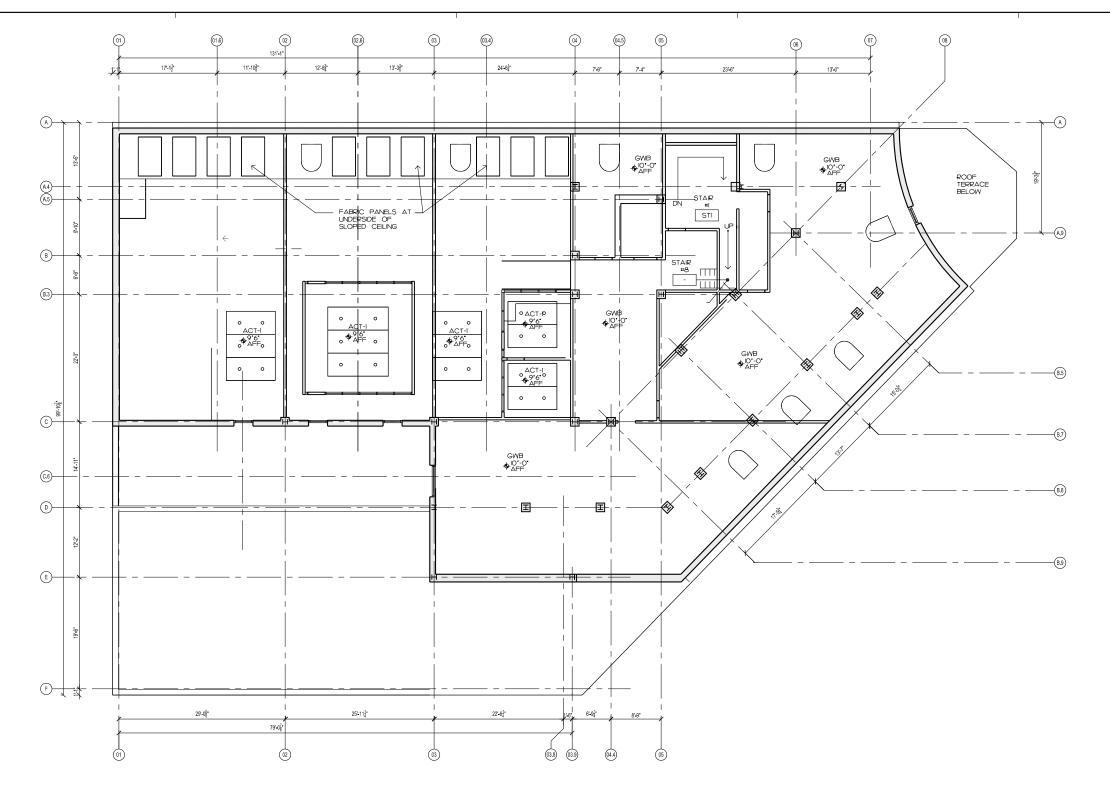
FOURTH FLOOR **REFLECTED** CEILING PLAN





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	$\times \times$	
2X2 RECESSED LIGHT	\bowtie	DECORATIVE PENDANT LIGHT
LINEAR PENDANT LIGHT	오	WALL MOUNTED LIGHT
WALL MOUNTED LIGHT	_	COMPACT WALL WASHER
STRIP LIGHT		CONTACT THALL THATHER
DECORATIVE PENDANT LIGHT	⊗+ † ⊗ †	EXIT SIGN

REFLECTED CEILING PLAN GENERAL NOTES

I, THE CONTRACTOR SHALL VERIFY ALL EXISTING CONDITIONS AND CONSTRUCTION, REVIEW WITH ALL TRADES THE EXTENT OF DEMOLITION REQUIRED,

2, THE CONTRACTOR SHALL PROTECT ALL MATERIALS AND EQUIPMENT NOTED TO REMAIN, ALL MATERIAL INDICATED TO BE SALVAGED OR REINSTALLED SHALL BE PROTECTED FROM DAMAGE,

3. SEE MECHANCAL, ELECTRICAL AND FIRE PROTECTION DRAWINGS FOR ALL LIGHT FIXTURE TYPES, EXIT SIGNS, SPRINKLER HEAD LOCATIONS AND AIR REGISTERS.

4. COORDINATE SOFFITS AT CABINETRY WITH INTERIOR ELEVATIONS.

5. ALL SPRINKLER HEADS TO ALIGN WITH LIGHTING, DOOR OPENINGS, WINDOWS AND SHOULD BE CENTERED ON CELLING TILES, CONTRACTOR SHALL BE RESPONSIBLE FOR SPRINKLER COORDINATION,

6. SEE SPECIFICATIONS FOR LIGHT FIXTURE TYPE TECHNICAL SPECIFICATONS.

7, COORDINATE RECESSED LIGHT FIXTURE LOCATIONS WITH DUCTWORK, SPRINKLERS AND STRUCTURE, SUBMIT REVISIONS FOR APPROVAL,

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9. ALL EXPOSED DUCT WORK, PIPES, CONDUIT, ETC., TO BE PAINTED.

10. UNDERSIDE OF CONCRETE DECK, & ALL EXISTING EXPOSED CONCRETE ENCASED STEEL BEAMS TO BE PAINTED.

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DRAWING TITLE

ATTIC LEVEL **REFLECTED CEILING PLAN**



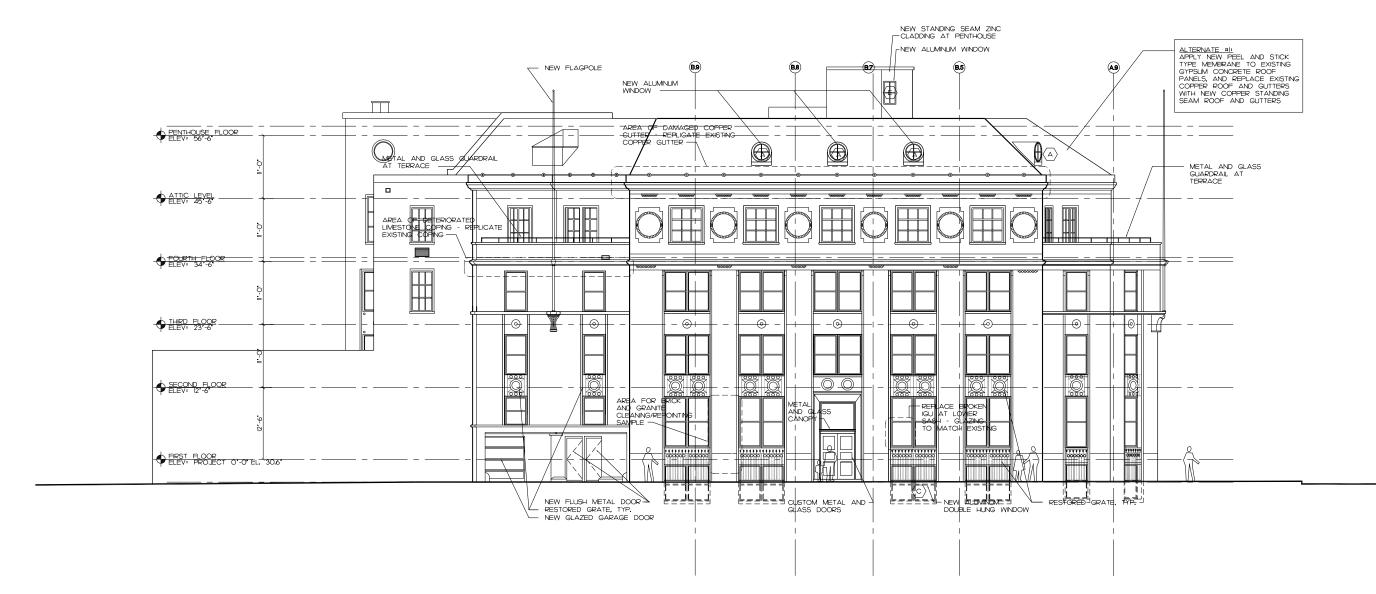


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RENOVATION ELEVATION GENERAL NOTES

I ALL BRICK TO BE CLEANED AND REPOINTED, SEE SPECIFICATION SECTIONS ____, A SECTION OF BRICK SHALL BE CLEANED PER THE SPECIFICATIONS FOR APPROVAL OF FINAL APPEARANCE, OWNER AND ARCHITECT TO APPROVE SAMPLE AREA PRIOR TO CLEANING OF ALL BRICK, SEE ELEVATION DRAWINGS FOR SAMPLE AREA LOCATION,

2. ALL STONE LINTELS, TRIMS, COPINGS, ORNAMENTS TO BE CLEANED PER SPECIFICATION SECTION _____, A SECTION OF STONE SHALL BE CLEANED PER THE SPECIFICATIONS FOR APPROVAL OF FINAL APPEARANCE, OWNER AND ARCHITECT TO APPROVA SAMPLE ARREA PRIOR TO CLEANING OF ALL BRICK, SEE ELEVATION DRAWINGS FOR SAMPLE AREA LOCATION.

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4. ALL AREAS OF EXISTING COPPER ROOF TO BE CLEANED,

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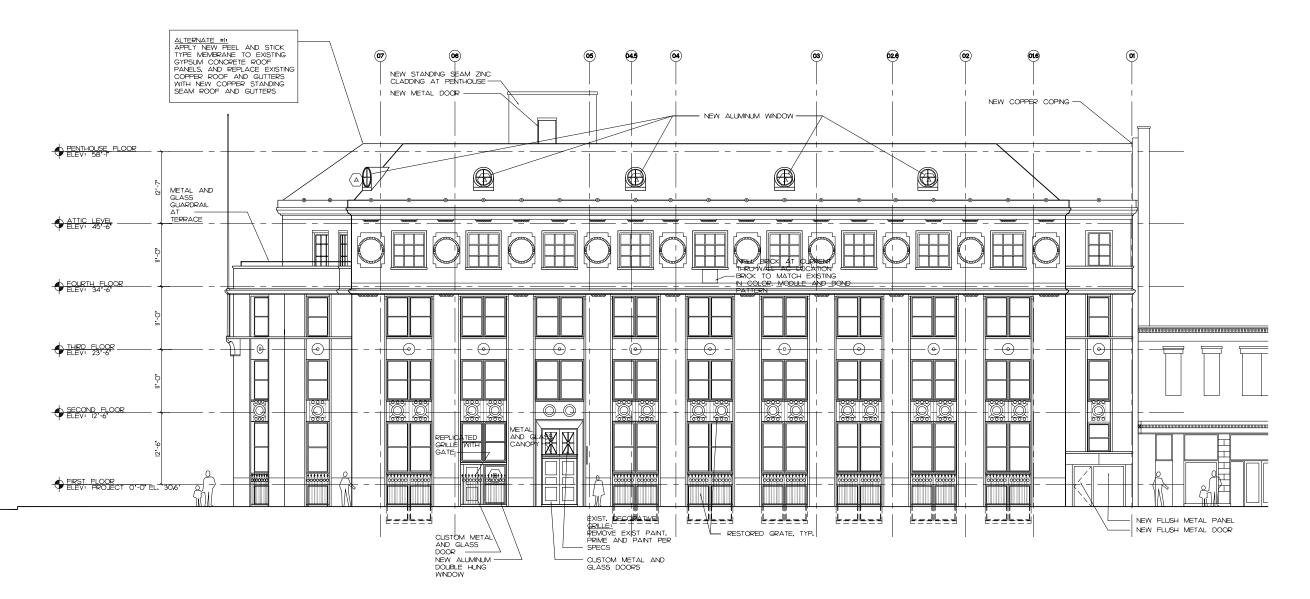




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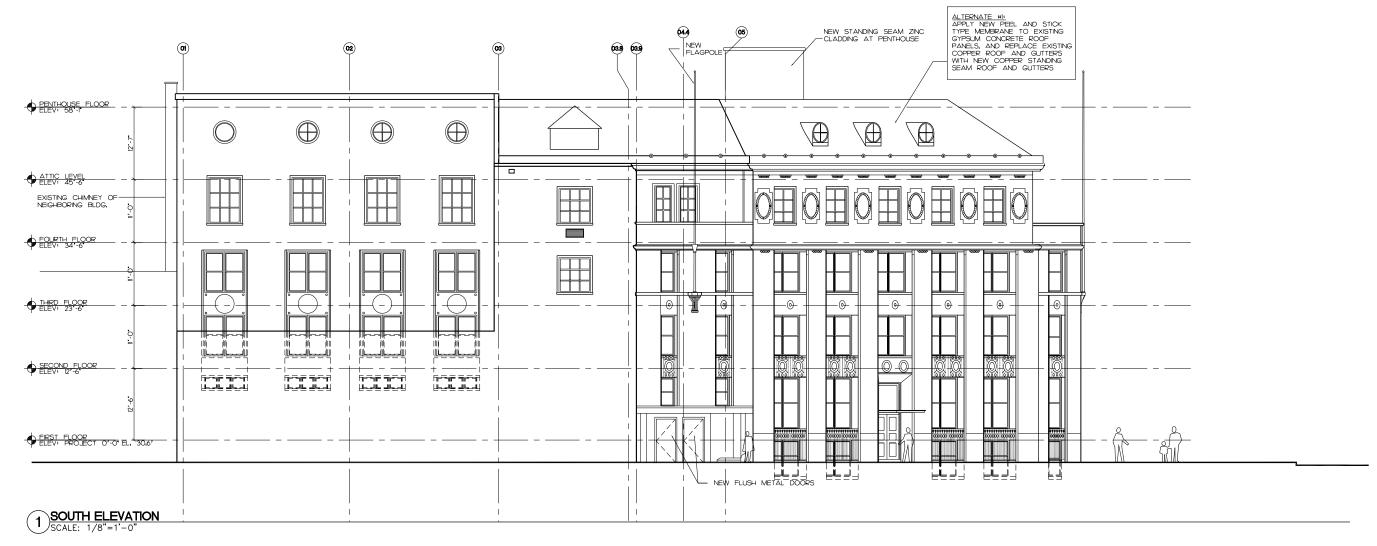


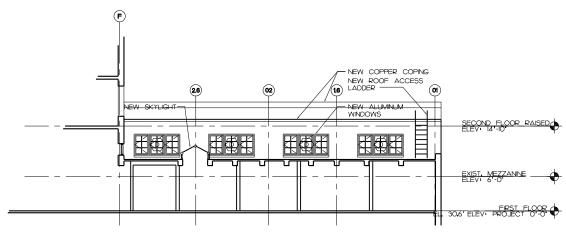


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1 GREEN STREET ELEVATION
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MEZZANINE ELEVATION

RENOVATION ELEVATION GENERAL NOTES

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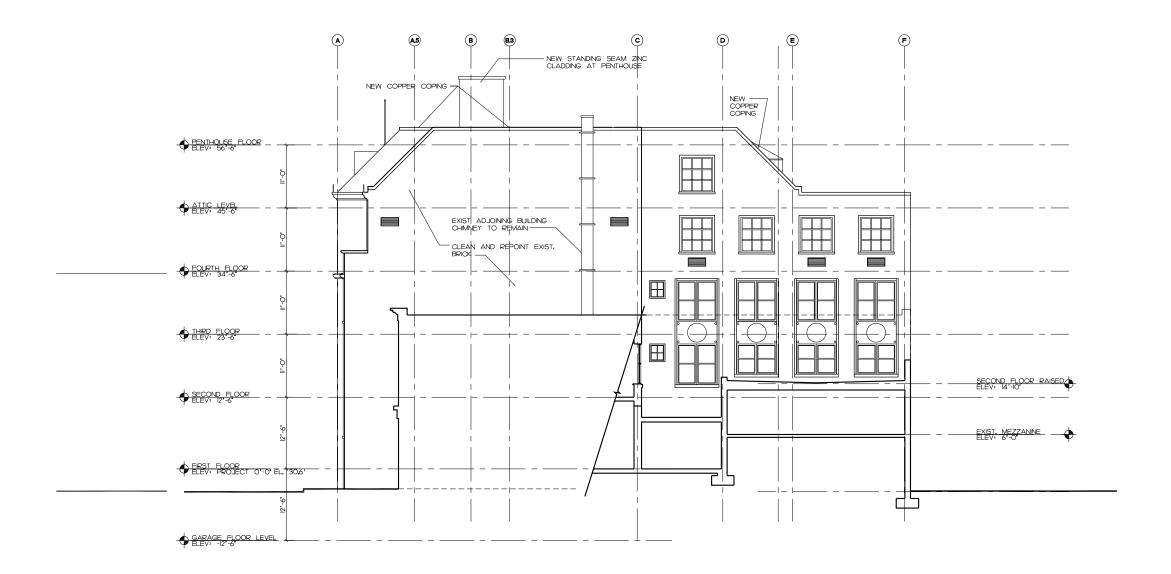
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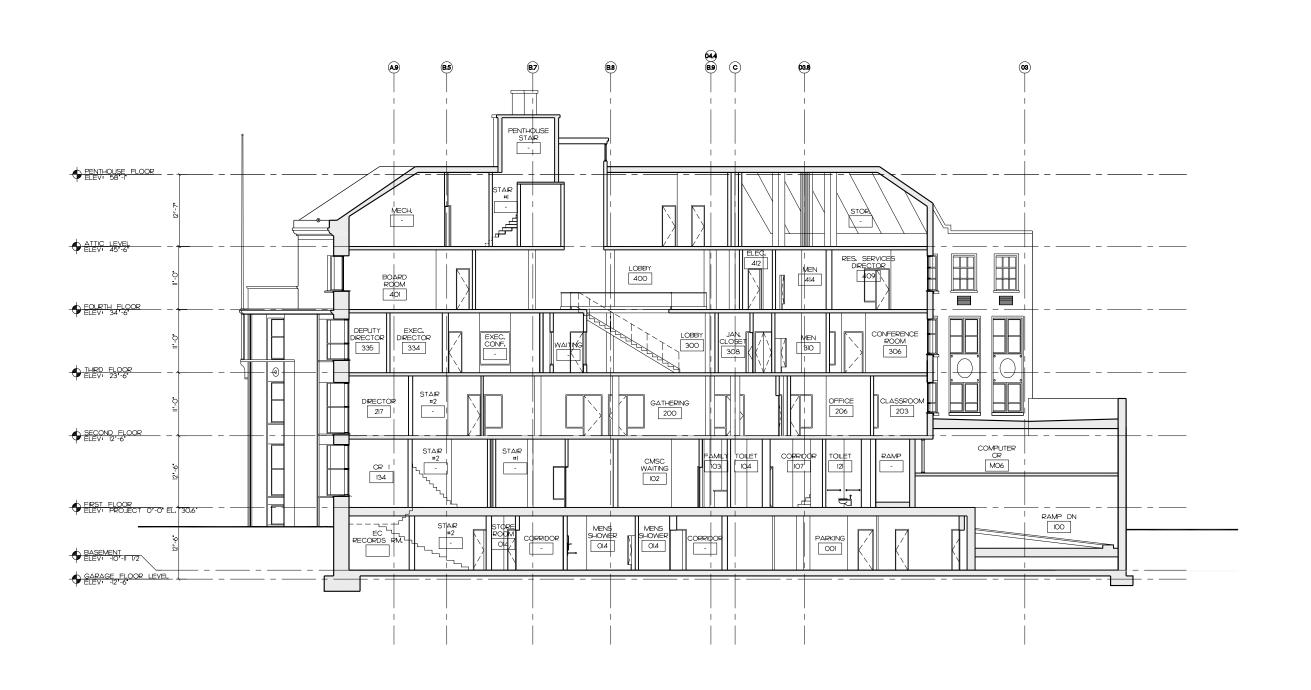




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1 BUILDING SECTION SCALE: 1/8"=1'-0"

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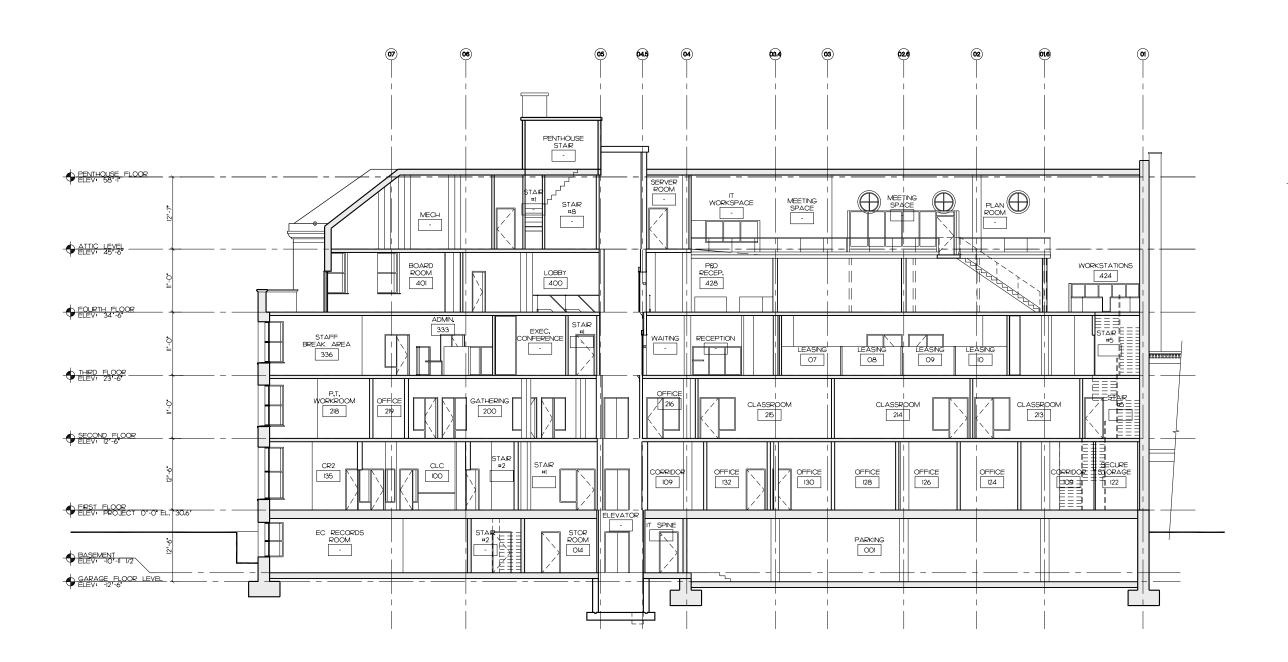
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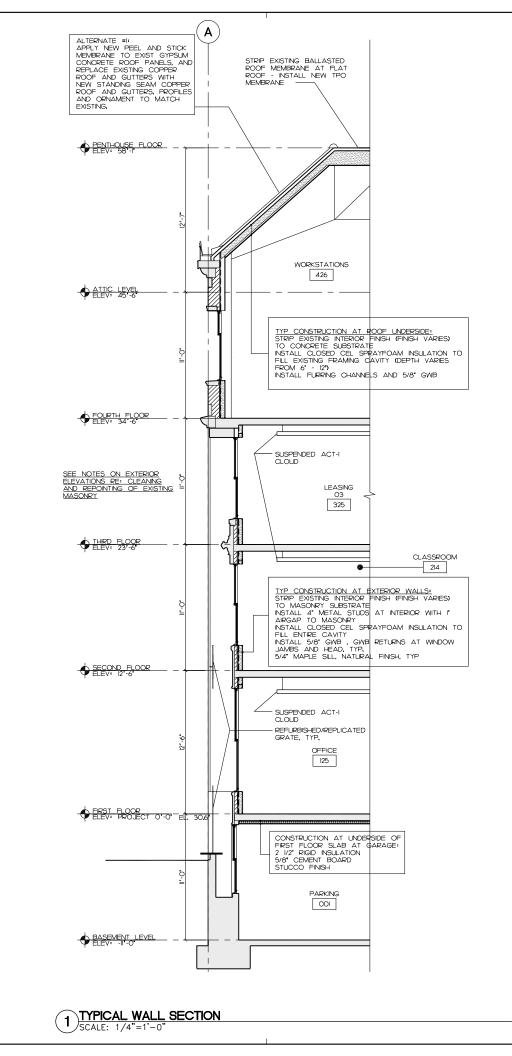
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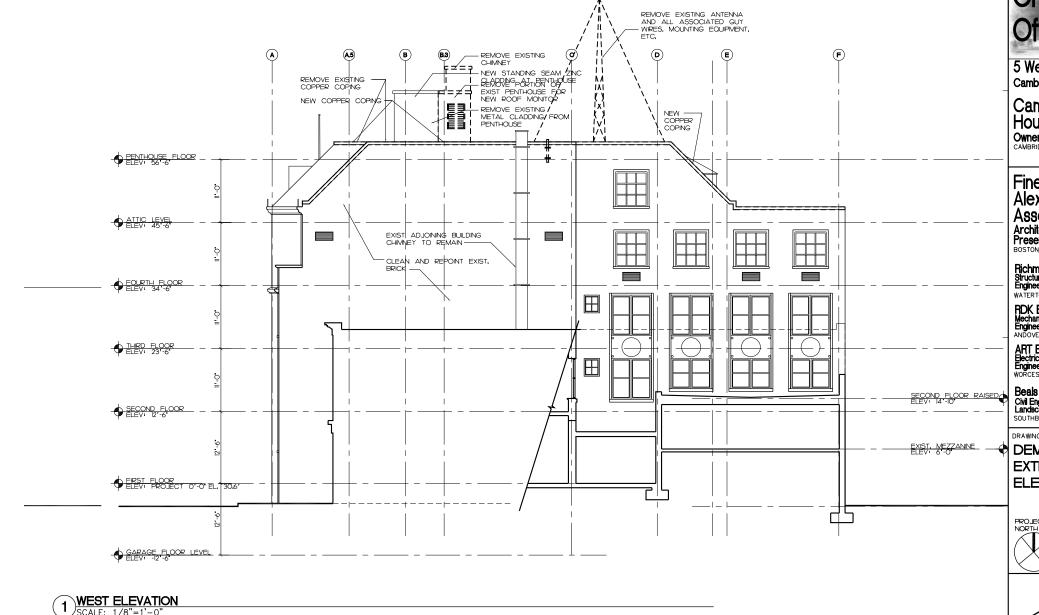
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DEMOLITION ELEVATION GENERAL NOTES

I, THE CONTRACTOR SHALL VERIFY ALL EXISTING CONDITIONS AND CONSTRUCTION REVIEW WITH ALL TRADES THE EXTENT OF DEMOLITION REQUIRED, HATCH PATTERNS ARE SHOWN FOR REPRESENTATION, ONLY AND SHOULD NOT BE USED AS A MEANS FOR DETERMINING QUANTITIES.

2. THE CONTRACTOR SHALL PROTECT ALL MATERIALS AND EQUIPMENT NOTED TO REMAIN, ALL MATERIAL INDICATED TO BE SALVAGED OR REINSTALLED SHALL BE PROTECTED FROM DAMAGE,

3. ALL MATERIAL INDICATED TO BE REMOVED SHALL BE DISPOSED OF IN ACCORDANCE WITH ALL APPLICABLE CODES AND LAWS, THE OWNER RETAINS THE RIGHT TO CLAIM AN EXISTING MATERIAL, SUCH MATERIAL SHALL BE PROTECTED FROM DAMAGE AND DELIVERED TO THE OWNER AS PER OWNER'S REQUIREMENTS,

4, PROVIDE ALL DEMOLITION WORK IN ORDER TO FACILITATE THE APPLICATION OF NEW WORK, AT THE CONCLUSION OF ALL DEMOLITION LEAVE AREA FREE AND CLEAR, BROOM CLEAN FOR THE APPLICATION OF NEW WORK,

5, REMOVE EXISTING WINDOWS, FRAMES, TRIM CASING AND ASSOCIATED HARDWARE WHERE INDICATED,

6. REMOVE EXISTING DOORS, FRAMES, TRIM, THRESHOLD AND ASSOCIATED HARDWARE WHERE INDICATED,

7, REMOVE EXISTING COPPER GUTTER, DOWNSPOUTS AND ASSOCIATED HARDWARE WHERE INDICATED.

8. REMOVE EXISTING DECORATIVE GRATE FOR RESTORATION/RECONSTRUCTION.

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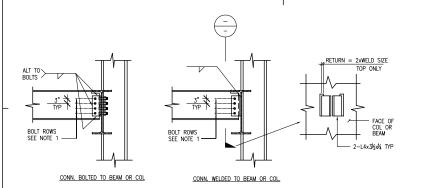
DEMOLITION EXTERIOR ELEVATIONS





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"N" = MINIMUM NUMBER OF BOLT ROWS

MINIMUM NUMBER OF BOLTS

W33 8 W30 8

W24 6

W18 4

W27

W12 3 W10 2

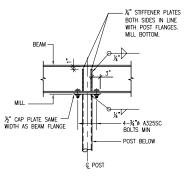
DOUBLE ANGLE CONNECTIONS TO BEAM OR COLUMN

NOTE: CONN SIMILAR WHEN CONNECTING TO GIRDER OR COLUMN (SHOWN DASHED)

NOTES:

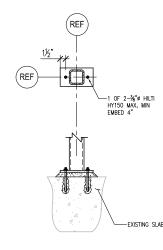
- SIMPLE SHEAR CONNECTIONS SHALL BE DESIGNED FOR THE REACTION SHOWN ON THE DRAWINGS OR THE GREATEST OF THE FOLLOWING:
- a. REACTION FROM AISC MANUAL OF STEEL TABLES FOR BEAMS FOR APPLICABLE BEAM MATERIAL AS PER GENERAL NOTES.
- b. MINIMUM NUMBER OF BOLTS, SEE TABLE.
- 2. BOLTS SHALL BE 34" DIAMETER A325 MINIMUM U.O.N..
- 3. PROVIDE WEB REINFORCING AS REQUIRED DUE TO WEB CUTS, COPES ETC ...
- DESIGN OF DOUBLE ANGLE CONNECTIONS SHALL BE BASED ON THE LATEST AISC PROCEDURES SHOWN IN THE AISC MANUAL OF STEEL CONSTRUCTION.
- 5. FACTOR FOR CONVERSION OF LOADS FROM SERVICE TO ULTIMATE SHALL BE EQUAL TO 1.6.
- 6. ALTERNATE CONNECTION SYSTEM (SINGLE ANGLE, SEATED, ETC) MAY BE USED ONLY UPON SPECIFIED APPROVAL OF THE ENGINEER OF RECORD. DETAILER SHALL SUBMIT WRITTEN REQUESTS FOR USE OF ALTERNATE CONNECTIONS TO THE ARCHITECT AND ENGINEER OF RECORD.

TYPICAL SIMPLE SHEAR CONNECTION DETAIL



NOTE: WELDS MAY BE SUBSTITUT
FOR BOLTS AS REQUIRED TO MEET
ADCHITECTURAL CONSTRAINTS

TYPICAL DETAIL AT BEAM SUPPORTED ON POST 2



BASEPLATE 3



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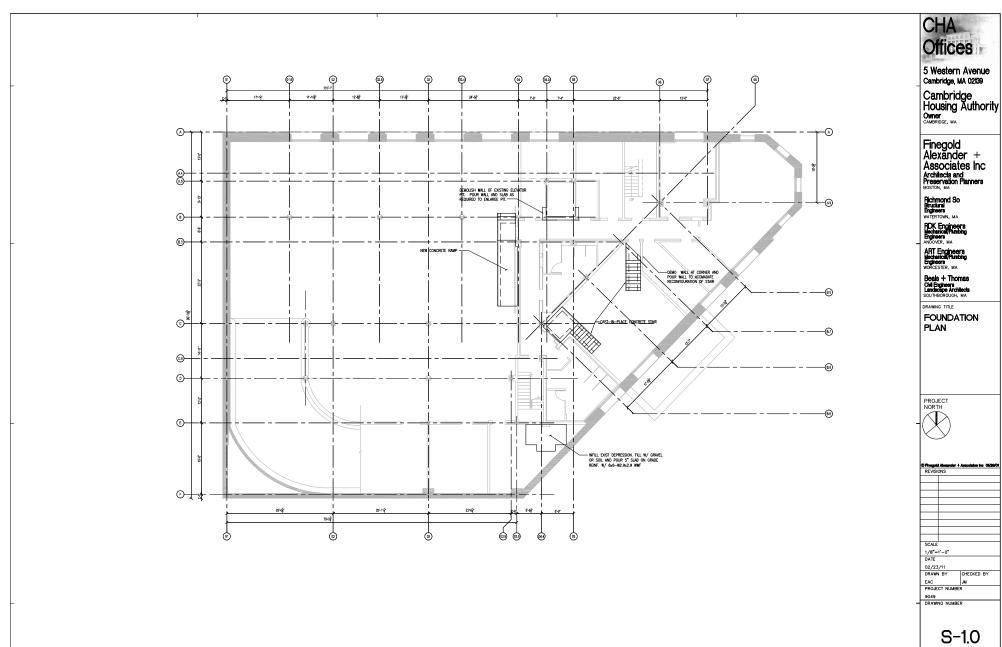
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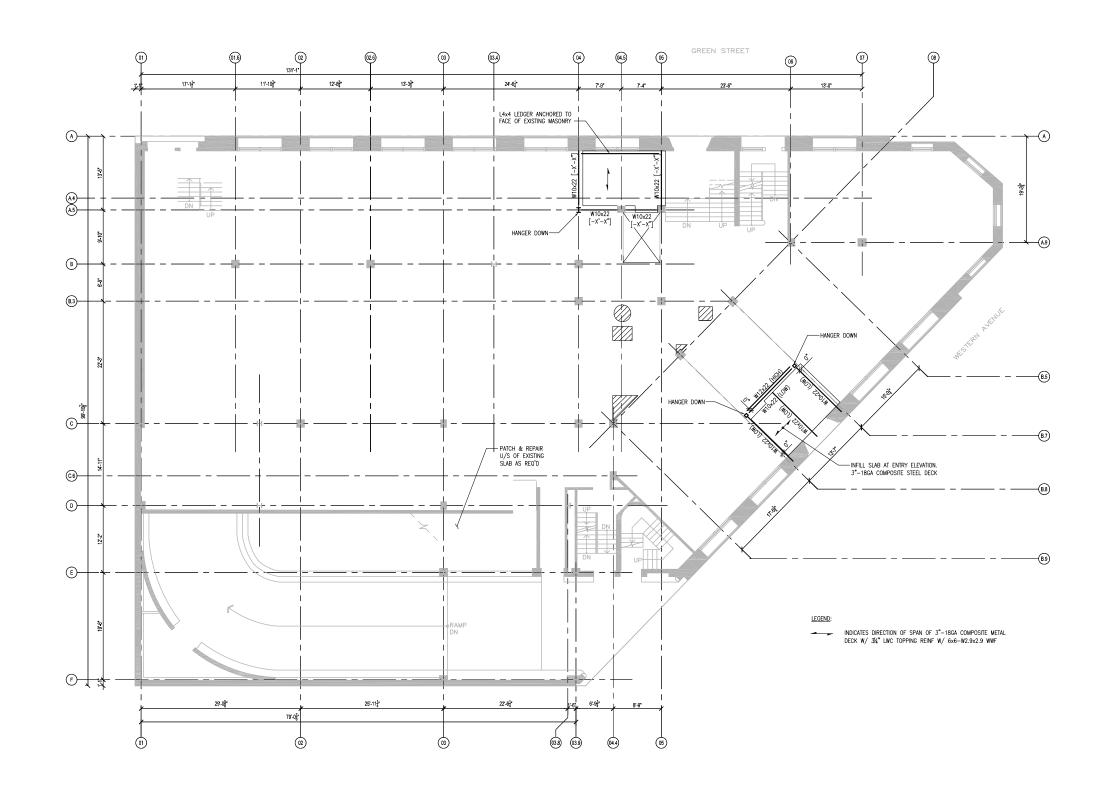
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TYPICAL DETAILS

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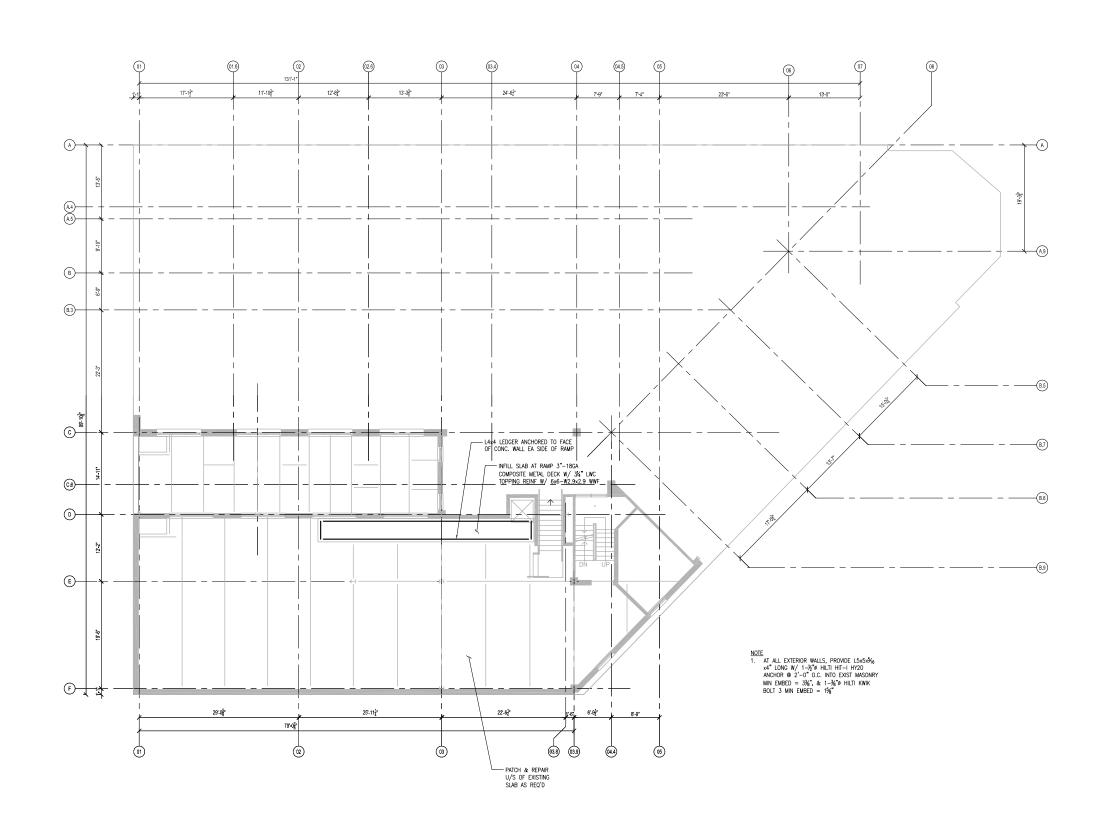
FIRST FLOOR FRAMING PLAN

PROJECT NORTH

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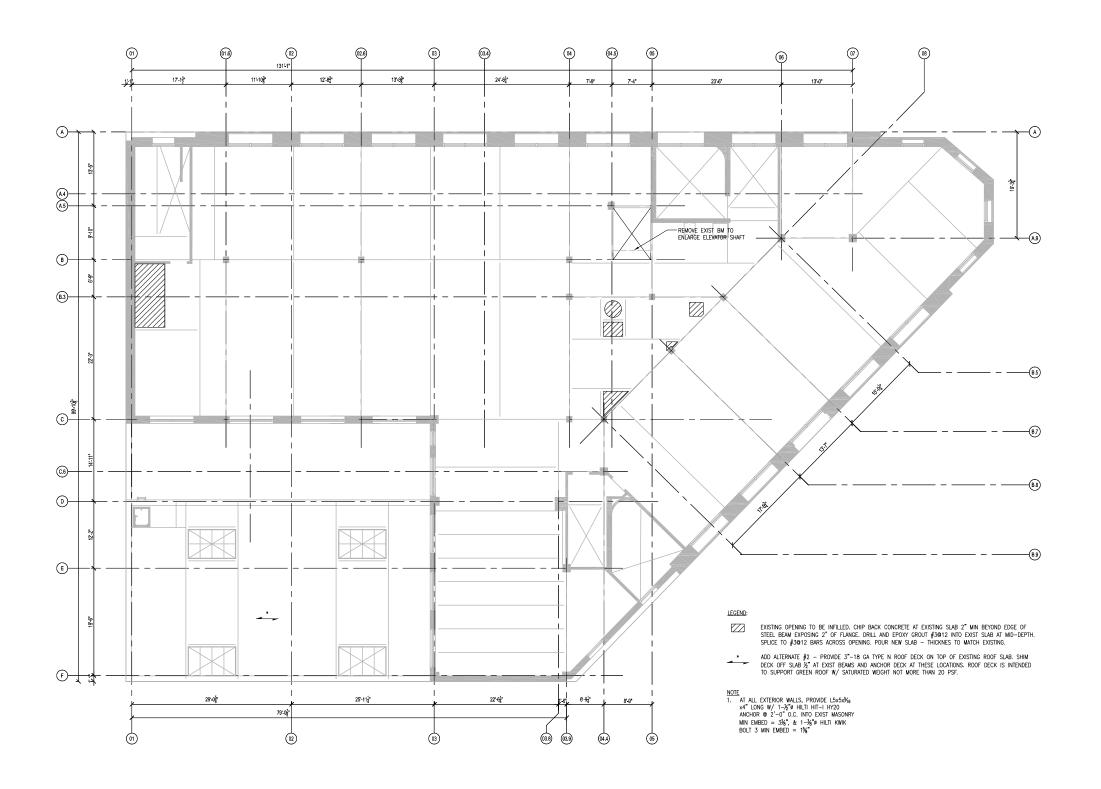
MEZZANINE FLOOR FRAMING PLAN

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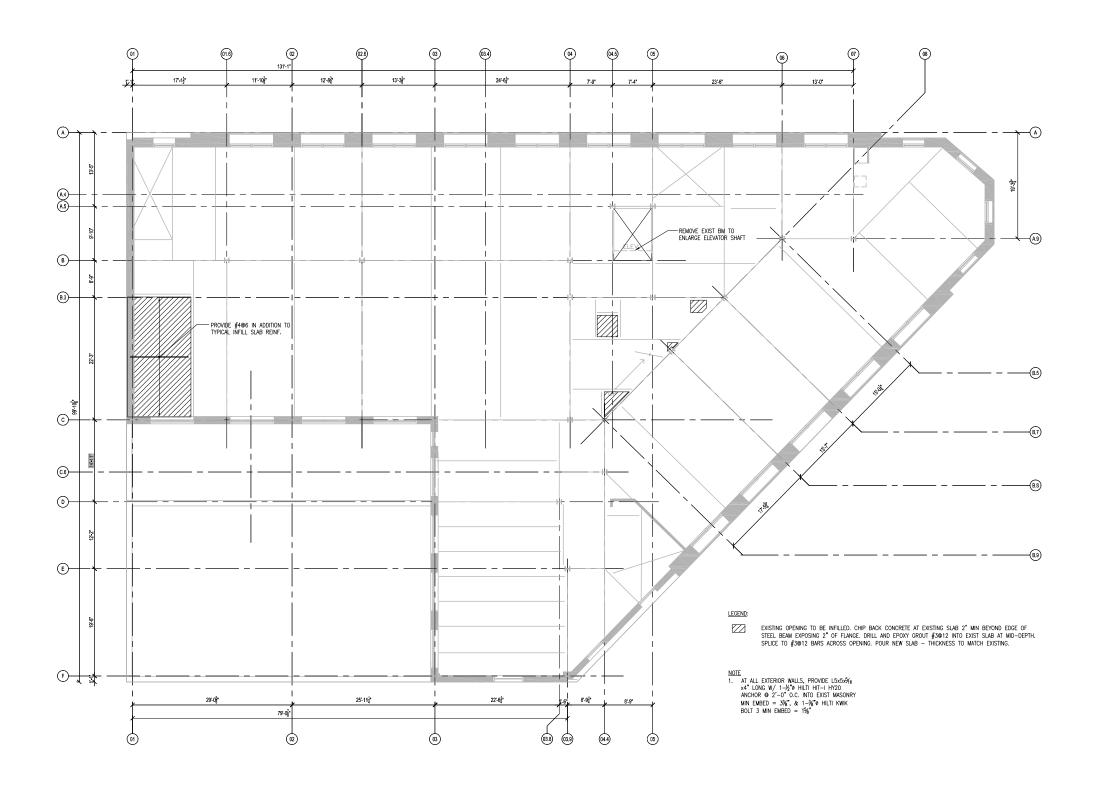
SECOND FLOOR FRAMING PLAN

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THIRD FLOOR FRAMING PLAN

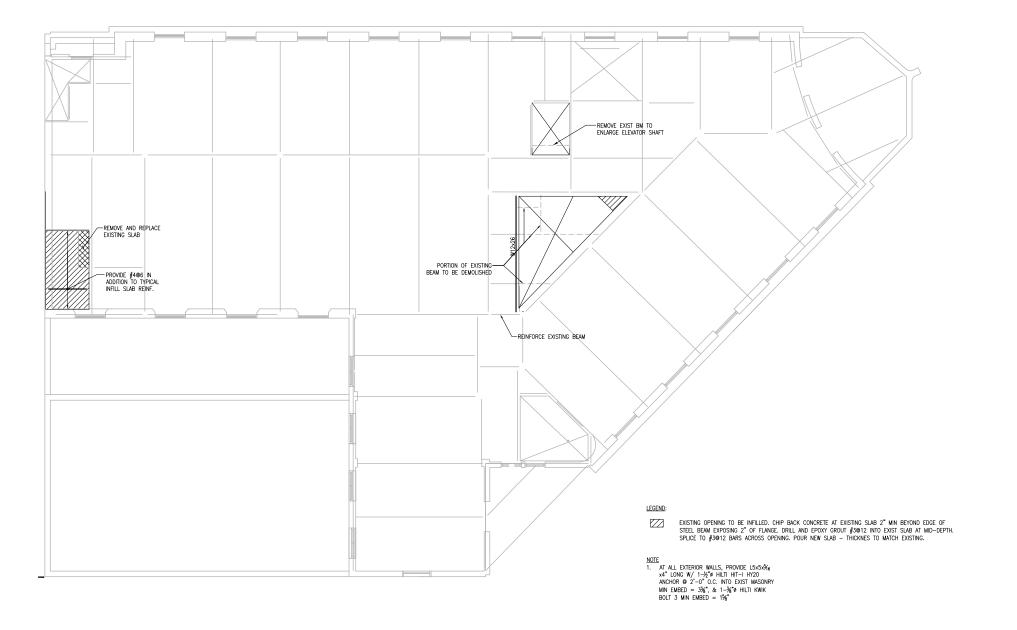
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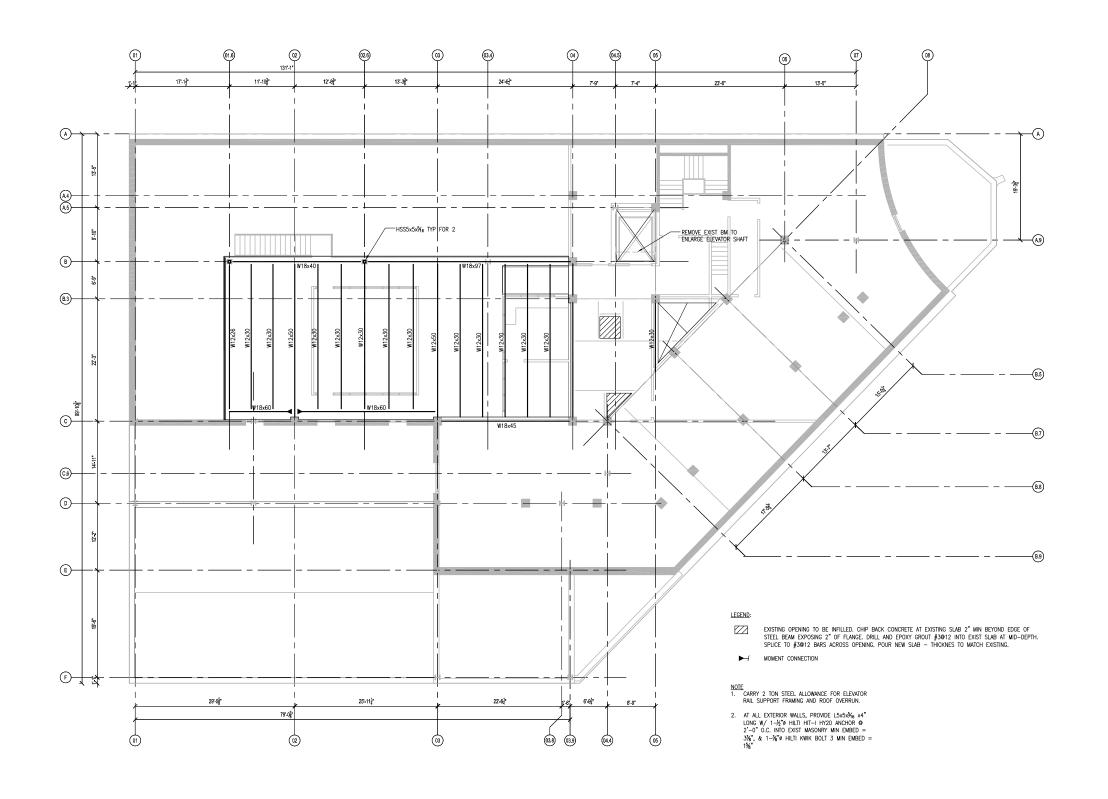
FOURTH FLOOR FRAMING PLAN

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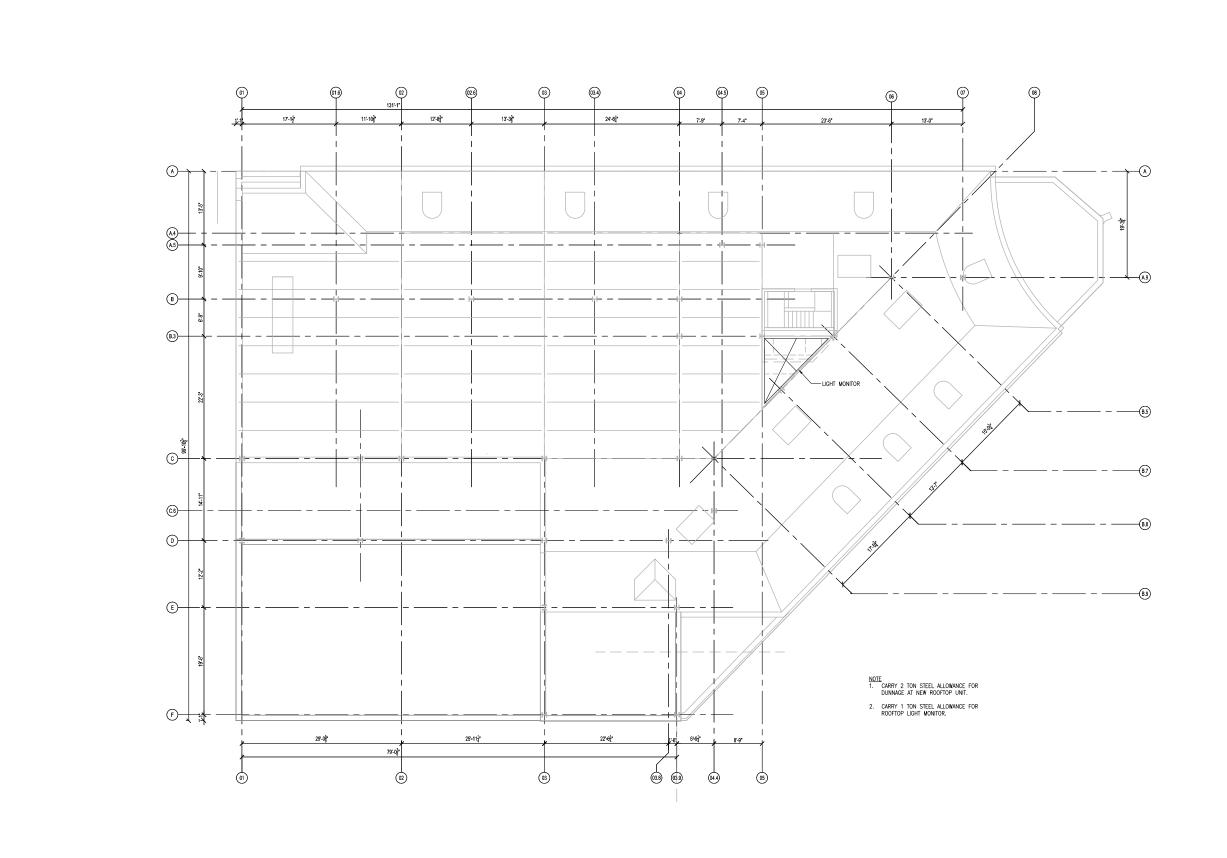
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