HATHAWAY LOFTS

15-33 RICHDALE AVENUE, CAMBRIDGE MA 02140



Drawing List

Special Permit Application and Open Space Diagram

Civil Engineering:

Existing Conditions Site Plan

Sediment & Erosion Control Plan

Site & Utility Plan

C3.0 Details

C3.1 Details

Landscape Architecture:

. Landscape Plan

Plant Materials

Architecture:

Site Context Plan

Shadow Studies

Existing Building Photos

Neighborhood Photos

Existing Building Photos

Existing Building Photos

Garage and First Floor Plans

Second Floor and Roof Plans

Bike Parking Plans

Rendered South Elevation

A201 Rendered North, West, and East Elevations

Building Sections

Perspective

Perspective

Perspective

Perspective

bhia

PROJECT NAME

Hathaway Lofts

Hathaway Partners, LLC.


PROJECT TEAM

CIVIL ENGINEER
Design Consultants, Inc.
120 Middlesex Avenue Suite 20
Somerville, MA 02145
617 776-3350

STRUCTURAL ENGINEER Veitas & Veitas Engineers, Ir 639 Granite Street Braintree, MA 02184 781 843-2863

Cover Sheet

COMMUTER RAIL

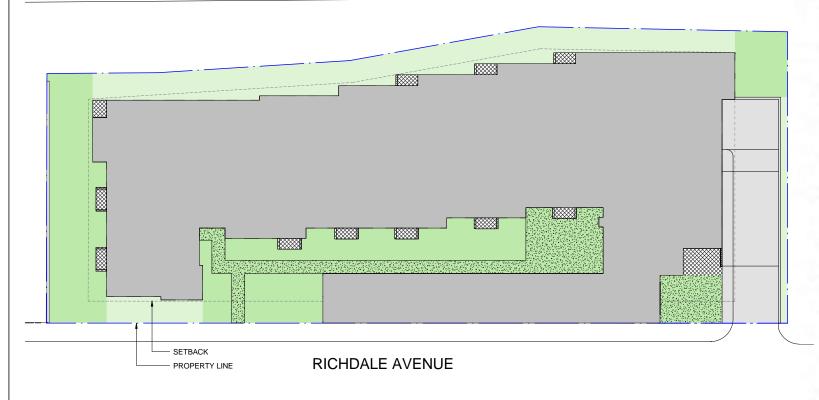

0 10 20	
	LEGEND
	PROPOSED BUILDING
	BALCONY OR OVERHANG
	INELIGIBLE OPEN SPACE
	OPEN SPACE
	OPEN SPACE - IMPERVIOUS
	OPEN SPACE LESS THAN 15'-0" IN WIDTH (EXCLUDED IN CALCULATIONS)

OPEN SPACE CALCULATIONS

	REQUIRED	PROPOSED	CALCULATED
PRIVATE OPEN SPACE	15%	21%	9,015 SF
PERMEABLE OPEN SPACE	50% OF PRIVATE OPEN SPACE	70%	6,308 SF

1 Open Space Plan and Calculations

DIMENSIONAL FORM

Project Address: 15-33 Richdale Avenue

Application Date: September 3, 2013

	Existing	Allowed or Required (max/min)	Proposed	Permitted
Lot Area (sq ft)	42,043	5,000	42,043	1
Lot Width (ft)	337	50	337	
Total Gross Floor Area (sq ft)	61,056	68,320	68,320	
Residential Base	0	52,554	52,554	
Non-Residential Base	61,056	0	0	
Inclusionary Housing Bonus	0	15,766	15,766	
Total Floor Area Ratio				
Residential Base	-	1.25	1.25	
Non-Residential Base	1.45	0	0	
Inclusionary Housing Bonus	-	0.30	0.30	
Total Dwelling Units	0	54	54	
Base Units	-	42	42	
Inclusionary Bonus Units	-	6	6	
Base Lot Area / Unit (sq ft)	-	1,000	1,001	
Total Lot Area / Unit (sq ft)	-	1 -	779	
Building Height(s) (ft)	+/- 30	45	45	
Front Yard Setback (ft)	0	10	new = 10	
Side Yard Setback – Side? (ft)	0	19	19	
Side Yard Setback – Side? (ft)	53	24	24	
Rear Yard Setback (ft)	3 to 13	65	10 minimum	
Open Space (% of Lot Area)				
Private Open Space	0	15%	21%	
Permeable Open Space	0	50% of P.O.S.	70% of P.O.S.	
Other Open Space (Specify)	0	1 4 6	-	
Off-Street Parking Spaces	20	54	54	
Bicycle Parking Spaces	0	56	56*	
Loading Bays	1	n/a	0	

Use space below and/or attached pages for additional notes:

* 56 Long term bike parking spaces will be provided in garage. In addition, 6 Short term bike parking spaces will be provided next to building entrance.

CITY OF CAMBRIDGE, MA . PLANNING BOARD . SPECIAL PERMIT APPLICATION

Bargmann Hendrie + Archetype, In 300 A Street Boston, MA 02210 617 350-0450 Tel 617 350-0215 Fax www.bhplus.com

PROJECT NAME

Hathaway Lofts

CLIENT

Hathaway Partners, LLC.

PROJECT TEAM

CIVIL ENGINEER
Design Consultants, Inc.
120 Middlesex Avenue Suite 20
Somerville, MA 02145
617 776-3350


STRUCTURAL ENGINEER
Veitas & Veitas Engineers, Inc.
639 Granite Street
Braintree, MA 02184
781 843-2863

MEP & FIRE PROTECTION ENGINEERS Allied Consulting Engineering Services, Inc. 215 Boston Post Road Sudbury, MA 01776 978 443-7888

DRAWING TITLE

Special Permit Application and Open Space Diagram



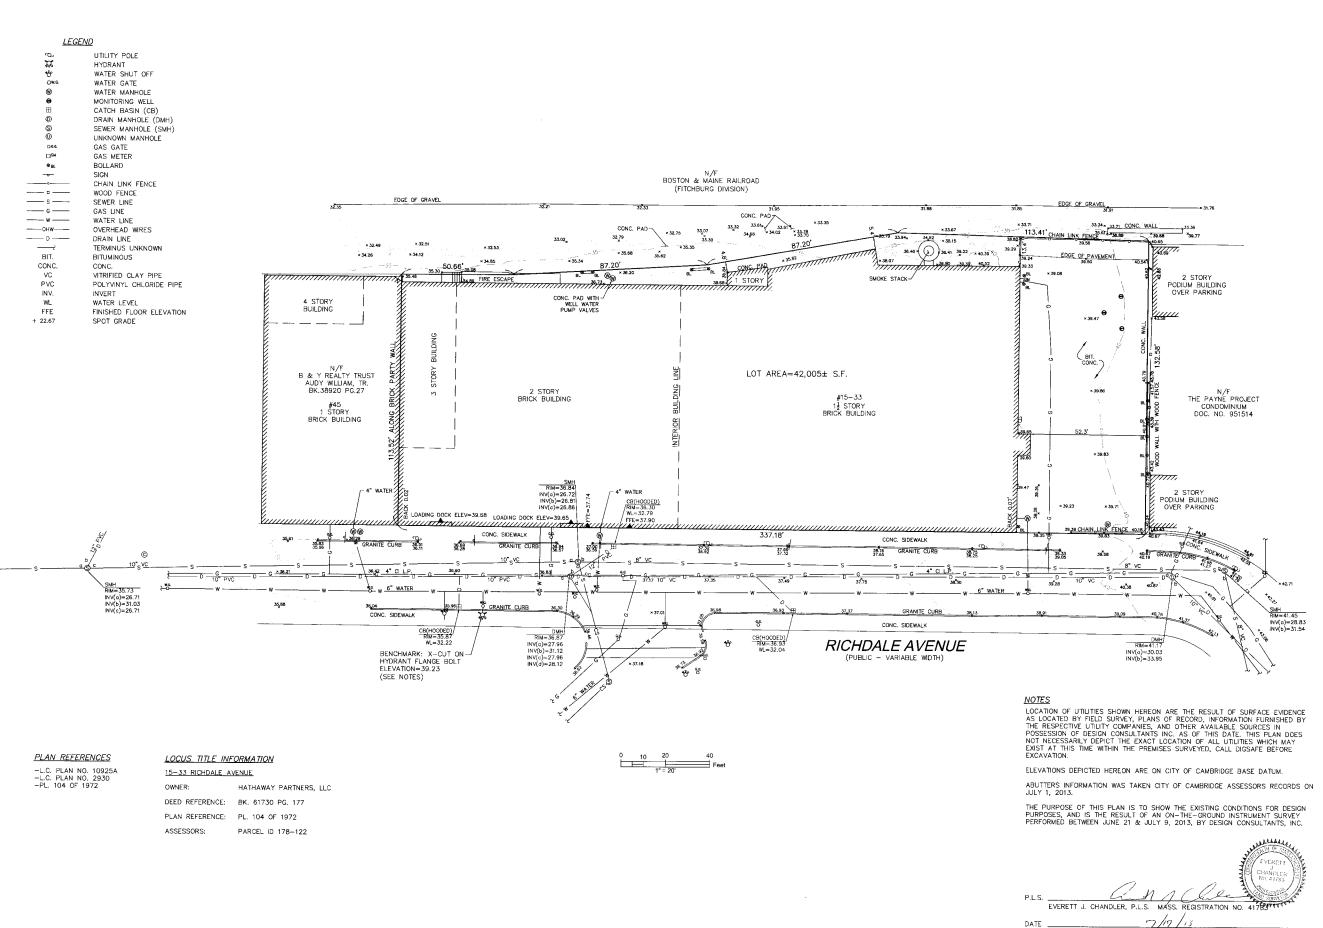

hhta

Bargmann Hendrie + Archetyp 300 A Street Boston, MA 02210 617 350-0450 Tel 617 350-0215 Fax www.bhplus.com

PROJECT NAME

Hathaway Lofts

15-33 Richdale Avenue Cambridge, MA 02140

_

Hathaway Partners LLC.

30 Brattle Street, 4th Floor Cambridge, MA 02138 617 864-8200

PROJECT TEAM

CIVIL ENGINEER
Design Consultants, Inc.
120 Middlesex Avenue Suite 20
Somerville, MA 02145
617 776-3350
617 776-7710

LANDSCAPE ARCHITECT

Kyle Zick Landscape Architecture,
Inc.

36 Bromfield Street Suite 202 Boston, MA 02108 617 451-1018 617 913-4663

STRUCTURAL ENGINEER
Veitas & Veitas Engineers, Inc.
639 Granite Street
Braintree, MA 02184
781 843-2863
781 849-2065

MECHANICAL, ELECTRICAL, PLUMBING ENGINEERS Allied Consulting Engineering Services, Inc. 215 Boston Post Road Sudbury, MA 01776 978 443-7888 978 443-658

REVISIONS

1 2 3 4 5 DATE

DRAWING TITLE

EXISTING CONDITIONS

DRAWING INFORMATION

Progress Drawings
DESCRIPTION

DESCRIPTION RUI

E ORAWN BY

3143_Richdale_A

ECT # FILE NAME

DRAWING NUMBER

C1.0

Copyright BH+A, Ir

PROJECT NAME AND LOCATION DESCRIPTION

SOIL CHARACTERISTICS

THE EXISTING SITE IS PRESENTLY PREDOMINANTLY DEVELOPED. THE UNDERLYING SOILS CONSIST

SEQUENCE OF MAJOR ACTIVITIES

THE TOTAL AREA TO BE DISTURBED IS APPROXIMATELY _____± ACRES.

- MISTALL ROSSON CONTROLS. CLEAR AND GRUB SITE.
 STRIP AND STOCKPILE TOPSONLS.
 CLEAR & GRUB, FELWOY E-AVEMENT, FENCES, ETC.
 CONSTRUCT BUILDING AND UTILITIES.
 CONSTRUCT FAVEWENT DRAWBATE SYSTEMS AND FINAL STABILIZATION OF SITE.
 CRISTRUCT FAVEWENT DRAWBAGE SYSTEMS AND FINAL STABILIZATION OF SITE.
 CRISTRUCT FAVEWENT DRAWBAGE SYSTEMS AND FINAL STABILIZATION OF SITE.
 CRISTRUCT FAVEWENT DRAWBAGE SYSTEMS FAVE FAVEWENT FAVEW

- EROSION AND SEDIMENT CONTROLS AND STABILIZATION PRACTICES STABILIZATION: AN AREA SHALL BE CONSIDERED STABILIZED ONCE DIE OF THE FOLLOWING HAS OCCURRED:

STABLIZATION: AN AREA SHALL BE CONSIDERED STABILIZED ONCE O'ME OF THE FOLLOWING HAS OCCURRED:

1. A MINIMUM OF 53X VECTATIVE GROWN HAS BEEN ESTABLISHED

2. A MINIMUM OF 53Y OF MON-EROSIVE MATERIAL SUCH AS STOWE OR RIP—RAP HAS BEEN INSTALLED

3. EROSION CONTROL BLANKETS HAVE BEEN PROPERLY INSTALLED.

5.TABLIZATION SHALL BE INITIATED ON ALL LOAM STOCKPILES AND DISTURBED AREAS WHERE CONSTRUCTION
ACTIVITY MILL NOT COCUR FOR MORE THAN THIRTY (SO) CALENDAR DAYS BY THE FOURTEENTH (14TH) DAY AFTER
CONSTRUCTION ACTIVICED FEMALWHILTY OF TEMPORATIVE CASED IN THAT AREA. ALL DISTURBED AREAS
SHALL BE STABLIZED WITHIN 72 HOURS OF ACTIVENING GRADE. STABLIZATION MEASURES TO BE USED INCLUDE:

- TEMPORARY SEEDING. MULCHING. STONE RIP RAP, JUTE MATTING.

DURING CONSTRUCTION, RUNOFF WILL BE DIVERTED AROUND THE SITE WITH EARTH DIKES, PIPING OR STABILIZED CHANNELS WHERE POSSIBLE. SHEET RUNOFF FROM THE SITE WILL BE FALTERED THROUGH HAY BALE BARRIERS AND/OR SLIT FARCES. ALL STORM DRAIN INTERS SHALL BE PROVIDED WITH BARRIER FALTERS. ALL CATCH BASINS WILL BE COVERED WITH A GEOTEXTILE FABRIC PRIOR TO THE BASE PAVEMENT COURSE BEING PLACED.

INSTALL SILT SACK INLET SEDIMENT-PROTECTION FOR DURATION OF CONSTRUCTION ACTIVITIES, TYPICAL

OFF SITE VEHICLE TRACKING

STABILIZED CONSTRUCTION ENTRANCES SHALL BE INSTALLED AT ALL EGRESSES TO THE SITE AND MAINTAINED FOR THE DURATION OF CONSTRUCTION.

TIMING OF CONTROLS/MEASURES

AS INDICATED IN THE SEQUENCE OF MAJOR ACTIVITIES THE AND SILT FENCES SHALL BE INSTALLED PRIOR TO COMMENCING ANY CLEARING OR BROING OF THE SITE. STRUCTURAL CONTROLS SHALL BE INSTALLED CONCURRENTLY WITH THE APPLICABLE ACTIVITY, AREAS WHERE CONSTRUCTION ACTIVITY. THE UPPORARLY CLEASES FOR WORSE THAN THERY (30) DAYS WILL BE STABILIZED WITH A TEMPORARY SEED AND MULCH WITHIN FOURTEEN (14) DAYS OF THE LAST DISTURBANCE. ONCE CONSTRUCTION. ACTIVITY CEASES PERMANENTLY IN AN AREA, SILT FENCES AND HAY BALE BARRIERS AND ANY EARTH/DIKES WILL BE REMOVED ONCE PERMANENT IMEASURES ARE ESTABLISHED.

STABILIZED CONSTRUCTION ENTRANCE

- A. AGGREGATE SIZE: USE TWO (2) INCHES STONE, OR RECLAMED OR RECYCLED CONCRETE EQUIVALENT.

 B. AGGREGATE THICKNESS: NOT LESS THAN SIX (6) INCHES.

 WOTH: TWILLY (12) FOOT MININUM, BUT NOT LESS THAN THE FULL MOTH OF POINTS WHERE INGRESS
 OR EGRESS OCCURS.

 D. ERNOTH: AS REQUIRED, BUT NOT LESS THAN FIFTY (50) FEET.
 E. GOURTHLE: TO BE PLACED OWER THE ENTIRE AREA TO BE COVERED WITH AGGREGATE, PIPING OF
 SURFACE WATER WHERE HYBRACE SHALL BE PROVIDED AS REQUIRED.

A. THE ENTRANCE SHALL BE MAINTAINED IN A CONDITION WHICH WILL PREVENT TRACKING OF SEDIMENT ONTO PUBLIC RIGHT-OF-WAY. WHEN WASHING IS REQUIRED, IT SHALL BE DONE ON AN AREA STABILIZED WITH AGORGETA WHICH DRANNS INTO AN APPROVED SEDIMENT TRAPPING DEVICE. ALL SEDIMENT SHALL BE PREVENTED FROM ENTERING STORM DRAINS, DITCHES, OR WATERWAYS.

WASTE DISPOSAL

1 WASTE MATERIALS

A ALL WASTE MATERIALS WILL BE COLLECTED AND STORED IN SECURELY LIDDED RECEPTACLES, ALL
TRASH AND CONSTRUCTION DEBRIS FROM THE SITE WILL BE DEPOSITED IN A DUMPSTER, NO
CONSTRUCTION WASTE MATERIALS WILL BE BURBED ON STEE ALL PERSONNEL WILL BE MISTRUCTED
REGARDING THE CORRECT PROCEDURE FOR WASTE DISPOSAL BY THE SUPERINTENDENT.

2. HAZARDOUS WASTE

A. ALL HAZARDOUS WASTE MATERIALS WILL BE DISPOSED OF IN THE MANNER SPECIFIED BY LOCAL OR STATE REGULATION OR BY THE MANUFACTURER. SITE PERSONNEL WILL BE INSTRUCTED IN THESE PRACTICES BY THE SUPERINTENDENT.

3. SANITARY WASTE

A. ALL SANITARY WASTE WILL BE COLLECTED FROM THE PORTABLE UNITS A MINIMUM OF ONCE PER WEEK BY A LICENSED SANITARY WASTE MANAGEMENT CONTRACTOR.


ADDITIONAL NOTES FOR WINTER CONSTRUCTION

- 1. ALL PROPOSED POST-DEVELOPMENT LANDSCAPED AREAS WHICH DO NOT EMHBIT A MINNUM OF 85% VEGETATURE GROWTH BY NOVEMBER 15TH, OR WHICH ARE DISTURBED AFTER NOVEMBER 15TH, SHALL BE STABILIZED BY SEEDING AND INSTALLINE GROSION CONTROL BLANKETS OF SICKIES GREATER THAN 4:1 AND SEEDING AND PLACING 3 TO 4 TONS OF MULCH PER ACRE, SECURED WITH ANCHORED NETTING, ELSEWINER: THE PLACEMENT OF ERSORN CONTROL BLANKETS OR MULCH AND NETTING SHALL NOT OCCUR OVER ACCUMULATED SNOW OR FROZEN GROUND.
- AFTER NOVEMBER 15TH, ALL TRAVEL SURFACES SHALL BE PROTECTED WITH A MINIMUM OF 3-MCMES OF CRUSHED GRAVEL OR IF CONSTRUCTION IS TO CONTINUE THROUGH THE MINTER SEASON BE CLEARED OF ANY ACCULULATED SNOWEALL AFTER EACH STOME VEWENT.

THE CONTRACTOR SHALL BE RESPONSIBLE TO CONTROL DUST THROUGHOUT THE CONSTRUCTION PERIOD. DUST CONTROL METHODS SHALL INCLUDE, BUT NOT LIMITED TO SPRINKLING WATER ON EXPOSED AREAS, COVERING LOADED DUMP TRUCKS LEAVING THE SITE, AND TEMPORARY MULCHING, DUST CONTROL, MEASURES SHALL BE UTILIZED SO AS TO PREVENT THE MIGRATION OF DUST FROM THE SITE TO ABUTTING AREAS.


ADDITIONAL NOTES FOR DRAINAGE INFILTRATION SYSTEMS

1. THE CONTRACTOR SHALL INSURE NO SEDIMENT ENTERS THE INFILTRATION BASINS DURING CONSTRUCTION, ADDITIONALLY NO SEDIMENT SHALL BE ALLOWED INTO THE DRAINAGE SYSTEM UPON COMPLETION OF THE SYSTEM, ALL SILITATION BARRERS SHALL BE INSPECTED DALLY AND CLEAMED AND MAINTAINED. SILTSACKS SHALDLUD BE REFLACED BI-WEEKLY OF AFTER ANY STORM EVENT IN EXCESS OF OS INCHES. STORM EXPLAINTY UNITS SHALL BE INSPECTED DALLY AND UNITS SHALL BE CLEARED IF ANY EMDIRED SEDIMENT.

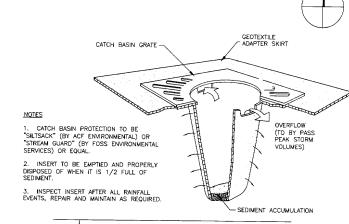

SILT SACK @ CATCH BASINS

NOT TO SCALE

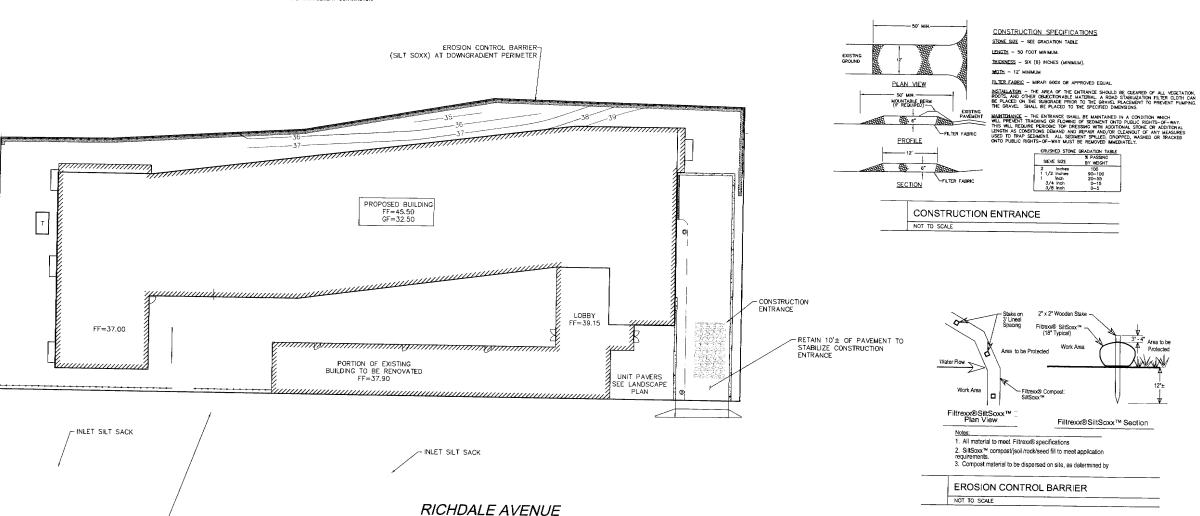

Boston, MA 02210 617 350-0215 Fax

PROJECT NAME

ARCHITECT

Hathaway Lofts

15-33 Richdale Avenue Cambridge, MA 02140

Hathaway Partners LLC.

30 Brattle Street, 4th Floor Cambridge, MA 02138

PROJECT TEAM

CIVIL ENGINEER Design Consultants, Inc. 120 Middlesex Avenue Suite 20 Somerville, MA 02145 617 776-3350 617 776-7710

LANDSCAPE ARCHITECT

Kyle Zick Landscape Architecture 36 Bromfield Street Suite 202 Boston, MA 02108 617 451-1018 617 913-4663

STRUCTURAL ENGINEER Veitas & Veitas Engineers, Inc. 639 Granite Street Braintree, MA 02184 781 843-2863 781 849-2065

MECHANICAL, ELECTRICAL, PLUMBING ENGINEERS PLUMBING ENGINEERS Allied Consulting Engineering Services, Inc. 215 Boston Post Road Sudbury, MA 01776 978 443-7888 978 443-4635

REVISIONS

DRAWING TITLE

SEDIMENT AND **EROSION CONTROL PLAN** (DRAFT)

DRAWING INFORMATION

DRAFT

Progress Drawings

DRAWING NUMBER

0 10 20 40

- THIS PLAN DOES NOT NECESSARILY DEPICT THE EXACT LOCATION AND SIZE OF ALL UTILITIES WHICH MAY EXIST AT THIS TIME INSIDE OR OUTSIDE OF EXISTING OR PROPOSED BUILDINGS, ON THE SUBJECT PROPERTY, WITHIN THE STREET R.O.W. OR ON ABUTTING LOTS.
- 2. THE CONTRACTOR IS RESPONSIBLE FOR VERIFYING AND RECORDING THE LOCATION OF EACH
- 3. THE CITY OF CAMBRIDGE MUNICIPAL UTILITIES (WATER, SEWER & DRAIN) MAY NOT BE PART OF DIG-SAFE. THE CONTRACTOR SHALL CONTACT THE CITY OF CAMBRIDGE FOR THE MARKING OF CAMBRIDGE MUNICIPAL UTILITIES, AND SHALL ALSO CONTACT DIG-SAFE AT 1-888-344-7233 OR 1-800-322-4844 AT LEAST 72 HOURS PRIOR TO EXCAVATION.
- 4. THE CONTRACTOR SHALL SUPPLY ALL PIPING, STRUCTURES, MATERIALS, AND APPURTENANCES, NECESSARY TO PERFORM ALL WET AND/OR DRY TAPS AS PART OF THIS CONTRACT.
- 5. NEW WATER SERVICES MUST BE LEFT SHUT OFF AT THE MAIN ON THE STREET UNTIL ACTIVATED BY THE CITY OF CAMBRIDGE.
- A DYE TEST SHALL BE PERFORMED BY A CITY OF CAMBRIDGE INSPECTOR PRIOR TO THE ISSUANCE OF AN OCCUPANCY PERMIT.
- 7. THE RESPONSIBILITY OF OWNERSHIP AND MAINTENANCE OF THE SEWER, WATER, AND DRAIN CONNECTIONS ON PRIVATE PROPERTY AND/OR PRIVATE AND PUBLIC WAYS SHALL REMAIN THAT OF THE OWNER.
- 8. THE CITY OF CAMBRIDGE RESERVES THE RIGHT TO INSPECT ALL PRIVATE FACILITIES DISCHARGING TO MUNICIPAL FACILITIES.
- 9. DURING EXCAVATION AND CONSTRUCTION OF PIPES AND STRUCTURES, TRENCHES MUST BE ADEQUATELY BRACED AND PROTECTED AGAINST CAVE-IN.
- 10. ALL WORK PERFORMED AS PART OF THIS PROJECT SHALL CONFORM TO STANDARDS OF THE CITY OF CAMBRIDGE, DEPARTMENT OF PUBLIC WORKS AND ANY OTHER AGENCY OR BODY WITH AUTHORITY IN THIS AREA.

- 11. ALL EXISTING UTILITY SERVICE CONNECTIONS, SEWER DISPOSAL FACILITIES, AND WELLS SHALL BE ABANDONED UNLESS NOTED OTHERWISE. THE CONTRACTOR IS RESPONSIBLE FOR VERIFYING THE EXACT LOCATION OF EACH CONNECTION. THE WATER, DRAIN, AND SEWER SERVICES SHALL BE CAPPED AND CUT AT THE MAIN IN THE STREET BY THE CONTRACTOR. ABANDOMMENT OF EXISTING CONNECTIONS SHALL BE COORDINATED BY THE CONTRACTOR WITH THE RESPECTIVE
- 12. ALL UTILITIES SHOWN ON THIS SITE ARE TO THE EXTERIOR OF THE BUILDING FOUNDATION ONLY. UTILITIES THROUGH THE FOUNDATION AND INSIDE THE BUILDING ARE APPROXIMATE AND THE RESPONSIBILITY OF THE MECHANICAL ENGINEER. (SEE MECHANICAL ENGINEER PLANS)
- CONTRACTOR SHALL ADJUST ALL GATES, SERVICE BOXES, ETC. WITHIN THE RECONSTRUCTION OF THE SIDEWALK AREA.
- 14. FOR ZONING REQUIREMENTS AND SETBACK INFORMATION, SEE ARCHITECTURAL DRAWING AND ZONING COMPLIANCE PLAN.
- 15. GRADES PROVIDED ARE INTERPOLATED FROM EXISTING CONDITIONS SURVEY. CONTRACTOR SHALL MEET THE EXISTING, UNEXCAVATED TOP OF CURB GRADE AND SIDEWALK GRADE AT THE LIMIT OF WORK.
- 16. ELEVATIONS DEPICTED HEREON ARE ON CITY OF CAMBRIDGE BASE DATUM.

PIPE MATERIALS:

DOMESTIC WATER SERVICE: CEMENT-LINED DUCTILE IRON (CLDI) CLASS 52 OR COPPER TYPE K (SIZE AND MATERIAL AS NOTED ON PLAN)

FIRE SERVICE: CEMENT-LINED DUCTILE IRON (CLDI) CLASS 52 OR COPPER TYPE K (SIZE AND MATERIAL AS NOTED ON PLAN)

SEWER SERVICE: PVC ASTM D3034-SDR 35 SIZE TO BE DETERMINED BY MEP SLOPE=0.020 FT/FT (MINIMUM)

STORM DRAIN: PVC ASTM D3034-SDR 35 SIZE AS NOTED
SLOPE=0.010 FT/FT (MINIMUM)

CONCRETE THRUST BLOCKS TO BE USED ONLY WHERE IT WILL BEAR ON UNDISTURBED EARTH. USE RESTRAINED JOINT FITTINGS (MEGALUG OR APPROVED EQUAL) WHERE CONCRETE THRUST BLOCK IS UNACCEPTABLE. SIZE OF BLOCK OR MEGALUG TO BE DESIGNED FOR SPECIFIC

SEWER CLEANOUTS & INTERNAL SEWER SERVICES:

THE OWNER SHALL FURNISH AND INSTALL ALL SEWER CLEANOUTS. EXACT LOCATION OF ALL SEWER CLEANOUTS AND INTERNAL SEWER SERVICES TO BE CONFIRMED/ COORDINATED BY MECHANICAL ENGINEER AND ARCHITECT.

ALL WATER SERVICE AND WATER MAIN PIPING SHALL BE INSTALLED WITH A MINIMUM COVER OF FIVE (5) FEET THROUGHOUT.

ARCHITECT

Bargmann Hendrie + Archetype, In 300 A Street Boston, MA 02210 617 350-0450 Tel 617 350-0215 Fax www.bhplus.com

PROJECT NAME

Hathaway Lofts

15-33 Richdale Avenue Cambridge, MA 02140

CLIENT

Hathaway Partners LLC.

30 Brattle Street, 4th Floor Cambridge, MA 02138 617 864-8200

PROJECT TEAM CIVIL ENGINEER

Somerville, MA 02145 617 776-3350

LANDSCAPE ARCHITECT Kyle Zick Landscape Architecture

STRUCTURAL ENGINEER Veitas & Veitas Engineers, Inc 639 Granite Street

639 Granite Street Braintree, MA 02184 781 843-2863 781 849-2065

MECHANICAL, ELECTRICAL, PLUMBING ENGINEERS Allied Consulting Engineering Services, Inc. 215 Boston Post Road Sudbury, MA 01776

REVISIONS

SITE &

DRAWING TITLE


UTILITY PLAN





Progress Drawings

SCALE DRAWN BY

DRAWING NUMBER

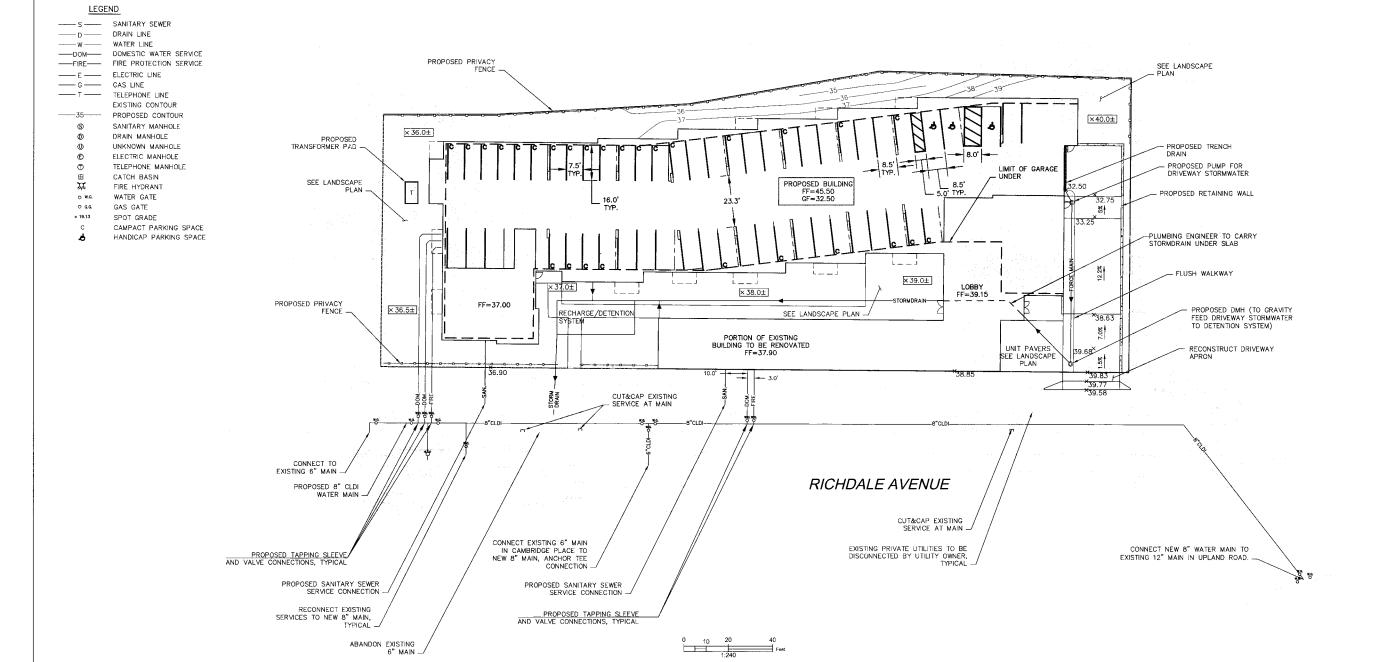

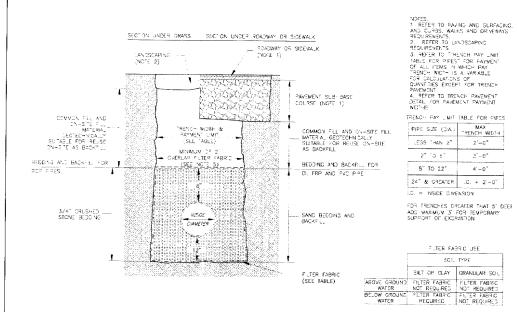

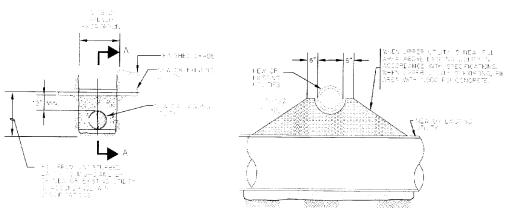

TRENCH DETAIL FOR SEWER AND DRAIN PIPES

ELEVATION

SECTION A-A


2'-0"

3'-0"

4'-0"

SCIL TYPE


UTILITY CROSSING NOT TO SCALE

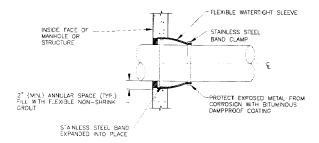

NOTE:

1. PRECAST OPENING OR CORE DRILLED INTO EXISTING STRUCTURE. SIZE VARIES TO ACCOMMODATE EXTENSION BONNET FLANCE DIAMETER OR PIPE.


FLEXIBLE SLEEVE CONNECTION NOT TO SCALE

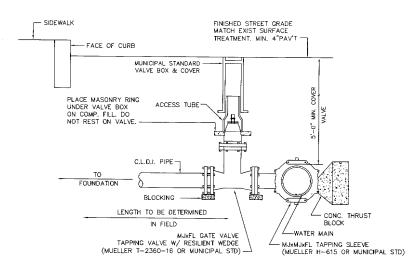


NOTE: 1. ALL WATER DISTRIBUTION VALVES, FITTINGS, AND PIPING SHALL COMPLY WITH ALL MUNICIPAL STANDARDS.

2. DETAIL UTILIZED FOR 4, 6, OR 8 INCH SERVICE PIPE.

WATER CONNECTION WITH WET TAP FOR 4 & 6 INCH SERVICE PIPE NOT TO SCALE

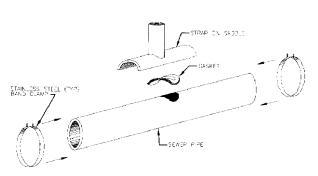


SADDLE CONNECTION - PLAN

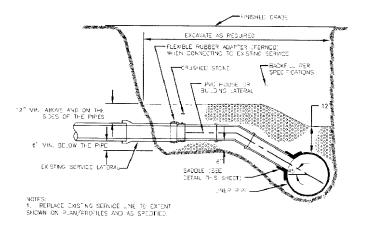


SADDLE CONNECTION - SECTION

SADDLE CONNECTION FOR SEWER OR DRAIN

NOT TO SCALE

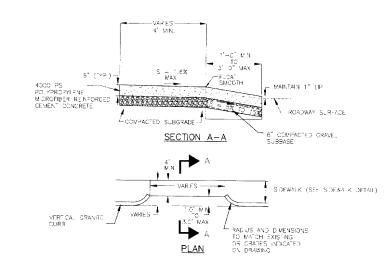




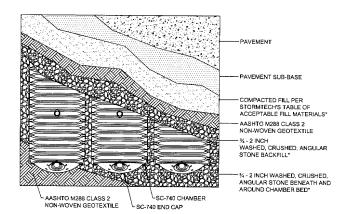

STORMTECH SC-740 CHAMBER SYSTEM PLAN VIEW DETAIL NOT TO SCALE

FOR STORMTECH INFORMATION CALL 1-888-892-2694 * SEE STORMTECH'S DESIGN MANUAL

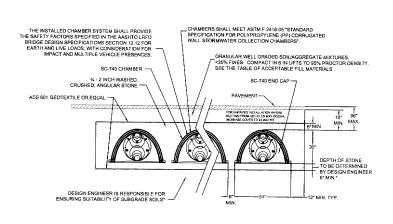

INFILTRATION/DETENTION SYSTEM

NOT TO SCALE

ARCHITECT

bhta

Bargmann Hendrie + 300 A Street Boston, MA 02210 617 350-0450 Tel 617 350-0215 Fax

PROJECT NAME

Hathaway Lofts

15-33 Richdale Avenue Cambridge, MA 02140

CLIENT

Hathaway Partners LLC.

30 Brattle Street, 4th Floor Cambridge, MA 02138 617 864-8200 617 864-8201

PROJECT TEAM

CIVIL ENGINEER
Design Consultants, Inc.
120 Middlesex Avenue Suite 20
Somerville, MA 02145

Kyle Zick Landscape Architecture

Inc. 36 Bromfield Street Suite 202 Boston, MA 02108 617 451-1018 617 913-4663

STRUCTURAL ENGINEER Veitas & Veitas Engineers, Inc. 639 Granite Street Braintree, Ma 02184 781 843-2963 781 849-2065

MECHANICAL, ELECTRICAL, PLUMBING ENGINEERS Allied Consulting Engineering Services, Inc. 215 Boston Post Road Sudbury, MA 01776 978 443-7888 978 443-4636


DRAWING TITLE

DETAILS


August 2, 2013 DATE OF ISSUE RLB DRAWN BY

COA = 3143_Richdale_Aven PROJECT #

C3.0

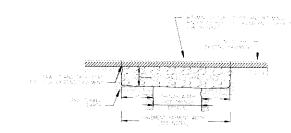

PAVEMENT TRENCH PATCH NOT TO SCALE

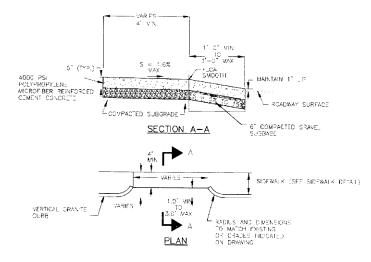

CEMENT CONCRETE DRIVEWAY APRON NOT TO SCALE

ARCHITECT

bhta

Bargmann Hendrie + Archetype, Inc 300 A Street Boston, MA 02210 617 350-0450 Tel 617 350-0215 Fax www.bhplus.com

PROJECT NAME

Hathaway Lofts

15-33 Richdale Avenue Cambridge, MA 02140

CLIENT

Hathaway Partners LLC.

30 Brattle Street, 4th Floor Cambridge, MA 02138 617 864-8200 617 864-8201

PROJECT TEAM

CIVIL ENGINEER
Design Consultants, Inc.
120 Middlesex Avenue Suite 20
Somerville, MA 02145
617 776-3350
617 776-7710

LANDSCAPE ARCHITECT Kyle Zick Landscape Architectu

Inc. 36 Bromfield Street Suite 202 8oston, MA 02108 617 451-1018 617 913-4663

STRUCTURAL ENGINEER Veltas & Veltas Engineers, Inc. 639 Granite Street Braintree, MA 02/144 781 843-2863 781 849-2065

MECHANICAL, ELECTRICAL, PLUMBING ENGINEERS Allied Consulting Engineering Services, inc. 215 Boston Post Road Suddury, MA 01776 978 443-7888 978 443-4636

DRAWING TITLE

DETAILS

DRAWING INFORMATION



August 2: 2013 DATE OF ISSUE

RLB

SCA_E DRAWN BY

3143 3143_Richdele_Ave.nt

PROJECT # FLE NAME

DRAWING NUMBER

C3.1





ARCHITECT bhta

PROJECT NAME

Hathaway Lofts

15-33 Richdale Avenue Cambridge, MA 02140

CLIENT

Hathaway Partners LLC.

30 Brattle Street, 4th Floor Cambridge, MA 02138 617 864-8200 617 864-8201

PROJECT TEAM

CIVIL ENGINEER
Design Consultants, Inc.
120 Middlesex Avenue Suite 20
Somerville, MA 02145
617 776-3350
617 776-7710

LANDSCAPE ARCHITECT

Kyle Zick Landscape Architectu 36 Bromfield Street, Suite 202 Boston, MA 02108 617 451-1018 617 913-4663

STRUCTURAL ENGINEER Veitas & Veitas Engineers, Inc. 639 Granite Street Braintree, MA 02184 781 843-2863 781 849-2065

MECHANICAL, ELECTRICAL, PLUMBING ENGINEERS Allied Consulting Engineering Services, Inc. 215 Boston Post Road Sudbury, MA 01776 978 443-7888 978 443-4636

REVISIONS

	1
	2
	3
	4
	5
DA	

DRAWING TITLE

Landscape Plan

DRAWING INFORMATION

August 13, 2013 DATE OF ISSUE

1"=20'-0" YJL

SCALE DRAWN BY

3143 xr-site dwg

PROJECT # FILE NAME

DRAWING NUMBER

L-01



Bargmann Hendrie + Arci 300 A Street Boston, MA 02210 617 350-0450 Tel 617 350-0215 Fax www.bhplus.com

PROJECT NAME

Hathaway Lofts

CLIENT

Hathaway Partners LLC.

30 Brattle Street, 4th Floor Cambridge, MA 02138 617 864-8200 617 864-8201

PROJECT TEAM

CIVIL ENGINEER
Design Consultants, Inc.
120 Middlesex Avenue Suite 20
Somerville, MA 02145
617 776-3350
617 776-7710

LANDSCAPE ARCHITECT Kyle Zick Landscape Architectur 36 Bromfield Street, Suite 202 Boston, MA 02108 617 451-1018 617 913-4663

STRUCTURAL ENGINEER Veitas & Veitas Engineers, Inc 639 Granite Street Braintree, Ma 02/144 781 843-2863 781 849-2065

DRAWING TITLE

Plant Materials

DRAWING INFORMATION

Bargmann Hendrie + Arche 300 A Street Boston, MA 02210 617 350-0450 Tel 617 350-0215 Fax www.bhplus.com

PROJECT NAME

Hathaway Lofts

CLIENT

Hathaway Partners, LLC.

30 Brattle Street, 4th Floor Cambridge, MA 02138 617 864-8200

PROJECT TEAM

CIVIL ENGINEER
Design Consultants, Inc.
120 Middlesex Avenue Suite 20
Somerville, MA 02145
617 776-3350

LANDSCAPE ARCHITECT Kyle Zick Landscape Architectu

STRUCTURAL ENGINEER
Veitas & Veitas Engineers, Inc.
639 Granite Street
Braintree, MA 02184
781 843-2863


MEP & FIRE PROTECTION ENGINEERS Allied Consulting Engineering Services, Inc. 215 Boston Post Road Sudbury, MA 01776 978 443-7888

Site Context Plan


Car Share Location

AS100




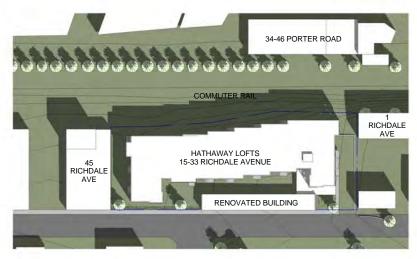


(1B) March 21 12 pm

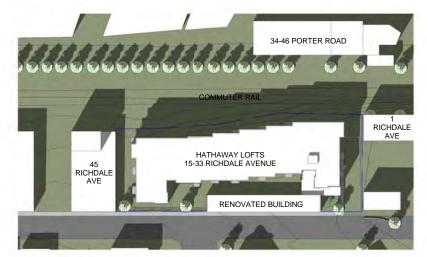


(1C) March 21 3 pm

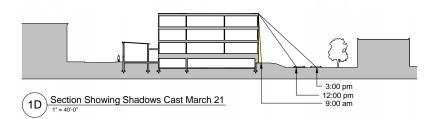


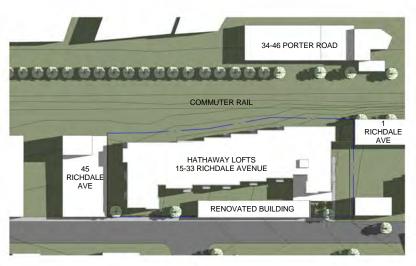


(2A) June 21 9 am

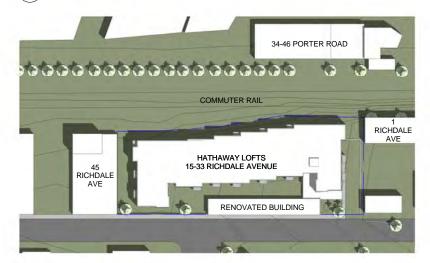


2B June 21 12 pm

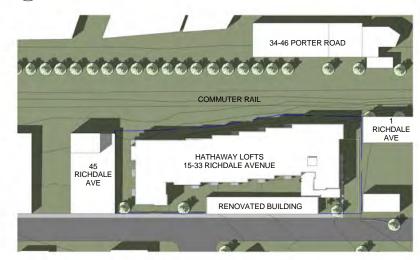


(2C) June 21 3 pm

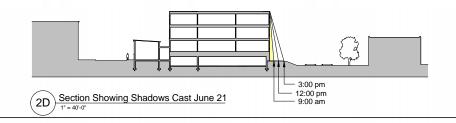


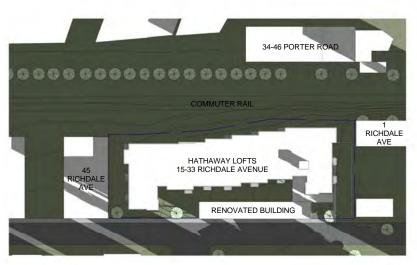

(3A) December 21 9 am

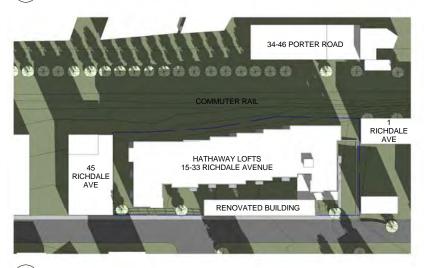


(3B) December 21 12 pm

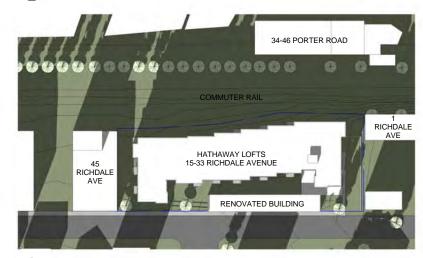

(3C) December 21 3 pm

THIS DIAGRAM REPRESENTS THE MOST EXTREME ANNUAL SHADING

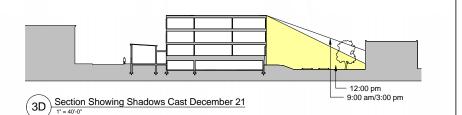

bhia

Bargmann Hendrie + Arche 300 A Street Boston, MA 02210 617 350-0450 Tel 617 350-0215 Fax

www.bhplus.com PROJECT NAME

Hathaway Lofts

15-33 Richdale Avenue Cambridge, MA 02140

CLIENT

Hathaway Partners, LLC.

30 Brattle Street, 4th Floor Cambridge, MA 02138 617 864-8200

PROJECT TEAM

CIVIL ENGINEER
Design Consultants, Inc.
120 Middlesex Avenue Suite 20
Somerville, MA 02145
617 776-3350

LANDSCAPE ARCHITECT Kyle Zick Landscape Architecture

STRUCTURAL ENGINEER Veitas & Veitas Engineers, Inc. 639 Granite Street Braintree, MA 02184 781 843-2863

MEP & FIRE PROTECTION ENGINEERS Allied Consulting Engineering Services, Inc. 215 Boston Post Road Sudbury, MA 01776 978 443-7888

REVISIONS

DRAWING TITLE

Shadow Studies

DRAWING INFORMATION

September 3, 2013

DATE OF ISSUE Special Permit Application
DESCRIPTION

1" = 40'-0" MRY

SCALE DRAWN BY 3143 3143_Richdale_Ave.rvt
PROJECT # FILE NAME

DRAWING NUMBER

AS101



Existing Building Looking East on Richdale Avenue



2 Existing Building Looking West on Richdale Avenue





4 Existing Building Entrance



5 Existing Center Bays



Existing End Bays 6



Rear Side of Existing Building Showing Areas of Repaired Facade Failure



8 Existing Building Looking East on Rail Road Right-of-Way



9 Existing Building Looking West on Rail Road Right-of-Way



Bargmann Hendrie + Arch 300 A Street Boston, MA 02210 617 350-0450 Tel 617 350-0215 Fax www.bhplus.com

PROJECT NAME **Hathaway Lofts**

15-33 Richdale Avenue Cambridge, MA 02140

CLIENT

Hathaway Partners, LLC.

30 Brattle Street, 4th Floor Cambridge, MA 02138 617 864-8200

PROJECT TEAM

CIVIL ENGINEER
Design Consultants, Inc.
120 Middlesex Avenue Suite 20
Somerville, MA 02145
617 776-3350

LANDSCAPE ARCHITECT

Kyle Zick Landscape Architecture

STRUCTURAL ENGINEER
Veitas & Veitas Engineers, Inc.
639 Granite Street
Braintree, MA 02184
781 843-2863

MEP & FIRE PROTECTION ENGINEERS Allied Consulting Engineering Services, Inc. 215 Boston Post Road Sudbury, MA 01776 978 443-7888

DRAWING TITLE

Existing **Building Photos**

DRAWING INFORMATION

3143 3143_Richdale_Ave.nt
PROJECT# FILE NAME

X001



1 Looking West from Upland Road



2 Looking West Along Richdale Avenue



Property Across the Street from Existing Building



General Residential Context Across the Street from Existing Building



General Residential Context Across the Street from Existing Building




6 Looking East Along Richdale Avenue



Property to the East of Existing Building



8 Looking East Along Richdale Avenue

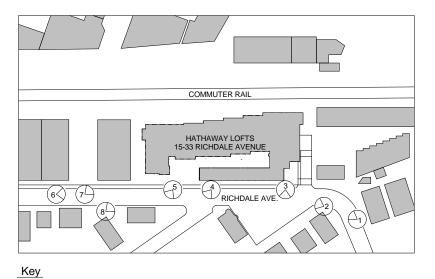



Bargmann Hendrie + Arct 300 A Street Boston, MA 02210 617 350-0450 Tel 617 350-0215 Fax www.bhplus.com

PROJECT NAME

Hathaway Lofts

15-33 Richdale Avenue Cambridge, MA 02140

CLIENT

Hathaway Partners, LLC.

30 Brattle Street, 4th Floor Cambridge, MA 02138 617 864-8200

PROJECT TEAM

CIVIL ENGINEER
Design Consultants, Inc.
120 Middlesex Avenue Suite 20
Somerville, MA 02145
617 776-3350

LANDSCAPE ARCHITECT

Kyle Zick Landscape Architecture

STRUCTURAL ENGINEER
Veitas & Veitas Engineers, Inc.
639 Granite Street
Braintree, MA 02184
781 843-2863

MEP & FIRE PROTECTION ENGINEERS Allied Consulting Engineering Services, Inc. 215 Boston Post Road Sudbury, MA 01776 978 443-7888

REVISIONS	3	
1		
2		
3		
4		
5		Ī

DRAWING TITLE

Neighborhood Photos

DRAWING INFORMATION

3143 3143_Richdale_Ave.rvt
PROJECT # FILE NAME
Printed on Konica 360 EFIRGB 90%

X002

Existing stucco entry is lacking in detail and execution. It is also not handicapped accessible.




Roof eave requires significant repair. Windows and trim need replacement.



Window sills are above a pedestrian's head height and the wall is flush to the property line with zero setback.

The exterior facade is in poor condition, especially at the foundation where rebar is exposed.

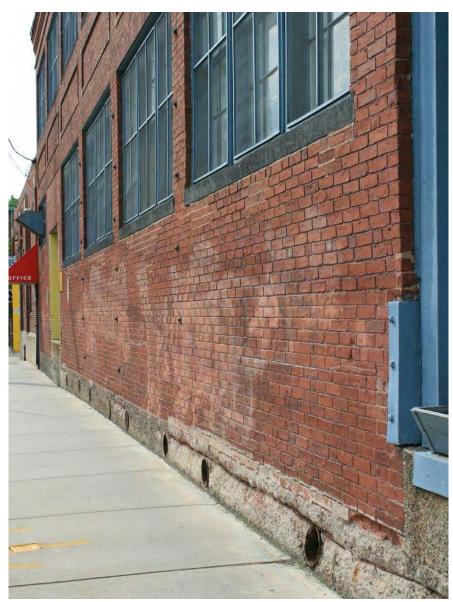

Bargmann Hendrie + 300 A Street Boston, MA 02210 617 350-0450 Tel 617 350-0215 Fax www.bhplus.com

PROJECT NAME

Hathaway Lofts

CLIENT

Hathaway Partners, LLC.

PROJECT TEAM

CIVIL ENGINEER
Design Consultants, Inc.
120 Middlesex Avenue 9
Somerville, MA 02145
617 776-3350

STRUCTURAL ENGINEER
Veitas & Veitas Engineers, Inc
639 Granite Street
Braintree, MA 02184
781 843-2863

DRAWING TITLE

Existing Building Photos

X003




The design proposal is to remove the two story section of the building to create relief and add green space and trees to the streetscape.



The one story section of the building is a better representation of the original bakery facade.



This bay of the building has been adapted over time and no longer bears resemblance to the original 1910 design.

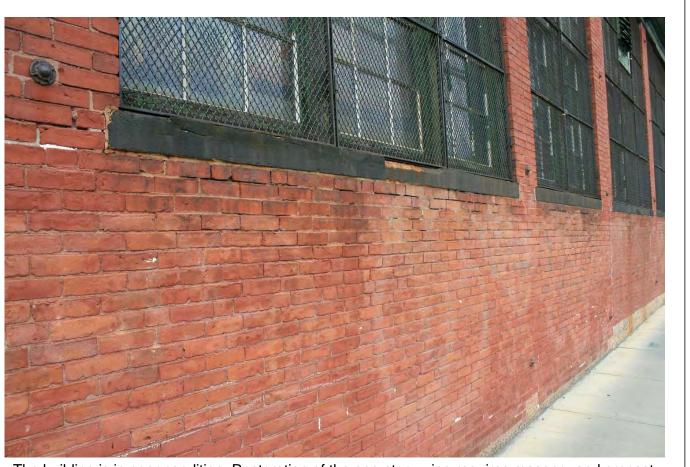

The building is in poor condition. Restoration of the one-story wing requires masonry and precast restoration and new windows.

ARCHITE

bha

Bargmann Hendrie + Archetype 300 A Street Boston, MA 02210 617 350-0450 Tel 617 350-0215 Fax www.bhplus.com

PROJECT NAME

Hathaway Lofts

15-33 Richdale Avenue

Hathaway Partners, LLC.

30 Brattle Street, 4th Floor Cambridge, MA 02138

PROJECT TEAM

CIVIL ENGINEER

Design Consultants, Inc.
120 Middlesex Avenue Suit
Somerville, MA 02145

LANDSCAPE ARCHITECT

Inc. 36 Bromfield Street Suite 202 Boston, MA 02108 617 451-1018

> Veitas & Veitas Engineers, In 639 Granite Street

Braintree, MA 02184 781 843-2863

MEP & FIRE PROTECTION
ENGINEERS
Allied Consulting Engineer

Services, Inc. 215 Boston Post Road Sudbury, MA 01776 978 443-7888

DEVIOLO

1 2 2 3 4 5 DATE

DRAWING TITL

Existing Building Photos

DRAWING INFORMATION


Special Permit Application
DESCRIPTION

Author
CALE DRAWN BY
143 3143_Richdale_A

DRAWING NUMBER

X004

Copyright BH+A, Inc.

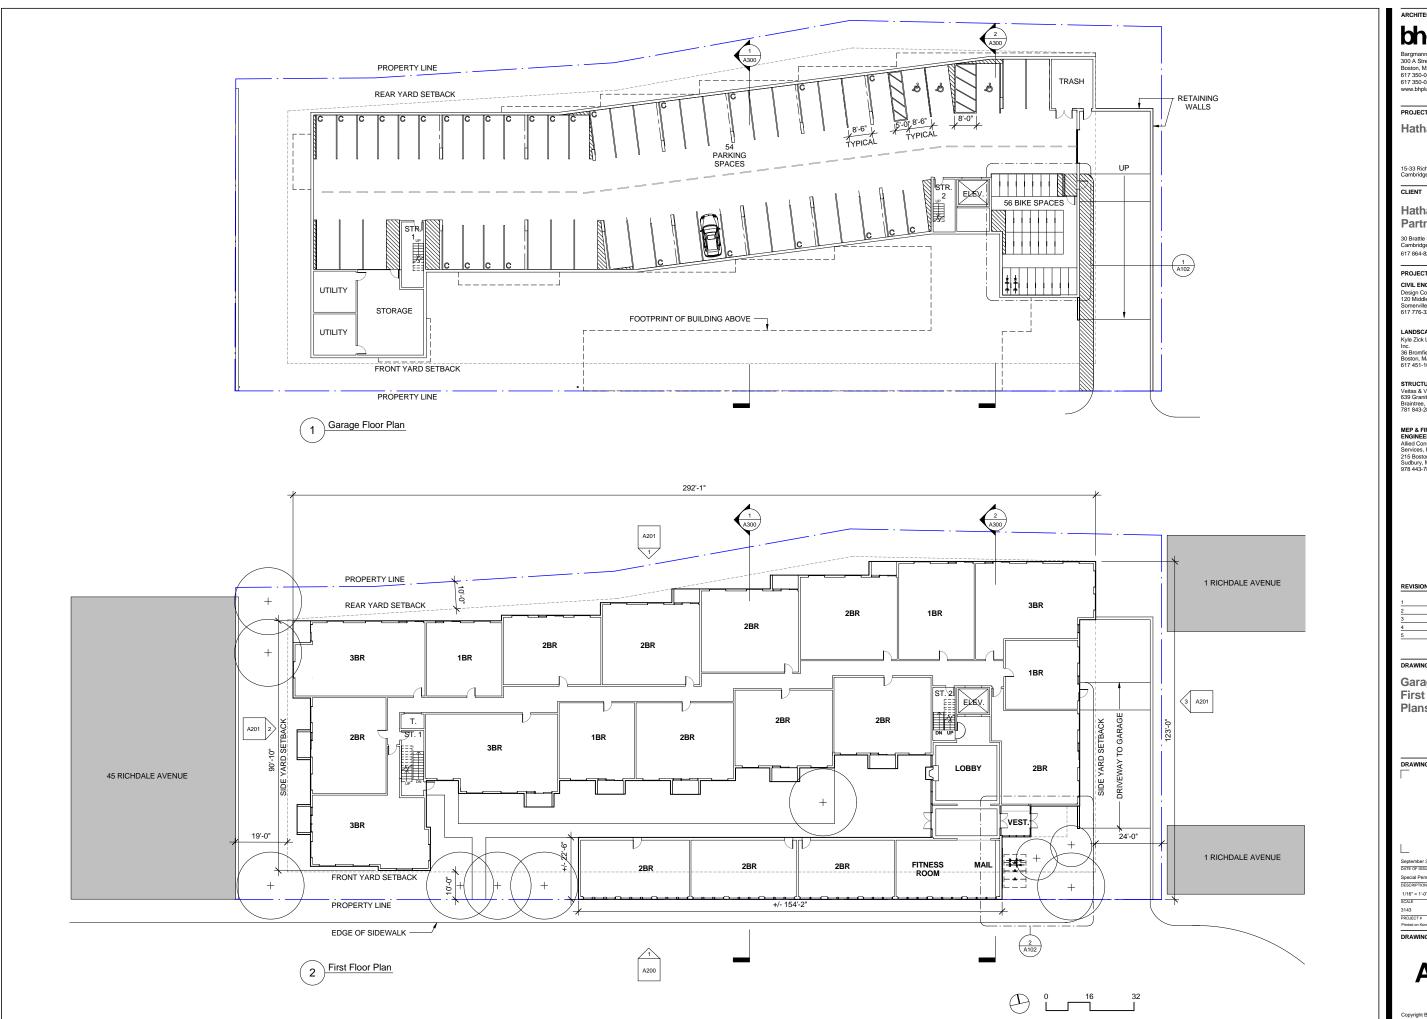

bhia

Bargmann Hendrie + Archetype, 300 A Street Boston, MA 02210 617 350-0450 Tel 617 350-0215 Fax www.bhplus.com

PROJECT NAME

Hathaway Lofts

15-33 Richdale Avenue Cambridge, MA 02140

Hathaway Partners, LLC.

30 Brattle Street, 4th Floor Cambridge, MA 02138 617 864-8200

PROJECT TEAM

CIVIL ENGINEER
Design Consultants, Inc.
120 Middlesex Avenue Suite 20
Somerville, MA 02145
617 776-3350

LANDSCAPE ARCHITECT Kyle Zick Landscape Architecture

STRUCTURAL ENGINEER Veitas & Veitas Engineers, Inc. 639 Granite Street Braintree, MA 02184 781 843-2863

MEP & FIRE PROTECTION ENGINEERS Allied Consulting Engineering Services, Inc. 215 Boston Post Road Sudbury, MA 01776 978 443-7888

REVISIONS

Garage and First Floor **Plans**

DRAWING INFORMATION

September 3, 2013


DATE OF ISSUE

Special Permit Application

DESCRIPTION 1/16" = 1'-0" MRY
SCALE DRAWN BY

3143 3143_Richdale_Ave.rvt
PROJECT # FILE NAME
Printed on Konica 360 EFIRGB 90%

DRAWING NUMBER

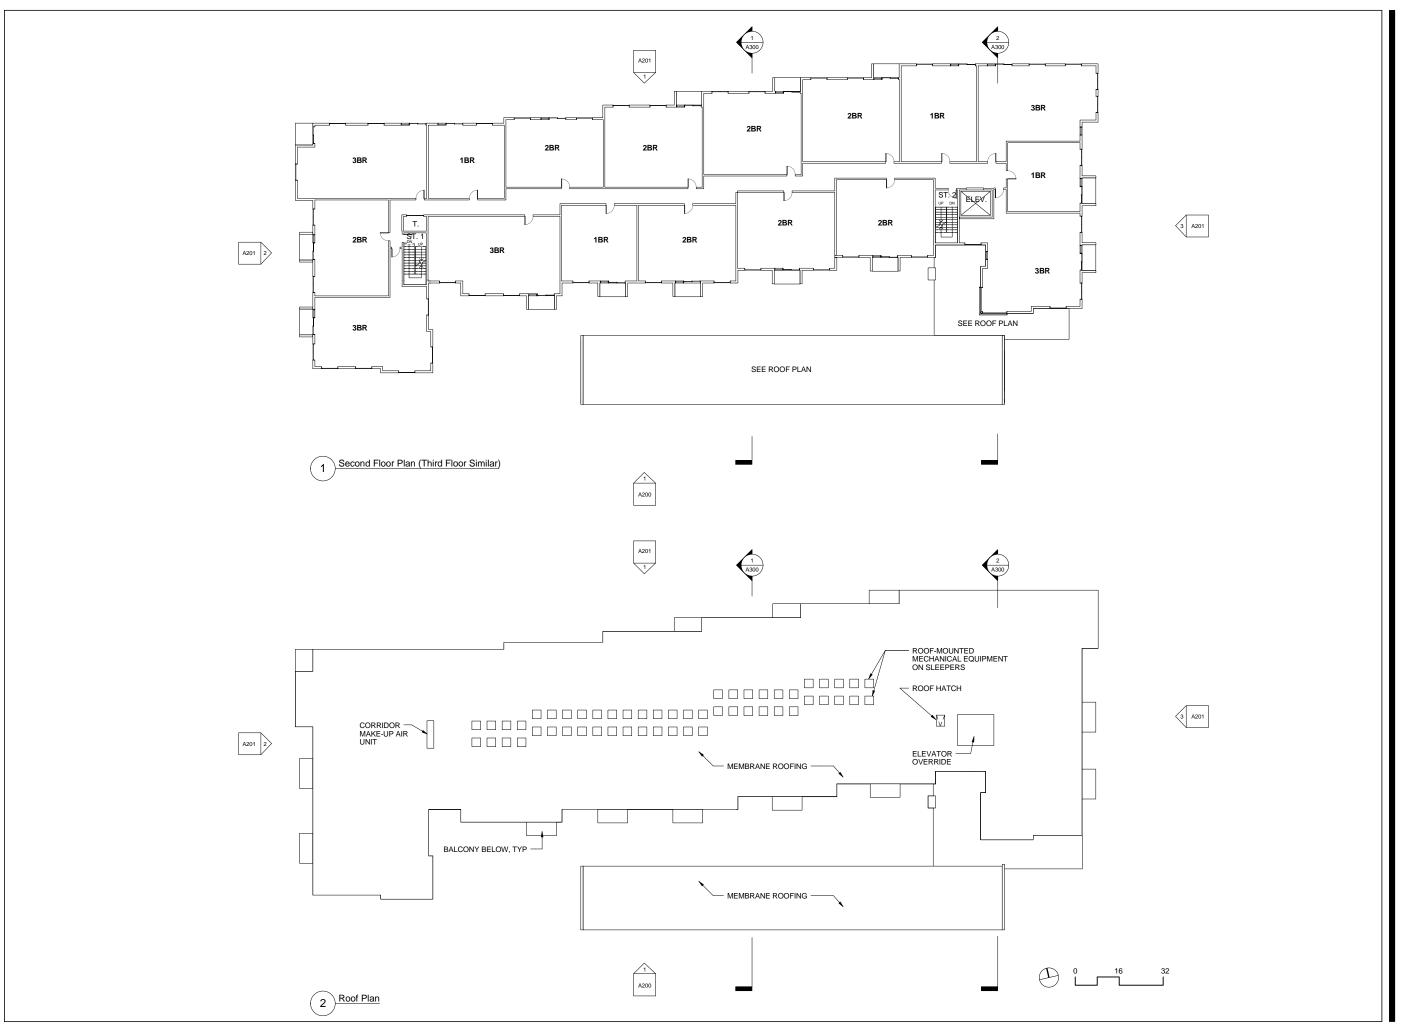

bhia

Bargmann Hendrie + Arche 300 A Street Boston, MA 02210 617 350-0450 Tel 617 350-0215 Fax www.bhplus.com

PROJECT NAME

Hathaway Lofts

15-33 Richdale Avenue Cambridge, MA 02140

CLIENT

Hathaway Partners, LLC.

30 Brattle Street, 4th Floor Cambridge, MA 02138 617 864-8200

PROJECT TEAM

CIVIL ENGINEER
Design Consultants, Inc.
120 Middlesex Avenue Suite 20
Somerville, MA 02145
617 776-3350

LANDSCAPE ARCHITECT Kyle Zick Landscape Architecture

STRUCTURAL ENGINEER Veitas & Veitas Engineers, Inc. 639 Granite Street Braintree, MA 02184 781 843-2863

MEP & FIRE PROTECTION ENGINEERS Allied Consulting Engineering Services, Inc. 215 Boston Post Road Sudbury, MA 01776 978 443-7888

REVISIONS

DRAWING TITLE


Second Floor and Roof Plans

DRAWING INFORMATION

September 3, 2013 DATE OF ISSUE

1/16" = 1'-0" SCALE

3143 3143_Richdale_Ave.rvt
PROJECT # FILE NAME
Printed on Konica 360 EFIRGB 90%

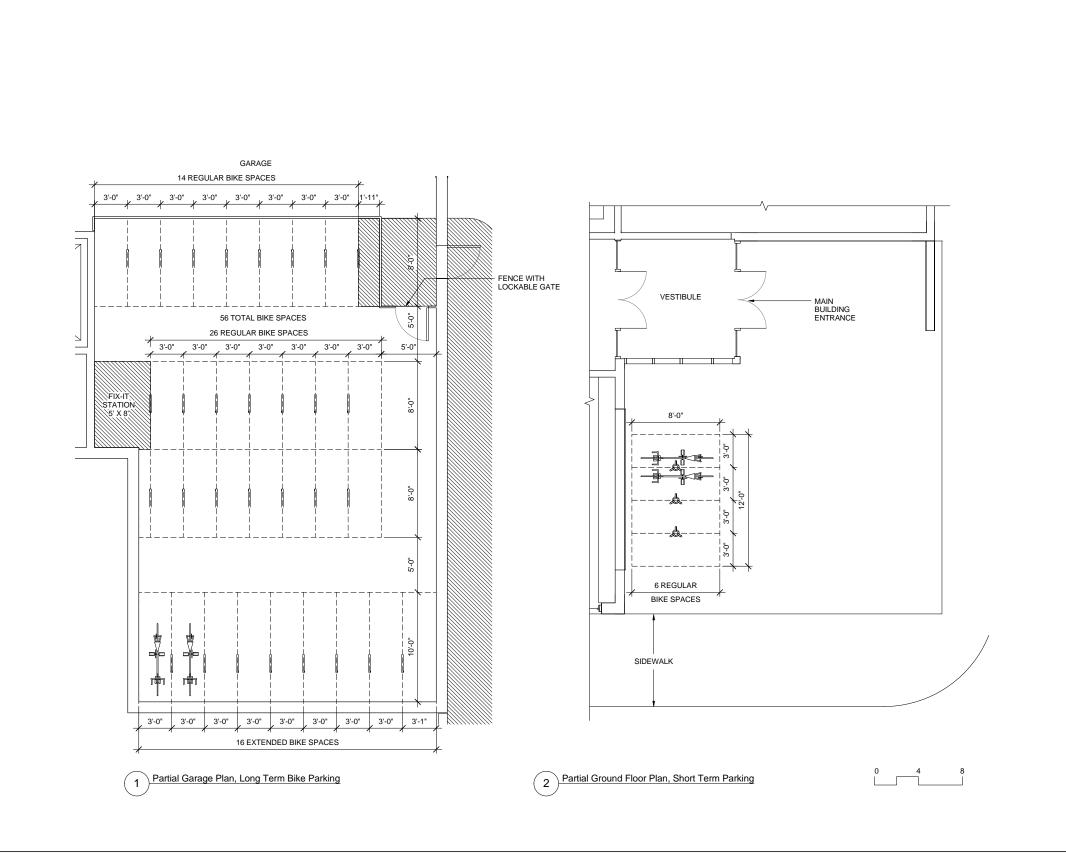

Bargmann Hendrie + Archetype, In 300 A Street Boston, MA 02210 617 350-0450 Tel 617 350-0215 Fax www.bhplus.com

PROJECT NAME

Hathaway Lofts

15-33 Richdale Avenue Cambridge, MA 02140

CLIENT

Hathaway Partners, LLC.

30 Brattle Street, 4th Floor Cambridge, MA 02138 617 864-8200

PROJECT TEAM

CIVIL ENGINEER
Design Consultants, Inc.
120 Middlesex Avenue Suite 20
Somerville, MA 02145
617 776-3350

LANDSCAPE ARCHITECT
Kyle Zick Landscape Architecture

STRUCTURAL ENGINEER Veitas & Veitas Engineers, Inc. 639 Granite Street Braintree, MA 02184 781 843-2863

MEP & FIRE PROTECTION ENGINEERS Allied Consulting Engineering Services, Inc. 215 Boston Post Road Sudbury, MA 01776 978 443-7888

REVISIONS

Bike Parking **Plans**

DRAWING INFORMATION

September 3, 2013

DATE OF ISSUE

Special Permit Application

DESCRIPTION

bhia

Bargmann Hendrie + Archetype, 300 A Street Boston, MA 02210 617 350-0450 Tel 617 350-0215 Fax www.bhplus.com

PROJECT NAME

Hathaway Partners, LLC.

30 Brattle Street, 4th Floor Cambridge, MA 02138 617 864-8200

PROJECT TEAM

CIVIL ENGINEER
Design Consultants, Inc.
120 Middlesex Avenue Suite 20
Somerville, MA 02145
617 776-3350

LANDSCAPE ARCHITECT Kyle Zick Landscape Architecture

STRUCTURAL ENGINEER Veitas & Veitas Engineers, Inc. 639 Granite Street Braintree, MA 02184 781 843-2863

MEP & FIRE PROTECTION ENGINEERS Allied Consulting Engineering Services, Inc. 215 Boston Post Road Sudbury, MA 01776 978 443-7888

REVISIONS

DRAWING TITLE

Rendered South Elevation


DRAWING INFORMATION

September 3, 2013

DATE OF ISSUE

3143 3143_Richdale_Ave.rvt
PROJECT # FILE NAME



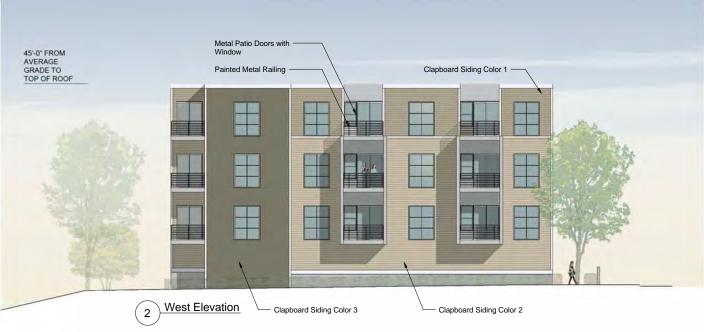



Bargmann Hendrie + Archetype, Ir 300 A Street Boston, MA 02210 617 350-0450 Tel 617 350-0215 Fax www.bhplus.com

PROJECT NAME

Hathaway Lofts

15-33 Richdale Avenue Cambridge, MA 02140

CLIENT

Hathaway Partners, LLC.

30 Brattle Street, 4th Floor Cambridge, MA 02138 617 864-8200

PROJECT TEAM

CIVIL ENGINEER
Design Consultants, Inc.
120 Middlesex Avenue Suite 20
Somerville, MA 02145
617 776-3350

LANDSCAPE ARCHITECT Kyle Zick Landscape Architecture

Inc. 36 Bromfield Street Suite 202 Boston, MA 02108 617 451-1018

STRUCTURAL ENGINEER
Veitas & Veitas Engineers, Inc.
639 Granite Street
Braintree, MA 02184
781 843-2863

MEP & FIRE PROTECTION ENGINEERS Allied Consulting Engineering Services, Inc. 215 Boston Post Road Sudbury, MA 01776 978 443-7888

REVISIONS


DRAWING TITLE

Rendered North, West, and East **Elevations**


DRAWING INFORMATION

September 3, 2013 DATE OF ISSUE

3143 3143_Richdale_Ave.nvt
PROJECT # FILE NAME
Printed on Konica 360 EFIRGB 90%

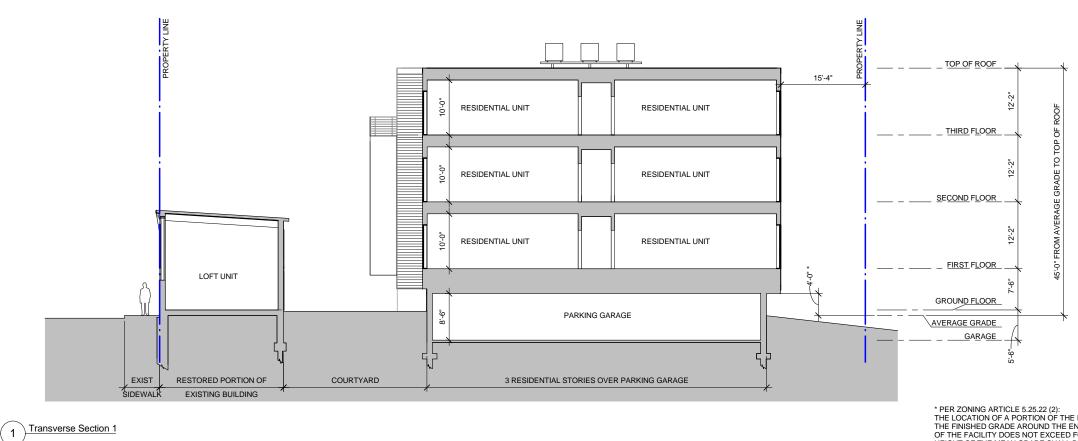

* PER ZONING ARTICLE 5.25.22 (2):
THE LOCATION OF A PORTION OF THE FACILITY ABOVE
THE FINISHED GRADE AROUND THE ENTIRE PERIMETER
OF THE FACILITY DOES NOT EXCEED FOUR (4) FEET...THE
HEIGHT OF THE MEAN GRADE SHALL BE MEASURED TO
THE ROOF OF THE FACILITY OR TO THE CEILING SHOULD
THE ROOF OF THE FACILITY OR TO THE CEILING SHOULD THE FACILITY BE SET ENTIRELY BELOW OTHER NON-PARKING ELEMENTS OF A BUILDING.

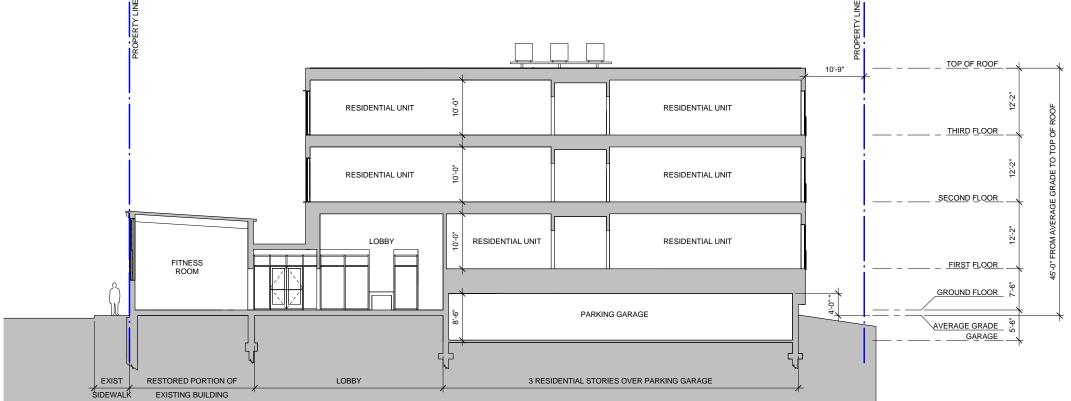

2 Transverse Section 2

ARCHITECT

bhla

Bargmann Hendrie + Archetype, 300 A Street Boston, MA 02210 617 350-0450 Tel 617 350-0215 Fax www.bhplus.com

PROJECT NAME

Hathaway Lofts

15-33 Richdale Avenue Cambridge, MA 02140

CLIENT

Hathaway Partners, LLC.

30 Brattle Street, 4th Floor Cambridge, MA 02138 617 864-8200

PROJECT TEAM

CIVIL ENGINEER
Design Consultants, Inc.
120 Middlesex Avenue Suite 20
Somerville, MA 02145
617 776-3350

LANDSCAPE ARCHITECT Kyle Zick Landscape Architecture

STRUCTURAL ENGINEER Veitas & Veitas Engineers, Inc. 639 Granite Street Braintree, MA 02184 781 843-2863

MEP & FIRE PROTECTION ENGINEERS Allied Consulting Engineering Services, Inc. 215 Boston Post Road Sudbury, MA 01776 978 443-7888

REVISIONS

Building Sections

DRAWING INFORMATION

September 3, 2013

DATE OF ISSUE

1/8" = 1'-0" SCALE

3143 3143_Richdale_Ave.rvt
PROJECT # FILE NAME



Looking West on Richdale Avenue

ARCHITEC

bhia

Bargmann Hendrie + Archetype 300 A Street Boston, MA 02210 617 350-0450 Tel 617 350-0215 Fax www.bhplus.com

PROJECT NAME

Hathaway Lofts

15-33 Richdale Aver Cambridge, MA 021

CLIENT

Hathaway Partners, LLC.

30 Brattle Street, 4th Floor Cambridge, MA 02138 617 864-8200

PROJECT TEAM

CIVIL ENGINEER
Design Consultants, Inc.
120 Middlesex Avenue Suite 20
Somerville, MA 02145
617 776-3350

LANDSCAPE ARCHITECT
Kyle Zick Landscape Architecture

Inc. 36 Bromfield Street Suite 202 Boston, MA 02108 617 451-1018

STRUCTURAL ENGINEER Veitas & Veitas Engineers, Inc. 639 Granite Street Braintree, MA 02184 781 843-2863

781 843-2863

MEP & FIRE PROTECTION ENGINEERS Allied Consulting Engineering Services, Inc. 215 Boston Post Road Sudbury, MA 01776 978 443-7888

EVISIONS

DATE

DRAWING TITLE

Perspective

DRAWING INFORMATION

September 3, 2013

Special Permit Applicat DESCRIPTION

MRY

SCALE DRAWN BY

3143_Richds

3143 3143_Richdale_Ave.rvt
PROJECT# FILE NAME
Printed on Konica 360 EFIRGB 90%

DRAWING NUMBE

A400

Copyright BH+A, Inc.



View of Existing Conditions Looking West from Upland Road



View of Proposed Construction Looking West from Upland Road

Bargmann Hendrie + Arch 300 A Street Boston, MA 02210 617 350-0450 Tel 617 350-0215 Fax www.bhplus.com

PROJECT NAME

Hathaway Lofts

15-33 Richdale Avenue Cambridge, MA 02140

CLIENT

Hathaway Partners, LLC.

30 Brattle Street, 4th Floor Cambridge, MA 02138 617 864-8200

PROJECT TEAM

CIVIL ENGINEER
Design Consultants, Inc.
120 Middlesex Avenue Suite 20
Somerville, MA 02145
617 776-3350

LANDSCAPE ARCHITECT

Kyle Zick Landscape Architecture

STRUCTURAL ENGINEER Veitas & Veitas Engineers, Inc. 639 Granite Street Braintree, MA 02184 781 843-2863

MEP & FIRE PROTECTION ENGINEERS Allied Consulting Engineering Services, Inc. 215 Boston Post Road Sudbury, MA 01776 978 443-7888

DRAWING TITLE

Perspective

DRAWING INFORMATION



View of Existing Conditions Looking West on Richdale Avenue



View of Proposed Construction Looking West on Richdale Avenue

Bargmann Hendrie + Arc 300 A Street Boston, MA 02210 617 350-0450 Tel 617 350-0215 Fax www.bhplus.com

PROJECT NAME

Hathaway Lofts

15-33 Richdale Avenue Cambridge, MA 02140

CLIENT

Hathaway Partners, LLC.

30 Brattle Street, 4th Floor Cambridge, MA 02138 617 864-8200

PROJECT TEAM

CIVIL ENGINEER
Design Consultants, Inc.
120 Middlesex Avenue Suite 20
Somerville, MA 02145
617 776-3350

LANDSCAPE ARCHITECT

Kyle Zick Landscape Architecture

STRUCTURAL ENGINEER Veitas & Veitas Engineers, Inc. 639 Granite Street Braintree, MA 02184 781 843-2863

MEP & FIRE PROTECTION ENGINEERS Allied Consulting Engineering Services, Inc. 215 Boston Post Road Sudbury, MA 01776 978 443-7888

DRAWING TITLE

Perspective

DRAWING INFORMATION



View of Existing Conditions Looking East on Richdale Avenue



View of Proposed Construction Looking East on Richdale Avenue

Bargmann Hendrie + Arc 300 A Street Boston, MA 02210 617 350-0450 Tel 617 350-0215 Fax www.bhplus.com

PROJECT NAME **Hathaway Lofts**

15-33 Richdale Avenue Cambridge, MA 02140

CLIENT

Hathaway Partners, LLC.

30 Brattle Street, 4th Floor Cambridge, MA 02138 617 864-8200

PROJECT TEAM

CIVIL ENGINEER
Design Consultants, Inc.
120 Middlesex Avenue Suite 20
Somerville, MA 02145
617 776-3350

LANDSCAPE ARCHITECT

Kyle Zick Landscape Architecture

STRUCTURAL ENGINEER Veitas & Veitas Engineers, Inc. 639 Granite Street Braintree, MA 02184 781 843-2863

MEP & FIRE PROTECTION ENGINEERS Allied Consulting Engineering Services, Inc. 215 Boston Post Road Sudbury, MA 01776 978 443-7888

DRAWING TITLE

Perspective

DRAWING INFORMATION