BZA APPLICATION FORM

GENERAL INFORMATION

	rsuant to Section 6409 of the Middle Class Tax Relief Act T-Mobile Northeast LLC	
PETITIONER:		
PETITIONER'	S ADDRESS: Prince Lobel Tye, LLP, Attn. Ricardo M. Sousa, Esq.,	100 Cambridge Street, Suite 2200, Boston, MA
LOCATION OF	PROPERTY: 1 Brattle Square	
TYPE OF OCC	UPANCY:TelecommunicationsZONING DISTRICT:	Business B
REASON FOR	PETITION:	
	_ Additions	New Structure
	_ Change in Use/Occupancy	Parking
	Conversion to Addi'l Dwelling Unit's	Sign
	Dormer	Subdivision
x	Other:Section 6409(a) of the Spectrum Act relief for Special P	ermit for the collocation of a Wireless Facility
	A DE DESTRICTORD LA DECECCIÓN :	
	I OF PETITIONER'S PROPOSAL: proposes to modify the existing wireless communications facility by repla	

Moreover, the Applicants proposal complies with Section 4.32 and 10.4 of the Cambridge Zoning Code.

SECTIONS OF ZONING ORDINANCE CITED:

Article	4.00	Section	4.32 (g)(1) Utilities - Telephone Exchange
Article	10.00	Section	10.4 - Special Permit
Article	6409	Section	Middle Class Tax Relief and Job Creation Act
Applicar	nts for	a Varian	ce must complete Pages 1-5

Applicants for a <u>Special Permit</u> must comple Applicants for an <u>Appeal</u> to the BZA	of a Zoning determination by the
Inspectional Services Department must attac for the appeal	ch a statement concerning the reasons
Original Signature(s):	(Petitioner(s)/Owner) Ricardo M. Sousa, Esq.
	(Print Name)
Address:	100 Cambridge Street, Suite 2200
	Boston, MA 02114
Tel. No.:	617-456-8123

E-Mail Address:

rsousa@princelobel.com

	M
Date:	IVI
Date.	

March 17, 2016

BZA APPLICATION FORM - OWNERSHIP INFORMATION

To be completed by OWNER, signed before a notary and returned to The Secretary of the Board of Zoning Appeals.

Redimont - ONO Brattle Salare I. I/We

Address: One Brown Savare, Combridge NA

State that I/We own the property located at _______ State that I/We own the property located at _______ State the subject of this zoning application.

The	record	title	of	this	property	is	in	the	name	of_	Piedmont -
C	9 Bu	star	26	0 8	evate	7	5.	H	E		

*Pursuant to a deed	d of duly recorded in th	ne date	_, Middlesex South
County Registry of	Deeds at Book	, Page	_; or
Middlesex Registry	District of Land Court	, Certificate No	
Book	Page		

General Houseper SIGNATURE BY LAND OWNER OR

AUTHORIZED TRUSTEE, OFFICER OR AGENT*

*Written evidence of Agent's standing to represent petitioner may be requested.

Commonwealth of Massachusetts, County of Nov Folk The above-name Haul NEWMAN personally appeared before me, this 16 of March, 2016, and made oath that the above statement is true. Notary My commission expires)2-14-18 (Notary Seal). EVAN K. ZALIOS Notary Public, Commonwealth of Massachusetts If ownership is not shown in recorded deed, e.g. if by Courts of Messachusetts .

deed, or inheritance, please include documentation.

Prince Lobel Tye LLP 100 Cambridge Street, Suite 2200 Boston, Massachusetts 02114

617 456 8000 main 617 456 8100 fax PrinceLobel.com



March 17, 2016

City of Cambridge Board of Zoning Appeals 831 Massachusetts Avenue Cambridge, MA 02139

Eligible Facilities Request pursuant to Section 6409 of the
Spectrum Act and an Application for Special Permit, in the alternative
alternative
1 Brattle Square, Cambridge, MA 02138
Assessor's Map 34, Lot 138 (the "Property")
T-Mobile Northeast LLC (the "Applicant")

Dear Honorable Members of the Board of Zoning Appeals:

This firm represents T-Mobile Northeast LLC ("T-Mobile") (hereinafter, the "Applicant") in connection with an application for a special permit from the City of Cambridge Board of Zoning Appeals (the "Board"), to modify an existing wireless communications facility on the Property. The Property is located in the Business B zoning district. To the extent that the Board determines that the requirements of Article 4 Section 4.32G.1 of the City of Cambridge Zoning Ordinance (the "Ordinance") apply, the use of the Property for a wireless telecommunications facility is permitted by special permit from the Board¹. The Applicant's proposal satisfies the requirements for the grant of a special permit pursuant to Section 10-43 of the Ordinance.

The Applicant's Proposed Facility (as defined herein) is subject to Section 6409 of the Middle Class Tax Relief and Job Creation Act of 2012, more commonly known as the "Spectrum Act" (47 U.S.C. § 1455). As such, we respectfully submit that in the event that the Board determines that the application does not comply with the Spectrum Act, the Applicant hereby states that the special permit requirements set forth in the Ordinance are hereby met by the Applicant, and that relief must be granted to the Applicant. The compliance with the Spectrum Act is shown on the Eligible Facilities Request permit application form attached hereto and incorporated herein by reference (the "EFR").

¹ Pursuant to Section 6409(a) of the Spectrum Act, state and local governments "may not deny and shall approve, any eligible facilities request for a modification of an existing wireless tower or base station that does not substantially change the physical dimensions of such tower or base station." As such, the Applicant submits that they need not apply for a special permit from the board. To the extent that this Board determines that the Applicants' proposed wireless facility must comply with special permit requirements set forth in Section 10-43 of the Ordinance, the Applicants submit that they have complied with said requirements, without waiving the argument that such relief is not required.

The Applicant seeks to modify its existing wireless communications facility by replacing three (3) existing panel antennas with three (3) new panel antennas, adjacent to the remaining T-Mobile antennas, and three (3) Remote Radio Head Units ("RRH"), together with supporting equipment (the "Proposed Facility). All of the proposed replacement antennas will be located in the same location as the antennas they will be replacing and painted to match the existing façade of the penthouse on the roof of building located at the Property (the "Building"), adjacent to three (3) existing T-Mobile antennas. Resulting in no net increase to the total number of antennas as previously approved under the Original Decision, as defined herein. The Applicant's facilities are shown on the Plans attached hereto and incorporated herein by reference (the "Plans")

I. <u>Background</u>

The Applicant is licensed by the Federal Communications Commission (the "FCC") to construct and operate a wireless telecommunications network in various markets throughout the country, including the Commonwealth of Massachusetts and in particular in the City of Cambridge. A copy of the Applicant's FCC license is attached hereto. The Applicant is in the process of designing and constructing a telecommunications system to serve all of the Commonwealth of Massachusetts. One of the key design objectives of its systems is to provide seamless coverage. Such a system requires a grid of radio transmitting and receiving links located approximately .5 to 2 miles apart, depending on the location of existing and proposed installations in the surrounding area, the existing use of the network and the existing topography. The radio transmitting and receiving facilities operate on a line-of-sight basis, requiring a clear path from the facility to the user on the ground. This dynamic requires the antennas to be located in a location where the signal is not obstructed or degraded by other buildings or by topographical features such as hills.

II. <u>Project Description</u>

As noted above, the Applicant proposes to modify its existing wireless facility currently operating on the rooftop of the Building by replacing three (3) existing panel antennas with three (3) new T-Mobile L700 panel antennas, together with three (3) RRH's and supporting equipment. All new antennas will be installed to be consistent with the original zoning decision for this facility (the "Original Decision"). Furthermore, as the Applicant is proposing to replace existing antennas with the new antennas there will be no increase in the total number of antennas on the roof of the Building. Consequently, the visual change to the Applicant's existing facility will be de minimus.

After installation, the Proposed Facility will be unmanned and will only require twice a month maintenance visits per carrier. The only utilities required to operate this Proposed Facility are standard 120-volt electrical power as well as telephone service. These are presently in place at the Property. The traffic generated by the Proposed Facility will be approximately two vehicle trips per month by maintenance personnel who will inspect the Proposed Facility to ensure it remains in good working order. The Proposed Facility will comply with all applicable local, state and federal safety codes.

III. Legal Arguments

A. <u>The Applicant complies with the Wireless Communications provisions set</u> forth in Section 4.32(g), footnote 49 of the Ordinance

Pursuant to Section 4.32(g) of the Ordinance, the Applicant's proposed use for a wireless communications facility in the Business B zoning district is permitted by special permit. The Applicant's Proposed Facility further complies with the provisions set forth in Section 4.32(g), footnote 49 of the Ordinance:

1. The Board of Zoning Appeal shall consider the scope of or limitations imposed by any license secured from any state or federal agency having jurisdiction over such matters.

Enclosed herewith is the Applicant's FCC license. The Applicant meets all requirements imposed by governmental authorities having jurisdiction over the Proposed Facility, including by the FCC, to provide wireless communications in this market area.

The intent of the U.S. Congress, when it enacted the Telecommunications Act of 1996 ("TCA") was to institute a framework to promote competition and innovation within the telecommunications industry. Under its license from the FCC, T-Mobile is obligated to provide a reliable "product" (i.e. wireless communications service) to the population of the City of Cambridge. Likewise, consumer expectations for increasingly robust and reliable service requires competing service providers (including T-Mobile) to identify and remedy existing gaps in reliable network coverage, or gaps that result from increasing subscriber voice and data traffic beyond the limits of existing network infrastructure. A carrier's failure to remedy network gaps in a timely fashion can result in a significant loss of subscribers to competing telecommunications carriers. As demonstrated in the Affidavit of Radio Frequency Expert provided by the Applicant and attached hereto, the Proposed Facility and corresponding relief requested are necessary to remedy a gap in reliable service coverage within T-Mobile's existing network infrastructure.

T-Mobile investigated alternative sites in and around the defined geographic area within which its engineers determined that a facility must be located to fill the gap in service coverage and to function effectively within its network of existing and planned facilities. This is an existing location that is being upgraded with new technology to provide the necessary coverage to the subject area of the City of Cambridge. Therefore, the Proposed Facility in the Business B zoning district is necessary to close the coverage gap that is illustrated on the propagation maps submitted herewith. Consequently, T-Mobile is unable to close a gap in its wireless network without obtaining the requested relief under Section 6409 of the Spectrum act or a Special Permit to modify its existing wireless facility in the Business B zoning district.

Furthermore, Section 6409(a) of the Spectrum Act mandates that state and local governments "may not deny, and shall approve, any eligible facilities request for a modification

Cambridge Board of Zoning Appeals March 17, 2016 Page 4

of an existing wireless tower or base station that does not substantially change the physical dimensions of such tower or base station." Under Section 6409(a)(2)(A)-(C) an Eligible Facilities Request is any request to modify a Tower or Base Station that involves "collocations of new Transmission Equipment," "removal," or "replacement" of Transmission Equipment.

Because federal law now preempts many of the permit application requirements that this jurisdiction would previously have required from an Applicant, we have provided, on the attached EFR, only the information that federal law allows this jurisdiction to consider when reviewing an EFR. As such, we submit that the Wireless Communications set forth in Section 4.32(g), footnote 49 of the Ordinance, provisions are not applicable to Proposed Facility and relief must be granted pursuant to Section 6409(a) of the Spectrum Act.

2. The Board of Zoning Appeal shall consider the extent to which the visual impact of the various elements of the proposed facility is minimized: (1) through the use of existing mechanical elements on the building's roof or other features of the building as support and background, (2) through the use in materials that in texture and color blend with the materials to which the facilities are attached, or (3) other effective means to reduce the visual impact of the facility on the site.

The Applicant's design minimizes the visual impact of the Proposed Facility. The facility will be installed on the existing rooftop of the Building and consistent with the Original Decision. The resulting installation will have an increased capacity to better serve the City of Cambridge without the need for an increased number of antennas on the Building. The proposed replacement antennas will be painted to match the color of the existing Building thereby minimizing any visual impacts.

As stated above, federal law now preempts many of the permit applications requirements that the Ordinance sets forth. To the extent that this Board determines that the Applicants' proposed wireless facility must comply with the Wireless Communications provisions set forth in Section 4.32(g), footnote 49 of the Ordinance, the Applicants submit that they have complied with said requirements, without waiving the argument that such relief is not required.

3. Where it is proposed to erect such a facility in any residential zoning district, the extent to which there is a demonstrated public need for the facility at the proposed locations, the existence of alternative, functionally suitable sites in nonresidential locations, the character of the prevailing uses in the area, and the prevalence of other existing mechanical systems and equipment carried on or above the roof of nearby structures. The Board of Zoning Appeal shall grant a special permit to erect such a facility in a residential zoning district only upon a finding that nonresidential uses predominate in the vicinity of the proposed facility's location and that the telecommunications facility is not inconsistent with the character that does prevail in the surrounding neighborhood.

The Applicant proposes to install its facility within the Business-B zoning district. As such, this is not applicable.

B. <u>The Applicant complies with the Special Permit Criteria set forth in Section</u> <u>10-43 of the Ordinance²</u>:

1. The requirements of the Ordinance can be met:

As provided above, the Applicant has met the requirements set forth in Section 4.32(g), footnote 49 of the Ordinance.

2. Traffic generated or patterns of access or egress would not cause congestion hazard, or substantial change in established neighborhood character for the following reasons:

The proposed installation will not obstruct existing rights-of-way or pedestrian access and will not change the daily conditions of access, egress, traffic, congestion hazard, or character of the neighborhood. The installation will not require the addition of any new parking or loading spaces. The use is passive and will not change the current conditions or appearance surrounding the Building. The facility will not produce any odors, fumes, noise or waste. There will be no need for water, sewer, or other municipal services.

As mentioned above, once modified, the facility will be unmanned and will only require infrequent visits by a technician, typically two times per month for routine diagnostics and/or maintenance, except in cases of emergency. These infrequent visits will not result in any material increase in traffic or disruption to patterns of access or egress that will cause congestion hazards or cause a substantial change in the established neighborhood character. The Applicant's maintenance personnel will make use of the existing access roads and parking at the Building.

3. The continued operation of or the development of adjacent uses as permitted in the Zoning Ordinance would not be adversely affected by the nature of the proposed use for the following reasons:

As described above and illustrated on the attached photograph simulations, the modification of the existing facility will produce a minimal change in the appearance of the Building. The modification of the existing facility will blend with the existing characteristics of

² Pursuant to Section 6409(a) of the Spectrum Act, state and local governments "may not deny and shall approve, any eligible facilities request for a modification of an existing wireless tower or base station that does not substantially change the physical dimensions of such tower or base station." As such, the Applicant submits that they need not apply for a special permit from the board. To the extent that this Board determines that the Applicants' proposed wireless facility must comply with special permit requirements set forth in Section 10-43 of the Ordinance, the Applicants submit that they have complied with said requirements, without waiving the argument that such relief is not required.

the Building and the surrounding neighborhood. Moreover, the proposed installation will not generate any traffic, smoke, dust, heat, glare, discharge of noxious substances, nor will it pollute waterways or groundwater. Conversely, the surrounding properties and general public will benefit from the potential to enjoy improved wireless communication.

4. Nuisance or hazard would not be created to the detriment of the health, safety, and/or welfare of the occupant of the proposed use or the citizens of the City for the following reasons:

The operations of the proposed telecommunications facility will not adversely impact the health, safety, and the welfare of the residents of the City of Cambridge. On the contrary, the proposed use will benefit the City and promote the safety and welfare of its residents, businesses and drivers by providing reliable state-of-the-art digital wireless voice and data services. Further, the site will improve the reliability of emergency communications with the police and fire departments by eliminating dropped or blocked calls due to inadequate signal strength or insufficient network capacity to handle call volume, particularly important during emergency situations.

The Proposed Facility will comply with all federal, state and local safety requirements including the standards established by the FCC, Federal Aviation Administration (FAA), the American Standards Institute (ANSI), and the Massachusetts Department of Public Health (MDPH).

Accordingly, the Proposed Facility will not adversely impact the health, safety and/or welfare of the neighborhood or the residents of the City of Cambridge.

5. For other reasons, the proposed installation will not impair the integrity of the district or adjoining district or otherwise derogate from the intent or purpose of this ordinance for the following reasons:

The Proposed Facility is designed to blend with the existing characteristics of the Property, reducing any visual impacts to the surrounding area. Accordingly, the Proposed Facility's design results in a minimal impact on the underlying and adjacent zoning district and is consistent with the Ordinance's intention to allow for less intrusive wireless telecommunications facilities in all districts (other than Open Space), including the Business B zoning districts.

As mentioned above, the proposed modifications to the existing installation will not generate any traffic, smoke, dust, heat, glare, discharge or noxious substances, nor will it pollute waterways or groundwater.

6. The new use of the building construction is consistent with the Urban Design Objective set for tin Section 19.30 of the Ordinance:

Not Applicable. The Applicant is not proposing to construct a new building or structure.

Cambridge Board of Zoning Appeals March 17, 2016 Page 7

IV. Summary

The Applicant hereby requests that the Board determine that the City of Cambridge has the right to authorize the construction of the Proposed Facility through the issuance of a Building Permit, pursuant to Section 6409(a) of the Spectrum Act. Or, in the alternative, its proposed modifications to the existing telecommunications facility will not have any adverse effect on the neighborhood within which the Property is located in particular, and the City of Cambridge as a whole. The findings are made in view of the particular characteristics of the Property and of the Applicant's proposed siting and equipment, as detailed above. This Property is the most appropriate location for the installation and operation of the wireless communications facility.

For the foregoing reasons the Applicant respectfully requests that the Board grant the foregoing relief pursuant to Section 6409(a) of the Spectrum Act or, in the alternative, zoning relief in the form of a Special Permit and such other relief as the Board deems necessary to allow the installation and operation of the Applicant's Proposed Facility.

Sincerely,

Ricardo M. S

Direct: 617-456-8123 Email: rsousa@princelobel.com

BZA APPLICATION FORM

DIMENSIONAL INFORMATION

APPLICANT: T-Mobi	le Northeast	PR	ESENT USE/OCCUPANC	¥:
LOCATION:1 Brat	tle Square		ZONE :	Business B
PHONE: 617-456-	8123	REQUESTED USE	OCCUPANCY:Wire	less Telecommunications
		EXISTING CONDITIONS	REQUESTED CONDITIONS	ORDINANCE REQUIREMENTS ¹
TOTAL GROSS FLOOR	AREA:	N/A	No Change	N/A (max.)
LOT AREA:		N/A		N/A (min.)
RATIO OF GROSS FLOO TO LOT AREA: ²	DR AREA	N/A	No Change	N/A (max.)
LOT AREA FOR EACH	OWELLING UNIT:	N/A	No Change	N/A (min.)
SIZE OF LOT:	WIDTH	N/A		N/A (min.)
Setbacks in	DEPTH FRONT	N/A	No Change	N/A (min.)
Feet:	REAR	N/A	No Change	N/A (min.)
	LEFT SIDE	N/A	No Change	N/A (min.)
	RIGHT SIDE	N/A	No Change	N/A (min.)
SIZE OF BLDG.:	HEIGHT	N/A	No Change	N/A (max.)
	LENGTH			
	WIDTH			
RATIO OF USABLE OP TO LOT AREA: ³)	EN SPACE	N/A	No Change	N/A (min.)
NO. OF DWELLING UN	TTS.	N/A	No Change	N/A (max.)
NO. OF PARKING SPAC		N/A	No Change	N/A (min./max)
NO. OF LOADING ARE		 N/A	No Change	N/A (min.)
DISTANCE TO NEARES		N/A	No Change	N/A (min.)
ON SAME LOT:				

Describe where applicable, other occupancies on same lot, the size of adjacent buildings on same lot, and type of construction proposed, e.g.; wood frame, concrete, brick, steel, etc.

The proposed installation involves a modification of an existing Wireless Telecommunications Facility,

more commonly referred to as a "collocation".

^{1.} SEE CAMBRIDGE ZONING ORDINANCE ARTICLE 5.000, SECTION 5.30 (DISTRICT OF DIMENSIONAL REGULATIONS).

^{2.} TOTAL GROSS FLOOR AREA (INCLUDING BASEMENT 7'-0" IN HEIGHT AND ATTIC AREAS GREATER THAN 5') DIVIDED BY LOT AREA.

^{3.} OPEN SPACE SHALL NOT INCLUDE PARKING AREAS, WALKWAYS OR DRIVEWAYS AND SHALL HAVE A MINIMUM DIMENSION OF 15'.

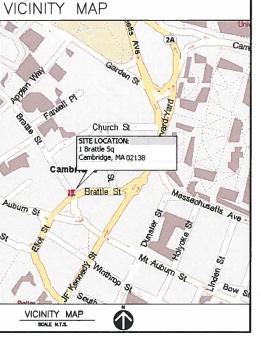
F - Mobile[®] **T-MOBILE NORTHEAST LLC**

T-MOBILE SITE #: 4BSM457A SITE NAME: BRATTLE SQUARE **1 BRATTLE SQUARE** CAMBRIDGE, MA 02138

GENERAL NOTES

- THE CONTRACTOR SHALL GIVE ALL NOTICES AND COMPLY WITH ALL LAWS, ORDINANCES, RULES, REGULATIONS AND LAWFUL ORDERS OF ANY PUBLIC AUTHORITY, MUNICIPAL AND UTLITY COMPANY SPECIFICATIONS, AND LOCAL AND STATE JURISDICTIONAL CODES BEARING ON THE PERFORMANCE OF THE WORK, THE WORK PERFORMED ON THE PROJECT AND THE WATERIALS INSTALLED SHALL BE IN STRICT ACORDANCE WITH ALL ABELICABLE CODES STRICT ACCORDANCE WITH ALL APPLICABLE CODES. REGULATIONS, AND ORDINANCES.
- THE ARCHITECT/ENGINEER HAVE MADE EVERY EFFORT TO SET FORTH IN THE CONSTRUCTION AND CONTRACT DOCUMENTS THE COMPLETE SCOPE OF WORK. THE CONTRACTOR BIDDING THE JOB IN EVERTHELESS CAUTIONED THAT MINOR OMISSIONS OR ERRORS IN THE DOMINING AND OD CONFORMED AND THE 2. CAUTIONED THAT MINUTE UNISSIONS ON ENHOUSES IN THE DRAWINGS AND OR SPECIFICATIONS SHALL NOT EXCUSE SAID CONTRACTOR FROM COMPLETING THE PROJECT AND IMPROVEMENTS IN ACCORDANCE WITH THE INTENT OF THESE DOCUMENTS DOCUMENTS.
- THE CONTRACTOR OR BIDDER SHALL BEAR THE 3. THE CONTRACTOR OR BIDDER SHALL BEAR THE RESPONSIBILITY OF NOTIFYING (IN WRITING) THE LESSEE REPRESENTATIVE OF ANY CONFLICTS, ERRORS, OR OMISSIONS PRIOR TO THE SUBMISSION OF CONTRACTOR'S PROPOSAL OR PERFORMANCE OF WORK. IN THE EVENT OF DISCREPANCIES THE CONTRACTOR SHALL PRICE THE MORE COSTLY OR EXTENSIVE WORK, UNLESS DIRECTED IN WRITING
- THE SCOPE OF WORK SHALL INCLUDE FURNISHING ALL MATERIALS, EQUIPMENT, LABOR AND ALL OTHER MATERIALS AND LABOR DEEMED NECESSARY TO COMPLETE THE WORK/PROJECT AS DESCRIBED HEREIN.
- THE CONTRACTOR SHALL VISIT THE JOB SITE PRIOR TO THE SUBMISSION OF BIDS OR PERFORMING WORK TO FAMILIARIZE HIMSELF WITH THE FIELD CONDITIONS AND TO VERIFY THAT THE PROJECT CAN BE CONSTRUCTED IN ACCORDANCE WITH THE CONTRACT DOCUMENTS. 5.
- THE CONTRACTOR SHALL OBTAIN AUTHORIZATION TO PROCEED WITH CONSTRUCTION PRIOR TO STARTING WORK ON ANY ITEM NOT CLEARLY DEFINED BY THE CONSTRUCTION 6. DRAWINGS / CONTRACT DOCUMENTS.
- 7. THE CONTRACTOR SHALL INSTALL ALL EQUIPMENT AND MATERIALS ACCORDING TO THE MANUFACTURER'S / VENDOR'S SPECIFICATIONS UNLESS NOTED OTHERWISE OF WHERE LOCAL CODES OR ORDINANCES TAKE PRECEDENCE.
- 8. THE CONTRACTOR SHALL PROVIDE A FULL SET OF CONSTRUCTION DOCUMENTS AT THE SITE UPDATED WITH THE LATEST REVISIONS AND ADDEDIDUMS OR CLARIFICATIONS AVAILABLE FOR THE USE BY ALL PERSONNEL INVOLVED WITH THE PROJECT.
- THE CONTRACTOR SHALL SUPERVISE AND DIRECT THE 9. THE CONTRACTOR SHALL SUPERVISE AND DIRECT THE PROJECT DESCRIBED HERIN. THE CONTRACTOR SHALL BE SOLELY RESPONSIBLE FOR ALL CONSTRUCTION MEANS, METHODS, TECHNIQUES, SEQUENCES AND PROCEDURES AND FOR COORDINATING ALL PORTIONS OF THE WORK UNDER THE CONTRACT.

- 10. THE CONTRACTOR SHALL BE RESPONSIBLE FOR THE CONTRACTOR SPACE RESEARCY CONSTRUCTION CONTROL SURVEYS, ESTABLISHING AND MAINTAINING ALL LINES AND GRADES REQUIRED TO CONSTRUCT ALL IMPROVEMENTS AS SHOWN HEREIN.
- 11. THE CONTRACTOR SHALL BE RESPONSIBLE FOR OBTAINING ALL PERMITS AND INSPECTIONS WHICH MAY BE REQUIRED FOR THE WORK BY THE ARCHITECT/ENGINEER, THE STATE, COUNTY OR LOCAL GOVERNMENT AUTHORITY.
- 12. THE CONTRACTOR SHALL MAKE NECESSARY PROVISIONS TO PROTECT EXISTING IMPROVEMENTS, EASEMENTS, PAVING, CURBING, ETC. DURING CONSTRUCTION. UPON COMPLETION OF WORK, THE CONTRACTOR SHALL REPAIR ANY DAMAGE THAT MAY HAVE OCCURRED DUE TO CONSTRUCTION ON OR ABOUT THE PROPERTY.
- 13. THE CONTRACTOR SHALL KEEP THE GENERAL WORK AREA CLEAN AND HAZARD FREE DURING CONSTRUCTION AND DISPOSE OF ALL DIRT, DEBRIS, RUBBISH AND REMOVE EQUIPMENT NOT SPECIFIED AS REMAINING ON THE PROPERTY. PREMISES SHALL BE LEFT IN CLEAN CONDITION AND FREE FROM PAINT SPOTS, DUST, OR SMUDGES OF ANY NATURE.
- 14. THE CONTRACTOR SHALL COMPLY WITH ALL OSHA REQUIREMENTS AS THEY APPLY TO THIS PROJECT.
- 15. THE CONTRACTOR SHALL NOTIFY THE LESSEE REPRESENTATIVE WHERE A CONFLICT OCCURS ON ANY OF THE CONTRACT DOCUMENTS. THE CONTRACTOR IS NOT TO ORDER MATERIAL OR CONSTRUCT ANY PORTION OF THE WORK THAT IS IN CONFLICT UNTL. CONFLICT IS RESOLVED BY THE LESSEE REPRESENTATIVE.
- 15. THE CONTRACTOR SHALL VERIFY ALL DIMENSIONS, ELEVATIONS, PROPERTY LINES, ETC. ON THE JOB.
- 17. ALL UNDERGROUND UTILITY INFORMATION WAS DETERMINED FROM SURFACE INVESTIGATIONS AND EXISTING PLANS OF RECORD. THE CONTRACTOR SHALL LOCATE ALL UNDERGROUND UTILITIES IN THE FIELD PRIOR TO ANY SITE WORK. CALL THE FOLLOWING FOR ALL PRE-CONSTRUCTION NOTIFICATION 72-HOURS PRIOR TO ANY EXCAVATION ACTIVITY. DIC SAFE SYSTEM (MA. HE. NH. BI, VT). ACTIVITY: DIG SAFE SYSTEM (MA, ME, NH, RI, VT): 1-888-344-7233 CALL BEFORE YOU DIG
- 18. PER FCC MANDATE, ENHANCED EMERGENCY (E911) SERVICE IS REQUIRED TO MEET NATIONWIDE STANDARDS FOR WIRELESS COMMUNICATIONS SYSTEMS. PROJECT OWNER IMPLEMENTATION REQUIRES DEPLOYMENT OF EQUIPMENT AND REQUIRES DEPLOTMENT OF EQUIPMENT AND ANTENNAS GENERALLY DEPICTED ON THIS PLAN, ATTACHED TO OR MOUNTED IN CLOSE PROXIMITY TO THE BTS RADIO CABINETS. THE PROJECT OWNER RESERVES THE RIGHT TO MAKE REASONABLE MODIFICATIONS TO ESTI EQUIPMENT AND LOCATION AS TECHNOLOGY EVOLVES TO MEET REQUIRED SEFCIECATIONS SPECIFICATIONS.




SHE	EET INDEX		[PROJECT SUM	MARY
SHT. NO.	DESCRIPTION	REV. NO.		SITE NUMBER:	4BSM45
T-1	TITLE SHEET	1		SITE ADDRESS:	1 BRAT CAMBRI
	PLOT PLAN ROOF PLAN	1		ZONING DISTRICT:	BUSINE
	SOUTH ELEVATION	1		PARCEL ID.:	MAP 16
	EAST ELEVATIONS ANTENNA, ROOM PLAN & RF SCHEDULE	1		CONSTRUCTION TYPE:	ROOF 1
	CONSTRUCTION DETAILS I	1		PROPERTY OWNER:	WELLS C/O C 745 AT
E1	GROUNDING DETAILS & NOTES	1		APPLICANT, LESSEE/LICENSEE, PROJECT OWNER:	BOSTO
				THIS DOCUMENT WAS DEVELO AND ITS SITE CONDITIONS AN ANOTHER SITE OR WHEN OTH OF THIS DOCUMENT IS AT TH	ID IS NOT
				A.D.A. COMPLIANCE: FACILITY IS UNMANNED AND I	NOT FOR H

DO NOT SCALE DRAWINGS

CONTRACTOR SHALL VERIFY ALL PLANS AND EXISTING DIMENSIONS AND CONDITIONS ON THE JOB SITE AND SHALL IMMEDIATELY NOTIFY THE T-MOBILE NORTHEAST LLC, REPRESENTATIVE IN WRITING OF DISCREPANCIES BEFORE PROCEEDING WITH THE WORK OR BE RESPONSIBLE FOR SAME.

THIS DOCUMENT IS THE CREATION, DESIGN, PROPERTY AND COPYRIGHTED WORK OF T-MOBILE NORTHEAST LLC. ANY DUPLICATION OR USE WITHOUT EXPRESS WRITTEN CONSENT IS STRICTLY PROHIBITED. DUPLICATION AND USE BY GOVERNMENT AGENCIES FOR THE PURPOSES OF CONDUCTING THEIR LAWFULLY AUTHORIZED REGULATORY AND ADMINISTRATIVE FUNCTIONS IS SPECIFICALLY ALLOWED.

	T - Mobile*. T-MOBILE NORTHEAST LLC A DELAWARE LIMITED LIABELTY COMPANY IS COMMERCE WAY, BUTTE B NORTON: (501) 288-2700 FAX: (503) 288-2703
	Dewberry Engineers Inc. 280 SUMMER STREET 10TH FLOOR BOSTON, MA 02210 PHONE: 617.695.3400 FAX: 617.695.3310 NANEPASHEMET PROJECT MANAGEMENT 328 WEST PHORE DRIVE SUME SUME SUME CIVIL NO. 511133 PAR GISTERED
	SICANAL EN SITE CONFIGURATION: 5F APPROVALS LANDLORD
SUMMARY	LEASING
4BSM457A	R.F
BRATTLE SQUARE	
1 BRATTLE SQUARE CAMBRIDGE, MA 02138	CONSTRUCTION
BUSINESS B	
MAP 168 LOT 36	PROJECT NO: 50037672
	JOB NO: 50074320
PE: ROOF TOP	DRAWN BY: JG
WELLS REIT-ONE BRATTLE SQUARE I,LLC C/O CB RICHARD ELLIS-NE PARTNERS, LP 745 ATLANTIC AVENUE BOSTON, MA 02111	CHECKED BY: LSP SUBMITTALS
T-MOBILE NORTHEAST LLC, 15 COMMERCE WAY, SUITE B NORTON, MA 02766	
B DEVELOPED TO REFLECT A SPECIFIC SITE TIONS AND IS NOT TO BE USED FOR HEN OTHER CONDITIONS PERTAIN. REUSE IS AT THE SOLE RISK OF THE USER.	1 03/10/16 FOR CONSTRUCTION 0 10/13/15 FOR CONSTRUCTION A 08/24/15 FOR REVIEW
D AND NOT FOR HUMAN HABITATION.	4BSM457A
	BRATTLE SQUARE
	1 BRATTLE SQUARE CAMBRIDGE, MA 02138
	SHEET TITLE
	TITLE SHEET
	SHEET NUMBER
	T-1

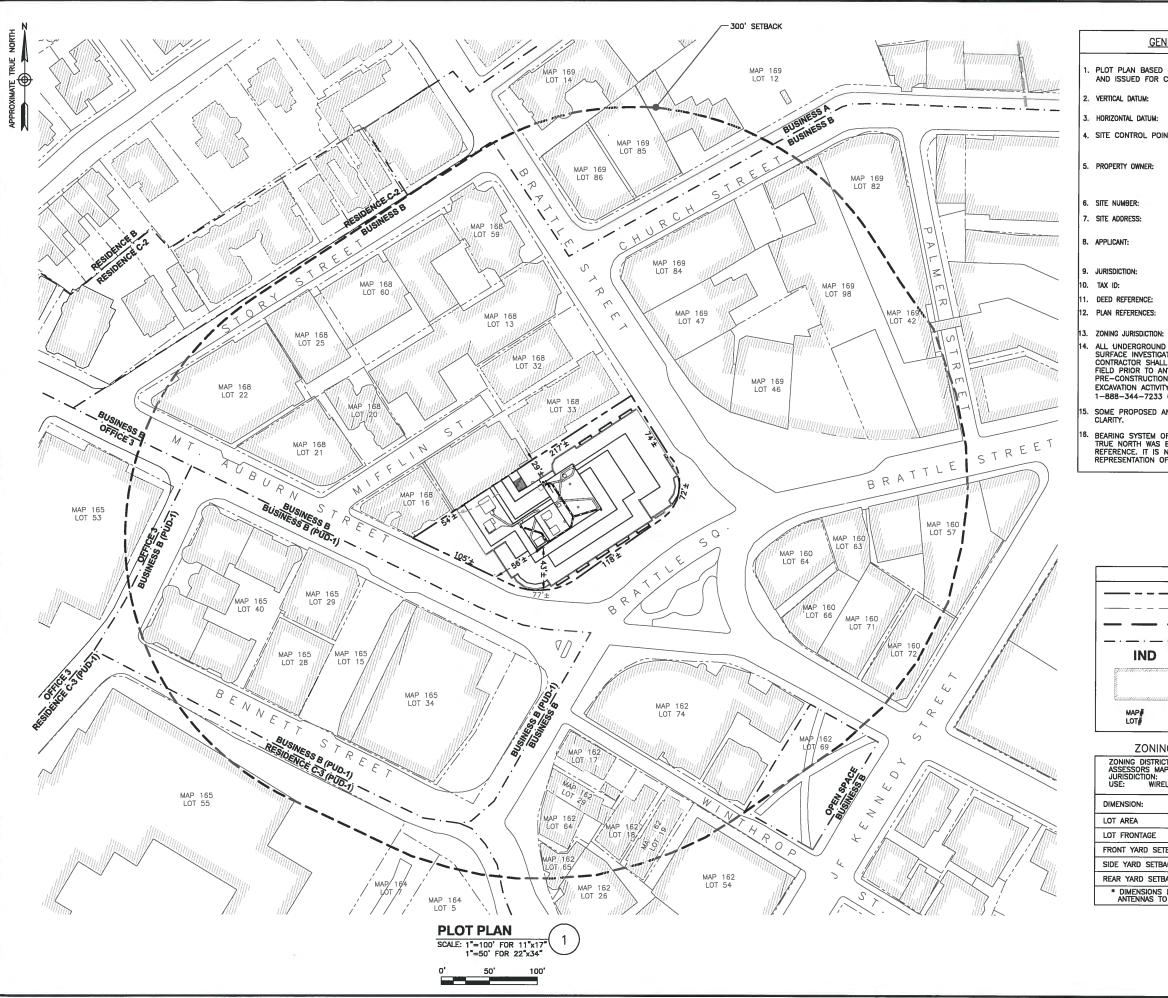

GENERAL NOTES:

	DRAWINGS BY HUDSON DESIGN GROUP, LLC, STRUCTION, REVISION 2, DATED 11/05/09.
	NORTH AMERICAN VERTICAL DATUM OF 1988 (NAVD88)
A:	NORTH AMERICAN DATUM OF 1983 (NAD83)
POINT:	CENTER OF BUILDING FOOTPRINT LATITUDE: N 42.373242° LONGITUDE: W -71.121417°
	WELLS REIT - ONE BRATTLE SQUARE I, LLC C/O CB RICHARD ELLIS - NE PARTNERS, LP 745 ATLANTIC AVENUE BOSTON, MA 02111 4BSM457A
	1 BRATTLE SQUARE CAMBRIDGE, MA 02138
	T-MOBILE NORTHEAST LLC, 15 COMMERCE WAY, SUITE B NORTON, MA 02766

CITY OF CAMBRIDGE

MAP 168 LOT 36

N/A

CITY OF CAMBRIDGE ASSESSORS MAP

N: BB-HSQ

ALL UNDERGROUND UTILITY INFORMATION WAS DETERMINED FROM SURFACE INVESTIGATIONS AND EXISTING PLANS OF RECORD. THE CONTRACTOR SHALL LOCATE ALL UNDERGROUND UTILITIES IN THE FIELD PRIOR TO ANY SITE WORK. CALL THE FOLLOWING FOR ALL PRE-CONSTRUCTION NOTIFICATION 72-HOURS PRIOR TO ANY EXCAVATION ACTIVITY: DIG SAFE SYSTEM (MA, ME, NH, RI, VT): 1-888-344-7233 CALL BEFORE YOU DIG (CT): 1-800-922-4455


SOME PROPOSED AND EXISTING INFORMATION NOT SHOWN FOR CLARITY.

BEARING SYSTEM OF THIS PLAN IS BASED ON TRUE NORTH. TRUE NORTH WAS ESTABLISHED FROM EXISTING PLAN REFERENCE. IT IS NOT INTENDED TO BE AN EXACT REPRESENTATION OF TRUE NORTH.

LEGEND				
	LOCUS PROPERTY LINE			
	300' SETBACK			
	ZONING BOUNDARY			
IND	ZONING DISTRICT			
unnunnunnun	EXISTING BUILDINGS			
MAP# Lot#	MAP/LOT			
ZONING SUMMARY TABLE				

MAP: MAF : CITY	INESS B (B 168 LOT 3 OF CAMBR DMMUNICATIO	36 IDGE			
	REQUIRED	EQUIPMENT	ANTENNA		
	-	-	28,940 S.F.		
	-	-	118 FT		
SETBACK*	NONE	INDOOR	43'±		
TBACK*	NONE	INDOOR	56'±		
TBACK*	NONE	INDOOR	29'±		
IS MEASURED FROM THE CLOSEST POINT OF TO NEAREST LOT LINE.					



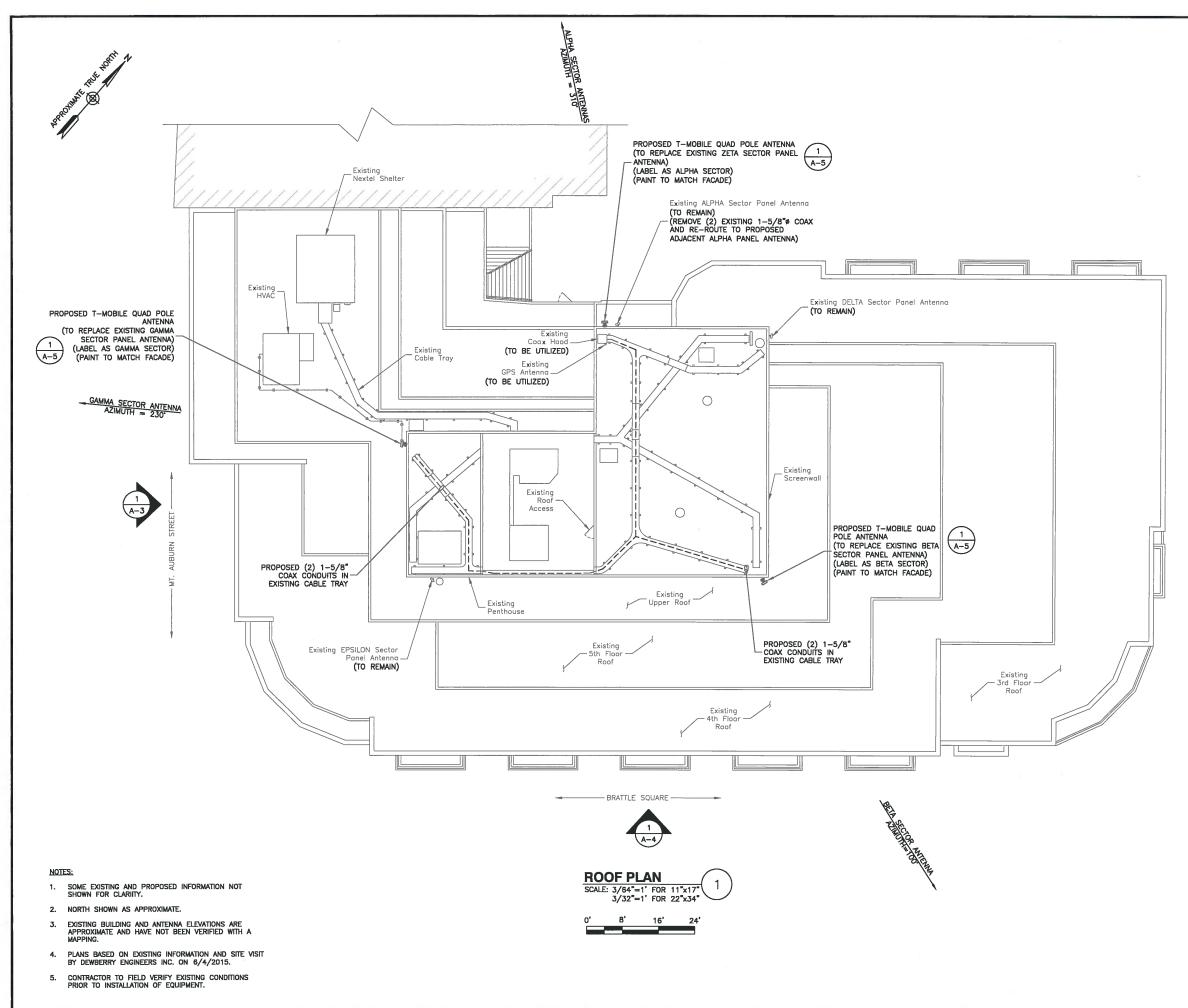


SCOPE OF WORK


 ADD (1) DUW30 TO RBS6201.
 ADD (3) RUS01 B2 RADIOS AND (6) B0 WATT RUS01 B4 RADIOS.
 ADD RET FUNCTIONALITY TO EACH SECTOR BY INSTALLING (6) SMART BIAS TEES.
 ADD (1) CELLMAX CMA-BDHH/6520/E0-B TO EACH SECTOR.
 RE-USE EXISTING GPS ANTENNA AND ADD SPLITTER AND GPS02.
 NOTE: ANTENNA MAST TOTAL COUNT = 6. EXISTING ANTENNA COUNT = 6. KEEP THREE EXISTING DUAL POLE ANTENNAS AND ADD ONE QUAD POLE CELLMAX CMA-BDHH/6520/E0-B ON THREE SECTORS (310-100-230). ADD (4) 1-5/8" HARD LINES. ROUTE HARD LINES AS REQUIRED. SEE ADDITIONAL COMMENTS

> ROOFTOP SITE WITH (6) SECTORS WITH ALL ANTENNA LOCATED ON THE PENTHOUSE ROOF. REPLACE (3) ANTENNAS WITH (3) NEW CELLMAX MED ANTENNAS. REPLACE 3 EXISTING ANTENNAS. REPLACE 3 EXISTING ANTENNAS. REPLACE 3 EXISTING DEG, 180 DEG AND 300 DEG, ADDING TWO (2) TWIN TMAS PER ANTENNA. ADD TWO (2) NEW COAX FOR ANTENNAS AT 100 DEG AND 230 DEG. MIGRATE 2 COAX FROM EXISTING 0 DEG SECTOR TO ANTENNA AT 310 DEG. REMOVE JUMPER FROM HARDLINE TO CDMA CABINET AND REPLACE WITH NEW JUMPERS TO THE LTE CABINET (ENSURE NEW JUMPERS HAVE 90 DEG CONNECTOR ON RADIO SIDE).

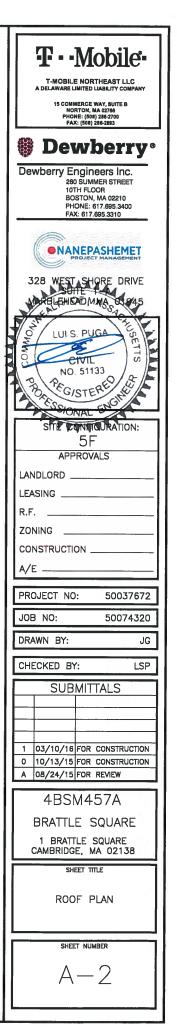EXISTING COAX LINES SHOWN CAN BE RE-USED FOR NEW ANTENNAS INSTEAD OF NEW PROPOSED COAX RUNS AS INDICATED. CONTRACTOR TO ENSURE 12 EXISTING/PROPOSED COAX RUNS ARE INSTALLED PER FINAL RFDS REQUIREMENTS. CONTRACTOR TO IDENTIFY AND REPLACE DAMAGED COAX AS REQUIRED.



------ BRATTLE STREET -----

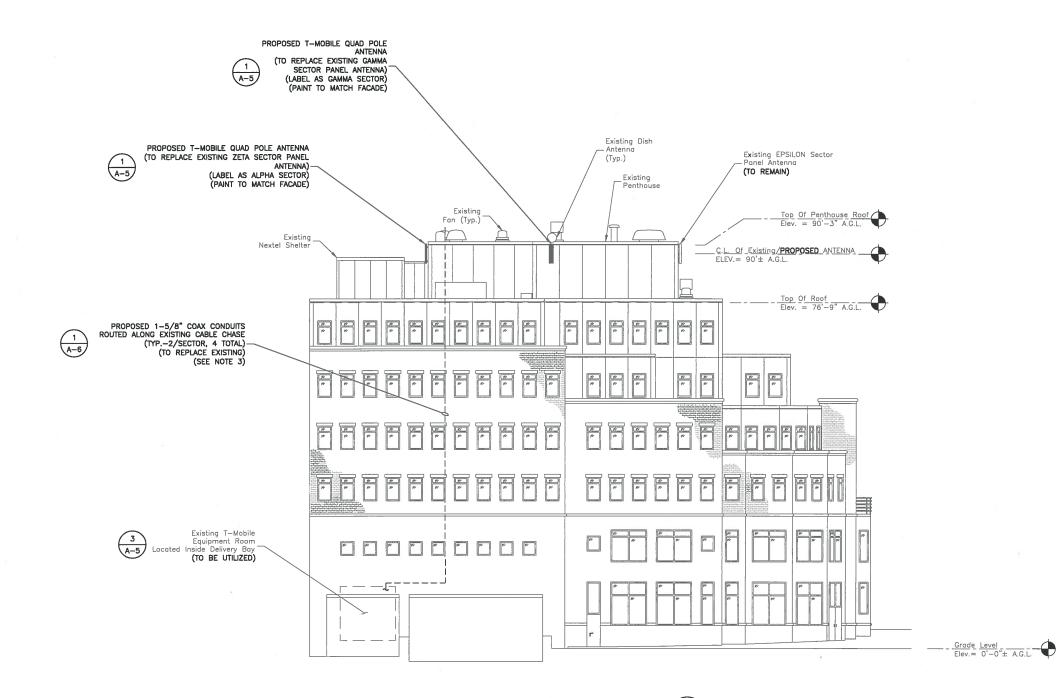

 SOUTH ELEVATION

 SCALE: 3/64*=1' FOR 11*x17"

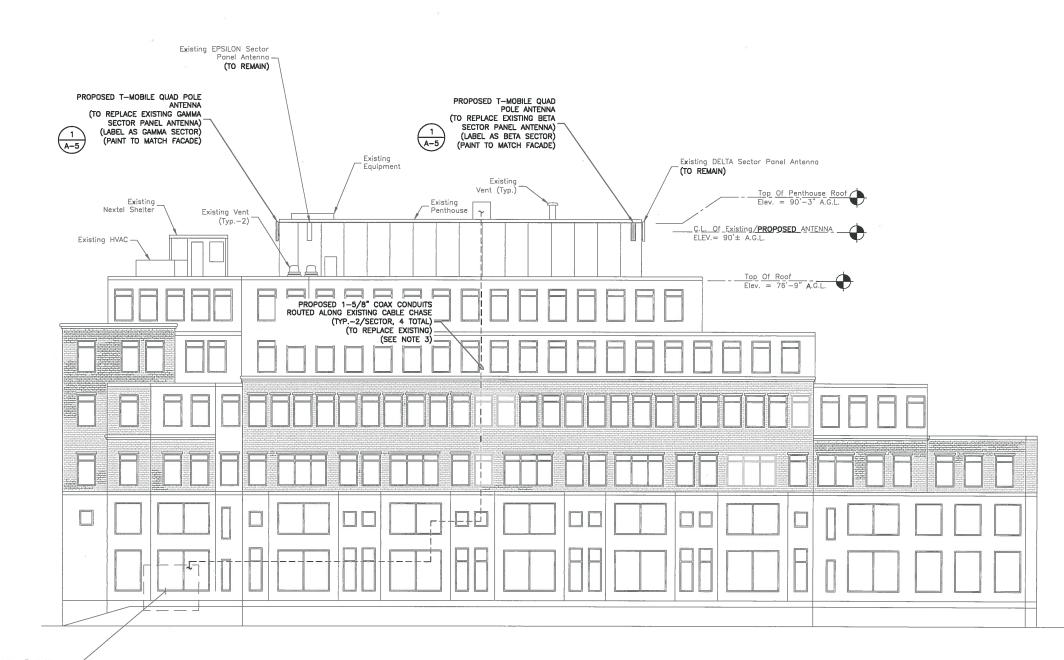
 3/32*=1' FOR 22*x34"

 0' 8' 16' 24'

NOTES:

- 1. ELEVATIONS SHOWN AS APPROXIMATE.
- 2. SOME EXISTING & PROPOSED INFORMATION NOT SHOWN FOR CLARITY.
- EXISTING COAX LINES SHOWN CAN BE RE-USED FOR NEW ANTENNAS INSTEAD OF NEW PROPOSED COAX RUNS AS INDICATED. CONTRACTOR TO ENSURE 12. EXISTING/PROPOSED COAX RUNS ARE INSTALLED PER FINAL RFDS REQUIREMENTS. CONTRACTOR TO IDENTIFY AND REPLACE DAMAGED COAX AS REQUIRED.






3 A-5

NOTES:

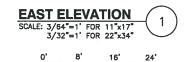Existing T-Mobile Equipment Room Located Inside Delivery Bay **(TO BE UTILIZED)**




1. ELEVATIONS SHOWN AS APPROXIMATE.

- 2. SOME EXISTING & PROPOSED INFORMATION NOT SHOWN FOR CLARITY.
- EXISTING COAX LINES SHOWN CAN BE RE-USED FOR NEW ANTENNAS INSTEAD OF NEW PROPOSED COAX RUNS AS INDICATED. CONTRACTOR TO ENSURE 12 EXISTING/PROPOSED COAX RUNS ARE INSTALLED PER FINAL RFDS REQUIREMENTS. CONTRACTOR TO IDENTIFY AND REPLACE DAMAGED COAX AS REQUIRED.

A DELAWARE LIMITED LIABILITY COMPA	NY			
15 COMMERCE WAY, SUITE B NORTON, MA 02765 PHONE: (360) 286-2700 FAX: (508) 286-2893				
Dewberry	y ®			
Dewberry Engineers Inc.	-			
280 SUMMER STREET 10TH FLOOR BOSTON, MA 02210 PHONE: 617.695.3400 FAX: 617.695.3310				
	ŗ			
328 WEST SHORE DRIV	E 5			
LUIS. PUGA				
CIVIL J	F			
NO. 51133	F			
B PECISTERE	-			
STE CONFRURATION				
5F				
APPROVALS				
LANDLORD	-			
LEASING	-			
R.F	-			
ZONING	-			
	-			
A/E				
PROJECT NO: 500376	72			
JOB NO: 500743	20			
DRAWN BY:	JG			
CHECKED BY:	SP			
	37			
SUBMITTALS				
1 03/10/16 FOR CONSTRUCT 0 10/13/15 FOR CONSTRUCT				
A 08/24/15 FOR REVIEW				
4BSM457A				
BRATTLE SQUARE				
1 BRATTLE SQUARE CAMBRIDGE, MA 02138				
SHEET TITLE				
EAST ELEVATION				
SHEET NUMBER				
A - 4				

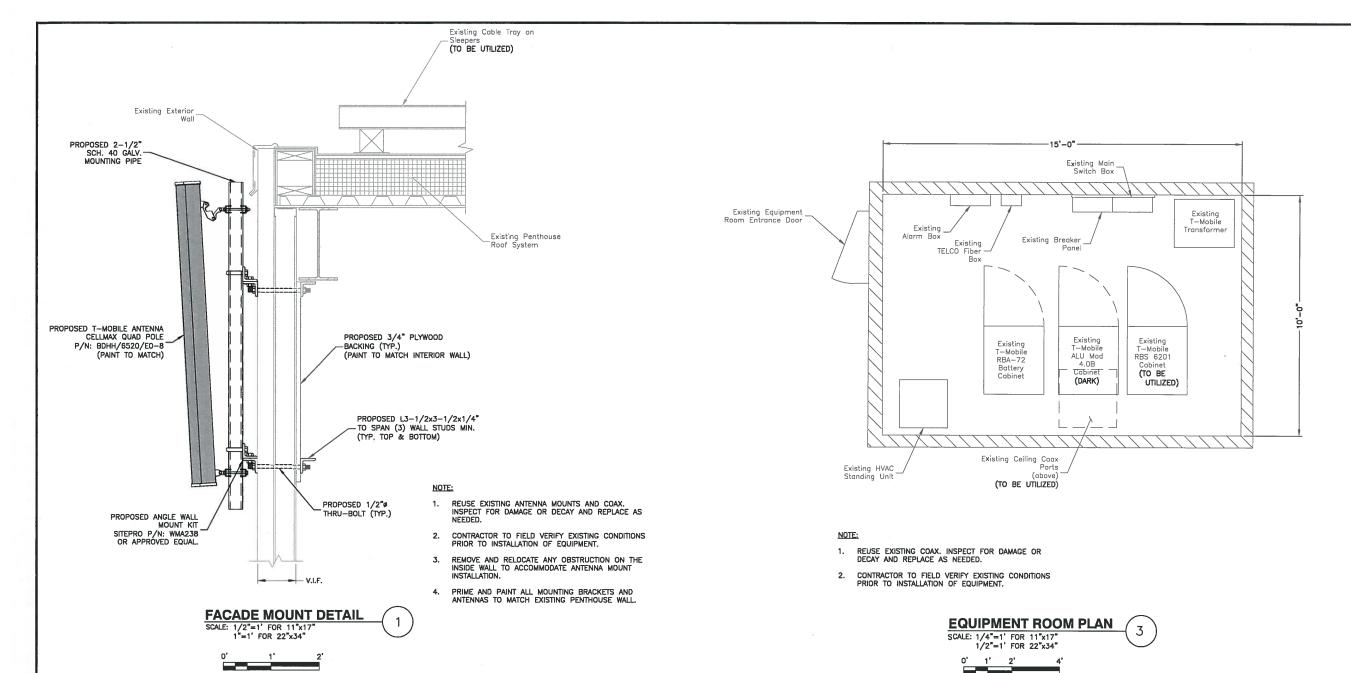
Grade Level Elev.= 0'-0"± A.G.L.



EXISTING ANTENNA (METROPCS CONFIGURATION)		PROPOSED/EXISTING ANTENNA (T-MOBILE CONFIGURATION)				
SECTOR	ANTENNA QTY.	ANTENNA MAKE & MODEL	SECTOR	ANT. QTY.	RF CABL. QTY.	ANTENNA MAKE & MODEL
ALPHA	1	KATHREIN 742 351 (60.1"x11.8"x3.3")	ALPHA	1	ο	KATHREIN 742 351 (60.1"x11.8"x3.3")
DELTA	1	KATHREIN 742 351 (60.1"x11.8"x3.3")	BETA	1	0	KATHREIN 742 351 (60.1"x11.8"x3.3")
BETA	1	KATHREIN 742 351 (60.1"x11.8"x3.3")	BETA	1	4	CELLMAX BDHH/6520/E0-8 (64.6"x15.9"x5")
EPSILON	1	KATHREIN 742 351 (60.1"x11.8"x3.3")	GAMMA	1	0	KATHREIN 742 351 (60.1"x11.8"x3.3")
Gamma	1	KATHREIN 742 351 (60.1"x11.8"x3.3")	GAMMA	1	4	CELLMAX BDHH/6520/E0-8 (64.6"x15.9"x5")
ZETA	1	KATHREIN 742 351 (60.1"x11.8"x3.3")	ALPHA	1	4	CELLMAX BDHH/6520/E0-8 (64.6"x15.9"x5")

RF SCHEDULE 2


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T-MOBILE NORTHEAST LLC ADELAWARE LUMITED LABELITY COMPANY IS COMMERCE WAY, BUITE B NORTON, MA 02766 PHORE: (500) 284-2883 FAX: (500) 284-2883 Beewbeerry *	
Dewberry Engineers Inc. 280 SUMMER STREET	
10TH FLOOR BOSTON, MA 02210	
PHONE: 617.695.3400 FAX: 617.695.3310	
328 WEST SHORE DRIVE	1
CIVIL NO. 51133 PIO CSTERED NO. 51134	
GIUNAL C.	1
SITE CONFIGURATION:	
APPROVALS	
LANDLORD	
LEASING	
R.F	
ZONING	
CONSTRUCTION	
A/E	
PROJECT NO: 50037672	
JOB NO: 50074320	
DRAWN BY: JG	
CHECKED BY: LSP	
SUBMITTALS	
1 03/10/16 FOR CONSTRUCTION 0 10/13/15 FOR CONSTRUCTION	
A 08/24/15 FOR REVIEW	
4BSM457A	
BRATTLE SQUARE	
1 BRATTLE SQUARE CAMBRIDGE, MA 02138	
SHEET TITLE	
ANTENNA, ROOM PLAN	
& RF SCHEDULE	
SHEET NUMBER	
A-5	
A-5	

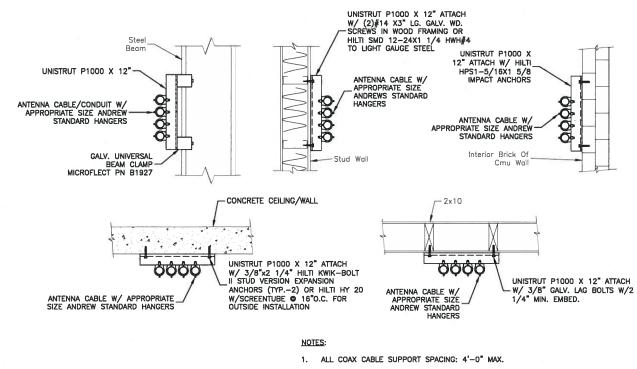



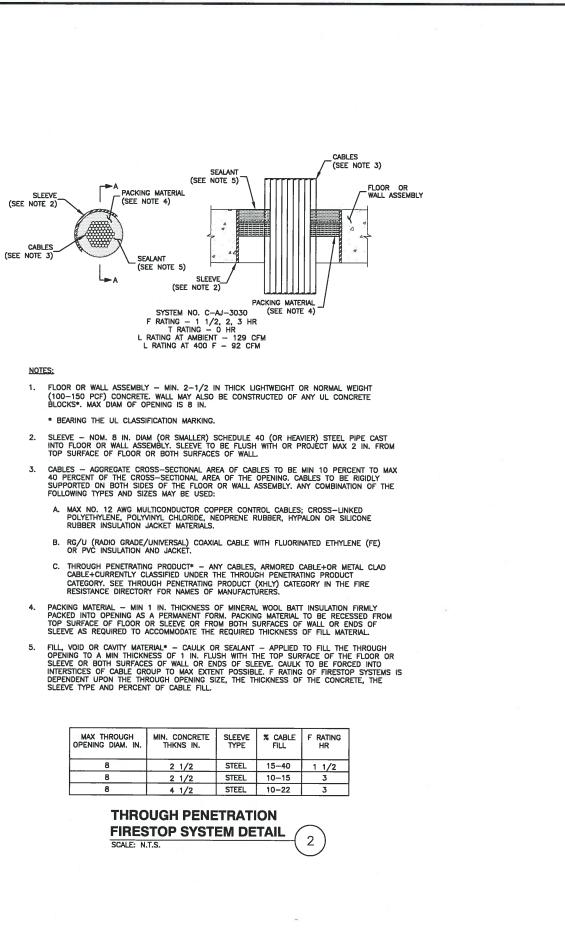ALL COAX TO BE VERTICALLY AND HORIZONTALLY SECURED THROUGHOUT CABLE RUN.






MAX THROUGH OPENING DIAM. IN.	MIN. CONCRETE THKNS IN.	SLEEVE TYPE	% CABLE FILL	F RATING HR
8	2 1/2	STEEL	15-40	1 1/2
8	2 1/2	STEEL	10-15	3
8	4 1/2	STEEL	10-22	3


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T ··Mobile·					
T-MOBILE NORTHEAST LLC A DELAWARE LIMITED LIABILITY COMPANY					
15 COMMERCE WAY, BUITE B NORTON, MA 02766 PHONE: (50) 286-2700 FAX: (508) 286-2883					
Bewberry	8				
Dewberry Engineers Inc. 280 SUMMER STREET 10TH FLOOR BOSTON, MA 02210 PHONE: 617.695.3400 FAX: 617.695.3310					
328 WEST SHORE DRIVE					
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APPROVALS	-				
LANDLORD	-				
LEASING	-				
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A/E					
PROJECT NO: 50037672	2				
JOB NO: 50074320)				
DRAWN BY: JO	3				
CHECKED BY: LSF	5				
SUBMITTALS	-				
1 03/10/16 FOR CONSTRUCTION 0 10/13/15 FOR CONSTRUCTION	-				
A 08/24/15 FOR REVIEW	-				
4BSM457A					
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4BSM457A BRATTLE SQUARE					
4BSM457A					
4BSM457A BRATTLE SQUARE					
4BSM457A BRATTLE SQUARE 1 BRATTLE SQUARE CAMBRIDGE, MA 02138 SHEET TITLE CONSTRUCTION DETAILS I					
4BSM457A BRATTLE SQUARE 1 BRATTLE SQUARE CAMBRIDGE, MA 02138 SHEET TITLE CONSTRUCTION DETAILS					

ELECTRICAL & GROUNDING NOTES

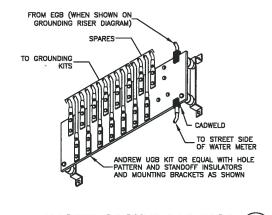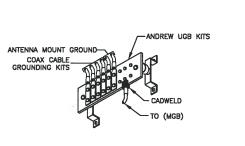- ALL ELECTRICAL WORK SHALL CONFORM TO THE REQUIREMENTS 1. OF THE NATIONAL ELECTRICAL CODE (NEC) AS WELL AS APPLICABLE STATE AND LOCAL CODES.
- 2. ALL ELECTRICAL ITEMS SHALL BE U.L. APPROVED OR LISTED AND PROCURED PER SPECIFICATION REQUIREMENTS.
- THE ELECTRICAL WORK INCLUDES ALL LABOR AND MATERIAL DESCRIBED BY DRAWINGS AND SPECIFICATION INCLUDING INCIDENTAL 3. WORK TO PROVIDE COMPLETE OPERATING AND APPROVED ELECTRICAL SYSTEM.
- GENERAL CONTRACTOR SHALL PAY FEES FOR PERMITS, AND IS RESPONSIBLE FOR OBTAINING SAID PERMITS AND COORDINATION OF INSPECTIONS. 4.
- ELECTRICAL AND TELCO WIRING OUTSIDE A BUILDING AND EXPOSED TO WEATHER SHALL BE IN WATER TICHT GALVANIZED RIGID STEEL CONDUITS OR SCHEDULE BO PVC (AS PERMITTED BY CODE) AND WHERE REQUIRED IN LIQUID TICHT FLEXIBLE METAL OR NONMETALLIC CONDUITS. 5.
- 6. RIGID STEEL CONDUITS SHALL BE GROUNDED AT BOTH ENDS.
- ELECTRICAL WIRING SHALL BE COPPER WITH TYPE XHHW, THWN, OR THIN INSULATION. 7.
- RUN ELECTRICAL CONDUIT OR CABLE BETWEEN ELECTRICAL UTILITY 8. DEMARCATION POINT AND LESSEE/LICENSEE CELL SITE PPC AS INDICATED ON THIS DRAWING. PROVIDE FULL LENGTH PULL ROPE. COORDINATE INSTALLATION WITH UTILITY COMPANY
- RUN TELCO CONDUIT OR CABLE BETWEEN TELEPHONE UTILITY DEMARCATION POINT AND LESSEE/LICENSEE CELL SITE TELCO CABINET AND BTS CABINET AS INDICATED ON THIS DRAWING PROVIDE FULL LENGTH PULL ROPE IN INSTALLED TELCO CONDUIT. PROVIDE GREENLEE CONDUIT MEASURING TAPE AT 9. END.
- 10. ALL EQUIPMENT LOCATED OUTSIDE SHALL HAVE NEMA 3R ENCLOSURE.
- 11. GROUNDING SHALL COMPLY WITH NEC ART, 250.
- GROUND COAXIAL CARLE SHIELDS MINIMUM AT BOTH ENDS LISING 12. MANUFACTURER'S COAX CABLE GROUNDING KITS SUPPLIED BY LESSEE/LICENSEE.
- 13. USE #6 COPPER STRANDED WIRE WITH GREEN COLOR INSULATION FOR GROUNDING (UNLESS OTHERWISE SPECIFIED) AND #2 SOLID TINNED BARE COPPER WIRE FOR BELOW GRADE GROUNDING AS INDICATED ON THE
- ALL GROUND CONNECTIONS TO BE BURNDY HYGROUND COMPRESSION TYPE CONNECTORS OR CADWELD EXOTHERMIC WELD. DO NOT ALLOW BARE COPPER WIRE TO BE IN CONTACT WITH GALVANIZED STEEL. 14.
- 15. ROUTE GROUNDING CONDUCTORS ALONG THE SHORTEST AND STRAIGHTEST PATH POSSIBLE, EXCEPT AS OTHERWISE INDICATED, GROUNDING LEADS SHOULD NEVER BE BENT AT RIGHT ANGLE. ALWAYS MAKE AT LEAST 12" RADIUS BENDS. #6 WIRE CAN BE BENT AT 6" RADIUS WHEN NECESSARY. BOND ANY METAL OBJECTS WITHIN 6 FEET OF LESSEE/LICENSEE EQUIPMENT OR CABINET TO MASTER GROUND BAR OR GROUNDING RING.
- CONNECTIONS TO GROUND BARS SHALL BE MADE WITH TWO HOLE COMPRESSION TYPE COPPER LUGS. APPLY OXIDE INHIBITING COMPOUND TO ALL LOCATIONS. 16.
- 17. APPLY OXIDE INHIBITING COMPOUND TO ALL COMPRESSION TYPE GROUND CONNECTIONS
- BOND ANTENNA MOUNTING BRACKETS, COAXIAL CABLE GROUND KITS, AND ALNA TO EGB PLACED NEAR THE ANTENNA LOCATION.
- 19. BOND ANTENNA EGBS AND MGB TO GROUND RING.
- 20. TEST COMPLETED GROUND SYSTEM AND RECORD RESULTS FOR PROJECT CLOSE-OUT DOCUMENTATION. 5 OHMS MINIMUM RESISTANCE REQUIRED.
- 21. BOND ANY METAL OBJECT WITHIN 7 FEET OF THE PROPOSED EQUIPMENT OR CABINET TO MASTER GROUND BAR.
- 22. VERIFY PROPOSED SERVICE UPGRADE WITH LOCAL UTILITY COMPANY PRIOR TO CONSTRUCTION.








EQUIPMENT GROUND BAR (EGB) SCALE: N.T.S.

2

To Existing Service



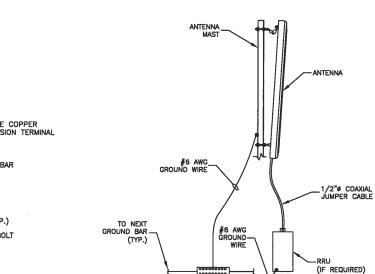GROUND BAR.



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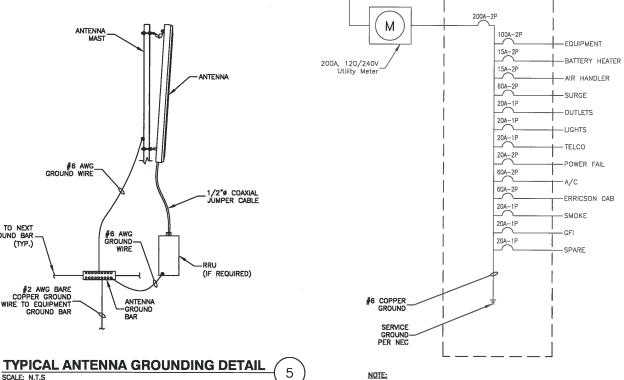
GROUND

RA

#2 AWG BARE COPPER GROUND WIRE TO EQUIPMENT GROUND BAR

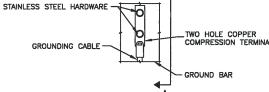
SCALE: N.T.S

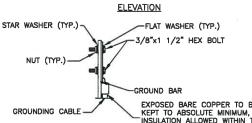
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1.










NOTES:

- DOUBLING UP OR STACKING OF 1. CONNECTIONS IS NOT PERMITTED.
- 2. OXIDE INHIBITING COMPOUND TO BE USED AT ALL LOCATIONS.

TYPICAL GROUND BAR MECHANICAL CONNECTION DETAIL

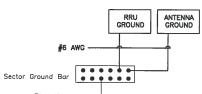SCALE: N.T.S.



......

#6 AWG

#2 AWG -

#2 AWG —

Existing MGB

Existing Equipment

NOTES:

Room MGB

ALL PROPOSED EQUIPMENT TO BE GROUNDED TO SECTOR

2. TYPICAL FOR ALL SECTORS.

3

VERIFY REQUIRED BREAKER SIZE WITH T-MOBILE CM CONTRACTOR TO VERIFY EXISTING PANEL CONDITIONS AND ALL EXISTING WIRING PRIOR TO INSTALLATION. CONTRACTOR TO CONFIRM EXISTING PANEL HAS CAPACITY FOR BREAKER REQUIREMENTS AND EXISTING CONDUITS/WIRING ARE SUITABLE FOR ANY UPGRADE.

6

ONE LINE POWER DIAGRAM

T··Mobile· T-MOBILE NORTHEAST LLC 15 COMMERCE WAY, SUITE B NORTON, MA 02766 PHONE: (508) 286-2700 FAX: (508) 286-2893 Dewberry* Dewberry Engineers Inc. 280 SUMMER STREET 10TH FLOOR BOSTON, MA 02210 PHONE: 617.695.3400 FAX: 617 695 3310 NANEPASHEMET 328 WEST SHORE DRIVE MARELEHEAD M MA 01 945 UIS PUGA 72 CIVIL NO 51133 PEGISTERED STIL CONFICURATION: APPROVALS LANDLORD LEASING R.F. ZONING CONSTRUCTION A/E PROJECT NO: 50037672 50074320 JOB NO: DRAWN BY: JG LSP CHECKED BY: SUBMITTALS 1 03/10/16 FOR CONSTRUCTION 0 10/13/15 FOR CONSTRUCTION A 08/24/15 FOR REVIEW 4BSM457A BRATTLE SQUARE 1 BRATTLE SQUARE CAMBRIDGE, MA 02138 SHEET TITLE GROUNDING DETAILS & NOTES SHEET NUMBER



15 Commerce Way Norton, MA 02766

PHOTO SIMULATION

4BSM457A BRATTLE SQUARE

Address:

1 Brattle Square CAMBRIDGE, MA 02138

> Date: 16 MARCH 2016

Prepared by Nanepashemet Project Management, Inc. 328 West Shore Drive Marblehead, MA 01945

PHOTO LOCATION MAP




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4BSM457A - BRATTLE SQUARE



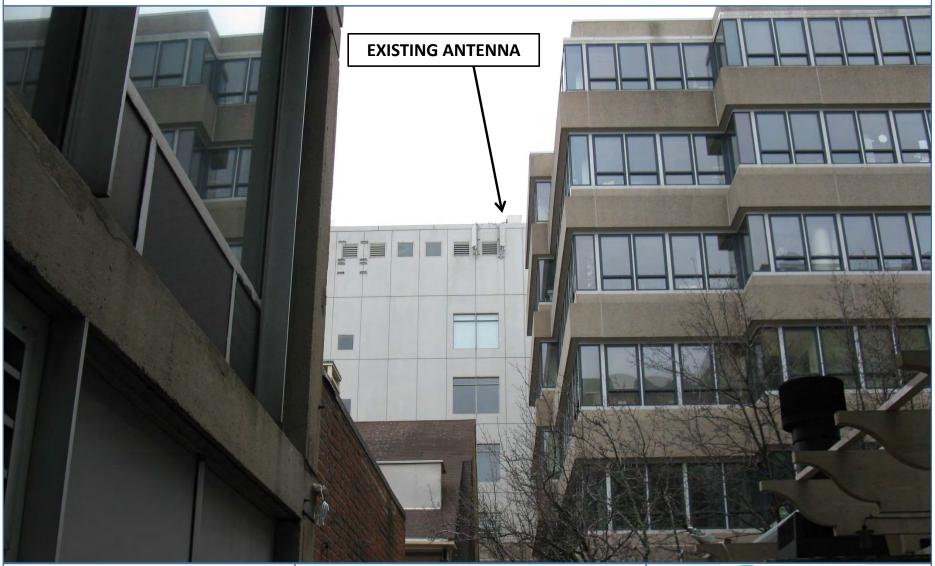PHOTO LOCATION 1 - EXISTING




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4BSM457A - BRATTLE SQUARE



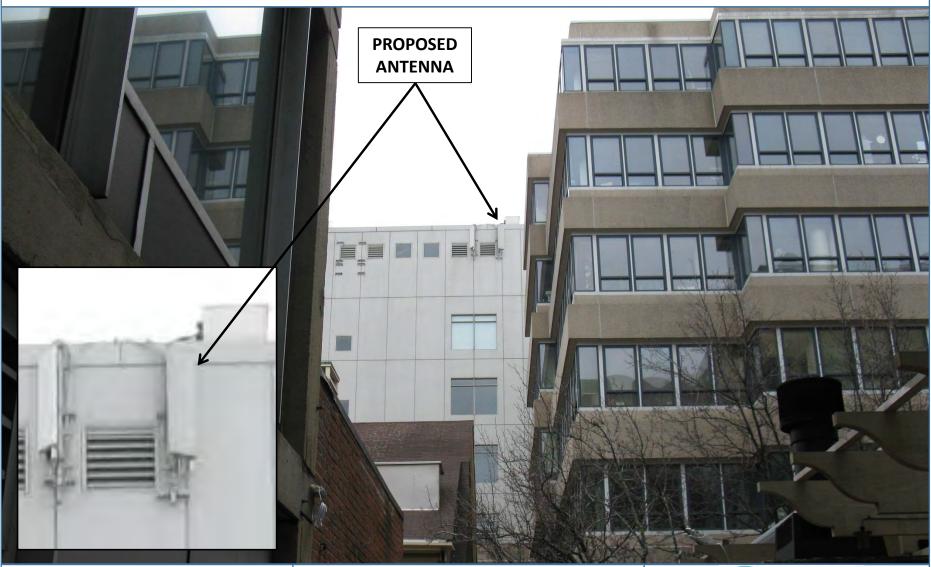PHOTO LOCATION 1 - PROPOSED



4BSM457A - BRATTLE SQUARE

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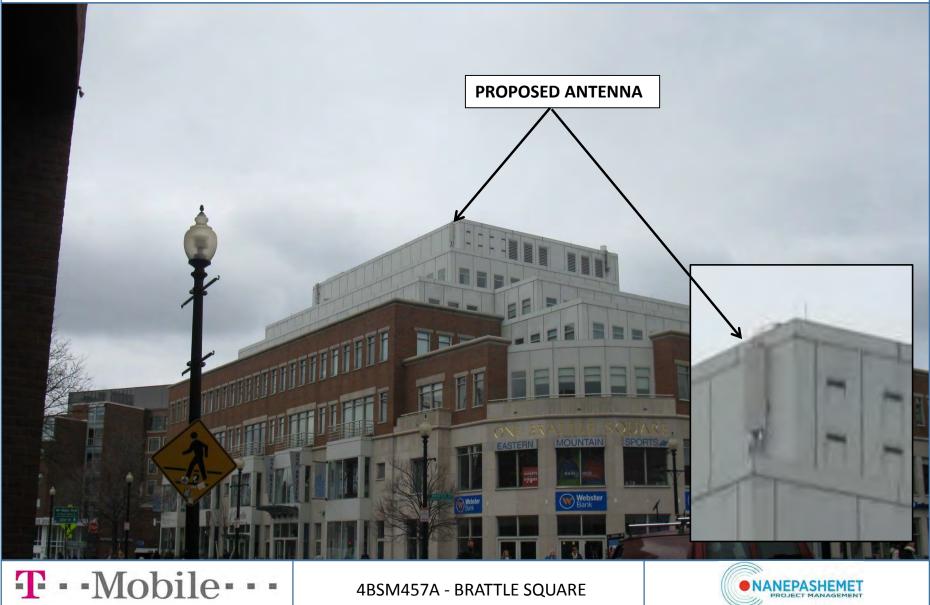


PHOTO LOCATION 2 - EXISTING



4BSM457A - BRATTLE SQUARE

PHOTO LOCATION 2 - PROPOSED



4BSM457A - BRATTLE SQUARE



