

November 26, 2018

Planning Board City of Cambridge 344 Broadway Cambridge, MA 02139

Re: Modifications to PB342

Dear Chairman Cohen and members of the Board:

Ascend Mass, LLC ("Ascend") appreciates the opportunity to present the enclosed modifications to its proposal to operate a Registered Marijuana Dispensary ("RMD") at 200 Monsignor O'Brien Highway.

1. Small Project PTDM Plan

The City of Cambridge's Parking and Transportation Demand Management Planning Officer has approved the Small Project PTDM Plan for 200 Monsignor O'Brien Highway, enclosed hereto as Exhibit A.

2. Modifications to Site Plan

Please see the enclosed proposed modifications to Ascend's site plan based on the feedback of the Board and Community Development Department staff, enclosed hereto as Exhibit B. Proposed changes include: (1) a narrowed curb cut; (2) the incorporation of landscaping to separate the parking lot from the street; (3) more clearly delineated short-term bicycle racks and long-term bicycle storage; and (4) additional landscaping along the perimeter of the parking lot.

3. Modifications to Window Displays

Please see the enclosed proposed modifications to Ascend's floorplan ("Exhibit C") and exterior renderings ("Exhibit D"). At the suggestion of the Board, the displays have been offset from the window frame approximately 24 inches. Inverted windows are proposed at the top of the display area to allow for the natural flow of light into the facility.

4. Rooftop Equipment

Please see the enclosed elevations that demonstrate the public view of proposed rooftop equipment, attached hereto as Exhibit E. Also enclosed, please find the existing roof plan, attached hereto as Exhibit F.

5. Lighting Plans.

Please see the existing lighting plans, attached hereto as Exhibit G.



We appreciate your thoughtful comments and look forward to the forthcoming hearing. Please do not hesitate to contact me directly for any further information.

Sincerely,

Andrea Cabral

Chief Executive Officer

Ascend Mass, LLC

City of Cambridge Community Development Department 344 Broadway, Cambridge, MA 02139

Attn: PTDM Planning Officer
Tel: (617) 349-4673 Fax: (617) 349-4633 TTY: (617) 349-4621
sgroll@cambridgema.gov http://www.cambridgema.gov/~CDD/et/tdm/index.html

Parking and Transportation Demand Management Small Project Plan


If project has 5 to 19 total parking spaces (existing plus new), please attach Interdepartmental Parking Facility Registration form and provide the following information.		
Property owner: Curley, Patrick A	A, Jr. Trustee of Allen Realty Trust	
Facility address: 200 Monsigno	r O'Brien Highway, Cambridge, MA 02141	
Contact name:	ca Rutenberg	
Phone: 6106755958 Fax:	Email: info@ascendmass.com	
# Car parking spaces: 5 # Bike spaces (long- & short-term): 16 Sq Ft: 3280 SF lot 5100 SF bldg		
Select at least three transportation of	demand management / trip reduction measures:	
Measure	Details	
☐ Transit subsidy (must be at least 50%)	Amount of monthly subsidy per person: 65% MBTA pass	
☐ Charge drivers directly for cost of auto parking	Cost of parking charged directly to driver: Percent of full cost:	
■ Subsidy for other modes	Amount of monthly subsidy (indicate mode): Full Bluebikes membership - Gold	
□ Shuttle service to nearby MBTA station	Station(s) served: Peak frequency:	
Preferential carpool parking program	Attach parking plan and application form for use of reserved spaces.	
□ Reduced rates for carpool parking	Cost of monthly parking for a carpool: Attach application needed to qualify for reduced rates.	
Bicycle amenities (above zoning requirement)	Describe: 3 short term spaces required; 16 provided	
☐ Car-share parking space	Describe terms (donated or leased):	
Other measures (See PTDM Officer list)	Attach description. Plnase see attached	
OWNER SIGNATURE:	DATE: 10/24/18	
	PTDM PLANNING OFFICER USE ONLY ED WITH CONDITIONS (SEE ATTACHED) Denied	
SIGNED: THO MOUL	Mag DATE: 11/21/18	

Ascend is comfortable with the below mentioned TDM Measures.


- 1. Provide 65% MBTA T-Pass subsidies, up to the federal fringe benefit limit, to all employees (may pro-rate incentive for part-time employees). The program shall be administered by the employer through the MBTA Corporate Pass Program.
- 2.Offer all employees Gold-Level Bluebikes bikeshare membership, to be administered through the Bluebikes Corporate Program by the employer.
- 3. Provide lockers for employees that walk or bike to work.
- 4. Have available an air pump and bicycle repair tools for employee and customers to use when needed.
- 5.Designate an employee of the facility as a Transportation Coordinator (TC) to manage the implementation of TDM measures and a transportation monitoring program. The TC will:
 - a. Post in a central and visible location (i.e., lobby for customers, break room for employees) information on available non-automobile services in the area, including, but not limited to:
 - i. Available pedestrian and bicycle facilities near the Project site.
 - ii. MBTA maps, schedules and fares.
 - iii. "Getting Around Cambridge" map (available at the Cambridge Community Development office).
 - iv. Locations of bicycle parking.
 - v. Bluebikes regional public bikeshare system.
 - vi. Carpool-matching programs.
 - vii. Other pertinent transportation information.
 - ix. Instead or in addition to posting paper MBTA schedules, provide a realtime transportation display screen or tablet in a central location to help people decide which mode to choose for each trip.
 - b. Compile and provide to all employees up-to-date transportation information explaining all commuter options. This information should also be distributed to all new employees as part of their orientation.
 - c. Provide customers with sustainable transportation information to access the site.
 - d. Provide and maintain information on the project's public website, newsletters, social media, etc. on how to access the site by all modes, with emphasis on sustainable modes.
 - e. Participate in any TC training offered by the City or local Transportation Management Association.

Traffic Monitoring


- 1. The TC will implement an annual transportation monitoring program which will involve surveying employees and customers on their travel modes and where they customarily park (cars and bikes). This monitoring data should help to inform the development of future medical marijuana dispensary projects, as we begin to better understand the trip generation and the demand for various travel modes. The annual monitoring program shall be in place for 10 years following the issuance of the project's Occupancy Permit at which time TP&T will work with the applicant to determine if it would be beneficial to continue the monitoring program.
- 2. The monitoring program should include information/observations of the loading activities (i.e., locations, number of times per week, etc.).
- 3. All surveys shall be designed and conducted in a manner approved by TP& T and the Community Development Department (CDD).
- 4. Approval of the form of any survey instrument or monitoring method should be approved before issuance of the Certificate of Occupancy.
- 5. Surveying shall begin one year from the date of the first Certificate of Occupancy. If the Certificate of Occupancy is issued between September 1st and February 29th, the monitoring should take place during the months of September or October and be reported to the City no later than November 30.If the Certificate of Occupancy is issued between March 1st and August 31st, monitoring should take place during the months of April or May and be reported to the City no later than June 30.

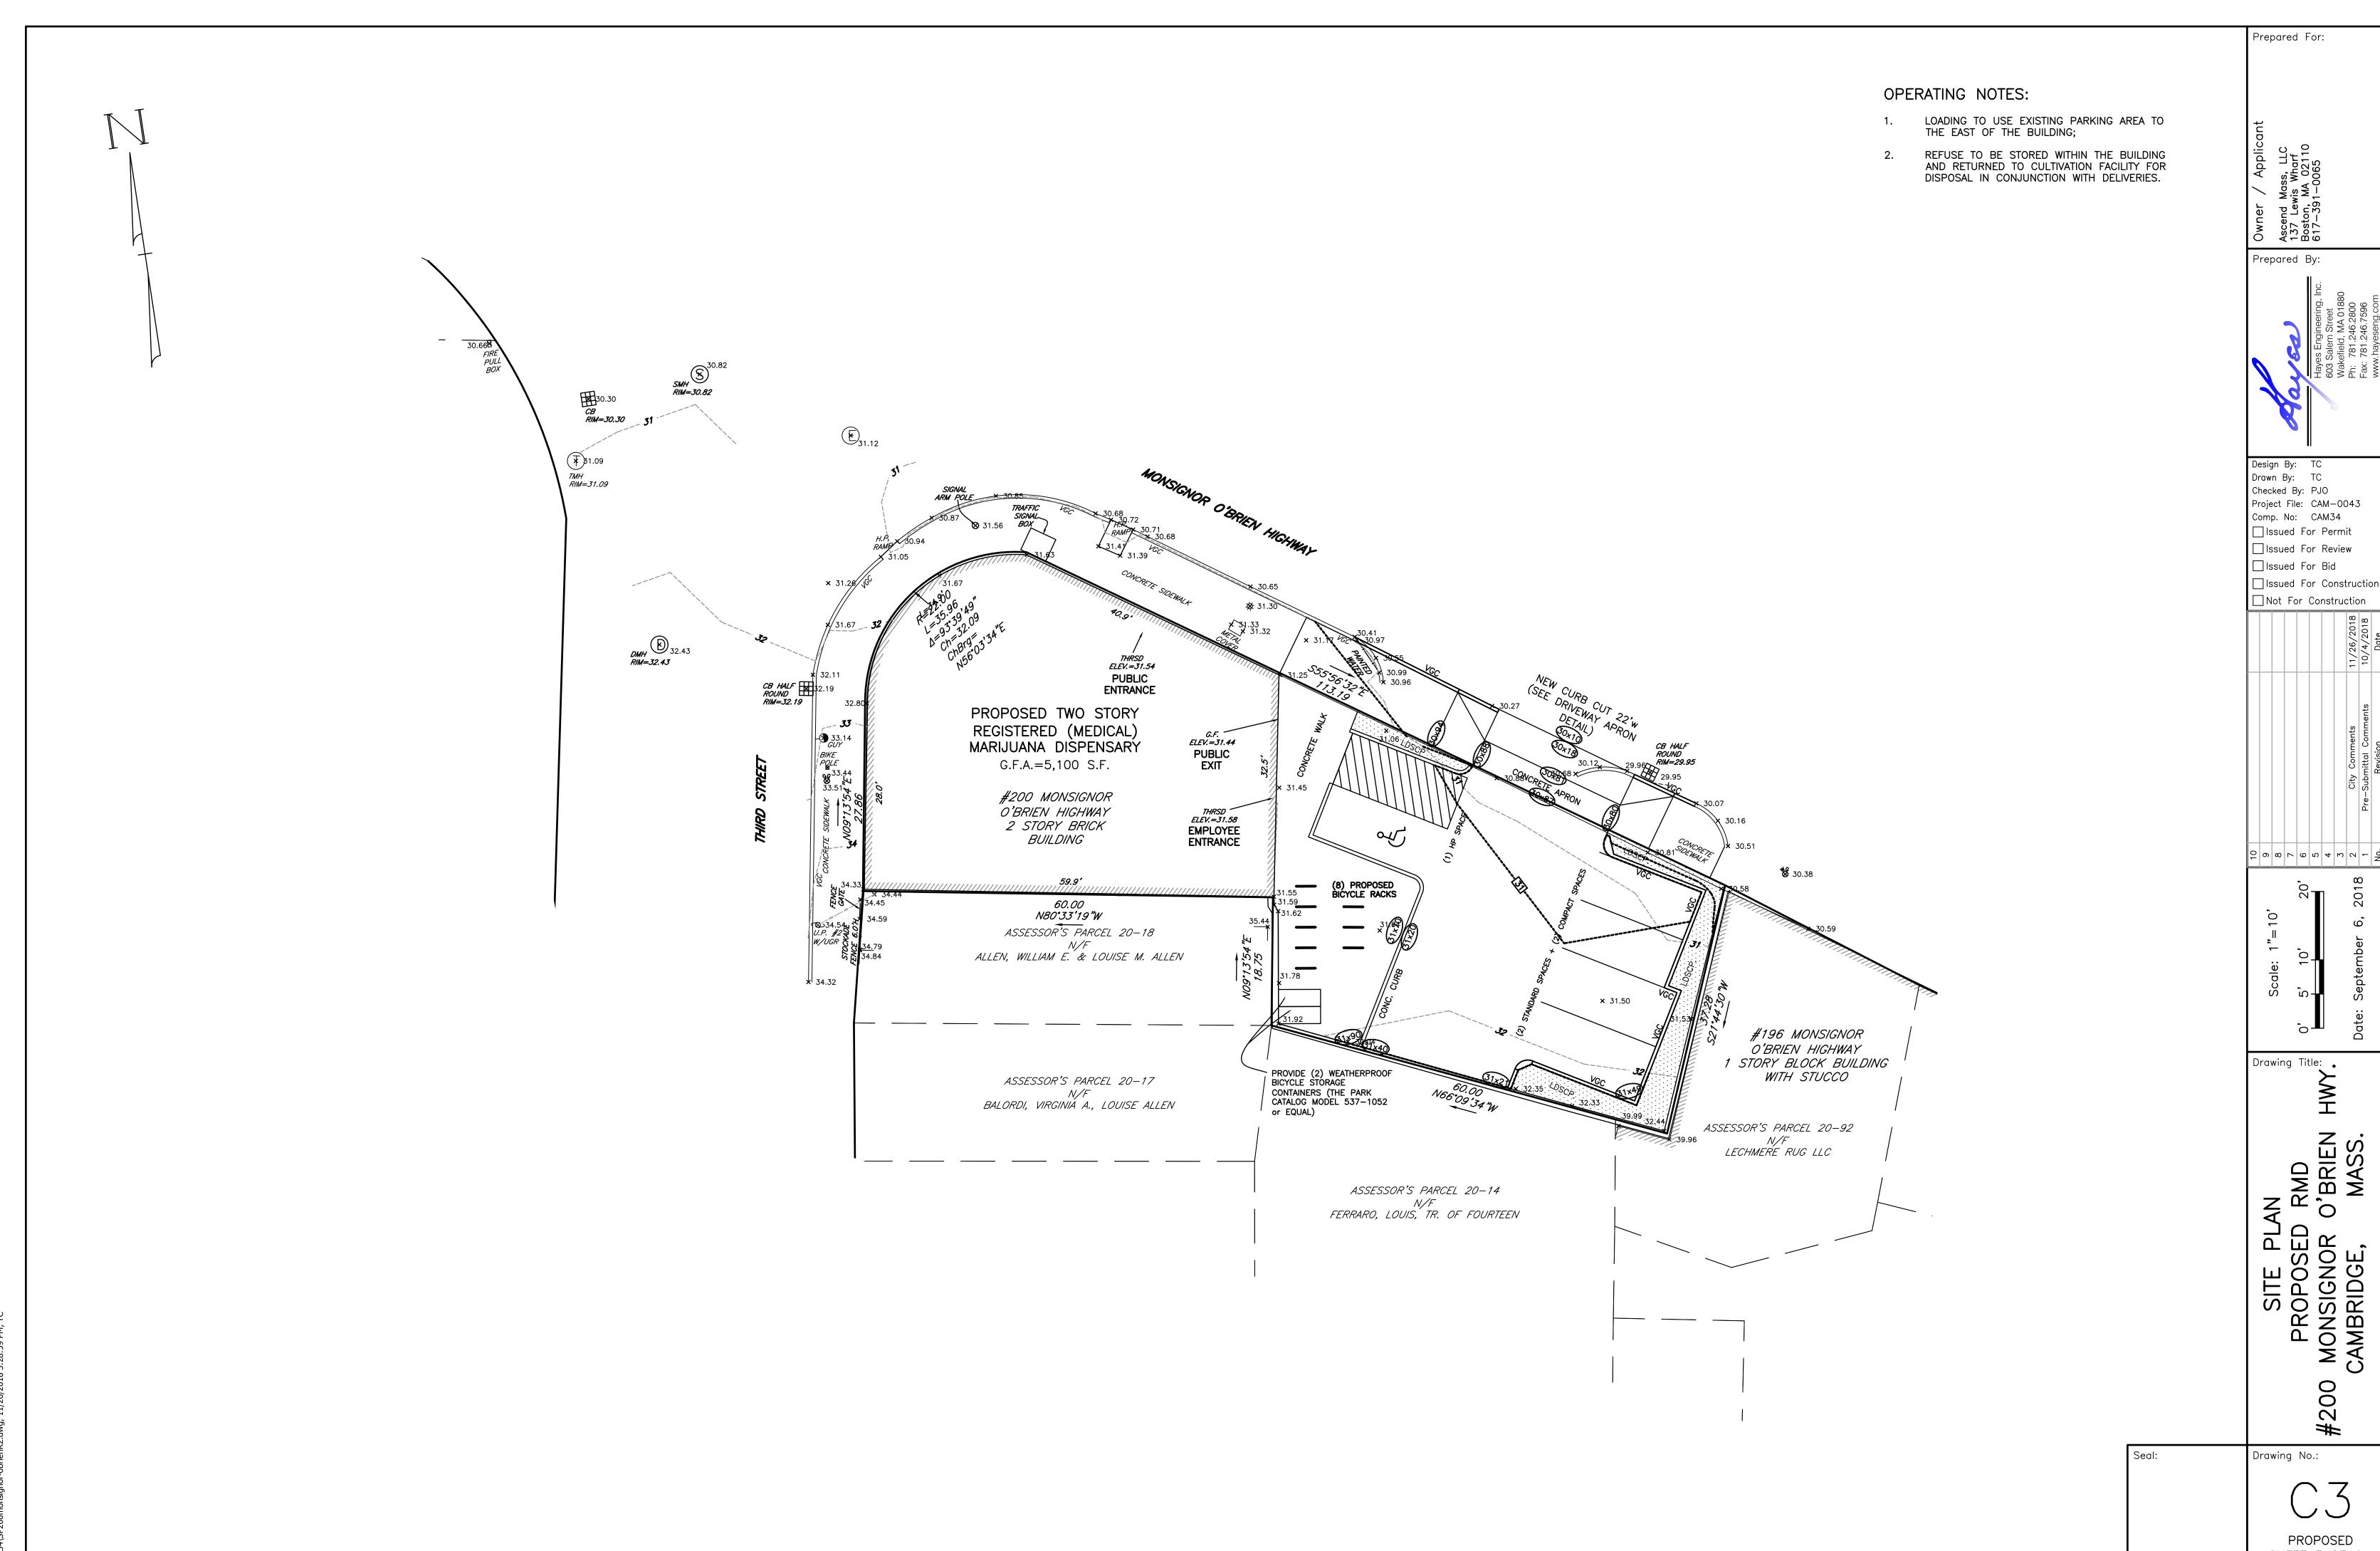



PROPOSED SHEET 3 OF 6

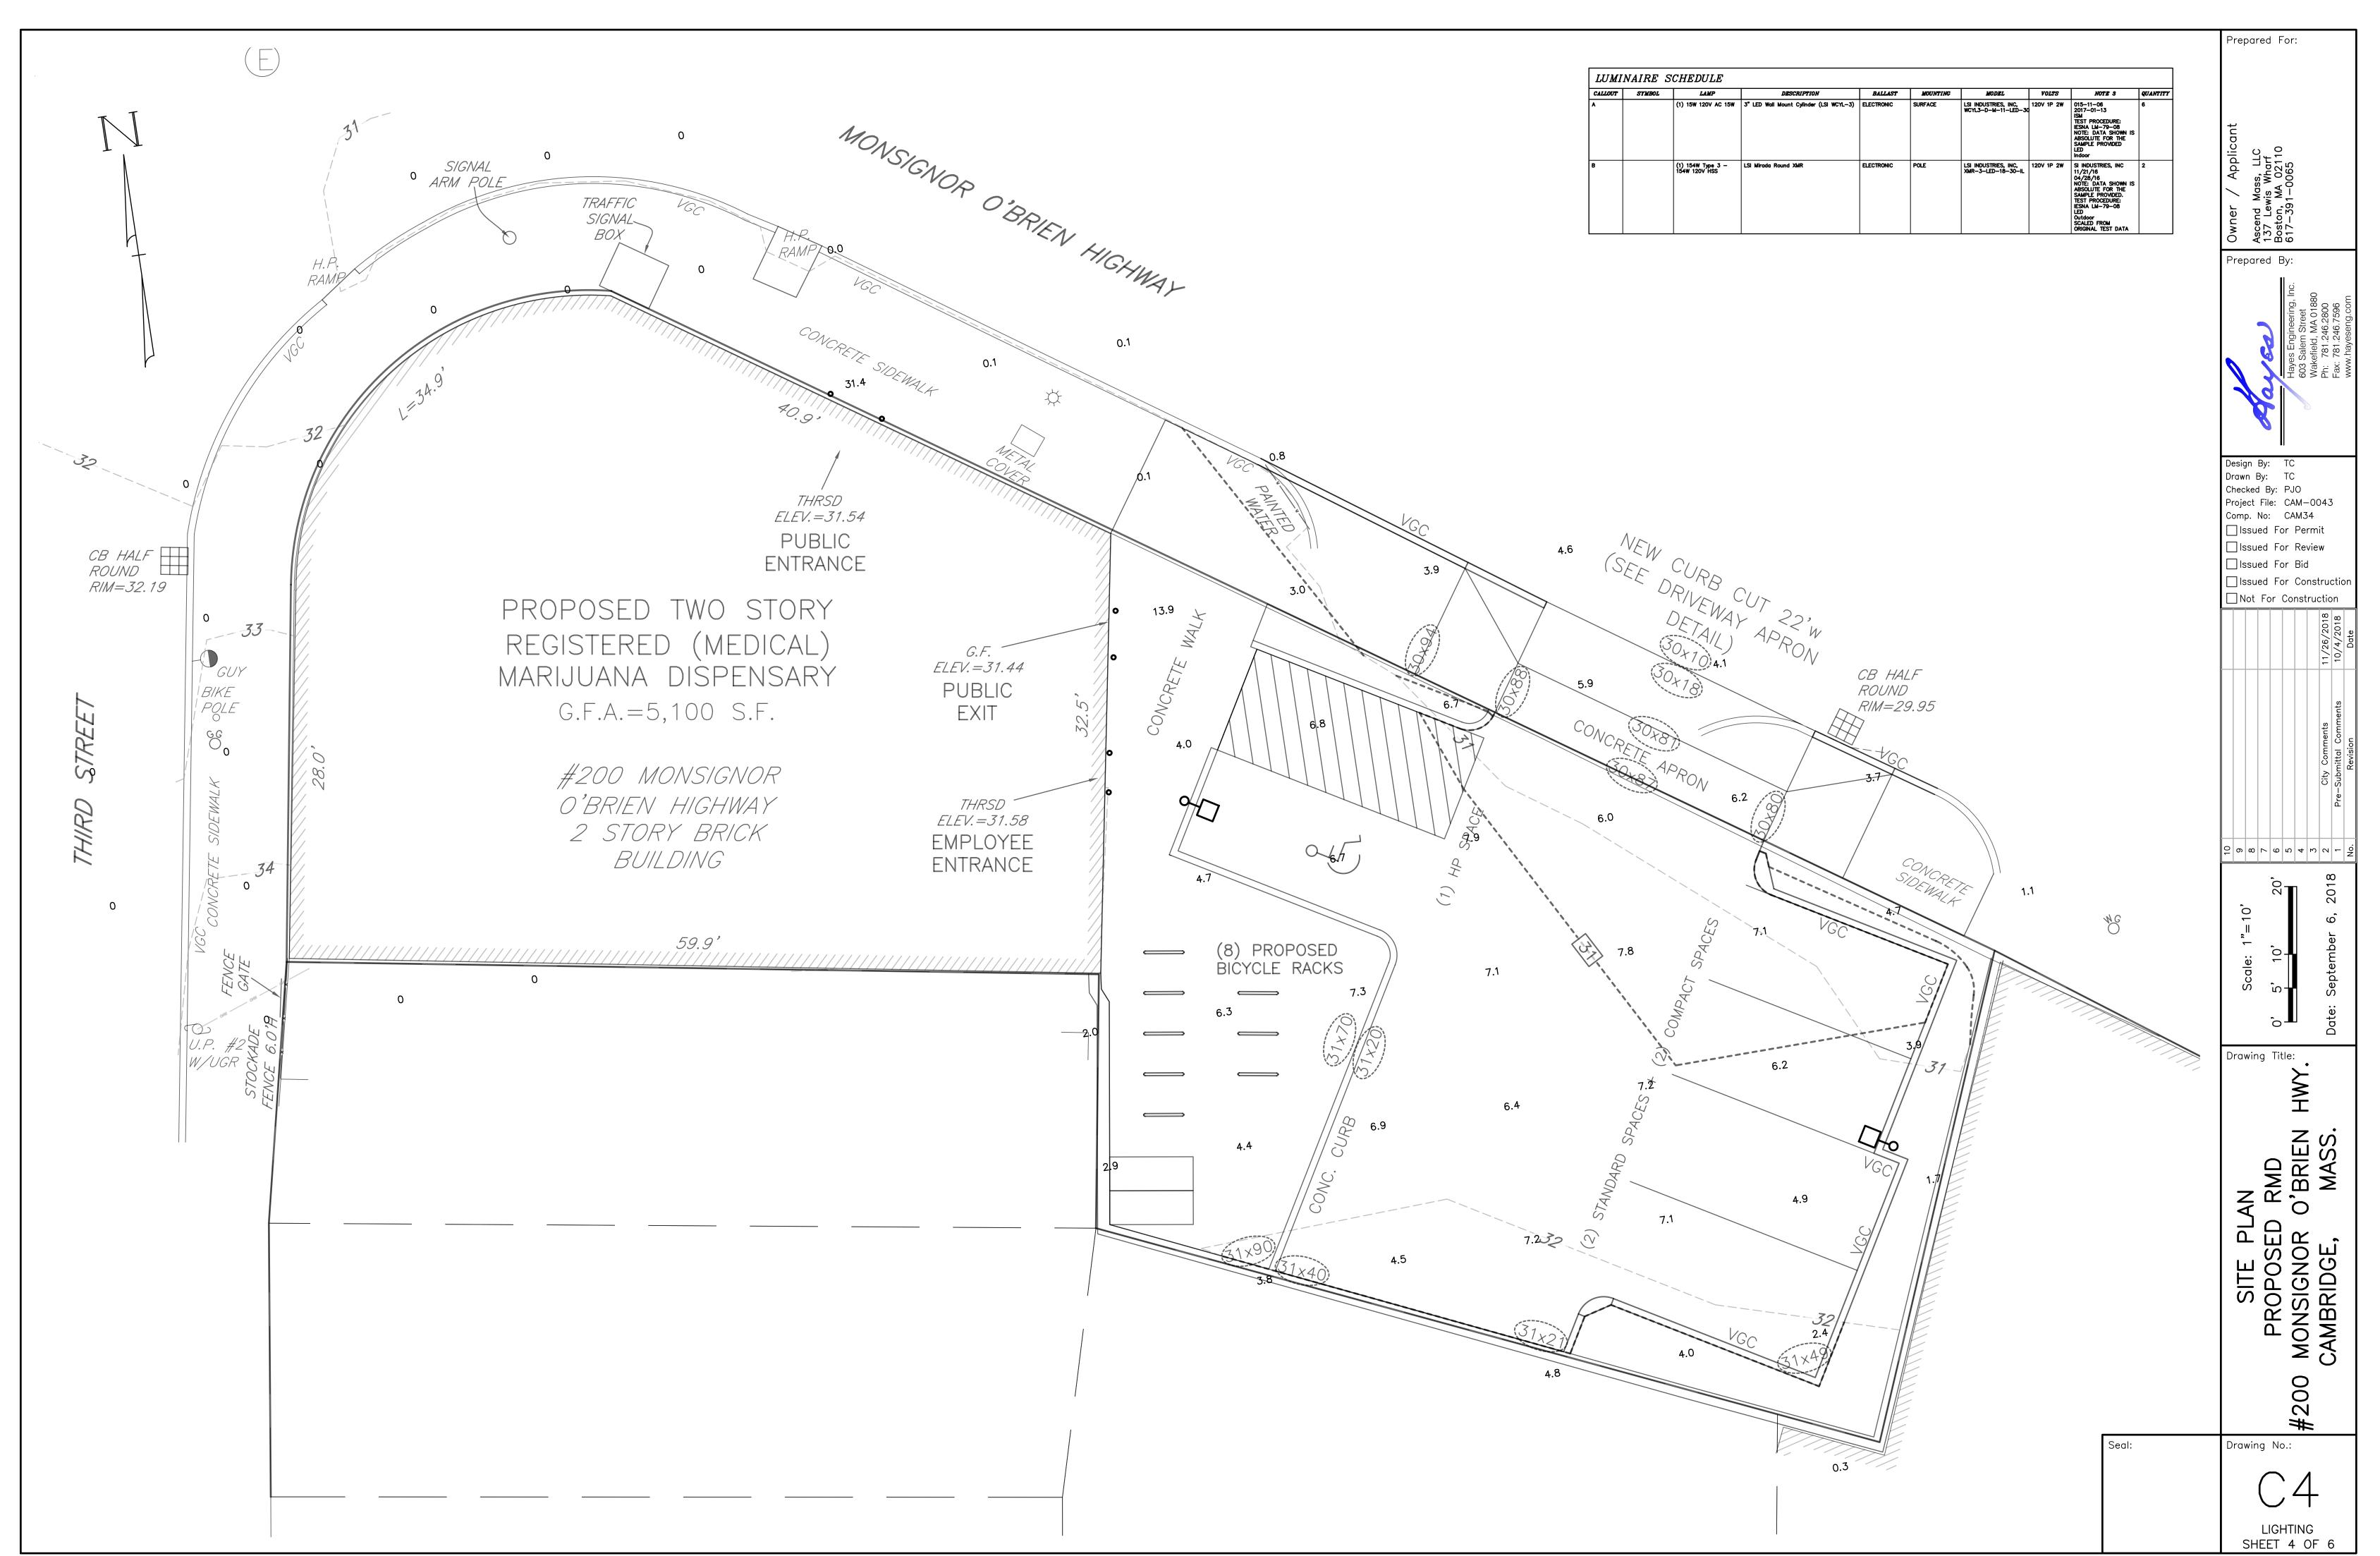

CAM34\SP200monsignor-obrienR2.dwg, 11/26/2018 3:29:04

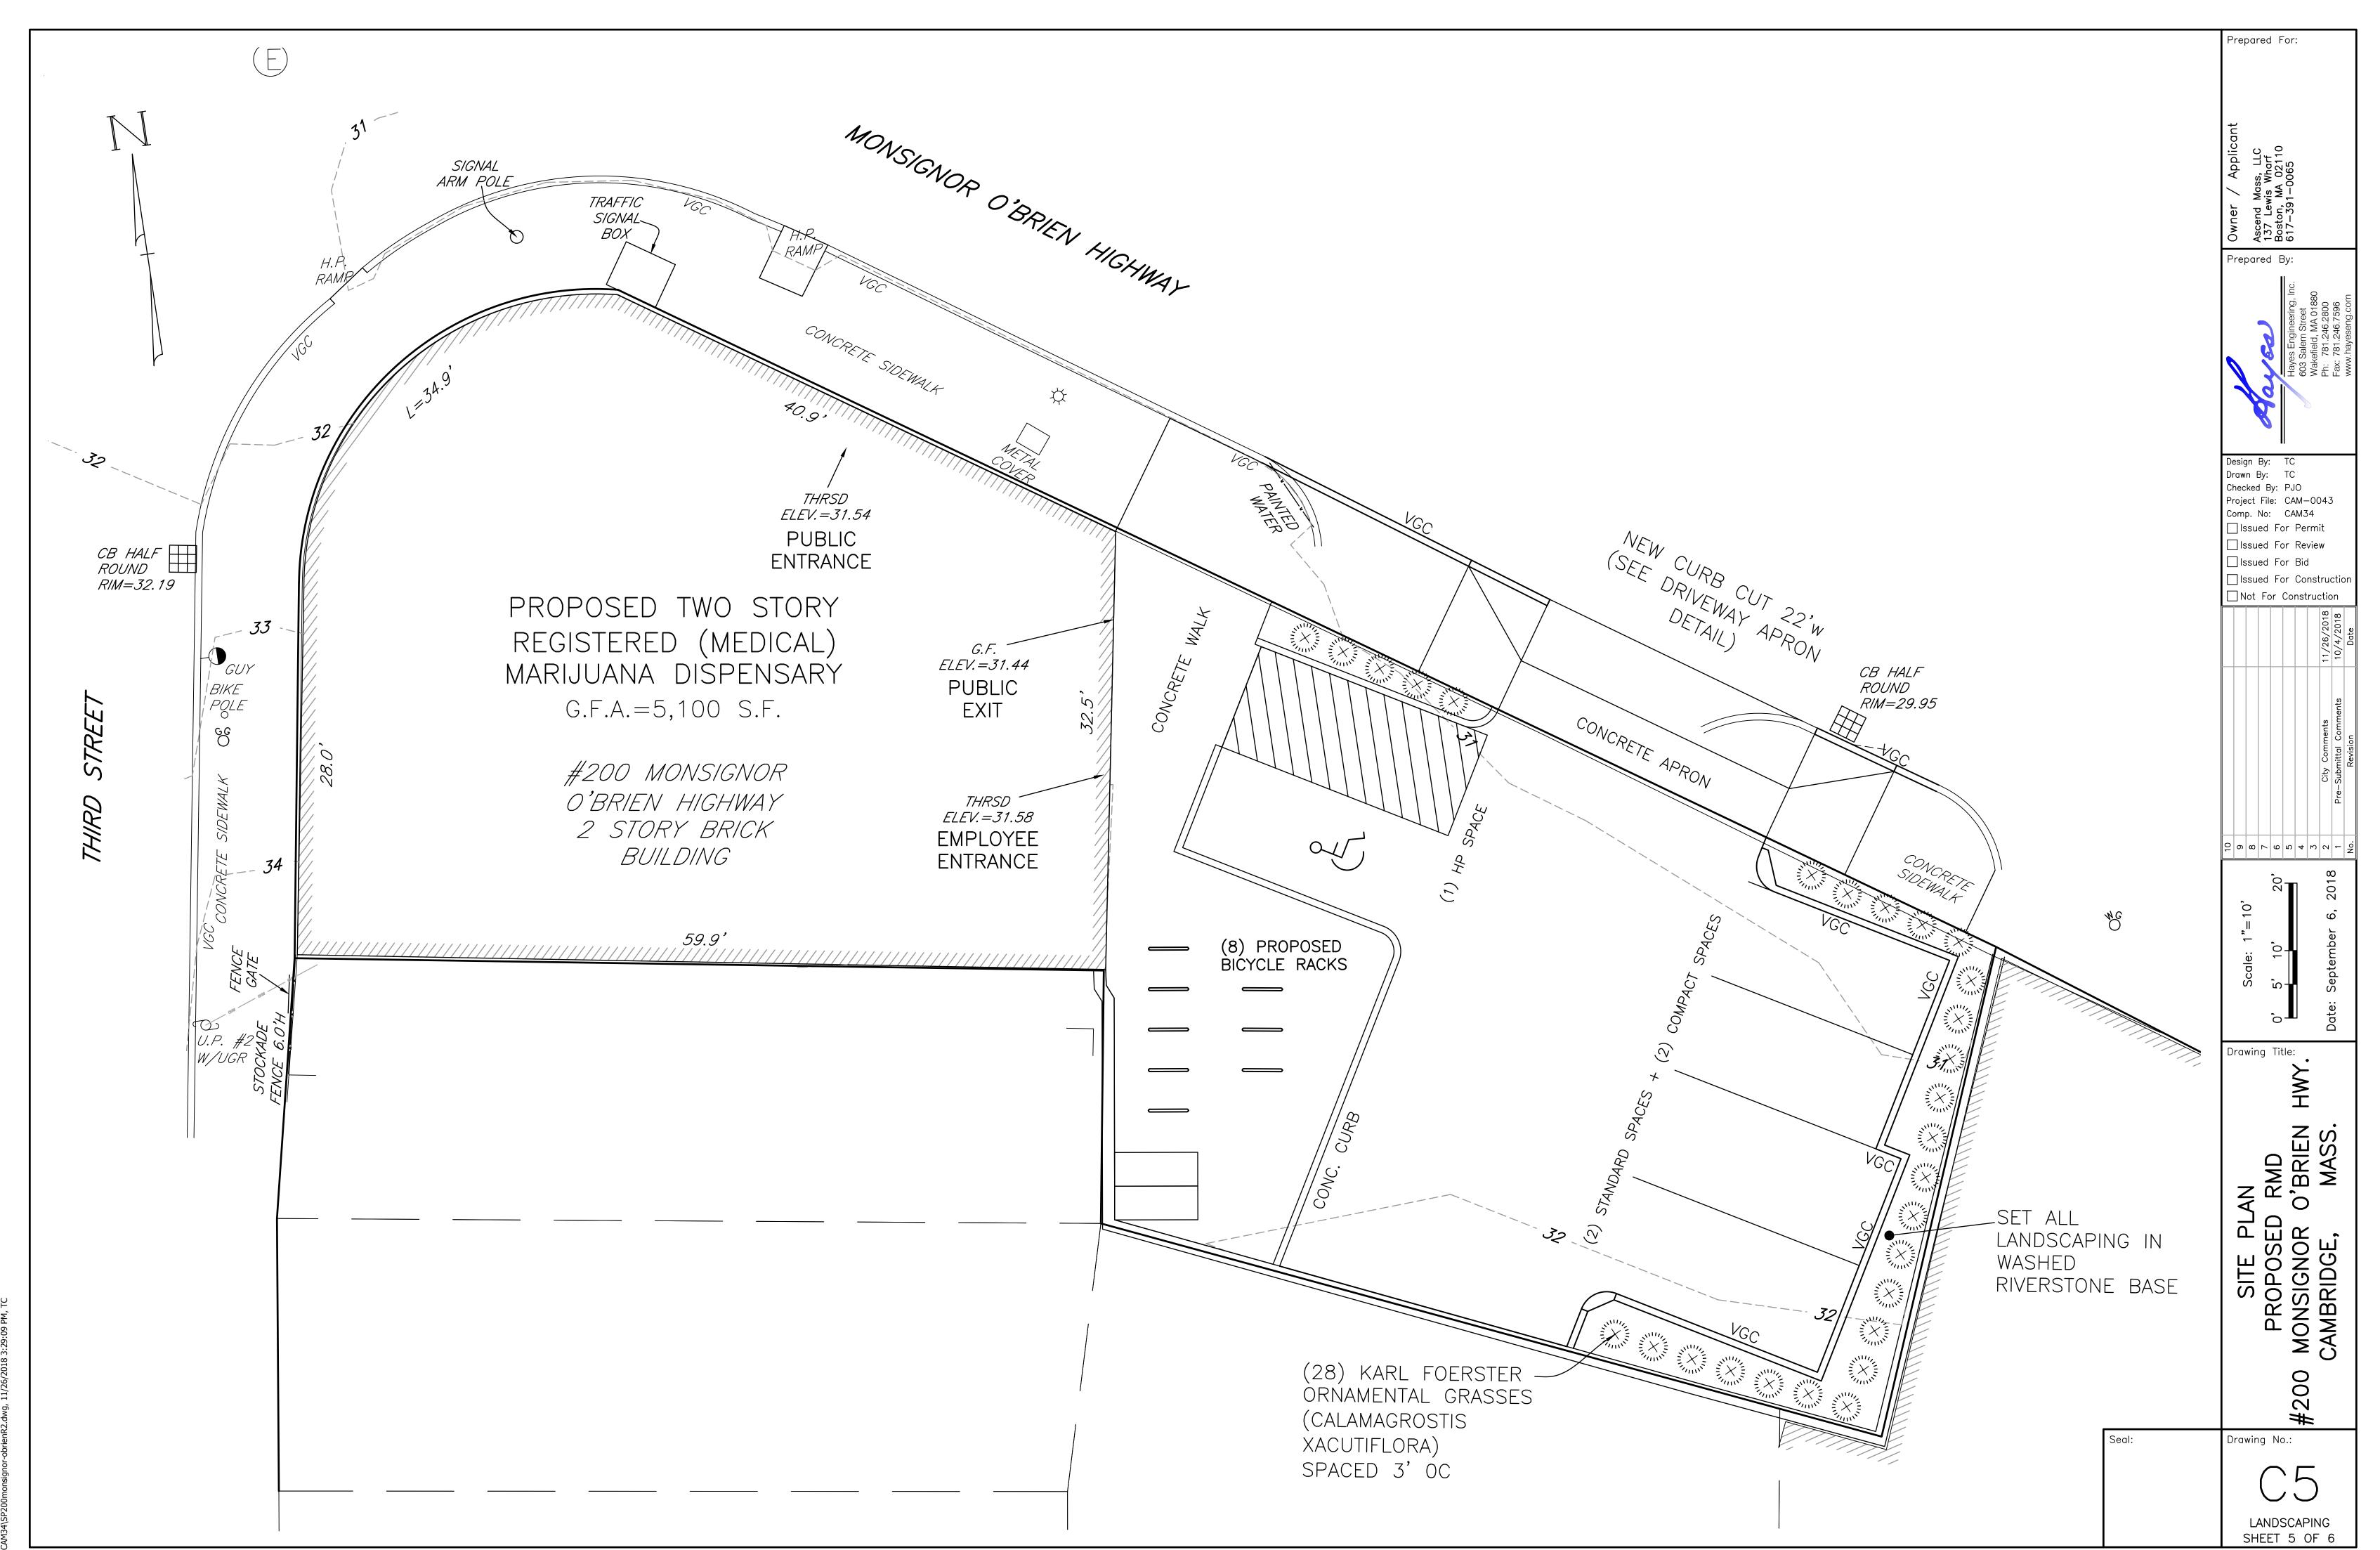

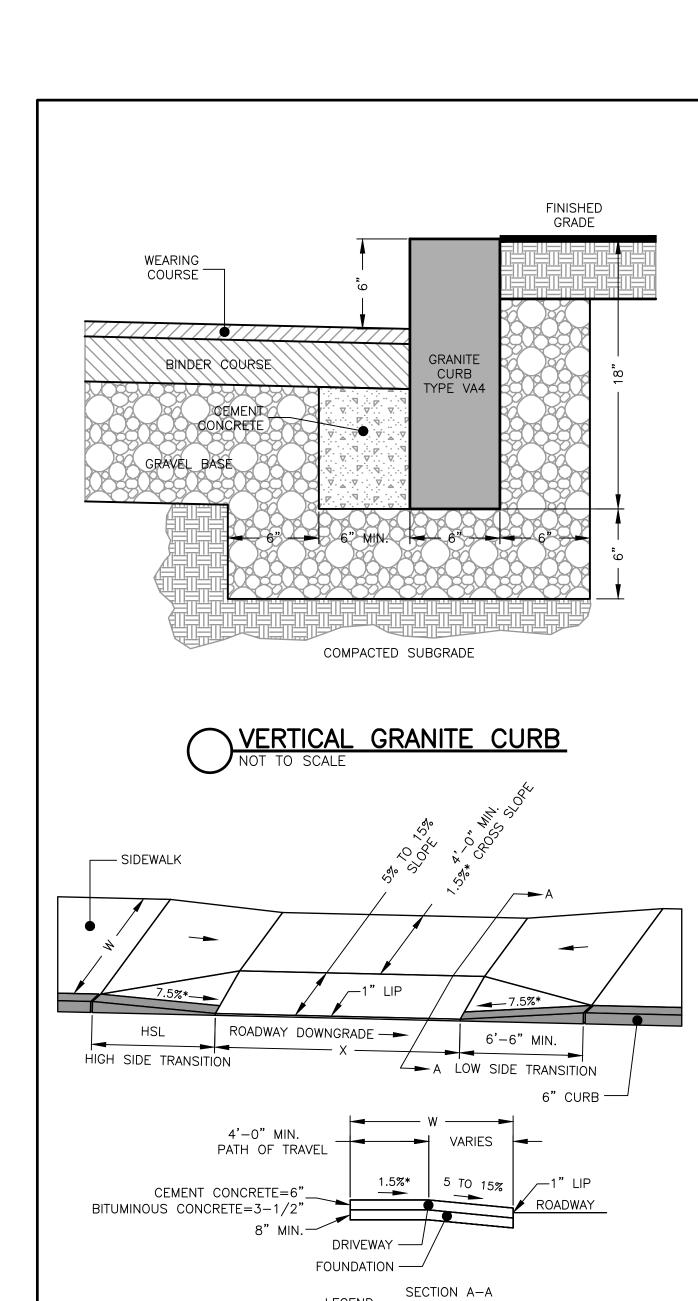

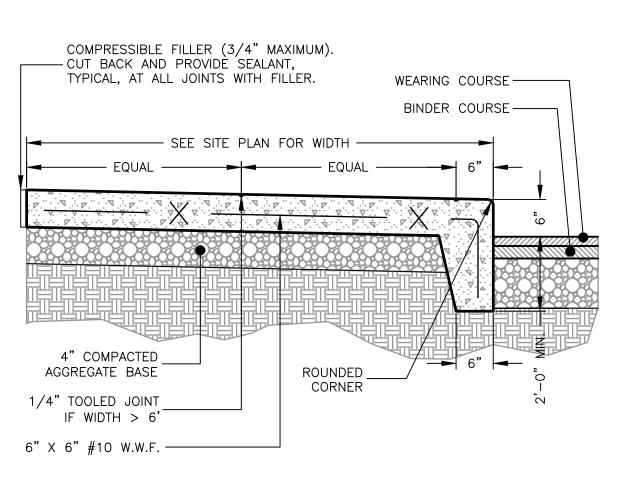

ROADWAY PROFILE GRADE %

> 0 TO 1

> 1 TO 2

> 2 TO 3

> 3 TO 4

> 4

BASED ON CURB REVEAL OF 6"

(HSL)

6'-6"

7'-8"

9'-0"

11'-0"

14'-0" 15'-0" MAX

PLAN FOR WIDTH -	2" BINDER COURSE —	2" BINDER COURSE
EQUAL 6"		
ROUNDED 6" 6" 0		6" MIN. CLEAN, GRADED
	8" MIN. CLEAN, GRADED AND COMPACTED STONE	AND COMPACTED STONE
	WELL DRAINED SUBGRADE (SUBGRADE COMPACTED TO 95% MODIFIED PROCTOR COMPACTION)	
NCRETE SIDEWALK		SECTION
JILDING PERIMETER)	NOT TO SCALE	

1-1/2" WEARING COURSE _


OVER TACK COAT

NOTE: THIS PAVEMENT SECTION DETAIL REFLECTS MINIMUM REQUIREMENTS. ENGINEER TO DETERMINE DESIGN BASED ON GEOTECHNICAL DATA.

TRUCK TRAFFIC CAR TRAFFIC

1-1/2" WEARING COURSE

OVEŘ TACK COAT

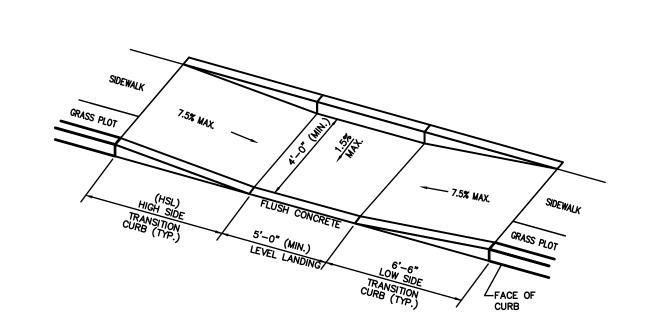


WHEELCHAIR RAMP
NOT TO SCALE

1. WHEELCHAIR RAMP SHALL COMPLY WITH ALL STATE AND FEDERAL RULES AND REGULATIONS. 2. TOLERANCE FOR WHEELCHAIR RAMP CONSTRUCTION ±0.5%

BIKE RACK (TYP.)
NOT TO SCALE

1. BIKE RACKS TO COMPLY WITH ALL CITY OF CAMBRIDGE TRAFFIC, PARKING, TRANSPORTATION, AND COMMUNITY DEVELOPMENT DEPARTMENTS REGULATIONS, AND ZONING REQUIREMENTS

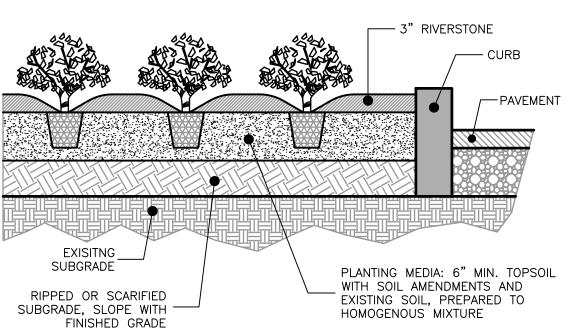

GROUND COVER PLANTING
NOT TO SCALE

Prepared For:
Owner / Applicant Ascend Mass, LLC 137 Lewis Wharf Boston, MA 02110 617-391-0065
Hayes Engineering, Inc. 603 Salem Street Wakefield, MA 01880 Ph: 781.246.2800 Fax: 781.246.7596 www.hayeseng.com
Design By: TC Drawn By: TC Checked By: PJO Project File: CAM-0043 Comp. No: CAM34 Issued For Permit Issued For Review Issued For Bid Issued For Construction Not For Construction
11/26/2018 10/4/2018 Date
City Comments Pre—Submittal Comments Revision
Scale: 1"=10' 8 8 7 7 7 6 6 6 9 5 10' 20' 6 6 9 8 9 9 9 9 9 9 9 9 9 9 9 9 9 9 9 9
SITE PLAN PROPOSED RMD #200 MONSIGNOR O'BRIEN HWY. CAMBRIDGE, MASS.
Drawing No.:

DETAILS

SHEET 6 OF 6

2. TO BE CONSTRUCTED OUT OF STAINLESS OR GALVANIZED STEEL


HSL=HIGH SIDE TRANSITION LENGTH

*=TOLERANCE FOR CONSTRUCTION ±0.5%

NOTE: DETAIL TAKEN FROM MASS HIGHWAY CONSTRUCTION STANDARDS.

W=SIDEWALK WIDTH

SIDEWALK THROUGH DRIVEWAY

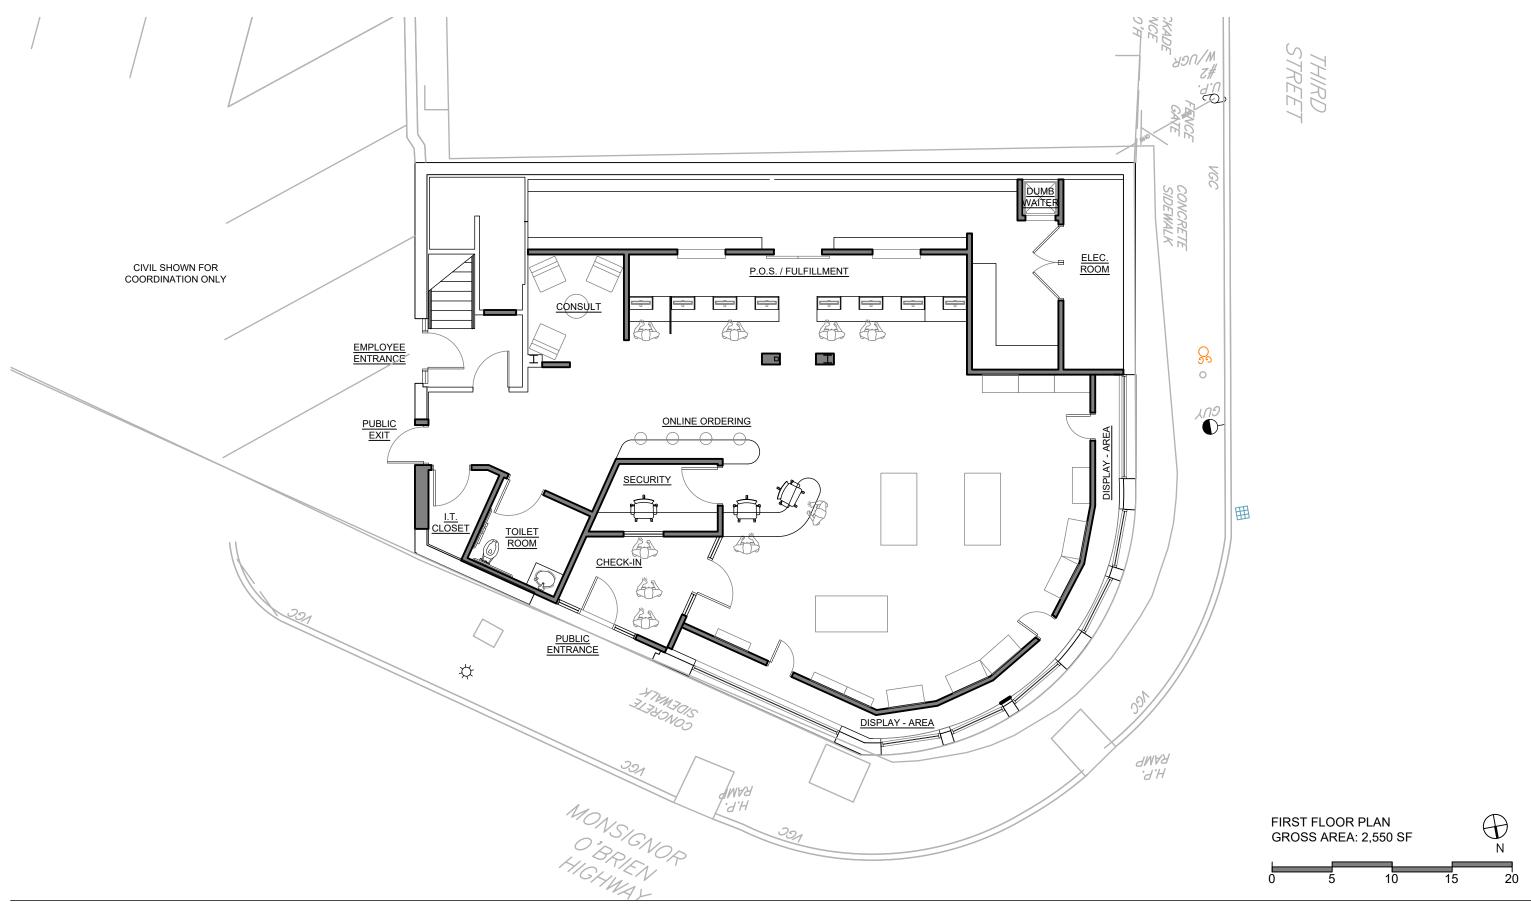


ASCEND DISPENSARY


Exhibit D






VIEW FROM ACROSS MONSIGNOR O'BRIEN HIGHWAY. A CORNER OF THE EXISTING ROOFTOP UNIT IS JUST VISIBLE ABOVE THE EDGE OF THE BUILDING.

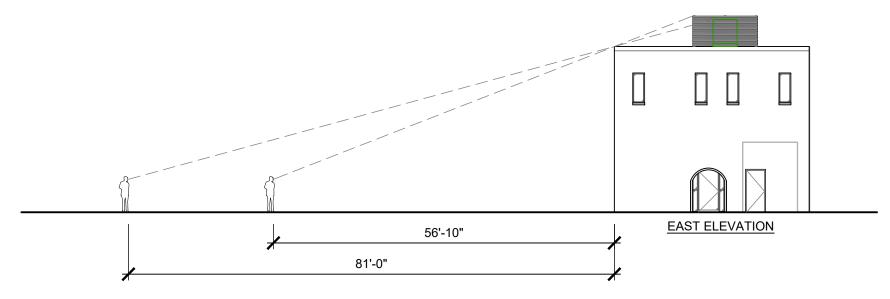

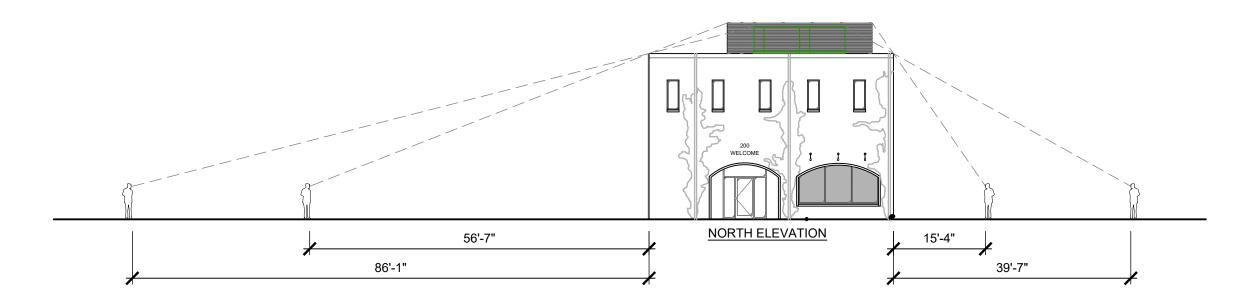

BKA # 218199

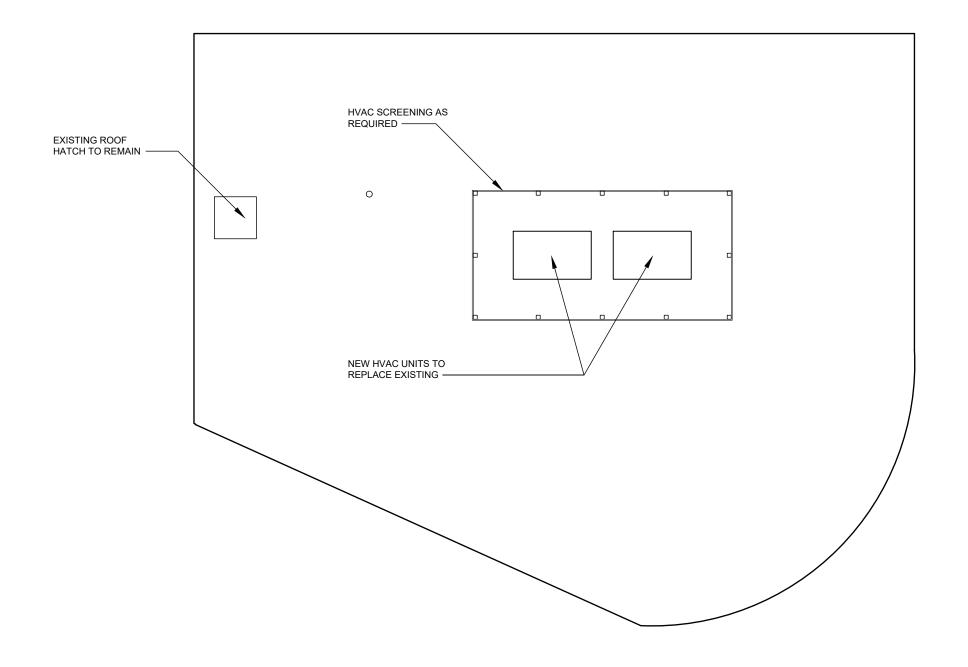



Prepared For: Exhibit G Prepared By: Design By: TC
Drawn By: TC
Checked By: PJO
Project File: CAM-0043 Comp. No: CAM34 ☐ Issued For Permit ☐ Issued For Review ☐ Issued For Bid 200 Monsignor O'Brien Highway ☐ Issued For Construction ☐ Not For Construction + 26 + 2.1 0 0 8 7 9 5 4 6 7 7 + 0.1 Drawing Title: O'BRIEN MASS. SITE PLAN
PROPOSED RN
MONSIGNOR O'B
CAMBRIDGE, M LSI INDUSTRIES, INC WCYL3-D-M-11-LED-30
ISM test report no. WCED3-15W-830-M
lamp(s): XXX
candela file 'WCYL3-D-M-11-LED-30.IES'
1 lamp(s) per luminaire, photometry is absolute
Light Loss Factor = 0.850, watts per luminaire = 15
Outreach (from mounting axis to photometric center)= 5 in
mounting height= 9 ft
number locations= 6, number luminaires= 6
kw all locations= 0.1 Target Point Set
4290 points at z=0, sp 3ft by 3ft
HORIZONTAL FOOTCANDLES
Average 0.2
Maximum 32.1
Minimum 0.0
Avg:Min N/A
Max:Min N/A
Coef Var 10.88
UnifGrad N/A #200 Drawing No.: LIGHTING SHEET 4 OF 4