

CITY OF CAMBRIDGE

BOARD OF ZONING APPEAL

831 Massachusetts Avenue, Cambridge MA 02139

2021 APR 15 PM 3: 52

617-349-6100

OFFICE OF THE CITY CLERK CAMBRIDGE, MASSACHUSETTS

BZA Application Form

| DTA | AT | | L | | |
|-----|----|----|------|------|----|
| DLA | IN | um | Der: | 1104 | 17 |

| General | Information |
|----------|----------------|
| Ochiciai | IIIIOIIIIauoii |

| The undersigned h | nereby petitions t | he Board of Zoning A | ppeal for the following: |
|---|---|--|---|
| Special Permit: | _X | Variance: | Appeal: |
| | | | |
| PETITIONER: 15 | 2 Charles St, LLC | | |
| PETITIONER'S A | DDRESS: 10 Ove | erlook Ridge Drive, M | alden, MA 02148 |
| LOCATION OF PR | ROPERTY: <u>152 C</u> | Charles St , Cambrid | ge, MA |
| TYPE OF OCCUP | ANCY: Two Fam | <u>ily</u> | ZONING DISTRICT: Residence C-1 Zone |
| REASON FOR PE | ETITION: | | |
| /Additions/ | | | |
| DESCRIPTION O | F PETITIONER'S | PROPOSAL: | |
| | | | onforming two family residence, which per M.G.L. Chapter addition does not increase the nature of the existing non- |
| SECTIONS OF ZO | ONING ORDINAN | ICE CITED: | |
| Article: 5.000 Article: 5.000 Article: 5.000 Article: 8.000 Article: 8.000 Article: 10.000 | Section: 5.25.41 Section: 5.31 (Ta Section: 8.22.2(| ble of Dimensional R c) (Alterations to Non Excepted by MGL 40 | -Conforming Structures) |
| | | Original Signature(s): | (Petitioner (s) / Owner) Matthew Moure (Print Name) |

Address: 152 Charles Street

1/5

Date: 4.12.21

Tel. No.

E-Mail Address: matt@kinvarracapital.com

BZA APPLICATION FORM - OWNERSHIP INFORMATION

To be completed by OWNER, signed before a notary and returned to The Secretary of the Board of Zoning Appeals.

| I/We 152 Charles St LLC |
|--|
| Address: 10 Overbok Rldge Dr #330 Malden MA 02141 |
| State that I/We own the property located at 152 Charles street. |
| which is the subject of this zoning application. |
| The record title of this property is in the name of 152 (harles St LLC |
| *Pursuant to a deed of duly recorded in the date 11.20.2020 Middlesex South County Registry of Deeds at Book 76230, Page 423; or Middlesex Registry District of Land Court, Certificate No. 00219742 |
| Book (2287 Page |
| SIGNATURE BY LAND OWNER OR |
| *Written evidence of Agent's standing to represent petitioner may be requested. |
| Commonwealth of Massachusetts, County of |
| The above-name matthew more personally appeared before me, |
| this 4th of March, 2021, and made oath that the above statement is true. |
| My commission expires 1/27/23 (Notary Seal) |
| If ownership is not shown in recorded deed, e.g., if by court order, recent deed, or inheritance, please include documentation. |

(ATTACHMENT B - PAGE 3)

BZA Application Form

SUPPORTING STATEMENT FOR A SPECIAL PERMIT

Please describe in complete detail how you meet each of the following criteria referring to the property and proposed changes or uses which are requested in your application. Attach sheets with additional information for special permits which have additional criteria, e.g.; fast food permits, comprehensive permits, etc., which must be met.

Granting the Special Permit requested for <u>152 Charles St</u>, <u>Cambridge</u>, <u>MA</u> (location) would not be a detriment to the public interest because:

A) Requirements of the Ordinance can or will be met for the following reasons:

MGL Chapter 40a, Section 6 grants unique protections to existing non-conforming one and two family structures, provided that any alteration does not increase the non-conforming nature of the existing structure. For structural changes to a non-conforming one or two family structure, Section 6 requires that when the proposed changes do not increase the non-conforming nature of the structure, the applicable Special Permit Granting Authority is to determine only that the proposed alteration not be "substantially more detrimental" than the existing nonconforming structure or use to the neighborhood, nothing more. While Article 8 Section 8.22.2.c of the Cambridge Zoning Ordinance states that an increase to the area or volume of an existing non-conforming structure in the Residence District by more than 25% is not allowed, and so would require a variance under Article 8 Section 8.22.3, the Zoning Code cannot be more restrictive than the specific protections provided to two family structures by Section 6 of MGL Chapter 40a. The proposed addition to 152 Charles Street does not increase the non-conforming nature of the property, and is not more detrimental to the neighborhood, and therefore only requires a finding that the proposed addition is not substantially more detrimental to the neighborhood than the existing structure.

Traffic generated or patterns of access or egress would not cause congestion hazard, or substantial change in established neighborhood character for the following reasons:

The proposed development will not alter access or egress because the existing curb cut will not change. No increase in the congestion hazard will be created by the addition because the number of dwelling units remains the same.

The continued operation of or the development of adjacent uses as permitted in the Zoning Ordinance would not be adversely affected by the nature of the proposed use for the following reasons:

The driveway curb cut will remain, and existing traffic patterns will also remain the same. The proposed parking spaces, reduced from five to two, will remain in the same general location as the existing parking spaces. The proposed addition will conform to the dimensional requirements of the district, and the amount of open space on the Property will be increased.

Nuisance or hazard would not be created to the detriment of the health, safety, and/or welfare of the occupant of the proposed use or the citizens of the City for the following reasons:

Open space will be increased from its current nonconforming condition to be conforming to the district requirements, and the total permeable area of the site will be increased, to the benefit of the neighborhood residents. Traffic patterns and driveway ingress and egress will remain consistent for adjacent residents. There will be no hazard or nuisance created by the requested relief. An

existing home that fits in with the history and character of the neighborhood will be restored, preserved, and improved, to the benefit of the neighborhood and the larger district.

For other reasons, the proposed use would not impair the integrity of the district or adjoining district or otherwise derogate from the intent or purpose of this ordinance for the following reasons:

The proposed addition, driveway and parking design are consistent with other uses in the neighborhood and the larger district. The proposed use is consistent with the residential uses in the neighborhood, and the proposed addition will conform to the dimensional requirements of the district.

*If you have any questions as to whether you can establish all of the applicable legal requirements, you should consult with an attorney.

BZA Application Form

DIMENSIONAL INFORMATION

Applicant: 152 Charles St, LLC Present Use/Occupancy: Two Family

Location: 10 Overlook Ridge Drive **Zone:** Residence C-1 Zone

Phone: Requested Use/Occupancy: Two Family

| | | Existing Conditions | Requested Conditions | Ordinance Requirements | |
|---|---------------|------------------------|---------------------------------|---------------------------|--------|
| TOTAL GROSS FLOOR AREA: | | 3,000 | 2,700 | N/A | (max.) |
| LOT AREA: RATIO OF GROSS | | 3,600 | No Change | 5,000 | (min.) |
| FLOOR AREA TO LOT AREA: 2 LOT AREA OF | | 0.83 | 0.75 | 0.75 | |
| EACH DWELLING UNIT | | 1,800 | 1,800 | 1,500 | |
| SIZE OF LOT: | WIDTH | 36 | No Change | 50 | |
| | DEPTH | 100 | No Change | N/A | |
| SETBACKS IN FEET | FRONT | 1.2 | No Change | 10 | |
| | REAR | 0 | 28.9 | 20 | |
| | LEFT SIDE | 0 | 0 | 7.5 | |
| | RIGHT SIDE | 1 | 10 | 7.5 | |
| SIZE OF BUILDING: | HEIGHT | 28.8 | 33.05 32.38 | 35 | |
| | WIDTH | 86.33 90.33 | 69.83 65.5 | N/A | |
| RATIO OF USABLE OPEN SPACE TO LOT AREA: | | 0% | 30.13% 30.04% | 30% | |
| NO. OF DWELLING UNITS: | | 2 | 2 | 2 | |
| NO. OF PARKING SPACES: | | 5 | 2 | 2 | |
| NO. OF LOADING AREAS: | | 0 | 0 | N/A | |
| DISTANCE TO NEAREST BLDG. ON SAME LOT | | 7.96 | N/A | 10 | |

Describe where applicable, other occupancies on the same lot, the size of adjacent buildings on same lot, and type of construction proposed, e.g; wood frame, concrete, brick, steel, etc.


- 1. SEE CAMBRIDGE ZONING ORDINANCE ARTICLE 5.000, SECTION 5.30 (DISTRICT OF DIMENSIONAL REGULATIONS).
- 2. TOTAL GROSS FLOOR AREA (INCLUDING BASEMENT 7'-0" IN HEIGHT AND ATTIC AREAS GREATER THAN 5') DIVIDED BY LOT AREA.
- 3. OPEN SPACE SHALL NOT INCLUDE PARKING AREAS, WALKWAYS OR DRIVEWAYS AND SHALL HAVE A MINIMUM DIMENSION OF 15'.

152 CHARLES ST


152 CHARLES ST, CAMBRIDGE MA 02141



SYMBOL LEGEND

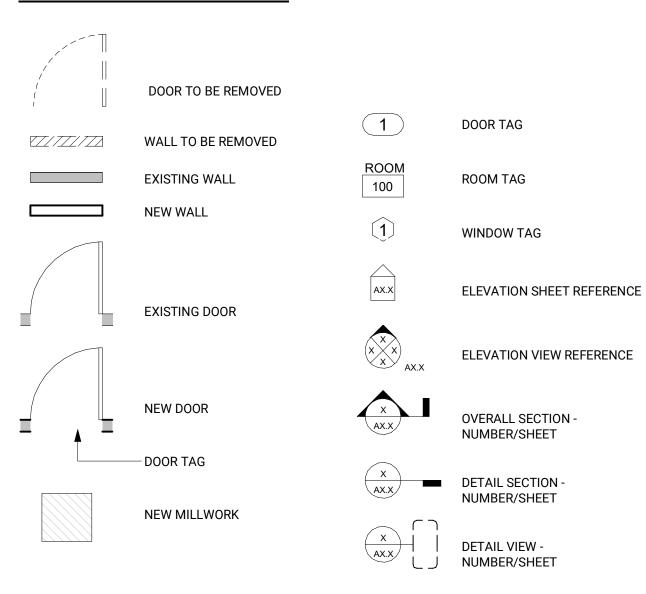

LOCUS MAP

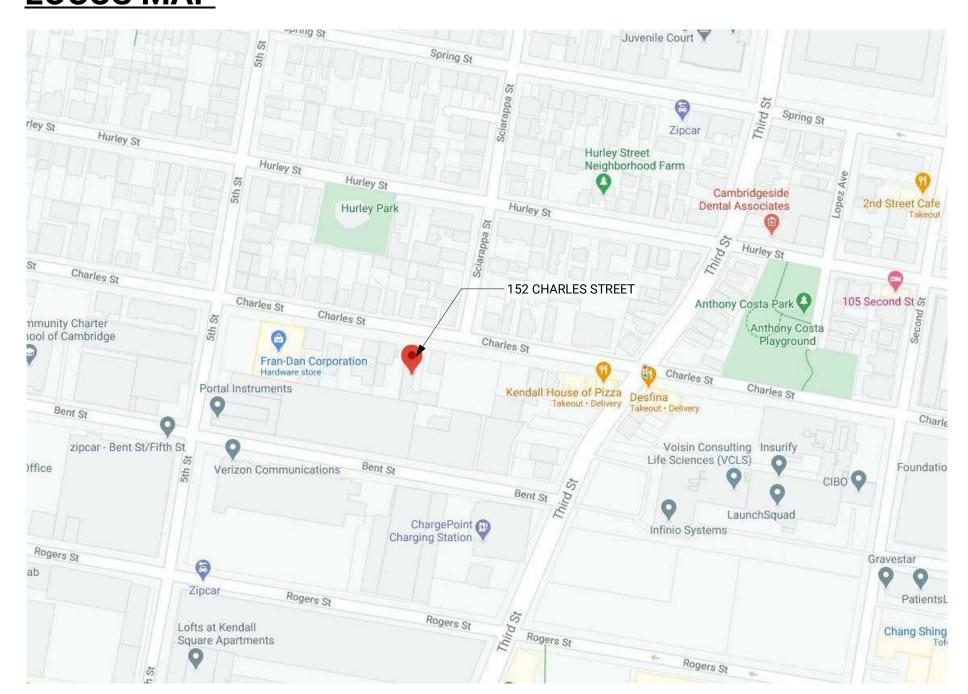





| Sheet List | | | | | | |
|--------------|------------------------------|--|--|--|--|--|
| Sheet Number | Sheet Number Sheet Name | | | | | |
| | | | | | | |
| A0.0 | COVER | | | | | |
| A0.1 | ZONING | | | | | |
| A1.1 | EXISTING AREA PLANS | | | | | |
| A1.2 | PROPOSED AREA PLANS | | | | | |
| A1.3 | BASEMENT & FIRST FLOOR PLANS | | | | | |
| A1.4 | SECOND FLOOR & ROOF PLAN | | | | | |
| A2.0 | ELEVATIONS | | | | | |
| A2.1 | ELEVATIONS | | | | | |
| A3.0 | SECTIONS | | | | | |
| A3.1 | WALL SECTION & DETAILS | | | | | |
| EX00 | Existing 3D View | | | | | |
| EX01 | Existing Floor Plans | | | | | |
| EX02 | Existing Exterior Elevations | | | | | |

GENERAL NOTES

- 1. THE GENERAL CONTRACTOR SHALL NOTIFY THE ARCHITECTS OF ALL DISCREPANCIES BETWEEN CONSTRUCTION DOCUMENTS
- THE GENERAL CONTRACTOR SHALL COMPLY WITH ALL FEDERAL, STATE, AND LOCAL REGULATIONS THAT MAY APPLY TO THE CONSTRUCTION OF THE PROJECT.
- 3. ALL WORK OF THIS PROJECT SHALL COMPLY WITH ACCEPTED BUILDING PRACTICES AND ALL CODES HAVING JURISDICTION OVER THIS PROJECT.
- 4. ALL DOCUMENTS ARCHITECTURAL AND ENGINEERING ARE BINDING AND SHOULD BE ISSUED TO ALL SUBS ANY DISCREPANCY SHOULD BE BROUGHT TO THE ARCHITECTS DIRECTION BEFORE THE BID IS COMPLETE AND/OR BEFORE THE START OF CONSTRUCTION.
- THE GENERAL CONTRACTOR SHALL LEAVE THE PROJECT SITE AND ALL SURROUNDING AREAS IN FINAL CLEAR CONDITION INCLUDING THE REMOVAL OF ALL DEBRIS RESULTING FROM CONSTRUCTION.
- THE CONTRACTOR SHALL AT ALL TIMES DURING THE PROGRESS OF THE WORK REMOVE ALL CONSTRUCTION DEBRIS AND MAINTAIN A DUST FREE ENVIRONMENT FOR ALL ADJACENT AREAS.
- 7. THE CONTRACTOR SHALL COORDINATE THE WORK OF ALL TRADES AND VERIFY THAT ALL CUTTING AND PATCHING REQUIRED FOR THE INSTALLATION OF ALL MATERIALS BY ALL TRADES IS PROPERLY EXECUTED.
- THE CONTRACTOR SHALL UTILIZE THE AREAS WITHIN THE SCOPE OF WORK FOR STORAGE OF MATERIALS AND TOOLS.
 ALL WRITTEN DIMENSIONS SHALL HAVE PRECEDENCE OVER ALL OTHERS, DO NOT SCALE DRAWINGS. IF THERE IS A QUESTION OR CONFLICT IN DIMENSIONS, NOTIFY THE ARCHITECT FOR CLARIFICATION.
- 10. VERIFY FIELD CONDITIONS PRIOR TO COMMENCEMENT OF EACH PORTION OF THE WORK. THE CONTRACT DRAWINGS ARE COMPLIMENTARY AND WHAT IS REQUIRED BY ONE SHALL BE BINDING AS IF REQUIRED BY ALL. THE CONTRACTOR SHALL COORDINATE ALL PORTIONS OF THE WORK.

 11. ALL GYPSUM WALL BOARD CONSTRUCTION SHALL CONFORM TO RECOMMENDATIONS, PRACTICES, STANDARDS, AND
- INSTRUCTIONS PUBLISHED BY U.S. GYPSUM COMPANY IN THE GYPSUM CONSTRUCTION HANDBOOK.
- 12. ALL FINISHED WORK SHALL BE FREE OF DEFECTS. THE OWNER RESERVES THE RIGHT TO REJECT ANY MATERIALS AND WORKMANSHIP WHICH ARE NOT CONSIDERED TO BE AT THE HIGHEST STANDARDS OF THE VARIOUS TRADES INVOLVED.
- 13. NO CHANGES OR SUBSTITUTIONS ARE ALLOWED UNLESS APPROVED BY THE ARCHITECT
 14. ANY MODIFICATION OF THESE CONSTRUCTION DOCUMENTS MUST BE APPROVED BY BALANCE ARCHITECTS IN WRITING
- 15. IF VARIANCE FROM THE EXISTING DRAWING OCCURS, NOTIFY THE ARCHITECT PRIOR TO COMMENCING ANY RELATED WORK.
 16. WHERE CONCEALED WD BLOCKING OR FRAME IS REQ. CONTRACTOR SHALL USE ONLY FIRE- RETARDANT TREATED WOOD.
 17. WHERE FIRE-RATED AND FULL HEIGHT PARTITIONS ARE PENETRATED BY STRUCTURAL MEMBERS, DUCTWORK, PIPING, AND CONDUIT, THE GYPSUM BOARD SHALL BE SCRIBED TO FIT TIGHT AGAINST THE PENETRATING ITEM AND CAULKED WITH THE
- THE CONDITION. COORDINATE WITH MECHANICAL AND ELECTRICAL WORK AND DETAILS.

 18. THE WORD "FEC" INDICATES FIRE EXTINGUISHERS AND CABINETS, WHERE AND AS INDICATED AND AS REQ'D BY THE GOVERNING LAWS AND CODES. FIRE EXTINGUISHERS AND CABINETS SHALL CONFORM TO CODE REQUIREMENTS. EXTINGUISHERS FOR GENERAL USE SHALL BE 10 LB ABC CHEMICAL TYPE AND AT KITCHENS CARBON DIOXIDE TYPE, ALL UL RATED; CABINET FACES SHALL BE SATIN FINISHED STAINLESS STEEL, CABINETS SHALL BE FULLY RECESSED. HEIGHT LOCATION OF ALL FIRE EXTINGUISHER CABINETS MUST COMPLY WITH THE ADA REQUIREMENTS. VERIFY IF EXISTING EQUIPMENT IN FIELD

APPROPRIATE SEALANT, OR CONSTRUCTED OTHERWISE TO PROVIDE A U.L. APPROVED ASSEMBLY DETAIL APPROPRIATE TO

IS COMPLIANT. GC TO COORDINATE DEPTH OF WALL CAVITY REQUIRED FOR RECESSED UNITS.

19. LOCATE ALL DOOR FRAMES 4" OFF ADJACENT WALL U.O.N. IN ALL CASES, PROVIDE ADA CLEARANCES OF 18" ON PULL SIDE AND 12" ON PUSH SIDE OF DOORS. BRING ANY DISCREPANCIES TO ARCHITECTS ATTENTION PRIOR TO FRAMING OF DOOR.



BALANCE ARCHITECTS

617.991.0269 | www.balance-architects.com 197 8th Street, Suite 2000, Boston, MA 02129

ROJECT NAME:

152 CHARLES ST

LIENT:


PROJECT ADDRESS:

KINVARRA CAPITAL

152 CHARLES ST, CAMBRIDGE MA 02141

COPYRIGHT BALANCE ARCHITECTS © 2021
THIS DOCUMENT IS THE SOLE PROPERTY OF
BALANCE ARCHITECTS. USE OF THIS DOCUMENT
BY THE OWNER FOR THE COMPLETION OF THIS
OR OTHER PROJECTS WITHOUT EXPRESS
WINITED CONSENT IS STRICTLY EXPRESS

| No. | Description | Date | | |
|-----|-------------|------|--|--|
| | | | | |
| | | | | |
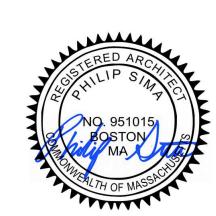


STAMP:

| 20.038 |
|--------------|
| 4/12/2021 |
| PS |
| PS |
| 1/4" = 1'-0' |
| |

COVER

A0.0

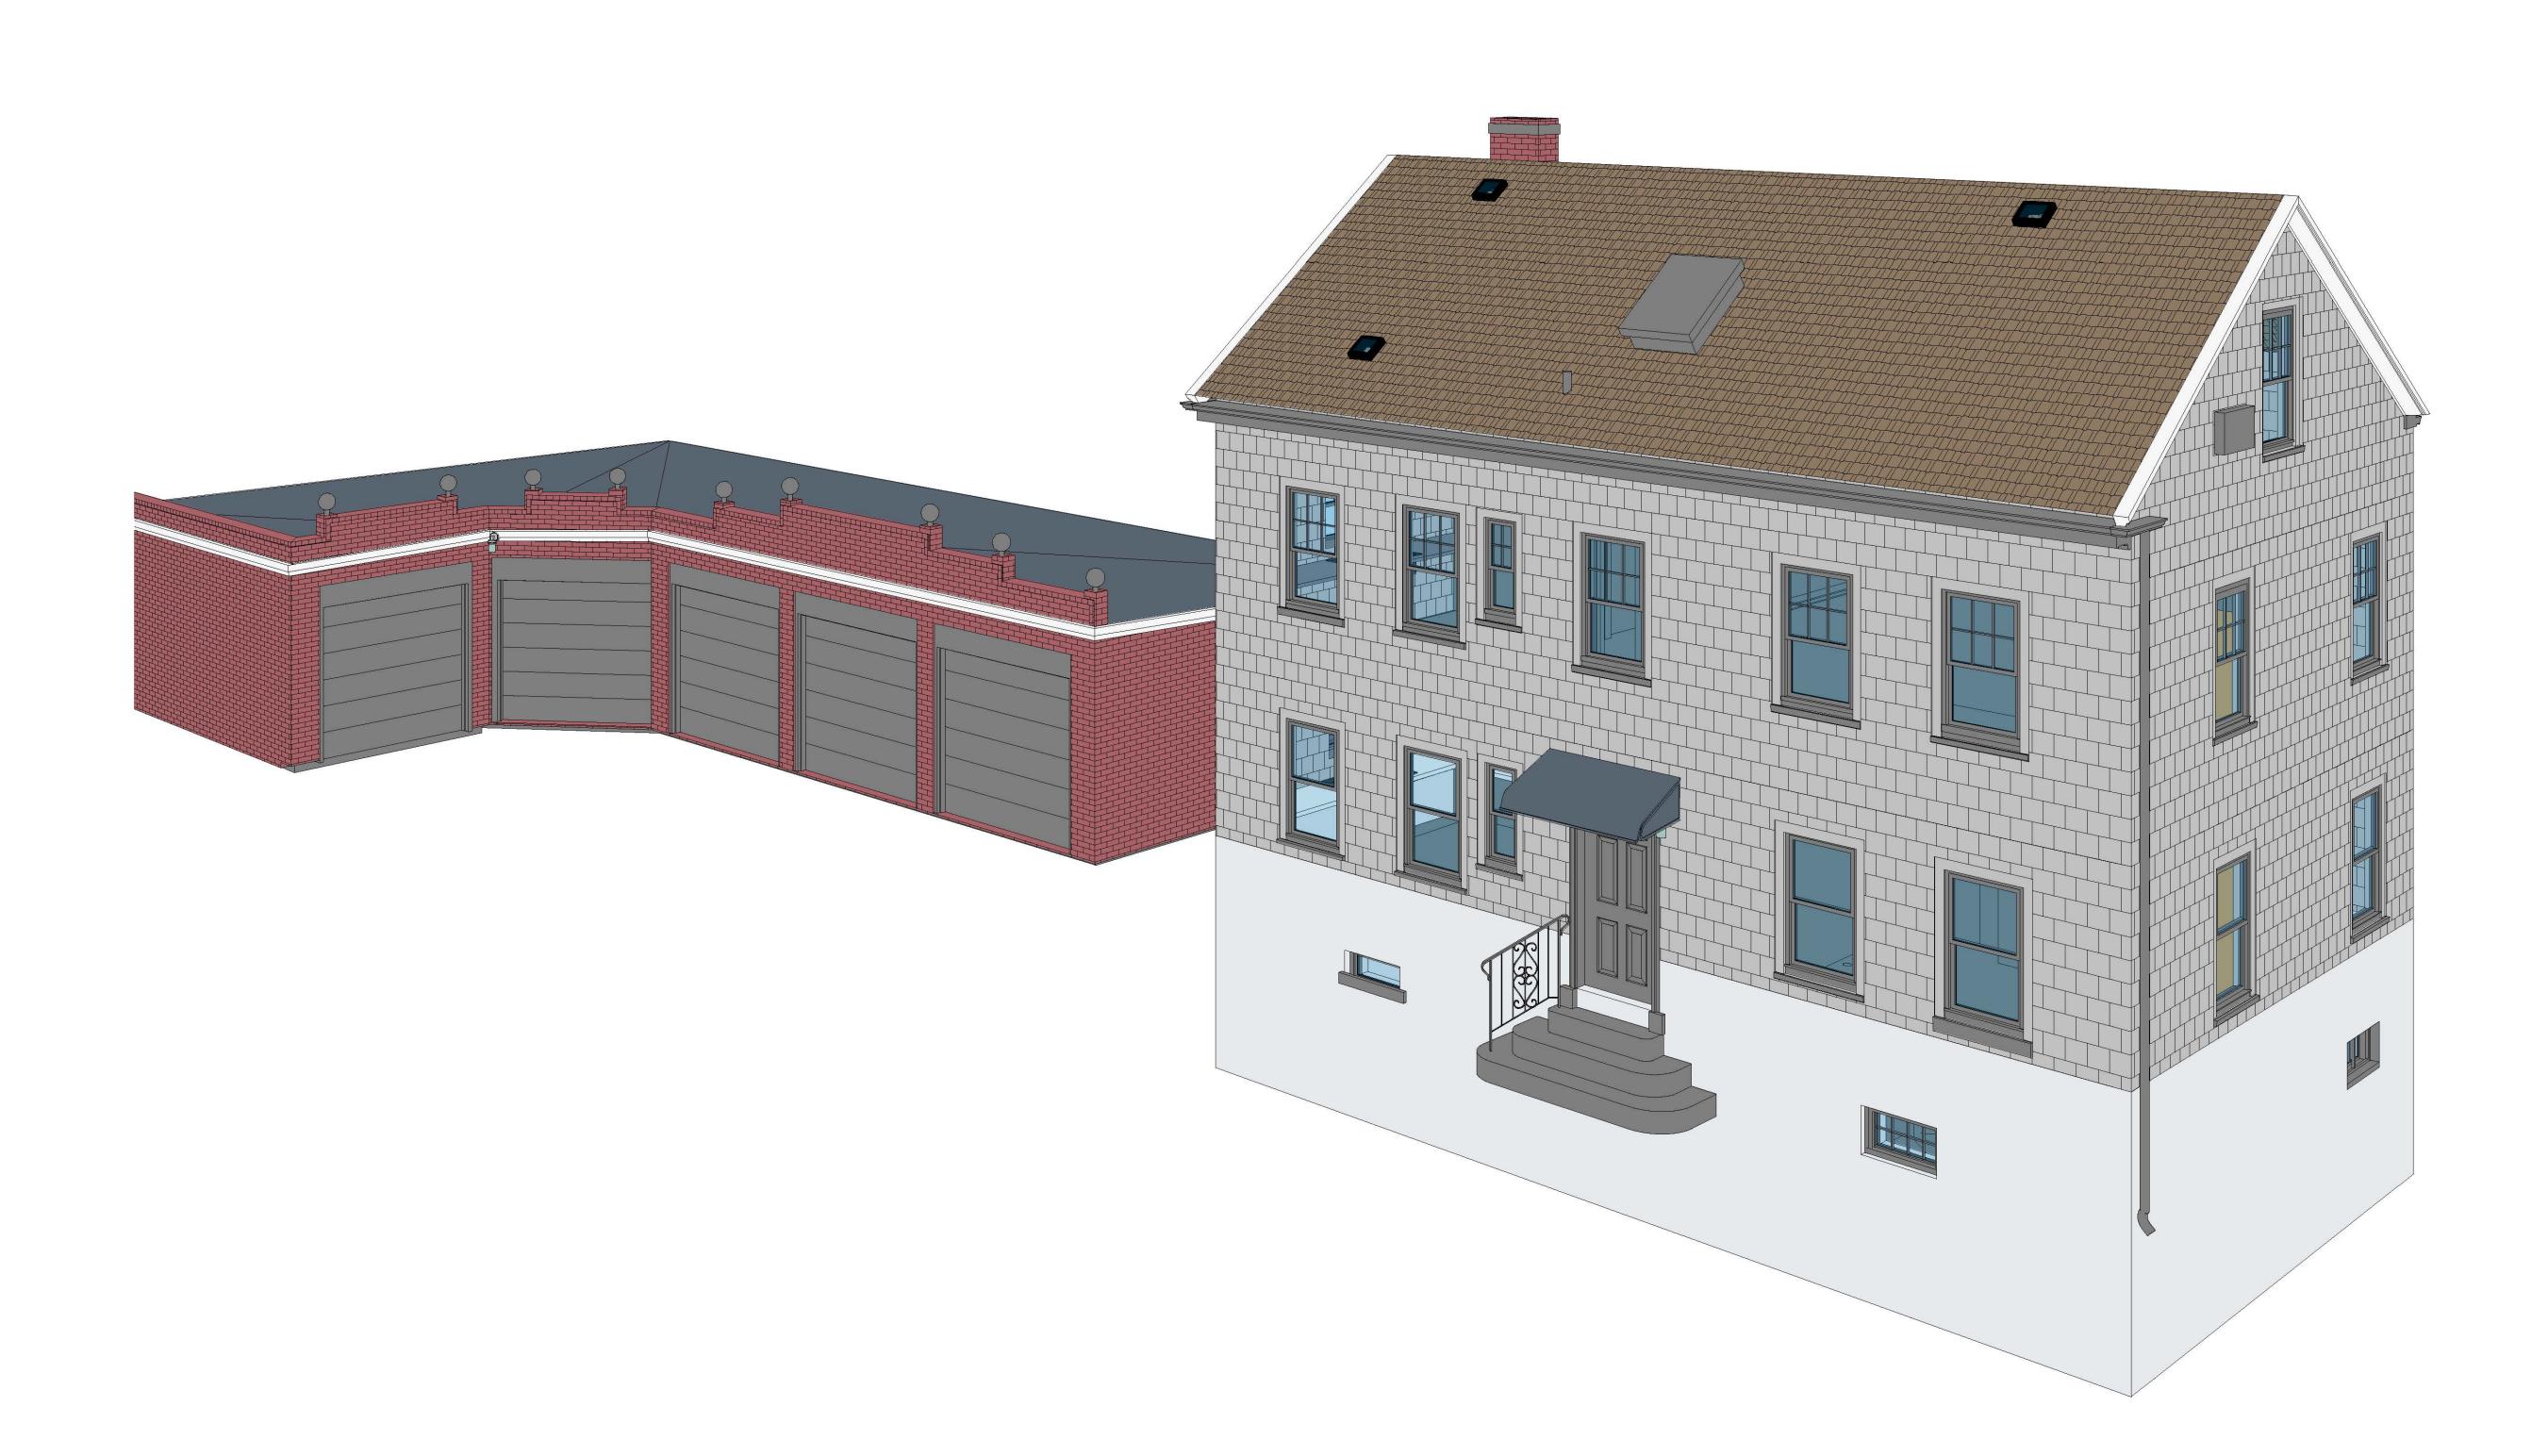



BALANCE ARCHITECTS

617.991.0269 | www.balance-architects.com 197 8th Street, Suite 2000, Boston, MA 02129

PROJECT NAME:

152 CHARLES STREET

CLIENT:

KINVARRA CAPITAL

PROJECT ADDRESS:

152 CHARLES ST, CAMBRIDGE, MA 02141

COPYRIGHT BALANCE ARCHITECTS © 2020 THIS DOCUMENT IS THE SOLE PROPERTY OF BALANCE ARCHITECTS. USE OF THIS DOCUMENT BY THE OWNER FOR THE COMPLETION OF THIS OR OTHER PROJECTS WITHOUT EXPRESS WRITTEN CONSENT IS STRICTLY FORBIDDEN.

| No. | Description | Date |
|-----|-------------|------|
| | | |
| | | |
STAMP:


| Project number | 20.038 |
|----------------|-----------|
| Date | 1/17/2021 |
| Drawn by | PS |
| Checked by | PS |
| Scale | |
| | |


Existing 3D View

EX00

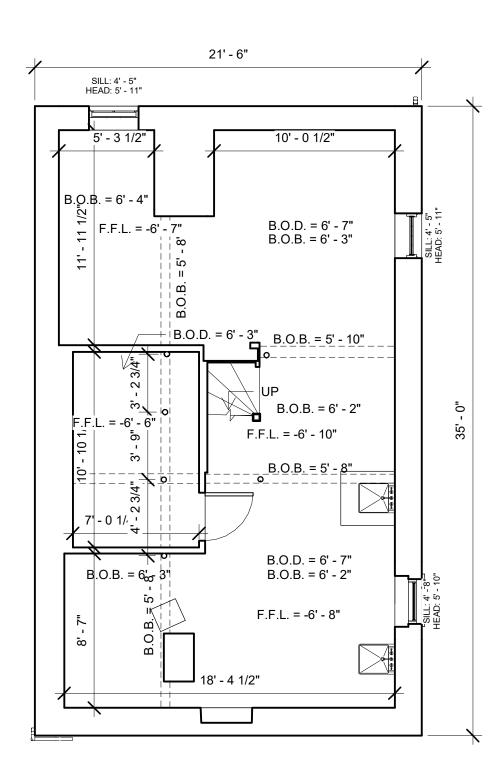

1 Basement 3/16" = 1'-0"

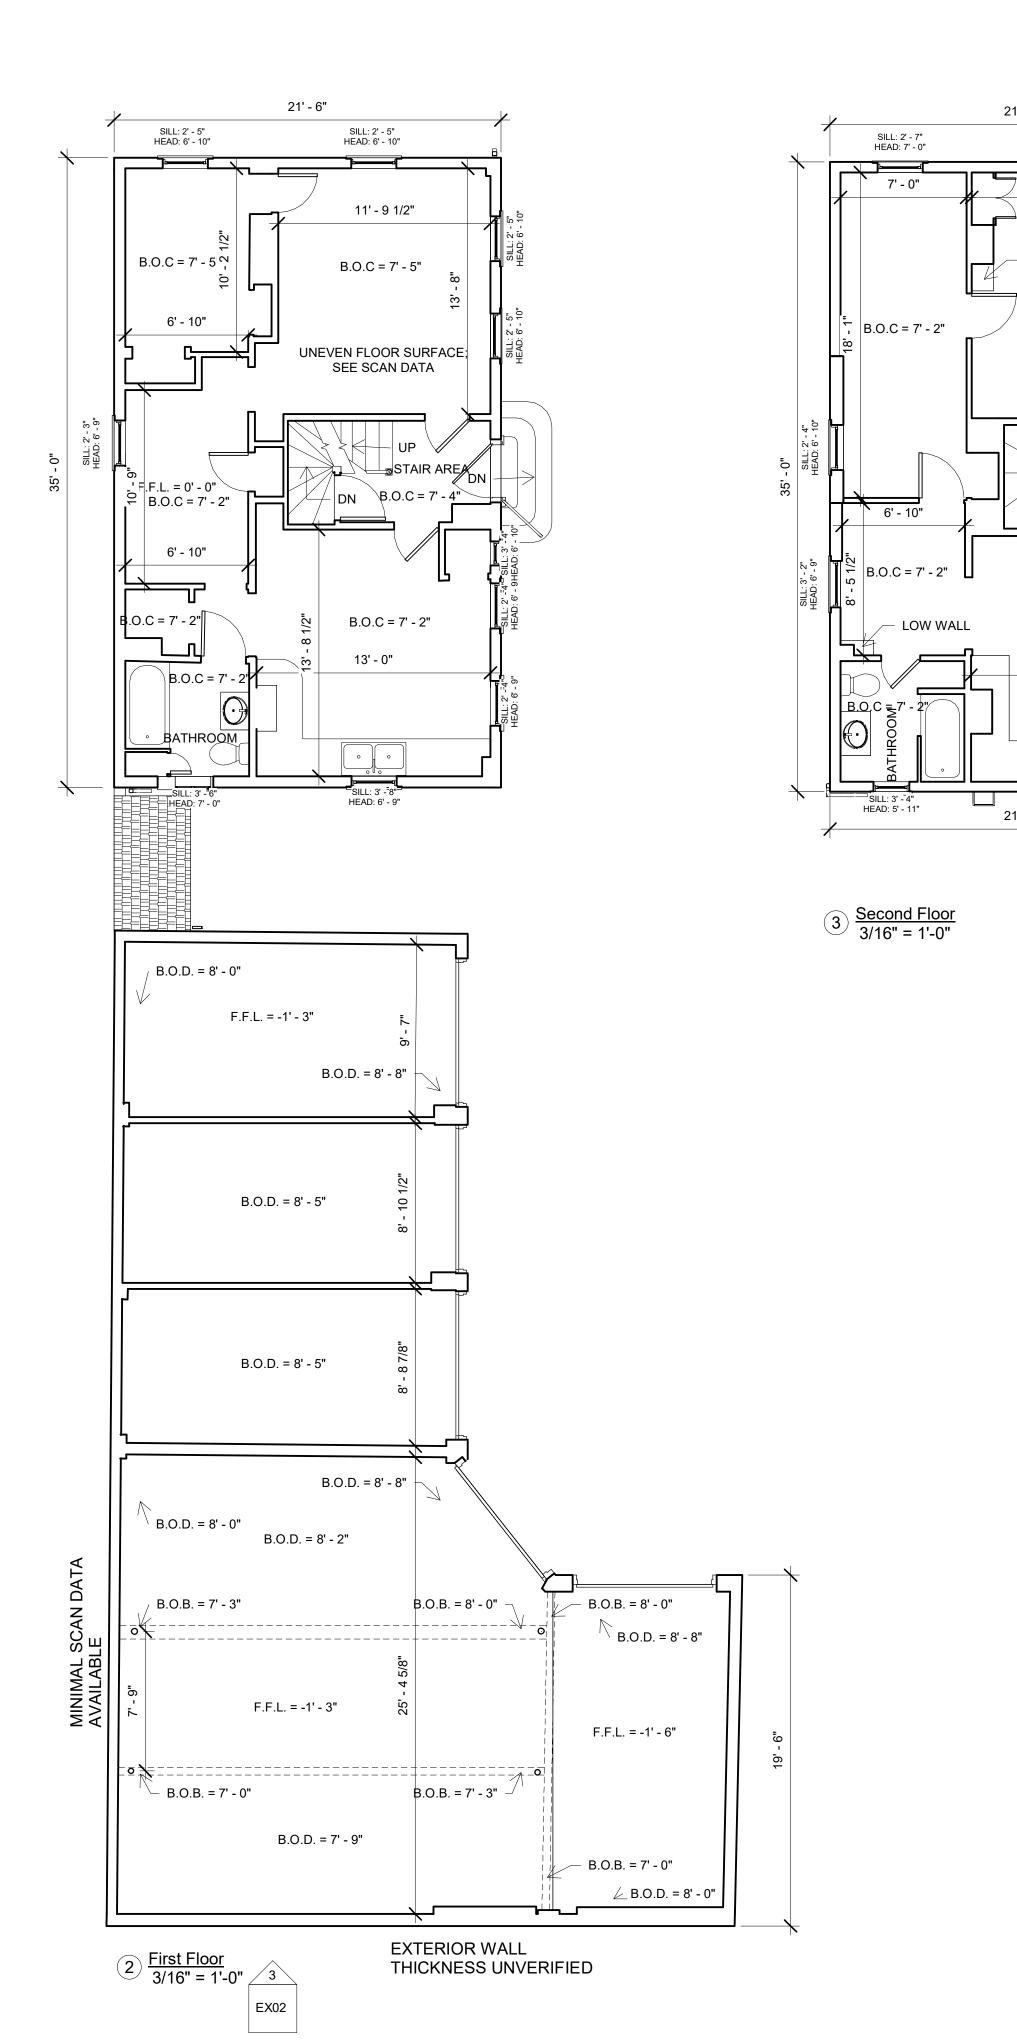

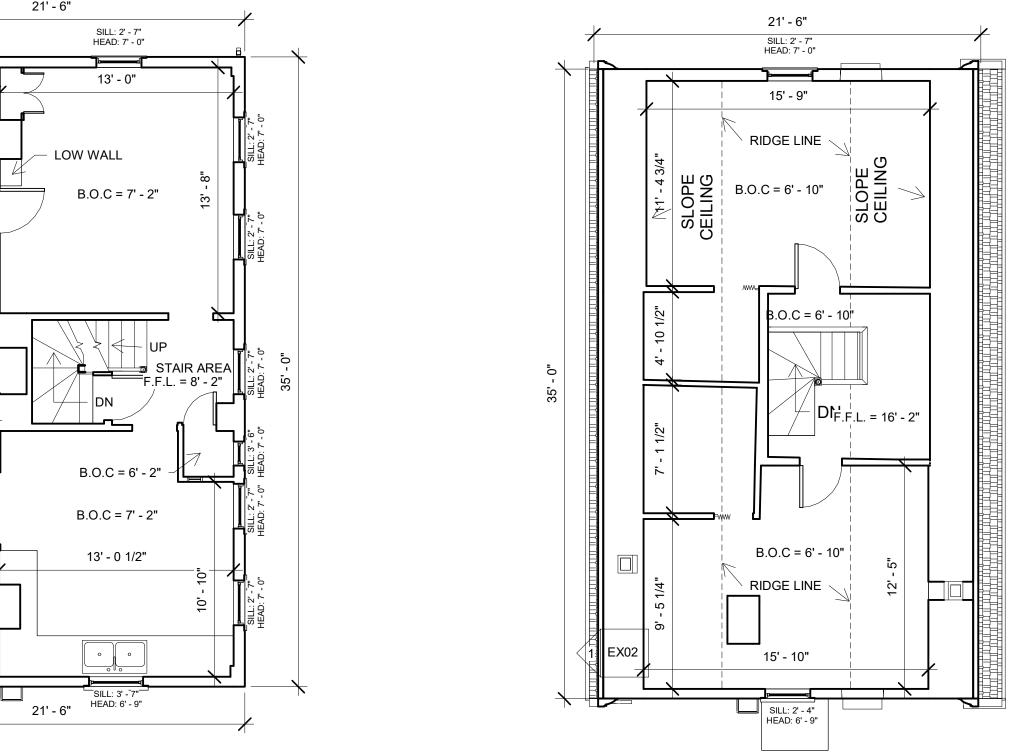

 $4 \frac{\text{Third Floor}}{3/16"} = 1'-0"$



BALANCE ARCHITECTS
617 991 0269 I www.balance-a

617.991.0269 | www.balance-architects.com 197 8th Street, Suite 2000, Boston, MA 02129

PROJECT NAME:

152 CHARLES STREET

CLIENT:

KINVARRA CAPITAL

PROJECT ADDRESS:

152 CHARLES ST, CAMBRIDGE, MA 02141

COPYRIGHT BALANCE ARCHITECTS © 2020 THIS DOCUMENT IS THE SOLE PROPERTY OF BALANCE ARCHITECTS. USE OF THIS DOCUMENT BY THE OWNER FOR THE COMPLETION OF THIS OR OTHER PROJECTS WITHOUT EXPRESS WRITTEN CONSENT IS STRICTLY FORBIDDEN.

| No. | Description | Date |
|-----|-------------|------|
| | | |
| | | |
STAMP:

 Project number
 20.038

 Date
 1/17/2021


 Drawn by
 PS

 Checked by
 PS

 Scale
 3/16" = 1'-0"

Existing Floor Plans

EX01

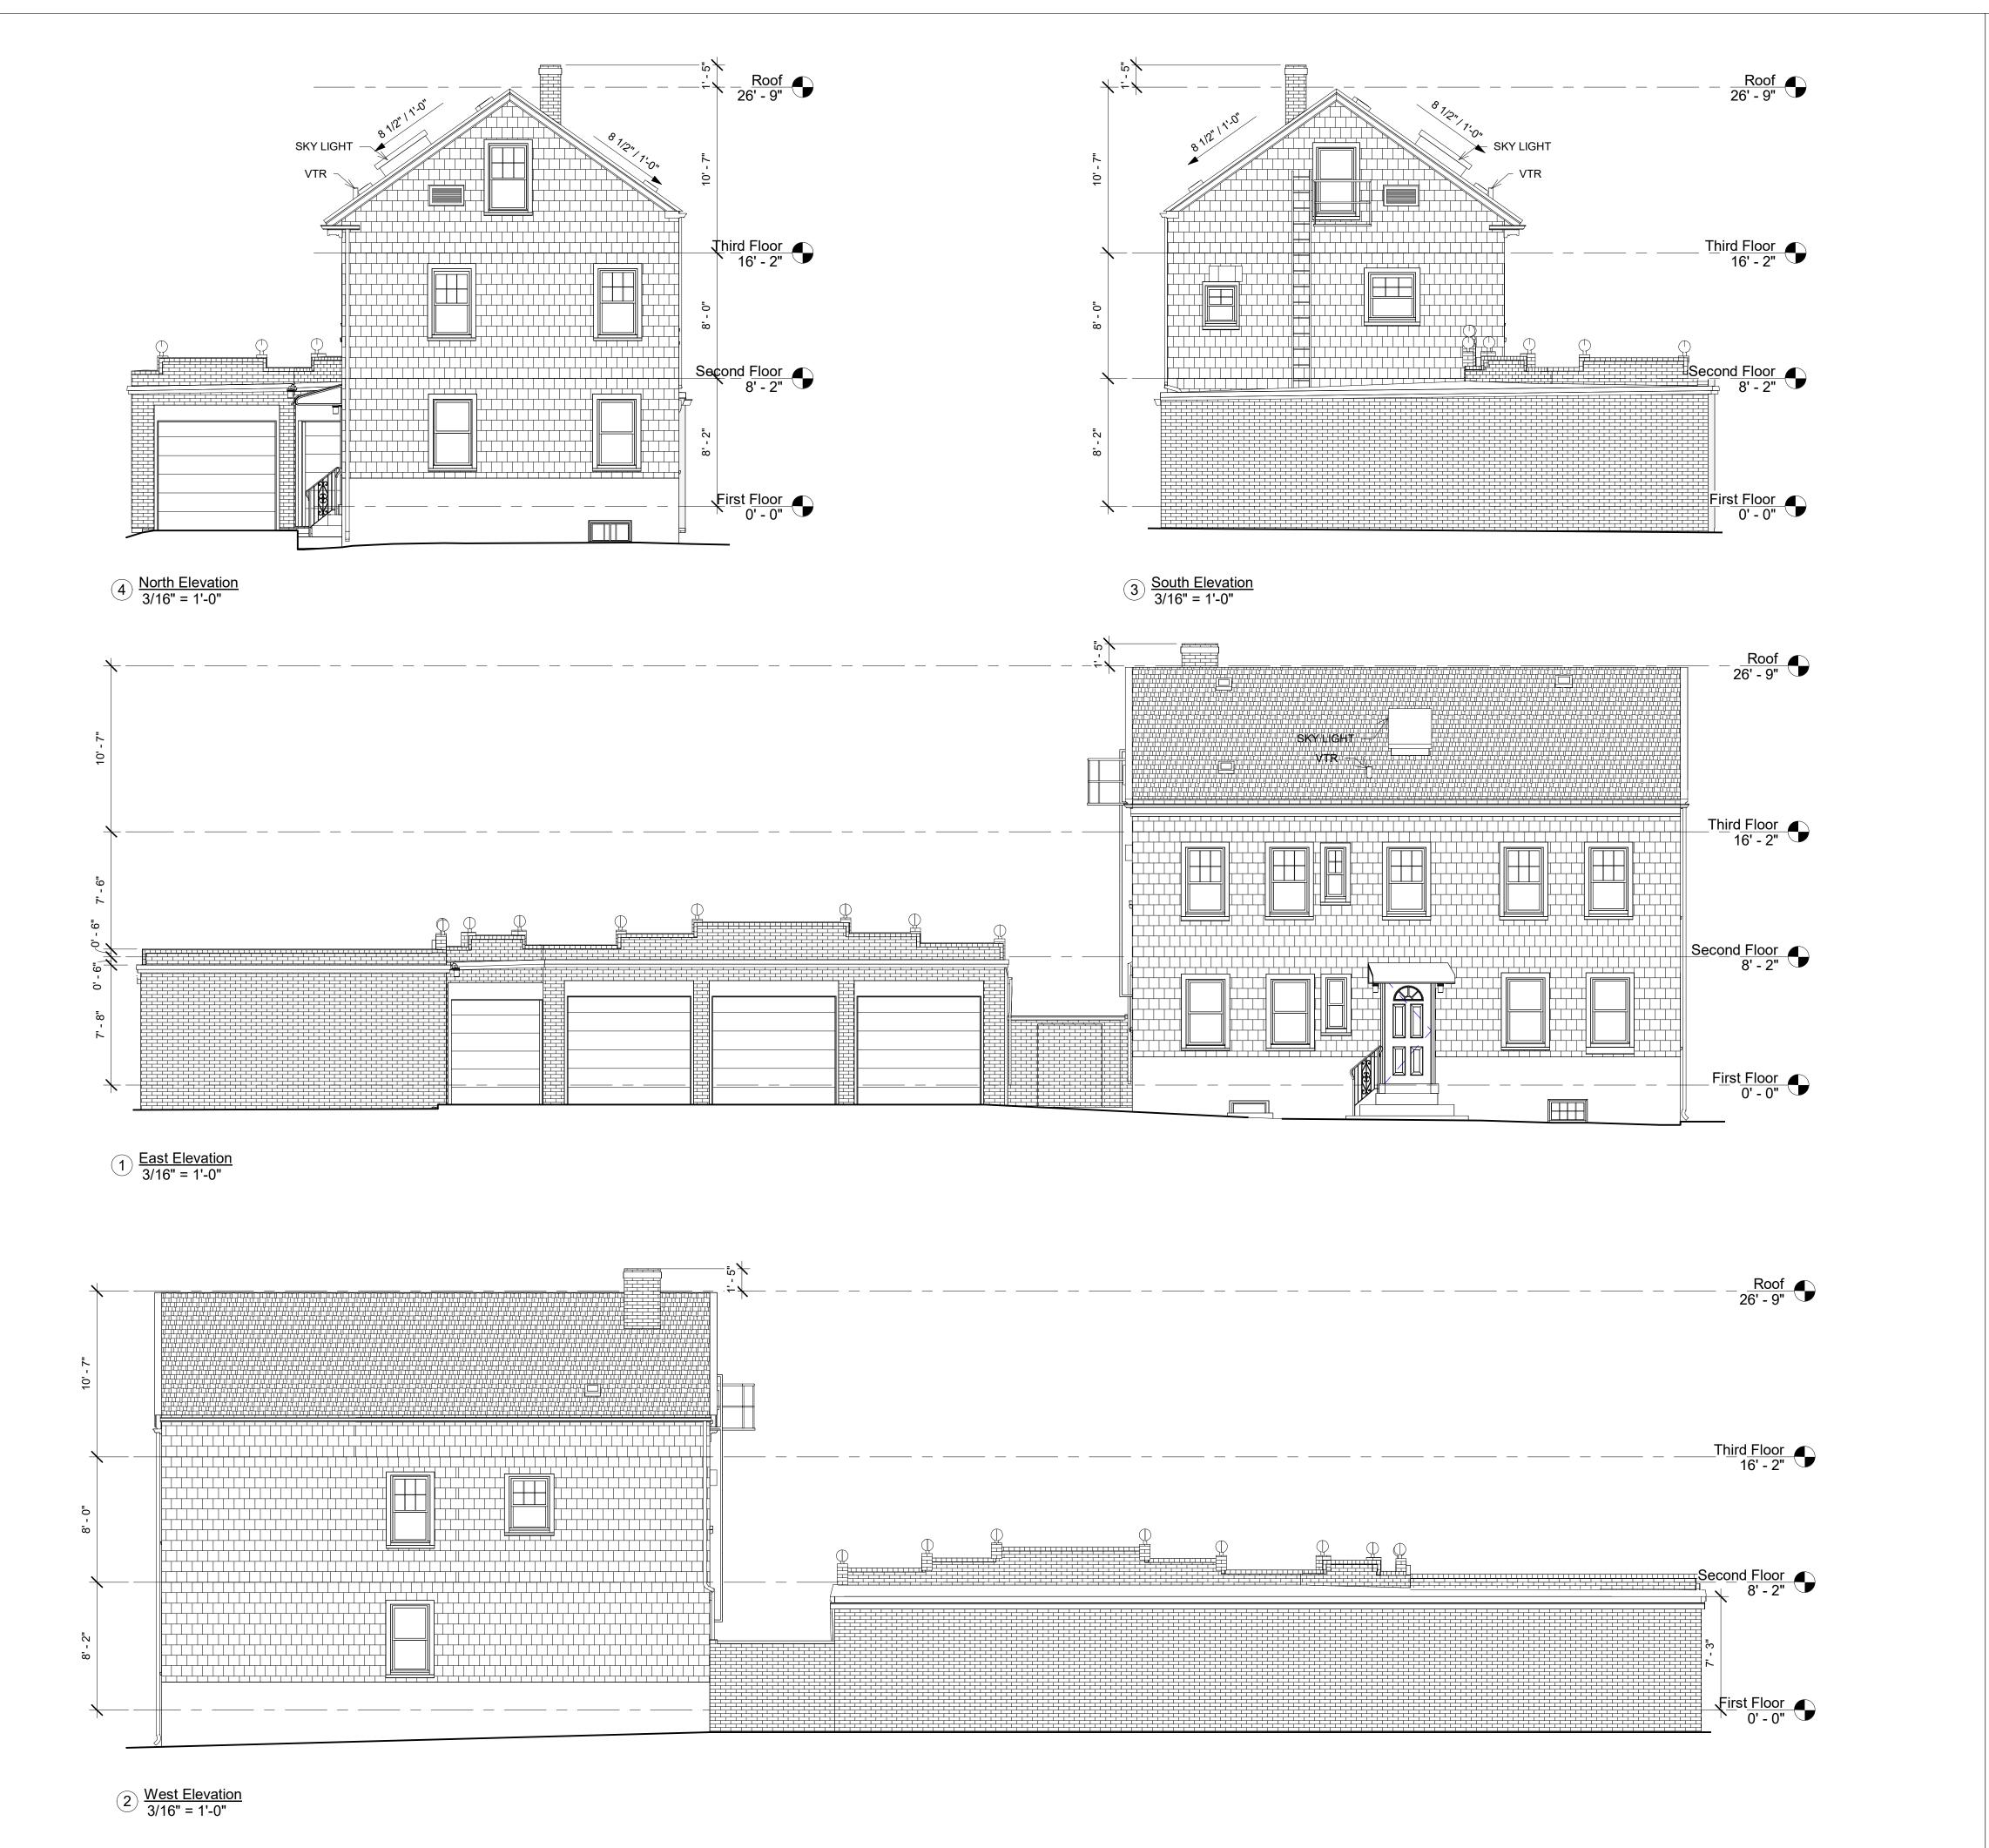



BALANCE ARCHITECTS

617.991.0269 | www.balance-architects.com 197 8th Street, Suite 2000, Boston, MA 02129

PROJECT NAME:

152 CHARLES STREET

CLIENT:

KINVARRA CAPITAL

PROJECT ADDRESS:

152 CHARLES ST, CAMBRIDGE, MA 02141

COPYRIGHT BALANCE ARCHITECTS © 2020 THIS DOCUMENT IS THE SOLE PROPERTY OF BALANCE ARCHITECTS. USE OF THIS DOCUMENT BY THE OWNER FOR THE COMPLETION OF THIS OR OTHER PROJECTS WITHOUT EXPRESS WRITTEN CONSENT IS STRICTLY FORBIDDEN.

No. Description Date



STAMI

 Project number
 20.038

 Date
 1/17/2021


 Drawn by
 ECS

 Checked by
 Checker

 Scale
 3/16" = 1'-0"

Existing Exterior Elevations

EX02

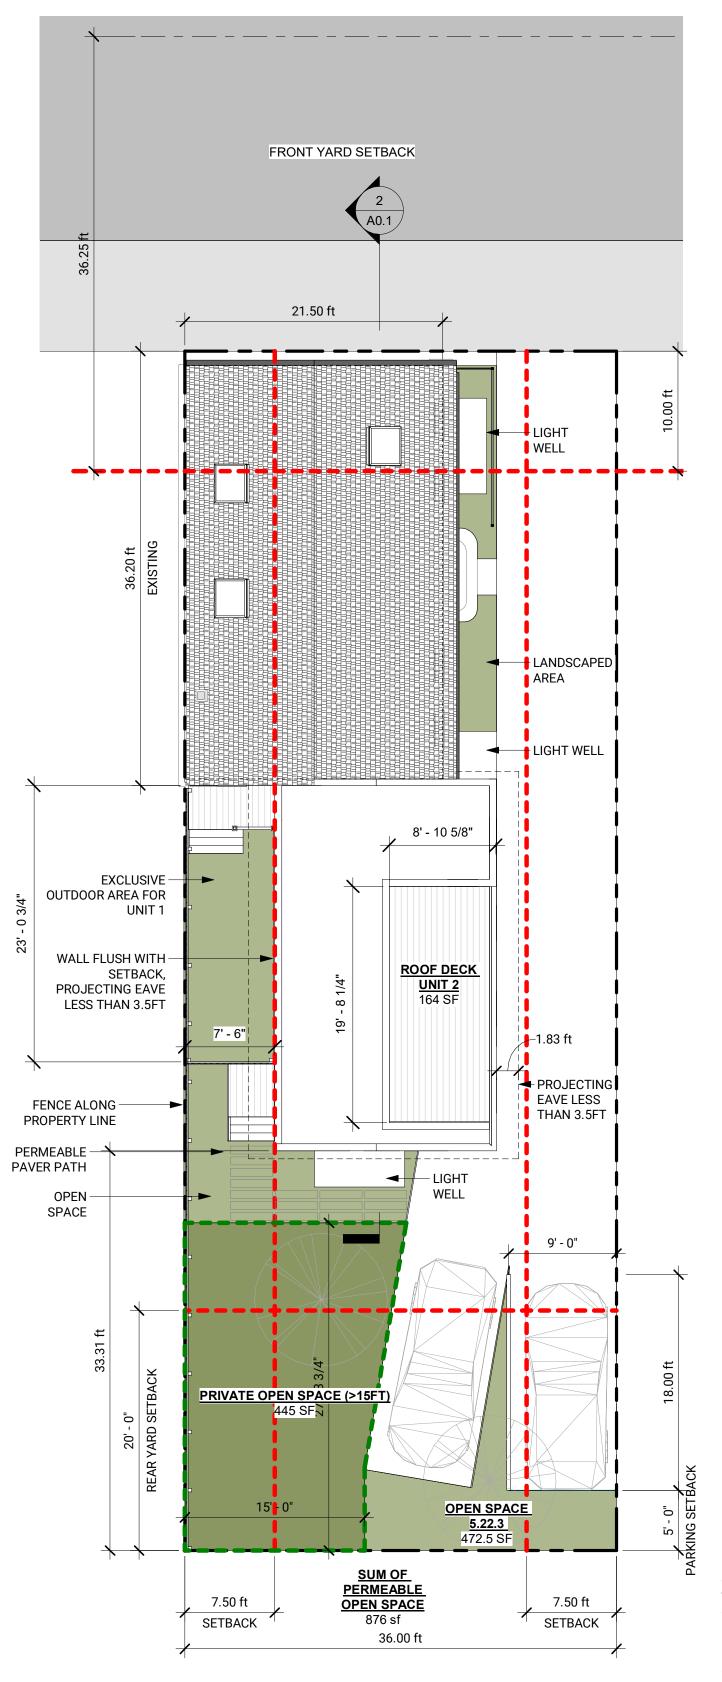

*WHOLE-HOUSE MECHANICAL VENTILATION SYSTEM IS INSTALLED IN ACCORDANCE WITH SECTION M1507. ARTIFICIAL LIGHT IS PROVIDED THAT IS CAPABLE OF PRODUCING AN AVERAGE ILLUMINATION OF 6 FOOTCANDLES (65 LUX) OVER THE AREA OF THE ROOM AT A HEIGHT OF 30 INCHES (762 MM) ABOVE THE FLOOR LEVEL.

OFFICE* BEDROOM - EMERGENCY **ESCAPE** WINDOW FAMILY ROOM* LIGHT WELL

(n) In a Residence C-1 District, no building plane (excluding projections as permitted by Section 5.24.2) may be nearer than seven feet, six inches (7'6") to a side lot line.

5.24.4 Measurements for minimum yards which are determined by formula shall be made in the following manner:

(1) "H" is the height of the building. "L" is the length of the wall measured parallel to the corresponding lot or street line. The front yard is measured from the street line, or building line where such has been established, except where otherwise indicated herein. For buildings of forty (40) feet or less in height the denominator in the yard formulas in the Tables in Section 5.30 may be increased by two subject to the minimum yard requirements set forth in footnotes a, b and c of Tables 5-1 and 5-2.

Height of Building. The vertical distance of the highest point of the roof above the mean grade of the ground adjoining the building.

5.21 Lot area and width.

5.21.1 On lots of less than the required area for the district in which they are located and which have been duly recorded by plan or deed with the Registry of Deeds before the date of the first passage of the applicable provisions of this or any prior Ordinance the minimum lot size and lot width regulations need not apply, but the floor area ratio and the minimum lot area regulations for each dwelling unit shall be applicable. In case of such lots of less than the required width the sum of the two required side yards need not be more than thirty (30) percent of the lot width, except that each side yard shall be a minimum of seven feet, six inches (7' 6").

5.22.1 - Private Open Space

... An area designated as private open space must have both a width and a length of at least fifteen (15) feet, except for balconies, and may not have a slope greater than ten (10) percent. With the exception of balcony areas, private open space shall be accessible to all occupants of a building; not less than one half of the required private open space shall be provided at ground level or within ten (10) feet of the level of the lowest floor used for residential purposes..

5.22.3 - Special Requirements in Residence C-1

At least fifty (50) percent of the required Private open space in these districts shall meet all of the requirements of Section 5.22.1.... At least fifty (50) percent of the required Private open space shall meet the definition of Permeable Open Space and shall not be subject to the dimensional limitations of Section 5.22.1 as applied to Private open

Rear Roof Deck 22' - 5 17/32" Rear T.O. Plate 20' - 9 1/8"

ADDITION Second Floor 11' - 7 25/32"

ADDITION First Floor
0' - 3 1/2"

Addition Basement -9' - 0 3/4"

ZONING SUMMARY

UNIT 2

Zoning District East Cambridge Housing Overlay (ECHO) **Subdistrict Type** Three Family Residential - 2000 3,600 SF Lot Size 1562 **Use Regulations** Two Family Dwelling

Existing Lot Area (S.F.) **Gross Floor Area** 3000.0 SF 2700.0 SF -300.0 SF # of Units



152 Charles Street, Cambridge, MA 02141

| Dimensional Requirements | Allowed | Existing | Proposed | Existing Conformance | Proposed Conformance | Comments |
|--|-----------|-----------|-----------|-----------------------------|-----------------------------|---|
| | | | | | | |
| Minimum Lot Size | 5000.0 SF | 3600.0 SF | 3600.0 ft | NO | NO | Existing non conforming |
| Max. FAR | 0.75 | 0.83 | 0.75 | NO | | 3,1,1 |
| Max Area (based on FAR) | 2700.0 | 3000.0 | 2700.0 | NO | YES | Existing non conforming, proposed conformance |
| Min. Lot Area/DU | 1500.0 SF | 1800.0 SF | 1800.0 SF | YES | YES | Existing conforming, proposed conformance |
| Min. Lot Width | 50 ft | 36.0 ft | 36.0 ft | NO | NO | Existing non conforming |
| Min. Front Yard Depth | 10.0 | 1.2 | 1.2 | NO | NO | H+L/6 =31.3+21.5/6 = 8.8' (10ft Min.) |
| Min. Side Yard Depth Left | 7.5 ft | .0 ft | .0 ft | NO | NO | Section 5.21.1, Existing non conforming |
| Min. Side Yard Depth Right | 7.5 ft | 1.0 ft | 10.0 ft | NO | YES | Section 5.21.1 |
| Min. Rear Yard Depth | 20.0 ft | .0 ft | 33.3 ft | NO | YES | Existing non conforming, proposed conforming |
| Minimum Ratio of Private Open Space to Lot Area | 30.00% | 0.00% | 30.04% | NO | YES | * See below |
| Min Open Space in SF | 1080.0 SF | .0 SF | 1081.5 SF | NO | YES | Existing non conforming, proposed conforming |
| Max. Height | 35.0 ft | 28.8 ft | 32.38 | YES | YES | Conforming |
| Off Street Parking | 2 | 5 | 2 | YES | YES | Conforming |

35.00 ft

UNIT 1

* Private open space larger than 15'x15' = 445 SF, Balcony Area = 160 SF, Private Open space not subject to dimensional limitations = 498 SF, Total of 1,103 SF, exceeding the minimum 1,080 SF required. Private Open Space that meets all requirements of Section 5.22.1 is: 445 + 160/1103 = 55% % Private Space that meets the Permeable Open Space requirements is: 445 +498/1103 = 85%.

At least 50% of required private open space shall be minimum length & width of 15' and no slope greater than 10%. Accessible to all occupants. Provided at ground level or within 10' of the level of the lowest floor. At least 50% of required private open space shall be permeable open space and not subject to dimensional limitations noted above.

Floor Area Ratio. The ratio of gross floor area of a structure to the total area of the lot.

Floor Area Gross. The sum, in square feet, of the gross horizontal areas of all floors of a building, as measured from the exterior walls [except in (8) and (9) below where only interior space shall be measured and in (h) where the area of the parking facility shall be measured] of a building or the centerline of party walls between buildings.

Gross Floor Area shall include:

(d) Attic space, whether finished or unfinished, within the area of a horizontal plane that is five (5) feet above the attic floor and which touches the side walls and/or the underside of the roof rafters and which is not excluded in (5) below;

Gross Floor Area shall not include:

(2) Area of parking facilities in structures located underground and the area of on grade open parking spaces outside the building footprint at or below the maximum number permitted on the premises as set forth in Sections 5.25 and

(3) Basement and cellar areas devoted to the operations and maintenance of the building such as heating and cooling equipment, electrical and telephone facilities, and fuel storage; (5) Unroofed porches and balconies no higher than the third floor;


(6) Attic space and other areas devoted to elevator machinery or mechanical equipment necessary for the operation of the building, including sustainable mechanical systems and related equipment and chases for systems including, but not limited to, solar energy systems, geothermal systems and heat pumps, solar hot water systems and related tubes and tanks, equipment related to radiant heating, hydronic cooling, heat recovery ventilators, and energy recovery ventilators;

(8) Attic space not otherwise included in (d) above; (15) Any basement or cellar living space in any single-family or two-family home.

5.24.2 Projecting eaves, chimneys, bay windows, balconies, open fire escapes and like projections which do not project more than three and one-half (3 ½) feet and which are part of a building not more than thirty-five (35) feet in height, and unenclosed steps, unroofed porches and the like which do not project more than ten (10) feet beyond the line of the foundation wall and which are not over four (4) feet above the average level of the adjoining ground, may extend beyond the minimum yard regulations otherwise provided for the district in which the structure is built.

Exemption for Residential Parking Spaces. Notwithstanding the provisions of Section 5.25.2 above, the following structured parking located above ground, accessory to a residential use, shall not be calculated as part of the Gross Floor Area on the lot:

(1) One parking space located within a townhouse unit or a one, two or three family dwelling. (2) A freestanding parking structure containing no more than one parking space per dwelling unit up to a maximum of three parking spaces on a lot containing a one, two or three family dwelling. (3) One parking space per dwelling unit, up to a maximum of fifteen (15) spaces, for multifamily dwellings.

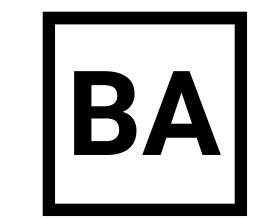

BALANCE ARCHITECTS 617.991.0269 | www.balance-architects.com 197 8th Street, Suite 2000, Boston, MA 02129

PROJECT NAME:

EXISTING ROOF RIDGE 26' - 9"

MAIN SECOND FLOOR NEW 10' - 1 1/4"

MAIN FIRST FLOOR NEW
0' - 0"


MAIN BASEMENT NEW -9' - 4 9/32"


152 CHARLES ST

KINVARRA CAPITAL

PROJECT ADDRESS: 152 CHARLES ST, CAMBRIDGE MA 02141

> COPYRIGHT BALANCE ARCHITECTS © 2021 THIS DOCUMENT IS THE SOLE PROPERTY OF BALANCE ARCHITECTS. USE OF THIS DOCUMENT BY THE OWNER FOR THE COMPLETION OF THIS OR OTHER PROJECTS WITHOUT EXPRESS WRITTEN CONSENT IS STRICTLY FORBIDDEN.

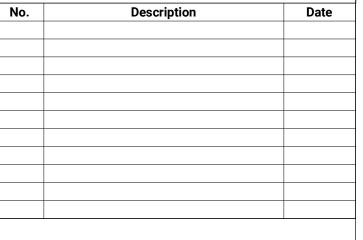

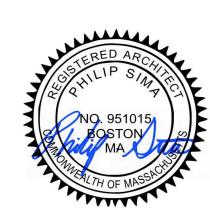


STAMP:


| Project number | 20.038 |
|----------------|--------------|
| Date | 4/12/2021 |
| Drawn by | PS |
| Checked by | PS |
| Scale | 1/8" = 1'-0" |

ZONING


A0.1

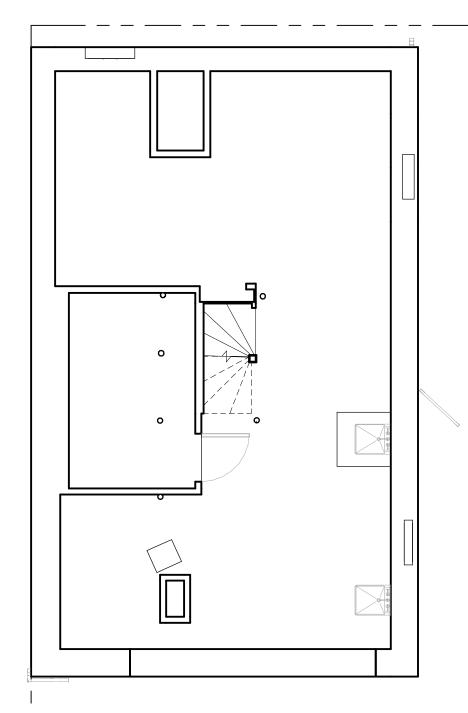


| Existing Gros | s Area Schedule | |
|-----------------------|-----------------|------|
| Level | Area | FAR |
| | | |
| MAIN FIRST FLOOR NEW | 1008 SF | 0.28 |
| MAIN FIRST FLOOR NEW | 32 SF | 0.01 |
| MAIN FIRST FLOOR NEW | 753 SF | 0.21 |
| SECOND FLOOR EXISTING | 769 SF | 0.21 |
| ROOF DECK | 438 SF | 0.12 |
| Grand total: 5 | 3000 SF | 0.83 |

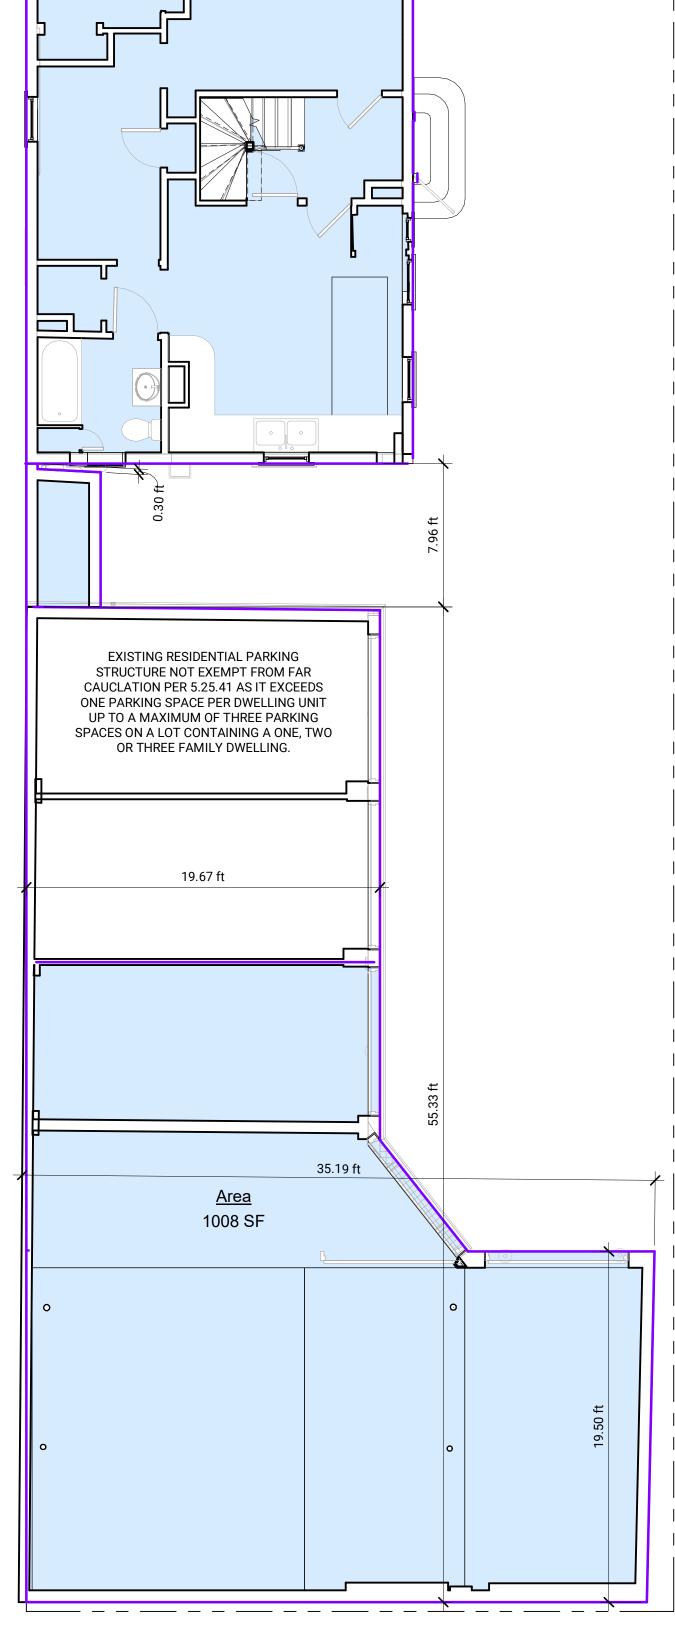

753 SF

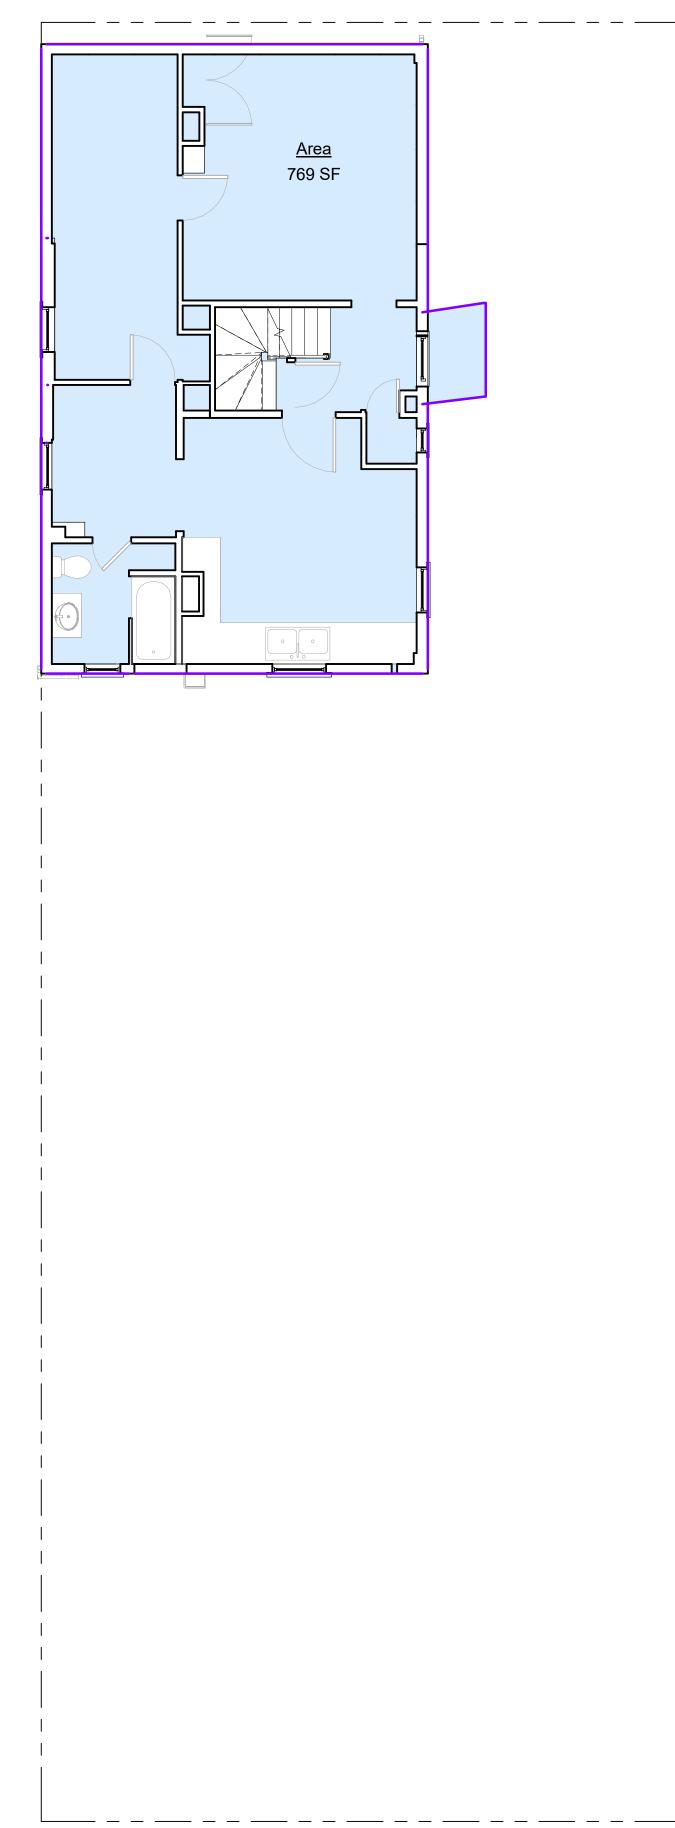

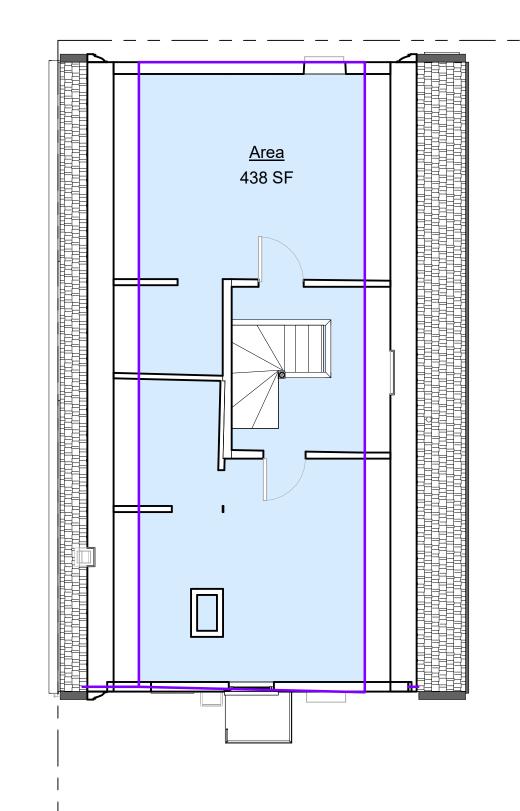



BALANCE ARCHITECTS

617.991.0269 | www.balance-architects.com 197 8th Street, Suite 2000, Boston, MA 02129

PROJECT NAME:

152 CHARLES ST

KINVARRA CAPITAL PROJECT ADDRESS:

152 CHARLES ST, CAMBRIDGE MA 02141

COPYRIGHT BALANCE ARCHITECTS © 2021 THIS DOCUMENT IS THE SOLE PROPERTY OF BALANCE ARCHITECTS. USE OF THIS DOCUMENT BY THE OWNER FOR THE COMPLETION OF THIS OR OTHER PROJECTS WITHOUT EXPRESS WRITTEN CONSENT IS STRICTLY FORBIDDEN.

| lo. | Description | Date |
|-----|-------------|------|
| | | |
| | | |
| Project number | 20.038 |
|----------------|---------------|
| Date | 4/12/2021 |
| Drawn by | PS |
| Checked by | PS |
| Scale | 3/16" = 1'-0" |
| | |


EXISTING AREA PLANS


A1.1





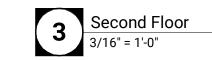

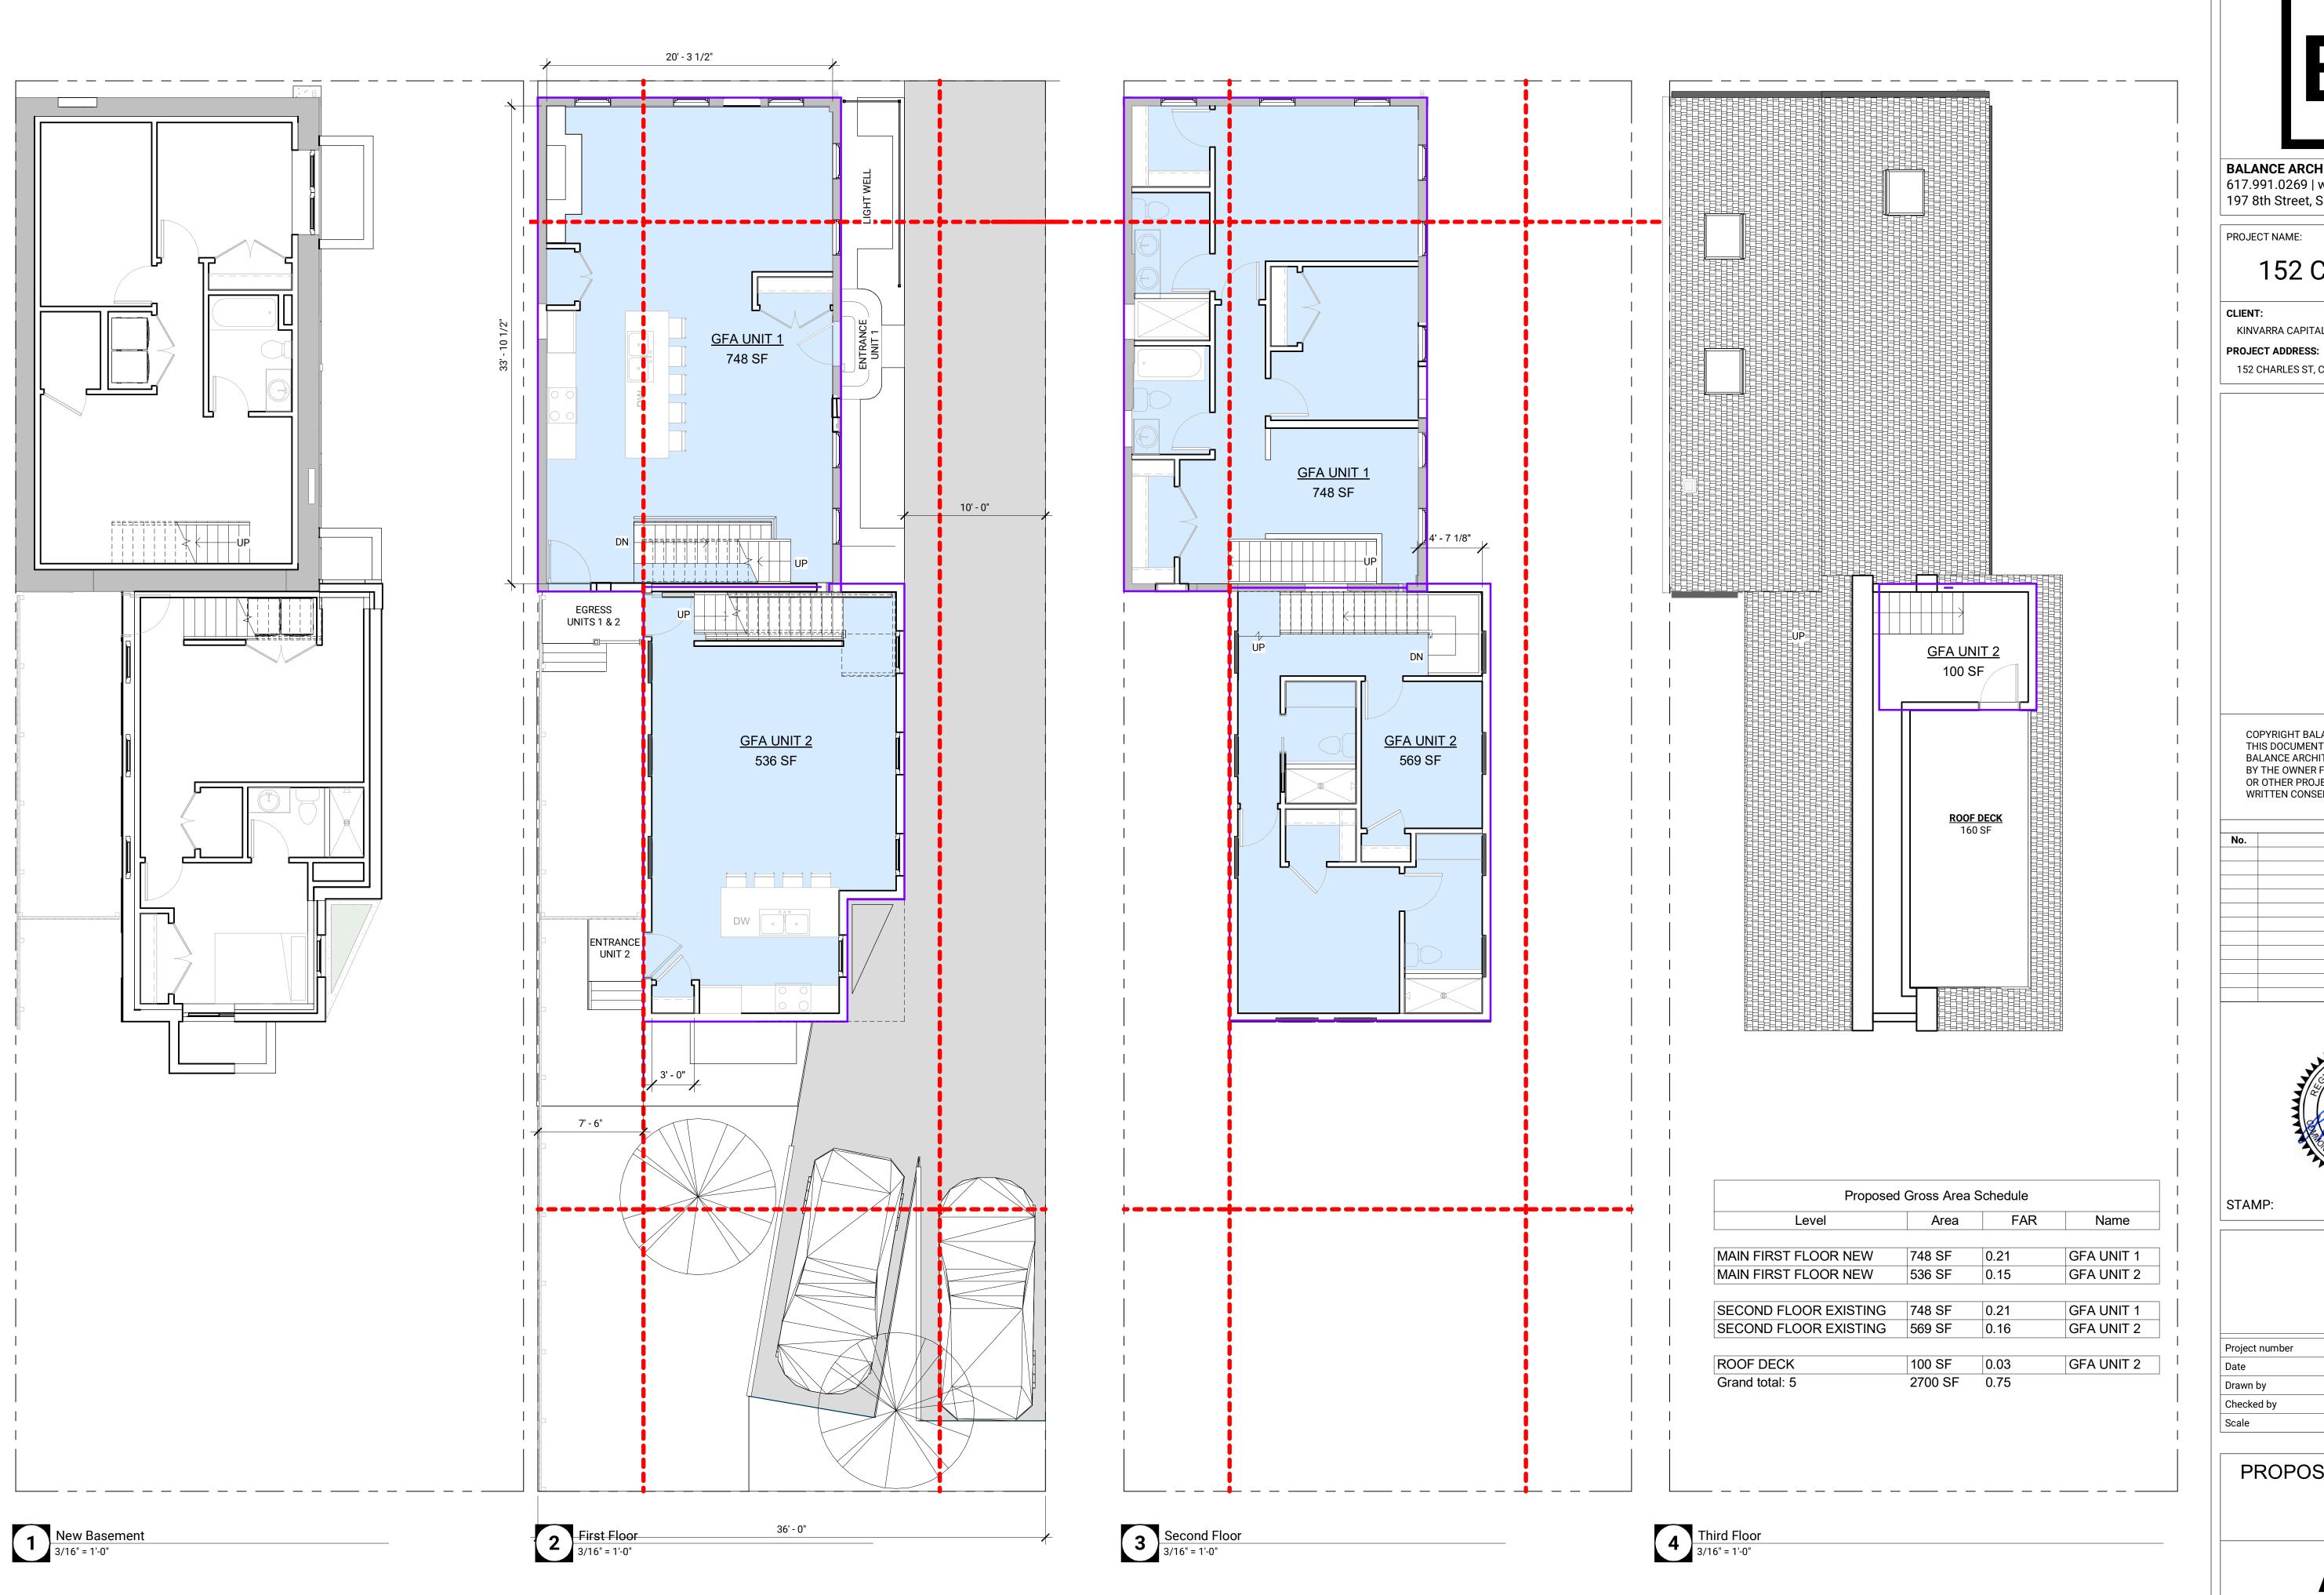

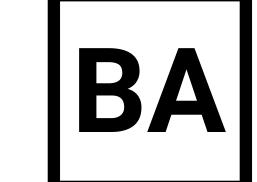

BALANCE ARCHITECTS

617.991.0269 | www.balance-architects.com 197 8th Street, Suite 2000, Boston, MA 02129

PROJECT NAME:

152 CHARLES ST

CLIENT:

KINVARRA CAPITAL

152 CHARLES ST, CAMBRIDGE MA 02141

COPYRIGHT BALANCE ARCHITECTS © 2021 THIS DOCUMENT IS THE SOLE PROPERTY OF BALANCE ARCHITECTS. USE OF THIS DOCUMENT BY THE OWNER FOR THE COMPLETION OF THIS OR OTHER PROJECTS WITHOUT EXPRESS WRITTEN CONSENT IS STRICTLY FORBIDDEN.

| No. | Description | Date |
|-----|-------------|------|
| | | |
| | | |
STAMP:

| Project number | 20.038 |
|----------------|---------------|
| Date | 4/12/2021 |
| Drawn by | PS/JMB |
| Checked by | PS |
| Scale | 3/16" = 1'-0" |
| | |

PROPOSED AREA PLANS

A1.2

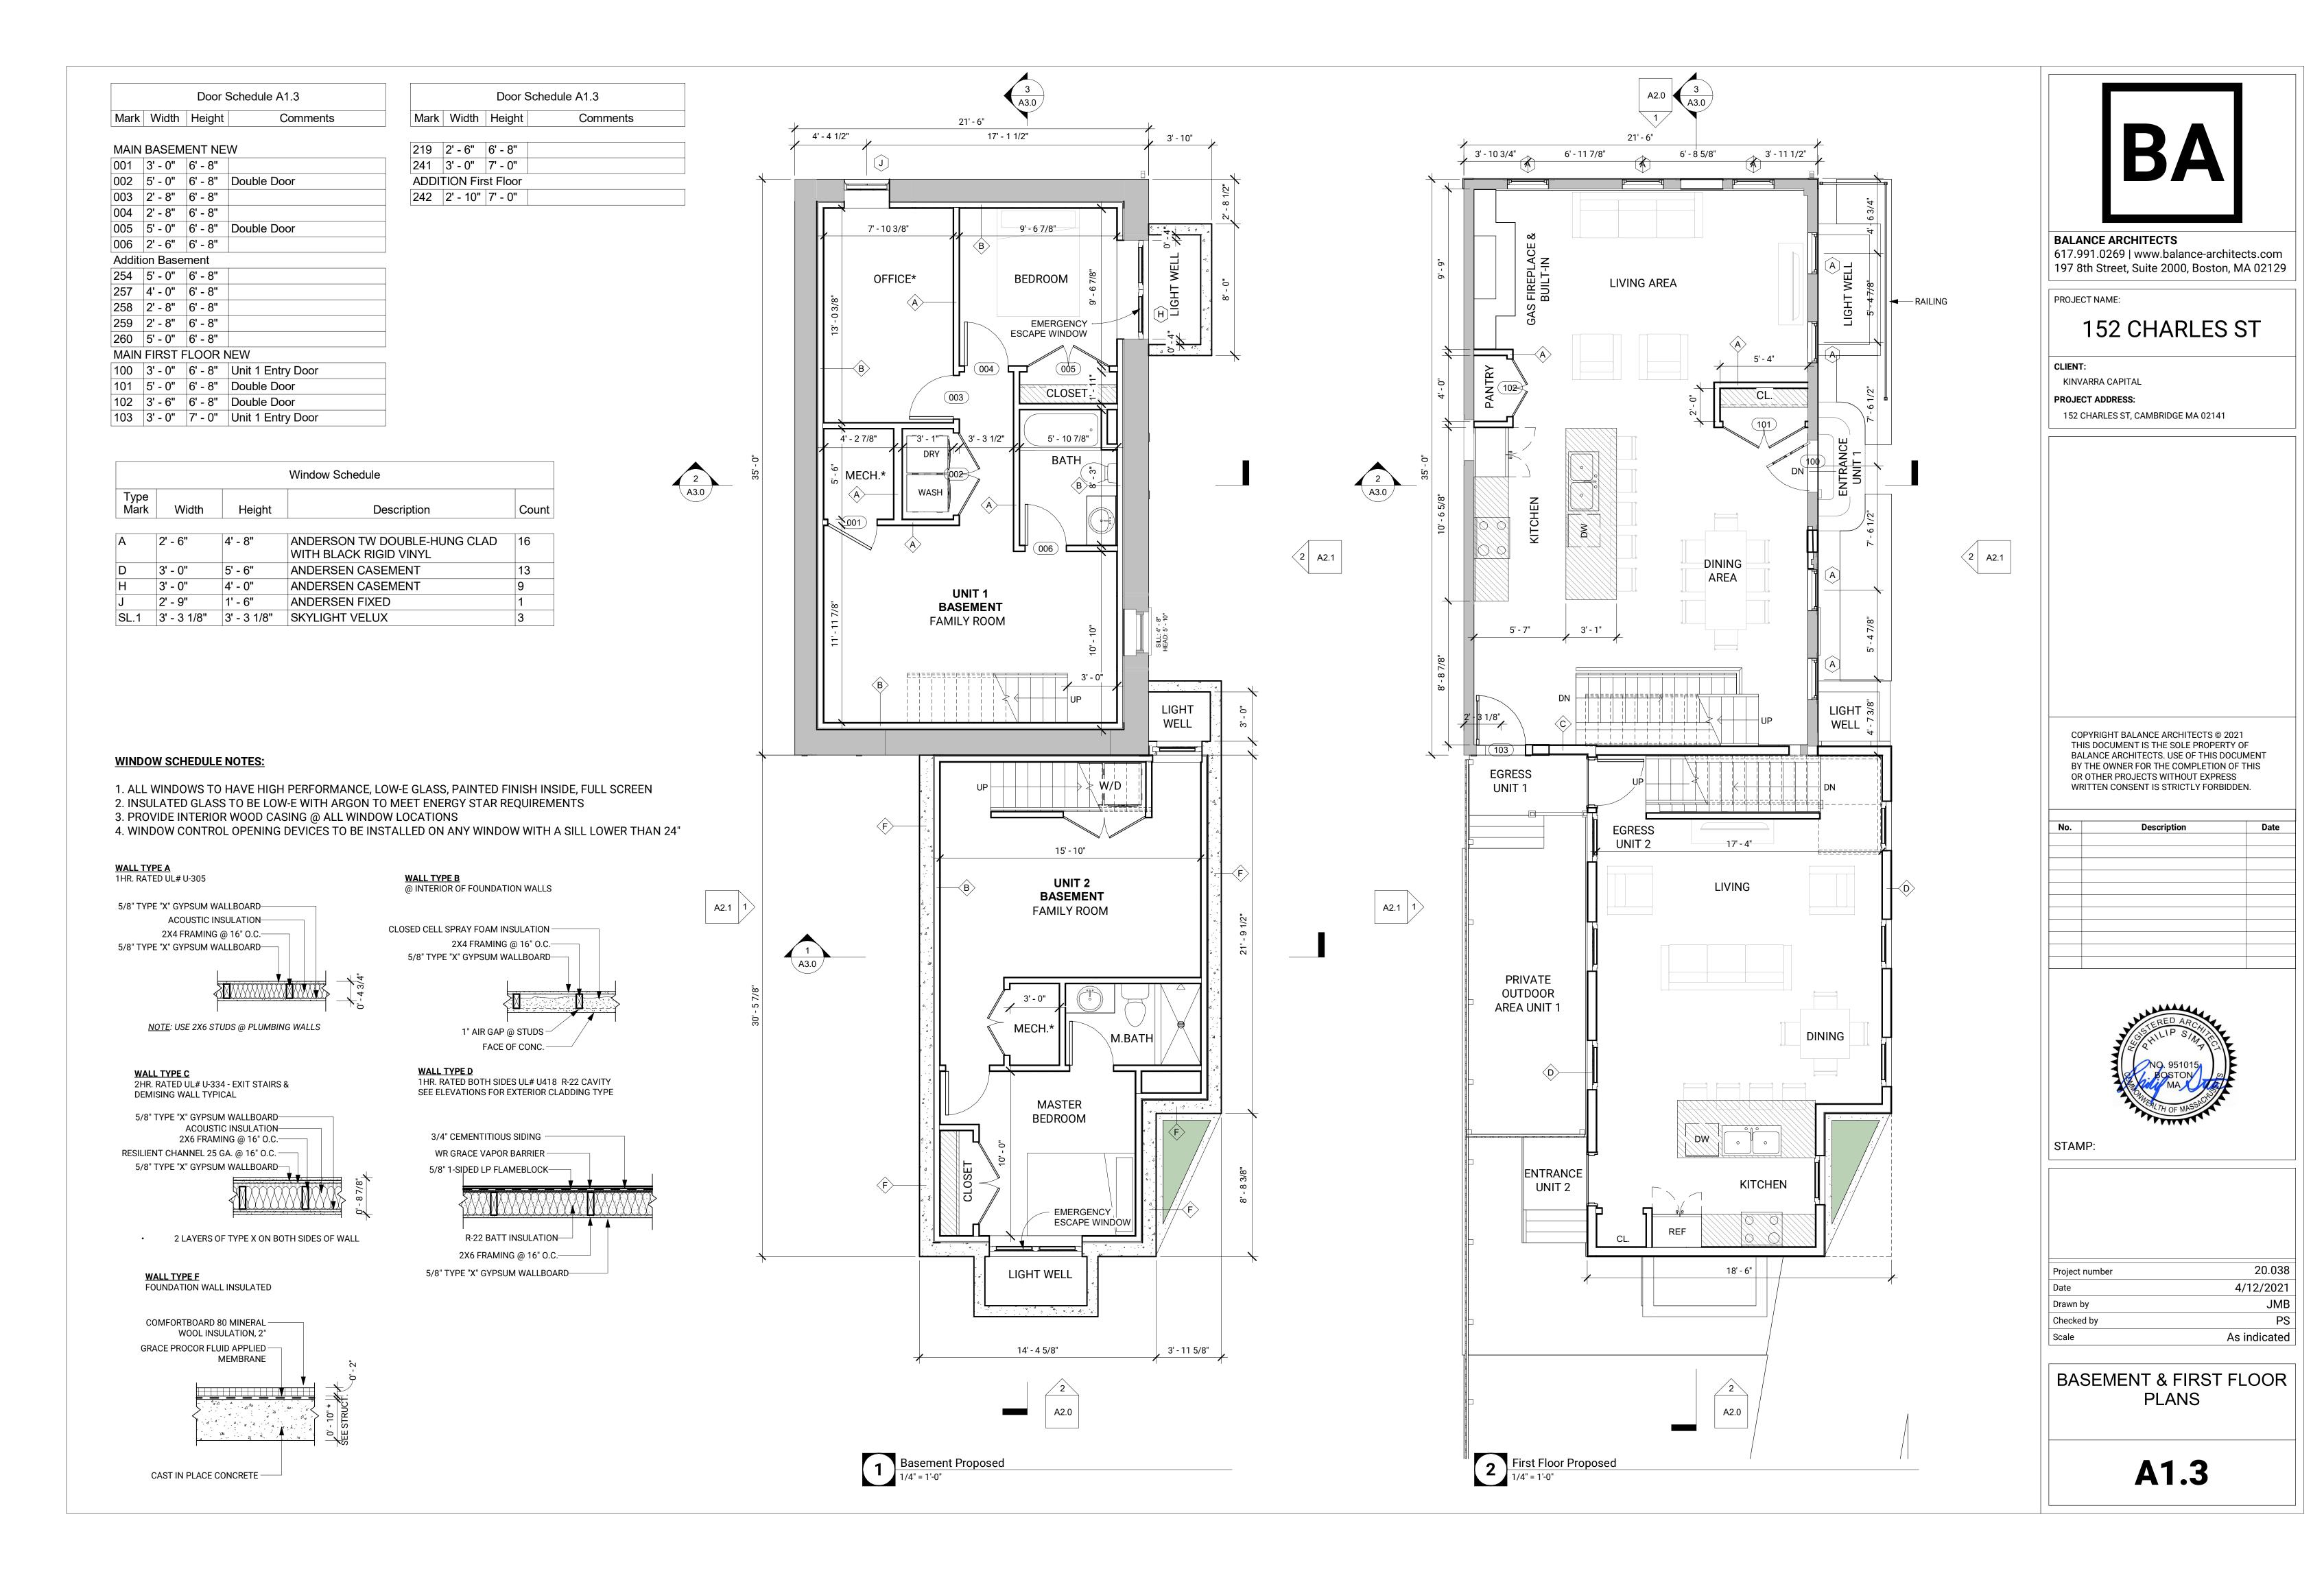

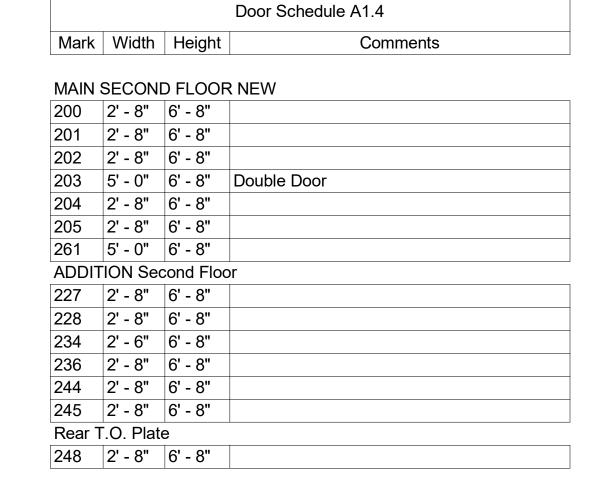


| Window Schedule | | | | |
|-----------------|-------------|-------------|--|-------|
| Type Mark | Width | Height | Description | Count |
| А | 2' - 6" | 4' - 8" | ANDERSON TW DOUBLE-HUNG CLAD WITH BLACK RIGID VINYL | 16 |
| D | 3' - 0" | 5' - 6" | ANDERSEN CASEMENT | 13 |
| Н | 3' - 0" | 4' - 0" | ANDERSEN CASEMENT | 9 |
| J | 2' - 9" | 1' - 6" | ANDERSEN FIXED | 1 |
| SL.1 | 3' - 3 1/8" | 3' - 3 1/8" | SKYLIGHT VELUX | 3 |



WINDOW SCHEDULE NOTES:


2 LAYERS OF TYPE X ON BOTH SIDES OF WALL

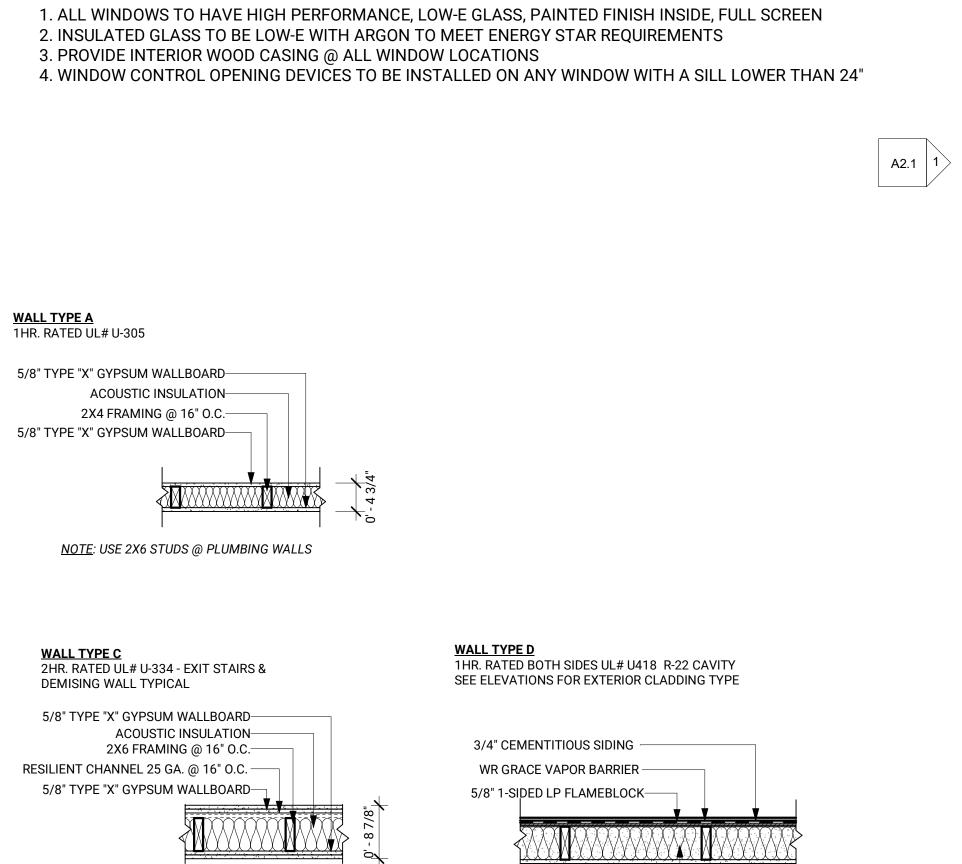

R-22 BATT INSULATION—

5/8" TYPE "X" GYPSUM WALLBOARD—

2X6 FRAMING @ 16" O.C.———

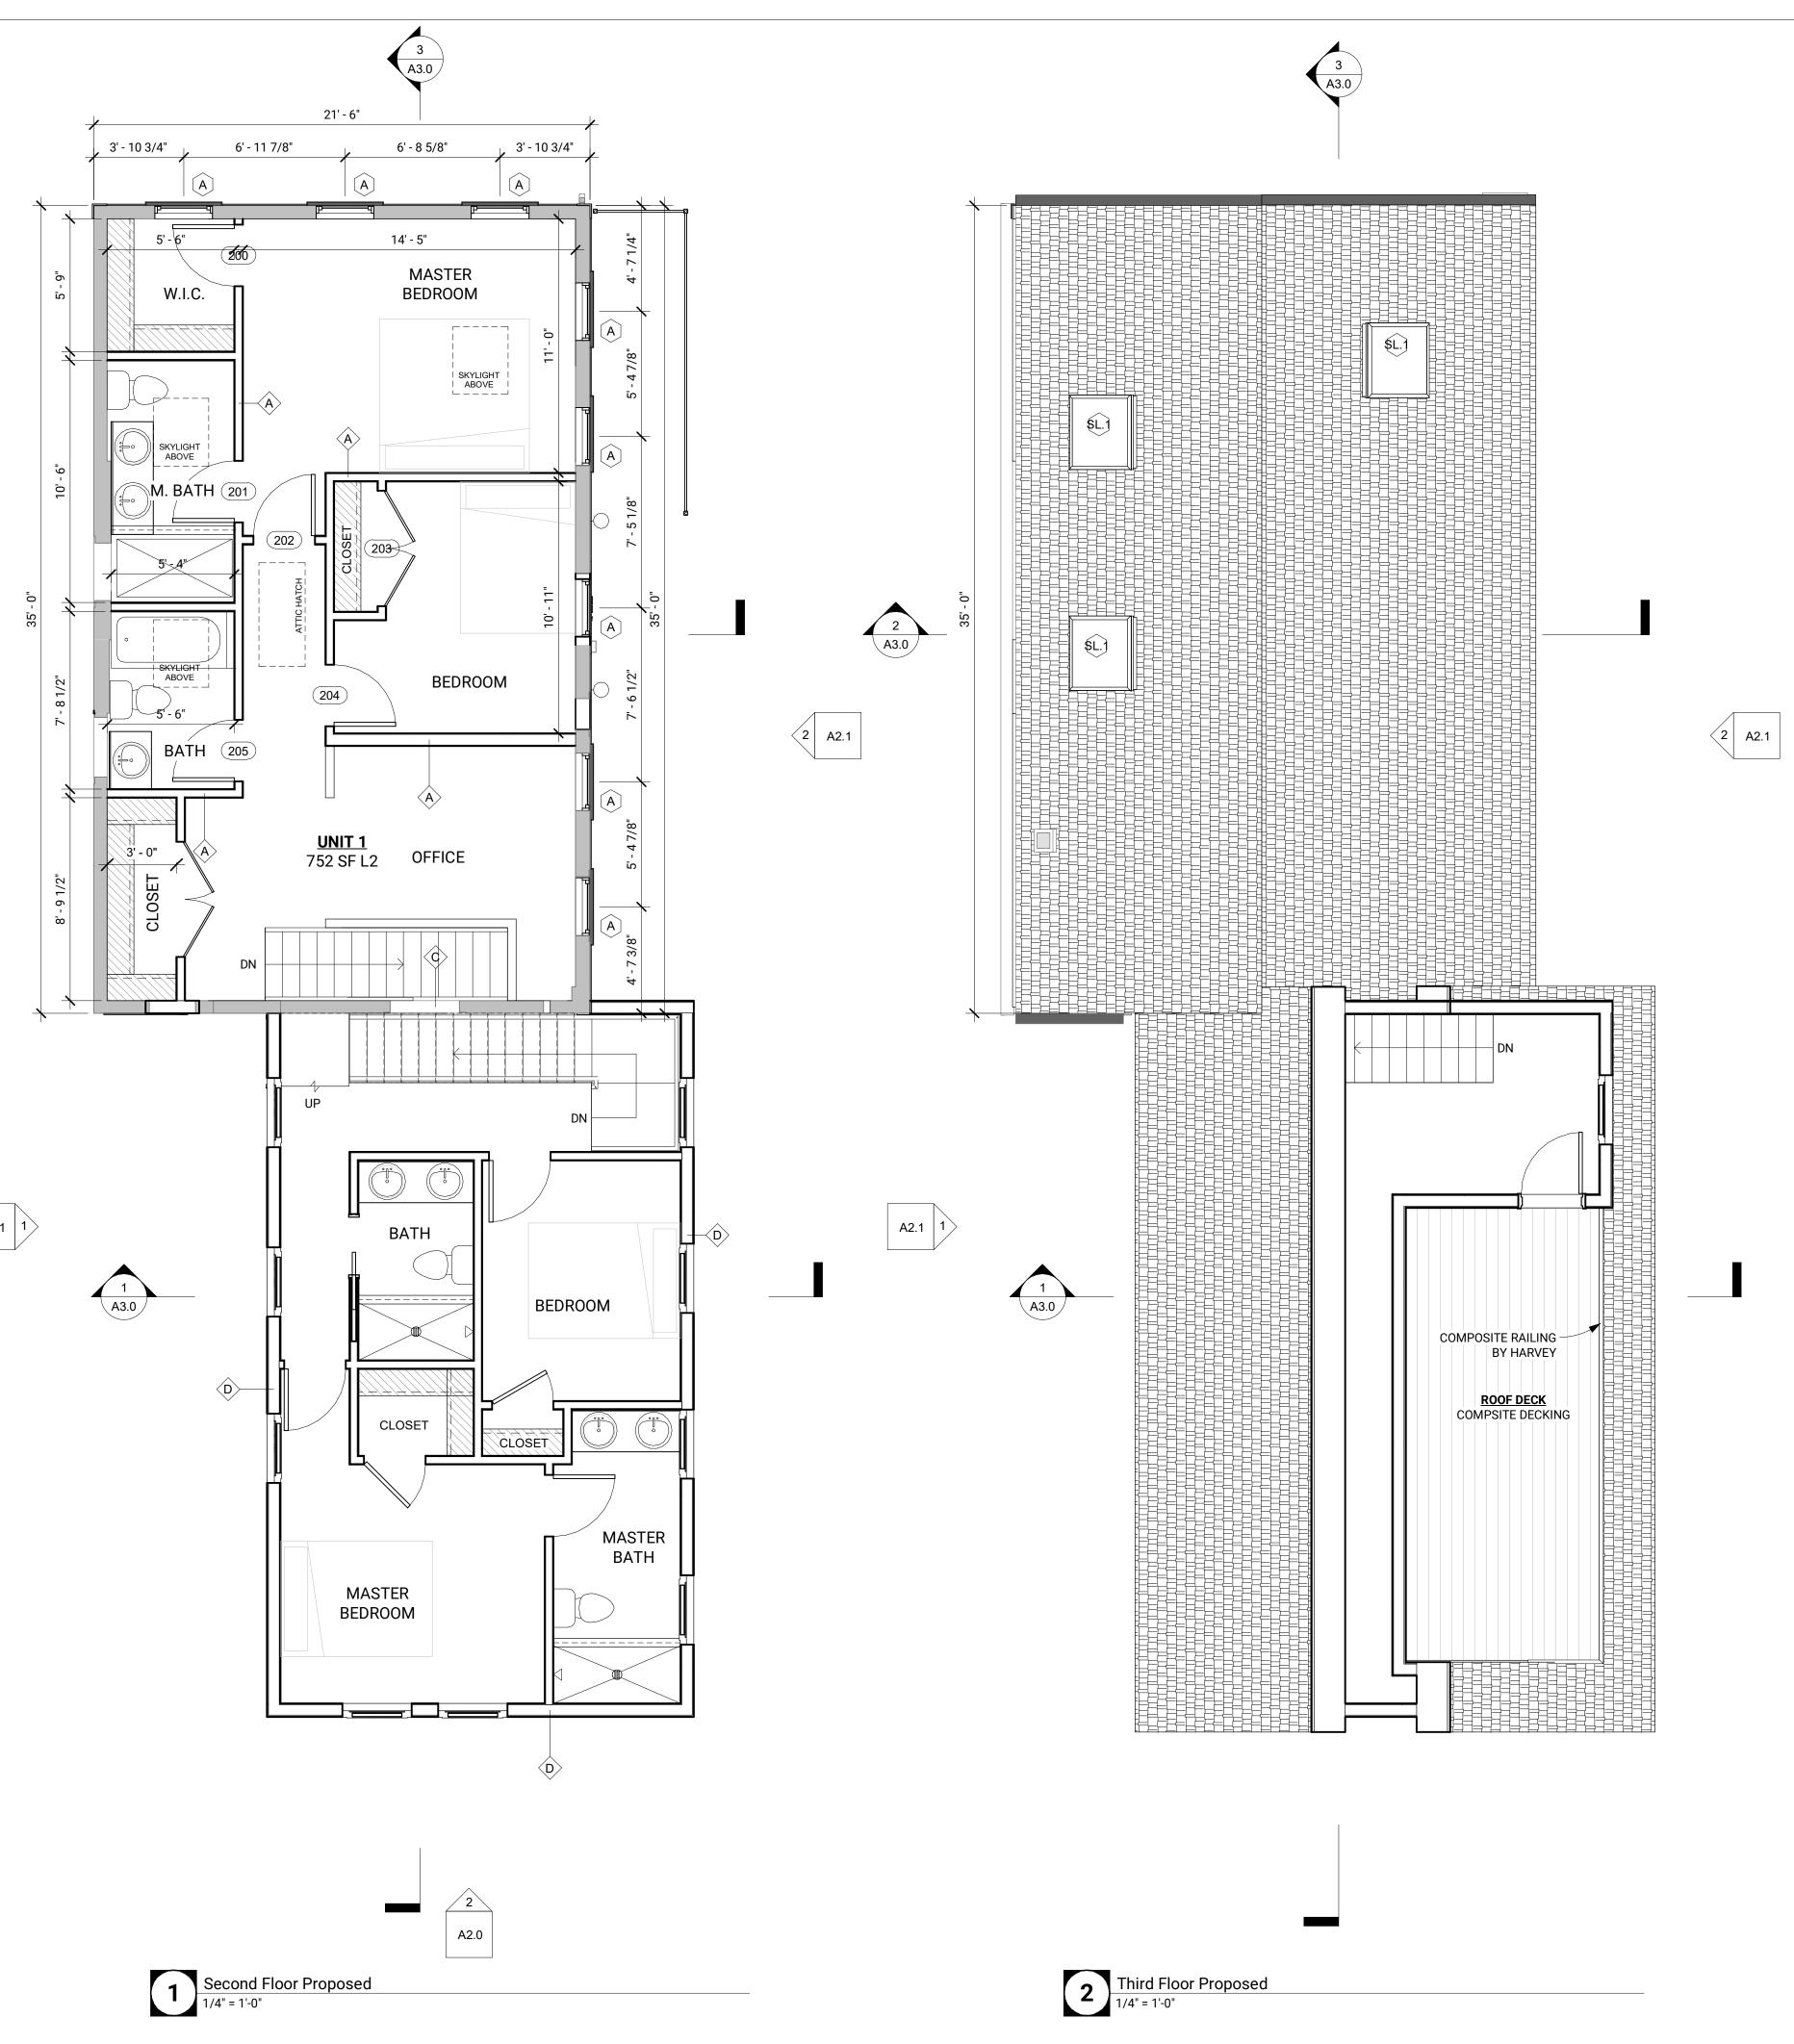



BALANCE ARCHITECTS

617.991.0269 | www.balance-architects.com 197 8th Street, Suite 2000, Boston, MA 02129

PROJECT NAME:

152 CHARLES ST


CLIENT:

KINVARRA CAPITAL PROJECT ADDRESS:

152 CHARLES ST, CAMBRIDGE MA 02141

COPYRIGHT BALANCE ARCHITECTS © 2021 THIS DOCUMENT IS THE SOLE PROPERTY OF BALANCE ARCHITECTS. USE OF THIS DOCUMENT BY THE OWNER FOR THE COMPLETION OF THIS OR OTHER PROJECTS WITHOUT EXPRESS WRITTEN CONSENT IS STRICTLY FORBIDDEN.

Description

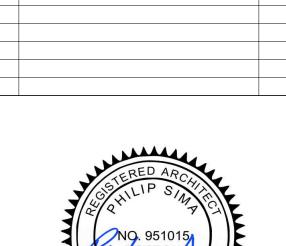


STAMP:


20.038 Project number 4/12/2021 Drawn by JMB Checked by As indicated

SECOND FLOOR & ROOF PLAN


A1.4

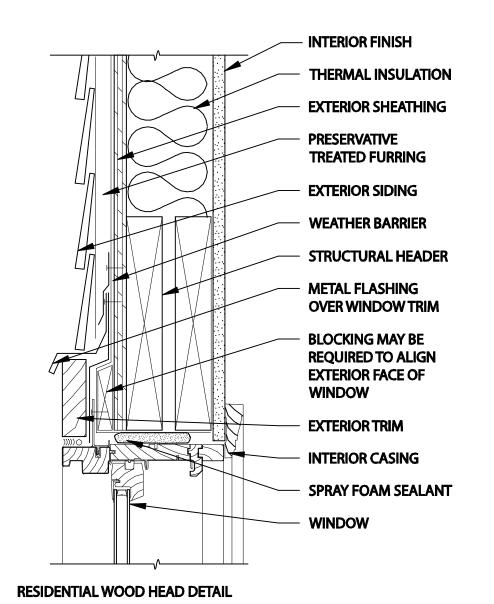




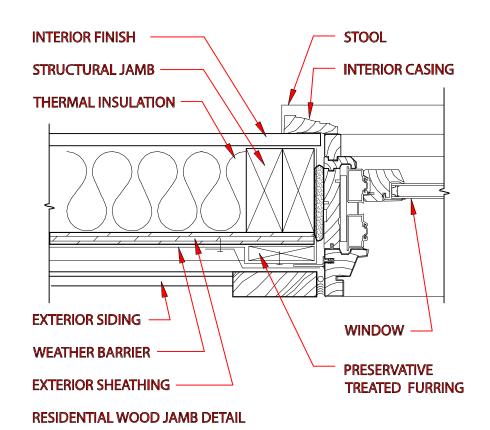




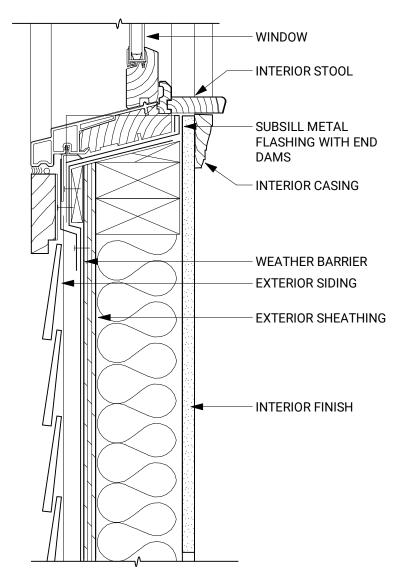



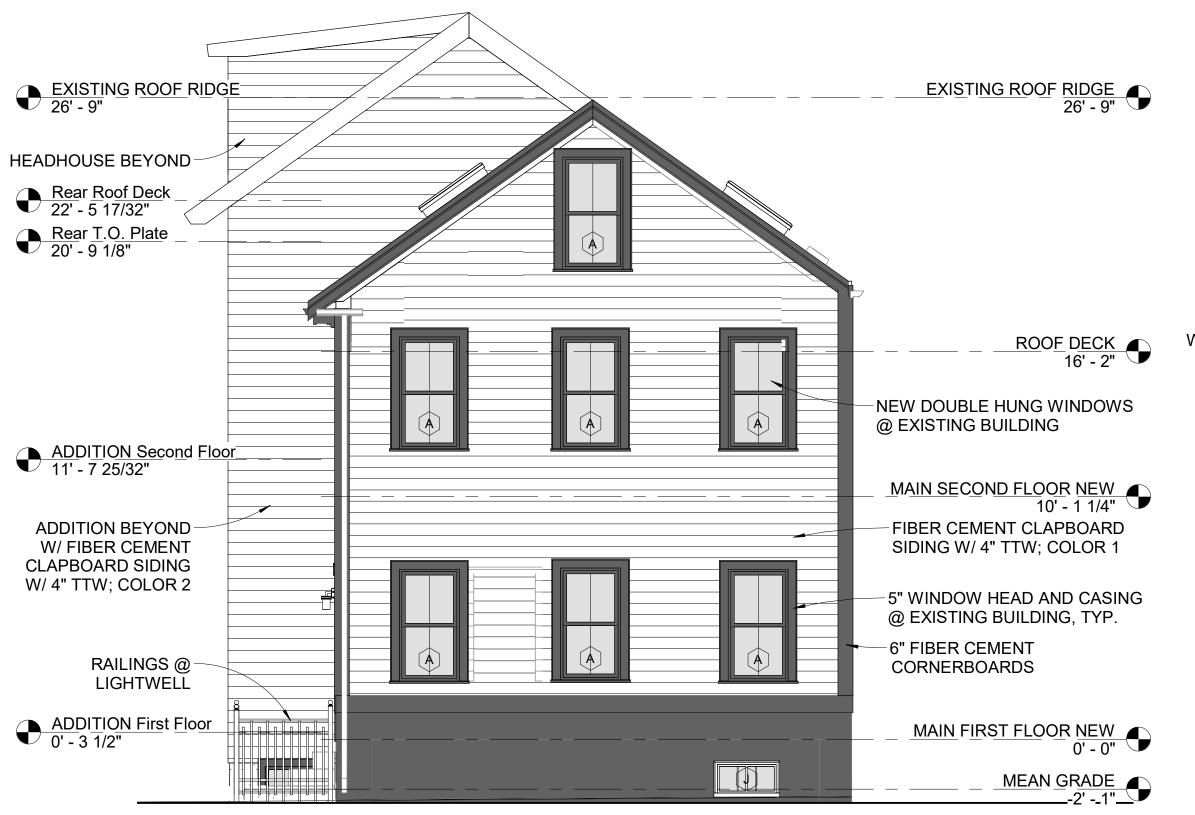



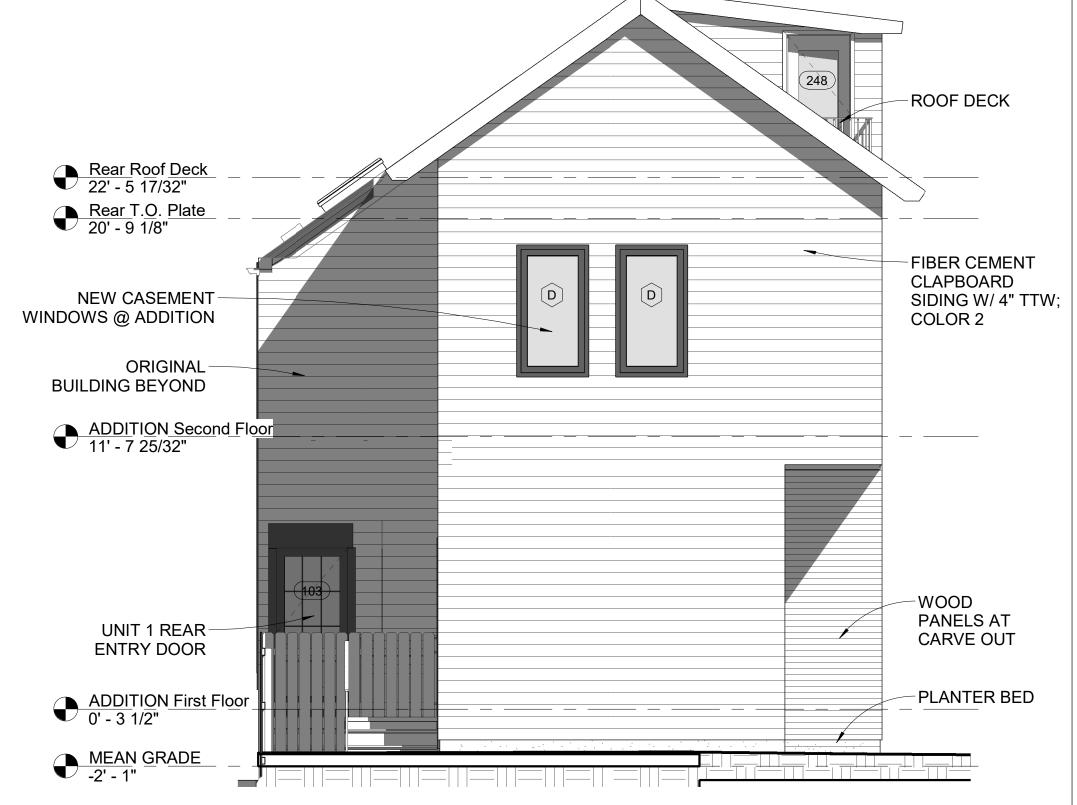

| | | | Window Schedule | |
|--------------|-------------|-------------|--|-------|
| Type Mark | Width | Height | Description | Count |
| A | 2' - 6" | 4' - 8" | ANDERSON TW DOUBLE-HUNG CLAD WITH BLACK RIGID VINYL | 16 |
| D | 3' - 0" | 5' - 6" | ANDERSEN CASEMENT | 13 |
| Н | 3' - 0" | 4' - 0" | ANDERSEN CASEMENT | 9 |
| J | 2' - 9" | 1' - 6" | ANDERSEN FIXED | 1 |
| SL.1 | 3' - 3 1/8" | 3' - 3 1/8" | SKYLIGHT VELUX | 3 |

WINDOW SCHEDULE NOTES:

- 1. ALL WINDOWS TO HAVE HIGH PERFORMANCE, LOW-E GLASS, PAINTED FINISH INSIDE, FULL SCREEN
- 2. INSULATED GLASS TO BE LOW-E WITH ARGON TO MEET ENERGY STAR REQUIREMENTS
- 3. PROVIDE INTERIOR WOOD CASING @ ALL WINDOW LOCATIONS
- 4. WINDOW CONTROL OPENING DEVICES TO BE INSTALLED ON ANY WINDOW WITH A SILL LOWER THAN 24"



BALANCE ARCHITECTS
617.991.0269 | www.balance-architects.com
197 8th Street, Suite 2000, Boston, MA 02129

PROJECT NAME:


152 CHARLES ST

CLIENT:

KINVARRA CAPITAL

PROJECT ADDRESS:152 CHARLES ST, CAMBRIDGE MA 02141

COPYRIGHT BALANCE ARCHITECTS © 2021
THIS DOCUMENT IS THE SOLE PROPERTY OF
BALANCE ARCHITECTS. USE OF THIS DOCUMENT
BY THE OWNER FOR THE COMPLETION OF THIS
OR OTHER PROJECTS WITHOUT EXPRESS
WRITTEN CONSENT IS STRICTLY FORBIDDEN.

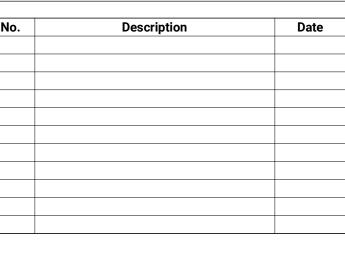



STAMP:

| Project number | 20.038 |
|----------------|--------------|
| Date | 4/12/2021 |
| Drawn by | PS |
| Checked by | PS |
| Scale | As indicated |

ELEVATIONS

A2.0





BA

BALANCE ARCHITECTS
617.991.0269 | www.balance-architects.com
197 8th Street, Suite 2000, Boston, MA 02129

PROJECT NAME:

152 CHARLES ST

CLIENT:

KINVARRA CAPITAL **PROJECT ADDRESS**:

152 CHARLES ST, CAMBRIDGE MA 02141

COPYRIGHT BALANCE ARCHITECTS © 2021
THIS DOCUMENT IS THE SOLE PROPERTY OF
BALANCE ARCHITECTS. USE OF THIS DOCUMENT
BY THE OWNER FOR THE COMPLETION OF THIS
OR OTHER PROJECTS WITHOUT EXPRESS
WRITTEN CONSENT IS STRICTLY FORBIDDEN.

Description

Date


| NO. 951015 BOSTON MA TH OF MASSECTION | |
|--|--|


STAMP:


| Project number | 20.038 |
|----------------|--------------|
| Date | 4/12/2021 |
| Drawn by | Author |
| Checked by | Checker |
| Scale | 1/4" = 1'-0" |

ELEVATIONS


A2.1

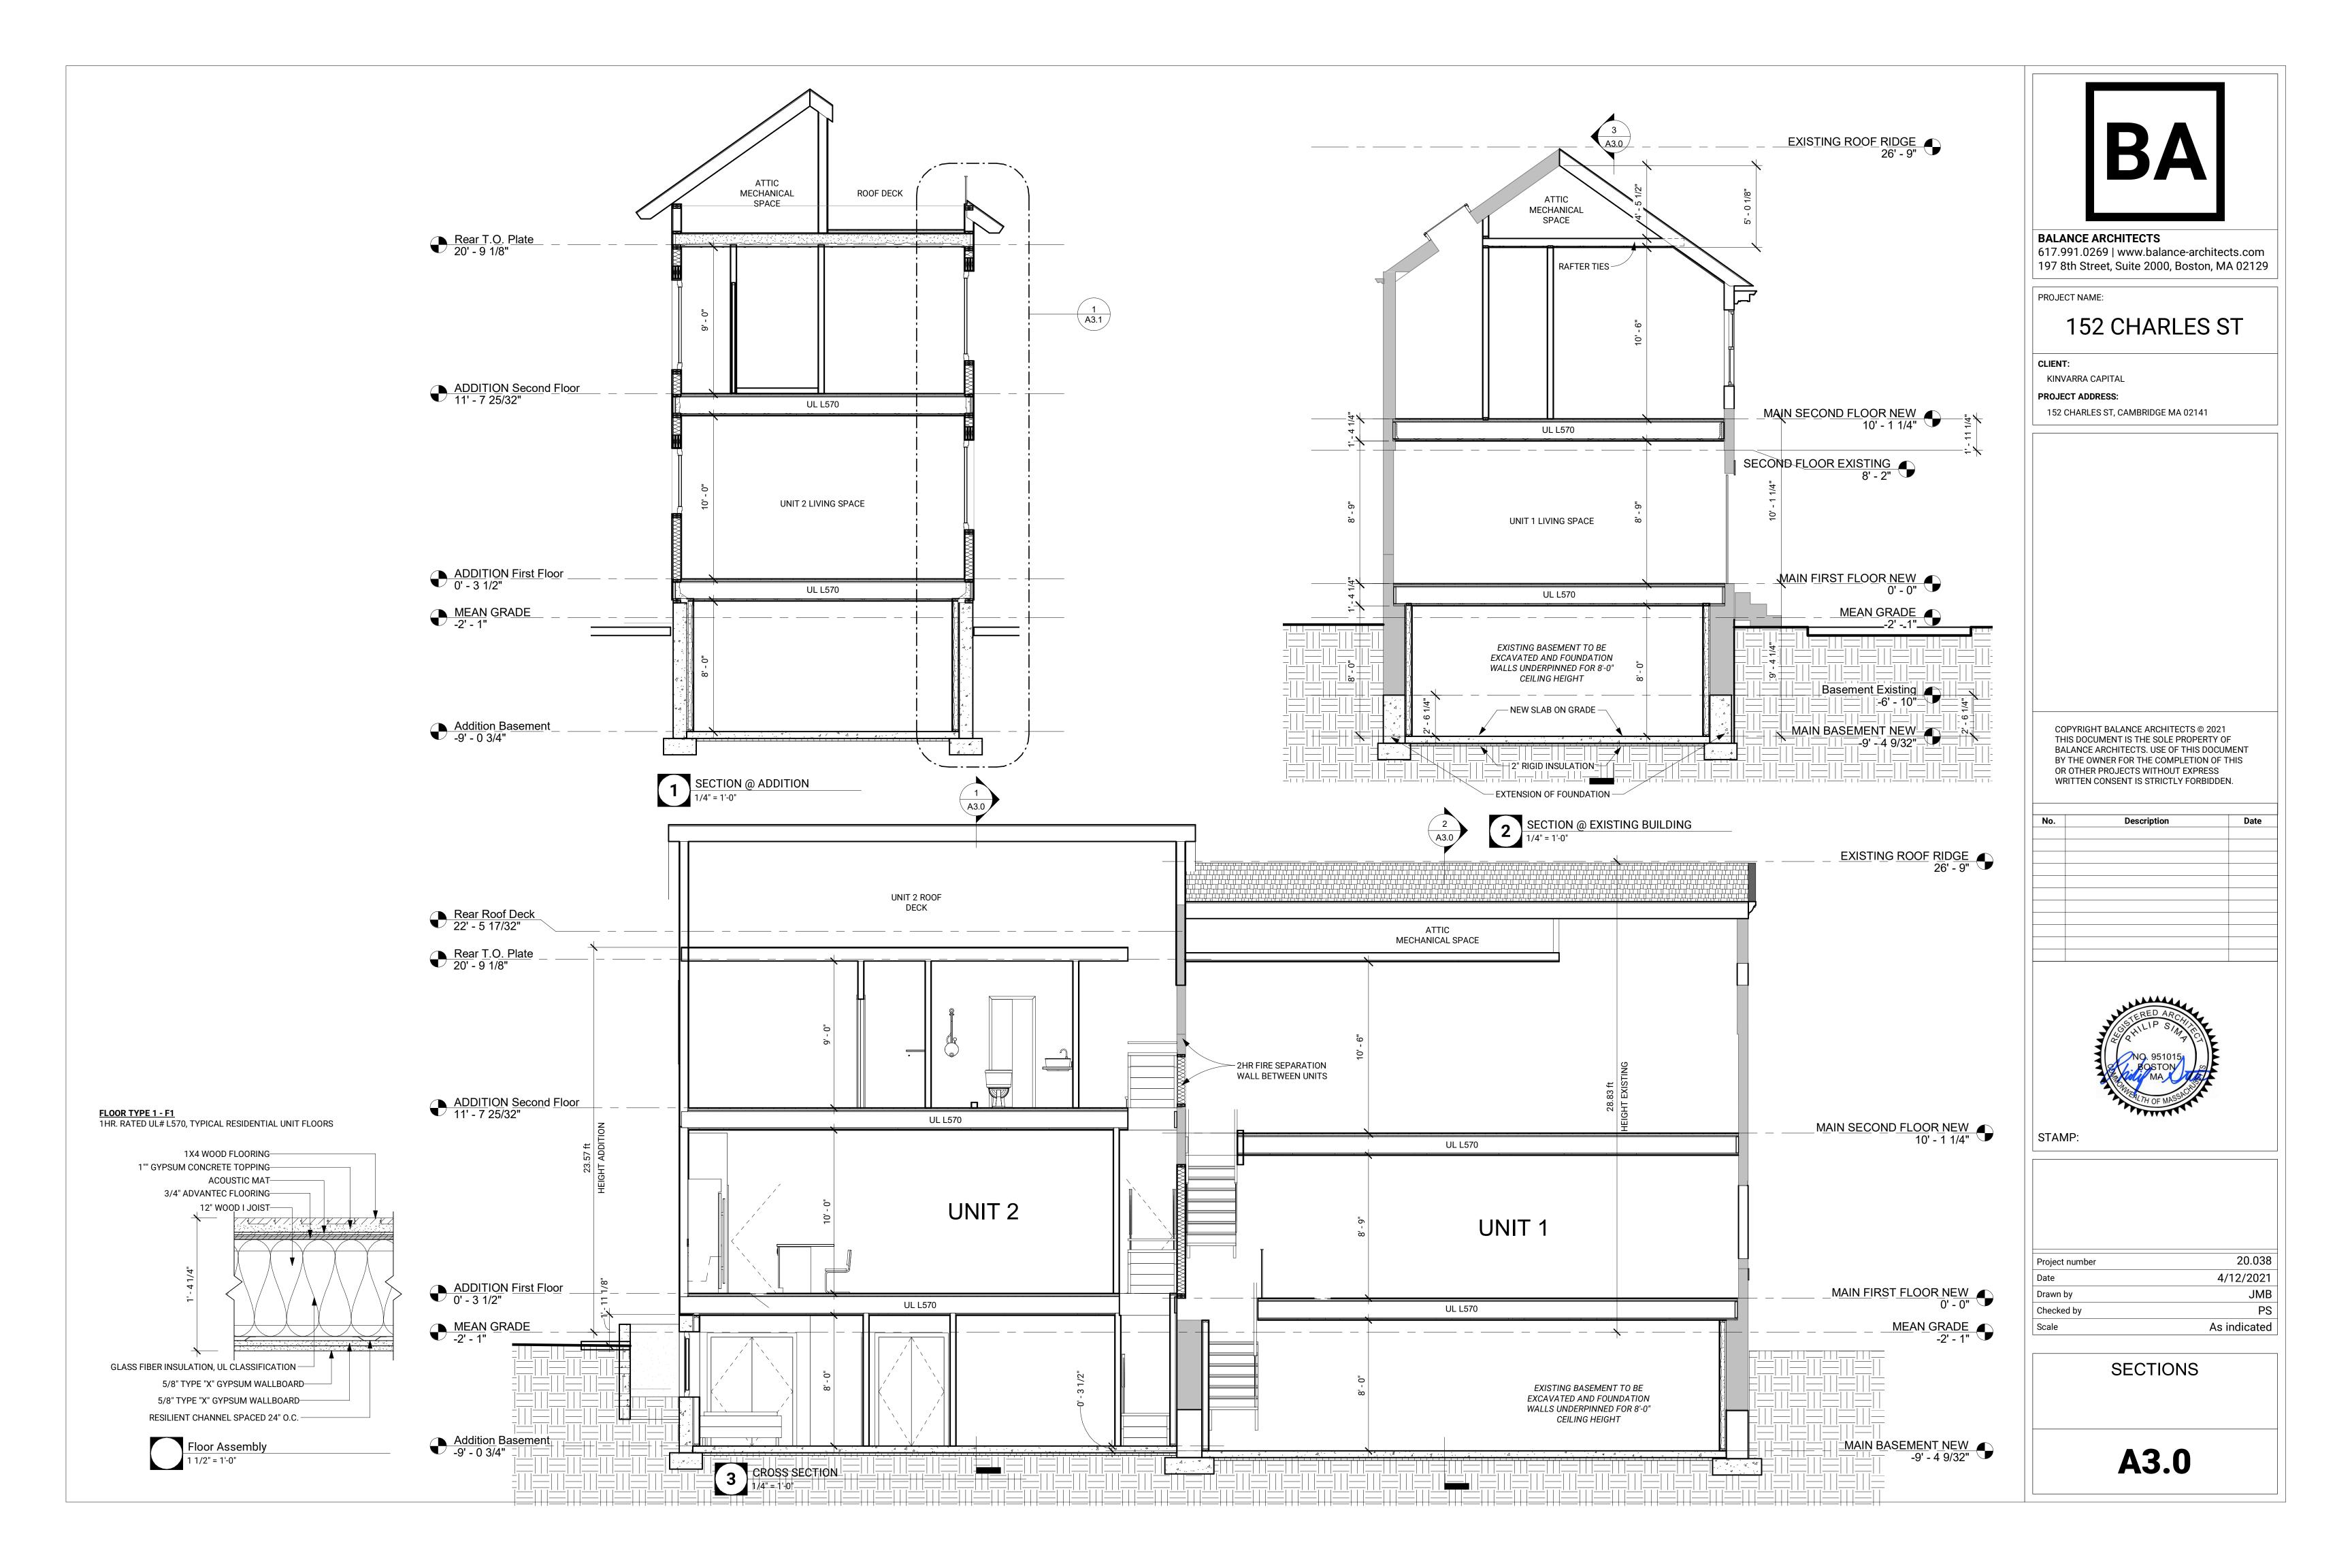


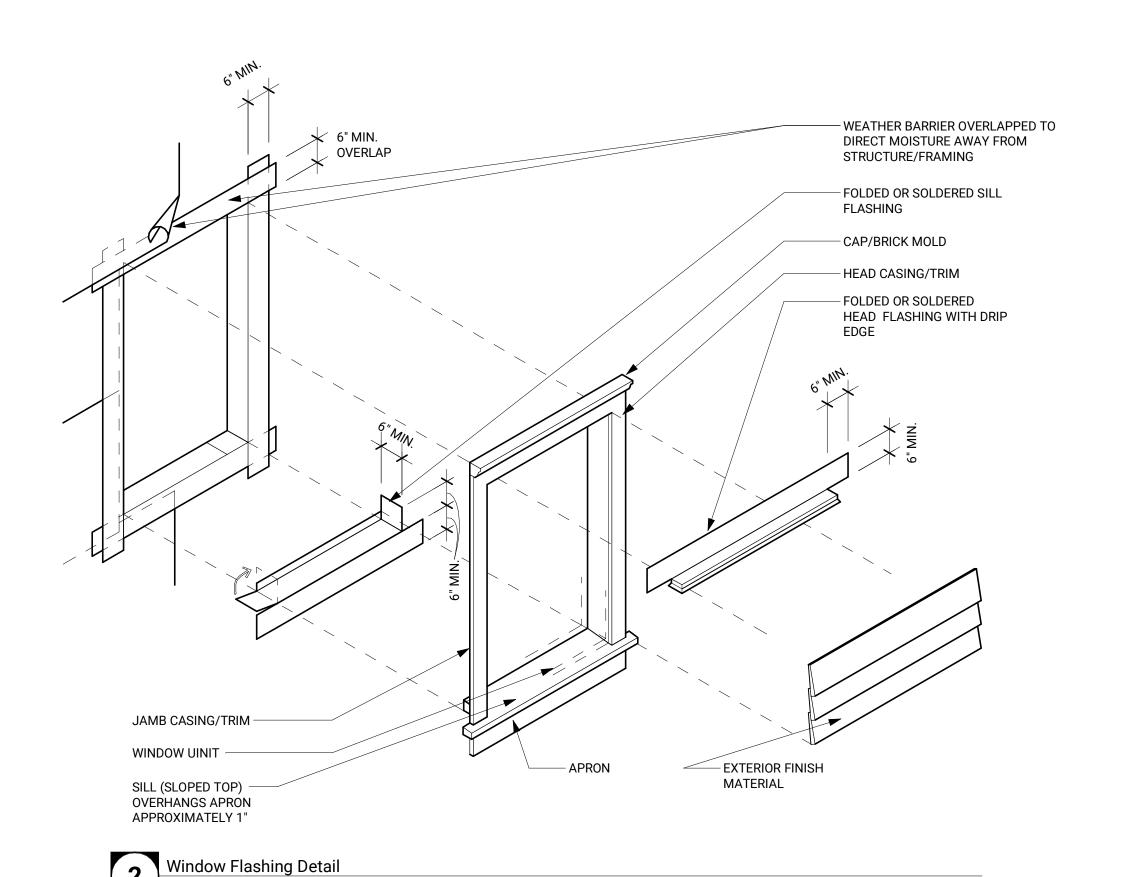

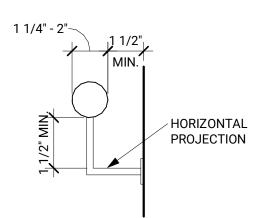



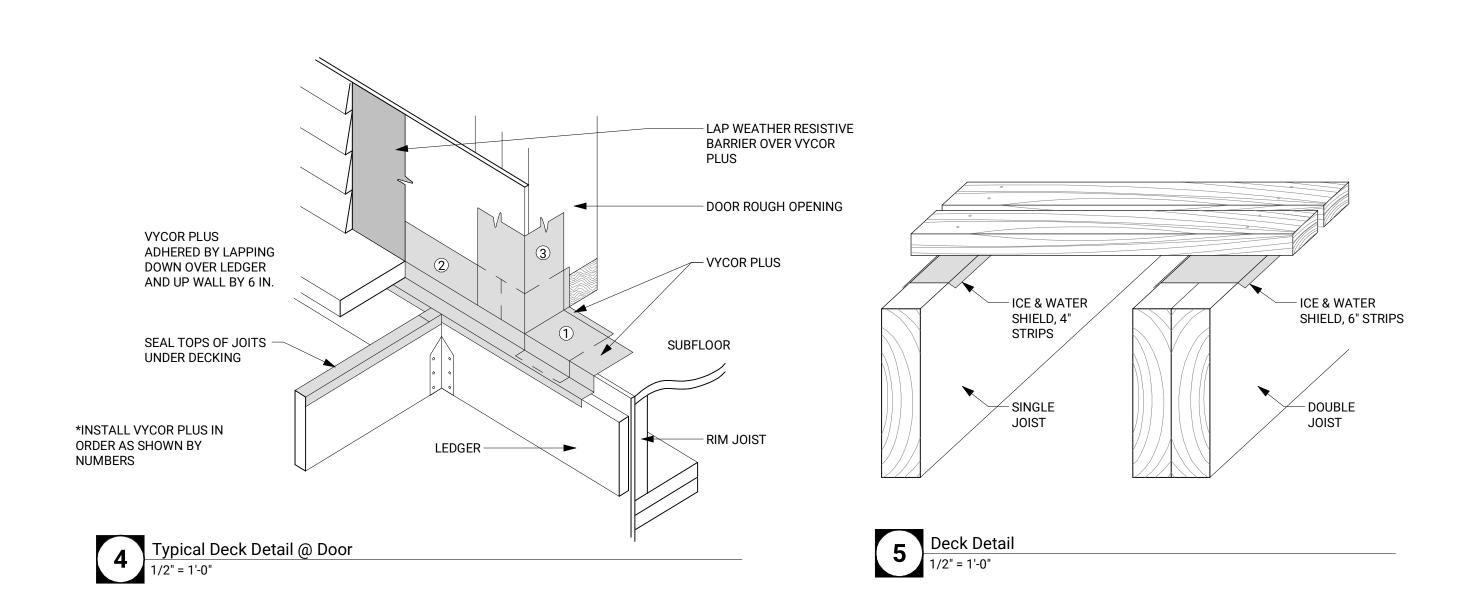

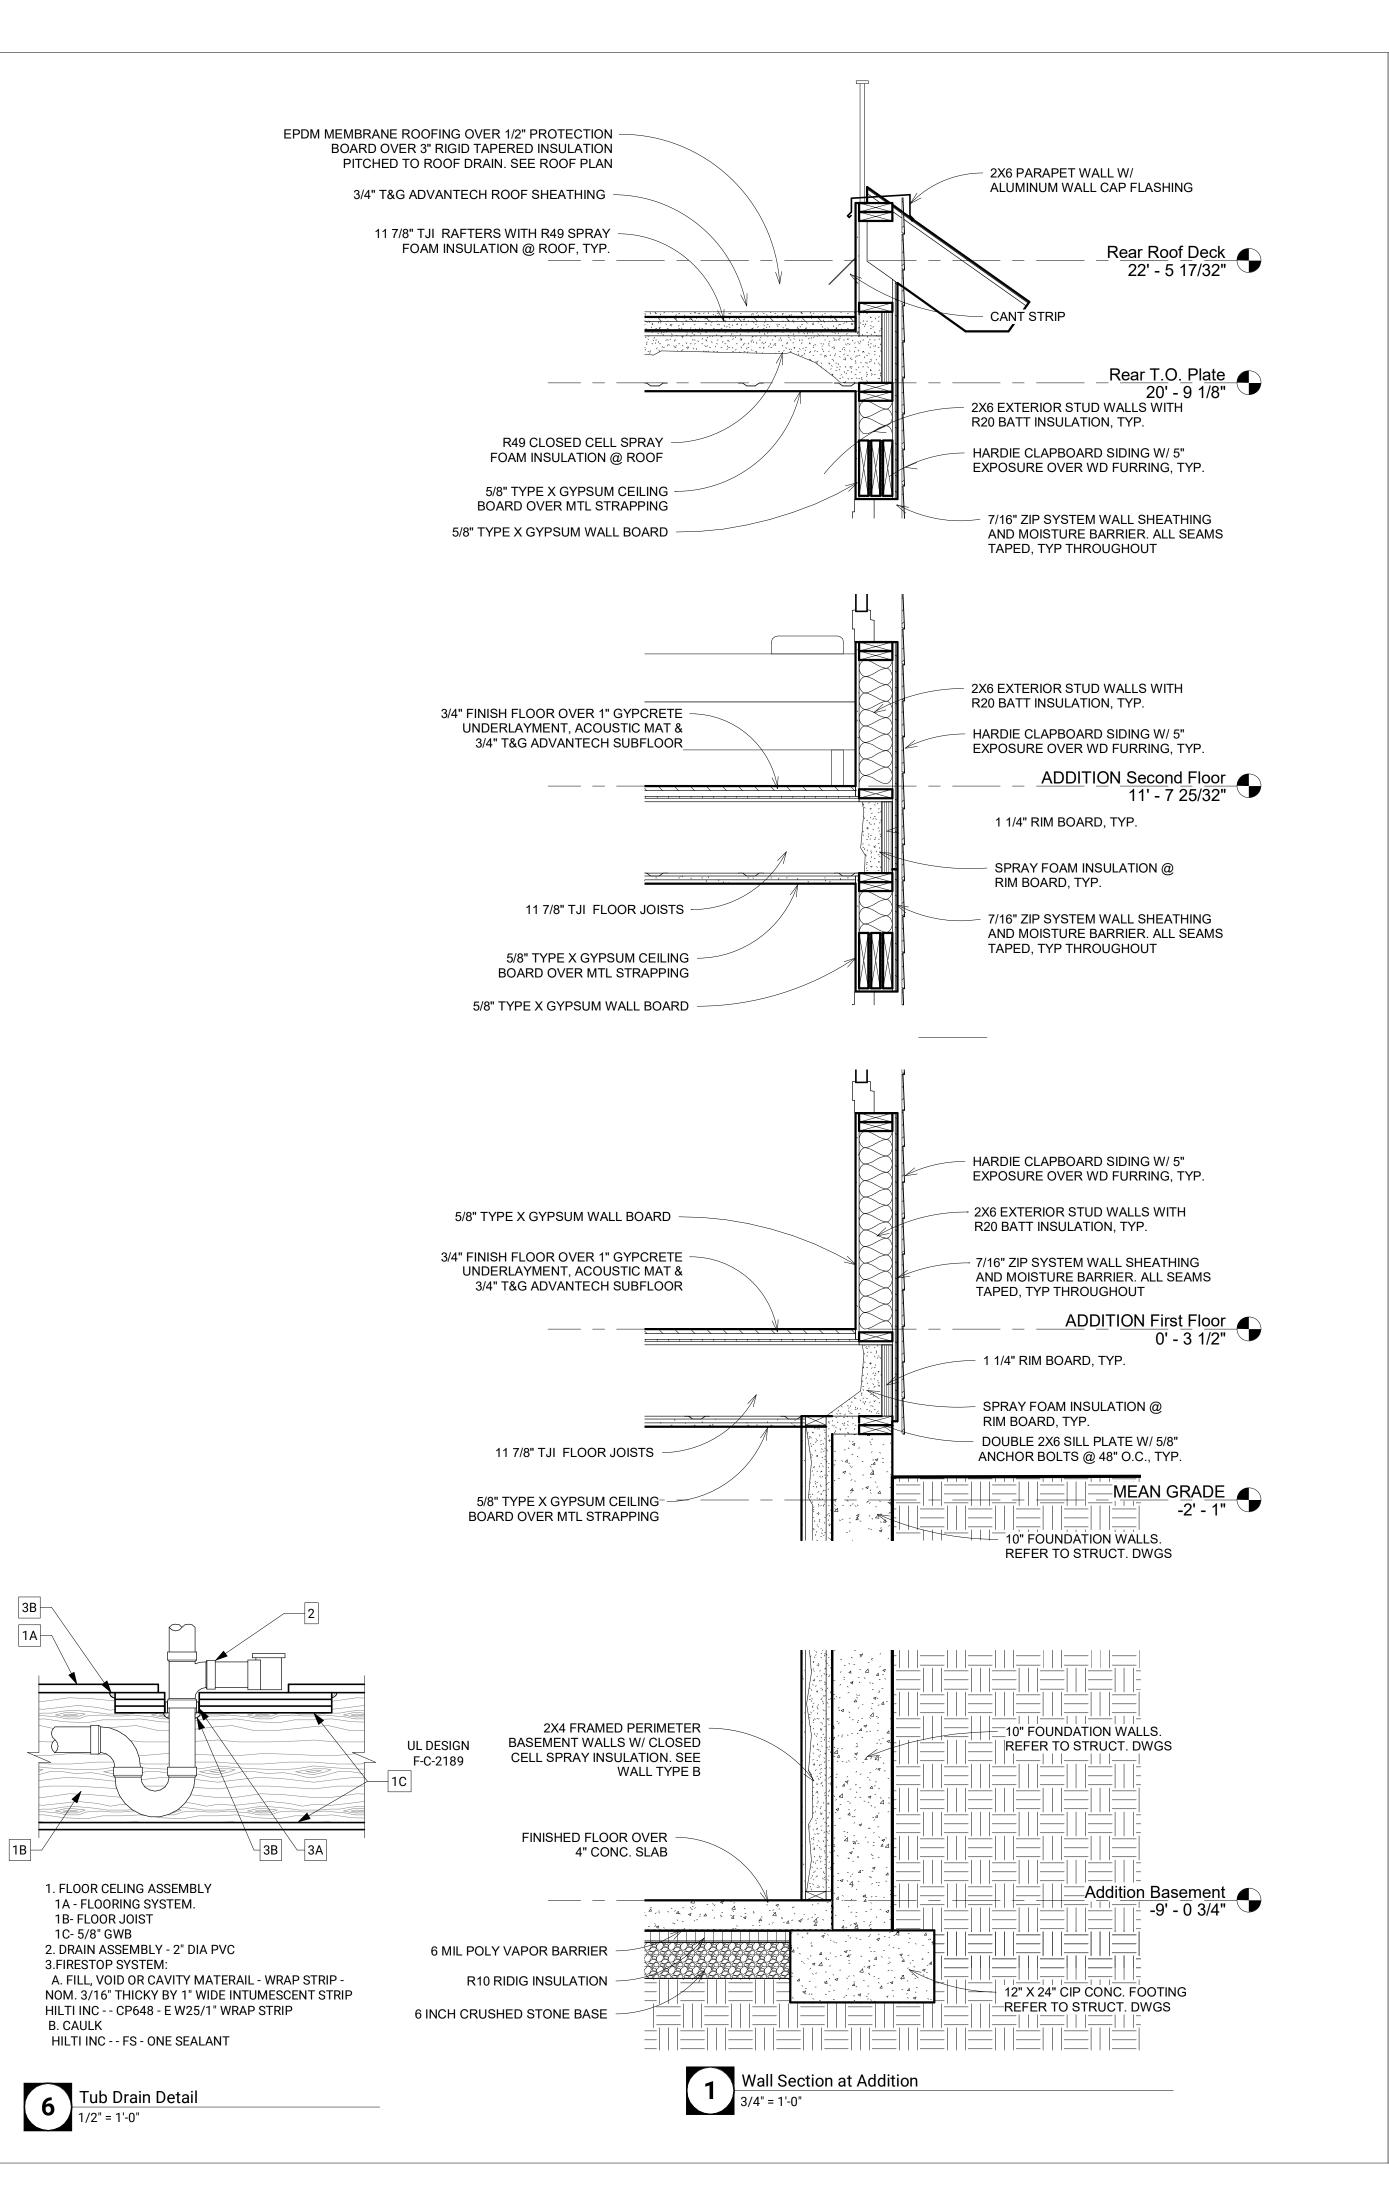



BALANCE ARCHITECTS
617.991.0269 | www.balance-architects.com
197 8th Street, Suite 2000, Boston, MA 02129

PROJECT NAME:

152 CHARLES ST


CLIENT:

KINVARRA CAPITAL

PROJECT ADDRESS:

152 CHARLES ST, CAMBRIDGE MA 02141

COPYRIGHT BALANCE ARCHITECTS © 2021
THIS DOCUMENT IS THE SOLE PROPERTY OF
BALANCE ARCHITECTS. USE OF THIS DOCUMENT
BY THE OWNER FOR THE COMPLETION OF THIS
OR OTHER PROJECTS WITHOUT EXPRESS
WRITTEN CONSENT IS STRICTLY FORBIDDEN.

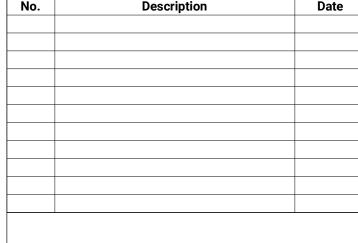




STAMP:

| Project number | 20.038 |
|----------------|--------------|
| Date | 4/12/2021 |
| Drawn by | JMB |
| Checked by | PS |
| Scale | As indicated |

WALL SECTION & DETAILS

A3.1

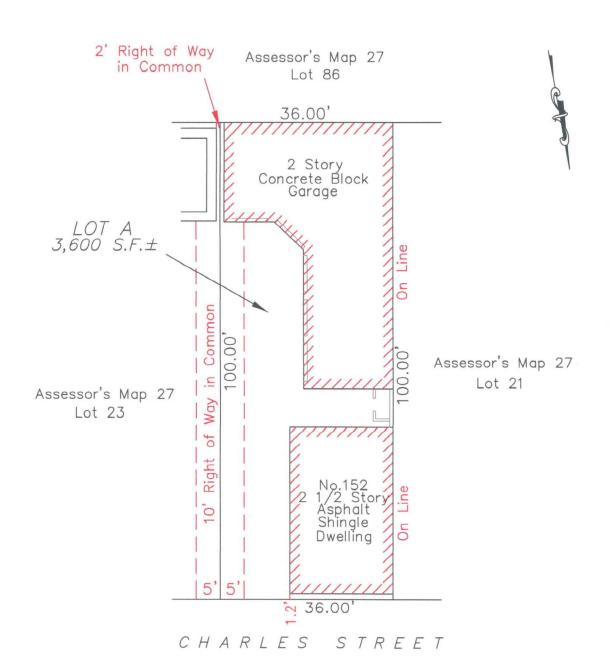



Zoning District: C-1 Deed Reference: Book 62287, Page 174 Assessor's Map 27, Lot 22 Existing Lot Coverage = 60.7% ±

PLOT PLAN OF LAND CAMBRIDGE, MA.

PREPARED FOR:
RYAN WITTIG

152 CHARLES STREET

SCALE: 1"=20' DATE: OCTOBER 27, 2020

DAVID P. TERENZONI, P.L.S. 4 ALLEN ROAD, PEABODY, MA. 01960

S20-082

152 Charles





A Neighborhood Organization for the Betterment of East Cambridge

April 1, 2021

Cambridge Historical Commission 831 Mass Ave, 2nd Floor Cambridge, MA 02139

RE: 152 Charles St (Case #4486)

Dear Cambridge Historical Commission Members and Executive Director Sullivan:

On March 24, 2021, property owner Ryan Wittig of Kinvarra Capital and architect Phil Simahl of Balance Architects, presented a revised proposal to redevelop the property located at 152 Charles St. to the East Cambridge Planning Team (ECPT). The existing site is improved with an 1854 single family home (currently used as a 2-family) and a 5-car garage from the 1930s. The proposal included razing the garage, renovating the existing structure as a single family, and create an additional attached unit in the rear.

The members present remarked the new design was a tremendous improvement over the original design presented at the Cambridge Historical Commission (CHC) on March 4th. Much improved. The new design provides a better continuity between the buildings, but respects the historic significance of the existing building and promotes a more modern look for the additional unit without the "Landed from outer space" look mentioned at the CHC meeting. Specifically, the members present liked:

- Reconfiguring the windows in the original structure so they appear in the historically appropriate
 places and that the new window are period correct.
- Removing the planned roof deck on the original structure.
- Reconfiguring the deck on the new unit as a dormer on a gabled roof.
- Moving the entrance of the second unit to the rear. No longer have to walk by a window of the original home.

After the presentation, the ECPT members present discussed the presentation and voted to support the proposed design as presented. We believe this project will be an asset to the neighborhood. We ask the Cambridge Historical Commission approve a Certificate of Appropriateness for designs for 152 Charles St.

Very truly yours,

50 h

Charles T. Hinds President, ECPT

Luis Barbosa

158/160 Charles Street Cambridge, MA 02141 Ibarbosa0513@gmail.com

1st April 2021

To the Cambridge Historical Commission,

This letter is in regards to the proposed development Case number 4486 for 152 Charles Street, by 152 Charles LLC.

My family and Ryan Witting have been in communication and have met with great understanding twice since the last historical commission meeting.

We discussed our concerns. Ryan explained the old plans during the first meeting. The second meeting about a week ago we were able to see the new plans which address the fence and the porch for privacy. Ryan has been nothing but kind and courteous.

Previous areas of concern:

- 1. Existing house -- The existing house has no additional windows or change in height. This was clarified at our first meeting with Ryan.
- 2. Demolition of garages and height of new dwelling--The set back was clarified for us as $7 \frac{1}{2}$ feet. We understand this to be the minimum by the city. This does allow for space between our properties which is very helpful. The set back of $7 \frac{1}{2}$ feet helps with the height of the new dwelling to not feel as if the new dwelling is right on top of us.
- 3. Fence--The fence has been agreed upon in regards to height, length, and type of material. We agreed it will mimic mostly the privacy that exists now. This was our major concern and it was easily agreed on. We all came to the understanding that privacy will benefit us as well as the new owners of the property. This will continue to allow our children and pets to roam free on our property.
- 4. Windows of new dwelling:-- There are 2 exit doors and windows on the new dwelling facing our property but the bottom exits and windows will be mostly blocked by the fence. The top windows are in the bedrooms and a staircase which was clarified.

- Roof deck to new dwelling: The roof deck has been changed to face into their property which was a very unexpected change and much appreciated by our family as a whole. This truly addresses the privacy concerns we had.
- 6. Sun/shadow: Ryan reviews the shadow study with us. This was also something very unexpected. This allowed us to easily visualize our property in regards to shadow. There will not be a shadow cast on our property because of the 7 ½ set back to the new dwelling unit. This was very helpful and put us at ease. This left us in a place where we do not have to wait and see what it will be like once the property is finished.

Ryan is committed to keep in contact with us during the construction. Ryan understands our concerns for the safety of our children and pets during construction, especially during the summer months.

We were not looking to be appeased or be difficult as a family. Ryan was understanding and made it easy to voice our concerns.

The new plan addresses our concerns!

The Barbosa family are in agreement and approve of the second plans that were shown to us last week. We hope the best for Ryan and his team during construction.

Sincerely,

Luis Barbosa and the entire family. 158/160 Charles Street Cambridge 02141 Ibarbosa0513@gmail.com



CAMBRIDGE HISTORICAL COMMISSION

831 Massachusetts Avenue, 2nd Fl., Cambridge, Massachusetts 02139 Telephone: 617 349 4683 Fax: 617 349 3116 TTY: 617 349 6112 E-mail: histcomm@cambridgema.gov URL: http://www.cambridgema.gov/Historic

Bruce A. Irving, *Chair*, Susannah Barton Tobin, *Vice Chair*; Charles M. Sullivan, *Executive Director* Joseph V. Ferrara, Chandra Harrington, Elizabeth Lyster, Caroline Shannon, Jo M. Solet, *Members* Gavin W. Kleespies, Paula A. Paris, Kyle Sheffield, *Alternates*

CERTIFICATE OF APPROPRIATENESS

Property:

152 Charles Street

Applicant:

152 Charles LLC

Attention:

Ryan Wittig

Kinvarra Capital

10 Overlook Ridge Dr. #330

Malden, Mass. 02148

The Cambridge Historical Commission hereby certifies, pursuant to the Massachusetts Historic Districts Act (MGL Ch. 40C) and the Cambridge Historical Buildings and Landmarks Ordinance (Cambridge City Code, Ch. 2.78), that the work described below is not incongruous to the historic aspects or architectural character of the building or district:

- 1. Renovate the existing two-family house as a single-family house
- 2. Demolish the existing five-bay garage at the rear of the lot
- 3. Construct an attached single-family townhouse in the rear of the lot

Work is to be carried out as indicated on the plans by Balance Architects titled, "152 Charles Street," and dated March 20, 2021.

Approval was granted on the following conditions,

- 1. That the window pattern on the historic front house be 2-over-2 double hung sash
- 2. That the construction details including the cladding and trim of the front unit be delegated to the staff for review and approval
- 3. That the final height and width of the rear unit be delegated to the staff for review and approval


All improvements shall be carried out as shown on the plans and specifications submitted by the applicant, except as modified above.

Certificate of Appropriateness, page 2

Approved plans and specifications are incorporated by reference into this certificate.

This certificate is granted upon the condition that the work authorized herein is commenced within six months after the date of issue. If the work authorized by this certificate is not commenced within six months after the date of issue, or if such work is suspended in significant part for a period of one year after the time the work is commenced, then this certificate shall expire and be of no further effect; provided that, for cause, one or more extensions of time, for periods not exceeding six months each, may be allowed in writing by the Chair.

| Case Number: 4486 | Date of Certificate: April 13, 2021 |
|--|---|
| Attest: A true and correct copy of offices of the City Clerk and the on April 13, 2021 | of decision filed with the e Cambridge Historical Commission |
| By <u>Susannah B. Tobin/slb</u> , Vic | e Chair. |
| ***** | ********* |
| Twenty days have elapsed since the | ne filing of this decision. |
| No appeal has been filed | . Appeal has been filed |
| Date | , City Clerk |

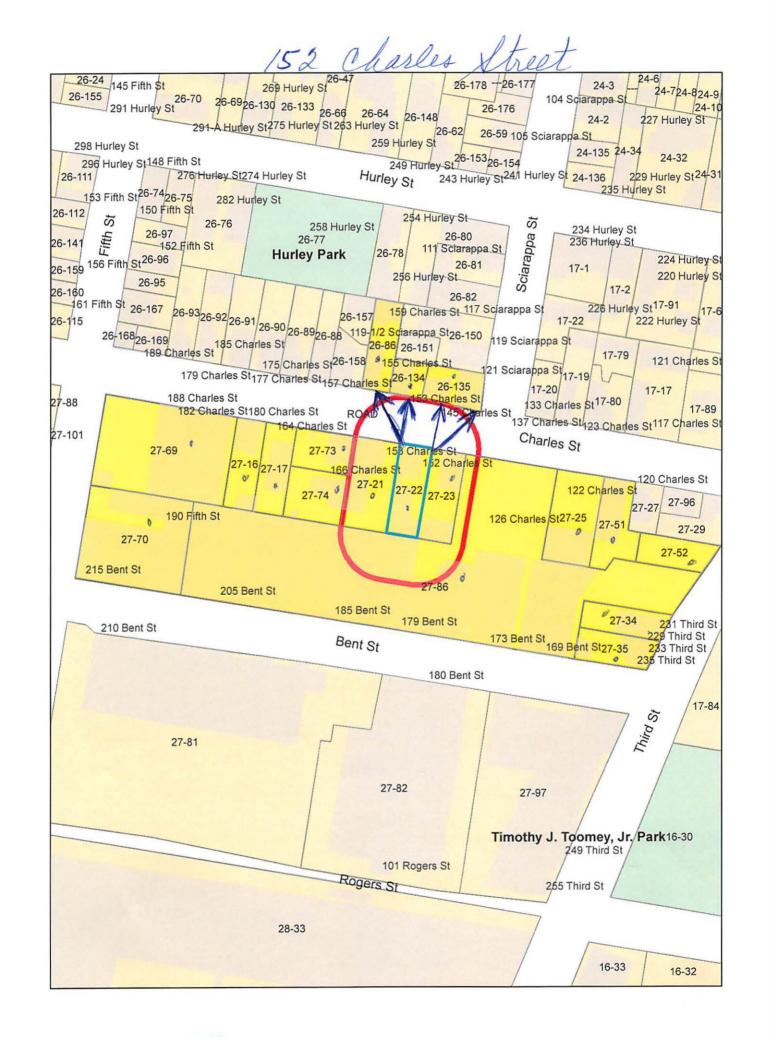

152 Clarles XX.

26-134 MCLAUGHLIN, BRYAN L. & REBECCA M. E. MCLAUGHLIN 135 CAMBRIDGE ST CAMBRIDGE, MA 02141

27-86
LOHNES, PAUL R.,
TR. OF THE ALEXANDER GRAHAM BELL TRUST
C/O LAVERTY / LOHNES PROP,
75 CAMBRIDGE PKWY, STE 100
CAMBRIDGE, MA 02142-1229

27-73 FARIA, ROBERT M. & ISABEL M. FARIA 164 CHARLES ST. CAMBRIDGE, MA 02141

27-70
BASS ROCKS REALTY LLC
75 CAMBRIDGE PARKWAY, SUITE 100
CAMBRIDGE, MA 02142

27-51 LIU, QIANG & YUNSI FEI 110 HAWTHORN AVE NEEDHAM, MA 02492

27-51 PETPRAYOON, PATCHANEE 124 CHARLES ST., #3 CAMBRIDGE, MA 02141

27-51 PETPRAYOON, PATCHANEE 122 CHARLES ST. UNIT#3 CAMBRIDGE, MA 02141

26-135 CAO, GUILIANG & JIANG QIAN 121 SCIARAPPA ST #2 CAMBRIDGE, MA 02139

26-86 BREML PARTNERS LLC 153 CHARLES ST - APT 2 CAMBRIDGE, MA 02141 27-17 LEUNG, HONG C. TRUSTEE OF THE HONG C. LEUNG REVOC TR. 56 POTTER POND LEXINGTON, MA 02421

27-16 GOULD, JONATHAN BARING 130 LINCOLN ST NEWTON, MA 02461

27-74
WHELAN, CHERYL, SAID ROCCO DIBIASE &
DOLORES DIBIASE, TRUSTEE
166 CHARLES ST
CAMBRIDGE, MA 02141

26-135 FONTELLA, MARY K. 121 SCIARAPPA ST., UNIT #1 CAMBRIDGE, MA 02141

26-135 CARAVELLA, JUSTIN A. 121 SCIARAPPA ST., #3 CAMBRIDGE, MA 02141

27-51 JEN, SHANG 124 CHARLES ST., #2 CAMBRIDGE, MA 02141

27-35 HAMOUDA, OMAR & BETSEY B. PRICE 235 THIRD ST CAMBRIDGE, MA 02141

27-34 231 THIRD STREET LLC C/O DND HOMES LLC 271 LINCOLN ST. SUITE 10 LEXINGTON, MA 02421

27-21 BARBOZA, LUIS F. & MARIA E. BARBOZA 160 CHARLES ST CAMBRIDGE, MA 02141-2118 27-22 152 CHARLES ST LLC C/O MATTHEW MOORE 10 OVERLOOK RIDGE DR - #330 MALDEN, MA 02148

SULLIVAN & WORCESTER LLP C/O JENNIFER R. SCHULTZ, ESQ. ONE POST OFFICE SQUARE BOSTON, MA 02109

27-69
KAGNO, N. IRA, SAMUEL GONDELMAN TRUSTEE
& CITY OF CAMBRIDGE TAX TITLE
188 CHARLES ST
CAMBRIDGE, MA 02141

27-51 ADAMOWICZ, ALEX 122 CHARLES ST., #1 CAMBRIDGE, MA 02141

27-23 ESPOSITO, GERARDO & ADRIANA TRS OF THE ESPOSITO REALTY TRUST 146 CHARLES ST UNIT #1 CAMBRIDGE, MA 02141

27-51 ZHANG, QIAN 122-124 CHARLES ST., #124/1 CAMBRIDGE, MA 02141

27-52 KENTON SCOTT 152 VASSAL LN CAMBRIDGE, MA 02138


27-23 DEFABIO, GRAZIA E. TRUSTEE 33 BAY VIEW TERRACE DANVERS, MA 01923

27-25 1ST CHARLES STREET LLC, C/O GLANZ PROPERTIES, INC. 1018 BEACON ST BROOKLINE, MA 02446





May 24, 2021

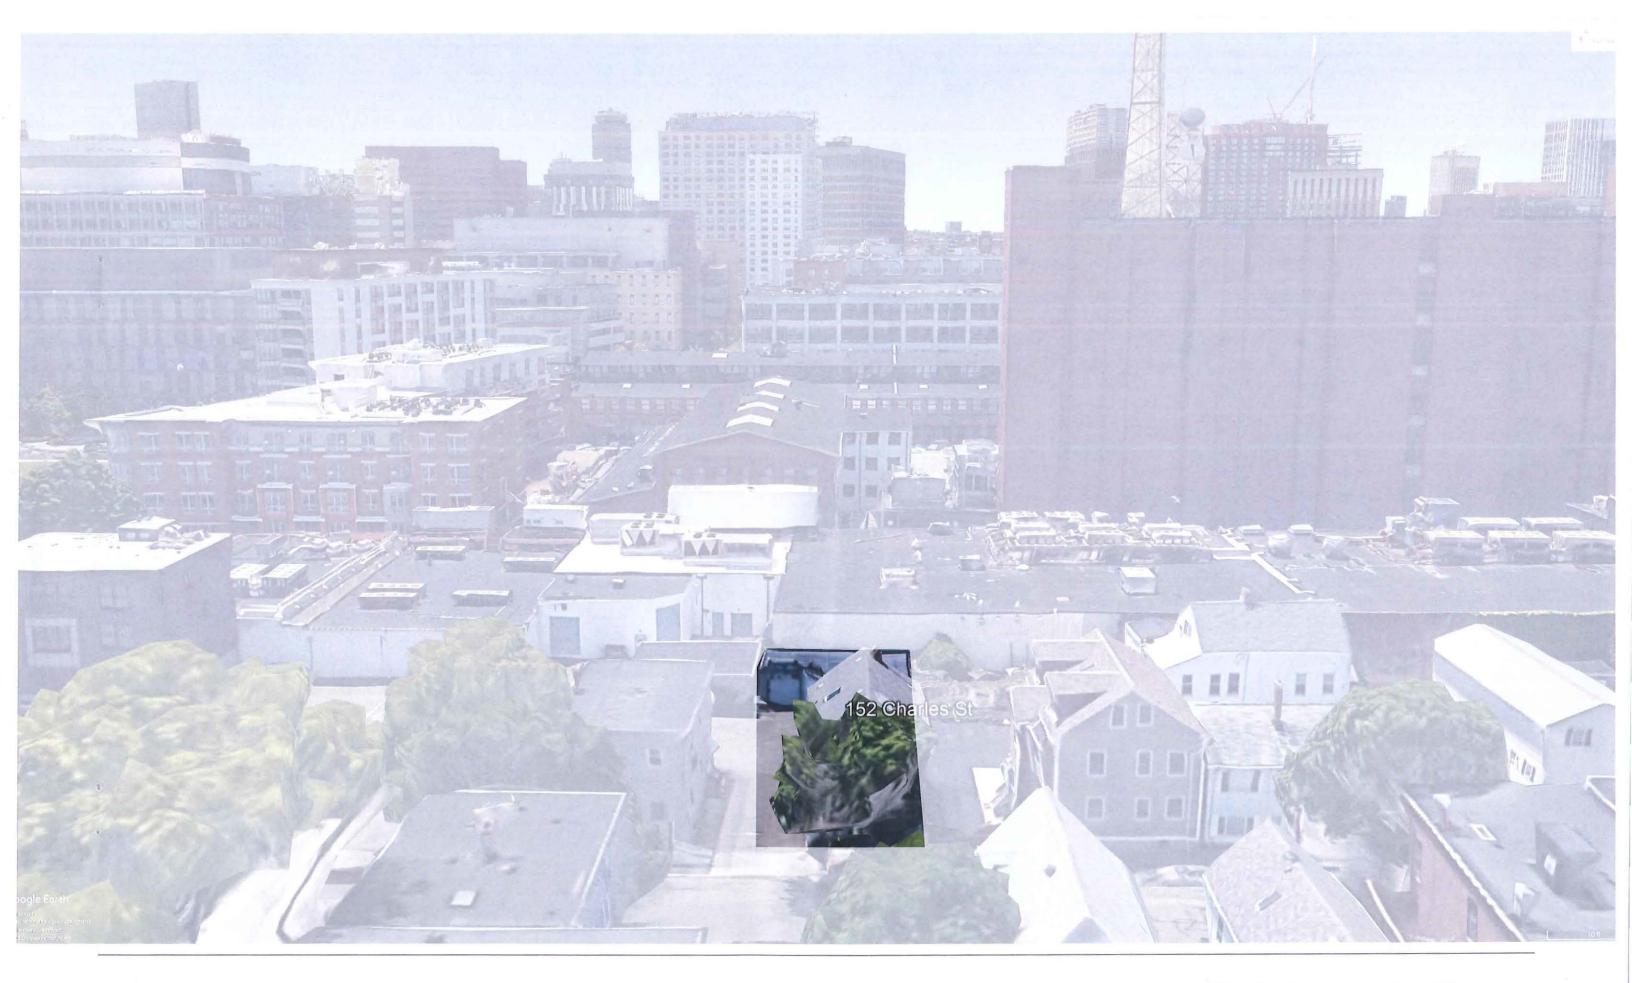

May 24, 2021












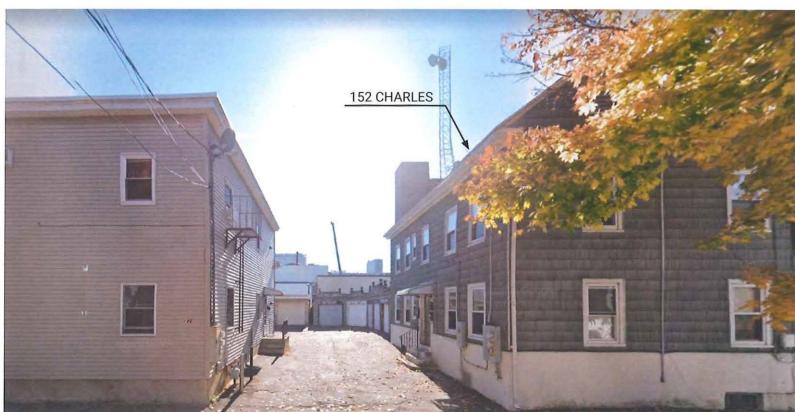









"LANDED FROM OUTER SPACE"

"HORRIBLE"

"ROOF DECKS AREN'T ACTUALLY USED"

"SNORKEL TO THE ROOF"

"CRAMPED ENTRANCE"

"NO CONTINUITY OR RELATIONSHIP BETWEEN BUILDINGS"



- REMOVED ROOF DECK FROM EXISTING BUILDING
- SIMILAR FENESTRATION RHYTHM, DIFFERENT FENESTRATION TYPE
- SNORKEL IS A DORMER
- CARRIED ACROSS SIDE YARD ROOF LINES BETWEEN BUILDINGS
- REAR ROOF DECK ORIENT AWAY FROM 158 CHARLES MORE PRIVACY
- FENCE BETWEEN 152 & 158 CHARLES


- UNIT 2 ENTRANCE MOVED TO REAR
- UNIT 2 FOOT PRINT SIMPLIFIED (REMOVED JOGS)
- UNIT 1 DEDICATED OUTDOOR AREA
- MOVED STAIRS AWAY FROM WINDOWS

BALANCE ARCHITECTS

May 24, 2021







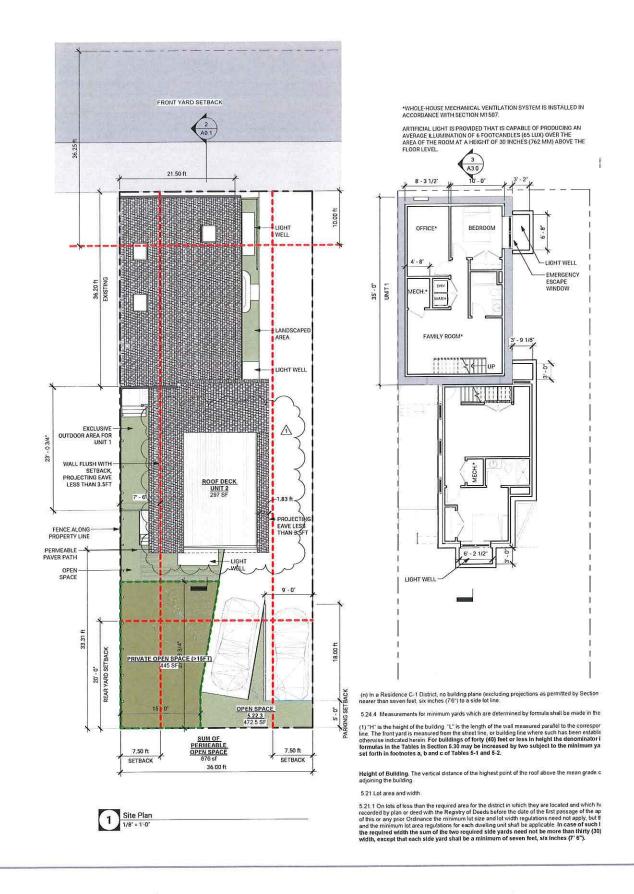


BALANCE BA ARCHITECTS



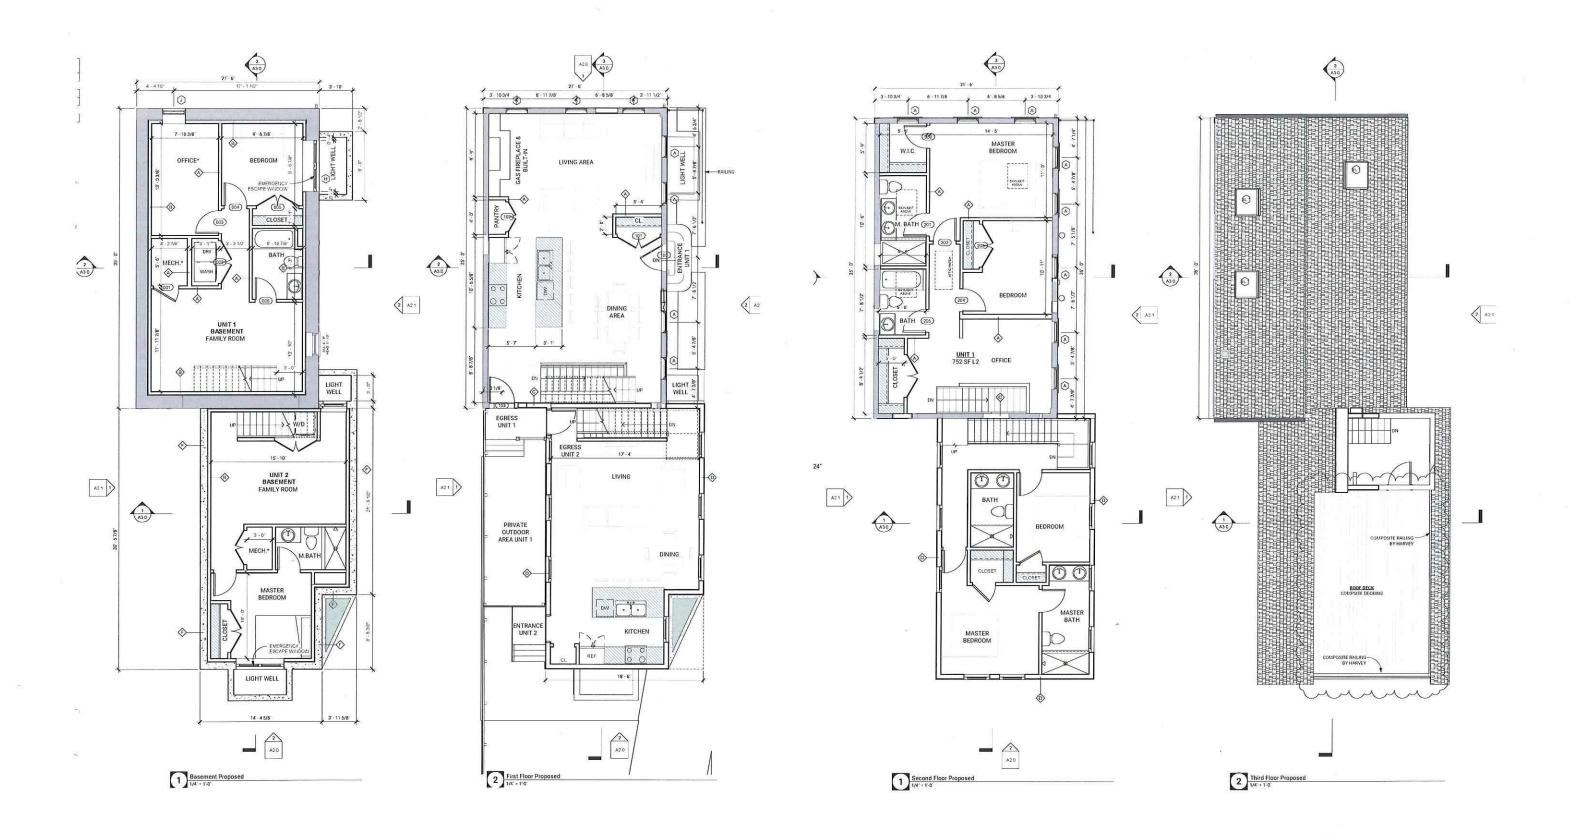

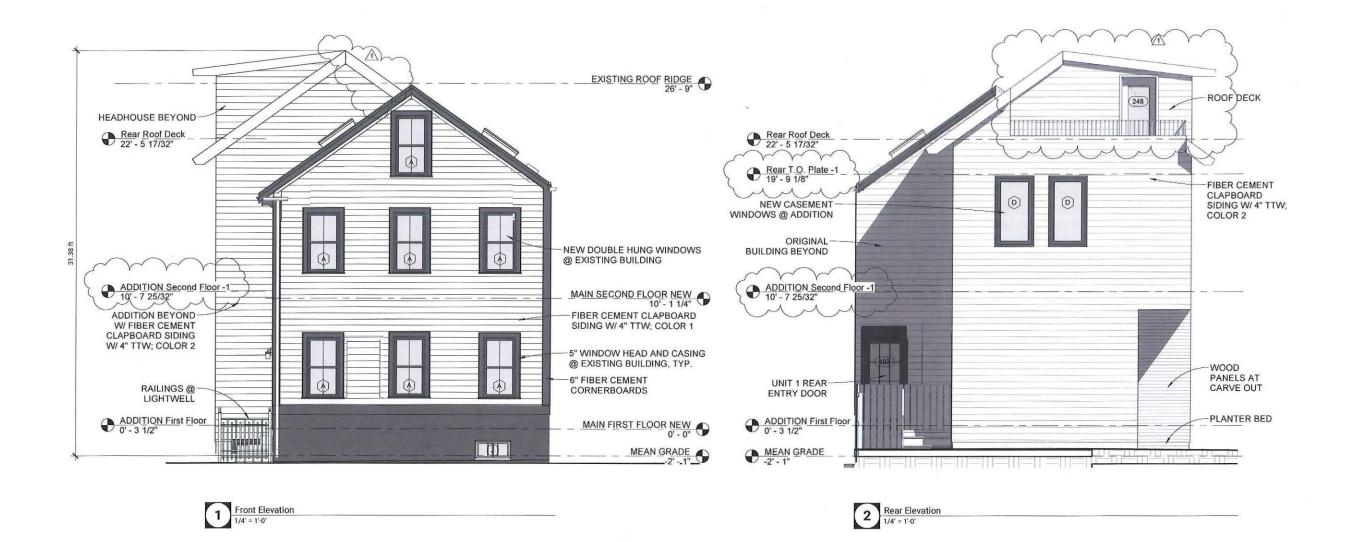

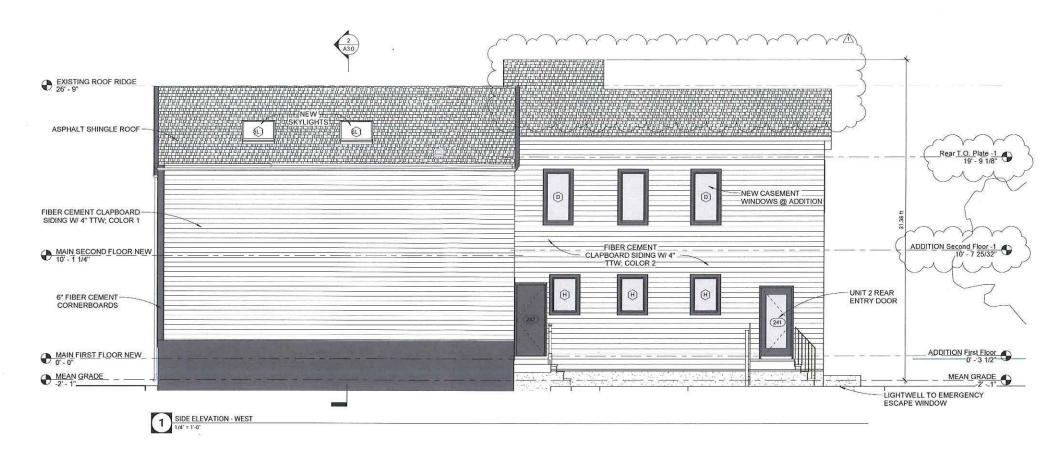





May 24, 2021



kinvarra CAPITAL
















152 CHARLES ST

152 CHARLES ST, CAMBRIDGE MA 02141




SYMBOL LEGEND

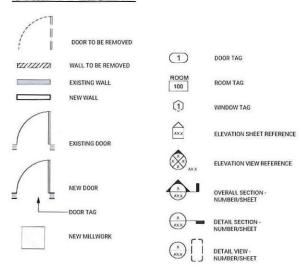

LOCUS MAP





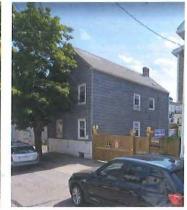

| Sheet List | | | | | | |
|-------------------------|------------------------------|--|--|--|--|--|
| Sheet Number Sheet Name | | | | | | |
| A0.0 | COVER | | | | | |
| A0.1 | ZONING | | | | | |
| A1.1 | EXISTING AREA PLANS | | | | | |
| A1.2 | PROPOSED AREA PLANS | | | | | |
| A1.3 | BASEMENT & FIRST FLOOR PLANS | | | | | |
| A1.4 | SECOND FLOOR & ROOF PLAN | | | | | |
| A2.0 | ELEVATIONS | | | | | |
| A2.1 | ELEVATIONS | | | | | |
| A3.0 | SECTIONS | | | | | |
| A3.1 | WALL SECTION & DETAILS | | | | | |
| EX00 | Existing 3D View | | | | | |
| EX01 | Existing Floor Plans | | | | | |
| EX02 | Existing Exterior Elevations | | | | | |

GENERAL NOTES

- THE GENERAL CONTRACTOR SHALL NOTIFY THE ARCHITECTS OF ALL DISCREPANCIES BETWEEN CONSTRUCTION DOCUMENTS
- THE GENERAL CONTRACTOR SHALL COMPLY WITH ALL FEDERAL, STATE, AND LOCAL REGULATIONS THAT MAY APPLY TO THE
- CONSTRUCTION OF THE PROJECT.
 ALL WORK OF THIS PROJECT SHALL COMPLY WITH ACCEPTED BUILDING PRACTICES AND ALL CODES HAVING JURISDICTION
- UVEN THIS PROJECT.
 ALL DOCUMENTS ARCHITECTURAL AND ENGINEERING ARE BINDING AND SHOULD BE ISSUED TO ALL SUBS. ANY DISCREPANCY SHOULD BE BROUGHT TO THE ARCHITECTS DIRECTION BEFORE THE BID IS COMPLETE AND/OR BEFORE THE START OF CONSTRUCTION. CONSTRUCTION. THE GENERAL CONTRACTOR SHALL LEAVE THE PROJECT SITE AND ALL SURROUNDING AREAS IN FINAL CLEAR CONDITION,

- CONSTRUCTION
 THE GENERAL ONTRACTOR SHALL LEAVE THE PROJECT SITE AND ALL SURROUNDING AREAS IN FINAL CLEAR CONDITION,
 INCLUDING THE REMOVAL OF ALL DEBRIS RESULTING FROM CONSTRUCTION.
 THE CONTRACTOR SHALL AT JUNES DURING THE PROGRESS OF THE WORK REMOVE ALL CONSTRUCTION DEBRIS AND
 MAINTAIN A BUST FREE ENVIRONMENT FOR ALL ADJACENT AREAS.
 THE CONTRACTOR SHALL CONSTRUCTION DEBRIS AND
 MAINTAIN A BUST FREE ENVIRONMENT FOR ALL ADJACENT AREAS.
 THE CONTRACTOR SHALL CONSTRUCTION DEBRIS AND
 THE CONTRACTOR SHALL CONSTRUCTION FOR ALL ADJACENT AREAS.
 THE CONTRACTOR SHALL CONSTRUCTION OF ALL MAINTAIN SHALL ADJACENT AREAS.
 ALL WRITTEN DIMENSIONS SHALL HAVE PRECEDENCE OVER ALL OTHERS, DO NOT SCALE DRAWINGS. IF THERE IS A QUESTION
 OR CONFLICT IN DIMENSIONS SHALL HAVE PRECEDENCE OVER ALL OTHERS, DO NOT SCALE DRAWINGS. IF THERE IS A QUESTION
 OR CONFLICT IN DIMENSIONS OF THE WORK.
 ALL WRITTEN DIMENSIONS SHALL HAVE PRECEDENCE OVER ALL OTHERS, DO NOT SCALE DRAWINGS. IF THERE IS A QUESTION
 OR CONFLICT IN DIMENSIONS OF THE WORK.
 ALL CORDINATE ALL PORTIONS OF THE WORK.
 ALL GYPSUM WALL BOARD CONSTRUCTION SHALL CONFORM TO RECOMMENDED HE CONTRACTOR SHALL
 CORDINATE ALL PORTIONS OF THE WORK.
 ALL CYPSUM WALL BOARD CONSTRUCTION SHALL CONFORM TO RECOMMENDATIONS PUBLISHED BY U.S. GYPSUM COMPANY IN THE GYPSUM CONSTRUCTION HANDBOOK.
 ALL FINISHED WORK SHALL BE FREE OF DEFECTS. THE OWNER RESERVES THE BIGHT TO RELECT ANY MATERIALS AND
 WORKMANSHIP WHICH ARE NOT CONSIDERED TO BE AT THE HIGHEST STANDARDS ON THE VARIOUS TRADES INVOLVED.
 NO CHANGES OR SUBSTITUTIONS ARE ALLOYED UNLESS APPROVED BY THE ARCHITECT FOR TO COMMENDE THE VARIOUS TRADES INVOLVED.
 NO CHANGES OR SUBSTITUTIONS ARE ALLOYED UNLESS APPROVED BY THE ARCHITECT FOR TO COMMENDE THE VARIOUS TRADES INVOLVED.
 NO CHANGES OR SUBSTITUTIONS ARE ALLOYED UNLESS APPROVED BY THE ARCHITECT BY WRITTING
 IN YMMODIFICATION OF THESE CONSTRUCTION DOCUMENTS MUST BE APPROVED BY SHE ARCHITECT SIN WRITTING
 IN YMMODIFICATION OF THESE CONSTRUCTION DOCUMENTS MUST BE APPROVED BY SHE ARCHITECT BY WRITTING
 IN YMMODIFICATIO



617.991.0269 | www.balance-architects.com 197 8th Street, Suite 2000, Boston, MA 02129

152 CHARLES ST

CLIENT:

KINVARRA CAPITAL PROJECT ADDRESS:

152 CHARLES ST, CAMBRIDGE MA 02141


| No. | Description | Date | |
|-----|------------------------|-----------|--|
| 1 | Revision 1 - Rear Roof | 5/24/2021 | |
| | | | |
| | | _ | |
| | | | |
| | | | |
| | | _ | |
| | | _ | |



| 20.038 |
|-----------|
| 4/12/2021 |
| PS |
| PS |
| |

COVER

A0.0

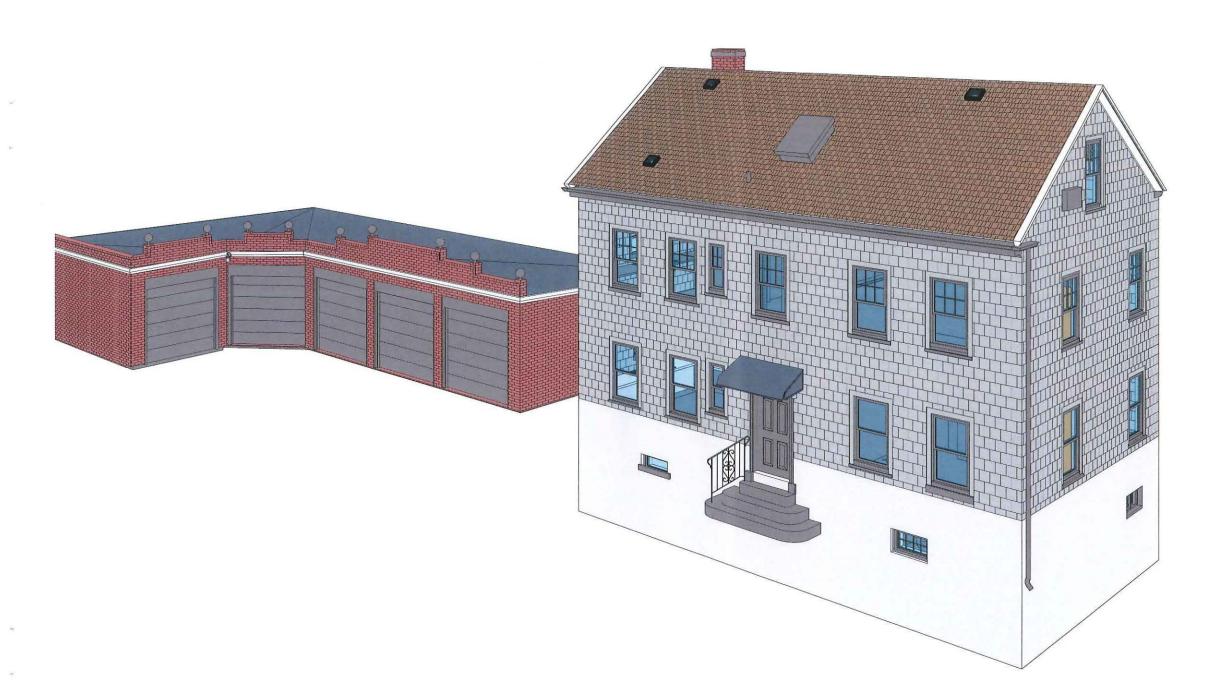



BALANCE ARCHITECTS 617.991.0269 | www.balance-architects.com 197 8th Street, Suite 2000, Boston, MA 02129

PROJECT NAME:

152 CHARLES STREET

CLIENT: KINVARRA CAPITAL

PROJECT ADDRESS: 152 CHARLES ST, CAMBRIDGE, MA 02141

COPYRIGHT BALANCE ARCHITECTS © 2020
THIS DOCUMENT IS THE SOLE PROPERTY OF
BALANCE ARCHITECTS. USE OF THIS DOCUMENT
BY THE OWNER FOR THE COMPLETION OF THIS
OR OTHER POOLECTS WITHOUT EXPRESS
WRITTEN CONSENT IS STRICTLY FORBIDDEN.

| Description | Date |
|-------------|-------------|
| | - |
| | |
| | |
| | - |
| | |
| | |
| | |
| | _ |
| | Description |




STAMP:


| Project number | 20.03 |
|----------------|----------|
| Date | 1/17/202 |
| Drawn by | Р |
| Checked by | P |
| Scale Scale | |


Existing 3D View

EX00

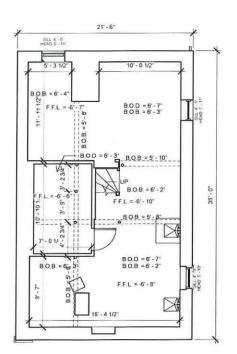

1 Basement 3/16" = 1'-0"

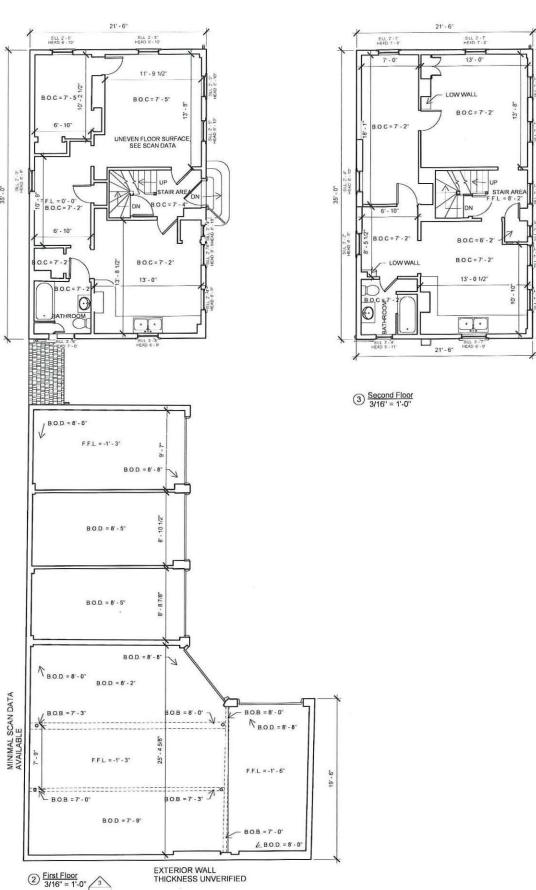

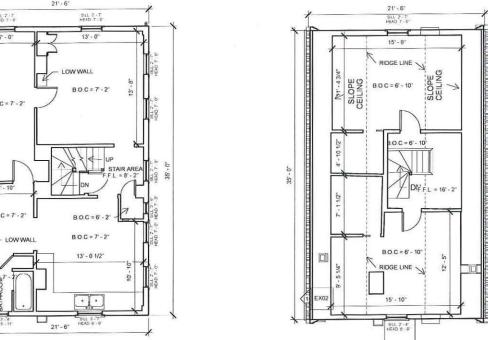

 $4 \frac{\text{Third Floor}}{3/16"} = 1'-0"$



BALANCE ARCHITECTS

617.991.0269 | www.balance-architects.com 197 8th Street, Suite 2000, Boston, MA 02129

PROJECT NAME:

152 CHARLES STREET

CLIENT: KINVARRA CAPITAL

PROJECT ADDRESS:

152 CHARLES ST, CAMBRIDGE, MA 02141

COPYRIGHT BALANCE ARCHITECTS © 2020
THIS DOCUMENT IS THE SOLE PROPERTY OF
BALANCE ARCHITECTS. USE OF THIS DOCUMENT
BY THE OWNER FOR THE COMPLETION OF THIS
OR OTHER PROJECTS WITHOUT EXPRESS
WRITTEN CONSENT IS STRICTLY FORBIDDEN.

| No. | Description | Date |
|-----|-------------|------|
| _ | | |
| | | |
| | | |
| _ | | _ |
| | | |
| | | |
| | | - |
| | | - |



STAMP:

| Project number | 20.038 |
|----------------|---------------|
| Date | 1/17/2021 |
| Drawn by | PS |
| Checked by | PS |
| Scale | 3/16" = 1'-0" |

Existing Floor Plans

EX01





BALANCE ARCHITECTS 617.991.0269 | www.balance-architects.com 197 8th Street, Suite 2000, Boston, MA 02129

PROJECT NAME:

152 CHARLES STREET

CLIENT: KINVARRA CAPITAL

PROJECT ADDRESS:

152 CHARLES ST, CAMBRIDGE, MA 02141

COPYRIGHT BALANCE ARCHITECTS © 2020
THIS DOCUMENT IS THE SOLE PROPERTY OF
BALANCE ARCHITECTS. USE OF THIS DOCUMENT
BY THE OWNER FOR THE COMPLETION OF THIS
OR OTHER PROJECTS WITHOUT EXPRESS.
WRITTEN CONSENT IS STRICTLY FORBIDDEN.

| - | |
|-----|--|
| | |
| - | |
| | |
| | |
| | |
| | |
| 7 2 | |
| | |
| | |
STAMP:

| Project number | 20.038 |
|----------------|---------------|
| Date | 1/17/2021 |
| Drawn by | ECS |
| Checked by | Checker |
| Scale | 3/16" = 1'-0" |

Existing Exterior Elevations

EX02

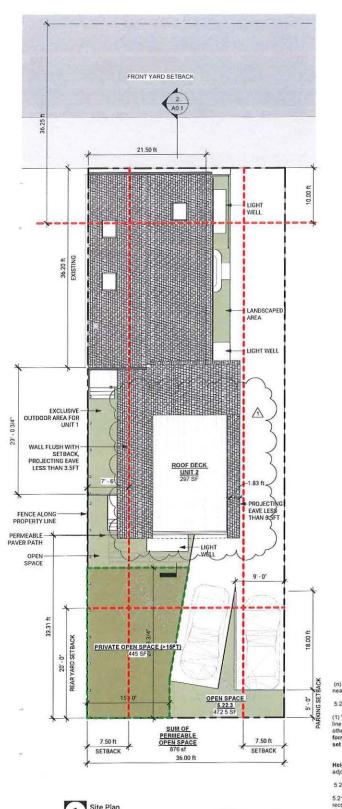

WHOLE-HOUSE MECHANICAL VENTILATION SYSTEM IS INSTALLED IN ACCORDANCE WITH SECTION M1507. ARTIFICIAL LIGHT IS PROVIDED THAT IS CAPABLE OF PRODUCING AN AVERAGE ILLUMINATION OF 6 FOOTCANDLES (65 LUX) OVER THE AREA OF THE ROOM AT A HEIGHT OF 30 INCHES (762 MM) ABOVE THE FLOORLEVEL A30 8 - 3 1/2 OFFICE* BEDROOM LIGHT WELL -EMERGENCY ESCAPE I } ← U LIGHT WELL

(n) In a Residence C-1 District, no building plane (excluding projections as permitted by Section 5.24.2) may be nearer than seven feet, six inches (76°) to a side lot line.

5.24.4 Measurements for minimum yards which are determined by formula shall be made in the following manner.

(1) "H" is the height of the building "L" is the length of the wall measured parallel to the corresponding lot or street line. The front yard is measured from the street line, or building line where such has been established, except where otherwise indicated herein. For buildings of forty (40) feet or less in height the denominator in the yard formulas in the Tables in Section 6.30 may be increased by two subject to the minimum yard requirements set forth in footnotes a, b and of Tables 5-1 and 6-2.

Height of Building. The vertical distance of the highest point of the roof above the mean grade of the ground adjoining the building.


5.21.1 On lots of less than the required area for the district in which they are located and which have been duly recorded by plan or deed with the Registry of Deeds before the date of the first passage of the applicable provisions of this or any prior Ordinance he minimum lot size and lot which regulations need not apply, but the floor area ratio and the minimum lot area regulations for each divelling unit shall be applicable. In case of such lots of less than the required width the sum of the two required side yards need not be more than thirty (30) percent of the lot width, except that each side yard shall be a minimum of seven foet, six linches (7° 6°).

6.22.1 – Private Open Space

An area designated as private open space must have both a width and a length of at least fifteen (15) feet, except for balcories, and may not have a slope greater than ten (10) percent. With the exception of balcory areas, private open space shall be accessible to all occupants of a building, not less than one half of the required private open space shall be provided at ground level or within ten (10) feet of the level of the lowest floor used for residential purposes.

5.22.3 - Special Requirements in Residence C-1

A least fifty (50) percent of the required Private open space in these districts shall meet all of the required Private open space in these districts shall meet all of the required Private open space shall meet the definition of Permeable Open Space and shall not be subject to the dimensional limitations of Section 5.22.1 as applied to Private open space.

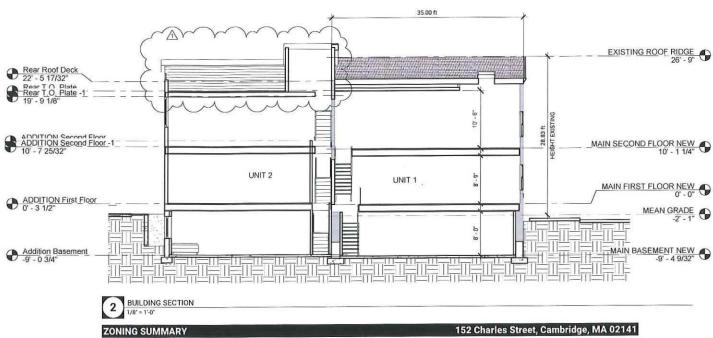

Zoning District Overlay Subdistrict Type East Cambridge Housing Overlay (ECHO) Three Family Residential - 2000 Lot Size 3,600 SF 1562 Use Regulation

| Property Information | Existing | Proposed | Net |
|----------------------|-----------|-----------|-----------|
| Lot Area (S.F.) | 3600.0 SF | NA | NA |
| Gross Floor Area | 3000.0 SF | 2700.0 SF | -300.0 SF |
| # of Units | 2 | 2 | 0 |

| Dimensional Requirements | Allowed | Existing | Proposed | Existing Conformance | Proposed Conformance | Comments |
|--|-----------|-----------|-----------|-----------------------------|----------------------|---|
| Minimum Lot Size | 5000.0 SF | 3600.0 SF | 3600.0 ft | NO | NO | Existing non conforming |
| Max. FAR | 0.75 | 0.83 | 0.75 | NO | | Existing non conforming, proposed conformance |
| Max Area (based on FAR) | 2700.0 | 3000.0 | 2700.0 | NO | | Existing non conforming, proposed conformanc |
| Min. Lot Area/DU | 1500.0 SF | 1800.0 SF | 1800.0 SF | YES | YES | Existing conforming, proposed conformance |
| Min. Lot Width | 50 ft | 36.0 ft | 36.0 ft | NO | NO | Existing non conforming |
| Min. Front Yard Depth | 10.0 | 1.2 | 1.2 | NO | | H+L/6 = 31.3+21.5/6 = 8.8' (10ft Min.) |
| Min. Side Yard Depth Left | 7.5 ft | .0 ft | .0 ft | NO | NO | Section 5.21.1, Existing non conforming |
| Min. Side Yard Depth Right | 7.5 ft | 1.0 ft | 10.0 ft | NO | YES | Section 5.21.1 |
| Min. Rear Yard Depth | 20.0 ft | .0 ft | 33.3 ft | NO | YES | Existing non conforming, proposed conforming |
| Minimum Ratio of Private Open Space to Lot Area | 30.00% | 0.00% | 34.44% | NO | YES | * See below |
| Min Open Space in SF | 1080.0 SF | .0 SF | 1240.0 SF | NO | | Existing non conforming, proposed conforming |
| Max. Height | 35.0 ft | 28.8 ft | 31.38 | YES | | Conforming |
| Off Street Parking | 2 | 5 | 2 | YES | YES | Conforming |

* Private open space larger than 15x15' = 445 SF, Balcony Area = 297 SF, Private Open space not subject to dimensional limitations = 498 SF, Total of 1,240 SF, exceeding the minimum 1,080 SF required. Private Open Space that meets all requirements of Section 5.22.1 Is: 445 + 297/1240 = 59% % Private Space that meets the Permeable Open Space requirements is: 445 + 498/1,240 = 76%.

At least 50% of required private open space shall be minimum length & width of 15' and no slope greater than 10%. Accessible to all occupants. Provided at ground level or within 10' of the level of the lowest floor. At least 50% of required private open space shall be permeable open space and not subject to dimensional limitations noted above.

Floor Area Ratio, The ratio of gross floor area of a structure to the total area of the lot

Floor Area Gross. The sum, in square feet, of the gross horizontal areas of all floors of a building, as measured from the extenor walls (except in (8) and (9) below where only interior space shall be measured and in (h) where the area of the parking facility shall be measured of a building or the centerline of party walls between buildings.

(d) Attic space, whether finished or unfinished, within the area of a horizontal plane that is five (5) feet above the attic floor and which touches the side walls and/or the underside of the roof rafters and which is not excluded in (6) below;

Gross Floor Area shall not include:

- (2) Area of parking facilities in structures located underground and the area of on grade open parking spaces outside the building footprint at or below the maximum number permitted on the premises as set forth in Sections 5.25 and
- 6.30.
 3) Basement and collar areas devoted to the operations and maintenance of the building such as heating and cooling equipment, electrical and telephone facilities, and fuel storage;
 (5) Unnoted porches and balconies no higher than the third floor;
 (6) Attio space and other areas devoted to elevator machinery or mechanical equipment necessary for the operation of the building including sustainable mechanical systems and related equipment and chases for systems including, but not limited to, solar energy systems, geothermal systems and heat pumps, solar hot water systems and related tubes and tanks, equipment related to radiant heating, hydronic cooling, heat recovery ventilators, and energy

(8) Attic space not otherwise included in (d) above, (15) Any basement or cellar living space in any single-family or two-family home

5 24.2 Projecting eaves, chimneys, bay windows, balconles, open fire escapes and like projections which do not project more than three and one-half (3 ½) feet and which are part of a building not more than thirty-five (35) feet in height, and unenclosed steps, unroofed porches and the like which do not project more than ten (10) feet beyond the line of the foundation wall and which are not over four (4) feet above the average level of the adjoining ground, may extend beyond the minimum yard regulations otherwise provided for the district in which the structure is built.

Exemption for Residential Parking Spaces. Notwithstanding the provisions of Section 5.25.2 above, the following structured parking located above ground, accessory to a residential use, shall not be calculated as part of the Gross Floor Area on the lot

(1) One parking space located within a townhouse unit or a one, two or three family dwelling.
(2) A freestanding parking structure containing no more than one parking space per dwelling unit up to a maximum of three parking spaces on a lot containing a one, two or three family dwellings.
(3) One parking space per dwelling unit, up to a maximum of fifteen (15) spaces, for multifamily dwellings.



BALANCE ARCHITECTS 617 991 0269 I www.balance-architects.com

197 8th Street, Suite 2000, Boston, MA 02129

PROJECT NAME

152 CHARLES ST

CLIENT: KINVARRA CAPITAL

PROJECT ADDRESS

152 CHARLES ST, CAMBRIDGE MA 02141

COPYRIGHT BALANCE ARCHITECTS © 2021 THIS DOCUMENT IS THE SOLE PROPERTY OF BALANCE ARCHITECTS. USE OF THIS DOCUMENT BY THE OWNER FOR THE COMPLETION OF THIS OR OTHER PROJECTS WITHOUT EXPRESS WRITTEN CONSENT IS STRICTLY FORBIDDEN.


| No. | Description | Date |
|-----|------------------------|---------|
| 1 | Revision 1 - Rear Roof | 5/24/20 |
| | | |
| | | |
| | | |
| | | |
| | | |
| | | |
| | TERED ARCHIVES | L |
| | A SONILLE STOP | E |

STAMP:

20.038 4/12/2021 PS Drawn by Checked by 1/8" = 1'-0" Scale


ZONING


A0.1

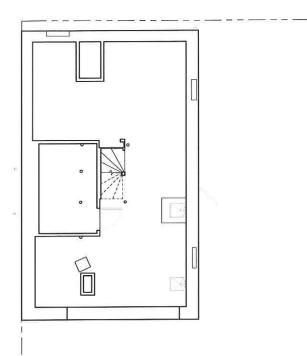


| Existing Gross Area Schedule | | | | | |
|------------------------------|---------|------|--|--|--|
| Level | Area | FAR | | | |
| MAIN FIRST FLOOR NEW | 1008 SF | 0.28 | | | |
| MAIN FIRST FLOOR NEW | 32 SF | 0.01 | | | |
| MAIN FIRST FLOOR NEW | 753 SF | 0.21 | | | |
| SECOND FLOOR EXISTING | 769 SF | 0.21 | | | |
| ROOF DECK | 438 SF | 0.12 | | | |
| Grand total: 5 | 3000 SF | 0.83 | | | |

Basement 3/16" = 1'-0"

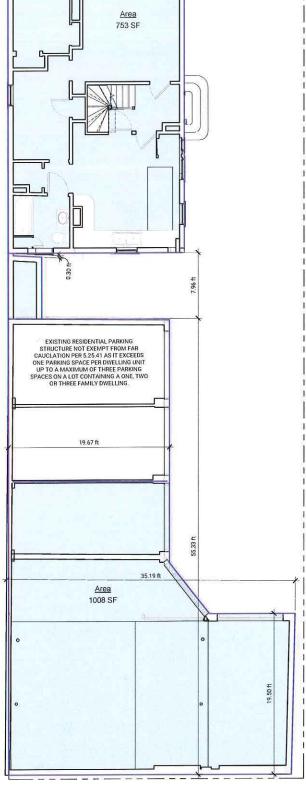

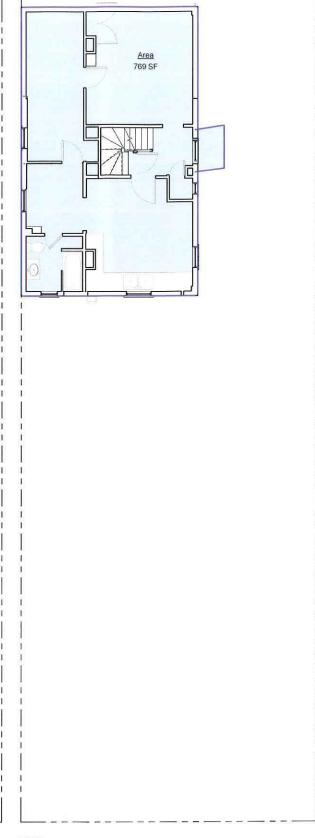

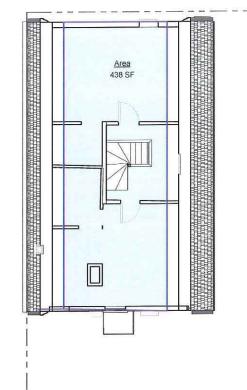

4 Third Floor 3/16" = 1'-0"



CLIENT: KINVARRA CAPITAL

152 CHARLES ST, CAMBRIDGE MA 02141

COPYRIGHT BALANCE ARCHITECTS © 2021 THIS DOCUMENT IS THE SOLE PROPERTY OF BALANCE ARCHITECTS. USE OF THIS DOCUMENT BY THE OWNER FOR THE COMPLETION OF THIS OR OTHER PROJECTS WITHOUT EXPRESS WRITTEN CONSENT IS STRICTLY FORBIDDEN.



STAMP:


20.038 4/12/2021 PS PS 3/16" = 1'-0" Checked by

EXISTING AREA PLANS


A1.1


2 First Floor 3/16" = 1'-0"

3/16" = 1'-0"

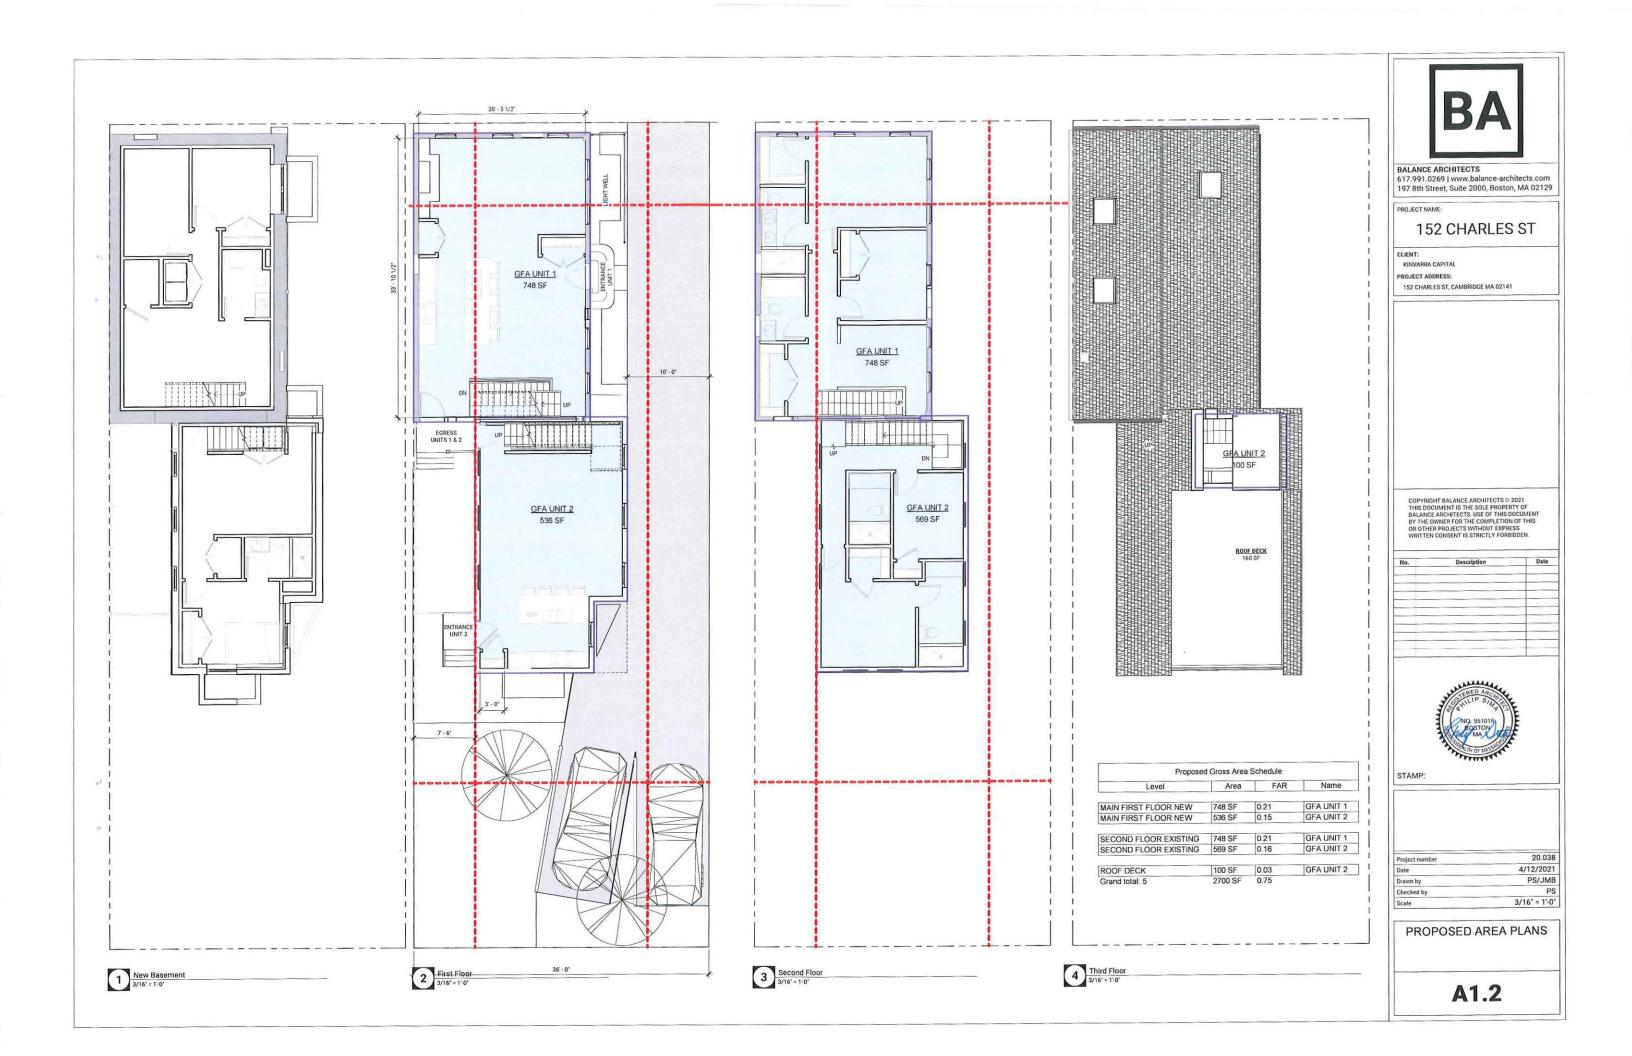




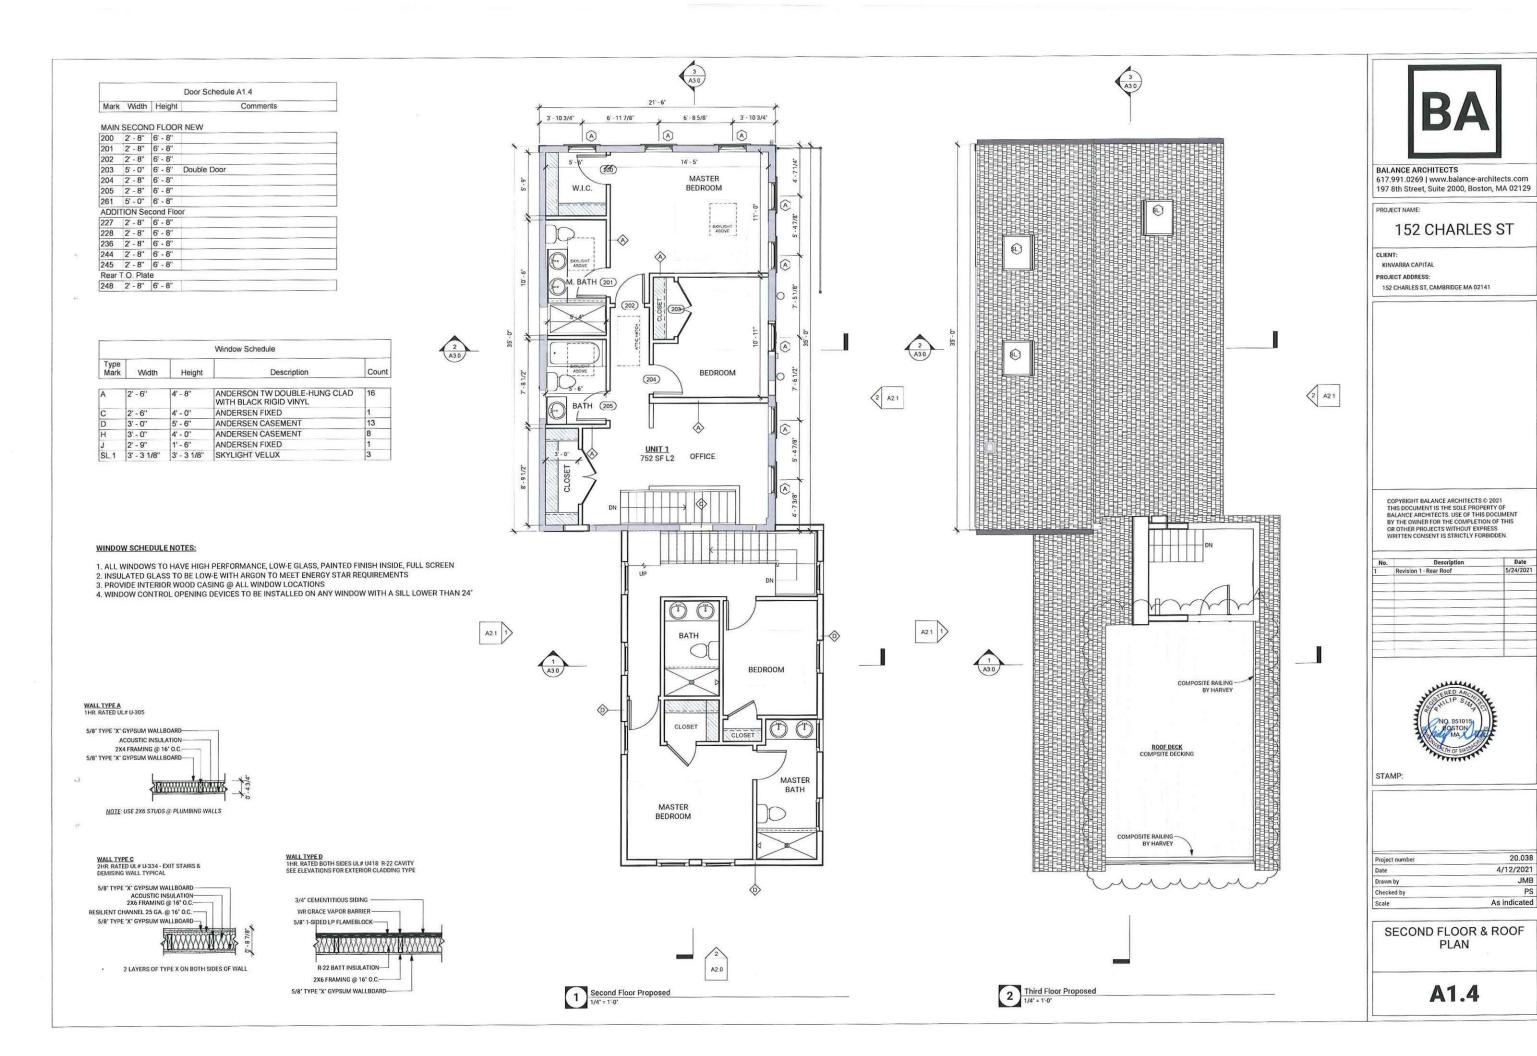


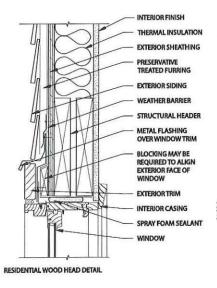

3 Window Head Detail

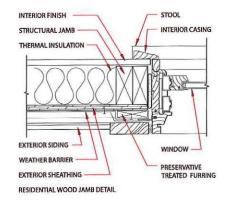

1 Front Elevation

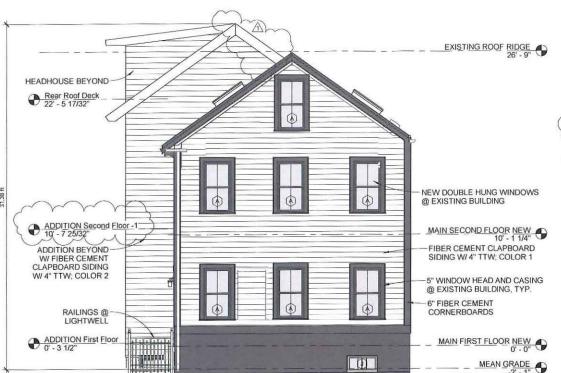



| Window Schedule | | | | | |
|-----------------|-------------|-------------|--|-------|--|
| Type Mark | Width | Height | Description | Count | |
| A | 2' - 6" | 4' - 8" | ANDERSON TW DOUBLE-HUNG CLAD WITH BLACK RIGID VINYL | 16 | |
| С | 2' - 6" | 4' - 0" | ANDERSEN FIXED | 1 | |
| D | 3' - 0" | 5' - 6" | ANDERSEN CASEMENT | 13 | |
| Н | 3' - 0" | 4' - 0" | ANDERSEN CASEMENT | 8 | |
| J | 2' - 9" | 1' - 6" | ANDERSEN FIXED | 1 | |
| SL.1 | 3' - 3 1/8" | 3' - 3 1/8" | SKYLIGHT VELUX | 3 | |

WINDOW SCHEDULE NOTES:

- ALL WINDOWS TO HAVE HIGH PERFORMANCE, LOW-E GLASS, PAINTED FINISH INSIDE, FULL SCREEN
 INSULATED GLASS TO BE LOW-E WITH ARGON TO MEET ENERGY STAR REQUIREMENTS
 PROVIDE INTERIOR WOOD CASING @ ALL WINDOW LOCATIONS

- 4. WINDOW CONTROL OPENING DEVICES TO BE INSTALLED ON ANY WINDOW WITH A SILL LOWER THAN 24"



BALANCE ARCHITECTS 617.991.0269 | www.balance-architects.com 197 8th Street, Suite 2000, Boston, MA 02129


PROJECT NAME:

152 CHARLES ST

CLIENT: KINVARRA CAPITAL

152 CHARLES ST, CAMBRIDGE MA 02141

COPYRIGHT BALANCE ARCHITECTS © 2021 THIS DOCUMENT IS THE SOLE PROPERTY OF BALANCE ARCHITECTS. USE OF THIS DOCUMENT BY THE OWNER FOR THE COMPLETION OF THIS OR OTHER PROJECTS WITHOUT EXPRESS WRITTEN CONSENT IS STRICTLY FORBIDDEN.

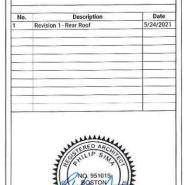


STAMP:

20.038 4/12/2021 PS As indicated


ELEVATIONS


A2.0

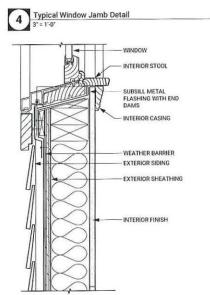



5 Typical Window Sill




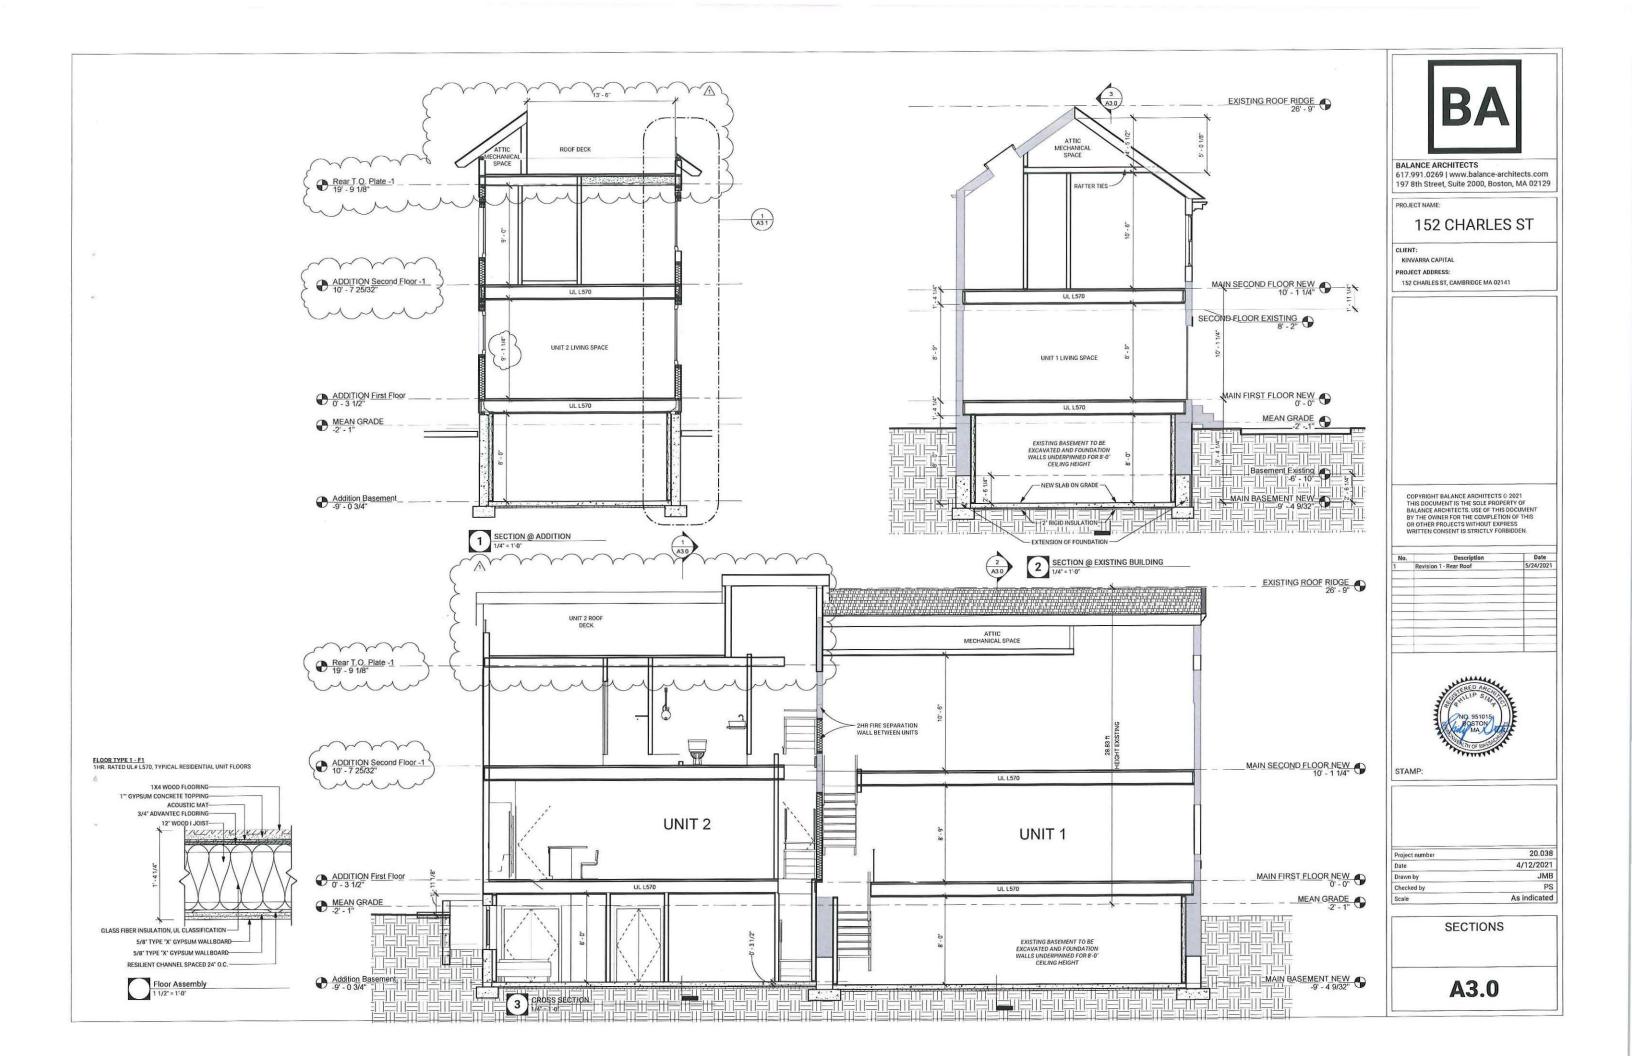

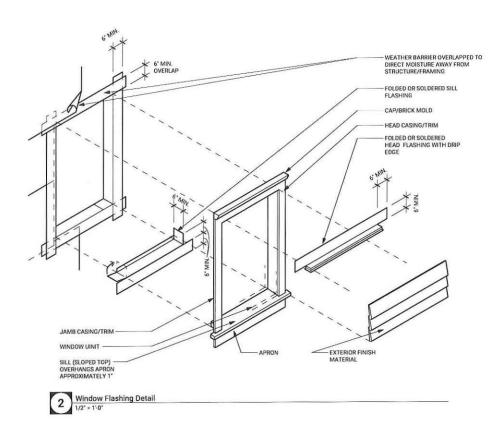

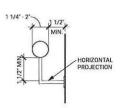

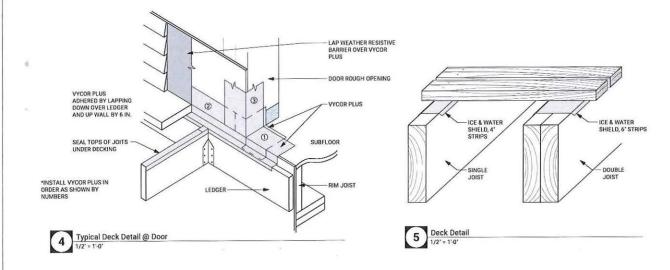

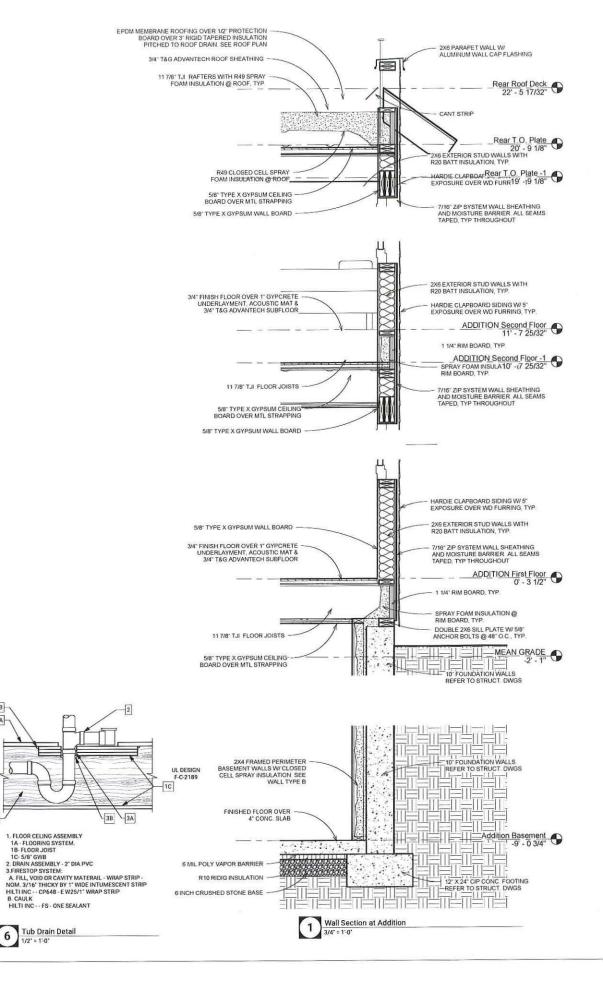

6 Tub Drain Detail



BALANCE ARCHITECTS

617.991.0269 | www.balance-architects.com 197 8th Street, Suite 2000, Boston, MA 02129

PROJECT NAME:

152 CHARLES ST

CLIENT:

PROJECT ADDRESS:

152 CHARLES ST. CAMBRIDGE MA 02141

COPYRIGHT BALANCE ARCHITECTS © 2021 THIS DOCUMENT IS THE SOLE PROPERTY OF BALANCE ARCHITECTS. USE OF THIS DOCUMENT BY THE OWNER FOR THE COMPLETION OF THIS OR OTHER PROJECTS WITHOUT EXPRESS WRITTEN CONSENT IS STRICTLY FORBIDDEN.


Date


STAMP:

4/12/2021 JMB Drawn by Checked by As indicated Scale

WALL SECTION & DETAILS

A3.1

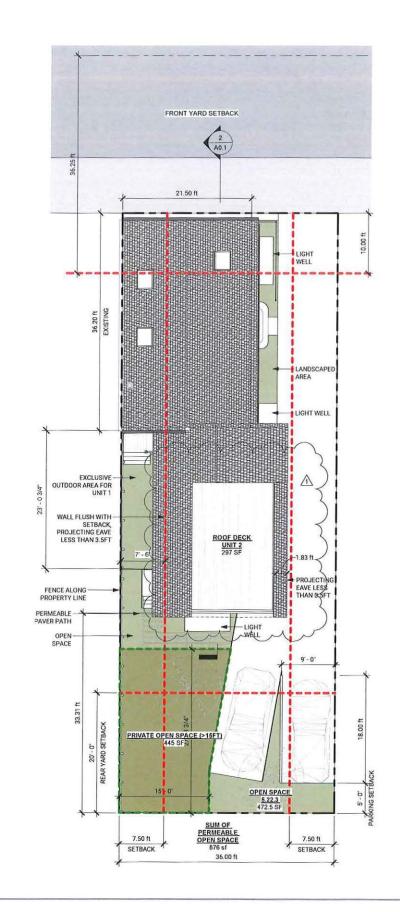


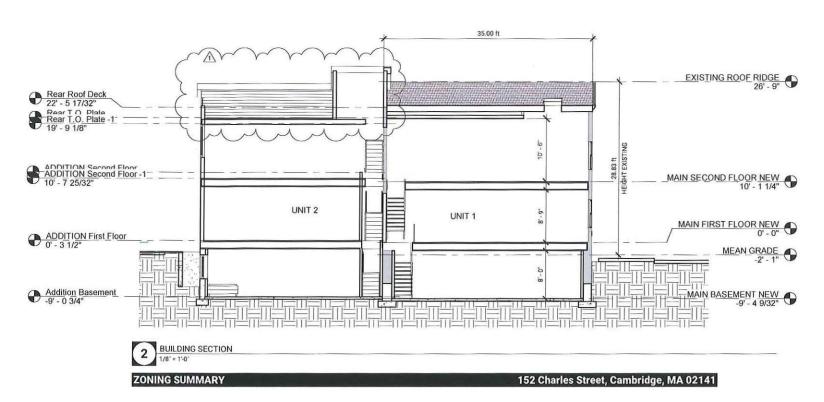





| Dimensional Requirements | Allowed | Existing | Proposed | Existing Conformance | Proposed Conformance | Comments |
|--|-----------|-----------|-----------|-----------------------------|----------------------|---|
| Minimum Lot Size | 5000.0 SF | 3600.0 SF | 3600.0 ft | NO | NO | Existing non conforming |
| Max. FAR | 0.75 | 0.83 | 0.75 | NO | YES | Existing non conforming, proposed conformance |
| Max Area (based on FAR) | 2700.0 | 3000.0 | 2700.0 | NO | YES | Existing non conforming, proposed conformance |
| Min. Lot Area/DU | 1500.0 SF | 1800.0 SF | 1800.0 SF | YES | YES | Existing conforming, proposed conformance |
| Min. Lot Width | 50 ft | 36.0 ft | 36.0 ft | NO | NO | Existing non conforming |
| Min. Front Yard Depth | 10.0 | 1.2 | 1.2 | NO | NO | H+L/6 =31.3+21.5/6 = 8.8' (10ft Min.) |
| Min. Side Yard Depth Left | 7.5 ft | .0 ft | .0 ft | NO | NO | Section 5.21.1, Existing non conforming |
| Min. Side Yard Depth Right | 7.5 ft | 1.0 ft | 10.0 ft | NO | YES | Section 5.21.1 |
| Min. Rear Yard Depth | 20.0 ft | .0 ft | 33.3 ft | NO | YES | Existing non conforming, proposed conforming |
| Minimum Ratio of Private Open Space to Lot Area | 30.00% | 0.00% | 34.44% | NO | YES | * See below |
| Min Open Space in SF | 1080.0 SF | .0 SF | 1240.0 SF | No | YES | Existing non conforming, proposed conforming |
| Max. Height | 35.0 ft | 28.8 ft | 31.38 | YES | YES | Conforming |
| Off Street Parking | 2 | 5 | V 2 | YES | YES | Conforming |

* Private open space larger than 15'x15' = 445 SF, Balcony Area = 297 SF, Private Open space not subject to dimensional limitations = 498 SF, Total of 1,240 SF, exceeding the minimum 1,080 SF required. Private Open Space that meets all requirements of Section 5.22.1 is: 445 + 297/1240 = 59% % Private Space that meets the Permeable Open Space

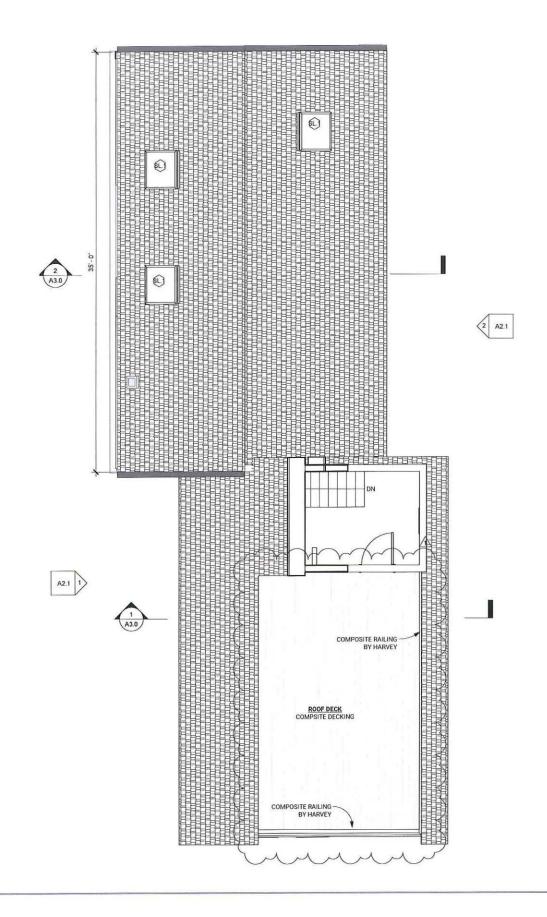

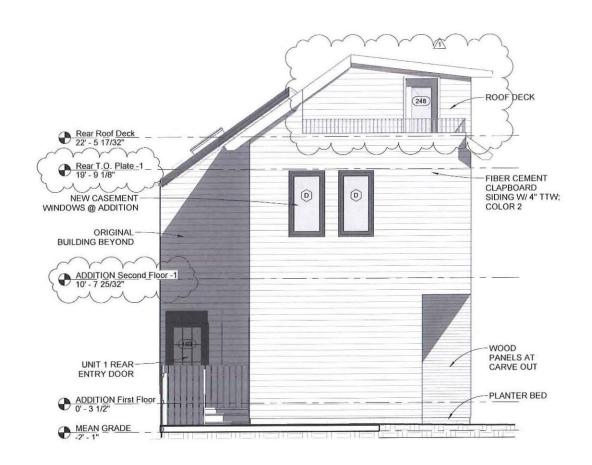


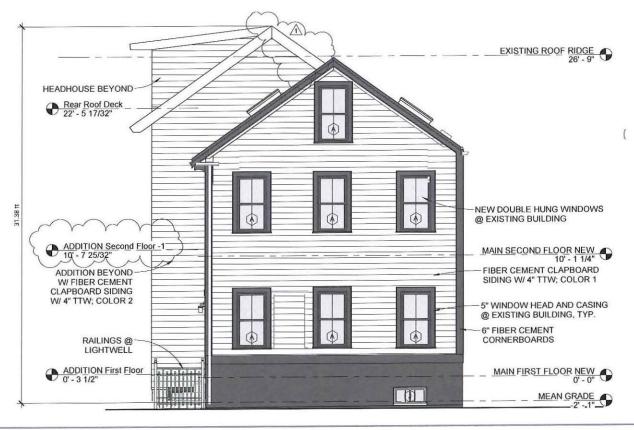




ELEVATIONS

kinvarra

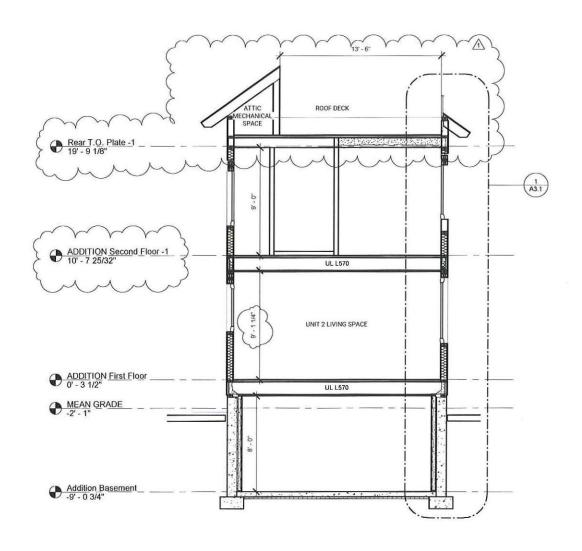

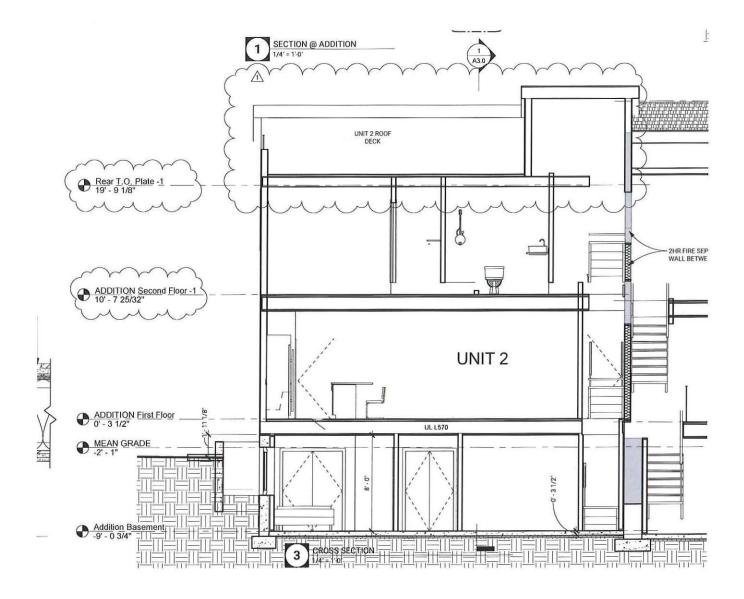





ORIGINAL - OPTION 1



UPDATED - OPTION 2

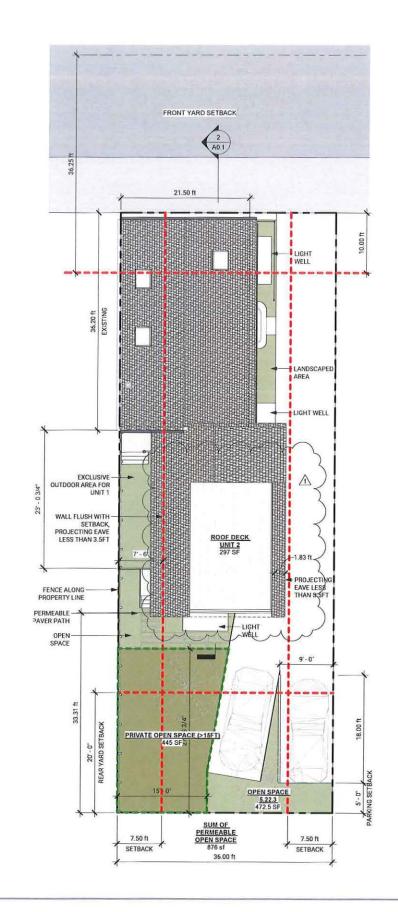


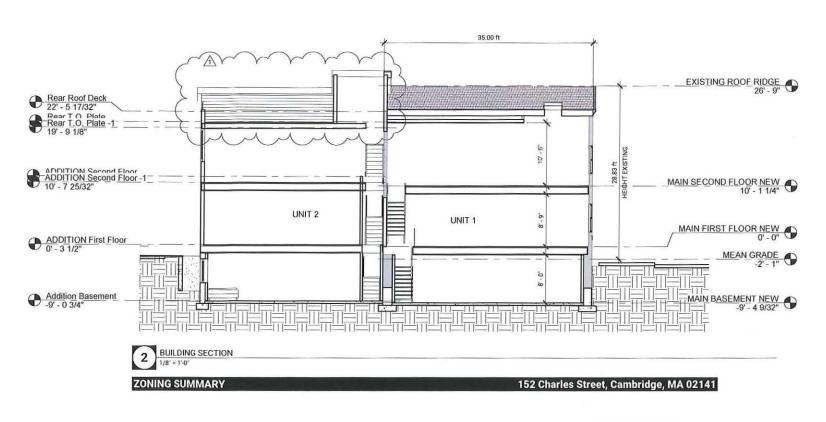






| Dimensional Requirements | Allowed | Existing | Proposed | Existing Conformance | Proposed Conformance | Comments |
|--|-----------|-----------|-----------|-----------------------------|----------------------|--|
| Minimum Lot Size | 5000.0 SF | 3600.0 SF | 3600.0 ft | NO | NO | Existing non conforming |
| Max. FAR | 0.75 | 0.83 | 0.75 | NO | YES | Existing non conforming, proposed conforman |
| Max Area (based on FAR) | 2700.0 | 3000.0 | 2700.0 | NO | YES | Existing non conforming, proposed conforman |
| Min. Lot Area/DU | 1500.0 SF | 1800.0 SF | 1800.0 SF | YES | YES | Existing conforming, proposed conformance |
| Min. Lot Width | 50 ft | 36.0 ft | 36.0 ft | NO | NO | Existing non conforming |
| Min. Front Yard Depth | 10.0 | 1.2 | 1.2 | NO | NO | H+L/6 =31.3+21.5/6 = 8.8' (10ft Min.) |
| Min. Side Yard Depth Left | 7.5 ft | .0 ft | .0 ft | NO | NO | Section 5.21.1, Existing non conforming |
| Min. Side Yard Depth Right | 7.5 ft | 1.0 ft | 10.0 ft | NO | YES | Section 5.21.1 |
| Min. Rear Yard Depth | 20.0 ft | .0 ft | 33.3 ft | NO | YES | Existing non conforming, proposed conforming |
| Minimum Ratio of Private Open Space to Lot Area | 30.00% | 0.00% | 34.44% | NO | YES | * See below |
| Min Open Space in SF | 1080.0 SF | .0 SF | 1240.0 SF | NO | YES | Existing non conforming, proposed conforming |
| Max. Height | 35.0 ft | 28.8 ft | 31.38 | YES | YES | Conforming |
| Off Street Parking | 2 | 5 | V 2 | YES | YES | Conforming |


* Private open space larger than 15'x15' = 445 SF, Balcony Area = 297 SF, Private Open space not subject to dimensional limitations = 498 SF, Total of 1,240 SF, exceeding the minimum 1,080 SF required. Private Open Space that meets all requirements of Section 5.22.1 is: 445 + 297/1240 = 59% % Private Space that meets the Permeable Open Space requirements is: 445 + 498/1,240 = 76%.

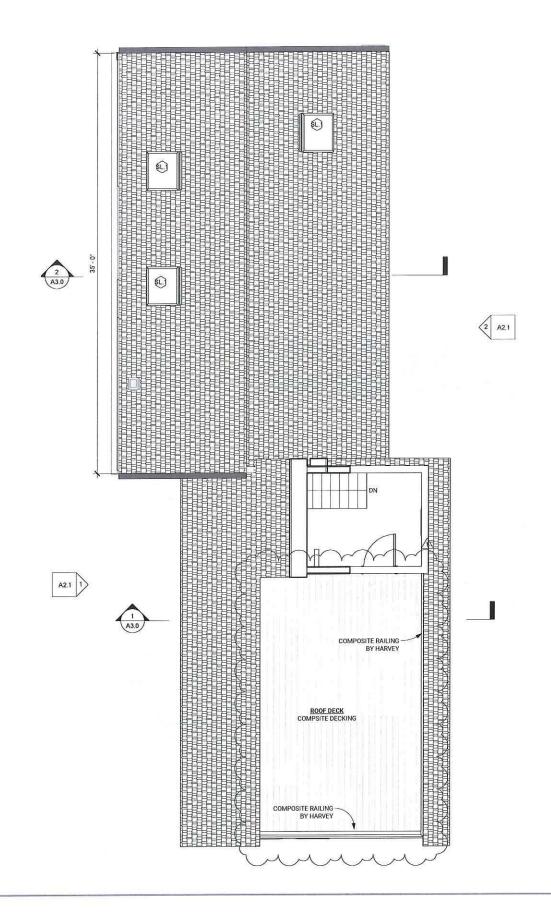

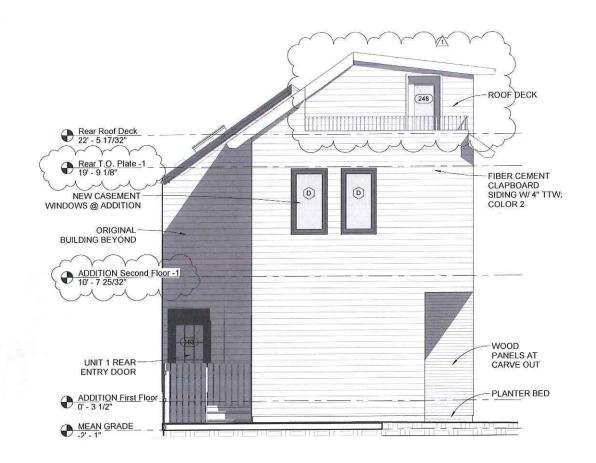

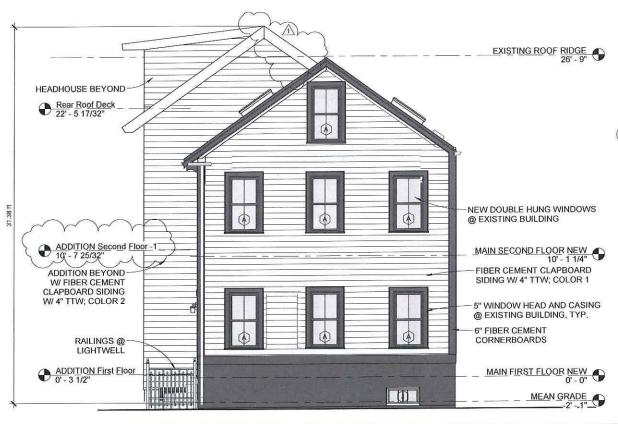

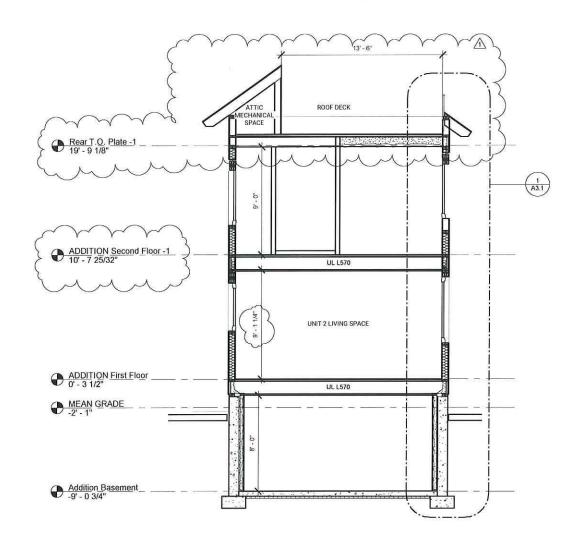

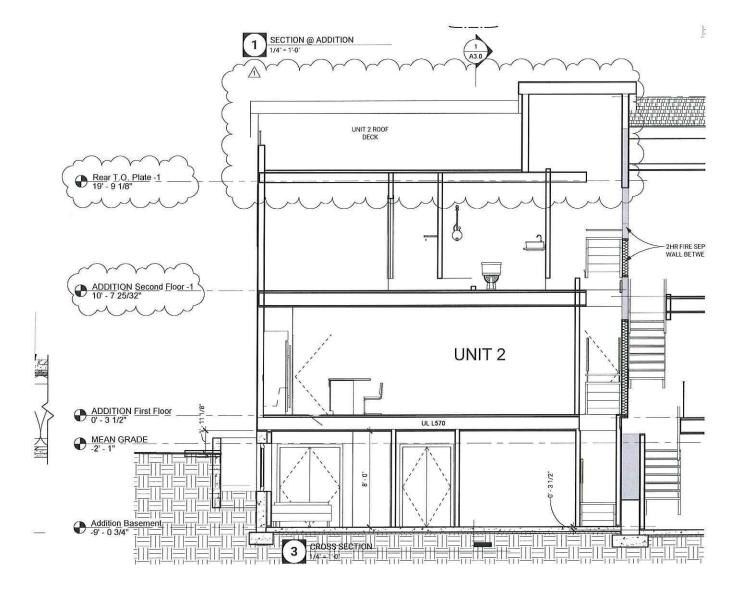















City of Cambridge

MASSACHUSETTS

BOARD OF ZONING APPEAL

831 Mass Avenue, Cambridge, MA. (617) 349-6100

BZA

POSTING NOTICE - PICK UP SHEET

The undersigned picked up the notice board for the Board of Zoning Appeals Hearing.

| Name: Pyth Witte | Date: 5/(2/2 |
|--------------------------|--------------|
| Address: 152 Charles St. | |
| Case No. BZA - 110457 | |
| Hearing Date: 5/27/21 | |

Thank you, Bza Members

Pyr6/