

# CITY OF CAMBRIDGE MASSACHUSETTS BOARD OF ZONING APPEAL 831 MASSACHUSETTS AVENUE CAMBRIDGE, MA 02139 617 349-6100

**BZA APPLICATION FORM** 

Plan No:

BZA-017293-2020

**GENERAL INFORMATION** 

The unders	signed hereby pet	titions the Boa	rd of Zoning Appeal fo	or the following:
Special Pe	rmit:√	_	Variance :	Appeal :
PETITIONE	R: Cellco	Partnershi	p d/b/a Verizon	Wireless - C/O Daniel D. Klasnick, Esquire
PETITIONE	ER'S ADDRESS :	210 Br	oadway Suite 203	Lynnfield, MA 01940
LOCATION	OF PROPERTY :	1654 Ma	ssachusetts Ave	Cambridge, MA
TYPE OF C	OCCUPANCY:		Mounted Mobile	ZONING DISTRICT: Residence C-2 Zone
REASON F	OR PETITION:			
	Oth	er: Eligibl	le Wireless Facil	lity - Modify Special Permit
DESCRIPT	ION OF PETITION	IER'S PROPOS	SAL:	
antennas remote r existing project	cadio heads are chimneys. A narrative, pl	antennas) nd replace All equipme Lans and ph	at the same heimith 6 remote rand to be painted oto simulations  D:	ght on existing chimneys. Remove 6 dio heads at the same location on the to match chimneys. Please see attached for more details.  ommunication Facility).
Article		Section	4.40 (Footnote	49) (Telecommunication Facility).
Article	-	Section	10.40-10.46 (Spe	ecial Permit).
Article	6409(a)	Section	(Middlesex Class	s Tax Relief Act (Spectrum Act).
			Original Signature(s)	(Petitioner(s) / Owner) Daniel D. Klasnick, attorney for Cellco Partnership
				d/b/a Verizon Wireless (Print Name)
				,
			Address	s: 210 Broadway, Suite 203
				Lynnfield, MA 01940
			Tel. No.	.: (781) 873-0021
			E-Mail A	Address:dklasnick@dkt-legal.com
Date :	June 12, 2020			

### BZA APPLICATION FORM - OWNERSHIP INFORMATION

To be completed by OWNER, signed before a notary and returned to The Secretary of the Board of Zoning Appeals.

I/We John Kurt Miller, Trustee	
(OWNER)	
Address: 1396 Beacon Street, Brookline, MA 02446	
State that I/We own the property located at 1654 Massachusetts Avenue	
which is the subject of this zoning application.	
The record title of this property is in the name of Clifford V. Miller Ti	rust
*Pursuant to a deed of duly recorded in the date $\frac{12.29.1972}{}$ , Middles County Registry of Deeds at Book $\frac{12356}{}$ , Page $\frac{367}{}$ ; or	ex South
Middlesex Registry District of Land Court, Certificate No.	
Book Page	
SIGNATURE BY LAND OWNER OR AUTHORIZED TRUSTEE, OFFICER OR AGE *Written evidence of Agent's standing to represent petitioner may be r	
Commonwealth of Massachusetts, County of Michael	
The above-name John Kurt Miller personally appeared be	fore me,
this 29th of May, 2020, and made oath that the above statement	is true.
Darage Pallado.	otary
My commission expires 12-31-300 (Notary Seal) REBECCA A. Notary Commonwealth of My Commission December 2	Public Massachusens on Explées
<ul> <li>If ownership is not shown in recorded deed, e.g. if by court ordered, or inheritance, please include documentation.</li> </ul>	

#### SUPPORTING STATEMENT FOR A SPECIAL PERMIT

Please describe in complete detail how you meet each of the following criteria referring to the property and proposed changes or uses which are requested in your application. Attach sheets with additional information for special permits which have additional criteria, e.g.; fast food permits, comprehensive permits, etc., which must be met.

Granting the Special Permit requested for 1654 Massachusetts Ave Cambridge, MA (location) would not be a detriment to the public interest because:

A) Requirements of the Ordinance can or will be met for the following reasons:

As demonstrated by the documents provided with this application and will be further discussed at the hearing on this matter, the modification satisfies the standards for an Eligible Facilities Request pursuant to Section 6409(a) of the Federal Spectrum Act. The proposed modification also satisfies the standards for the grant of a special permit. (For further details, please see attached narrative and supporting documents)

B) Traffic generated or patterns of access or egress would not cause congestion hazard, or substantial change in established neighborhood character for the following reasons:

The modification of the unmanned facility will not change existing traffic demand or impact ingress or egress. The modified facility will continue to generate only about one to two vehicles trips per month in a standard passernger vehicle. (For further details, please see attached narrative and supporting documents)

C) The continued operation of or the development of adjacent uses as permitted in the Zoning Ordinance would not be adversely affected by the nature of the proposed use for the following reasons:

The modified facility will have no adverse effects on the operation or development of adjacent uses. The modified facility will emit no light, odor, dust or glare and generates no unusual noise or other adverse impacts. (For further details, please see attached narrative and supporting documents)

Nuisance or hazard would not be created to the detriment of the health, safety and/or welfare of the occupant of the proposed use or the citizens of the City for the following reasons:

The modified facility will generate no additional traffic or other negative impacts on surrounding properties or with the City of Cambridge. The facility requires no water or sewer services and emits no light, odor, dust or glare and generates no unusual noise or other adverse impacts. The facility will be unoccupied with no employees or customers. The availability of wireless enhances the health, safety and welfare of the community.

For other reasons, the proposed use would not impair the integrity of the district or adjoining district or otherwise derogate from the intent or purpose of this ordinance for the following reasons:

E)

The facility has been designed to minimize its visual impact and is in harmony with the general purpose of the zoning ordinance and the previously issued special permits for this use and in accordance with the requirements for an Eligible Facilities Request under Section 6409(a). Please see attached narrative and supporting documents)

#### **DIMENSIONAL INFORMATION**

APPLICANT: Verizon Wireless PRESENT USE/OCCUPANCY: Wireless

LOCATION: 1654 Massachusetts Ave Cambridge, MA ZONE: Residence C-2 Zone

PHONE: 7818730021 **REQUESTED USE/OCCUPANCY:** Wireless **EXISTING** REQUESTED **ORDINANCE CONDITIONS** REQUIREMENTS **CONDITIONS** TOTAL GROSS FLOOR AREA: 22978 N/C N/C (max.) 17578 N/C 5000 (min.) LOT AREA: N/C N/C N/A RATIO OF GROSS FLOOR AREA (max.) TO LOT AREA: N/A N/C 600 LOT AREA FOR EACH DWELLING UNIT: (min.) N/A N/C N/A SIZE OF LOT: WIDTH (min.) N/A N/C N/A DEPTH N/C N/A N/A SETBACKS IN FEET: FRONT (min.) N/A N/C N/A (min.) REAR N/C N/A N/A LEFT SIDE (min.) N/C N/A N/A RIGHT SIDE (min.) 69' N/C N/A SIZE OF BLDG.: HEIGHT (max.) N/C N/A N/A LENGTH N/C N/A N/A WIDTH N/C N/A N/A (min.) RATIO OF USABLE OPEN SPACE TO LOT AREA: N/A N/C N/A (max.) NO. OF DWELLING UNITS: N/C N/A N/A (min./max) NO. OF PARKING SPACES: N/A N/C N/A NO. OF LOADING AREAS: (min.) N/A N/C N/A (min.) DISTANCE TO NEAREST BLDG.

Describe where applicable, other occupancies on same lot, the size of adjacent buildings on same lot, and type of construction proposed, e.g.; wood frame, concrete, brick, steel, etc.

ON SAME LOT:

<sup>1.</sup> SEE CAMBRIDGE ZONING ORDINANCE ARTICLE 5.000, SECTION 5.30 (DISTRICT OF DIMENSIONAL REGULATIONS).

<sup>2.</sup> TOTAL GROSS FLOOR AREA (INCLUDING BASEMENT 7'-0" IN HEIGHT AND ATTIC AREAS GREATER THAN 5') DIVIDED BY LOT AREA.

<sup>3.</sup> OPEN SPACE SHALL NOT INCLUDE PARKING AREAS, WALKWAYS OR DRIVEWAYS AND SHALL HAVE A MINIMUM DIMENSION OF 15'.



# CITY OF CAMBRIDGE MASSACHUSETTS BOARD OF ZONING APPEAL 831 MASSACHUSETTS AVENUE CAMBRIDGE, MA 02139020 JUN 16 AM 10: 50 617 349-6100

**BZA APPLICATION FORM** 


OFFICE OF THE CITY CLERK CAMBRIDGE. MASSACHUSETTS

Plan No:

BZA-017293-2020

**GENERAL INFORMATION** 

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Special Pe	rmit: <u>√</u>		Variance :		Appeal :
PETITIONE	R: Cellc	o Partnershi	p d/b/a Verizon	Wirele	ess - C/O Daniel D. Klasnick, Esquire
PETITIONE	R'S ADDRESS	210 Br	oadway Suite 203	Lynnfi	field, MA 01940
LOCATION	OF PROPERTY	/: 1654 Ma	ssachusetts Ave	Cambri	idge, MA
TYPE OF C	CCUPANCY:		Mounted Mobile	_ ZONII	NING DISTRICT: Residence C-2 Zone
REASON F	OR PETITION :	*			
	Ot	her: Eligibl	e Wireless Facil	ity -	- Modify Special Permit
DESCRIPT	ION OF PETITIO	NER'S PROPOS	SAL:		
building antennas remote r existing project	mounted moderate (total of adio heads and chimneys. narrative, of Company of the	bile communi 11 antennas) and replace All equipme plans and ph	cations facility at the same height with 6 remote race nt to be painted oto simulations for	by rem ght on dio hea to mat for mon	
Article	STILL STATE OF THE				ication Facility).
Article					Telecommunication Facility).
Article		<del></del> -	10.40-10.46 (Spe		
Article	6409(a)	Section	(Middlesex Class	s Tax F	Relief Act (Spectrum Act).
			Original Signature(s)	1	(Petitioner(s) / Owner) Daniel D. Klasnick, attorney for Cellco Partnership d/b/a Verizon Wireless
				-	(Print Name)
			Address	s: <sup>2</sup>	210 Broadway, Suite 203
					Lynnfield, MA 01940
			Tel. No.	: _	(781) 873-0021
				ddress:	s: dklasnick@dkt-legal.com
Date :	June 12, 2020				

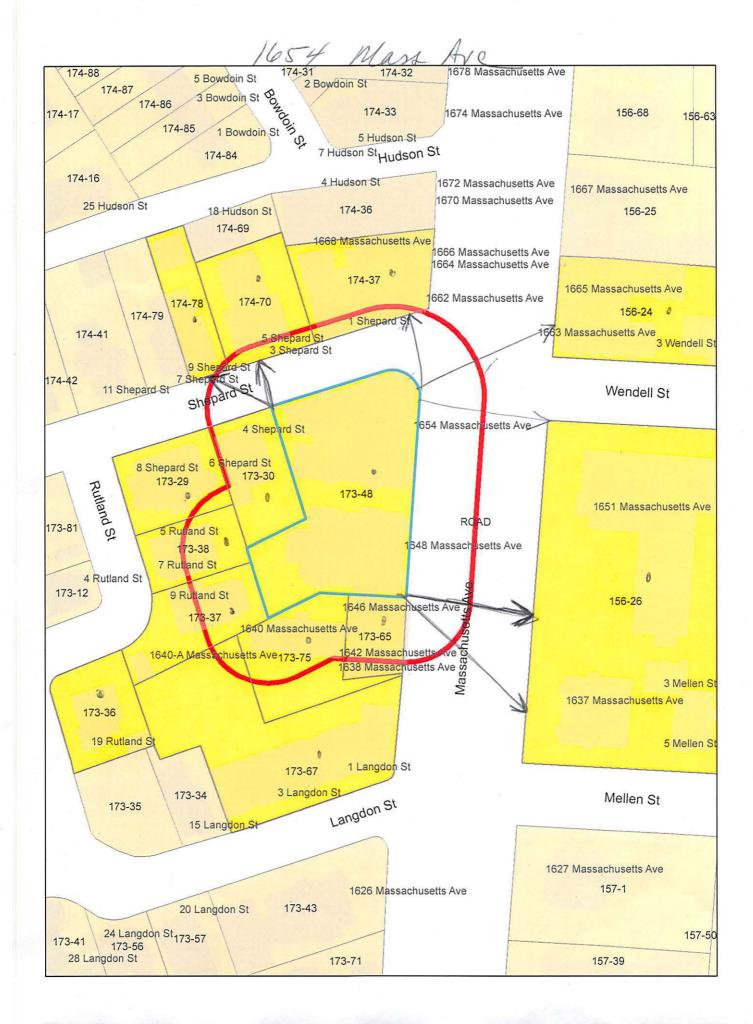

1654 Mass Ave

174-37 STONE INVESTMENT HOLDING LLC, 9 SHEPARD ST. CAMBRIDGE, MA 02138 174-70
KAUPPILA, ANDREA M.
TRUSTEE OF ST. GEORGE FAMILY TRUST
3 SHEPARD ST. UNIT 2
CAMBRIDGE, MA 02138-1501

CELLCO PARTNERSHIP D/B/A VERIZON WIRELESS C/O DANIEL D. KLASNICK, ESQ. 210 BROADWAY – SUITE 203 LYNNFIELD, MA 01940

174-78
KANTOR, DAVID,
TR. THE KANTOR SHEPARD STREET NOMINEE TR
7 SHEPARD STREET
CAMBRIDGE, MA 02138-1711

156-24 LESLEY COLLEGE 29 EVERETT STREET CAMBRIDGE, MA 02138 156-26
PRESIDENT & FELLOWS OF HARVARD COLLEGE
C/O HARVARD REAL ESTATE, INC.
HOLYOKE CENTER, ROOM 1017
1350 MASS. AVE.
CAMBRIDGE, MA 02138

174-70
LEE, SHIRLEY Y. & FRANK S. LEE.,
TR. FRANK S. LEE & SHIRLEY Y. LEE FAMILY TR.
3 SHEPARD ST., UNIT #1
CAMBRIDGE, MA 02139

174-70 METTLER, BERNARD 2120 KEYWOOD PARKWAY MINNEAPOLIS, MN 55405 173-29 WHELAN, PATRICIA MARIE 6 SHEPARD ST #2 CAMBRIDGE, MA 02138-1712

173-30 OTIS, MELISSA W. & SAMUEL A. OTIS, JR., TR. 4 SHEPARD ST CAMBRIDGE, MA 02138 173-29 BASS, STEEDMAN 6 SHEPARD ST., UNIT #4 CAMBRIDGE, MA 02139 173-29 MOULTON, MARGARET M. & PETER F. MOULTON 6-8 SHEPARD ST #6 CAMBRIDGE, MA 02138

173-37 MOORE, GORDON T., CHARLOTTE B. MOORE 9 RUTLAND ST CAMBRIDGE, MA 02138 173-75 HORST, ARCH WILLIAM, JR. 55 BREWSTER STREET CAMBRIDGE, MA 02138 173-29 SIMPSON, ANITA RAE 8 SHEPARD ST. UNIT#1 CAMBRIDGE, MA 02138

173-29 WATKINS, JUSTIN J. & ANNE WATKINS 8 SHEPARD ST, #3 CAMBRIDGE, MA 02138 173-67
JOHN HARVARD LLC,
C/O CHESTNUT HILL REALTY CORP
P.O BX 396
CHESTNUT HILL, MA 02467

173-36 WESTHEIMER, ELLEN 19 RUTLAND ST CAMBRIDGE, MA 02138

173-65 TABIT, SALIM, NANCY C TABIT& EDDY TABIT TRUSTEES THE TABIT FAMILY 2010 IRREV TRU 1804 DOGWOOD CIRCLE NORTH ANDOVER, MA 01845

173-48
MILLER, TUCKER REED JOHN KURT MILLER
C/O CLIFFORD V MILLER INC
1396 BEACON ST
BROOKLINE, MA 02446

174-70 ZUCKER, DEBORAH 3 SHEPARD ST #3 CAMBRIDGE, MA 02138

173-38 PUTRIH, TOBIAS & MOJCA SKOBERNE 5-7 RUTLAND ST. UNIT#7/1 CAMBRIDGE, MA 02139 173-38 RUTTER, JOHN A. & KATHLEEN HUNTER RUTTER 5-7 RUTLAND ST. UNIT#5/1 CAMBRIDGE, MA 02139 174-70 RAGER, CLARE SELDEN & KYLE M. RAGER 3 SHEPARD ST UNIT 4 CAMBRIDGE, MA 02138

173-29
BASS, STEEDMAN L.,
TRUSTEE STEEDMAN L. BASS 2008 TRUST
6-8 SHEPARD ST UNIT 5
CAMBRIDGE, MA 02138

173-38 FEDAK, SCOTT M. & LAUREN ELIZABETH 7 RUTLAND ST UNIT 7-2 CAMBRIDGE, MA 02138



For visual reference only. Actual visibility is dependent upon weather conditions, season, sunlight, and viewer location.



**HARVARD SQ 2 MA** 

DEWBERRY NO. 50121514 (Page 1 of 10)



Dewberry Engineers Inc. 99 Summer St. Suite 700 Boston, MA 02110











Proposed Alpha Sector Panel Antennas (Typ.-2) On A Side-By-Side Bracket On Existing Mast Pipe

Proposed Alpha Sector NR HRU Antenna (Typ.-1) On Existing Mast Pipe


FLOYD'S® BAR

Dewberry\*



HARVARD SQ 2 MA Photo 2B

View Facing Southwest From Massachusetts Avenue (Page 6 of 10)

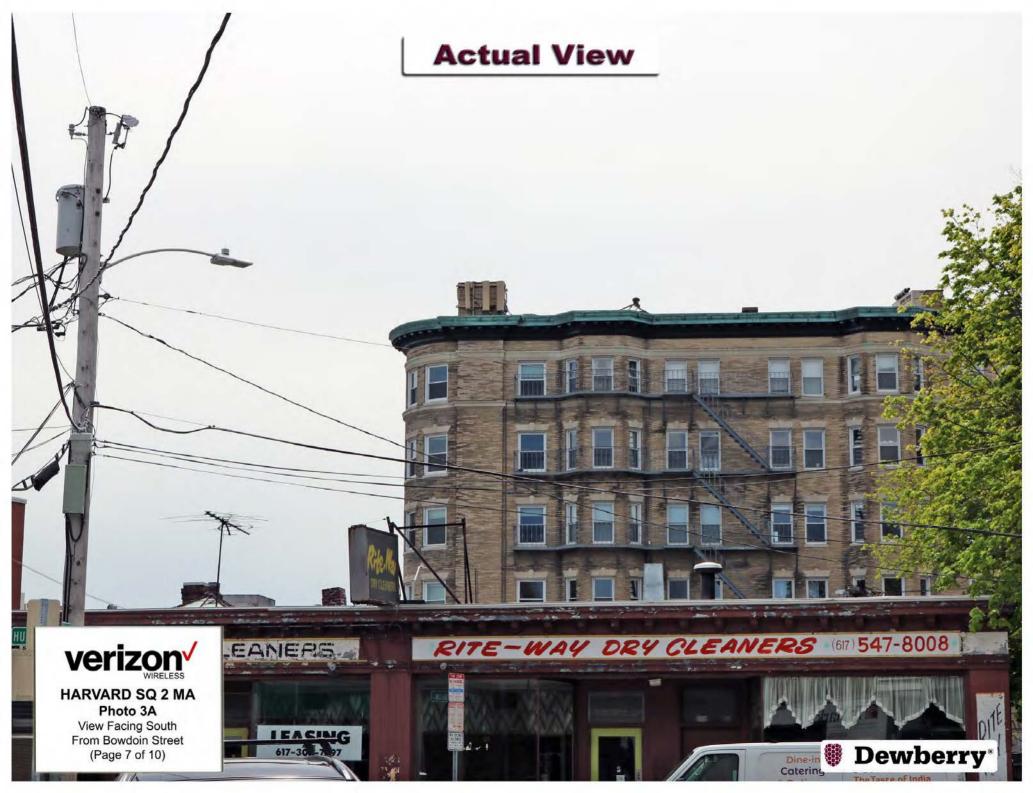










# HARVARD SQ 2 MA

# 1654 MASSACHUSETTS AVENUE CAMBRIDGE, MA 02138

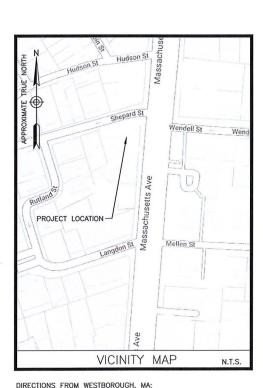

TAKE MA-9 E. MERGE ONTO I-90 E. TAKE EXIT 18 TOWARD CAMBRIDGE. SLIGHT RICHT ONTO CAMBRIDGE STREET. CONTINUE ONTO RIVER STREET. TURN LEFT ONTO PUTNAM AVENUE. SLIGHT

LEFT ONTO MASSACHUSETTS AVENUE. TURN LEFT ONTO SHEPARD STREET. THE SITE WILL BE ON THE LEFT.

#### **ENGINEER**

DEWBERRY ENGINEERS INC. 99 SUMMER ST. SUITE 700 BOSTON, MA 02110

PHONE # (617) 531-0813 FAX # (617) 695-3310

#### CONSTRUCTION

VERIZON WIRELESS 118 FLANDERS ROAD WESTBOROUGH, MA 01581-3956

PHONE # (401) 545-3175 CONTACT: STEVE RYAN

CONSULTANT TEAM

#### SITE NAME: HARVARD SQ 2 MA

## PROPERTY OWNER: TUCKER REED MILLER

C/O CLIFFORD V MILLER INC. 1396 BEACON STREET BROOKLINE, MA 02446

# APPLICANT: CELLCO PARTNERSHIP D/B/A VERIZON WIRELESS 118 FLANDERS ROAD

ELECTRIC UTILITY: EVERSOURCE 1-800-592-2000

TELEPHONE UTILITY: VERIZON 1-800-870-9999

CENTER OF EXISTING STRUCTURE\*: LATITUDE: 42' 22' 53.9" N LONGITUDE: 71' 07' 12.4" W \* PER HANDHELD GPS

PROJECT SUMMARY

#### SITE ADDRESS: 1654 MASSACHUSETTS AVENUE

#### PROJECT DIRECTORY

THE SITE WILL CONSIST OF REMOVING (7) EXISTING PANEL ANTENNAS AND REPLACING WITH (6) NEW PANEL ANTENNAS (2/SECTOR) AND (3) NEW NR ANTENNAS (1/SECTOR) FOR A FINAL TOTAL OF (11) ANTENNAS ON SITE. (6) RRHS WILL BE REMOVED AND REPLACED WITH (6) NEW RRHS (2/SECTOR).

#### PROJECT DESCRIPTION

THIS DOCUMENT WAS DEVELOPED TO REFLECT A SPECIFIC SITI AND ITS SITE CONDITIONS AND IS NOT TO BE USED FOR ANOTHER SITE OR WHEN OTHER CONDITIONS PETAIN, REUSE OF THIS DOCUMENT IS AT THE SOLE PISK OF THE USER

A.D.A. COMPLIANCE: FACILITY IS UNMANNED AND NOT FOR HUMAN HABITATION.

NO.	DESCRIPTION
T-1	TITLE SHEET
A-1	ROOF PLAN
A-2	EAST & NORTH ELEVATIONS
A-3	WEST ELEVATION
A-4	CONSTRUCTION DETAILS
A-5	CONSTRUCTION DETAILS & NOTES

SHEET INDEX



VERIZON WIRELESS 118 FLANDERS ROAD WESTBOROUGH, MA 01581-3956

HARVARD SQ 2 MA

	ANTMO DRAWINGS				
1	05/13/20	FOR SUBMITTAL			
0	03/04/20	FOR SUBMITTAL			
Α	02/12/20	FOR REVIEW			



Dewberry Engineers Inc. 98 SUMMER STREET SUITE 700 BOSTON, MA 02110 PHONE: 617.695.3400 FAX: 617.695.3410



DRAWN BY:	SCA
REVIEWED BY:	CDH
CHECKED BY:	BBR
PROJECT NUMBER:	50121487
JOB NUMBER:	50121514
SITE NUMBER	

1654 MASSACHUSETTS AVE CAMBRIDGE, MA 02138


SHEET TITLE

TITLE SHEET

SHEET NUMBER

SITE ADDRESS

T-1

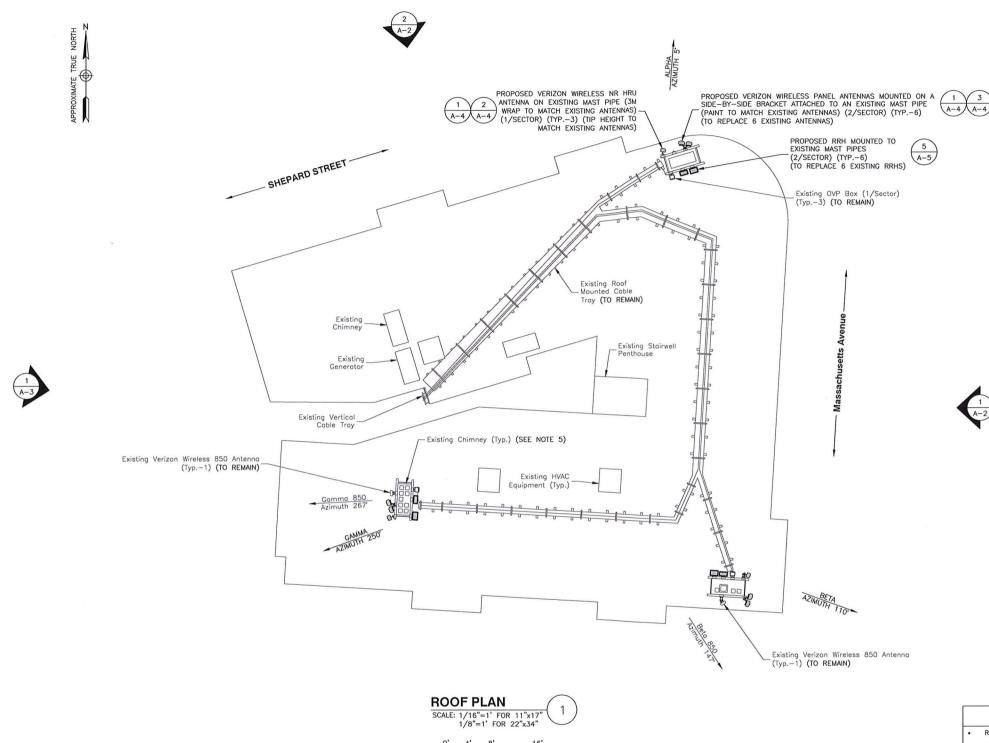

### SCOPE OF WORK

- REMOVE (1) 850 ANTENNA FROM ALPHA SECTOR
- REMOVE (6) HEX ANTENNAS (2/SECTOR)
- REMOVE (6) RRHS (2/SECTOR)
- INSTALL (6) NEW PANEL ANTENNAS ON SIDE-BY-SIDE MOUNTS ATTACHED TO EXISTING MAST PIPES (2 ANTENNAS/SECTOR)
- INSTALL (3) NEW NR HRU ANTENNAS ON EXISTING MAST PIPES (1/SECTOR)
- INSTALL (6) NEW RRHS (2/SECTOR)
- INSTALL ADDITIONAL JUMPER CABLES BETWEEN SECTOR OVPS, RRHS, & ANTENNAS.
- EXISTING & PROPOSED ANTENNAS & MOUNTS SHALL BE GROUNDED PER VERIZON WIRELESS SPECIFICATIONS

SCOPE OF WORK BASED ON RFDS FOR HARVARD SQ 2 MA DATED 01/21/2020. VERIFY SCOPE OF WORK WITH FINAL RFDS PRIOR TO CONSTRUCTION.



VERIZON WIRELESS 118 FLANDERS ROAD WESTBOROUGH, MA 01581-3956

**HARVARD SQ 2 MA** 

		ANTMO	DRAWINGS
١	1		FOR SUBMITTAL
١	0	03/04/20	FOR SUBMITTAL
ı	Α	02/12/20	FOR REVIEW



Dewberry Engineers Inc. 99 SUMMER STREET SUITE 700 BOSTON, MA 02110 PHONE: 617.695.3310 FAX: 617.695.3310



DRAWN BY: SCA

REVIEWED BY: CDH

CHECKED BY: BBR

PROJECT NUMBER: 50121487

JOB NUMBER: 50121514

SITE NUMBER

137823

SITE ADDRESS

1654 MASSACHUSETTS AVE CAMBRIDGE, MA 02138

SHEET TITLE


ROOF PLAN

SHEET NUMBER

A-1

#### SITE NOTES:

- 1. NORTH ARROW SHOWN AS APPROXIMATE.
- 2. EXISTING BUILDING AND ANTENNA ELEVATIONS ARE APPROXIMATE AND HAVE NOT BEEN VERIFIED WITH A MAPPING.
- 3. PLANS BASED ON SITE VISIT BY DEWBERRY ENGINEER ON 01/08/20.
- 4. INSTALL ALL EQUIPMENT PER STRUCTURAL ASSESSMENT LETTER BY DEWBERRY ENGINEERS INC. DATED 01/29/20.
- CONTRACTOR TO INSPECT CONDITIONS OF ALL EXISTING ANCHORS/THREADED RODS FOR SIGNS OF RUST. WHERE RUST IS FOUND, APPLY COLD GALVANIZING COMPOUND TO PROTECT ANCHORS/THREADED RODS FROM CORROSION.
- CONTRACTOR TO UTILIZE 3M WRAP FOR ALL NR HRU ANTENNAS TO MATCH SURROUNDING AREAS. INSTALL 3M WRAP ON ANTENNAS PER MANUFACTURER'S SPECIFICATION & RECOMMENDATIONS.

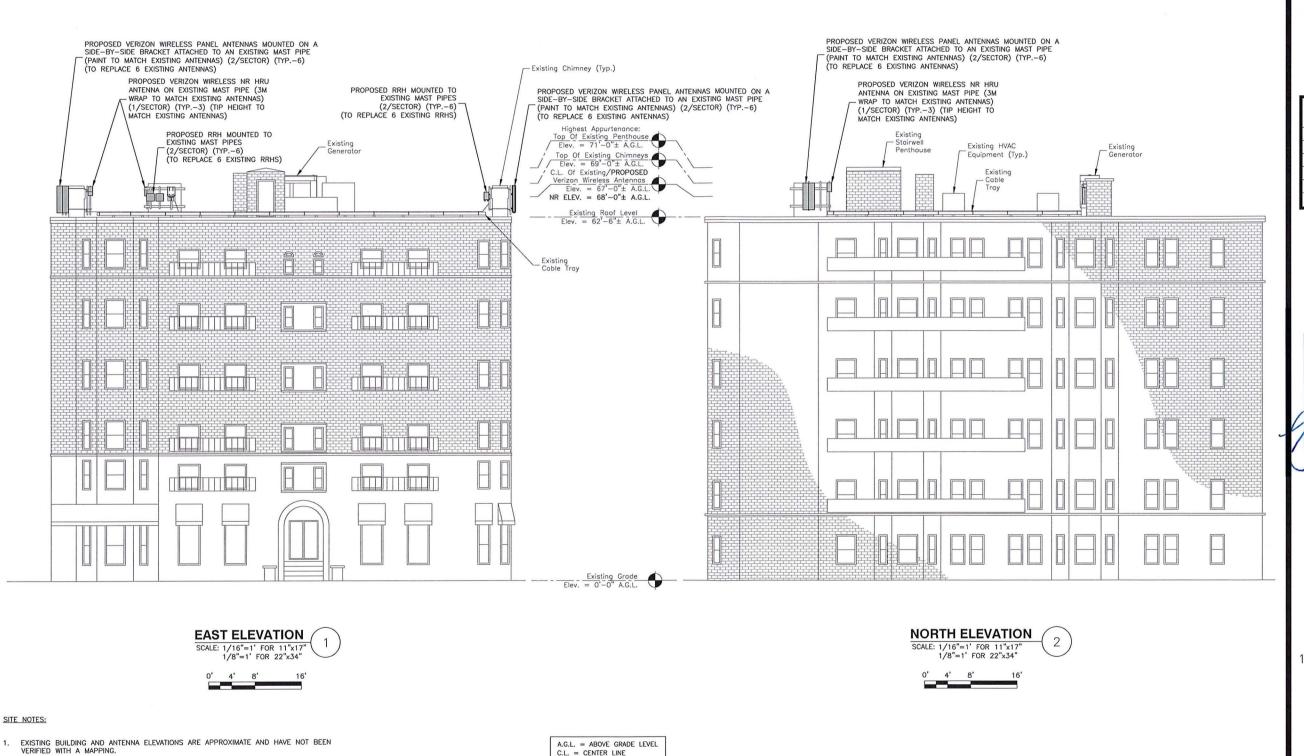

2. PLANS BASED ON SITE VISIT BY DEWBERRY ENGINEERS INC ON 01/08/20.



VERIZON WIRELESS 118 FLANDERS ROAD WESTBOROUGH, MA 01581-3956

HARVARD SQ 2 MA

ANTMO DRAWINGS

1 05/13/20 FOR SUBMITTAL
0 03/04/20 FOR SUBMITTAL
A 02/12/20 FOR REVIEW



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PHONE: 617.695.3400
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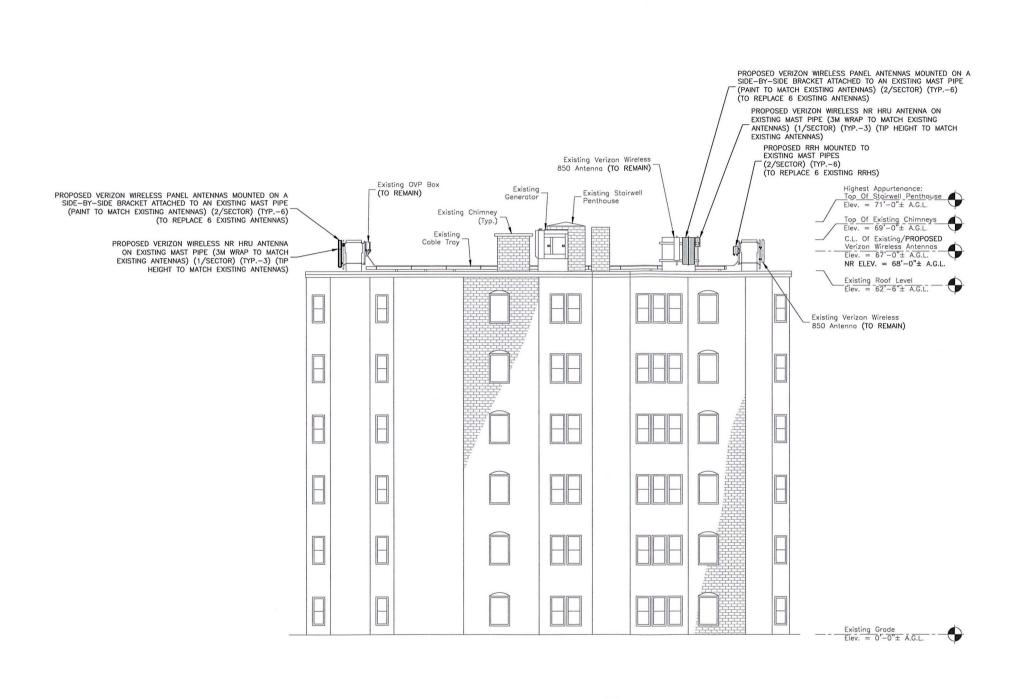
1654 MASSACHUSETTS AVE CAMBRIDGE, MA 02138

SHEET TITLE

EAST & NORTH ELEVATIONS

SHEET NUMBER

A-2



A.G.L. = ABOVE GRADE LEVEL C.L. = CENTER LINE WEST ELEVATION
SCALE: 1/16"=1' FOR 11"x17"
1/8"=1' FOR 22"x34"



#### SITE NOTES:

- EXISTING BUILDING AND ANTENNA ELEVATIONS ARE APPROXIMATE AND HAVE NOT BEEN VERIFIED WITH A MAPPING.
- 2. PLANS BASED ON SITE VISIT BY DEWBERRY ENGINEERS INC ON 01/08/20.



VERIZON WIRELESS 118 FLANDERS ROAD WESTBOROUGH, MA 01581-3956

HARVARD SQ 2 MA

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DRAWN BY: SCA

BBR

REVIEWED BY: CDH

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SITE NUMBER

137823

SITE ADDRESS

1654 MASSACHUSETTS AVE CAMBRIDGE, MA 02138

SHEET TITLE

WEST ELEVATION

SHEET NUMBER

A-3

#### **EXISTING CONFIGURATION**

ANTENNA POSITION 4

#### ALPHA SECTOR

ANTENNA POSITION 1 ANTENNA POSITION 2 ANTENNA POSITION 3 Pan (ED) 4CW0000G Pane BE REMOVED) BXA-80063/4CF F (TO BE REMOVE TO BE REMOVE X654 (To

BETA/GAMMA SECTORS ANTENNA POSITION 1 ANTENNA POSITION 2 ANTENNA POSITION 3 0000G Panel REMOVED) Panel ED) -80063/4CF Pai (TO REMAIN) HEX654CW0000G (TO BE REMOVE

4CW(

X65,

ANTENNA POSITION 4 (EMPTY)

ANTENNA POSITION 4 (EMPTY)

BXA-

PROPOSED CONFIGURATION

#### ALPHA SECTOR

ANTENNA POSITION 2 (EMPTY)

ANTENNA

ANTENNA POSITION 3 PANE

# ANTENNA POSITION 4 (EMPTY)



ANTENNA POSITION 2 POSITION 3 .80063/4CF Pa (TO REMAIN) PANEL ACE EX PANEL ACE EX CTO REPLA BXA-

#### BETA/GAMMA SECTORS

HEX654CW0000G	12.0 / 7.1 / 51.1	
BXA-80063/4CF	11.2 / 4.5 / 47.4	

**Dimensions: Existing Antennas** 

ALL DIMENSIONS ARE MEASURED IN INCHES AND ARE PROVIDED IN THE FORMAT: WIDTH/DEPTH/HEIGHT

#### **DIMENSIONS: PROPOSED ANTENNAS** 9.6 / 6.9 / 18.5 NHH-65A-R2B 11.9 / 7.1 / 55.6


ALL DIMENSIONS ARE MEASURED IN INCHES AND ARE PROVIDED IN THE FORMAT: WIDTH/DEPTH/HEIGHT

#### NOTES:

- 1. AS VIEWED STANDING BEHIND THE ANTENNAS.
- 2. ANTENNA CONFIGURATION BASED ON ANTENNA REC DATED 01/21/20. VERIFY SCOPE OF WORK WITH FINAL RFDS PRIOR TO CONSTRUCTION.

#### **ANTENNA CONFIGURATION**



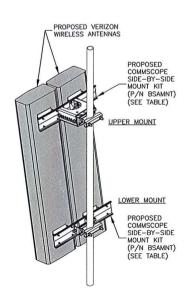

#### MANUFACTURER: SAMSUNG

NR HRU PART NUMBER: DIMENSIONS: 18.5"H X 9.6"W X 6.9"D WEIGHT: 33 LBS

**PLAN** 

ISOMETRIC (FRONT FACE)

#### NOTES:

MOUNTING PIPE -

PROPOSED STAINLESS STEEL BAND (TYP.-2) (SAMSUNG P/N: NW-FSSTBNH20VZ)

INSTALL ALL EQUIPMENT PER MANUFACTURER'S RECOMMENDATIONS. USE APPROPRIATE MOUNTING HARDWARE FOR CONSTRUCTION TYPE.

ISOMETRIC (REAR FACE)

ANTENNAS ARE SHOWN PERPENDICULAR TO BUILDING FACADE. ANTENNAS WILL BE REQUIRED TO BE PANNED TO MEET REQUIRED AZIMUTHS.

PROPOSED BRACKET

3. ANTENNA WEIGHT: 33.0 LBS.

SIDE

4. CONTRACTOR TO UTILIZE 3M WRAP FOR ALL NR HRU ANTENNAS TO MATCH SURROUNDING AREAS. INSTALL 3M WRAP ON ANTENNAS PER MANUFACTURER'S SPECIFICATION & RECOMMENDATIONS.

3

#### NR ANTENNA DETAIL

PROPOSED VERIZON WIRELESS NR ANTENNA

PROPOSED - ANTENNA BRACKET

COMMSCOPE P/N: BSAMNT MOUNT TABLE					
COMMSCOPE P/N	SUPPORTED ANTENNAS	QUANTITY REQUIRED PER (2) ANTENNAS	NUMBER OF MOUNTING POINTS	GAP BETWEEN ANTENNAS	
BSAMNT-SBS-1-2	SBNHH-1D65A/B/C NHH-65A/B/C-R2B	1	2	3-3/8"	
BSAMNT-SBS-2-2	JAHH-65A/B/C-R3B JAHH-45A-R3B NHH-45A-R2B SBNHH-1D45A/B	1	2	2"	
BSAMNT-SBS-2-3	NHH-45B/C-R2B JAHH-45B/C-R3B SBNHH-1D45C	11	3	2"	

TABLE BASED ON POWER POINT PRESENTATION BY COMMSCOPE TITLED SIDE BY SIDE MOUNTS. CONTRACTOR TO VERIFY PART NUMBERS WITH MANUFACTURER PRIOR TO ORDERING. INSTALL PER MANUFACTURER RECOMMENDATIONS & SPECIFICATIONS.

- SPACING OF PROPOSED EQUIPMENT SHALL BE CONFIRMED AND PROPOSED MOUNTS SHALL NOT IMPEDE EQUIPMENT CLEARANCES. ACCESS TO EQUIPMENT SHALL BE MAINTAINED.
- PROPOSED ANTENNA MOUNT SHALL BE INSTALLED ACCORDING TO MANUFACTURER

#### SIDE-BY-SIDE ANTENNA MOUNT

SCALE: N.T.S.




VERIZON WIRELESS 118 FLANDERS ROAD WESTBOROUGH, MA 01581-3956

**HARVARD SQ 2 MA** 

ANTMO DRAWINGS					
1		FOR SUBMITTAL			
0	03/04/20	FOR SUBMITTAL			
Α	02/12/20	FOR REVIEW			



Dewberry Engineers Inc. 99 SUMMER STREET SUITE 700

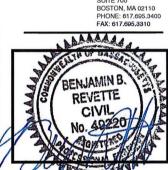

	_	
DRAWN	BY:	SCA

BBR

REVIEWED BY: CDH

CHECKED BY:

PROJECT NUMBER: 50121487

50121514 JOB NUMBER:

SITE NUMBER

137823

SITE ADDRESS

1654 MASSACHUSETTS AVE CAMBRIDGE, MA 02138

SHEET TITLE


CONSTRUCTION **DETAILS** 

SHEET NUMBER

A-4

#### **GENERAL NOTES:**


- ALL DIMENSIONS TO, OF, AND ON EXISTING BUILDINGS, DRAINAGE STRUCTURES, AND SITE IMPROVEMENTS SHALL BE VERIFIED IN FIELD BY CONTRACTOR PRIOR TO ALL FABRICATION WITH ALL DISCREPANCIES REPORTED IMMEDIATELY TO THE ENGINEER.
- 2. DO NOT CHANGE SIZE NOR SPACING OF STRUCTURAL ELEMENTS.
- DETAILS SHOWN ARE TYPICAL; SIMILAR DETAILS APPLY TO SIMILAR CONDITIONS UNLESS OTHERWISE NOTED.
- THESE DRAWINGS DO NOT INCLUDE NECESSARY COMPONENTS FOR CONSTRUCTION SAFETY WHICH IS THE SOLE RESPONSIBILITY OF THE
- BRACE STRUCTURES UNTIL ALL STRUCTURAL ELEMENTS NEEDED FOR STABILITY ARE INSTALLED. THESE ELEMENTS ARE AS FOLLOWS: LATERAL BRACING, ANCHOR BOLTS, ETC.
- DETERMINE EXACT LOCATION OF EXISTING UTILITIES, DRAIN PIPES, VENTS, ETC. BEFORE COMMENCING WORK.
- INCORRECTLY FABRICATED, DAMAGED, OR OTHERWISE MISFITTING OR INCORRECTED TABINGATED, DAMAGED, OR OTHERWISE MISTING ON WONCONFORMING MATERIALS OR CONDITIONS SHALL BE REPORTED TO THE OWNER PRIOR TO REMEDIAL OR CORRECTIVE ACTION. ANY SUCH REMEDIAL ACTION SHALL REQUIRE WRITTEN APPROVAL BY THE OWNER'S REPRESENTATIVE PRIOR TO PROCEEDING.
- EACH CONTRACTOR SHALL COOPERATE WITH THE OWNER'S REPRESENTATIVE, AND COORDINATE HIS WORK WITH THE WORK OF
- REPAIR ANY DAMAGE DURING CONSTRUCTION TO MATCH EXISTING PRE-CONSTRUCTION CONDITIONS TO THE SATISFACTION OF THE CONSTRUCTION MANAGER.
- ALL CABLE/CONDUIT ENTRY/EXIT PORTS SHALL BE WEATHERPROOFED DURING INSTALLATION USING A SILICONE SEALANT.
- 11. THE CONTRACTOR SHALL SUPERVISE AND DIRECT THE PROJECT DESCRIBED HEREIN. THE CONTRACTOR SHALL BE SOLELY RESPONSIBLE FOR ALL CONSTRUCTION MEANS, METHODS, TECHNIQUES, SEQUENCES AND PROCEDURES AND FOR COORDINATING ALL PORTIONS OF THE WORK UNDER THE CONTRACT.
- 12. SEAL PENETRATIONS THROUGH FIRE RATED AREAS WITH UL LISTED D FIRE CODE APPROVED MATERIALS.
- 13. TURN OVER ALL SALVAGEABLE BUILDING MATERIAL TO BUILDING
- 14. ALL DISRUPTIVE WORK AND WORK WITHIN TENANT SPACES TO BE COORDINATED WITH BUILDING REPRESENTATIVE.
- 15. ALL ROOF PENETRATIONS SHALL BE RESTORED TO MAINTAIN ALL ROOF WARRANTIES AND ENSURE A PERMANENT WATERPROOF SEAL.

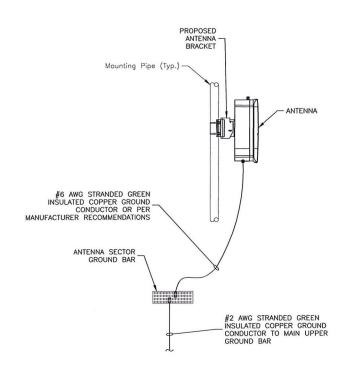

#### NOTES:

- VERIFY EXISTING GROUNDING SYSTEM IS INSTALLED PER VERIZON
- 2. BOND NEW EQUIPMENT INTO EXISTING GROUND SYSTEM IN ACCORDANCE WITH VERIZON WIRELESS STANDARDS AND MANUFACTURER'S RECOMMENDATIONS.




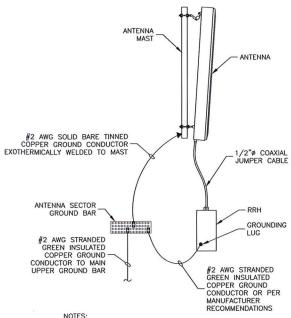

#### NOTES:

- VERIFY EXISTING GROUNDING SYSTEM IS INSTALLED PER
- BOND NEW EQUIPMENT INTO EXISTING GROUND SYSTEM IN ACCORDANCE WITH VERIZON WIRELESS STANDARDS & MANUFACTURER'S RECOMMENDATIONS.

TYPICAL ANTENNA/RRH **GROUNDING DETAIL** 

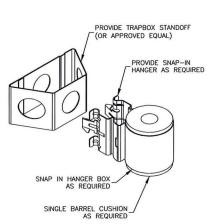

JUMPER MOUNT SCALE: N.T.S.

MANUFACTURER:

MODEL:

WEIGHT:

DIMENSIONS:

SAMSUNG

97.5 LBS

B2/B66A RRH BR049

15.0"H X 15.9"W X 10.0"D

## Dewberry®

Dewberry Engineers Inc. SUITE 700 BOSTON, MA 02110 PHONE: 617.695,3400 FAX: 617.695,3310

VERIZON WIRELESS

118 FLANDERS ROAD

WESTBOROUGH, MA 01581-3956


HARVARD SQ 2 MA

ANTMO DRAWINGS

1 05/13/20 FOR SUBMITTAL

0 03/04/20 FOR SUBMITTAL

A 02/12/20 FOR REVIEW

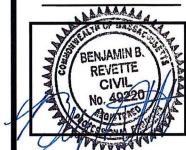

DRAWN BY: SCA CDH REVIEWED BY BBR CHECKED BY PROJECT NUMBER 50121487 50121514 JOB NUMBER: SITE NUMBER

137823

SITE ADDRESS


1654 MASSACHUSETTS AVE CAMBRIDGE, MA 02138

SHEET TITLE

CONSTRUCTION DETAILS & NOTES

SHEET NUMBER

A-5

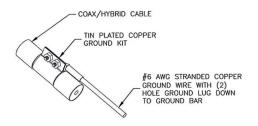


#### NOTES:

- DO NOT INSTALL CABLE GROUND KIT AT A BEND. ALWAYS DIRECT GROUND WIRE DOWN TO GROUND BAR.
- 2. GROUNDING KIT SHALL BE TIN PLATED COPPER WITH TWO-HOLE LUG, SIZE PER COAX DIAMETER
- 3. WEATHER SEAL GROUND KIT PER CARRIER REQUIREMENTS.
- 4. COAX CABLE GROUND KIT LOCATION & QUANTITY SHALL BE PER CARRIER SPECIFICATIONS & STANDARDS.

#### COAX/HYBRID GROUNDING DETAIL SCALE: N.T.S.



LTE 700/850

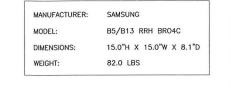



LTE AWS/PCS

- 1. COAX & JUMPERS NOT SHOWN FOR CLARITY.
- 2. GROUND RRHS AND MOUNTS PER MANUFACTURER'S RECOMMENDATIONS AND VERIZON WIRELESS STANDARDS.
- CONFIRM REQUIRED RRHS WITH THE LATEST ANTENNA REC.

**RRH DETAILS** 

NOTES:



# Application to Modify Special Permit

1654 Massachusetts Avenue Cambridge, MA



### Our Expertise. Your Future. Succeeding Together.®

Daniel D. Klasnick

Licensed in Massachusetts and New Hampshire dklasnick@dkt-legal.com

June 2, 2020

City of Cambridge Board of Zoning Appeals 41 Pleasant Street Methuen, Massachusetts 01844

Re: Application to Modify Special Permit – Eligible Facility
Building Mounted Mobile Communications Facility
Located at 1654 Massachusetts Avenue, Cambridge, Massachusetts

**Dear Board Members:** 

Enclosed please find an Application to the Board of Zoning Appeals to modify a special permit for the modification of an existing building mounted mobile communications facility submitted on behalf of Cellco Partnership d/b/a Verizon Wireless.

In accordance with the Application requirements, please find enclosed the following:

- Application;
- Support Statements;
- Application fee of \$500.00 To be Paid by Online Invoice
- Assessors GIS Block Map;
- Dimensional Form;
- Ownership Certificate, Notarized;
- Stamped Project Plans; and
- Photo Simulations

The Applicant would be happy to provide any additional information that you may require and would appreciate reasonable notice of any additional information you require in time to provide such information for the public hearing.

Should you require any additional information, please don't hesitate to contact me. Thank you very much for your cooperation.

Very truly yours,

DUVAL & KLASNICK LLC

Daniel D. Klasnick By:

Attorney at Law

### GENERAL INFORMATION

pecial Per	mit: X	Variance:	Appe	eal:
ETITIONER:	Cellco Partn	ership d/b/a Verizon Wirel	ess	
TITIONER'	S ADDRESS:	c/o Duval & Klasnick LLC ,	210 Broadway, Suite 203	, Lynnfield, MA 01940
OCATION OF	PROPERTY:	1654 Massachusetts Avenue	e	
YPE OF OCC	UPANCY: Ret	ail/Apartment	ZONING DISTRICT:	Residence C-2; Mass Ave Ove
EASON FOR	PETITION:			
	_ Additions	3		New Structure
	_ Change in	use/Occupancy		Parking
	_ Conversio	on to Addi'l Dwellin	ng Unit's	Sign
	_ Dormer			Subdivision
X		Iobile Communications Factor         nder Section 6409(a) of the		ble Facilities Request
TOOD TOWN		NER'S PROPOSAL:	,	
Aodification of 1 of 1 with 6 remote	f existing mobi  1 antennas) at t  radio heads at t	the same height on existing	chimneys. Remove 6 rer	note radio heads and replace
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for a total of 1  with 6 remote a  himneys. Plea  ECTIONS OF  rticle 4  rticle 10  rticle 6409  coplicants coplicants coplicants coplicants coplicants coplicants coplicants	f existing mobile and the search of the sear	the same height on existing the same location on the existing the same loc	chimneys. Remove 6 reresting chimneys. All equivalent Photo Simulations for Photo Simulations of Photo Simul	note radio heads and replace ipment to be painted to match more details.  d 6 letermination by the oncerning the reasons ck er(s)/Owner) mey for Cellco Partnership nt Name) 203

#### SUPPORTING STATEMENT FOR A SPECIAL PERMIT

Please describe in complete detail how you meet each of the following criteria referring to the property and proposed changes or uses which are requested in your application. Attach sheets with additional information for special permits which have additional criteria, e.g.; fast food permits, comprehensive permits, etc., which must be met.

Granting the Special Permit requested for 1654 Massachusetts Avenue (location) would not be a detriment to the public interest because:

A) Requirements of the Ordinance can or will be met for the following reasons:

As demonstrated by the documents provided with this application and will be further discussed at the hearing on this matter, the modification satisfies the standards for an Eligible Facilities Request pursuant to Section 6409(a) of the Federal Spectrum Act. The proposed modification also satisfies the standards for the grant of a special permit. (For further details, please see attached narrative and supporting documents)

B) Traffic generated or patterns of access or egress would not cause congestion hazard, or substantial change in established neighborhood character for the following reasons:

The modification of the unmanned facility will not change existing traffic demand or impact ingress or egress. The modified facility will continue to generate only about one to two vehicles trips per month in a standard passenger vehicle. (For further details, please see attached narrative and supporting documents)

C) The continued operation of or the development of adjacent uses as permitted in the Zoning Ordinance would not be adversely affected by the nature of the proposed use for the following reasons:

The modified facility will have no adverse effects on the operation or development of adjacent uses. The modified facility will emit no light, odor, dust or glare and generates no unusual noise or other adverse impacts. (For further details, please see attached narrative and supporting documents)

Nuisance or hazard would not be created to the detriment of the health, safety and/or welfare of the occupant of the proposed use or the citizens of the City for the following reasons:

The modified facility will generate no additional traffic or other negative impacts on surrounding properties or within the City of Cambridge. The facility requires no water or sewer services and emits no light, odor, dust or glare and generates no unusual noise or other adverse impacts. The facility will be unoccupied with no employees or customers. The availability of wireless services enhances the health, safety and welfare of the community. (For further details, please see attached narrative and supporting documents)

E) For other reasons, the proposed use would not impair the integrity of the district or adjoining district or otherwise derogate from the intent or purpose of this ordinance for the following reasons:

The facility has been designed to minimize its visual impact and is in harmony with the general purpose of the zoning ordinance and the previously issued special permits for this use and in accordance with the requirements for an Eligible Facilities Request under Section 6409(a). (Please see attached narrative and supporting documents)

(ATTACHMENT B - PAGE 6)

#### DIMENSIONAL INFORMATION

HONE: (781) 873-002	21	REQUESTED USE/OCCUPANCY: Mobile Communications Facility			
HONE:		EXISTING CONDITIONS	REQUESTED CONDITIONS	ORDINANCE REQUIREMENTS	
OTAL GROSS FLOOR	AREA:	22,978 sf	No Change	N/A	(max
LOT AREA:		17, 578 sf		5,000 sf.	(min
RATIO OF GROSS FLOOR AREA TO LOT AREA: <sup>2</sup>			No Change	1.75	_ (max
OT AREA FOR EACH	DWELLING UNIT:	N/A	No Change	600 Sf.	(min
IZE OF LOT:	WIDTH				(min
	DEPTH				-
etbacks in	FRONT		No Change	H+L/4	(min.
<u>eet</u> :	REAR		No Change	H+L/4	(min
	LEFT SIDE		No Change	H+L/5	(min
	RIGHT SIDE		No Change	H+L/5	(min
IZE OF BLDG.:	HEIGHT	62'6" (roof level)	No Change	85'	(max
	LENGTH	69' (top of chimne	ys)		
	WIDTH				
RATIO OF USABLE OPEN SPACE					
) LOT AREA: 3)		N/A	N/A	None	(min
NO. OF DWELLING UNITS:		N/A	N/A	N/A	_(max
NO. OF PARKING SPACES:		N/A	N/A	N/A (mi	n./ma
NO. OF LOADING AREAS:		N/A	N/A	N/A	(min
DISTANCE TO NEAREST BLDG. DN SAME LOT:		N/A	No change	N/A	(min
			ame lot, the size		

<sup>1.</sup> SEE CAMBRIDGE ZONING ORDINANCE ARTICLE 5.000, SECTION 5.30 (DISTRICT OF DIMENSIONAL REGULATIONS).

<sup>2.</sup> TOTAL GROSS FLOOR AREA (INCLUDING BASEMENT 7'-0" IN HEIGHT AND ATTIC AREAS GREATER

THAN 5') DIVIDED BY LOT AREA.

3. OPEN SPACE SHALL NOT INCLUDE PARKING AREAS, WALKWAYS OR DRIVEWAYS AND SHALL HAVE A MINIMUM DIMENSION OF 15'.

#### CHECK LIST

DATE: May 2, 2020

PROPERTY LOCATION: 1654 Massachusetts Avenue


PETITIONER OR REPRESENTATIVE: Cellco Partnership d/b/a Verc/o Duval & Klasnick LLC, 210 Broadway, Suite			
ADDRESS & PHONE: (781) 873-0021 - Daniel D. Klasnick, Esquire			
BLOCK: 173 LOT:	: 48	_	
PLEASE CHECK THAT YOU HAVE INCLUDED THE FOLLOWING WILL NOT BE ACCEPTED FOR PROCESSING & SCHEDULING PROVIDED.			
PLEASE INCLUDE THIS CHECKLIST WITH YOUR APPLICATION. ALL DOCUMENTS ARE TO BE TYPED OR WRITTEN LEGIBLY.			
DOCUMENTS	REQUIRED	ENCLOSED	
Application Form  3 Forms with Original Signatures	<u>X</u>	_X	
Supporting Statements - Scanned & 1 set to Zoning	_X	X	
Application Fee (You will receive invoice online)	_X	_ X	
Assessor's GIS "Block Map" (Available on line or At Engineering Dept 147 Hampshire Street)	<u>X</u>	X	
Dimensional Form - Refer to Cambridge Zoning Ordinance - Scanned & 1 set to Zoning (Subject to further review by Zoning Specialist)	<u>X</u>	<u>X</u>	
Ownership Certificate, Notarized - Scanned & 1 set to Zoning	<u>X</u>	<u>X</u>	
Floor Plans - Scanned & 1 set to Zoning	X	X	
Elevations - Scanned & 1 set to Zoning	_X	_X	
Certified Plot Plan - Scanned & 1 set to Zoning (By Registered Land Surveyor)	X	X	
Photographs of Property - Scanned & 1 set to Zoning	X	X	
Parking Plan (if relevant to your application) Scanned & 1 set to Zoning	N/A	N/A	
FOR SUBDIVISION ALSO INCLUDE: Scanned & 1 set to Zonia	ng		
Proposed Deeds	N/A	N/A	
Evidence of Separate Utilities **	N/A	N/A	
Proposed Subdivision Plan	N/A	N/A	
Petitioners are advised to refer to Attachment A (Pr	rocedures for applyi	ng to the Board	

of Zoning Appeal) & consult zoning staff for review.

It is advisable for the Petitioner to discuss the petition with the abutters as listed in the Zoning BZA Case file.

 $<sup>^{\</sup>star}$  For Special Permits under Art. 4.32.G.1 (Communication Towers and Antennas), include a photo simulation.

<sup>\*\*</sup> Can be submitted after subdivision has been approved.

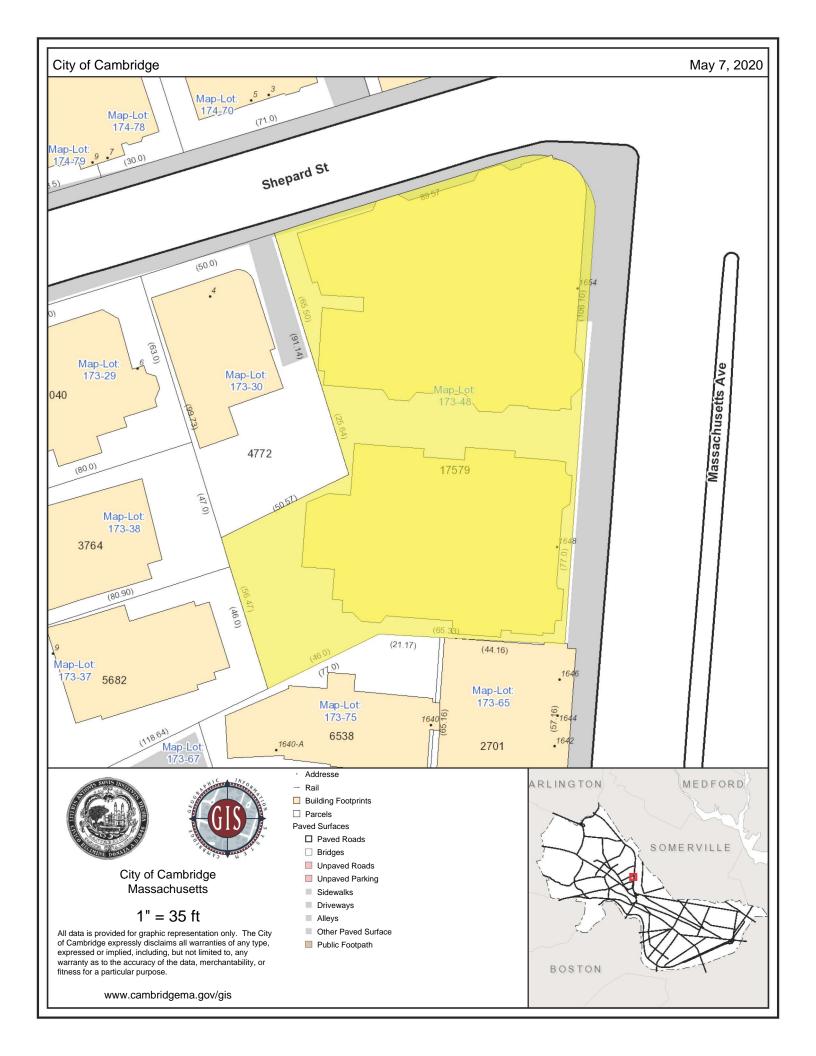

#### CITY OF CAMBRIDGE

### NARRATIVE IN SUPPORT OF APPLICATION TO MODIFY SPECIAL PERMIT

**APPLICANT:** Cellco Partnership d/b/a Verizon Wireless

**SITE ADDRESS:** 1654 Massachusetts Avenue

Cambridge, Massachusetts

**ASSESSOR'S LOT I.D.:** Map 173, Lot 48

**ZONING DISTRICT:** Residence (C-2) and Massachusetts Avenue Overlay

District

#### **BACKGROUND**

This Narrative in Support of an Application to Modify Special Permit, *while reserving all rights*, to modify an existing building mounted mobile communications facility ("Facility") is respectfully submitted by Cellco Partnership d/b/a Verizon Wireless ("Verizon Wireless") to the City of Cambridge, Board of Zoning Appeal ("Board"). Verizon Wireless seeks approval to further modify its existing Facility approved by special permit Case No: #9282 as previously amended by Case No: #BZA-012742-2017 on the existing building at 1654 Massachusetts Avenue Street (the "Property").

This application is submitted with full reservation of Verizon Wireless' rights including without limitation Section 6409(a) of the federal Middle Class Tax Relief and Job Creation Act of 2012 also referred to as the "Spectrum Act." The Spectrum Act was passed to "advance wireless broadband service" for both public safety and commercial purposes. The modification to the existing Facility satisfies the standards for the modification of an eligible facility under the Spectrum Act.

#### APPLICANT'S INTEREST IN THE PROPERTY

Clifford V. Miller Trust ("Owner") and Cellco Partnership d/b/a Verizon Wireless entered into a certain Lease Agreement by which Owner leased to Verizon Wireless building space and access/utility easement rights on a portion of the Owner's property located at 1654 Massachusetts Avenue being shown on Tax Map of the City of Cambridge at Map 173, Lot 48 for the location of Verizon Wireless' antennas and space for its equipment.

See Exhibit 1, ZBA Application Form - Ownership Information.

#### PROJECT DESCRIPTION

As noted on the attached plans and described in this application, the building owned by Clifford V. Miller Trust is a 6-story brick building used for apartment purposes (the "Building"). In compliance with Special Permit Case No: #9282 as previously amended by Case No: #BZA-012742-2017, Verizon Wireless has installed and operates an existing Facility consisting of 3 sectors of 3 antennas each (9 in total) and equipment room in the Building. The existing antennas are chimney mounted painted to match.

#### **Facility Modification Details**

#### **Total of Eleven (11) Antennas with Remote Radio Heads**

Verizon Wireless proposes to mount a total of eleven (11) antennas through replacing 6 antennas and installing 3 new antennas while maintaining 2 existing antennas to the side of the 3 existing chimneys that will be painted to match the color of the chimneys with remote radio heads as follows:

(a) <u>Alpha Sector Chimney Mounted Equipment</u> (northerly orientation toward Shepard Street)

Remove 3 antennas and 2 remote radio heads. Install 3 new antennas with 2 antennas mounted on a side-by-side bracket attached to the existing mast pipe (paint to match) and install one antenna on existing pipe mast (enclosed with 3M wrap to match) at a height to match the existing antennas. Install 2 remote radio heads mounted to existing pipe mounts on chimney. Total: 3 antennas and 2 remote radio heads. – *See Roof Plan Sheet A-1*.

(b) <u>Beta Sector Chimney Mounted Equipment</u> (easterly orientation toward Massachusetts Avenue)

Remove 2 antennas and 2 remote radio heads. Install 3 new antennas with 2 antennas mounted on a side-by-side bracket attached to the existing mast pipe (paint to match) and install one antenna on existing pipe mast (enclosed with 3M wrap to match) at a height to match the existing antennas. Install 2 remote radio heads mounted to existing pipe mounts on chimney. Total: 4 antennas and 2 remote radio heads. – *See Roof Plan Sheet A-1*.

(c) Gamma Sector Chimney Mounted Equipment (westerly orientation)

Remove 2 antennas and 2 remote radio heads. Install 3 new antennas with 2 antennas mounted on a side-by-side bracket attached to the existing mast pipe (paint to match) and install one antenna on existing pipe mast (enclosed with 3M wrap to match) at a height to match the existing antennas. Install 2 remote radio heads mounted to

existing pipe mounts on chimney. Total: 4 antennas and 2 remote radio heads. – *See Roof Plan Sheet A-1*.

There will be no changes to the location of the equipment room

Access to the site is directly available via Massachusetts Avenue or Shepard Street. The site will be visited by Verizon Wireless personnel approximately once per month in a single service vehicle.

Electric and telephone lines run from the basement inside of the building to the basement equipment room. The generator will continue to be connected by power, control conduit and natural gas line.

See Exhibit 2, Plans. See Exhibit 3, Photo Simulations

#### SATISFACTION OF ELIGIBLE FACILITIES REQUEST STANDARDS

On February 22, 2012, President Obama signed into law H.R. 3630, known as the "Middle Class Tax Relief and Job Creation Act of 2012," which then became Public Law 112-96 ("P.L. 112-96"). Section 6409(a) of P.L. 112-96 adds new language to the existing body of laws, regulations, and decisions pertaining to wireless facility zoning.<sup>2</sup>

Verizon Wireless respectfully submits the proposed modifications satisfy the standards for an eligible facility request pursuant to 47 U.S.C. §1455 and 47 C.F.R. §1.6100. In an effort to advance Congress' goal of facilitating the rapid deployment of qualified modifications, the Federal Communications Commission adopted rules in 2014 that clarified many of the terms of Section 6409(a). The Commission stated that the purpose of implementing the rules "will serve the public interest by providing guidance to all stakeholders on their rights and responsibilities under the provision, reducing the delays

(a) FACILITY MODIFICATIONS.—

<sup>&</sup>lt;sup>1</sup> Middle Class Tax Relief and Job Creation Act of 2012, Pub L. No. 112-96, 126 Stat. 156 (2012).

<sup>&</sup>lt;sup>2</sup> Section 6409(a) states:

<sup>(1)</sup> IN GENERAL.—Notwithstanding section 704 of the Telecommunications Act of 1996 (Public Law 104–104) or any other provision of law, a State or local government may not deny, and shall approve, any eligible facilities request for a modification of an existing wireless tower or base station that does not substantially change the physical dimensions of such tower or base station.

<sup>(2)</sup> ELIGIBLE FACILITIES REQUEST.—For purposes of this subsection, the term "eligible facilities request" means any request for modification of an existing wireless tower or base station that involves—

<sup>(</sup>A) collocation of new transmission equipment;

<sup>(</sup>B) removal of transmission equipment; or

<sup>(</sup>C) replacement of transmission equipment.

<sup>(3)</sup> APPLICABILITY OF ENVIRONMENTAL LAWS.—Nothing in paragraph (1) shall be construed to relieve the Commission from the requirements of the National Historic Preservation Act or the National Environmental Policy Act of 1969.

<sup>&</sup>lt;sup>3</sup> See Accelerating of Broadband Deployment by Improving Wireless Facilities Siting Policies, Report and Order, 29 FCC Rcd 12865 (2014) ("2014 Order").

in the review process for wireless infrastructure modifications, and facilitating the rapid deployment of wireless infrastructure, thereby promoting the advanced wireless broadband services."<sup>4</sup>

47 U.S. Code §1455(a) and 47 C.F.R. §1.6100(b) builds on the existing legal framework for wireless facilities by requiring permitting authorities to approve an eligible facilities request in an effort to streamline "the process for siting of a wireless facility by preempting the ability of State and local authorities to delay collocation of, removal of, and replacement of wireless transmission equipment." "Collocation" is defined as "the mounting or installation of transmission equipment on an eligible support structure for the purpose of transmitting and/or receiving radio frequency signals for communications purposes." The term "eligible support structure" means any structure that is a "tower" or "base station." A "base station" is defined as a structure or equipment that enables Commission-licensed or authorized wireless communications and includes any structure other than a tower that supports or houses permitted equipment used for wireless communications services. The term "eligible facilities request" includes any request for modification of an existing wireless tower or base station that involves— (i) collocation of new transmission equipment; (ii) removal of transmission equipment; or (iii) replacement of transmission equipment.

The Property constitutes a "base station" and an "eligible support structure" in that it currently exists and "supports and houses" wireless communication equipment that has been reviewed and approved under the City's zoning ordinance. The proposed replacement of the Verizon Wireless antennas and remote heads on the Property for the purpose of transmitting and receiving radio frequency signals for communication purposes constitutes a "replacement of transmission equipment" and the proposed addition of antennas is the "collocation of new transmission equipment."

Federal authorities clearly provide that an eligible facilities request must be approved if the installation does not result in a substantial change.<sup>8</sup> The proposed modifications to the existing Verizon Wireless facility is an "eligible facilities request." Through its statutory mandate and given the lack of statutory definitions, the Federal Communications Commission has defined a substantial change under Section 6409(a) as follows:

- (i) For other eligible support structures (i.e., the "Building"), it increases the height of the structure by more than 10% or more than ten feet, whichever is greater There will be no increase in height. The proposed chimney mounted antennas and remote radio heads will not be any higher.
- (ii) For other eligible support structures (i.e., the "Building"), it involves adding an appurtenance to the body of the structure that would protrude from the edge of the structure

<sup>&</sup>lt;sup>4</sup> Id. At 12872.

<sup>&</sup>lt;sup>5</sup> 158 Cong. Rec. E237 (daily ed. Feb. 24, 2012) (statement of Rep. Upton).

<sup>&</sup>lt;sup>6</sup> 47 C.F.R. §1.6100(b)(1)

<sup>&</sup>lt;sup>7</sup> 47 U.S.C. § 1455(a)(2) and §1.6100(b)(3)

<sup>&</sup>lt;sup>8</sup> See 47 U.S.C. §1455(a) and 47 C.F.R. §1.6100(b)

by more than six feet – The proposed additional and replacement antennas will not protrude more than six feet from the chimneys.

- (iii) For any eligible support structure (i.e., the "Building"), it involves installation of more than the standard number of new equipment cabinets for the technology involved, but not to exceed four cabinets; or, it involves installation of any new equipment cabinets on the ground if there are no pre-existing ground cabinets associated with the structure The proposed modification does not involve the installation of new cabinets. All radio equipment will remain at the current location.
- (iv) It does not entail any excavation or deployment outside the current site **The** modification does not involve any excavation or deployment outside the current site.
- (v) It would not defeat the concealment elements of the eligible support structure Verizon Wireless' modifications do not defeat any concealment elements the replacement antennas mounted to the side of the chimneys will be at the same location and height as the replaced antennas (painted to match) the color.
- (vi) It complies with conditions associated with the siting approval **The** installation will remain compliant with the existing special permits.

It is clear that state and local authorities have no power to deny a complying installation, and any attempt to do so would be in direct conflict with federal law. Having satisfied the standards for the modification of an eligible support structure that will not result in a substantial change, the Board may not deny the Section 6409(a) Modification. Consistent with that determination, the permitting is limited to non-discretionary permitting related to applicable building, structural and electrical codes. Additionally, when an applicant asserts in writing that a request for a modification is covered by this section, a State or local government may only require the applicant to provide documentation or information to the extent reasonably necessary to determining whether the request meets the requirements for an eligible facilities request. Further, the Federal Communications Commission also adopted rules that require local review subject to Section 6409(a) be completed within sixty (60) days. A Section 6409(a) request will be "deemed granted" if not approved within the sixty (60) day period.

#### SATISFACTION OF SPECIAL PERMIT REVIEW STANDARDS

Based on the description set forth herein, and as will be further demonstrated at the Public Hearing on this matter, the proposed modification of the Facility meets the location, height and site requirements of Section 4.32(g)(1), Section 4.40 (footnote 4) and Sections 10.40 - 10.46. Pursuant to Ordinance, the modification of the Facility is allowed upon the grant of a modification to the special permit from the Zoning Board of Appeals in the currently designated Special District 10-H (SD-10H).

While reserving all rights, Verizon Wireless' modification satisfies the standards set forth in Section 4.40 (footnote 4) and Sections 10.40 – 10.46 of the City of Cambridge, Zoning Ordinance.

1. The scope of or limitations imposed by any license secured from any state or federal agency having jurisdiction over such matters — Verizon Wireless operates in compliance with all of the rules and regulations promulgated by the Federal Communications Commission as required by its licensing.

#### See Exhibit 4, FCC License to Operate.

- 2. The extent to which the visual impact of the various elements of the proposed facility is minimized: (1) Through the use of existing mechanical elements on a building's roof or other features of the building as support and background, (2) Through the use of materials that in texture and color blend with the materials to which the facilities are attached, or (3) Other effective means to reduce the visual impact of the facility from off the site Verizon Wireless proposes to mount a total of eleven (11) antennas to the side of the 3 existing chimneys that will be painted to match the color of the chimneys with remote radio heads.
- 3. Where it is proposed to erect such a facility in any residential zoning district, the extent to which there is a demonstrated public need for the facility at the proposed locations, the existence of alternative, functionally suitable sites in nonresidential locations, the character of the prevailing uses in the area, and the prevalence of other, existing mechanical systems and equipment carried on or above the roof of nearby structures. The Board of Zoning Appeal shall grant a special permit to erect such a facility in a residential zoning district only upon a finding that nonresidential uses predominate in the vicinity of the proposed facility's location and that the telecommunication facility is not inconsistent with the character that does prevail in the surrounding neighborhood The wireless use and modification of the Facility is consistent with the purpose of the Residence (C-2) District to encourage use that is in harmony with the adjacent neighborhood and residential uses.

The proposed modification also satisfies the standards of Section 10.43 of the Ordinance for the grant of special permits. As noted above, the proposed modification will allow Verizon Wireless to improve wireless signal coverage and is an integral part of Verizon Wireless' network design in the City of Cambridge. The modification of the equipment detailed herein will aid in reaching Verizon Wireless' goal to provide enhanced service and communications in the City of Cambridge. The proposed modification will generate no traffic or other negative impacts on surrounding properties or the City of Cambridge. The WTF requires no water or sewer services. The utilities will continue to be obtained from existing service. The Facility will continue to be unoccupied, with no employees or customers. The Facility will continue to be regularly maintained by qualified technicians to assure that the equipment operates at optimal condition so that no threat of explosion, fire or other danger to life or property occurs. Reliable wireless service also enhances community safety, because it is used by public safety officials as well as the public in times of crisis, natural disaster, inclement weather and similar circumstances.

It is a truism to state that it is absolutely essential that there is the necessary infrastructure to ensure access to reliable wireless services. The ability to utilize mobile

devices has become so integral that the absence of reliable service certainly has a negative impact. The availability of reliable wireless service also provides greater access to 911 emergency services. Maintaining wireless service provides another tool for ensuring that emergencies can be reported as quickly as possible, which reduces the response times of public safety personnel.

Because the application is for the modification of equipment that provides wireless services, the proposal is subject to \$704 of the federal Telecommunications Act of 1996 ("TCA"), codified at 47 U.S.C. \$332(c)(7)(B). By way of background, the TCA is a federal law enacted in 1996 whose purpose is "[t]o promote competition and reduce regulation in order to secure lower prices and higher quality services for American telecommunications consumers and encourage the rapid deployment of new telecommunications technologies." To further this purpose, the TCA established national standards that apply to permitting for wireless facilities. These standards preempt inconsistent state and local laws, so they must be considered in making decisions related to wireless facilities.

The proposed modification of the existing Facility satisfies the criteria for granting a special permit, Verizon Wireless respectfully requests that the Board modify the existing special permit to allow for the proposed upgrade of this existing mobile communications system.

#### **CONCLUSION**

The availability of wireless communications service enhances community safety, and is increasingly relied upon by civil defense and other safety officers as well as the general public in times of crisis, natural disaster, bad storms or similar circumstances. Wireless communications service also provides a convenience to residents, and is an attractive feature and service to businesses. The proposed modification, by providing these services, will promote the health, safety, convenience and general welfare of the inhabitants of the City of Cambridge.

In compliance with Section 6409(a) of the federal Middle Class Tax Relief and Job Creation Act of 2012, the proposed modification constitutes an eligible facilities request entitled to approval. In the alternative, with all rights reserved, the proposed modification meets all the standards for a special permit pursuant to the City's Zoning Ordinance. Verizon Wireless respectfully requests that the Board vote to grant a special permit or modification to Special Permit #9615 and any other relief pursuant to the City of Cambridge Zoning Ordinance, Massachusetts General Laws chapter 40A, and, the federal Telecommunications Act of 1996.

# Exhibit 1 "ZBA Application Form – Ownership Information"

#### BZA APPLICATION FORM - OWNERSHIP INFORMATION

To be completed by OWNER, signed before a notary and returned to The Secretary of the Board of Zoning Appeals.

I/We John Kurt Miller, Trustee
(OWNER)
Address: 1396 Beacon Street, Brookline, MA 02446
State that I/We own the property located at 1654 Massachusetts Avenue ,
which is the subject of this zoning application.
The record title of this property is in the name of Clifford V. Miller Trust
*Pursuant to a deed of duly recorded in the date 12.29.1972 , Middlesex South County Registry of Deeds at Book 12356 , Page 367 ; or
Middlesex Registry District of Land Court, Certificate No.
Book Page
SIGNATURE BY LAND OWNER OR AUTHORIZED TRUSTEE, OFFICER OR AGENT*  *Written evidence of Agent's standing to represent petitioner may be requested.
Commonwealth of Massachusetts, County of Middle X
The above-name
this $\frac{29th}{}$ of $\frac{1}{200}$ , and made oath that the above statement is true.
Toloron Robert or Notary
My commission expires 12-31-2021 (Notary Seal) REBECCA A. RAFFERTY Notary Public Commonwealth of Massachusetts My Commission Expires December 31, 2021


 If ownership is not shown in recorded deed, e.g. if by court order, recent deed, or inheritance, please include documentation.

## Exhibit 2 "Plans"



## HARVARD SQ 2 MA

## 1654 MASSACHUSETTS AVENUE CAMBRIDGE, MA 02138

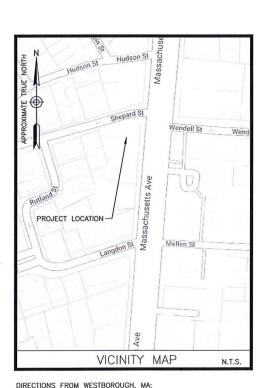

TAKE MA-9 E. MERGE ONTO I-90 E. TAKE EXIT 18 TOWARD CAMBRIDGE. SLIGHT RICHT ONTO CAMBRIDGE STREET. CONTINUE ONTO RIVER STREET. TURN LEFT ONTO PUTNAM AVENUE. SLIGHT

LEFT ONTO MASSACHUSETTS AVENUE. TURN LEFT ONTO SHEPARD STREET. THE SITE WILL BE ON THE LEFT.

#### **ENGINEER**

DEWBERRY ENGINEERS INC. 99 SUMMER ST. SUITE 700 BOSTON, MA 02110

PHONE # (617) 531-0813 FAX # (617) 695-3310

#### CONSTRUCTION

VERIZON WIRELESS 118 FLANDERS ROAD WESTBOROUGH, MA 01581-3956

PHONE # (401) 545-3175 CONTACT: STEVE RYAN

CONSULTANT TEAM

#### SITE NAME: HARVARD SQ 2 MA

### PROPERTY OWNER: TUCKER REED MILLER

C/O CLIFFORD V MILLER INC. 1396 BEACON STREET BROOKLINE, MA 02446

## APPLICANT: CELLCO PARTNERSHIP D/B/A VERIZON WIRELESS 118 FLANDERS ROAD

ELECTRIC UTILITY: EVERSOURCE 1-800-592-2000

TELEPHONE UTILITY: VERIZON 1-800-870-9999

CENTER OF EXISTING STRUCTURE\*: LATITUDE: 42' 22' 53.9" N LONGITUDE: 71' 07' 12.4" W \* PER HANDHELD GPS

PROJECT SUMMARY

#### SITE ADDRESS: 1654 MASSACHUSETTS AVENUE

#### PROJECT DIRECTORY

THE SITE WILL CONSIST OF REMOVING (7) EXISTING PANEL ANTENNAS AND REPLACING WITH (6) NEW PANEL ANTENNAS (2/SECTOR) AND (3) NEW NR ANTENNAS (1/SECTOR) FOR A FINAL TOTAL OF (11) ANTENNAS ON SITE. (6) RRHS WILL BE REMOVED AND REPLACED WITH (6) NEW RRHS (2/SECTOR).

#### PROJECT DESCRIPTION

THIS DOCUMENT WAS DEVELOPED TO REFLECT A SPECIFIC SITI AND ITS SITE CONDITIONS AND IS NOT TO BE USED FOR ANOTHER SITE OR WHEN OTHER CONDITIONS PETAIN, REUSE OF THIS DOCUMENT IS AT THE SOLE PISK OF THE USER

A.D.A. COMPLIANCE: FACILITY IS UNMANNED AND NOT FOR HUMAN HABITATION.

NO.	DESCRIPTION
T-1	TITLE SHEET
A-1	ROOF PLAN
A-2	EAST & NORTH ELEVATIONS
A-3	WEST ELEVATION
A-4	CONSTRUCTION DETAILS
A-5	CONSTRUCTION DETAILS & NOTES

SHEET INDEX



VERIZON WIRELESS 118 FLANDERS ROAD WESTBOROUGH, MA 01581-3956

HARVARD SQ 2 MA

	ANTMC	DRAWINGS
1	05/13/20	FOR SUBMITTAL
0	03/04/20	FOR SUBMITTAL
Α	02/12/20	FOR REVIEW



Dewberry Engineers Inc. 98 SUMMER STREET SUITE 700 BOSTON, MA 02110 PHONE: 617.695.3400 FAX: 617.695.3410



DRAWN BY:	SCA
REVIEWED BY:	CDH
CHECKED BY:	BBR
PROJECT NUMBER:	50121487
JOB NUMBER:	50121514
SITE NUMBER	

1654 MASSACHUSETTS AVE CAMBRIDGE, MA 02138


SHEET TITLE

TITLE SHEET

SHEET NUMBER

SITE ADDRESS

T-1

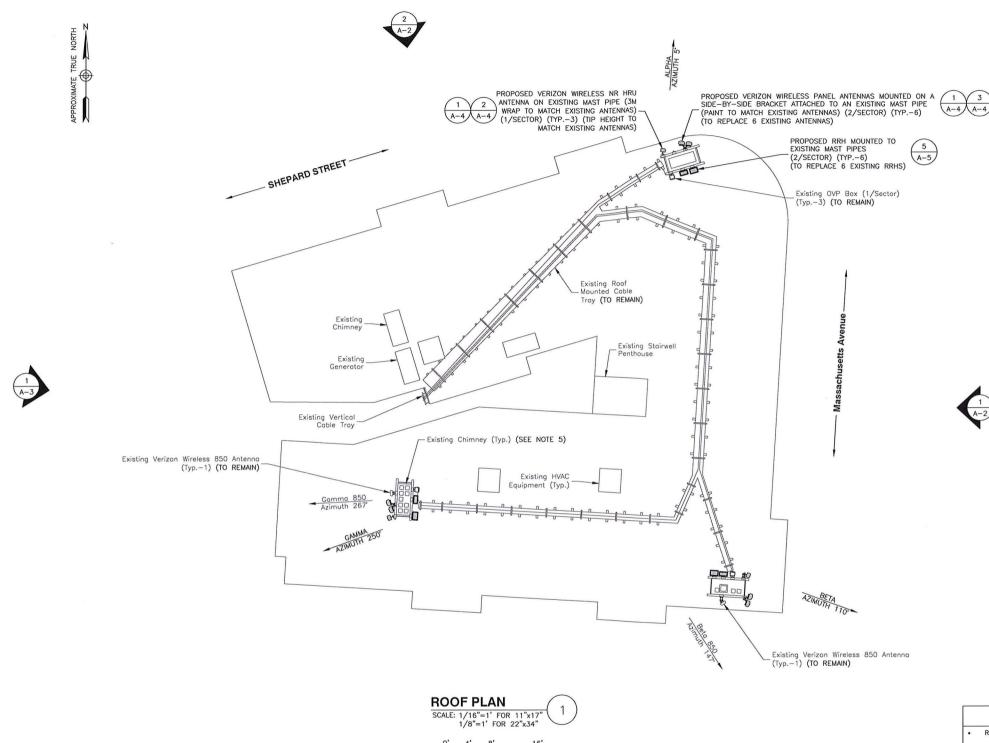

#### SCOPE OF WORK

- REMOVE (1) 850 ANTENNA FROM ALPHA SECTOR
- REMOVE (6) HEX ANTENNAS (2/SECTOR)
- REMOVE (6) RRHS (2/SECTOR)
- INSTALL (6) NEW PANEL ANTENNAS ON SIDE-BY-SIDE MOUNTS ATTACHED TO EXISTING MAST PIPES (2 ANTENNAS/SECTOR)
- INSTALL (3) NEW NR HRU ANTENNAS ON EXISTING MAST PIPES (1/SECTOR)
- INSTALL (6) NEW RRHS (2/SECTOR)
- INSTALL ADDITIONAL JUMPER CABLES BETWEEN SECTOR OVPS, RRHS, & ANTENNAS.
- EXISTING & PROPOSED ANTENNAS & MOUNTS SHALL BE GROUNDED PER VERIZON WIRELESS SPECIFICATIONS

SCOPE OF WORK BASED ON RFDS FOR HARVARD SQ 2 MA DATED 01/21/2020. VERIFY SCOPE OF WORK WITH FINAL RFDS PRIOR TO CONSTRUCTION.



VERIZON WIRELESS 118 FLANDERS ROAD WESTBOROUGH, MA 01581-3956

**HARVARD SQ 2 MA** 

		ANTMO	DRAWINGS
١	1		FOR SUBMITTAL
١	0	03/04/20	FOR SUBMITTAL
ı	Α	02/12/20	FOR REVIEW



Dewberry Engineers Inc. 99 SUMMER STREET SUITE 700 BOSTON, MA 02110 PHONE: 617.695.3310 FAX: 617.695.3310



DRAWN BY: SCA

REVIEWED BY: CDH

CHECKED BY: BBR

PROJECT NUMBER: 50121487

JOB NUMBER: 50121514

SITE NUMBER

137823

SITE ADDRESS

1654 MASSACHUSETTS AVE CAMBRIDGE, MA 02138

SHEET TITLE


ROOF PLAN

SHEET NUMBER

A-1

#### SITE NOTES:

- 1. NORTH ARROW SHOWN AS APPROXIMATE.
- 2. EXISTING BUILDING AND ANTENNA ELEVATIONS ARE APPROXIMATE AND HAVE NOT BEEN VERIFIED WITH A MAPPING.
- 3. PLANS BASED ON SITE VISIT BY DEWBERRY ENGINEER ON 01/08/20.
- 4. INSTALL ALL EQUIPMENT PER STRUCTURAL ASSESSMENT LETTER BY DEWBERRY ENGINEERS INC. DATED 01/29/20.
- CONTRACTOR TO INSPECT CONDITIONS OF ALL EXISTING ANCHORS/THREADED RODS FOR SIGNS OF RUST. WHERE RUST IS FOUND, APPLY COLD GALVANIZING COMPOUND TO PROTECT ANCHORS/THREADED RODS FROM CORROSION.
- CONTRACTOR TO UTILIZE 3M WRAP FOR ALL NR HRU ANTENNAS TO MATCH SURROUNDING AREAS. INSTALL 3M WRAP ON ANTENNAS PER MANUFACTURER'S SPECIFICATION & RECOMMENDATIONS.

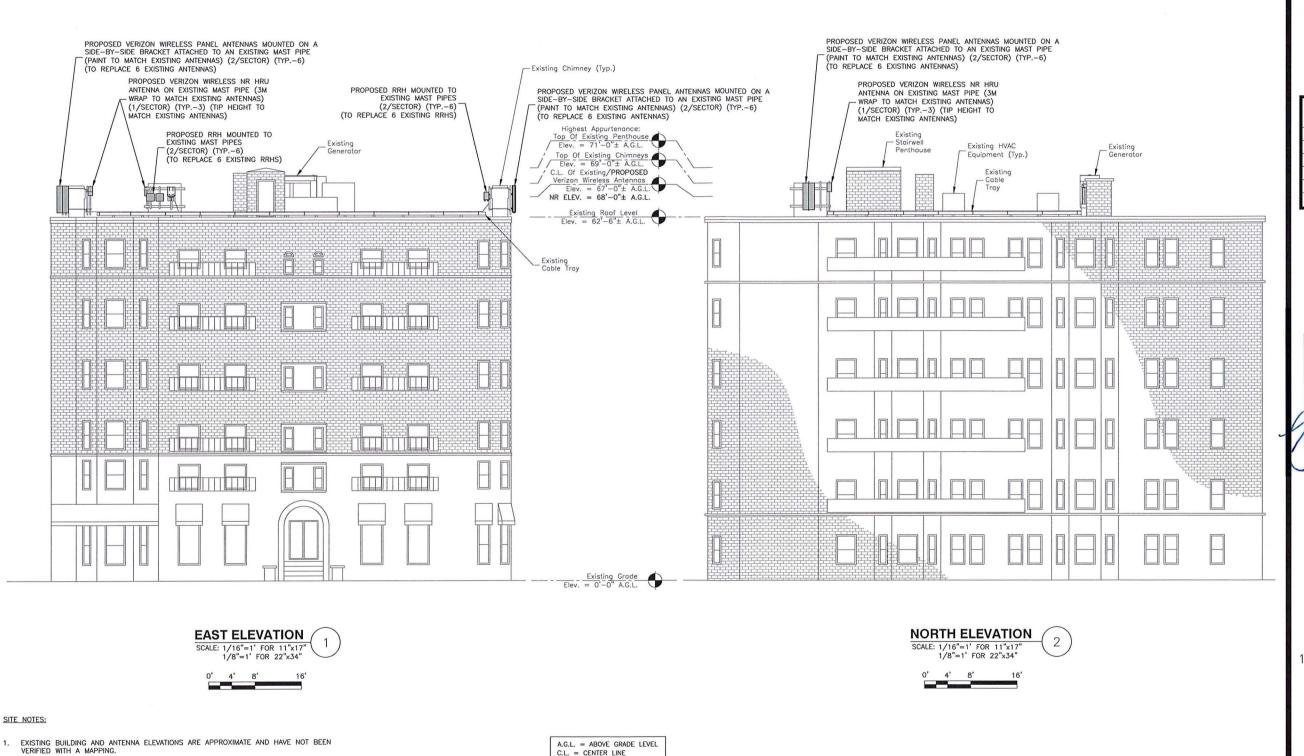

2. PLANS BASED ON SITE VISIT BY DEWBERRY ENGINEERS INC ON 01/08/20.



VERIZON WIRELESS 118 FLANDERS ROAD WESTBOROUGH, MA 01581-3956

HARVARD SQ 2 MA

ANTMO DRAWINGS

1 05/13/20 FOR SUBMITTAL
0 03/04/20 FOR SUBMITTAL
A 02/12/20 FOR REVIEW



Dewberry Engineers Inc.
99 SUMMER STREET
SUITE 700
BOSTON, MA 02110
PHONE: 617.695.3400
FAX: 617.695.3310



DRAWN BY: SCA

BBR

REVIEWED BY: CDH

PROJECT NUMBER: 50121487

JOB NUMBER: 50121514

SITE NUMBER

CHECKED BY:

137823

SITE ADDRESS


1654 MASSACHUSETTS AVE CAMBRIDGE, MA 02138

SHEET TITLE

EAST & NORTH ELEVATIONS

SHEET NUMBER

A-2

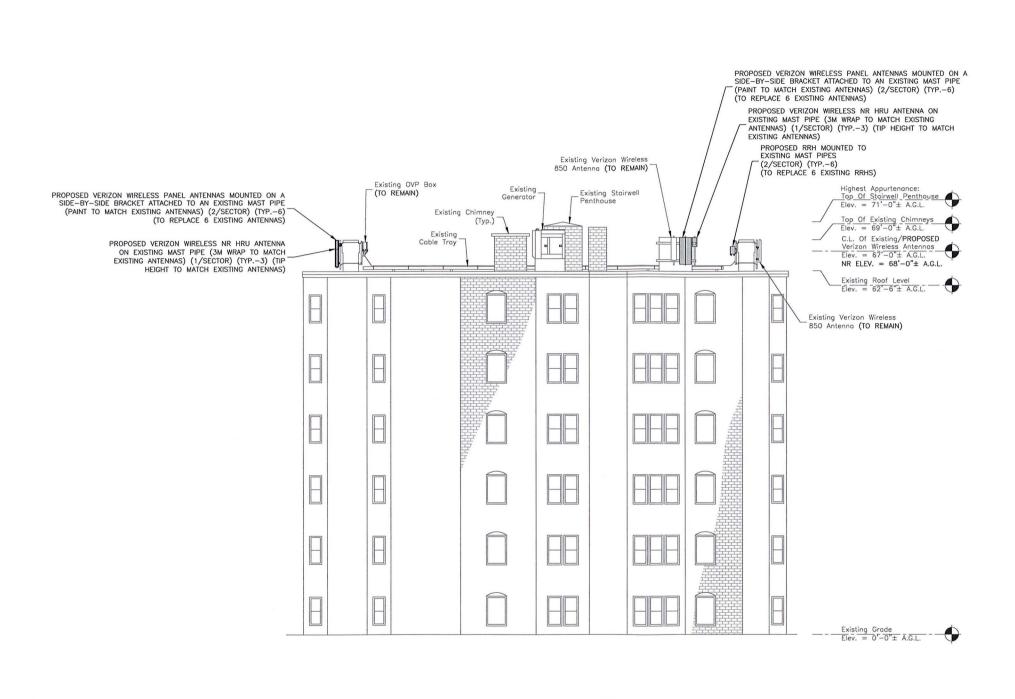

A.G.L. = ABOVE GRADE LEVEL C.L. = CENTER LINE WEST ELEVATION
| SCALE: 1/16"=1' FOR 11"x17" | 1/8"=1' FOR 22"x34"



#### SITE NOTES:

- EXISTING BUILDING AND ANTENNA ELEVATIONS ARE APPROXIMATE AND HAVE NOT BEEN VERIFIED WITH A MAPPING.
- 2. PLANS BASED ON SITE VISIT BY DEWBERRY ENGINEERS INC ON 01/08/20.



VERIZON WIRELESS 118 FLANDERS ROAD WESTBOROUGH, MA 01581-3956

HARVARD SQ 2 MA

ANTMO DRAWINGS				
1	05/13/20	FOR	SUBMITTAL	
0	03/04/20	FOR	SUBMITTAL	
Α	02/12/20	FOR	REVIEW	



Dewberry Engineers Inc. 99 SUMMER STREET SUITE 700 BOSTON, MA 02110 PHONE: 617.695.3400 FAX: 617.695.3310



DRAWN BY: SCA

BBR

REVIEWED BY: CDH

CHECKED BY:

PROJECT NUMBER: 50121487

JOB NUMBER: 50121514

SITE NUMBER

137823

SITE ADDRESS

1654 MASSACHUSETTS AVE CAMBRIDGE, MA 02138

SHEET TITLE

WEST ELEVATION

SHEET NUMBER

A-3

#### **EXISTING CONFIGURATION**

ANTENNA POSITION 1

Panel ED)

(TO BE REMOVE

ANTENNA POSITION 4

#### ALPHA SECTOR

ANTENNA POSITION 1 ANTENNA POSITION 2 ANTENNA POSITION 3 Pan (ED) 4CW0000G Pane BE REMOVED) BXA-80063/4CF + (TO BE REMOVE TO BE REMOVE X654 (To

#### BETA/GAMMA SECTORS

ANTENNA POSITION 2 ANTENNA POSITION 3 /0000G Panel REMOVED)

4CW(

X65,

ANTENNA POSITION 4 (EMPTY)

-80063/4CF Par (TO REMAIN)

BXA-

POSITION 3

.80063/4CF Par (TO REMAIN)

BXA-

PROPOSED CONFIGURATION

#### ALPHA SECTOR

ANTENNA

ANTENNA POSITION 2 (EMPTY) ANTENNA POSITION 3

PANE

ANTENNA POSITION 4 (EMPTY)

ANTENNA POSITION 1


BETA/GAMMA SECTORS ANTENNA POSITION 2

> ROPOSED PANEL (TO REPLACE EXI PANEL ACE EX

ANTENNA POSITION 4 (EMPTY)



PROPOSED BRACKET PROPOSED VERIZON WIRELESS NR ANTENNA SIDE

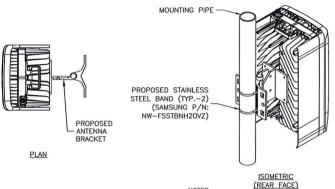


NOTES:

MANUFACTURER: SAMSUNG NR HRU PART NUMBER: DIMENSIONS: 18.5"H X 9.6"W X 6.9"D 33 LBS WEIGHT:

- INSTALL ALL EQUIPMENT PER MANUFACTURER'S RECOMMENDATIONS. USE APPROPRIATE MOUNTING HARDWARE FOR CONSTRUCTION TYPE.
- ANTENNAS ARE SHOWN PERPENDICULAR TO BUILDING FACADE. ANTENNAS WILL BE REQUIRED TO BE PANNED TO MEET REQUIRED AZIMUTHS.
- 3. ANTENNA WEIGHT: 33.0 LBS.
- 4. CONTRACTOR TO UTILIZE 3M WRAP FOR ALL NR HRU ANTENNAS TO MATCH SURROUNDING AREAS. INSTALL 3M WRAP ON ANTENNAS PER MANUFACTURER'S SPECIFICATION & RECOMMENDATIONS.

NR ANTENNA DETAIL

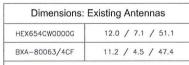

ALL DIMENSIONS ARE MEASURED IN INCHES AND ARE PROVIDED IN THE FORMAT: WIDTH/DEPTH/HEIGHT


DIMENSIONS: PROPOSED ANTENNAS			
NR	9.6 / 6.9 / 18.5		
NHH-65A-R2B	11.9 / 7.1 / 55.6		
INCHES AND ARE	ARE MEASURED IN E PROVIDED IN THE H/DEPTH/HEIGHT		

#### NOTES:

- 1. AS VIEWED STANDING BEHIND THE ANTENNAS.
- 2. ANTENNA CONFIGURATION BASED ON ANTENNA REC DATED 01/21/20. VERIFY SCOPE OF WORK WITH FINAL RFDS
  PRIOR TO CONSTRUCTION.

#### **ANTENNA CONFIGURATION**



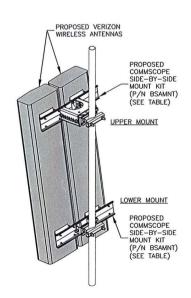

CO	MMSCOPE P/N: BSA	MNT MOUNT	TABLE	
COMMSCOPE P/N	SUPPORTED ANTENNAS	QUANTITY REQUIRED PER (2) ANTENNAS	NUMBER OF MOUNTING POINTS	GAP BETWEEN ANTENNAS
BSAMNT-SBS-1-2	SBNHH-1D65A/B/C NHH-65A/B/C-R2B	1	2	3-3/8"
BSAMNT-SBS-2-2	JAHH-65A/B/C-R3B JAHH-45A-R3B NHH-45A-R2B SBNHH-1D45A/B	1	2	2"
BSAMNT-SBS-2-3	NHH-45B/C-R2B JAHH-45B/C-R3B SBNHH-1D45C	1	3	2"

TABLE BASED ON POWER POINT PRESENTATION BY COMMSCOPE TITLED SIDE BY SIDE MOUNTS. CONTRACTOR TO VERIFY PART NUMBERS WITH MANUFACTURER PRIOR TO ORDERING. INSTALL PER MANUFACTURER RECOMMENDATIONS & SPECIFICATIONS.

- SPACING OF PROPOSED EQUIPMENT SHALL BE CONFIRMED AND PROPOSED MOUNTS SHALL NOT IMPEDE EQUIPMENT CLEARANCES. ACCESS TO EQUIPMENT SHALL BE MAINTAINED.
- PROPOSED ANTENNA MOUNT SHALL BE INSTALLED ACCORDING TO MANUFACTURER

SIDE-BY-SIDE ANTENNA MOUNT

SCALE: N.T.S.

3



VERIZON WIRELESS 118 FLANDERS ROAD WESTBOROUGH, MA 01581-3956

**HARVARD SQ 2 MA** 

	ANTMC	DRAWINGS
1		FOR SUBMITTAL
0		FOR SUBMITTAL
Α	02/12/20	FOR REVIEW



Dewberry Engineers Inc. 99 SUMMER STREET SUITE 700 BOSTON, MA 02110 PHONE: 617.695.3400 FAX: 617.695.3310



	_	
DRAWN	BY:	SCA

BBR

REVIEWED BY: CDH

CHECKED BY:

PROJECT NUMBER: 50121487

50121514 JOB NUMBER:

SITE NUMBER

137823

SITE ADDRESS

1654 MASSACHUSETTS AVE CAMBRIDGE, MA 02138

SHEET TITLE


CONSTRUCTION **DETAILS** 

SHEET NUMBER

A-4

#### **GENERAL NOTES:**


- ALL DIMENSIONS TO, OF, AND ON EXISTING BUILDINGS, DRAINAGE STRUCTURES, AND SITE IMPROVEMENTS SHALL BE VERIFIED IN FIELD BY CONTRACTOR PRIOR TO ALL FABRICATION WITH ALL DISCREPANCIES REPORTED IMMEDIATELY TO THE ENGINEER.
- 2. DO NOT CHANGE SIZE NOR SPACING OF STRUCTURAL ELEMENTS.
- DETAILS SHOWN ARE TYPICAL; SIMILAR DETAILS APPLY TO SIMILAR CONDITIONS UNLESS OTHERWISE NOTED.
- THESE DRAWINGS DO NOT INCLUDE NECESSARY COMPONENTS FOR CONSTRUCTION SAFETY WHICH IS THE SOLE RESPONSIBILITY OF THE
- BRACE STRUCTURES UNTIL ALL STRUCTURAL ELEMENTS NEEDED FOR STABILITY ARE INSTALLED. THESE ELEMENTS ARE AS FOLLOWS: LATERAL BRACING, ANCHOR BOLTS, ETC.
- DETERMINE EXACT LOCATION OF EXISTING UTILITIES, DRAIN PIPES, VENTS, ETC. BEFORE COMMENCING WORK.
- INCORRECTLY FABRICATED, DAMAGED, OR OTHERWISE MISFITTING OR INCORRECTED TABINGATED, DAMAGED, OR OTHERWISE MISTING ON WONCONFORMING MATERIALS OR CONDITIONS SHALL BE REPORTED TO THE OWNER PRIOR TO REMEDIAL OR CORRECTIVE ACTION. ANY SUCH REMEDIAL ACTION SHALL REQUIRE WRITTEN APPROVAL BY THE OWNER'S REPRESENTATIVE PRIOR TO PROCEEDING.
- EACH CONTRACTOR SHALL COOPERATE WITH THE OWNER'S REPRESENTATIVE, AND COORDINATE HIS WORK WITH THE WORK OF
- REPAIR ANY DAMAGE DURING CONSTRUCTION TO MATCH EXISTING PRE-CONSTRUCTION CONDITIONS TO THE SATISFACTION OF THE CONSTRUCTION MANAGER.
- ALL CABLE/CONDUIT ENTRY/EXIT PORTS SHALL BE WEATHERPROOFED DURING INSTALLATION USING A SILICONE SEALANT.
- 11. THE CONTRACTOR SHALL SUPERVISE AND DIRECT THE PROJECT DESCRIBED HEREIN. THE CONTRACTOR SHALL BE SOLELY RESPONSIBLE FOR ALL CONSTRUCTION MEANS, METHODS, TECHNIQUES, SEQUENCES AND PROCEDURES AND FOR COORDINATING ALL PORTIONS OF THE WORK UNDER THE CONTRACT.
- 12. SEAL PENETRATIONS THROUGH FIRE RATED AREAS WITH UL LISTED D FIRE CODE APPROVED MATERIALS.
- 13. TURN OVER ALL SALVAGEABLE BUILDING MATERIAL TO BUILDING
- 14. ALL DISRUPTIVE WORK AND WORK WITHIN TENANT SPACES TO BE COORDINATED WITH BUILDING REPRESENTATIVE.
- 15. ALL ROOF PENETRATIONS SHALL BE RESTORED TO MAINTAIN ALL ROOF WARRANTIES AND ENSURE A PERMANENT WATERPROOF SEAL.

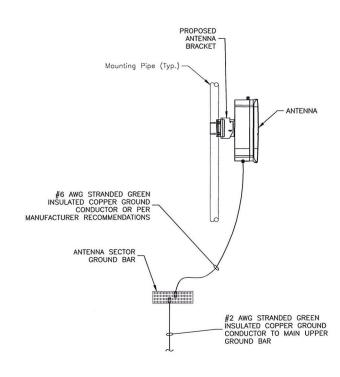

#### NOTES:

- VERIFY EXISTING GROUNDING SYSTEM IS INSTALLED PER VERIZON
- 2. BOND NEW EQUIPMENT INTO EXISTING GROUND SYSTEM IN ACCORDANCE WITH VERIZON WIRELESS STANDARDS AND MANUFACTURER'S RECOMMENDATIONS.




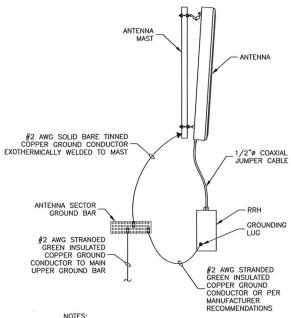

#### NOTES:

- VERIFY EXISTING GROUNDING SYSTEM IS INSTALLED PER
- BOND NEW EQUIPMENT INTO EXISTING GROUND SYSTEM IN ACCORDANCE WITH VERIZON WIRELESS STANDARDS & MANUFACTURER'S RECOMMENDATIONS.

TYPICAL ANTENNA/RRH **GROUNDING DETAIL** 

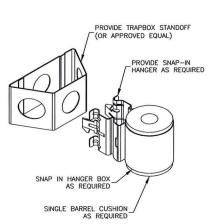

JUMPER MOUNT SCALE: N.T.S.

MANUFACTURER:

MODEL:

WEIGHT:

DIMENSIONS:

SAMSUNG

97.5 LBS

B2/B66A RRH BR049

15.0"H X 15.9"W X 10.0"D

### Dewberry®

Dewberry Engineers Inc. SUITE 700 BOSTON, MA 02110 PHONE: 617.695,3400 FAX: 617.695,3310

VERIZON WIRELESS

118 FLANDERS ROAD

WESTBOROUGH, MA 01581-3956

HARVARD SQ 2 MA

ANTMO DRAWINGS

1 05/13/20 FOR SUBMITTAL

0 03/04/20 FOR SUBMITTAL

A 02/12/20 FOR REVIEW



DRAWN BY: SCA CDH REVIEWED BY BBR CHECKED BY PROJECT NUMBER 50121487 50121514 JOB NUMBER: SITE NUMBER

137823

SITE ADDRESS


1654 MASSACHUSETTS AVE CAMBRIDGE, MA 02138

SHEET TITLE

CONSTRUCTION DETAILS & NOTES

SHEET NUMBER

A-5

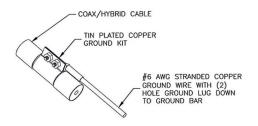

#### NOTES:

- DO NOT INSTALL CABLE GROUND KIT AT A BEND. ALWAYS DIRECT GROUND WIRE DOWN TO GROUND BAR.
- 2. GROUNDING KIT SHALL BE TIN PLATED COPPER WITH TWO-HOLE LUG, SIZE PER COAX DIAMETER
- 3. WEATHER SEAL GROUND KIT PER CARRIER REQUIREMENTS.
- 4. COAX CABLE GROUND KIT LOCATION & QUANTITY SHALL BE PER CARRIER SPECIFICATIONS & STANDARDS.

#### COAX/HYBRID GROUNDING DETAIL SCALE: N.T.S.



LTE 700/850





LTE AWS/PCS

- 1. COAX & JUMPERS NOT SHOWN FOR CLARITY.
- 2. GROUND RRHS AND MOUNTS PER MANUFACTURER'S RECOMMENDATIONS AND VERIZON WIRELESS STANDARDS.
- CONFIRM REQUIRED RRHS WITH THE LATEST ANTENNA REC.

**RRH DETAILS** 

NOTES:

## Exhibit 3 "Photo Simulations"



For visual reference only. Actual visibility is dependent upon weather conditions, season, sunlight, and viewer location.



**HARVARD SQ 2 MA** 

DEWBERRY NO. 50121514 (Page 1 of 10)



Dewberry Engineers Inc. 99 Summer St. Suite 700 Boston, MA 02110











Proposed Alpha Sector Panel Antennas (Typ.-2) On A Side-By-Side Bracket On Existing Mast Pipe

Proposed Alpha Sector NR HRU Antenna (Typ.-1) On Existing Mast Pipe


FLOYD'S® BAR

Dewberry\*



HARVARD SQ 2 MA Photo 2B

View Facing Southwest From Massachusetts Avenue (Page 6 of 10)

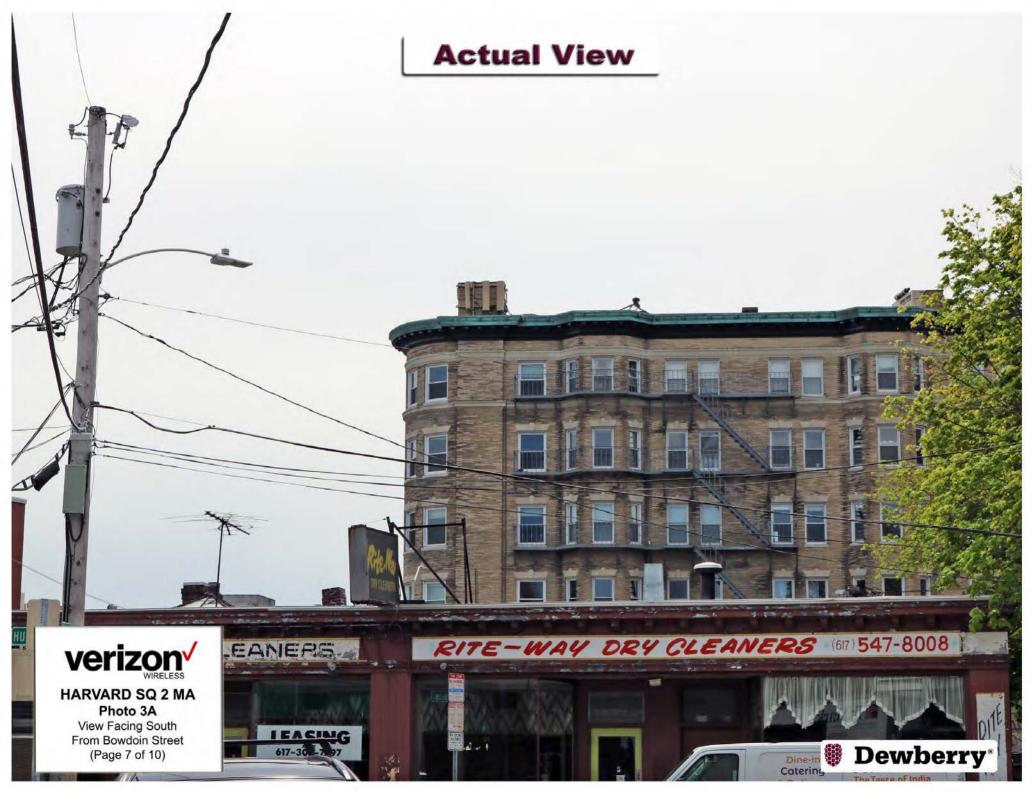







## Exhibit 4 "FCC License to Operate"

#### REFERENCE COPY

This is not an official FCC license. It is a record of public information contained in the FCC's licensing database on the date that this reference copy was generated. In cases where FCC rules require the presentation, posting, or display of an FCC license, this document may not be used in place of an official FCC license.



#### **Federal Communications Commission**

#### **Wireless Telecommunications Bureau**

#### RADIO STATION AUTHORIZATION

LICENSEE: CELLCO PARTNERSHIP

ATTN: REGULATORY CELLCO PARTNERSHIP 5055 NORTH POINT PKWY, NP2NE ENGINEERING ALPHARETTA, GA 30022

<b>Call Sign</b> WRBA936	File Number		
Radio Service			
UU - Upper Microwave Flexible Use			
Service			

FCC Registration Number (FRN): 0003290673

<b>Grant Date</b> 09-11-2018	Effective Date 02-27-2019	Expiration Date 10-06-2028	Print Date
Market Number BTA051		nel Block L1	Sub-Market Designator
	Market Boston		
<b>1st Build-out Date</b> 06-01-2024	2nd Build-out Date	3rd Build-out Date	4th Build-out Date

#### Waivers/Conditions:

Grant of the request to update licensee name is conditioned on it not reflecting an assignment or transfer of control (see Rule 1.948); if an assignment or transfer occurred without proper notification or FCC approval, the grant is void and the station is licensed under the prior name.

#### **Conditions:**

Pursuant to §309(h) of the Communications Act of 1934, as amended, 47 U.S.C. §309(h), this license is subject to the following conditions: This license shall not vest in the licensee any right to operate the station nor any right in the use of the frequencies designated in the license beyond the term thereof nor in any other manner than authorized herein. Neither the license nor the right granted thereunder shall be assigned or otherwise transferred in violation of the Communications Act of 1934, as amended. See 47 U.S.C. § 310(d). This license is subject in terms to the right of use or control conferred by §706 of the Communications Act of 1934, as amended. See 47 U.S.C. §606.

This license may not authorize operation throughout the entire geographic area or spectrum identified on the hardcopy version. To view the specific geographic area and spectrum authorized by this license, refer to the Spectrum and Market Area information under the Market Tab of the license record in the Universal Licensing System (ULS). To view the license record, go to the ULS homepage at http://wireless.fcc.gov/uls/index.htm?job=home and select "License Search". Follow the instructions on how to search for license information.

Licensee Name: CELLCO PARTNERSHIP

Call Sign: WRBA936 File Number: Print Date:

700 MHz Relicensed Area Information:

Market Name Buildout Deadline Buildout Notification Status

#### REFERENCE COPY

This is not an official FCC license. It is a record of public information contained in the FCC's licensing database on the date that this reference copy was generated. In cases where FCC rules require the presentation, posting, or display of an FCC license, this document may not be used in place of an official FCC license.



#### **Federal Communications Commission**

#### **Wireless Telecommunications Bureau**

#### RADIO STATION AUTHORIZATION

LICENSEE: CELLCO PARTNERSHIP

ATTN: REGULATORY CELLCO PARTNERSHIP 5055 NORTH POINT PKWY, NP2NE ENGINEERING ALPHARETTA, GA 30022

<b>Call Sign</b> WRBA937	File Number	
Radio Service		
UU - Upper Microwave Flexible Use		
Service		

FCC Registration Number (FRN): 0003290673

<b>Grant Date</b> 09-11-2018	Effective Date 02-27-2019	Expiration Date 10-06-2028	Print Date
Market Number BTA051		nel Block L2	Sub-Market Designator
	Marke Boston	t Name n, MA	
<b>1st Build-out Date</b> 06-01-2024	2nd Build-out Date	3rd Build-out Date	4th Build-out Date

#### Waivers/Conditions:

Grant of the request to update licensee name is conditioned on it not reflecting an assignment or transfer of control (see Rule 1.948); if an assignment or transfer occurred without proper notification or FCC approval, the grant is void and the station is licensed under the prior name.

#### **Conditions:**

Pursuant to §309(h) of the Communications Act of 1934, as amended, 47 U.S.C. §309(h), this license is subject to the following conditions: This license shall not vest in the licensee any right to operate the station nor any right in the use of the frequencies designated in the license beyond the term thereof nor in any other manner than authorized herein. Neither the license nor the right granted thereunder shall be assigned or otherwise transferred in violation of the Communications Act of 1934, as amended. See 47 U.S.C. § 310(d). This license is subject in terms to the right of use or control conferred by §706 of the Communications Act of 1934, as amended. See 47 U.S.C. §606.

This license may not authorize operation throughout the entire geographic area or spectrum identified on the hardcopy version. To view the specific geographic area and spectrum authorized by this license, refer to the Spectrum and Market Area information under the Market Tab of the license record in the Universal Licensing System (ULS). To view the license record, go to the ULS homepage at http://wireless.fcc.gov/uls/index.htm?job=home and select "License Search". Follow the instructions on how to search for license information.

Licensee Name: CELLCO PARTNERSHIP

Call Sign: WRBA937 File Number: Print Date:

700 MHz Relicensed Area Information:

Market Name Buildout Deadline Buildout Notification Status

## Exhibit 5 "ZBA Decisions"



## City of Cambridge

08/11/2006 02:38 PM

Page: 1 of 6

### MASSACHUSETTS BOARD OF ZONING APPEAL

1 2001 JUL 18 A 10:43 831 Mass Avenue, Cambridge, MA.

(617) 349-6100 OFFICE OF THE CITY CLERK I cut realles

CAMBRIDGE, MASSACHUSETTS Trustees of the will of Cliffond & miller

Tucker willer Frederick Grill

CASE NO:

010-61-5

9282

Back 12356 . 365

LOCATION:

1654 Mass Avenue

Cambridge, MA

Residence C-2 Zone

PETITIONER:

Verizon Wireless

C/o Michael S. Giaimo, Attorney

PETITION:

Special Permit: To install telecommunication antennas on the roof of

existing building and place equipment in the basement of the building.

**VIOLATIONS:** 

Art. 4.000, Sec. 4.32.G.1 (Telecommunication Facility).

Art. 10.000, Sec. 10.40 (Special Permit).

DATE OF PUBLIC NOTICE:

April 21 & 28, 2006

DATE OF PUBLIC HEARING: May 11, 2006

MEMBERS OF THE BOARD:

THOMAS SIENIEWICZ - CHAIR

JENNIFER PINCK – VICE CHAIR

SUSAN SPURLOCK KEEFE B. CLEMONS

CONSTANTINE ALEXANDER

ASSOCIATE MEMBERS:

**BRENDAN SULLIVAN** 

CHRISTOPHER CHAN

PAUL D. GRIFFIN

EDWARD W. WAYLAND

TIMOTHY HUGHES

STACYJHON THOMAS

Members of the Board of Zoning Appeal heard testimony and viewed materials submitted regarding the above request for relief from the requirements of the Cambridge Zoning Ordinance. The Board is familiar with the location of the petitioner's property, the layout and other characteristics as well as the surrounding district.

RETURN TO COLE LLP ONE BOSTON PLACE, BOSTON, NA 02100 19247,0162/77

Case No. 9282

Location: 1654 Mass Ave

Petitioner: Verizon Wireless - c/o Michael Giaimo, Esq.

On May 11, 2006, Petitioner's attorney Michael Giaimo appeared before the Board of Zoning Appeal requesting a special permit to install telecommunication antennas on the roof of the existing building and to place equipment in the basement of the building.

Mr. Giaimo stated that the proposal was to mount camouflaged antennas to chimneys on the building, to center some equipment on the roof of the building, so as not to be visible from the public way, and to place other equipment in the basement, serviced by cabling to run though an interior portion of the building. He stated that this arrangement would minimize the visual impact of the installation. Mr. Giaimo stated that the petitioner is properly licensed with the FCC and he provided that license. He stated that there was a significant gap in cell coverage in this area. He stated that alternative sites had been explored without success. He detailed failed discussions, including those with Harvard University regarding suitable buildings in nonresidential districts. He stated that the property is at the edge of a residential district, where business and institutional uses predominate. Mr. Giaimo stated that the installation would not increase traffic. He stated that the noise from the weekly testing of the generator will be mitigated by its housing. Mr. Giaimo also stated that the unit would only be tested during the day, during the highest ambient sound levels. Finally, he stated that the unit would be centered on the rooftop to minimize its audible impact.

The Chair noted a letter of opposition from Charlotte Moore of 9 Rutland Street and Henrietta Davis, City Councilor. The Chair asked if anyone wished to be heard on the matter, no one indicated such.

After discussion, the Chair moved that the Board find that the applicant possesses a valid federal license for the specific antennae and equipment that they propose to install at the site.

The five member Board voted unanimously in favor of making the finding (Sieniewicz, Pinck, Sullivan, Wayland, and Thomas).

The Chair moved that the Board find that the visual impact of the various elements of the proposed facility have been minimized, specifically through locating mechanical elements in the center of the building's roof, in the basement, and utilizing the features of the building as support and background, in particular, the cable tray being attached to a windowless portion of the building inside. The Chair moved that the Board find that there have been effective means to reduce the visual impact of the facility through camouflaging on the chimneys and through the siting of mechanical equipment, so that it is not visually apparent to anybody in the public way.

The five member Board voted unanimously in favor of making the finding (Sieniewicz, Pinck, Sullivan, Wayland, and Thomas).

The Chair moved that the Board find that the application, as detailed and demonstrated in drawings submitted in support of the application, is consistent with the requirements of special permits in the district, in particular, that it will not impact the adjoining districts, will not cause an increase of the traffic across the property lines over what exists there today and will not substantially derogate from the intent or purpose of the ordinance in its installation at this site.

The five member Board voted unanimously in favor of making the finding (Sieniewicz, Pinck, Sullivan, Wayland, and Thomas).

The Chair moved that the Board find that the applicant has demonstrated that there is a public need for the facility at the proposed location and that the existence of alternative functionally suitable sites in non-residential locations or in adjoining districts have been explored.

The five member Board voted unanimously in favor of making the finding (Sieniewicz, Pinck, Sullivan, Wayland, and Thomas).

The Chair moved that the Board find that the proposed work at 1654 Massachusetts Avenue has been detailed in such a way as to minimize, if not eliminate, the aesthetic impact of the installation on the adjoining residential properties, in particular, the generator having been moved to the center of the roof. The Chair moved that the Board find that acoustical studies have been conducted to assure that the impact from the noise from the periodic testing of that equipment will be mitigated both through a manufacturer's installed acoustical covering, which comes with the generator, and through engineering modeling which indicates that there will be a 1 decibel increase in sound levels at adjacent property levels at a given point in the day. The Chair moved that the Board find that the impact has also been mitigated by detailing the antennae and the cable trays in such a way so that they will not be apparent to adjacent property owners.

The five member Board voted unanimously in favor of making the finding (Sieniewicz, Pinck, Sullivan, Wayland, and Thomas).

The Chair moved that the Board find that the telecommunications facility is not inconsistent with the character that prevails in the surrounding neighborhood, in particular, in its efforts to camouflage the installation.

The five member Board voted unanimously in favor of making the finding (Sieniewicz, Pinck, Sullivan, Wayland, and Thomas).

The Chair moved that the Board find that the site at 1654 Massachusetts Avenue, which is on the border of a residential district and is less than 100' from a business district to the north and to the northeast, where residential uses do not predominate, there are business uses as pictured in a drawing, C1, presented at the hearing. The Chair moved that the Board find that to the east, although there is a residential district, the district is typified by institutional uses, specifically the Harvard Law School and Leslie University facilities across the street. The Chair moved that the Board find that residential uses do not predominate on the majority of the borders of this particular property at 1654 Massachusetts Avenue.

The five member Board voted unanimously in favor of making the finding (Sieniewicz, Pinck, Sullivan, Wayland, and Thomas).

The Chair moved that, based on the previous findings, the Board grant the special permit to install telecommunications antennae on the roof of the existing building and place equipment in the basement of the building at 1654 Massachusetts Avenue, on the following conditions:

- 1. that should the equipment be abandoned or should the lease expire at the premises, the equipment will be removed from said premises and the building restored to its condition as it exists today,
- 2. that the generator testing will be limited to once a week for one hour and that it be timed so that it has the least impact acoustically on the district and the surrounding districts and community,
- 3. that the installation be consistent with drawings and details submitted in support of the application, entitled Verizon Wireless Harvard Square 2 at 1654 Massachusetts Avenue, project No. 2112.094, bearing the Board's stamp and marked Case 9282, consisting of six sheets of drawings, bearing the revision stamp dated the 14<sup>th</sup> of February 2006, revised for comments, created by Bay State Design.

The five member Board voted unanimously in favor of granting the special permit (Sieniewicz, Pinck, Sullivan, Wayland, and Thomas) with the above conditions. Therefore, the special permit is granted.

The Board based its decision upon the above findings and upon the following:

- 1) The meeting of the requirements of the Ordinance;
- 2) Traffic generated or patterns of access or egress would not cause congestion, hazard, or substantial change in the established neighborhood character;
- 3) The continued operation of or the development of adjacent uses as permitted in the Ordinance would not be adversely affected by the nature of the proposed uses:
- 4) Nuisance or hazard would not be created to the detriment of the health, safety and /or welfare of the occupants of the proposed use;
- 5) The proposed use would not impair the integrity of the district or adjoining district or otherwise derogate from the Ordinance, and in fact would be a significant improvement to the structure and benefit the neighborhood, and;
- 6) The new use or building construction is not inconsistent with the Urban Design Objectives set forth in Section 19.30 of the Cambridge Zoning Ordinance.

The Board of Zoning Appeal is empowered to waive local zoning regulations only. This decision therefore does not relieve the petitioner in any way from the duty to comply with local ordinances and regulation of the other local agencies, including, but not limited to the Historical Commission, License Commission and/or compliance with requirements pursuant to the Building Code and other applicable codes.

Thomas Sieniewicz, Chair

Attest: A true and correct copy of decision filed with the offices of the City Cleand Planning Board on 7/18/06 by Mana offices, Clean	erk erk.
Twenty days have elapsed since the filing of this decision.	
No appeal has been filed	
Appeal has been filed and dismissed or denied.	
Date: August a 200 American Chung City Cle	erk



Artest Middleson Thomas

### Middlesex South Registry of Deeds

## Electronically Recorded Document

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### **Recording Information**

Document Number : 81440
Document Type : DECIS

Recorded Date : May 31, 2017 Recorded Time : 03:51:11 PM

Recorded Book and Page : 69365 / 577

Number of Pages(including cover sheet) : 5
Receipt Number : 2089003
Recording Fee : \$75.00

Middlesex South Registry of Deeds Maria C. Curtatone, Register 208 Cambridge Street Cambridge, MA 02141 617-679-6300 www.cambridgedeeds.com



#### CITY OF CAMBRIDGE **MASSACHUSETTS BOARD OF ZONING APPEAL** 831 MASSACHUSETTS AVENUE **CAMBRIDGE, MA 02139**

2017 1004

	617 349-6100 2017-101 75 7010: 53
OWNER: J	. Kurt Miller, Tucker R. Miller, and Frederick R. Grien, rustees under the will of Clifford V. Miller Pook 12356 Pg 365
CASE NO:	BZA-012742-2017 Residence C-2 Mass Ave Overlay
LOCATION:	1654 Massachusetts Ave Cambridge, MA
PETITIONER:	Cellco Partnership, d/b/a Verizon Wireless - C/O Timothy Twardowski, Esq.
PETITION:  VIOLATION:	Special Permit: To upgrade existing mobile communications facility by replacing three existing sectors of three antennas each (for a total of 9 antennas). Two new remote radio heads (for a total of 6) and one large junction box (for a total of three) will be added to each sector. All new equipment will be painted to match the chimneys.
Article 4.000	section 4.32.G.1 (Telecommunications Facility).
Article 4.000	Section 4.40 (Footnote 49) (Telecommunications Facility).
Article 10.000	Section 10.40-10.46 (Special Permit).
Article 6409(a)	Section Middle Class Tax Relief Act (Spectrum Act)
DATE OF PUBLIC	· · · · · · · · · · · · · · · · · · ·
MEMBERS OF THE	CONSTANTINE ALEXANDER - CHAIR BRENDAN SULLIVAN - VICE-CHAIR JANET O. GREEN PATRICK TEDESCO ANDREA A. HICKEY
ASSOCIATE INICIVIBI	DOUGLAS MYERS
	SLATER W. ANDERSON
	ALISON HAMMER

Members of the Board of Zoning Appeal heard testimony and viewed materials submitted regarding the above request for relief from the requirements of the Cambridge Zoning Ordinance. The Board is familiar with the location of the petitioner's property, the layout and other characteristics as well as the surrounding district.

JIM MONTEVERDE **GEORGE BEST LAURA WERNICK** 

Case No. BZA-012742-2017

Location: 1654 Massachusetts Avenue

Petitioner: Cellco Partnership d/b/a Verizon Wireless – c/o Timothy Twardowski, Esq.

On April 13, 2017, Petitioner's attorney Timothy Twardowski appeared before the Board of Zoning Appeal requesting a special permit in order to upgrade its existing mobile communications facility by replacing three existing sectors of three antennas each (for a total of nine antennas) and by adding two new remote radio heads (for a total of six) and one large junction box (for a total of three) to each sector, painted to match the chimneys. The Petitioner requested relief under Article 4, Section 4.32.G.1 and Article 10, Section 10.40 of the Cambridge Zoning Ordinance ("Ordinance") and Section 6409 of the Middle Class Tax Relief & Job Creation Act. The Petitioner submitted materials in support of their application including information about the project, plans, and photographs.

Mr. Twardowski stated that the proposal was to swap out nine existing antennas with new ones and to add attendant equipment all painted to match the chimney to which they were to be attached. He stated that the proposed work was not a substantial change to the facility under Section 6409 in that no new equipment cabinets were proposed, no excavation was proposed, no concealment elements were being defeated, the height was not being raised, there would be no protrusions, and the conditions from the original special permit would continue to be adhered to.

After discussion, the Chair moved that the Board make the following findings based upon the application materials submitted and all evidence before the Board and that based upon the findings the Board grant the requested relief as described in the Petitioner's submitted materials and the evidence before the Board: that the Board find that the requirements of the Ordinance could not be met without the special permit; that the Board find that traffic generated or patterns of access or egress resulting from what proposed would not cause congestion, hazard, or substantial change in established neighborhood character; that the Board find that the continued operation of or development of adjacent uses as permitted in the Ordinance would not be adversely affected by what was proposed; that the Board find that no nuisance or hazard would be created to the detriment of the health, safety, and/or welfare of the occupant of the structure or the citizens of the City; that the Board find that what was proposed would not impair the integrity of the district or adjoining district or otherwise derogate from the intent and purpose of the Ordinance; that the Board find that the proposed modification of the existing telecommunication facility would not substantially change the physical dimensions of the existing wireless tower or base station at such facility within the meaning of Section 6409(a) of The Middle Class Tax Relief and Job Creation Act of 2012, also known as The Spectrum Act.

The Chair further moved that based upon all the information presented the Board grant the requested relief as described in the Petitioner's submitted materials and the evidence before the Board on the following conditions:

- 1. that the work proceed in accordance with plans submitted by the petitioner, as initialed by the Chair,
- 2. that upon completion of the work, the physical appearance and visual impact of the proposed work be consistent with the photo simulations submitted by the petitioner, as initialed by the Chair,
- 3. that the petitioner at all times maintain the proposed work so that its physical appearance and visual impact remain consistent with the photo simulations previously referred to,
- 4. that should the petitioner cease to utilize the equipment approved tonight for a continuous period of six months or more, it promptly thereafter remove such equipment and restore the building on which it was located to its prior condition and appearance to an extent reasonably practicable,
- 5. that the petitioner continue to comply with the conditions imposed by the Board with respect to previous Special Permits granted to the petitioner with regard to the site in question,
- 6. that inasmuch as the health effects of the transmission of electromagnetic energy waves is a matter of ongoing societal concern and scientific study, the Special Permit is also subject to the following conditions:
  - A. that the petitioner shall file with the Inspectional Services Department each report it files with the federal authorities regarding electromagnetic energy wave emissions emanating from all of the petitioner's equipment on the site. Each such report shall be filed with the Inspectional Services Department no later than ten business days after the report has been filed with the federal authorities. Failure to timely file any such report with the Inspectional Services Department shall ipso facto terminate the Special Permit granted tonight.
  - B. that in the event that at any time federal authorities notify the petitioner that its equipment on the site, including, but not limited to the special permit granted tonight, fails to comply with the requirements of law or governmental regulations, whether with regard to the emissions of electromagnetic energy waves or otherwise, the petitioner, within ten business days of receipt of such notification of such failure, shall file with the Inspectional Services Department a report disclosing in reasonable detail that such failure has occurred and the basis for such claimed failure. The special permit shall ipso facto terminate if any of the petitioner's federal licenses are suspended, revoked, or terminated.
  - C. that to the extent a special permit has terminated pursuant to the foregoing paragraphs A and B, the petitioner may apply to this Board for a new special permit provided that the public notice containing such application discloses in reasonable detail that the application has been

- filed because of a termination of the special permit pursuant to paragraphs A or B above. Any such new application shall not be deemed a repetitive petition and therefore will not be subject to the twoyear period during which repetitive petitions may not be filed.
- D. that within ten business days after receipt of a Building Permit for the installation of the equipment subject to this petition, the petitioner shall file with the Inspectional Services Department a sworn Affidavit of the person in charge of the installation of equipment by the petitioner with a geographical area that includes Cambridge stating that A, he or she has such responsibility; and B, that the equipment being installed pursuant to the Special Permit we are granting tonight will comply with all federal safety rules and will be situated and maintained in locations with appropriate barricades and other protections such that individuals, including nearby residents and occupants of nearby structures, will be sufficiently protected from excessive radiofrequency radiation under federal law.

The five member Board voted unanimously in favor of granting the special permit with the above conditions (Alexander, Sullivan, Green, Hickey, and Tedesco). Therefore, the special permit is granted as conditioned.

The Board of Zoning Appeal is empowered to waive local zoning regulations only. This decision therefore does not relieve the petitioner in any way from the duty to comply with local ordinances and regulations of the other local agencies, including, but not limited to the Historical Commission, License Commission and/or compliance with requirements pursuant to the Building Code and other applicable codes.

Attest: A true and correct copy of decision filed with the offices of the City Clerk and Planning Board on 5-5-17 by Mana factor, Clerk.

Twenty days have elapsed since the filing of this decision.

No appeal has been filed \_\_\_\_\_\_.

Appeal has been filed and dismissed or denied.

Date: My 20 20 City Clerk