

CITY OF CAMBRIDGE BOARD OF ZONING APPEAL CAMBRIDGE AND SEP 24 CA

BZA Number: 92796

Genera	I Informa	tion

The undersigned l	nereby petitio	ons the Board of Zoning A	ppeal for the following:
Special Permit:	X	Variance:	Appeal:
PETITIONER: Ce	llco Partners	<u>hip d/b/a Verizon Wirele</u>	ss C/O Duval & Klasnick LLC (Daniel D. Klasnick, Esquire)
PETITIONER'S A	DDRESS: 21	o Broadway, Suite 203, L	ynnfield, MA 01940
LOCATION OF PI	ROPERTY: 1	98 Broadway , Cambrid	g <u>e, MA</u>
TYPE OF OCCUP	PANCY: Mob	le Communications	ZONING DISTRICT: Industry B Zone
REASON FOR PE	ETITION:		
/Telecommunicat	ion Facility (antenna)/	
DESCRIPTION O	F PETITION	ER'S PROPOSAL:	
rooftop antennas. existing mast pipe antennas. Remov	The 9 new a and 3 anten	ntennas consisting of 6 a nas on existing pipe mas	moving 9 existing rooftop antennas and installing 9 new ntennas mounted on a side-by-side bracket attached to the t on the roof of the building at a height to match the existing emote radio heads with 3 large junction boxes to replace 3 n the rooftop.
SECTIONS OF Z	ONING ORD	INANCE CITED:	
Article: 4.000 Article: 4.000 Article: 10.00 Article: 6409(a)	Section: 4.4 Section: 10	2.G.1 (Telecommunication (Footnote 49) (Telecon 40-10.46 (Special Permit 4dle Class Tax Relief and	nmunications Facility)
		Original Signature(s):	(Petitioner (s) / Owner)
			Daniel D. Klasnick

Address:

(Print Name)

Tel. No.

E-Mail Address:

781-873-0021

Date: Scptimber 21, 2020

dklasnick@dkt-legal.com

BZA APPLICATION FORM - OWNERSHIP INFORMATION

To be completed by OWNER, signed before a notary and returned to The Secretary of the Board of Zoning Appeals.

I/WE KENDAW SQUARE ENTITY, INC
Address: 1270 SOLDIERS FIELD ROAD, BOSTON, MA 02135-1003
State that I/We own the property located at I/I PORTLAND ST CAMBRIDGE MA which is the subject of this zoning application.
The record title of this property is in the name of KENDAU SQUARE ENTITY INC.
*Pursuant to a deed of duly recorded in the date 12 31 85, Middlesex South County Registry of Deeds at Book 16682, Page 565; or
Middlesex Registry District of Land Court, Certificate No
BookPage
Pull his AGENT
*Written evidence of Agent's standing to represent petitioner may be requested.
Commonwealth of Massachusetts, County of Suffer
The above-name full (huro5 personally appeared before me, this 315 of July , 2020, and made oath that the above statement is true. Notary
My commission expires (Notary Seal) Andrea D. Salvi NOTARY PUBLIC Commonwealth of Massachusetts My Commission Expires December 26, 2025
 If ownership is not shown in recorded deed, e.g. if by court order, recent deed, or inheritance, please include documentation.

BZA Application Form

SUPPORTING STATEMENT FOR A SPECIAL PERMIT

Please describe in complete detail how you meet each of the following criteria referring to the property and proposed changes or uses which are requested in your application. Attach sheets with additional information for special permits which have additional criteria, e.g.; fast food permits, comprehensive permits, etc., which must be met.

Granting the Special Permit requested for <u>198 Broadway</u>, <u>Cambridge</u>, <u>MA</u> (location) would not be a detriment to the public interest because:

A) Requirements of the Ordinance can or will be met for the following reasons:

As demonstrated by the documents provided with this application and will be further discussed at the hearing on this matter, the modification satisfies the standards for an Eligible Facilities Request pursuant to Section 6409(a) of the Federal Spectrum Act. The proposed modification also satisfies the standards for the grant of a special permit. (For further details, please see attached narrative and supporting documents)

B) Traffic generated or patterns of access or egress would not cause congestion hazard, or substantial change in established neighborhood character for the following reasons:

The modification of the unmanned facility will not change existing traffic demand or impact ingress or egress. The modified facility will continue to generate only about one to two vehicles trips per month in a standard passenger vehicle. (For further details, please see attached narrative and supporting documents)

The continued operation of or the development of adjacent uses as permitted in the Zoning

Ordinance would not be adversely affected by the nature of the proposed use for the following reasons:

The modified facility will have no adverse effects on the operation or development of adjacent uses. The modified facility will emit no light, odor, dust or glare and generates no unusual noise or other adverse impacts. (For further details, please see attached narrative and supporting documents)

Nuisance or hazard would not be created to the detriment of the health, safety, and/or welfare of the occupant of the proposed use or the citizens of the City for the following reasons:

The modified facility will generate no additional traffic or other negative impacts on surrounding properties or within the City of Cambridge. The facility requires no water or sewer services and emits no light, odor, dust or glare and generates no unusual noise or other adverse impacts. The facility will be unoccupied with no employees or customers. The availability of wireless services enhances the health, safety and welfare of the community. (For further details, please see attached narrative and supporting documents)

For other reasons, the proposed use would not impair the integrity of the district or adjoining district or otherwise derogate from the intent or purpose of this ordinance for the following reasons:

The facility has been designed to minimize its visual impact and is in harmony with the general purpose of the zoning ordinance for this use and in accordance with the requirements for an

Eligible Facilities Request under Section 6409(a). (Please see attached narrative and supporting documents)

*If you have any questions as to whether you can establish all of the applicable legal requirements, you should consult with an attorney.

Phone:

BZA Application Form

DIMENSIONAL INFORMATION

Applicant: Cellco Partnership d/b/a Verizon Wireless

Present Use/Occupancy:

Mobile Communications

Facility

Location: 210 Broadway, Suite 203 781-873-0021

Zone:

Industry B Zone

Requested Use/Occupancy:

Mobile Communications

Facility

		Existing Conditions	Requested Conditions	Ordinance Requirements	
TOTAL GROSS FLOOR AREA:		N/A	N/A	N/A	(max.)
LOT AREA:		N/A	N/A	N/A	(min.)
RATIO OF GROSS FLOOR AREA TO LOT AREA: ²		N/A	N/A	N/A	
LOT AREA OF EACH DWELLING UNIT		N/A	N/A	N/A	
SIZE OF LOT:	WIDTH	N/A	N/A	N/A	
	DEPTH	N/A	N/A	N/A	
SETBACKS IN FEET	FRONT	N/A	N/A	N/A	
	REAR	N/A	N/A	N/A	
	LEFT SIDE	N/A	N/A	N/A	
	RIGHT SIDE	N/A	N/A	N/A	
SIZE OF BUILDING:	HEIGHT	N/A	N/A	N/A	
	WIDTH	N/A	N/A	N/A	
RATIO OF USABLE OPEN SPACE TO LOT AREA:		N/A	N/A	N/A	
NO. OF DWELLING UNITS:		N/A	N/A	N/A	
NO. OF PARKING SPACES:		N/A	N/A	N/A	
NO. OF LOADING AREAS:		N/A	N/A	N/A	
DISTANCE TO NEAREST BLDG. ON SAME LOT		N/A	N/A	N/A	

Describe where applicable, other occupancies on the same lot, the size of adjacent buildings on same lot, and type of construction proposed, e.g; wood frame, concrete, brick, steel, etc.

- 1. SEE CAMBRIDGE ZONING ORDINANCE ARTICLE 5.000, SECTION 5.30 (DISTRICT OF DIMENSIONAL REGULATIONS).
- 2. TOTAL GROSS FLOOR AREA (INCLUDING BASEMENT 7'-0" IN HEIGHT AND ATTIC AREAS GREATER THAN 5') **DIVIDED BY LOT AREA.**
- 3. OPEN SPACE SHALL NOT INCLUDE PARKING AREAS, WALKWAYS OR DRIVEWAYS AND SHALL HAVE A MINIMUM **DIMENSION OF 15'.**

198 Broadway

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34 Newtowne Ct	43A-21			43A-28	ROA 43A-29

198 Broadway

42-13 CAMBRIDGE ELECTRIC LIGHT CO. NSTAR ELECTRIC CO. P.O. BOX 270 HARTFORD, CT 06141-0270

42-57 AZARIAH, D'VORAH 125 PORTLAND ST #5 CAMBRIDGE, MA 02139

42-88 KAY, SUPA 125 HARVARD ST, #101 CAMBRIDGE, MA 02139

42-88 WORON, STEPHANIE 125 HARVARD ST. UNIT#306 CAMBRIDGE, MA 02139

42-88 BERNARD, ROSE M. 125 HARVARD ST. UNIT#301 CAMBRIDGE, MA 02139

42-88 DIETRICH, KERRY 125 HARVARD ST., #408 CAMBRIDGE, MA 02139

42-88 TRAHANT, REMY 125 HARVARD ST. UNIT#205 CAMBRIDGE, MA 02139

42-88 LIU, HAOYANG & SIAN V. LIU 125 HARVARD ST. UNIT#307 CAMBRIDGE, MA 02139

42-88 HENRIQUEZ, REYNA E. 678 MASSACHUSETTS AVE CAMBRIDGE, MA 02139

42-88 JAHAN, NASIM 125 HARVARD ST., #201 CAMBRIDGE, MA 02139 42-33 200 BROADWAY, LLC, ATTN: CHRISTOPHER CASSEL 200 BROADWAY CAMBRIDGE, MA 02139

42-57 KOCHANOWSKI, EDWARD J. & MARGERY WILSON 125 PORTLAND ST CAMBRIDGE, MA 02139

42-88 DENG, CHAO LI & GUAN YU CHEN 125 HARVARD ST., #404 CAMBRIDGE, MA 02139

42-88 KHALIFA, IMTIYAZ 125 HARVARD ST UNIT #303 CAMBRIDGE, MA 02139

42-88 ALI, AMINAT H. 125 HARVARD ST. UNIT#207 CAMBRIDGE, MA 02139

42-88
PENAGOS-VARGAS, HECTOR L. &
MARIS I. ESQUITIN-CISNEROS
125 HARVARD ST UNIT #305
CAMBRIDGE, MA 02139

42-88 YENESEW, ENDESHAW W. & HASABE A. MEKONEN 125 HARVARD ST. UNIT#202 CAMBRIDGE, MA 02139

42-88 GREEN, JANICE B. 125 HARVARD ST. UNIT#406 CAMBRIDGE, MA 02139

42-88 MARTINEZ, LIGIA E. 125 HARVARD ST., #208 CAMBRIDGE, MA 02141

42-88 WILLIAMS, NINA M. 125 HARVARD ST UNIT #203 CAMBRIDGE, MA 02139 DUVAL & KLASNICK, LLC C/O DANIEL D. KLASNICK, ESQ. 210 BROADWAY, SUITE 203 LYNNFIELD, MA 01940

43A-24 CHARLES STARK DRAPER LABORATORY, INC. ATTN: ELIZABETH MORA - MS #05 555 TECHNOLOGY SQUARE CAMBRIDGE, MA 02139

42-88 LAVINE, REBECCA 125 HARVARD ST., #401 CAMBRIDGE, MA 02139

42-88 KAFLE, RUKMANI & RAMJI BASNET 125 HARVARD ST., #302 CAMBRIDGE, MA 02139

42-88 CRYSTOFF, JEFFREY M. 125 HARVARD ST #206 CAMBRIDGE, MA 02139

42-88 CRUZ, MARGARITA 125 HARVARD ST., #304 CAMBRIDGE, MA 02139

42-88 BISHOP, MICHAEL BLAKE 125 HARVARD ST., #405 CAMBRIDGE, MA 02139

42-88 BRITT, ERIN M. 125 HARVARD ST., #403 CAMBRIDGE, MA 02139

42-88 DAS, SUBRATA & JOYSRI DAS 125 HARVARD ST UNIT #204 CAMBRIDGE, MA 02139

42-57 JAS HOMEOWNERSHIP LLC 1035 CAMBRIDGE ST., #12 CAMBRIDGE, MA 02141 42-88
JAS HOMEOWNERSHIP LLC,
C/O JUST A START CORPORATION
1035 CAMBRIDGE ST. #12
CAMBRIDGE, MA 02141

42-57 LEE, HAN KYU 125 PORTLAND ST., #7 CAMBRIDGE, MA 02140

42-57 BASTOS, GERADO 125 PORTLAND ST. CAMBRIDGE, MA 02139

42-57 MONTOYA, AMANDA MARLENE 125 PORTLAND ST., #4 CAMBRIDGE, MA 02139 198 Broadway

42-57 GEBRETSADIK, TEZERA T & SEBLE H. KIDANE 125 PORTLAND ST #1 CAMBRIDGE, MA 02139

42-58
MARTINS, ALFRED & ALICE MARTINS,
TRS. OF THE MARTINS HARVARD REALTY TRUST
166 HIGHLAND AVE
SOMERVILLE, MA 02143-1506

42-68
MARTINS, ALFRED & ALICE MARTINS
TRS. OF THE MARTINS HARVARD REALTY TRUST
& CITY OF CAMBRIDGE TAX TITLE
166 HIGHLAND AVE.
SOMERVILLE, MA 02143-1506

42-57 VOGEL, FRANK E. 125 PORTLAND ST., #2 CAMBRIDGE, MA 02139

42-70
U.S.T. FINANCIAL PLANNING CO., INC.
C/O INTERCONTINENTAL MANAGEMENT CORP.
1270 SOLDIERS FIELD ROAD
BRIGHTON, MA 02135

42-87 BROADWAY/HAMPSHIRE ASSOCIATES LIMITED PARTNERSHIP ONE APPLETON ST. BOSTON, MA 02116



Application for Special Permit

198 Broadway aka 141 Portland Street Cambridge, MA



Our Expertise. Your Future. Succeeding Together.®

Daniel D. Klasnick

Licensed in Massachusetts and New Hampshire dklasnick@dkt-legal.com

September 17, 2020

City of Cambridge Board of Zoning Appeals 831 Massachusetts Avenue Cambridge, Massachusetts 02139

Re: Application for Special Permit
Building Mounted Mobile Communications Facility
Located at 198 Broadway aka 141 Portland Street, Cambridge, Massachusetts

Dear Board Members:

Enclosed please find an Application to the Board of Zoning Appeals for a special permit for the modification of an existing building mounted mobile communications facility submitted on behalf of Cellco Partnership d/b/a Verizon Wireless.

In accordance with the Application requirements, please find enclosed the following:

- Application;
- Support Statements;
- Check for the application fee of \$500.00 payable to the City of Cambridge;
- Assessors GIS Block Map;
- Dimensional Form;
- Ownership Certificate, Notarized;
- Stamped Project Plans; and
- Photo Simulations

The Applicant would be happy to provide any additional information that you may require and would appreciate reasonable notice of any additional information you require in time to provide such information for the public hearing.

Should you require any additional information, please don't hesitate to contact me. Thank you very much for your cooperation.

Very truly yours,

DUVAL & KLASNICK LLC

Daniel D. Klasnick By:

Attorney at Law

GENERAL INFORMATION

ETITIONER'S ADDRESS: c/o Daval & Klasnick LLC, 210 Broadway, Suite 203, Lynnfield, MA 01940 OCATION OF PROPERTY: 198 Broadway (aka 141 Portland Street) When the Communications and District and Structure and Parking EASON FOR PETITION: Additions	Special Permit: X	Variance:	Appe	al:
OCATION OF PROPERTY: 198 Broadway (aka 141 Portland Street) YPE OF OCCUPANCY: Mobile Communications Facility EASON FOR PETITION: Additions New Structure Additions Parking Conversion to Addi'l Dwelling Unit's Sign Dormer Subdivision X Other: Mobile Communications Facility Modification (Eligible Facilities Request under Section 6409(a) of Federal Spectrum Act) ESCRIPTION OF PETITIONER'S PROPOSAL: Addity the existing mobile communications facility by replacing 9 antennas and installing 9 antennas. Instal Pantennas with 6 antennas mounted on a side-by-side bracket attached to the existing mast pipe and 3 antennas are existing pipe mast at a height to match the existing antennas. Remove 6 remote radio heads and install 6 remote radio heads with 3 large junction boxes to replace 3 small junction boxes mounted to existing pipe mode and install 6 remote radio heads with 3 large junction boxes to replace 3 small junction boxes mounted to existing pipe mode and install 6 remote radio heads with 3 large junction boxes to replace 3 small junction boxes mounted to existing pipe mode and install 6 remote radio heads with 3 large junction boxes to replace 3 small junction boxes mounted to existing pipe mode and install 6 remote radio heads with 3 large junction boxes to replace 3 small junction boxes mounted to existing pipe mode and install 6 remote radio heads with 3 large junction boxes to replace 3 small junction boxes mounted to existing pipe mode and install 6 remote radio heads with 3 large junction boxes to replace 3 small junction boxes mounted to existing pipe mode and install 6 remote radio heads with 3 large junction boxes to replace 3 small junction boxes mounted to existing pipe mode and install 6 remote radio heads with 3 large junction boxes to replace 3 small junction boxes mounted to existing pipe mode and install 6 remote radio heads with 3 large junction boxes to replace 3 small junction boxes mounted to existing pipe mode and install 6 remote radio heads with 3 large junction boxes for pipe mode an	PETITIONER: Cellco	Partnership d/b/a Verizon Wire	eless	
Mobile Communications ZONING DISTRICT: Industry B (IB) Facility Additions	ETITIONER'S ADDRES	ss: c/o Duval & Klasnick LLC,	210 Broadway, Suite 203,	Lynnfield, MA 01940
Additions Additions Change in Use/Occupancy Conversion to Addi'l Dwelling Unit's Sign Dormer X Other: Mobile Communications Facility Modification (Eligible Facilities Request under Section 6409(a) of Federal Spectrum Act) ESCRIPTION OF PETITIONER'S PROPOSAL: Modify the existing mobile communications facility by replacing 9 antennas and installing 9 antennas. Instal 2 antennas mounted on a side-by-side bracket attached to the existing mast pipe and 3 antenna con existing pipe mast at a height to match the existing antennas. Remove 6 remote radio heads and install 6 remote radio heads with 3 large junction boxes to replace 3 small junction boxes mounted to existing pipe mode existing pipe mode and install 6 remote radio heads with 3 large junction boxes to replace 3 small junction boxes mounted to existing pipe mode existing pipe mode existing pipe mode and install 6 remote radio heads with 3 large junction boxes to replace 3 small junction boxes mounted to existing pipe mode existing pipe mode and install 6 remote radio heads with 3 large junction boxes to replace 3 small junction boxes mounted to existing pipe mode existing pipe mode and install 6 remote radio heads with 3 large junction boxes to replace 3 small junction boxes mounted to existing pipe mode existing mode existing pipe mode existing	LOCATION OF PROPER	ry: 198 Broadway (aka 141 Po	ortland Street)	
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(Petitioner(s)/Owner) Daniel D. Klasnick attorney for Cellco Partnership d/b/a Verizon Wireless (Print Name)	Applicants for a <mark>Sy</mark> Applicants for an	pecial Permit must comp n Appeal to the BZA	plete Pages 1-4 and of a Zoning de	etermination by t
Daniel D. Klasnick attorney for Cellco Partnership <u>d/b/a Verizon Wireless</u> (Print Name)		Original Signature(s):		
			Daniel D. Klasnick attorney d/b/a Verizon Wireless	y for Cellco Partnership
Address. 210 Dioudina), Outto 200		Address:	210 Broadway, Suite 2	•
Lynnfield, MA 01940			T (2.11.354.01040	
Tel. No.: (781) 873-0021			Lynnfield, MA 01940	
E-Mail Address: dklasnick@dkt-legal.com		Tel. No.:	`	
ate: September 17, 2020			(781) 873-0021	-legal.com

SUPPORTING STATEMENT FOR A SPECIAL PERMIT

Please describe in complete detail how you meet each of the following criteria referring to the property and proposed changes or uses which are requested in your application. Attach sheets with additional information for special permits which have additional criteria, e.g.; fast food permits, comprehensive permits, etc., which must be met.

Granting the Special Permit requested for 198 Broadway aka 141 Portland Street (location) would not be a detriment to the public interest because:

A) Requirements of the Ordinance can or will be met for the following reasons:

As demonstrated by the documents provided with this application and will be further discussed at the hearing on this matter, the modification satisfies the standards for an Eligible Facilities Request pursuant to Section 6409(a) of the Federal Spectrum Act. The proposed modification also satisfies the standards for the grant of a special permit. (For further details, please see attached narrative and supporting documents)

B) Traffic generated or patterns of access or egress would not cause congestion hazard, or substantial change in established neighborhood character for the following reasons:

The modification of the unmanned facility will not change existing traffic demand or impact ingress or egress. The modified facility will continue to generate only about one to two vehicles trips per month in a standard passenger vehicle. (For further details, please see attached narrative and supporting documents)

C) The continued operation of or the development of adjacent uses as permitted in the Zoning Ordinance would not be adversely affected by the nature of the proposed use for the following reasons:

The modified facility will have no adverse effects on the operation or development of adjacent uses. The modified facility will emit no light, odor, dust or glare and generates no unusual noise or other adverse impacts. (For further details, please see attached narrative and supporting documents)

Nuisance or hazard would not be created to the detriment of the health, safety and/or welfare of the occupant of the proposed use or the citizens of the City for the following reasons:

The modified facility will generate no additional traffic or other negative impacts on surrounding properties or within the City of Cambridge. The facility requires no water or sewer services and emits no light, odor, dust or glare and generates no unusual noise or other adverse impacts. The facility will be unoccupied with no employees or customers. The availability of wireless services enhances the health, safety and welfare of the community. (For further details, please see attached narrative and supporting documents)

E) For other reasons, the proposed use would not impair the integrity of the district or adjoining district or otherwise derogate from the intent or purpose of this ordinance for the following reasons:

The facility has been designed to minimize its visual impact and is in harmony with the general purpose of the zoning ordinance for this use and in accordance with the requirements for an Eligible Facilities Request under Section 6409(a). (*Please see attached narrative and supporting documents*)

(ATTACHMENT B - PAGE 6)

DIMENSIONAL INFORMATION

APPLICANT: Cellco Partnership d/b/a Verizon Wireless PRESENT USE/OCCUPANCY: Mobile Communications Facility 198 Broadway aka 141 Portland Street **Industry B** LOCATION: ZONE: PHONE: (781) 873-0021 REQUESTED USE/OCCUPANCY: Mobile Communications Facility EXISTING REQUESTED ORDINANCE CONDITIONS CONDITIONS REQUIREMENTS¹ N/A No Change N/A TOTAL GROSS FLOOR AREA: (max.) N/A N/A LOT AREA: (min.) RATIO OF GROSS FLOOR AREA N/A No Change N/A TO LOT AREA: (max.) N/A N/A No Change LOT AREA FOR EACH DWELLING UNIT: (min.) N/A N/A SIZE OF LOT: WIDTH (min.) DEPTH N/A No Change N/A Setbacks in FRONT (min.) Feet: N/A No Change N/A REAR (min.) N/A N/A No Change LEFT SIDE (min.) N/A No Change N/A RIGHT SIDE (min.) N/A No Change N/A SIZE OF BLDG.: HEIGHT (max.) LENGTH WIDTH RATIO OF USABLE OPEN SPACE TO LOT AREA: 3) N/A No Change N/A (min.) No Change N/A N/A NO. OF DWELLING UNITS: (max.) No Change N/A N/A NO. OF PARKING SPACES: (min./max) No Change N/A N/A NO. OF LOADING AREAS: (min.) No Change N/A N/A DISTANCE TO NEAREST BLDG. (min.) ON SAME LOT: Describe where applicable, other occupancies on same lot, the size of adjacent buildings on same lot, and type of construction proposed, e.g.; wood frame, concrete, brick, steel, etc. The proposed installation involves the modification of an existing Mobile Communications Facility that satisifies the standards for an eligible facilities request under Section 6409(a) of the Federal Spectrum Act.

^{1.} SEE CAMBRIDGE ZONING ORDINANCE ARTICLE 5.000, SECTION 5.30 (DISTRICT OF DIMENSIONAL REGULATIONS).

^{2.} TOTAL GROSS FLOOR AREA (INCLUDING BASEMENT 7'-0" IN HEIGHT AND ATTIC AREAS GREATER THAN 5') DIVIDED BY LOT AREA.

^{3.} OPEN SPACE SHALL NOT INCLUDE PARKING AREAS, WALKWAYS OR DRIVEWAYS AND SHALL HAVE A MINIMUM DIMENSION OF 15'.

CHECK LIST

PROPERTY LOCATION: 198 Broadway aka 141 Portland Street

DATE: September 17, 2020


PETITIONER OR REPRESENTATIVE: Cellco Partnership d/b/a Veri					
c/o Duval & Klasnick LLC, 210 Broadway, Suite 203, Lynnfield, MA 01940 DDRESS & PHONE: (781) 873-0021 - Daniel D. Klasnick, Esquire					
BLOCK: 42 LOT:	70	_			
	TH YOUR APPLICATION.				
PROVIDED.					
PLEASE INCLUDE THIS CHECKLIST WITH YOUR APPLICATION. ALL DOCUMENTS ARE TO BE TYPED OR WRITTEN LEGIBLY.					
DOCUMENTS	REQUIRED	ENCLOSED			
Application Form 3 Forms with Original Signatures	_X	X			
Supporting Statements - Scanned & 1 set to Zoning	X	X			
Application Fee (You will receive invoice online)	X	X			
Assessor's GIS "Block Map" (Available on line or At Engineering Dept 147 Hampshire Street)	_X	X			
Dimensional Form - Refer to Cambridge Zoning Ordinance - Scanned & 1 set to Zoning (Subject to further review by Zoning Specialist)	_X	X			
Ownership Certificate, Notarized - Scanned & 1 set to Zoning	X	X			
Floor Plans - Scanned & 1 set to Zoning	_X	X			
Elevations - Scanned & 1 set to Zoning	X	X			
Certified Plot Plan - Scanned & 1 set to Zoning (By Registered Land Surveyor)	X	X			
Photographs of Property - Scanned & 1 set to Zoning	_X	_X			
Parking Plan (if relevant to your application) Scanned & 1 set to Zoning		N/A			
FOR SUBDIVISION ALSO INCLUDE: Scanned & 1 set to Zonir	ng				
Proposed Deeds	N/A 	N/A			
Evidence of Separate Utilities **	N/A	N/A			
Proposed Subdivision Plan	N/A	N/A			

Petitioners are advised to refer to Attachment A (Procedures for applying to the Board of Zoning Appeal) & consult zoning staff for review.

It is advisable for the Petitioner to discuss the petition with the abutters as listed in the Zoning BZA Case file.

 $^{^{\}star}$ For Special Permits under Art. 4.32.G.1 (Communication Towers and Antennas), include a photo simulation.

^{**} Can be submitted after subdivision has been approved.

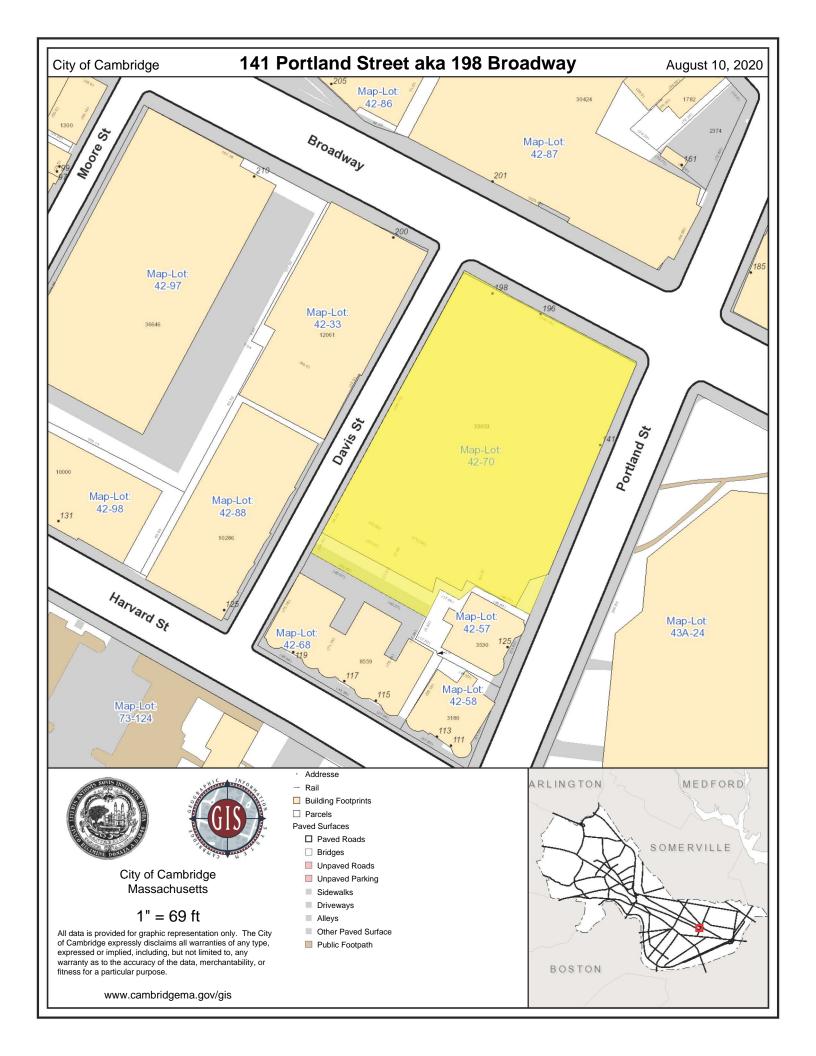

CITY OF CAMBRIDGE

NARRATIVE IN SUPPORT OF APPLICATION FOR SPECIAL PERMIT

APPLICANT: Cellco Partnership d/b/a Verizon Wireless

SITE ADDRESS: 198 Broadway (aka 141 Portland Street)

Cambridge, Massachusetts

ASSESSOR'S LOT I.D.: Map 42, Lot 70

ZONING DISTRICT: Industry B (IB)

BACKGROUND

This Narrative in Support of an Application for Special Permit, *while reserving all rights*, to modify an existing building mounted mobile communications facility ("Facility") is respectfully submitted by Cellco Partnership d/b/a Verizon Wireless ("Verizon Wireless") to the City of Cambridge, Board of Zoning Appeal ("Board"). Verizon Wireless seeks approval to further modify its existing Facility on the existing building at 198 Broadway aka 141 Portland Street (the "Property").

This application is submitted with full reservation of Verizon Wireless' rights including without limitation Section 6409(a) of the federal Middle Class Tax Relief and Job Creation Act of 2012 also referred to as the "Spectrum Act." The Spectrum Act was passed to "advance wireless broadband service" for both public safety and commercial purposes. The modification to the existing Facility satisfies the standards for the modification of an eligible facility under the Spectrum Act.

APPLICANT'S INTEREST IN THE PROPERTY

Kendall Square Entity, Inc. ("Owner") and Cellco Partnership d/b/a Verizon Wireless entered into a certain Lease Agreement by which Owner leased to Verizon Wireless building space and access/utility easement rights on a portion of the Owner's property located at 198 Broadway aka 141 Portland Street being shown on Tax Map of the City of Cambridge at Map 42, Lot 70 for the location of Verizon Wireless' antennas and space for its equipment.

See Exhibit 1, ZBA Application Form - Ownership Information.

PROJECT DESCRIPTION

As noted on the attached plans and described in this application, the building owned by Kendall Square Entity, Inc. is a 10-story brick building used for office purposes (the "Building"). Verizon Wireless has installed and operates an existing Facility consisting of 3 sectors of 4 antennas each (12 in total) and equipment room in the Building. The existing antennas are installed on 3 separate ballast mounts on the rooftop.

Facility Modification Details

Total of Twelve (12) Antennas with Remote Radio Heads

Verizon Wireless proposes to mount a total of twelve (12) antennas through replacing 9 antennas and installing 9 new antennas while maintaining 3 existing antennas on the modified ballast mounts with remote radio heads as follows:

(a) Alpha Sector Ballast Mounted Equipment

Remove 3 antennas and 2 remote radio heads. Retain 1 antenna, install 3 new antennas with 2 antennas mounted on a side-by-side bracket attached to the existing mast pipe and install one antenna on existing pipe mast at a height to match the existing antennas. Install 2 remote radio heads and install one large junction box to replace small junction box mounted to existing pipe mounts. Total: 4 antennas, 2 remote radio heads and 1 large junction box. – *See Roof Plan Sheet C-1*.

(b) Beta Sector Ballast Mounted Equipment

Remove 3 antennas and 2 remote radio heads. Retain 1 antenna, install 3 new antennas with 2 antennas mounted on a side-by-side bracket attached to the existing mast pipe and install one antenna on existing pipe mast at a height to match the existing antennas. Install 2 remote radio heads and install one large junction box to replace small junction box mounted to existing pipe mounts. Total: 4 antennas, 2 remote radio heads and 1 large junction box. – *See Roof Plan Sheet C-1*.

(c) Gamma Sector Ballast Mounted Equipment

Remove 3 antennas and 2 remote radio heads. Retain 1 antenna, install 3 new antennas with 2 antennas mounted on a side-by-side bracket attached to the existing mast pipe and install one antenna on existing pipe mast at a height to match the existing antennas. Install 2 remote radio heads and install one large junction box to replace small junction box mounted to existing pipe mounts. Total: 4 antennas, 2 remote radio heads and 1 large junction box. – *See Roof Plan Sheet C-1*.

See Exhibit 2, Plans. See Exhibit 3, Photo Simulations

SATISFACTION OF ELIGIBLE FACILITIES REQUEST STANDARDS

On February 22, 2012, President Obama signed into law H.R. 3630, known as the "Middle Class Tax Relief and Job Creation Act of 2012," which then became Public Law 112-96 ("P.L. 112-96"). Section 6409(a) of P.L. 112-96 adds new language to the existing body of laws, regulations, and decisions pertaining to wireless facility zoning.²

Verizon Wireless respectfully submits the proposed modifications satisfy the standards for an eligible facility request pursuant to 47 U.S.C. §1455 and 47 C.F.R. §1.6100. In an effort to advance Congress' goal of facilitating the rapid deployment of qualified modifications, the Federal Communications Commission adopted rules in 2014 that clarified many of the terms of Section 6409(a). The Commission stated that the purpose of implementing the rules "will serve the public interest by providing guidance to all stakeholders on their rights and responsibilities under the provision, reducing the delays in the review process for wireless infrastructure modifications, and facilitating the rapid deployment of wireless infrastructure, thereby promoting the advanced wireless broadband services."

47 U.S. Code §1455(a) and 47 C.F.R. §1.6100(b) builds on the existing legal framework for wireless facilities by requiring permitting authorities to approve an eligible facilities request in an effort to streamline "the process for siting of a wireless facility by preempting the ability of State and local authorities to delay collocation of, removal of, and replacement of wireless transmission equipment." "Collocation" is defined as "the mounting or installation of transmission equipment on an eligible support structure for the purpose of transmitting and/or receiving radio frequency signals for communications purposes." The term "eligible support structure" means any structure that is a "tower" or "base station." A "base station" is defined as a structure or equipment that enables Commission-licensed or authorized wireless communications and includes any structure other than a tower that supports or houses permitted equipment used for wireless

(a) FACILITY MODIFICATIONS.—

¹ Middle Class Tax Relief and Job Creation Act of 2012, Pub L. No. 112-96, 126 Stat. 156 (2012).

² Section 6409(a) states:

⁽¹⁾ IN GENERAL.—Notwithstanding section 704 of the Telecommunications Act of 1996 (Public Law 104–104) or any other provision of law, a State or local government may not deny, and shall approve, any eligible facilities request for a modification of an existing wireless tower or base station that does not substantially change the physical dimensions of such tower or base station.

(2) ELIGIBLE FACILITIES REQUEST.—For purposes of this subsection, the term "eligible facilities request" means any request for modification of an existing wireless tower or base station.

facilities request' means any request for modification of an existing wireless tower or base station that involves—

⁽A) collocation of new transmission equipment;

⁽B) removal of transmission equipment; or

⁽C) replacement of transmission equipment.

⁽³⁾ APPLICABILITY OF ENVIRONMENTAL LAWS.—Nothing in paragraph (1) shall be construed to relieve the Commission from the requirements of the National Historic Preservation Act or the National Environmental Policy Act of 1969.

³ See Accelerating of Broadband Deployment by Improving Wireless Facilities Siting Policies, Report and Order, 29 FCC Rcd 12865 (2014) ("2014 Order").

⁴ Id. At 12872.

⁵ 158 Cong. Rec. E237 (daily ed. Feb. 24, 2012) (statement of Rep. Upton).

communications services.⁶ The term "eligible facilities request" includes any request for modification of an existing wireless tower or base station that involves— (i) collocation of new transmission equipment; (ii) removal of transmission equipment; or (iii) replacement of transmission equipment.⁷

The Property constitutes a "base station" and an "eligible support structure" in that it currently exists and "supports and houses" wireless communication equipment that has been reviewed and approved under the City's zoning ordinance. The proposed replacement of the Verizon Wireless antennas and remote heads on the Property for the purpose of transmitting and receiving radio frequency signals for communication purposes constitutes a "replacement of transmission equipment" and the proposed addition of antennas is the "collocation of new transmission equipment."

Federal authorities clearly provide that an eligible facilities request must be approved if the installation does not result in a substantial change. The proposed modifications to the existing Verizon Wireless facility is an "eligible facilities request." Through its statutory mandate and given the lack of statutory definitions, the Federal Communications Commission has defined a substantial change under Section 6409(a) as follows:

- (i) For other eligible support structures (i.e., the "Building"), it increases the height of the structure by more than 10% or more than ten feet, whichever is greater There will be no increase in height. The proposed ballast mounted antennas and remote radio heads will not be any higher.
- (ii) For other eligible support structures (i.e., the "Building"), it involves adding an appurtenance to the body of the structure that would protrude from the edge of the structure by more than six feet The proposed additional and replacement antennas will not protrude more than six feet from the ballasts.
- (iii) For any eligible support structure (i.e., the "Building"), it involves installation of more than the standard number of new equipment cabinets for the technology involved, but not to exceed four cabinets; or, it involves installation of any new equipment cabinets on the ground if there are no pre-existing ground cabinets associated with the structure The proposed modification does not involve the installation of new cabinets. All radio equipment will remain at the current location.
- (iv) It does not entail any excavation or deployment outside the current site **The** modification does not involve any excavation or deployment outside the current site.
- (v) It would not defeat the concealment elements of the eligible support structure Verizon Wireless' modifications do not defeat any concealment elements the replacement antennas mounted to the ballasts at the same location and height as the replaced antennas.

⁶ 47 C.F.R. §1.6100(b)(1)

⁷ 47 U.S.C. § 1455(a)(2) and §1.6100(b)(3)

⁸ See 47 U.S.C. §1455(a) and 47 C.F.R. §1.6100(b)

(vi) It complies with conditions associated with the siting approval – **The** installation will remain compliant.

It is clear that state and local authorities have no power to deny a complying installation, and any attempt to do so would be in direct conflict with federal law. Having satisfied the standards for the modification of an eligible support structure that will not result in a substantial change, the Board may not deny the Section 6409(a) Modification. Consistent with that determination, the permitting is limited to non-discretionary permitting related to applicable building, structural and electrical codes. Additionally, when an applicant asserts in writing that a request for a modification is covered by this section, a State or local government may only require the applicant to provide documentation or information to the extent reasonably necessary to determining whether the request meets the requirements for an eligible facilities request. Further, the Federal Communications Commission also adopted rules that require local review subject to Section 6409(a) be completed within sixty (60) days. A Section 6409(a) request will be "deemed granted" if not approved within the sixty (60) day period.

SATISFACTION OF SPECIAL PERMIT REVIEW STANDARDS

Based on the description set forth herein, and as will be further demonstrated at the Public Hearing on this matter, the proposed modification of the Facility meets the location, height and site requirements of Section 4.32(g)(1), Section 4.40 (footnote 4) and Sections 10.40 - 10.46. Pursuant to Ordinance, the modification of the Facility is allowed upon the grant of a special permit from the Zoning Board of Appeals in the currently designated Industry B zoning district.

While reserving all rights, Verizon Wireless' modification satisfies the standards set forth in Section 4.40 (footnote 4) and Sections 10.40 – 10.46 of the City of Cambridge, Zoning Ordinance.

1. The scope of or limitations imposed by any license secured from any state or federal agency having jurisdiction over such matters – **Verizon Wireless operates in compliance** with all of the rules and regulations promulgated by the Federal Communications Commission as required by its licensing.

See Exhibit 4, FCC License to Operate.

- 2. The extent to which the visual impact of the various elements of the proposed facility is minimized: (1) Through the use of existing mechanical elements on a building's roof or other features of the building as support and background, (2) Through the use of materials that in texture and color blend with the materials to which the facilities are attached, or (3) Other effective means to reduce the visual impact of the facility from off the site Verizon Wireless proposes to mount a total of twelve (12) antennas to the 3 existing ballasts with remote radio heads.
- 3. Where it is proposed to erect such a facility in any residential zoning district, the extent to which there is a demonstrated public need for the facility at the proposed

locations, the existence of alternative, functionally suitable sites in nonresidential locations, the character of the prevailing uses in the area, and the prevalence of other, existing mechanical systems and equipment carried on or above the roof of nearby structures. The Board of Zoning Appeal shall grant a special permit to erect such a facility in a residential zoning district only upon a finding that nonresidential uses predominate in the vicinity of the proposed facility's location and that the telecommunication facility is not inconsistent with the character that does prevail in the surrounding neighborhood — The wireless use and modification of the Facility is consistent with the purpose of the Industry B (IB) District.

The proposed modification also satisfies the standards of Section 10.43 of the Ordinance for the grant of special permits. As noted above, the proposed modification will allow Verizon Wireless to improve wireless signal coverage and is an integral part of Verizon Wireless' network design in the City of Cambridge. The modification of the equipment detailed herein will aid in reaching Verizon Wireless' goal to provide enhanced service and communications in the City of Cambridge. The proposed modification will generate no traffic or other negative impacts on surrounding properties or the City of Cambridge. The WTF requires no water or sewer services. The utilities will continue to be obtained from existing service. The Facility will continue to be unoccupied, with no employees or customers. The Facility will continue to be regularly maintained by qualified technicians to assure that the equipment operates at optimal condition so that no threat of explosion, fire or other danger to life or property occurs. Reliable wireless service also enhances community safety, because it is used by public safety officials as well as the public in times of crisis, natural disaster, inclement weather and similar circumstances.

It is a truism to state that it is absolutely essential that there is the necessary infrastructure to ensure access to reliable wireless services. The ability to utilize mobile devices has become so integral that the absence of reliable service certainly has a negative impact. The availability of reliable wireless service also provides greater access to 911 emergency services. Maintaining wireless service provides another tool for ensuring that emergencies can be reported as quickly as possible, which reduces the response times of public safety personnel.

Because the application is for the modification of equipment that provides wireless services, the proposal is subject to §704 of the federal Telecommunications Act of 1996 ("TCA"), codified at 47 U.S.C. §332(c)(7)(B). By way of background, the TCA is a federal law enacted in 1996 whose purpose is "[t]o promote competition and reduce regulation in order to secure lower prices and higher quality services for American telecommunications consumers and encourage the rapid deployment of new telecommunications technologies." To further this purpose, the TCA established national standards that apply to permitting for wireless facilities. These standards preempt inconsistent state and local laws, so they must be considered in making decisions related to wireless facilities.

The proposed modification of the existing Facility satisfies the criteria for granting a special permit, Verizon Wireless respectfully requests that the Board grant a special

permit to modify the existing facility to allow for the proposed upgrade of this existing mobile communications system.

CONCLUSION

The availability of wireless communications service enhances community safety, and is increasingly relied upon by civil defense and other safety officers as well as the general public in times of crisis, natural disaster, bad storms or similar circumstances. Wireless communications service also provides a convenience to residents, and is an attractive feature and service to businesses. The proposed modification, by providing these services, will promote the health, safety, convenience and general welfare of the inhabitants of the City of Cambridge.

In compliance with Section 6409(a) of the federal Middle Class Tax Relief and Job Creation Act of 2012, the proposed modification constitutes an eligible facilities request entitled to approval. In the alternative, with all rights reserved, the proposed modification meets all the standards for a special permit pursuant to the City's Zoning Ordinance. Verizon Wireless respectfully requests that the Board vote to grant a special permit and any other relief pursuant to the City of Cambridge Zoning Ordinance, Massachusetts General Laws chapter 40A, and, the federal Telecommunications Act of 1996.

Exhibit 1 "ZBA Application Form – Ownership Information"

BZA APPLICATION FORM - OWNERSHIP INFORMATION

To be completed by OWNER, signed before a notary and returned to The Secretary of the Board of Zoning Appeals.


I/We KENDAW SQUARE ENTITY, INC
Address: 1270 SOLDIERS FIELD ROAD, BOSTON, MA 02135-1003
State that I/We own the property located at 141 PORTLAND ST, CAMBRIDGE, MA
which is the subject of this zoning application.
The record title of this property is in the name of KENDAU
SQUARE ENTITY INC.
*Pursuant to a deed of duly recorded in the date 12(3185, Middlesex South
County Registry of Deeds at Book 16682, Page 565; or
Middlesex Registry District of Land Court, Certificate No
Book
SIGNATURE BY LAND OWNER OR AUTHORIZED TRUSTEE, OFFICER OR AGENT* *Written evidence of Agent's standing to represent petitioner may be requested.
Commonwealth of Massachusetts, County of Suffer
The above-name $\frac{\text{Paul}}{\text{UnvoS}}$ personally appeared before me, this $\frac{31^{\text{St}}}{\text{Of}}$ of $\frac{\text{July}}{\text{UnvoS}}$, 2020, and made oath that the above statement is true.
My commission expires (Notary Seal) Andrea D. Salvi NOTARY PUBLIC Commonwealth of Massachusetts My Commission Expires December 26, 2025
• If ownership is not shown in recorded deed, e.g. if by court order, recent deed, or inheritance, please include documentation.

Exhibit 2 "Plans"



MIT MA

198 BROADWAY (AKA 141 PORTLAND STREET) CAMBRIDGE, MA 02139

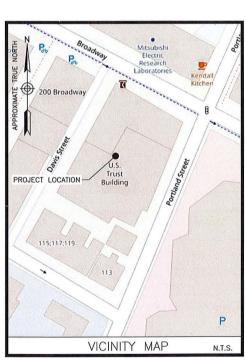

DIRECTIONS FROM WESTBOROUGH, MA:

TAKE MA-9 E. MERGE ONTO I-90 E. TAKE EXIT 18 TOWARD

CAMBRIDGE. SLIGHT RIGHT ONTO CAMBRIDGE STREET. TURN RIGHT ONTO MEMORIAL DR. TURN LEFT ONTO VASSAR ST. TURN LEFT ONTO MASSACHUSETTS AVE. TURN RIGHT ONTO ALBANY ST. ALBANY ST TURNS SLIGHTLY LEFT AND BECOMES PORTLAND ST.

ENGINEER DEWBERRY ENGINEERS INC. 99 SUMMER ST. SUITE 700 BOSTON, MA 02110 PHONE # (617) 531–0813 FAX # (617) 695–3310 CONTACT: BENJAMIN REVETTE, P.E. CONSTRUCTION VERIZON WIRELESS 118 FLANDERS ROAD WESTBOROUGH, MA 01581–3956 PHONE # (617) 921–9716 CONTACT: ERIC WAINWRIGHT

SITE NAME: MIT MA

PROPERTY OWNER:
U.S.T., FINANCIAL PLANNING CO., INC.
O INTERCONTINENTAL MANAGEMENT CORF

C/O INTERCONTINENTAL MANAGEMENT CORP. 1270 SOLDIERS FIELD ROAD BRIGHTON, MA 02135

APPLICANT:
CELLCO PARTNERSHIP
D/B/A VERIZON WIRELESS
118 FLANDERS ROAD
WESTBOROUGH, MA 01581-3956

ELECTRIC UTILITY: EVERSOURCE 1-800-592-2000

TELEPHONE UTILITY: VERIZON 1-800-870-9999

CENTER OF EXISTING STRUCTURE*: LATITUDE: 42' 21' 56.5" N LONGITUDE: 71' 05' 33.2" W * PER GOOGLE EARTH

PROJECT SUMMARY

SITE ADDRESS:

198 BROADWAY

(AKA 141 PORTLAND STREET)

ZONING DISTRICT:

MAP/LOT: 42 / 70

PROJECT DIRECTORY

THE SITE WILL CONSIST OF REMOVING (9) EXISTING ANTENNAS AND REPLACING WITH (9) NEW ANTENNAS ANTENNAS (3/SECTOR). (6) RRHS WILL BE REMOVED AND REPLACED WITH (6) NEW RRHS (2/SECTOR). EXISTING JUNCTION BOXES AND HYBRID CABLES WILL BE REMOVED AND REPLACED WITH NEW JUNCTION BOXES AND HYBRID CABLES.

PROJECT DESCRIPTION

THIS DOCUMENT WAS DEVELOPED TO REFLECT A SPECIFIC SITE AND ITS SITE CONDITIONS AND IS NOT TO BE USED FOR ANOTHER SITE OR WHEN OTHER CONDITIONS PERTAIN. REUSE OF THIS DOCUMENT IS AT THE SOLE RISK OF THE USER.

FACILITY IS UNMANNED AND NOT FOR HUMAN HABITATION.

SHT. NO.	DESCRIPTION
T-1	TITLE SHEET
C-1	ROOF PLAN
C-2	ELEVATION
C-3	CONSTRUCTION DETAILS
C-4	CONSTRUCTION DETAILS & NOTES
	SHEET INDEX



VERIZON WIRELESS 400 FRIBERG PARKWAY WESTBOROUGH, MA 01581-3956

MIT MA

	ANTMO	DRAWINGS
2	08/31/20	FOR SUBMITTAL
1	08/24/20	FOR SUBMITTAL
0	04/07/20	FOR SUBMITTAL
Α	02/19/20	FOR COMMENT



Dewberry Engineers Inc. 99 SUMMER STREET SUITE 700 BOSTON, MA 02110 PHONE: 617,695,3400 FAX: 617,695,3410



DRAWN BY:	SCA
REVIEWED BY:	CDH
CHECKED BY:	BBR
PROJECT NUMBER:	50121487
JOB NUMBER:	50121515
SITE NUMBER	

137421

SITE ADDRESS:


198 BROADWAY (AKA 141 PORTLAND STREET CAMBRIDGE, MA 02139

SHEET TITLE

TITLE SHEET

SHEET NUMBER

T-1

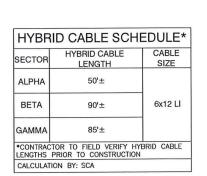


SCOPE OF WORK

- REMOVE (2) EXISTING CONCRETE 12"x12"x12" BALLAST BLOCKS ON EACH BALLAST FRAME (6 TOTAL)
- REMOVE (9) PANEL ANTENNAS (3/SECTOR)
- REMOVE (6) RRHS (2/SECTOR)
- REMOVE (3) SMALL JUNCTION BOXES (1/SECTOR)
 FROM THE ROOFTOP & (3) SMALL JUNCTION BOXES
 (1/SECTOR) FROM THE EQUIPMENT ROOM.
- REMOVE (3) EXISTING 6x12 HYBRID CABLES.
- INSTALL (6) NEW PANEL ANTENNAS ON SIDE—BY—SIDE MOUNTS ATTACHED TO EXISTING MAST PIPES (2 ANTENNAS/SECTOR)
- INSTALL (3) NEW NR HRU ANTENNAS ON EXISTING MAST PIPES (1/SECTOR)
- INSTALL (6) NEW RRHS (2/SECTOR)
- INSTALL (3) NEW LARGE JUNCTION BOXES (1/SECTOR)
- INSTALL (3) NEW 6x12 LI HYBRID CABLES (1/SECTOR)
- INSTALL (3) NEW 1x1 JUMPER CABLES (1/SECTOR)
- EXISTING & PROPOSED ANTENNAS & MOUNTS SHALL BE GROUNDED PER VERIZON WIRELESS SPECIFICATIONS

SCOPE OF WORK BASED ON RFDS FOR MIT MA DATED 04/02/2020. VERIFY SCOPE OF WORK WITH FINAL RFDS PRIOR TO CONSTRUCTION.

SITE NOTES:

- 1. NORTH ARROW SHOWN AS APPROXIMATE.
- 2. EXISTING BUILDING AND ANTENNA ELEVATIONS ARE APPROXIMATE AND HAVE NOT BEEN VERIFIED WITH A MAPPING.
- 3. PLANS BASED ON SITE VISITS BY DEWBERRY ENGINEERS INC. ON 01/08/20 & 02/12/20.
- INSTALL ALL EQUIPMENT PER STRUCTURAL ANALYSIS PACKAGE BY DEWBERRY ENGINEERS INC. DATED 04/07/20.

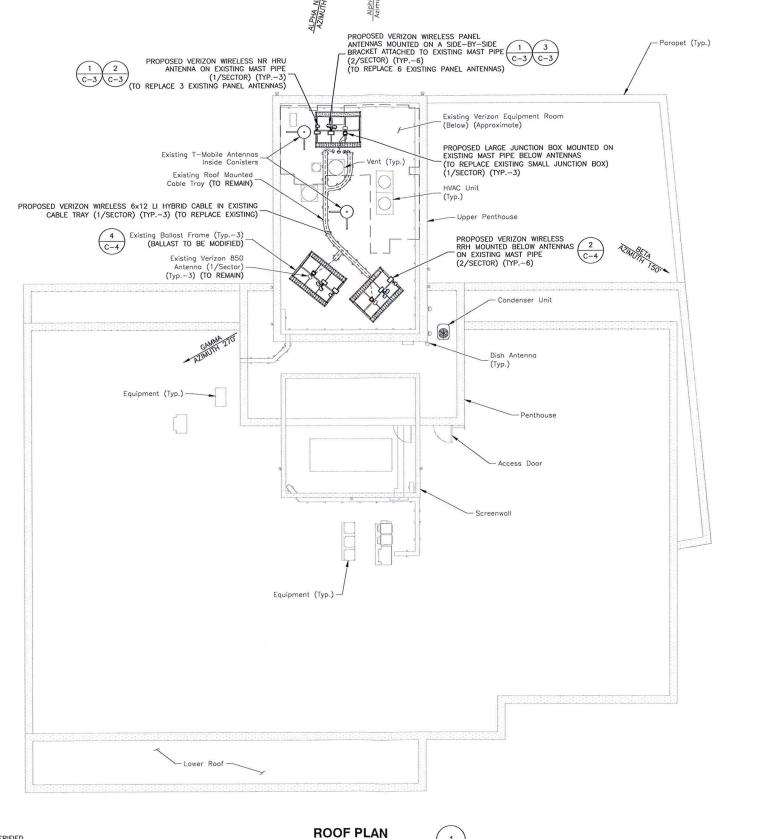

SCALE: 3/64"=1' FOR 11"x17"

3/32"=1' FOR 22"x34"

24'



VERIZON WIRELESS 400 FRIBERG PARKWAY WESTBOROUGH, MA 01581-3956

MIT MA

	ANTMO	DRAWINGS
2	08/31/20	FOR SUBMITTAL
1	08/24/20	FOR SUBMITTAL
0	04/07/20	FOR SUBMITTAL
Α	02/19/20	FOR COMMENT



Dewberry Engineers Inc. 99 SUMMER STREET SUITE 700 BOSTON, MA 02110 PHONE: 617.695,3400 FAX: 617.695,3310



DRAWN BY: SCA

BBR

REVIEWED BY: CDH

PROJECT NUMBER: 50121487

JOB NUMBER: 50121515

SITE NUMBER

CHECKED BY:

137421

SITE ADDRESS:


198 BROADWAY (AKA 141 PORTLAND STREET CAMBRIDGE, MA 02139

SHEET TITLE

ROOF PLAN

SHEET NUMBER

C - 1

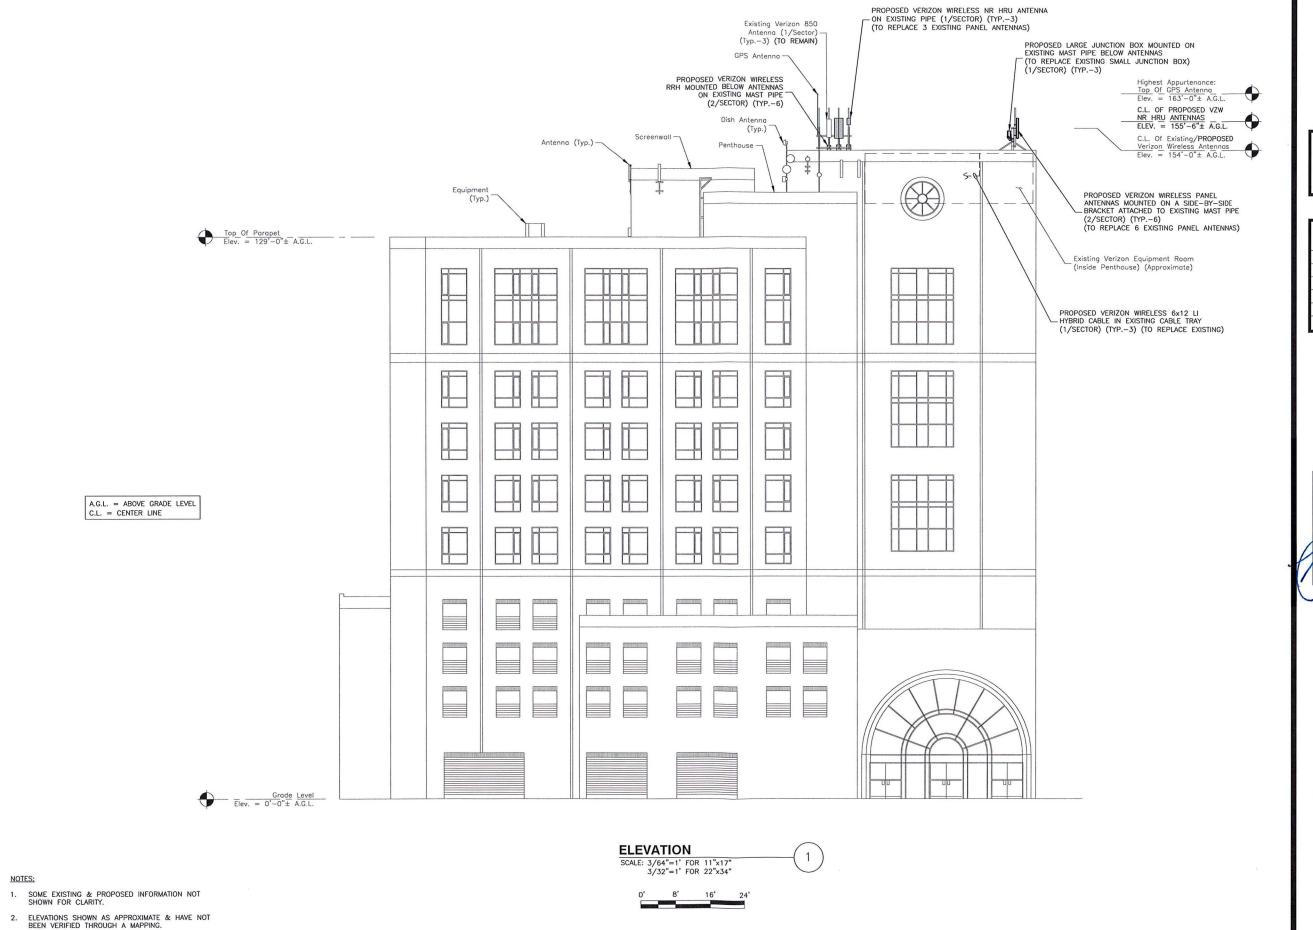



VERIZON WIRELESS 400 FRIBERG PARKWAY WESTBOROUGH, MA 01581-3956

MIT MA

ANTMO DRAWINGS		
_	00 /74 /00	FOR CURWITH
2	08/31/20	FOR SUBMITTAL FOR SUBMITTAL
0	04/07/20	FOR SUBMITTAL
A	02/19/20	FOR COMMENT



Dewberry Engineers Inc.
99 SUMMER STREET
SUITE 700
BOSTON, MA 02110
PHONE: 617,695,3400
FAX: 617,695,3310



DRAWN BY: SCA

REVIEWED BY: CDH

BBR

50121515

CHECKED BY:

PROJECT NUMBER: 50121487

SITE NUMBER

JOB NUMBER:

137421

SITE ADDRESS:

198 BROADWAY (AKA 141 PORTLAND STREET CAMBRIDGE, MA 02139


SHEET TITLE

ELEVATION

SHEET NUMBER

C-2

ALL SECTORS

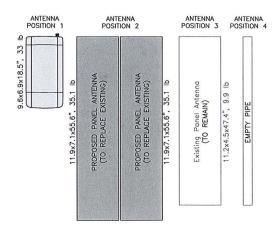


NOTES:

- 1. AS VIEWED STANDING BEHIND THE ANTENNAS.
- ANTENNA CONFIGURATION BASED ON ANTENNA REC DATED 04/02/20. VERIFY SCOPE OF WORK WITH FINAL RFDS PRIOR TO CONSTRUCTION.

ANTENNA CONFIGURATION

SCALE: N.T.S

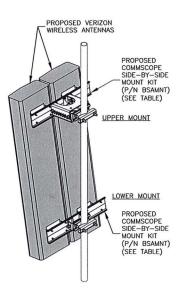

COMMSCOPE P/N: BSAMNT MOUNT TABLE					
COMMSCOPE P/N	SUPPORTED ANTENNAS	QUANTITY REQUIRED PER (2) ANTENNAS	NUMBER OF MOUNTING POINTS	GAP BETWEEN ANTENNAS	
BSAMNT-SBS-1-2	SBNHH-1D65A/B/C NHH-65A/B/C-R2B	1	2	3-3/8"	
BSAMNT-SBS-2-2	JAHH-65A/B/C-R3B JAHH-45A-R3B NHH-45A-R2B SBNHH-1D45A/B	1	2	2"	
BSAMNT-SBS-2-3	NHH-45B/C-R2B JAHH-45B/C-R3B SBNHH-1D45C	1	3	2"	

TABLE BASED ON POWER POINT PRESENTATION BY COMMSCOPE TITLED SIDE BY SIDE MOUNTS. CONTRACTOR TO VERIFY PART NUMBERS WITH MANUFACTURER PRIOR TO ORDERING. INSTALL PER MANUFACTURER RECOMMENDATIONS & SPECIFICATIONS.


NOTES:

SCALE: N.T.S.

- SPACING OF PROPOSED EQUIPMENT SHALL BE CONFIRMED AND PROPOSED MOUNTS SHALL NOT IMPEDE EQUIPMENT CLEARANCES. ACCESS TO EQUIPMENT SHALL BE MAINTAINED.
- PROPOSED ANTENNA MOUNT SHALL BE INSTALLED ACCORDING TO MANUFACTURER SPECIFICATIONS.

SIDE-BY-SIDE ANTENNA MOUNT




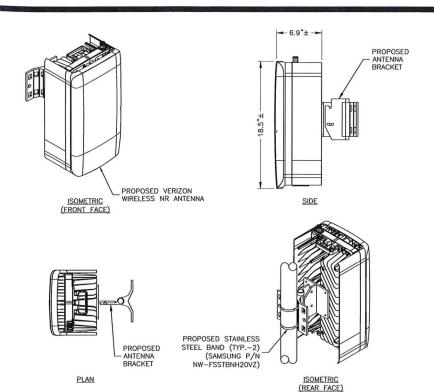

NOTES:

- INSTALL ALL EQUIPMENT PER MANUFACTURER'S RECOMMENDATIONS. USE APPROPRIATE MOUNTING HARDWARE FOR CONSTRUCTION TYPE.
- 2. ANTENNA WEIGHT: 33.0 LBS.



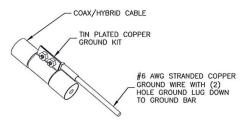

NOTES:

- DO NOT INSTALL CABLE GROUND KIT AT A BEND, ALWAYS DIRECT GROUND WIRE DOWN TO GROUND BAR.
- 2. GROUNDING KIT SHALL BE TIN PLATED COPPER WITH TWO—HOLE LUG, SIZE PER COAX DIAMETER.
- 3. WEATHER SEAL GROUND KIT PER CARRIER REQUIREMENTS.
- COAX CABLE GROUND KIT LOCATION & QUANTITY SHALL BE PER CARRIER SPECIFICATIONS & STANDARDS.

COAX/HYBRID GROUNDING DETAIL

SCALE: N.T.S.



VERIZON WIRELESS 400 FRIBERG PARKWAY WESTBOROUGH, MA 01581-3956

MIT MA

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Α	02/19/20	FOR COMMENT



Dewberry Engineers Inc.
99 SUMMER STREET
SUITE 700
BOSTON, MA 02110
PHONE: 617.095.3400
FAX: 617.605.3310



DRAWN BY:	SCA
REVIEWED BY:	CDH
CHECKED BY:	BBR
PROJECT NUMBER:	50121487
JOB NUMBER:	50121515

137421

SITE ADDRESS:

198 BROADWAY (AKA 141 PORTLAND STREET CAMBRIDGE, MA 02139

SHEET TITLE


CONSTRUCTION DETAILS

SHEET NUMBER

C - 3

GENERAL NOTES:


- ALL DIMENSIONS TO, OF, AND ON EXISTING BUILDINGS, DRAINAGE STRUCTURES, AND SITE IMPROVEMENTS SHALL BE VERIFIED IN FIELD BY CONTRACTOR PRIOR TO ALL FABRICATION WITH ALL DISCREPANCIES REPORTED IMMEDIATELY TO THE ENGINEER.
- 2. DO NOT CHANGE SIZE NOR SPACING OF STRUCTURAL ELEMENTS.
- 3. DETAILS SHOWN ARE TYPICAL; SIMILAR DETAILS APPLY TO SIMILAR CONDITIONS UNLESS OTHERWISE NOTED.
- THESE DRAWINGS DO NOT INCLUDE NECESSARY COMPONENTS FOR CONSTRUCTION SAFETY WHICH IS THE SOLE RESPONSIBILITY OF THE CONTRACTOR.
- BRACE STRUCTURES UNTIL ALL STRUCTURAL ELEMENTS NEEDED FOR STABILITY ARE INSTALLED. THESE ELEMENTS ARE AS FOLLOWS: LATERAL BRACING, ANCHOR BOLTS, ETC.
- 6. DETERMINE EXACT LOCATION OF EXISTING UTILITIES, DRAIN PIPES, VENTS, ETC. BEFORE COMMENCING WORK.
- INCORRECTLY FABRICATED, DAMAGED, OR OTHERWISE MISFITTING OR NONCONFORMING MATERIALS OR CONDITIONS SHALL BE REPORTED TO THE OWNER PRIOR TO REMEDIAL OR CORRECTIVE ACTION. ANY SUCH REMEDIAL ACTION SHALL REQUIRE WRITTEN APPROVAL BY THE OWNER'S REPRESENTATIVE PRIOR TO PROCEEDING.
- 8. EACH CONTRACTOR SHALL COOPERATE WITH THE OWNER'S REPRESENTATIVE, AND COORDINATE HIS WORK WITH THE WORK OF OTHERS.
- REPAIR ANY DAMAGE DURING CONSTRUCTION TO MATCH EXISTING PRE-CONSTRUCTION CONDITIONS TO THE SATISFACTION OF THE CONSTRUCTION MANAGER.
- ALL CABLE/CONDUIT ENTRY/EXIT PORTS SHALL BE WEATHERPROOFED DURING INSTALLATION USING A SILICONE SEALANT.
- 11. THE CONTRACTOR SHALL SUPERVISE AND DIRECT THE PROJECT DESCRIBED HEREIN. THE CONTRACTOR SHALL BE SOLELY RESPONSIBLE FOR ALL CONSTRUCTION MEANS, METHODS, TECHNIQUES, SEQUENCES AND PROCEDURES AND FOR COORDINATING ALL PORTIONS OF THE WORK UNDER THE CONTRACT.
- 12. SEAL PENETRATIONS THROUGH FIRE RATED AREAS WITH UL LISTED D FIRE CODE
- 13. TURN OVER ALL SALVAGEABLE BUILDING MATERIAL TO BUILDING MANAGER.
- 14. ALL DISRUPTIVE WORK AND WORK WITHIN TENANT SPACES TO BE COORDINATED WITH
- ALL ROOF PENETRATIONS SHALL BE RESTORED TO MAINTAIN ALL ROOF WARRANTIES AND ENSURE A PERMANENT WATERPROOF SEAL.

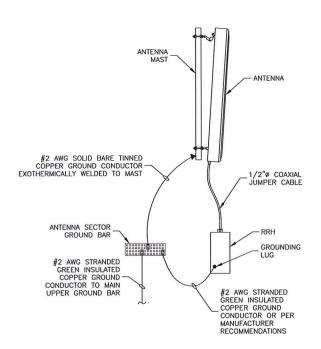

NOTES:

- VERIFY EXISTING GROUNDING SYSTEM IS INSTALLED PER VERIZON WIRELESS STANDARDS.
- 2. BOND NEW EQUIPMENT INTO EXISTING GROUND SYSTEM IN ACCORDANCE WITH VERIZON WIRELESS STANDARDS & MANUFACTURER'S RECOMMENDATIONS.


TYPICAL ANTENNA/RRH **GROUNDING DETAIL** SCALE: N.T.S

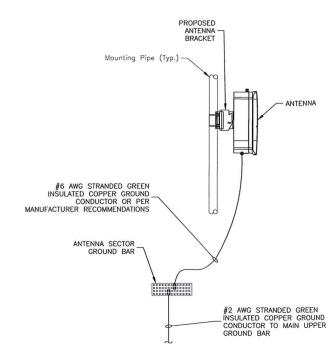

NOTES:

- 1. VERIFY EXISTING GROUNDING SYSTEM IS INSTALLED PER VERIZON
- BOND NEW EQUIPMENT INTO EXISTING GROUND SYSTEM IN ACCORDANCE WITH VERIZON WIRELESS STANDARDS AND MANUFACTURER'S RECOMMENDATIONS.

TYPICAL NR ANTENNA **GROUNDING DETAIL**

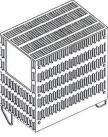

LTE 700/850



LTE AWS/PCS



MANUFACTURER: SAMSUNG B2/B66A RRH BR049 MODEL:

MANUFACTURER:

DIMENSIONS:

MODEL:

WEIGHT:

15.0"H X 15.9"W X 10.0"D 97.5 LBS WEIGHT:

SAMSUNG

82.0 LBS

B5/B13 RRH BRO4C


15.0"H X 15.0"W X 8.1"D

NOTES:

- 1. COAX & JUMPERS NOT SHOWN FOR CLARITY.
- 2. GROUND RRHS AND MOUNTS PER MANUFACTURER'S RECOMMENDATIONS AND VERIZON WIRELESS STANDARDS.
- CONFIRM REQUIRED RRHS WITH THE LATEST ANTENNA REC.

RRH DETAILS

2

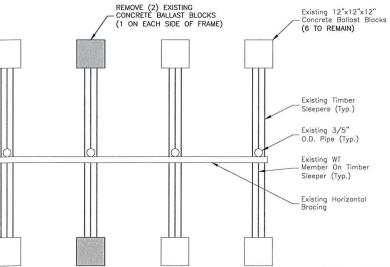

BALLAST MODIFICATIONS SCALE: N.T.S.

VERIZON WIRELESS 400 FRIBERG PARKWAY WESTBOROUGH, MA 01581-3956

MIT MA

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1	08/24/20	FOR SUBMITTAL	
0	04/07/20	FOR SUBMITTAL	
Α	02/19/20	FOR COMMENT	



Dewberry Engineers Inc. 99 SUMMER STREET SUITE 700 BOSTON, MA 02110 PHONE: 617,695,3400 FAX: 617,695,3310



DRAWN BY: SCA REVIEWED BY: CDH

CHECKED BY: BBR PROJECT NUMBER: 50121487

JOB NUMBER: 50121515

SITE NUMBER

137421

SITE ADDRESS: 198 BROADWAY

(AKA 141 PORTLAND STREET CAMBRIDGE, MA 02139

SHEET TITLE

CONSTRUCTION DETAILS & NOTES

SHEET NUMBER

Exhibit 3 "Photo Simulations"



For visual reference only. Actual visibility is dependent upon weather conditions, season, sunlight, and viewer location.


118 Flanders Road Westborough, MA 01581

MIT MA


DEWBERRY NO. 50121515 (Page 1 of 10)




Dewberry Engineers Inc. 99 Summer St. Suite 700 Boston, MA 02110

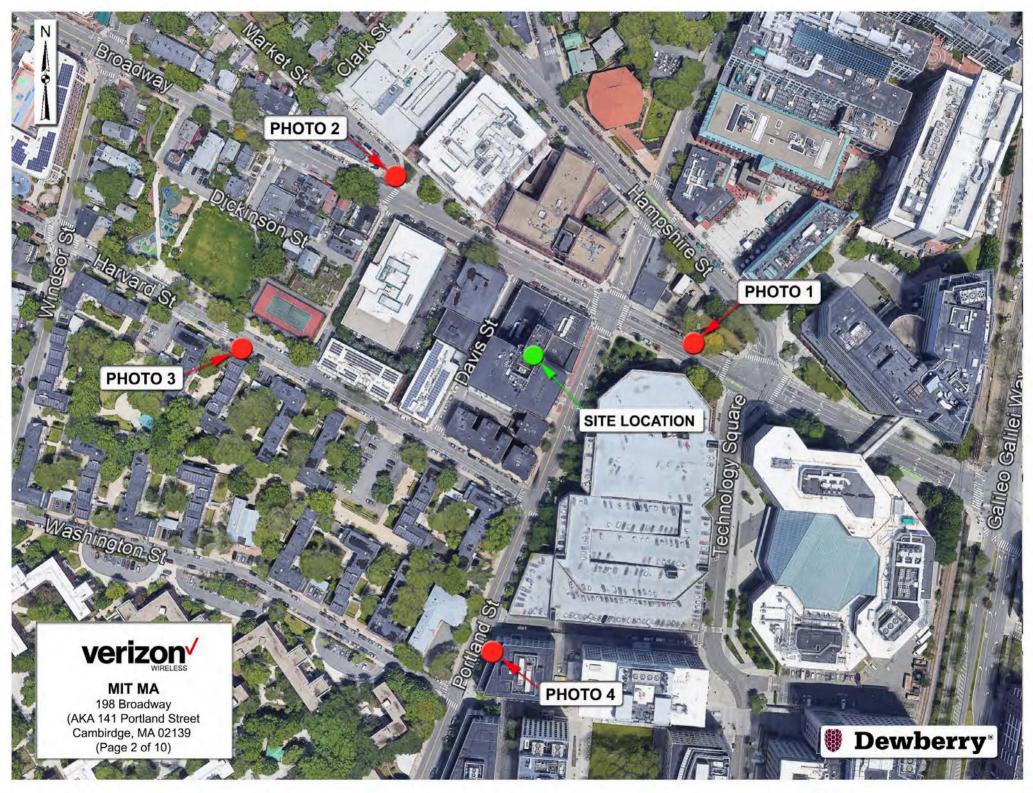




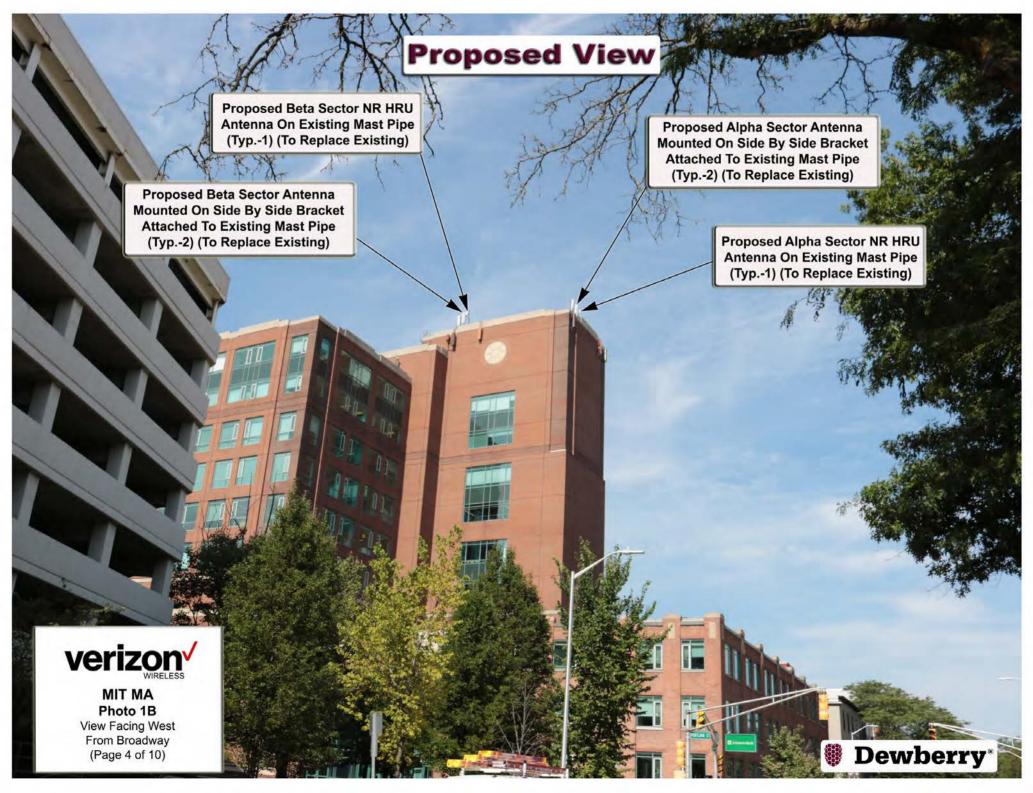



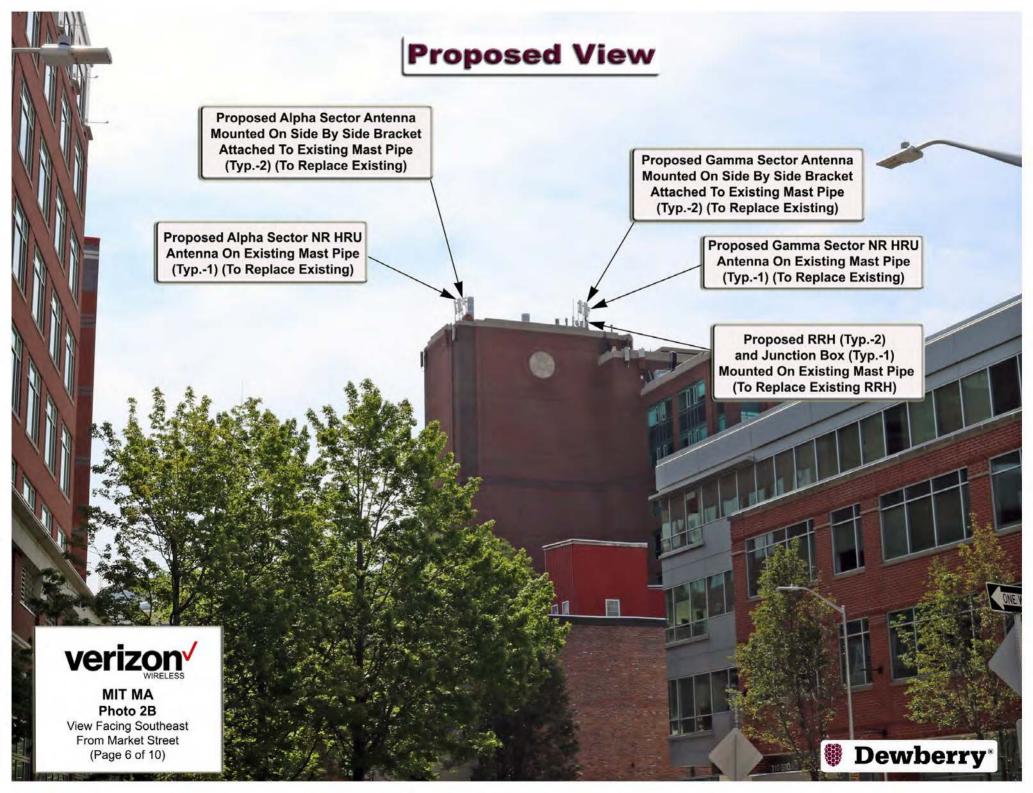

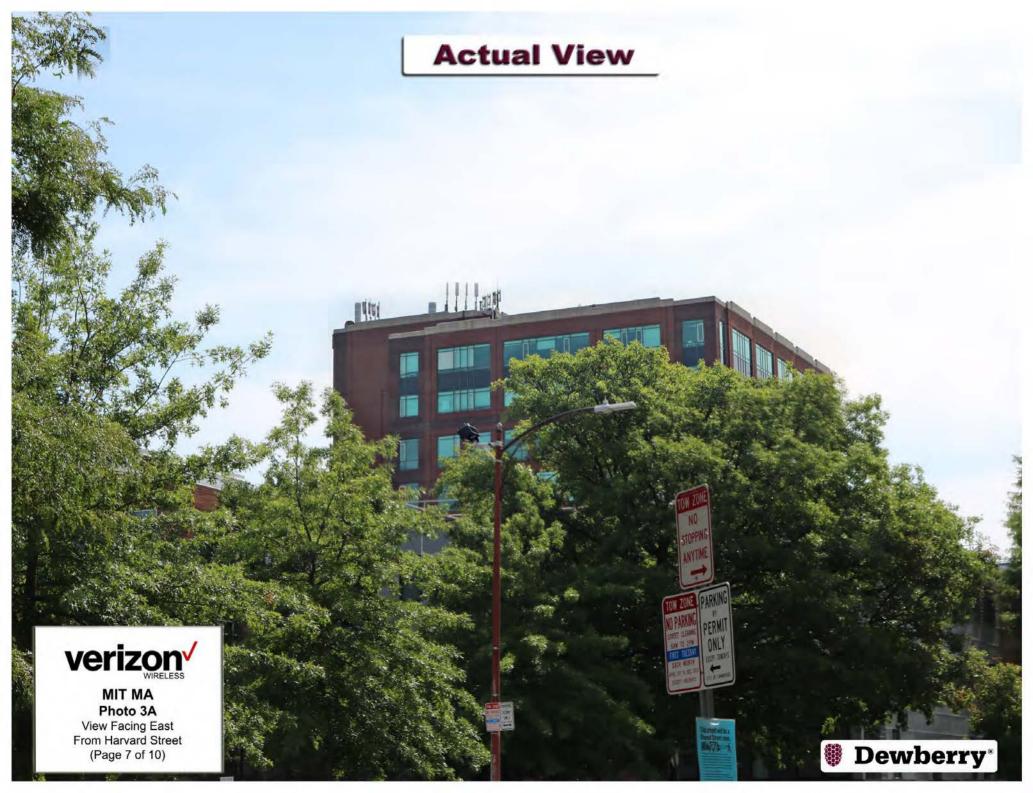

Proposed View

Proposed Alpha Sector Antenna Mounted On Side By Side Bracket Attached To Existing Mast Pipe (Typ.-2) (To Replace Existing) Proposed Gamma Sector Antenna Mounted On Side By Side Bracket Attached To Existing Mast Pipe (Typ.-2) (To Replace Existing)

Proposed Alpha Sector NR HRU Antenna On Existing Mast Pipe (Typ.-1) (To Replace Existing) Proposed Gamma Sector NR HRU Antenna On Existing Mast Pipe (Typ.-1) (To Replace Existing)

Proposed RRH (Typ.-2) and Junction Box (Typ.-1) Mounted On Existing Mast Pipe (To Replace Existing RRH)



MIT MA Photo 3B

View Facing East From Harvard Street (Page 8 of 10)







Exhibit 4 "FCC License to Operate"

REFERENCE COPY

This is not an official FCC license. It is a record of public information contained in the FCC's licensing database on the date that this reference copy was generated. In cases where FCC rules require the presentation, posting, or display of an FCC license, this document may not be used in place of an official FCC license.



Federal Communications Commission

Wireless Telecommunications Bureau

RADIO STATION AUTHORIZATION

LICENSEE: CELLCO PARTNERSHIP

ATTN: REGULATORY CELLCO PARTNERSHIP 5055 NORTH POINT PKWY, NP2NE ENGINEERING ALPHARETTA, GA 30022

Call Sign WRBA936	File Number		
Radio	Service		
UU - Upper Microwave Flexible Use			
Serv	vice		

FCC Registration Number (FRN): 0003290673

Grant Date 09-11-2018	Effective Date 02-27-2019	Expiration Date 10-06-2028	Print Date
Market Number BTA051		nel Block L1	Sub-Market Designator
	Market Boston		
1st Build-out Date 06-01-2024	2nd Build-out Date	3rd Build-out Date	4th Build-out Date

Waivers/Conditions:

Grant of the request to update licensee name is conditioned on it not reflecting an assignment or transfer of control (see Rule 1.948); if an assignment or transfer occurred without proper notification or FCC approval, the grant is void and the station is licensed under the prior name.

Conditions:

Pursuant to §309(h) of the Communications Act of 1934, as amended, 47 U.S.C. §309(h), this license is subject to the following conditions: This license shall not vest in the licensee any right to operate the station nor any right in the use of the frequencies designated in the license beyond the term thereof nor in any other manner than authorized herein. Neither the license nor the right granted thereunder shall be assigned or otherwise transferred in violation of the Communications Act of 1934, as amended. See 47 U.S.C. § 310(d). This license is subject in terms to the right of use or control conferred by §706 of the Communications Act of 1934, as amended. See 47 U.S.C. §606.

This license may not authorize operation throughout the entire geographic area or spectrum identified on the hardcopy version. To view the specific geographic area and spectrum authorized by this license, refer to the Spectrum and Market Area information under the Market Tab of the license record in the Universal Licensing System (ULS). To view the license record, go to the ULS homepage at http://wireless.fcc.gov/uls/index.htm?job=home and select "License Search". Follow the instructions on how to search for license information.

Licensee Name: CELLCO PARTNERSHIP

Call Sign: WRBA936 File Number: Print Date:

700 MHz Relicensed Area Information:

Market Name Buildout Deadline Buildout Notification Status

REFERENCE COPY

This is not an official FCC license. It is a record of public information contained in the FCC's licensing database on the date that this reference copy was generated. In cases where FCC rules require the presentation, posting, or display of an FCC license, this document may not be used in place of an official FCC license.



Federal Communications Commission

Wireless Telecommunications Bureau

RADIO STATION AUTHORIZATION

LICENSEE: CELLCO PARTNERSHIP

ATTN: REGULATORY CELLCO PARTNERSHIP 5055 NORTH POINT PKWY, NP2NE ENGINEERING ALPHARETTA, GA 30022

Call Sign WRBA937	File Number			
Radio Service				
UU - Upper Microwave Flexible Use				
Serv	vice.			

FCC Registration Number (FRN): 0003290673

Grant Date 09-11-2018	Effective Date 02-27-2019	Expiration Date 10-06-2028	Print Date
Market Number BTA051		nel Block L2	Sub-Market Designator
	Marke Boston	t Name n, MA	
1st Build-out Date 06-01-2024	2nd Build-out Date	3rd Build-out Date	4th Build-out Date

Waivers/Conditions:

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Conditions:

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This license may not authorize operation throughout the entire geographic area or spectrum identified on the hardcopy version. To view the specific geographic area and spectrum authorized by this license, refer to the Spectrum and Market Area information under the Market Tab of the license record in the Universal Licensing System (ULS). To view the license record, go to the ULS homepage at http://wireless.fcc.gov/uls/index.htm?job=home and select "License Search". Follow the instructions on how to search for license information.

Licensee Name: CELLCO PARTNERSHIP

Call Sign: WRBA937 File Number: Print Date:

700 MHz Relicensed Area Information:

Market Name Buildout Deadline Buildout Notification Status

Exhibit 5 "Building Permit"

Permit Fee 19

CITY OF CAMBRIDGE INSPECTIONAL SERVICES DEPARTMENT

NO. 17 09 1 12

DATE JULY-16. 2009

BUILDING PERMIT

THIS MAY CERTIFY THAT		(DICT)		
has permission to	ANEX	JUA WIST	techtan	
situated on	141	DONTUAL	ST	

provided that the person accepting this permit adhere to regulations governing the Inspectional Services Department. Approved plans must be retained on the job site and this permit kept posted until the final inspection has been made. Buildings shall not be occupied until a final inspection has been made and a Certificate of Use and Occupancy has been issued. Twenty-four (24) hours notice is required for inspections and inspections will be made within forty-eight (48) hours. Work shall not proceed until inspectors approve various stages below. Code violations are subject to \$1000 fine/day.

IF ORIGINAL ESTIMATED COST OF JOB IS \$100K OR MORE, THEN A FINAL COST AFFIDAVIT IS REQUIRED PRIOR TO A FINAL SIGN OFF ON BUILDING PERMIT CARD.


Commissioner

Excavation Depth and Soil Conditions Date	Footings Foundation Drains Date	Rough Frame	Wall Ceiling Finish Date	Insulation Date	Electrical Rough	Elect Fina Date	
Inspector	Inspector	Inspector	Inspector	Inspector	Inspector	Inspe	
	m.opesio.			mopodio.	mispodio		
Plumbing	Gas	HVAC	Sanitation	Sanitation	Final Inspection For		Fire
Rough	Rough	Sprinkler	Rough	Final	Certificate of Occupa	ancy	Department
Final	Final						
Date	Date	Date	Date	Date	Date		
Inspector	Inspector	Inspector	Inspector	Inspector	Inspector		Form IS 57



MIT MA

198 BROADWAY (AKA 141 PORTLAND STREET) CAMBRIDGE, MA 02139

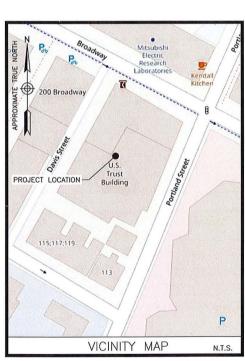

DIRECTIONS FROM WESTBOROUGH, MA:

TAKE MA-9 E. MERGE ONTO I-90 E. TAKE EXIT 18 TOWARD

CAMBRIDGE. SLIGHT RIGHT ONTO CAMBRIDGE STREET. TURN RIGHT ONTO MEMORIAL DR. TURN LEFT ONTO VASSAR ST. TURN LEFT ONTO MASSACHUSETTS AVE. TURN RIGHT ONTO ALBANY ST. ALBANY ST TURNS SLIGHTLY LEFT AND BECOMES PORTLAND ST.

ENGINEER DEWBERRY ENGINEERS INC. 99 SUMMER ST. SUITE 700 BOSTON, MA 02110 PHONE # (617) 531–0813 FAX # (617) 695–3310 CONTACT: BENJAMIN REVETTE, P.E. CONSTRUCTION VERIZON WIRELESS 118 FLANDERS ROAD WESTBOROUGH, MA 01581–3956 PHONE # (617) 921–9716 CONTACT: ERIC WAINWRIGHT

SITE NAME: MIT MA

PROPERTY OWNER:
U.S.T., FINANCIAL PLANNING CO., INC.
O INTERCONTINENTAL MANAGEMENT CORF

C/O INTERCONTINENTAL MANAGEMENT CORP. 1270 SOLDIERS FIELD ROAD BRIGHTON, MA 02135

APPLICANT:
CELLCO PARTNERSHIP
D/B/A VERIZON WIRELESS
118 FLANDERS ROAD
WESTBOROUGH, MA 01581-3956

ELECTRIC UTILITY: EVERSOURCE 1-800-592-2000

TELEPHONE UTILITY: VERIZON 1-800-870-9999

CENTER OF EXISTING STRUCTURE*: LATITUDE: 42' 21' 56.5" N LONGITUDE: 71' 05' 33.2" W * PER GOOGLE EARTH

PROJECT SUMMARY

SITE ADDRESS:

198 BROADWAY

(AKA 141 PORTLAND STREET)

ZONING DISTRICT:

MAP/LOT: 42 / 70

PROJECT DIRECTORY

THE SITE WILL CONSIST OF REMOVING (9) EXISTING ANTENNAS AND REPLACING WITH (9) NEW ANTENNAS ANTENNAS (3/SECTOR). (6) RRHS WILL BE REMOVED AND REPLACED WITH (6) NEW RRHS (2/SECTOR). EXISTING JUNCTION BOXES AND HYBRID CABLES WILL BE REMOVED AND REPLACED WITH NEW JUNCTION BOXES AND HYBRID CABLES.

PROJECT DESCRIPTION

THIS DOCUMENT WAS DEVELOPED TO REFLECT A SPECIFIC SITE AND ITS SITE CONDITIONS AND IS NOT TO BE USED FOR ANOTHER SITE OR WHEN OTHER CONDITIONS PERTAIN. REUSE OF THIS DOCUMENT IS AT THE SOLE RISK OF THE USER.

FACILITY IS UNMANNED AND NOT FOR HUMAN HABITATION.

SHT. NO.	DESCRIPTION
T-1	TITLE SHEET
C-1	ROOF PLAN
C-2	ELEVATION
C-3	CONSTRUCTION DETAILS
C-4	CONSTRUCTION DETAILS & NOTES
	SHEET INDEX



VERIZON WIRELESS 400 FRIBERG PARKWAY WESTBOROUGH, MA 01581-3956

MIT MA

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1	08/24/20	FOR SUBMITTAL		
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Α	02/19/20	FOR COMMENT		



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PROJECT NUMBER:	50121487
JOB NUMBER:	50121515
SITE NUMBER	

137421

SITE ADDRESS:


198 BROADWAY (AKA 141 PORTLAND STREET CAMBRIDGE, MA 02139

SHEET TITLE

TITLE SHEET

SHEET NUMBER

T-1

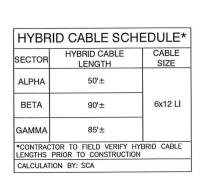


SCOPE OF WORK

- REMOVE (2) EXISTING CONCRETE 12"x12"x12" BALLAST BLOCKS ON EACH BALLAST FRAME (6 TOTAL)
- REMOVE (9) PANEL ANTENNAS (3/SECTOR)
- REMOVE (6) RRHS (2/SECTOR)
- REMOVE (3) SMALL JUNCTION BOXES (1/SECTOR)
 FROM THE ROOFTOP & (3) SMALL JUNCTION BOXES
 (1/SECTOR) FROM THE EQUIPMENT ROOM.
- REMOVE (3) EXISTING 6x12 HYBRID CABLES.
- INSTALL (6) NEW PANEL ANTENNAS ON SIDE—BY—SIDE MOUNTS ATTACHED TO EXISTING MAST PIPES (2 ANTENNAS/SECTOR)
- INSTALL (3) NEW NR HRU ANTENNAS ON EXISTING MAST PIPES (1/SECTOR)
- INSTALL (6) NEW RRHS (2/SECTOR)
- INSTALL (3) NEW LARGE JUNCTION BOXES (1/SECTOR)
- INSTALL (3) NEW 6x12 LI HYBRID CABLES (1/SECTOR)
- INSTALL (3) NEW 1x1 JUMPER CABLES (1/SECTOR)
- EXISTING & PROPOSED ANTENNAS & MOUNTS SHALL BE GROUNDED PER VERIZON WIRELESS SPECIFICATIONS

SCOPE OF WORK BASED ON RFDS FOR MIT MA DATED 04/02/2020. VERIFY SCOPE OF WORK WITH FINAL RFDS PRIOR TO CONSTRUCTION.

SITE NOTES:

- 1. NORTH ARROW SHOWN AS APPROXIMATE.
- 2. EXISTING BUILDING AND ANTENNA ELEVATIONS ARE APPROXIMATE AND HAVE NOT BEEN VERIFIED WITH A MAPPING.
- 3. PLANS BASED ON SITE VISITS BY DEWBERRY ENGINEERS INC. ON 01/08/20 & 02/12/20.
- INSTALL ALL EQUIPMENT PER STRUCTURAL ANALYSIS PACKAGE BY DEWBERRY ENGINEERS INC. DATED 04/07/20.

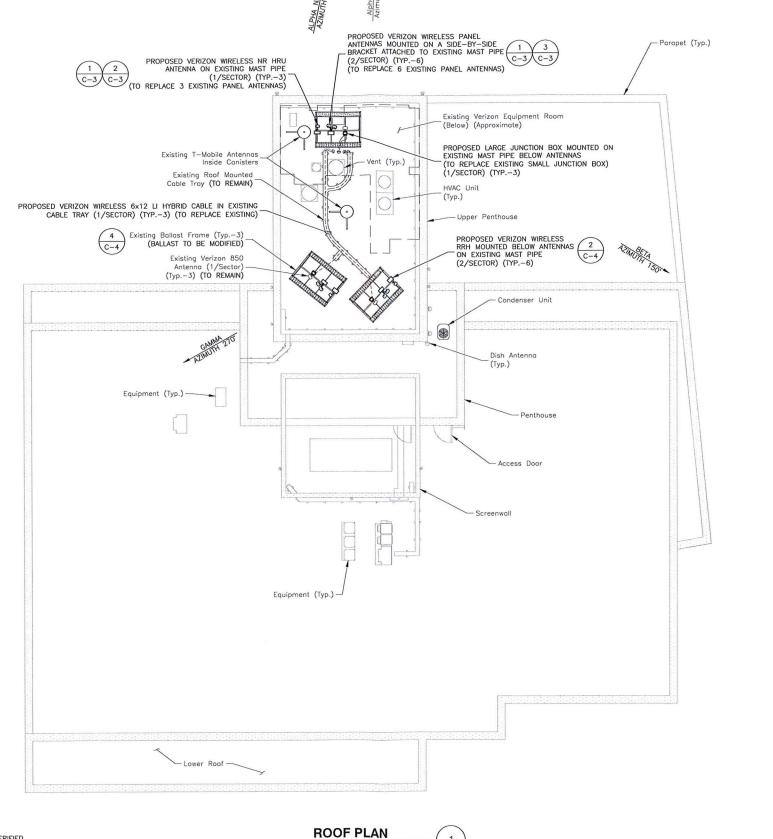

SCALE: 3/64"=1' FOR 11"x17"

3/32"=1' FOR 22"x34"

24'



VERIZON WIRELESS 400 FRIBERG PARKWAY WESTBOROUGH, MA 01581-3956

MIT MA

	ANTMO DRAWINGS			
2	08/31/20	FOR SUBMITTAL		
1	08/24/20	FOR SUBMITTAL		
0	04/07/20	FOR SUBMITTAL		
Α	02/19/20	FOR COMMENT		



Dewberry Engineers Inc. 99 SUMMER STREET SUITE 700 BOSTON, MA 02110 PHONE: 617.695,3400 FAX: 617.695,3310



DRAWN BY: SCA

BBR

REVIEWED BY: CDH

PROJECT NUMBER: 50121487

JOB NUMBER: 50121515

SITE NUMBER

CHECKED BY:

137421

SITE ADDRESS:


198 BROADWAY (AKA 141 PORTLAND STREET CAMBRIDGE, MA 02139

SHEET TITLE

ROOF PLAN

SHEET NUMBER

C - 1

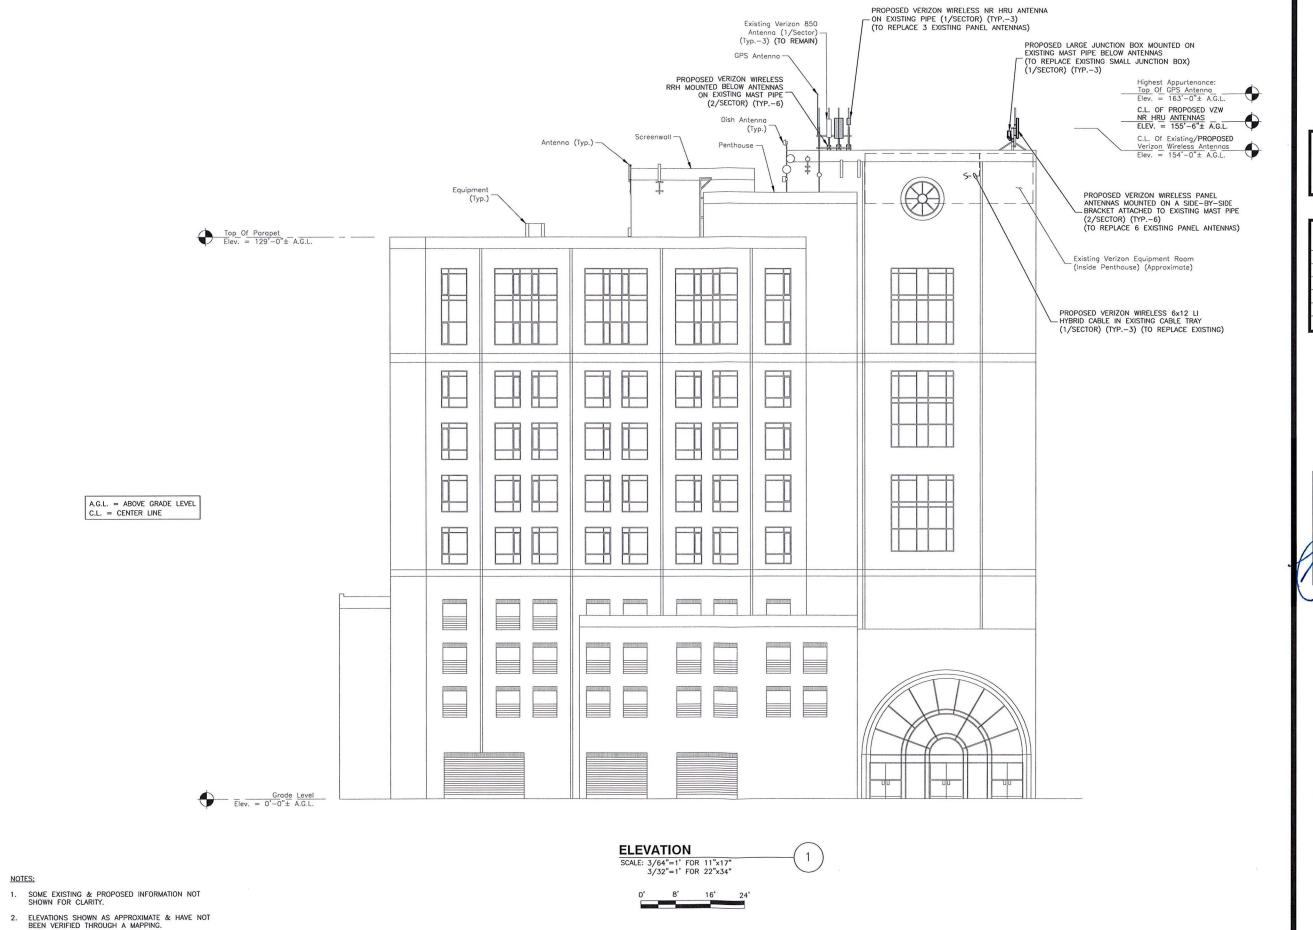



VERIZON WIRELESS 400 FRIBERG PARKWAY WESTBOROUGH, MA 01581-3956

MIT MA

	ANTMO	DRAWINGS
_	00 /74 /00	FOR CURWITH
2	08/31/20	FOR SUBMITTAL FOR SUBMITTAL
0	04/07/20	FOR SUBMITTAL
A	02/19/20	FOR COMMENT



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SUITE 700
BOSTON, MA 02110
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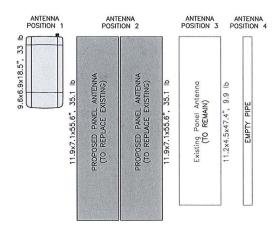
SHEET TITLE

ELEVATION

SHEET NUMBER

C-2

ALL SECTORS




NOTES:

- 1. AS VIEWED STANDING BEHIND THE ANTENNAS.
- ANTENNA CONFIGURATION BASED ON ANTENNA REC DATED 04/02/20. VERIFY SCOPE OF WORK WITH FINAL RFDS PRIOR TO CONSTRUCTION.

ANTENNA CONFIGURATION

SCALF: N.T.S

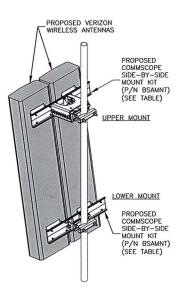

CO	MMSCOPE P/N: BSA	MNT MOUNT	TABLE			
COMMSCOPE SUPPORTED QUANTITY REQUIRED PER MOUNTING BETW (2) ANTENNAS (2) ANTENNAS POINTS ANTE						
BSAMNT-SBS-1-2 SBNHH-1D65A/B/C NHH-65A/B/C-R2B		1	2	3-3/8"		
BSAMNT-SBS-2-2	JAHH-65A/B/C-R3B JAHH-45A-R3B NHH-45A-R2B SBNHH-1D45A/B	1	2	2"		
BSAMNT-SBS-2-3	NHH-45B/C-R2B JAHH-45B/C-R3B SBNHH-1D45C	1	3	2"		

TABLE BASED ON POWER POINT PRESENTATION BY COMMSCOPE TITLED SIDE BY SIDE MOUNTS. CONTRACTOR TO VERIFY PART NUMBERS WITH MANUFACTURER PRIOR TO ORDERING. INSTALL PER MANUFACTURER RECOMMENDATIONS & SPECIFICATIONS.


NOTES:

SCALE: N.T.S.

- SPACING OF PROPOSED EQUIPMENT SHALL BE CONFIRMED AND PROPOSED MOUNTS SHALL NOT IMPEDE EQUIPMENT CLEARANCES. ACCESS TO EQUIPMENT SHALL BE MAINTAINED.
- PROPOSED ANTENNA MOUNT SHALL BE INSTALLED ACCORDING TO MANUFACTURER SPECIFICATIONS.

SIDE-BY-SIDE ANTENNA MOUNT




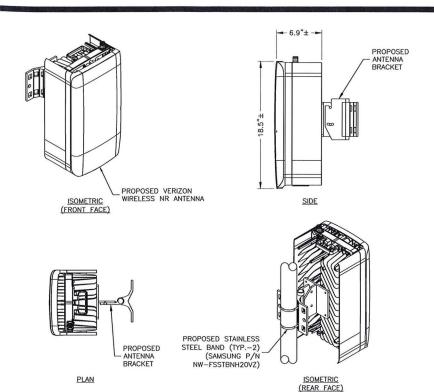

NOTES:

- INSTALL ALL EQUIPMENT PER MANUFACTURER'S RECOMMENDATIONS. USE APPROPRIATE MOUNTING HARDWARE FOR CONSTRUCTION TYPE.
- 2. ANTENNA WEIGHT: 33.0 LBS.



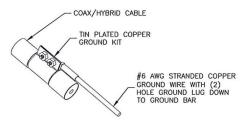

NOTES:

- DO NOT INSTALL CABLE GROUND KIT AT A BEND, ALWAYS DIRECT GROUND WIRE DOWN TO GROUND BAR.
- 2. GROUNDING KIT SHALL BE TIN PLATED COPPER WITH TWO—HOLE LUG, SIZE PER COAX DIAMETER.
- 3. WEATHER SEAL GROUND KIT PER CARRIER REQUIREMENTS.
- COAX CABLE GROUND KIT LOCATION & QUANTITY SHALL BE PER CARRIER SPECIFICATIONS & STANDARDS.

COAX/HYBRID GROUNDING DETAIL

SCALE: N.T.S.



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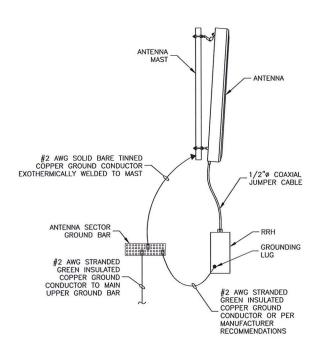
CONSTRUCTION DETAILS

SHEET NUMBER

C - 3

GENERAL NOTES:


- ALL DIMENSIONS TO, OF, AND ON EXISTING BUILDINGS, DRAINAGE STRUCTURES, AND SITE IMPROVEMENTS SHALL BE VERIFIED IN FIELD BY CONTRACTOR PRIOR TO ALL FABRICATION WITH ALL DISCREPANCIES REPORTED IMMEDIATELY TO THE ENGINEER.
- 2. DO NOT CHANGE SIZE NOR SPACING OF STRUCTURAL ELEMENTS.
- 3. DETAILS SHOWN ARE TYPICAL; SIMILAR DETAILS APPLY TO SIMILAR CONDITIONS UNLESS OTHERWISE NOTED.
- THESE DRAWINGS DO NOT INCLUDE NECESSARY COMPONENTS FOR CONSTRUCTION SAFETY WHICH IS THE SOLE RESPONSIBILITY OF THE CONTRACTOR.
- BRACE STRUCTURES UNTIL ALL STRUCTURAL ELEMENTS NEEDED FOR STABILITY ARE INSTALLED. THESE ELEMENTS ARE AS FOLLOWS: LATERAL BRACING, ANCHOR BOLTS, ETC.
- 6. DETERMINE EXACT LOCATION OF EXISTING UTILITIES, DRAIN PIPES, VENTS, ETC. BEFORE COMMENCING WORK.
- INCORRECTLY FABRICATED, DAMAGED, OR OTHERWISE MISFITTING OR NONCONFORMING MATERIALS OR CONDITIONS SHALL BE REPORTED TO THE OWNER PRIOR TO REMEDIAL OR CORRECTIVE ACTION. ANY SUCH REMEDIAL ACTION SHALL REQUIRE WRITTEN APPROVAL BY THE OWNER'S REPRESENTATIVE PRIOR TO PROCEEDING.
- 8. EACH CONTRACTOR SHALL COOPERATE WITH THE OWNER'S REPRESENTATIVE, AND COORDINATE HIS WORK WITH THE WORK OF OTHERS.
- REPAIR ANY DAMAGE DURING CONSTRUCTION TO MATCH EXISTING PRE-CONSTRUCTION CONDITIONS TO THE SATISFACTION OF THE CONSTRUCTION MANAGER.
- ALL CABLE/CONDUIT ENTRY/EXIT PORTS SHALL BE WEATHERPROOFED DURING INSTALLATION USING A SILICONE SEALANT.
- 11. THE CONTRACTOR SHALL SUPERVISE AND DIRECT THE PROJECT DESCRIBED HEREIN. THE CONTRACTOR SHALL BE SOLELY RESPONSIBLE FOR ALL CONSTRUCTION MEANS, METHODS, TECHNIQUES, SEQUENCES AND PROCEDURES AND FOR COORDINATING ALL PORTIONS OF THE WORK UNDER THE CONTRACT.
- 12. SEAL PENETRATIONS THROUGH FIRE RATED AREAS WITH UL LISTED D FIRE CODE
- 13. TURN OVER ALL SALVAGEABLE BUILDING MATERIAL TO BUILDING MANAGER.
- 14. ALL DISRUPTIVE WORK AND WORK WITHIN TENANT SPACES TO BE COORDINATED WITH
- ALL ROOF PENETRATIONS SHALL BE RESTORED TO MAINTAIN ALL ROOF WARRANTIES AND ENSURE A PERMANENT WATERPROOF SEAL.



NOTES:

- VERIFY EXISTING GROUNDING SYSTEM IS INSTALLED PER VERIZON WIRELESS STANDARDS.
- 2. BOND NEW EQUIPMENT INTO EXISTING GROUND SYSTEM IN ACCORDANCE WITH VERIZON WIRELESS STANDARDS & MANUFACTURER'S RECOMMENDATIONS.


TYPICAL ANTENNA/RRH **GROUNDING DETAIL** SCALE: N.T.S

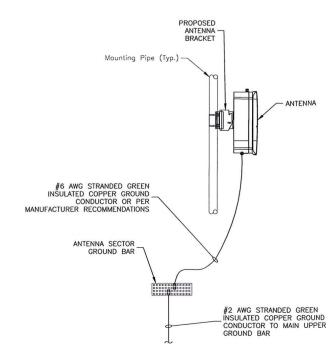

NOTES:

- 1. VERIFY EXISTING GROUNDING SYSTEM IS INSTALLED PER VERIZON
- 2. BOND NEW EQUIPMENT INTO EXISTING GROUND SYSTEM IN ACCORDANCE WITH VERIZON WIRELESS STANDARDS AND MANUFACTURER'S RECOMMENDATIONS.

TYPICAL NR ANTENNA **GROUNDING DETAIL**

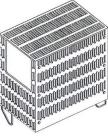

LTE 700/850



LTE AWS/PCS



MANUFACTURER: SAMSUNG B2/B66A RRH BR049 MODEL:

MANUFACTURER:

DIMENSIONS:

MODEL:

WEIGHT:

15.0"H X 15.9"W X 10.0"D 97.5 LBS WEIGHT:

SAMSUNG

82.0 LBS

B5/B13 RRH BRO4C


15.0"H X 15.0"W X 8.1"D

NOTES:

- 1. COAX & JUMPERS NOT SHOWN FOR CLARITY.
- 2. GROUND RRHS AND MOUNTS PER MANUFACTURER'S RECOMMENDATIONS AND VERIZON WIRELESS STANDARDS.
- CONFIRM REQUIRED RRHS WITH THE LATEST ANTENNA REC.

RRH DETAILS

2

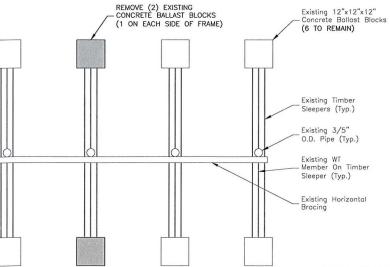

BALLAST MODIFICATIONS SCALE: N.T.S.

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SHEET TITLE

CONSTRUCTION DETAILS & NOTES

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