

CITY OF CAMBRIDGE

BOARD OF ZONING APPEAL

831 Massachusetts Avenue, Cambridge MA 02139
2021 JUN 15 AM 10: 29

617-349-6100

BZA Application Form

BZA Number: 125782

General Information

The undersigned h	ereby petitions t	he Board of Zoning Ap	peal for the following:
Special Permit:	_X	Variance:	Appeal:
PETITIONER: Ce	<u>llco Partnership</u>		S C/O Daniel D. Klasnick, Esquire
PETITIONER'S AI	DDRESS: Duval	& Klasnick LLC, Boxfo	
LOCATION OF PR	ROPERTY: 2067	Massachusetts Ave	Cambridge, MA
TYPE OF OCCUP Facility	ANCY: Mobile C	ommunications	ZONING DISTRICT: Business A-2 Zone
REASON FOR PE	TITION:		
/Telecommunicati	on Facility (ante	nna)/	
DESCRIPTION O	F PETITIONER'S	PROPOSAL:	
and relocating 3 a	ntennas to an ex all at the same lo	isting mount, installing	cating 6 antennas to 3 new proposed side by side mounts 3 new antennas on an existing mount and retaining 3 existing sector frames or penthouse wall at a top height
SECTIONS OF ZO	ONING ORDINA	NCE CITED:	
Article: 4.000 Article: 4.000 Article: 10.000 Article: 6409(a)	Section: 4.40 (F Section: 10.40 -	1 (Telecommunication ootnote 49 - Telecomm 10.46 (Special Permit) Class Tax Relief and J	nunications Facility)
		Original Signature(s):	(Petitioner (s) / Owner)
			Daniel D. Klasnicic (Print Name)

Address:

P.O. BOX 254

Box fold, MA 01921

эl. No.

E-Mail Address:

(781) 873-0021 dklasnick@dkt-legal.com

Date: June 11, 2021


BZA APPLICATION FORM - OWNERSHIP INFORMATION

To be completed by OWNER, signed before a notary and returned to The Secretary of the Board of Zoning Appeals.

I/We Henderson Carriage Limited Partnership
(OWNER) Address: c/o The Davis Companies, 125 High Street, Suite 2111, Boston, MA 02110
Address: 270 1148 Davis Companies, 123 111gh offeet, oatte 2111, Boston, 1111 02110
State that I/We own the property located at 2067 Massachusetts Avenue
which is the subject of this zoning application.
The record title of this property is in the name of Henderson Carriage Limited
Partnership
*Pursuant to a deed of duly recorded in the date $\underline{04/23/1998}$, Middlesex South
County Registry of Deeds at Book 28494 , Page 149 ; or
Middlesex Registry District of Land Court, Certificate No
Book Page
SIGNATURE BY LAND OWNER OR AUTHORIZED TRUSTEE, OFFICER OR AGENT*
*Written evidence of Agent's standing to represent petitioner may be requested.
Commonwealth of Massachusetts, County of Suffolk
Jonathan G. Davis, as President of Davis Investment Corp., the sole Manager of
Henderson Carriage SPE General Partner LLC, the General Partner of Henderson
Carriage Limited Partnership, personally appeared before me, this 26 of May,
2021, and made oath that the above statement is true
My commission expires 5/24/24 (Notary Seal). DIANE K. REMSBERG Notary Public
COMMONWEALTH OF MASSACHUSETT

• If ownership is not shown in recorded deed, e.g. if by court order, recent deed, or inheritance, please include documentation.

My Commission Expires On May 27, 2027

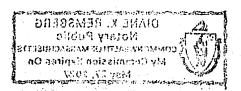

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BZA Application Form

SUPPORTING STATEMENT FOR A SPECIAL PERMIT

Please describe in complete detail how you meet each of the following criteria referring to the property and proposed changes or uses which are requested in your application. Attach sheets with additional information for special permits which have additional criteria, e.g.; fast food permits, comprehensive permits, etc., which must be met.

Granting the Special Permit requested for <u>2067 Massachusetts Ave , Cambridge, MA</u> (location) would not be a detriment to the public interest because:

A) Requirements of the Ordinance can or will be met for the following reasons:

As demonstrated by the documents provided with this application and will be further discussed at the hearing on this matter, the modification satisfies the standards for an Eligible Facilities Request pursuant to Section 6409(a) of the Federal Spectrum Act. The proposed modification also satisfies the standards for the grant of a special permit. (For further details, please see attached narrative and supporting documents)

B) Traffic generated or patterns of access or egress would not cause congestion hazard, or substantial change in established neighborhood character for the following reasons:

The modification of the unmanned facility will not change existing traffic demand or impact ingress or egress. The modified facility will continue to generate only about one to two vehicles trips per month in a standard passenger vehicle. (For further details, please see attached narrative and supporting documents)

The continued operation of or the development of adjacent uses as permitted in the Zoning

Ordinance would not be adversely affected by the nature of the proposed use for the following reasons:

The modified facility will have no adverse effects on the operation or development of adjacent uses. The modified facility will emit no light, odor, dust or glare and generates no unusual noise or other adverse impacts. (For further details, please see attached narrative and supporting documents)

Nuisance or hazard would not be created to the detriment of the health, safety, and/or welfare of the occupant of the proposed use or the citizens of the City for the following reasons:

The modified facility will generate no additional traffic or other negative impacts on surrounding properties or within the City of Cambridge. The facility requires no water or sewer services and emits no light, odor, dust or glare and generates no unusual noise or other adverse impacts. The facility will be unoccupied with no employees or customers. The availability of wireless services enhances the health, safety and welfare of the community. (For further details, please see attached narrative and supporting documents)

For other reasons, the proposed use would not impair the integrity of the district or adjoining district or otherwise derogate from the intent or purpose of this ordinance for the following reasons:

The facility has been designed to minimize its visual impact and is in harmony with the general purpose of the zoning ordinance for this use and in accordance with the requirements for an

Eligible Facilities Roughest under Section 6409(a). (Please so attached narrative and supporting documents)

*If you have any questions as to whether you can establish all of the applicable legal requirements, you should consult with an attorney.

BZA Application Form

DIMENSIONAL INFORMATION

Applicant: Cellco Partnership d/b/a Verizon Wireless

Present Use/Occupancy:

Mobile Communications

Facility

Phone:

Location: Duval & Klasnick LLC 2067 Mccsachusetts Avenue

Business A-2 Zone

Mobile Communications

Facility

(781) 873-0021

Requested Use/Occupancy:

		Existing Conditions	Requested Conditions	Ordinance Requirements	
TOTAL GROSS					
FLOOR AREA:		N/A	N/A	N/A	(max.)
LOT AREA:		N/A	N/A	N/A	(min.)
RATIO OF GROSS FLOOR AREA TO LOT AREA: ²		N/A	N/A	N/A	
LOT AREA OF EACH DWELLING UNIT		N/A	N/A	N/A	
SIZE OF LOT:	WIDTH	N/A	N/A	N/A	
	DEPTH	N/A	N/A	N/A	
SETBACKS IN FEET	:FRONT	N/A	N/A	N/A	
	REAR	N/A	N/A	N/A	
	LEFT SIDE	N/A	N/A	N/A	
	RIGHT SIDE	N/A	N/A	N/A	
SIZE OF BUILDING:	HEIGHT	N/A	N/A	N/A	
* 	WIDTH	N/A	N/A	N/A	
RATIO OF USABLE OPEN SPACE TO LOT AREA:		N/A	N/A	N/A	
NO. OF DWELLING UNITS:		N/A	N/A	N/A	
NO. OF PARKING SPACES:		N/A	N/A	N/A	
NO. OF LOADING AREAS:		N/A	N/A	N/A	
<u>DISTANCE TO</u> <u>NEAREST BLDG.</u> <u>ON SAME LOT</u>		N/A	N/A	N/A	

Describe where applicable, other occupancies on the same lot, the size of adjacent buildings on same lot, and type of construction proposed, e.g; wood frame, concrete, brick, steel, etc.

- 1. SEE CAMBRIDGE ZONING ORDINANCE ARTICLE 5.000, SECTION 5.30 (DISTRICT OF DIMENSIONAL REGULATIONS).
- 2. TOTAL GROSS FLOOR AREA (INCLUDING BASEMENT 7'-0" IN HEIGHT AND ATTIC AREAS GREATER THAN 5') DIVIDED BY LOT AREA.
- 3. OPEN SPACE SHALL NOT INCLUDE PARKING AREAS, WALKWAYS OR DRIVEWAYS AND SHALL HAVE A MINIMUM DIMENSION OF 15'.



PORTER SQ MA

2067 MASSSACHUSETTS AVENUE CAMBRIDGE, MA 02140

FUZE PROJECT ID: 16277392

PSLC: 137887



DEWBERRY ENGINEERS INC. 99 SUMMER ST. SUITE 700 BOSTON, MA 02110 PHONE # (617) 531-0800 CONTACT: BENJAMIN REVETTE, PE CONSTRUCTION VERIZON WIRELESS 118 FLANDERS ROAD WESTBOROUGH, MA 01581-3956
CONTACT: BENJAMIN REVETTE, PE CONSTRUCTION VERIZON WIRELESS 118 FLANDERS ROAD
CONSTRUCTION VERIZON WIRELESS 118 FLANDERS ROAD
VERIZON WIRELESS 118 FLANDERS ROAD
PROJECT TEAM

PMI ACCESSED AT:	HTTPS://PMI.VZWSMART.COM
SMART TOOL VENDOR PROJECT NUMBER:	N/A
VZW LOCATION CODE (PSLC):	137887
FUZE NUMBER:	16277395
MOUNT MODIFICATION REQUIRED?	NO
CONTRACTOR PMI	REQUIREMENTS
THIS DOCUMENT WAS DEVELOPED	TO REFLECT A SPECIFIC SIT

FACILITY IS UNMANNED AND NOT FOR HUMAN HABITATION.

	1.	RELOCATE (6) ANTENNAS TO (3) PROPOSED SIDE BY SIDE MOUNTS FROM POSITION 2 TO POSITION 3.
	2.	RELOCATE (3) EXISTING NR HRU ANTENNAS TO EXISTING MAST PIPE IN POSITION 2.
3	3.	INSTALL (3) NEW VZSO1 ANTENNAS ON EXISTING ANTENNA MOUNTING PIPE IN POSITION 1.
	4.	INSTALL NEW JUMPER CABLES AS REQUIRED BY RFDS.
ı		
ŀ	NC	OTE:
	1.	SCOPE OF WORK BASED ON ANTENNA REC FOR "PORTER_SQ_MA" DATED 11/09/20. VERIFY SCOPE OF WORK WITH FINAL RFDS PRIOR TO CONSTRUCTION.
		SCOPE OF WORK
	12.90	

ı	NO.	DESCRIPTION
-		
	T-1	TITLE SHEET
	GN-1	GENERAL NOTES
	C-1	ROOF PLAN
	C-2	ELEVATION
	C-3	CONSTRUCTION DETAILS
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		SHEET INDEX
•	- ALAN CONTRACT	

ver	izon ^v
	WIRELESS

VERIZON WIRELESS 118 FLANDERS ROAD WESTBOROUGH, MA 01581-3956

PORTER SQ MA

С	ONSTRUC	TION	DRAWINGS
0	04/14/21	FOR	SUBMITTAL



ewberry Engineers Inc. 99 SUMMER STREET SUITE 700 BOSTON, MA 02110 PHONE: 617.695,3400 FAX: 617.695,3310



DRAWN BY:	AJB
REVIEWED BY:	CDH
CHECKED BY:	BBR
PROJECT NUMBER:	50121487
JOB NUMBER:	50121974
SITE NUMBER	
137887	7
CITE ADDRECC	

2067 MASSACHUSETTS

AVENUE CAMBRIDGE, MA
02140

SHEET TITLE

TITLE SHEET

SHEET NUMBER

T - 1

GENERAL CONSTRUCTION NOTES:

- ALL WORK SHALL CONFORM TO ALL CURRENT APPLICABLE FEDERAL, STATE, AND LOCAL CODES, AND COMPLY WITH
- CONTRACTOR SHALL CONTACT "DIG SAFE" (888-344-7233) FOR IDENTIFICATION OF UNDERGROUND UTILITIES PRIOR TO START OF CONSTRUCTION.
- 3. CONTRACTOR IS RESPONSIBLE FOR COORDINATING ALL REQUIRED INSPECTIONS.
- ALL DIMENSIONS TO, OF, AND ON EXISTING BUILDINGS, DRAINAGE STRUCTURES, AND SITE IMPROVEMENTS SHALL BE VERIFIED IN FIELD BY CONTRACTOR WITH ALL DISCREPANCIES REPORTED TO THE ENGINEER.
- 5. DO NOT CHANGE SIZE OR SPACING OF STRUCTURAL ELEMENTS.
- 6. DETAILS SHOWN ARE TYPICAL: SIMILAR DETAILS APPLY TO SIMILAR CONDITIONS UNLESS OTHERWISE NOTED.
- THESE DRAWINGS DO NOT INCLUDE NECESSARY COMPONENTS FOR CONSTRUCTION SAFETY WHICH IS THE SOLE
- CONTRACTOR SHALL BRACE STRUCTURES UNTIL ALL STRUCTURAL ELEMENTS NEEDED FOR STABILITY ARE INSTALLED. THESE ELEMENTS ARE AS FOLLOWS: LATERAL BRACING, ANCHOR BOLTS, ETC.
- 9. CONTRACTOR SHALL DETERMINE EXACT LOCATION OF EXISTING UTILITIES, DRAIN PIPES, VENTS, ETC. BEFORE COMMENCING
- 10. INCORRECTLY FABRICATED, DAMAGED, OR OTHERWISE MISFITTING OR NONCONFORMING MATERIALS OR CONDITIONS SHALL BE REPORTED TO THE OWNER PRIOR TO REMEDIAL OR CORRECTIVE ACTION. ANY SUCH REMEDIAL ACTION SHALL REQUIRE WRITTEN APPROVAL BY THE OWNER'S REPRESENTATIVE PRIOR TO PROCEEDING
- 11. EACH CONTRACTOR SHALL COOPERATE WITH THE OWNER'S REPRESENTATIVE, AND COORDINATE HIS WORK WITH THE WORK OF OTHERS
- 12. CONTRACTOR SHALL REPAIR ANY DAMAGE CAUSED BY CONSTRUCTION OF THIS PROJECT TO MATCH EXISTING PRE-CONSTRUCTION CONDITIONS TO THE SATISFACTION OF THE VERIZON WIRELESS CONSTRUCTION MANAGER
- 13. ALL CABLE/CONDUIT ENTRY/EXIT PORTS SHALL BE WEATHERPROOFED DURING INSTALLATION USING A SILICONE SEALANT.
- 14. WHERE EXISTING CONDITIONS DO NOT MATCH THOSE SHOWN IN THIS PLAN SET, CONTRACTOR WILL NOTIFY ENGINEER, VERIZON WIRELESS PROJECT CONSTRUCTION MANAGER, AND LANDLORD IMMEDIATELY
- CONTRACTOR SHALL ENSURE ALL SUBCONTRACTORS ARE PROVIDED WITH A CURRENT SET OF DRAWINGS AND SPECIFICATIONS FOR THIS PROJECT.
- ALL ROOF WORK SHALL BE DONE BY A QUALIFIED AND EXPERIENCED ROOFING CONTRACTOR IN COORDINATION WITH ANY
 CONTRACTOR WARRANTING THE ROOF TO ENSURE THAT THE WARRANTY IS MAINTAINED.
- 17. CONTRACTOR SHALL REMOVE ALL RUBBISH AND DEBRIS FROM THE SITE AT THE END OF EACH DAY.
- 18. CONTRACTOR SHALL COORDINATE WORK SCHEDULE WITH LANDLORD AND TAKE PRECAUTIONS TO MINIMIZE IMPACT AND DISRUPTION OF OTHER OCCUPANTS OF THE FACILITY.
- 19. CONTRACTOR SHALL FURNISH VERIZON WIRELESS WITH THREE AS-BUILT SETS OF DRAWINGS UPON COMPLETION OF WORK.
- 20. ANTENNAS AND CABLES ARE TYPICALLY PROVIDED BY VERIZON WIRELESS. PRIOR TO SUBMISSION OF BID, CONTRACTOR SHALL COORDINATE WITH PROJECT MANAGER TO DETERMINE WHAT, IF ANY, ITEMS WILL BE PROVIDED BY VERIZON WIRELESS. ALL ITEMS NOT PROVIDED BY VERIZON WIRELESS SHALL BE PROVIDED AND INSTALLED BY THE CONTRACTOR. CONTRACTOR WILL INSTALL ALL ITEMS PROVIDED BY VERIZON WIRELESS.
- 21. PRIOR TO SUBMISSION OF BID, CONTRACTOR WILL COORDINATE WITH VERIZON WIRELESS PROJECT MANAGER TO DETERMINE IF ANY PERMITS WILL BE OBTAINED BY VERIZON WIRELESS. ALL REQUIRED PERMITS NOT OBTAINED BY VERIZON WIRELESS MUST BE OBTAINED, AND PAID FOR, BY THE CONTRACTOR.
- 22. GENERAL CONTRACTOR SHALL HAVE A LICENSED HVAC CONTRACTOR START THE HVAC UNITS, SYNCHRONIZE THE THERMOSTATS, ADJUST ALL SETTINGS ON EACH UNIT ACCORDING TO VERIZON WIRELESS CONSTRUCTION MANAGER'S SPECIFICATIONS, AND THOROUGHLY TEST AND BALANCE EACH UNIT TO ENSURE PROPER OPERATION PRIOR TO TURNING THE SITE OVER TO OWNER
- 23. CONTRACTOR SHALL INSTALL ALL SITE SIGNAGE IN ACCORDANCE WITH VERIZON WIRELESS SPECIFICATIONS AND
- 24. CONTRACTOR SHALL SUBMIT ALL SHOP DRAWINGS TO ENGINEER FOR REVIEW AND APPROVAL PRIOR TO FABRICATION
- 25. UNLESS OTHERWISE NOTED VERIZON WIRELESS SHALL PROVIDE ALL REQUIRED RF MATERIAL FOR CONTRACTOR TO INSTALL, INCLUDING ANTENNAS, TMA'S, BIAS-T'S, COMBINERS, PDU, DC BLOCKS, SURGE ARRESTORS, GPS ANTENNA, GPS SURGE ARRESTOR, COAXIAL CABLE.
- PRIOR TO SUBMISSION OF BID, CONTRACTOR SHALL VERIFY ALL EQUIPMENT TO BE PROVIDED BY VERIZON WIRELESS FOR INSTALLATION BY CONTRACTOR.
- 27. ALL EQUIPMENT SHALL BE INSTALLED ACCORDING TO MANUFACTURER'S SPECIFICATIONS AND LOCATED ACCORDING TO VERIZON WIRELESS SPECIFICATIONS, AND AS SHOWN IN THESE PLANS.
- 28. DETAILS SHOWN ARE TYPICAL; SIMILAR DETAILS APPLY TO SIMILAR CONDITIONS UNLESS OTHERWISE NOTED.
- 29. THE CONTRACTOR SHALL SUPERVISE AND DIRECT THE PROJECT DESCRIBED HEREIN. THE CONTRACTOR SHALL BE SOLELY RESPONSIBLE FOR ALL THE CONSTRUCTION MEANS, METHODS, TECHNIQUES, SEQUENCES AND PROCEDURES AND FOR COORDINATING ALL PORTIONS OF THE WORK UNDER THE CONTRACT.
- 30. CONTRACTOR SHALL NOTIFY THE ENGINEER A MINIMUM OF 48 HOURS IN ADVANCE PRIOR TO CONSTRUCTION START, MORE SPECIFICALLY BEFORE; SEALING ANY FLOOR, WALL OR ROOF PENETRATION, FINAL UTILITY CONNECTIONS, POURING CONNECTIONS, BACKFILLING UTILITY TRENCHES AND STRUCTURAL POST OR MOUNTING CONNECTIONS, FOR ENGINEERING REVIEW
- 31. SEAL PENETRATIONS THROUGH FIRE RATED AREAS WITH UL LISTED D FIRE CODE APPROVED MATERIALS.
- 32. REPAIR ANY DAMAGE DURING CONSTRUCTION TO MATCH EXISTING PRE-CONSTRUCTION CONDITIONS TO THE SATISFACTION
- 33. ALL DISRUPTIVE WORK AND WORK WITHIN TENANT SPACES TO BE COORDINATED WITH BUILDING REPRESENTATIVE.

CODE SPECIFICATIONS:

- ALL WORK SHALL COMPLY WITH THE FOLLOWING APPLICABLE CODES:
- MASSACHUSETTS STATE BUILDING CODE, 9TH EDITION, CONSISTENT WITH THE FOLLOWING CODES:
- 2015 INTERNATIONAL RESIDENTIAL CODE (IRC)
- 2015 INTERNATIONAL BUILDING CODE (IBC)
- 2015 INTERNATIONAL EXISTING BUILDING CODE (IBC)
- 2020 NATIONAL ELECTRICAL CODE (NEC)
- IN THE EVENT OF CONFLICT, THE MOST RESTRICTIVE CODE SHALL PREVAIL.
- 2. ALL STRUCTURAL WORK TO BE DONE IN ACCORDANCE WITH THE AMERICAN INSTITUTE OF STEEL CONSTRUCTION MANUAL, 13TH EDITION (AISC 13TH ED.)
- ALL CONCRETE WORK TO BE DONE IN ACCORDANCE WITH THE AMERICAN CONCRETE INSTITUTE (ACI 301) SPECIFICATIONS FOR STRUCTURAL CONCRETE FOR BUILDINGS (ACI 318) AND BUILDING CODE REQUIREMENTS FOR REINFORCED CONCRETE.
- ALL REINFORCING STEEL WORK TO BE DONE IN ACCORDANCE WITH THE (ACI 315) MANUAL OF STANDARD PRACTICE FOR DETAILING REINFORCED CONCRETE STRUCTURES.

GROUNDING NOTES:

- 1. GROUNDING SHALL COMPLY WITH NEC ART. 250.
- 2. GROUNDING CONDUCTORS SHALL BE #6 COPPER STRANDED WIRE WITH GREEN COLOR INSULATION FOR INDOOR USE.
- ALL GROUND CONNECTIONS TO BE BURNDY HYGROUND COMPRESSION TYPE CONNECTORS OR CADWELD EXOTHERMIC WELD DO NOT ALLOW BARE COPPER WIRE TO BE IN CONTACT WITH GALVANIZED STEEL
- 4. ROUTE GROUNDING CONNECTORS ALONG THE SHORTEST AND STRAIGHTEST PATH POSSIBLE, EXCEPT AS OTHERWISE INDICATED. GROUNDING LEADS SHOULD NOT BE BENT AT RIGHT ANGLE. ALWAYS MAKE 12" RADIUS BENDS. #6 WIRE CAN BE BENT AT 6" RADIUS WHEN NECESSARY.
- CONNECTIONS TO GROUNDING BAR SHALL BE MADE WITH TWO HOLE COMPRESSION TYPE COPPER LUGS. APPLY OXIDE INHIBITING COMPOUND TO ALL LOCATIONS.
- 6. TEST COMPLETED GROUNDING SYSTEM AND RECORD RESISTANCE VALUES FOR PROJECT CLOSE-OUT DOCUMENTATION. GROUND RESISTANCE SHALL NOT EXCEED 5 OHMS.
- GROUNDING CONDUCTORS BETWEEN MGB AND WATERMAIN SHALL BE #2/O. BONDING JUMPERS FROM METALLIC SURFACES SHALL BE #2 MINIMUM. ALL GROUND CONDUCTORS AND BONDING JUMPERS SHALL BE SOFT DRAWN ANNEALED, TINNED, BARE STRANDED COPPER WIRE. COAXIAL CABLES SHALL BE GROUNDED AT A MINIMUM OF TWO LOCATIONS USING VERIZON PROVIDED GROUNDING KITS. EXACT LOCATIONS SHALL BE FINALIZED IN THE FIELD BY THE CONSTRUCTION MANAGER.

STRUCTURAL STEEL NOTES:

- STRUCTURAL STEEL SHALL CONFORM TO THE LATEST EDITION OF THE AISC "SPECIFICATION FOR THE DESIGN, FABRICATION AND ERECTION OF STRUCTURAL STEEL FOR BUILDINGS".
- 2. STRUCTURAL STEEL ROLLED SHAPES, PLATES, AND BARS SHALL CONFORM TO THE FOLLOWING ASTM

DESIGNATIONS:

ASTM A-992, GRADE 50

ASTM A-992, GRADE 8

ASTM A-500, GRADE B

ASTM A-500, GRADE B

ASTM A-302, TYPE SC OR N

E1554, GRADE 36

ASTM A-53, GRADE B

STEEL PIPE

ALL W SHAPES, UNLESS NOTED OR A992 OTHERWISE.

ALL OTHER ROLLED SHAPES, PLATES AND BARS UNLESS NOTED OTHERWISE.

ALL OTHER ROLLED SHAPES, PLATES AND BARS UNLESS NOTED OTHERWISE.

ALL W SHAPES, UNLESS NOTED OTHERWISE.

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ALL OTHER ROLLED SHAPES, PLATES AND BARS UNLESS NOTED OTHERWISE.

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- 3. ALL WELDING SHALL BE DONE USING E70XX ELECTRODES AND WELDING SHALL CONFORM TO AISC AND AWS D1.1 WHERE FILLET WELD SIZES ARE NOT SHOWN, PROVIDE THE MINIMUM SIZE PER TABLE J2.4 IN THE AISC "MANUAL OF STEEL CONSTRUCTION", 14TH EDITION. WHERE WELD LENGTH IS NOT INDICATED, USE FULL LENGT WELD. AT THE COMPLETION OF ALL WELDING, ALL DAMAGE TO GALVANIZED COATING SHALL BE REPAIRED.
- BOLTED CONNECTIONS SHALL USE BEARING TYPE GALVANIZED ASTM A325 BOLTS (3/4" DIA.) SUPPLIED WITH A
 NUT AND WASHER UNDER TURNED END AND SHALL HAVE MINIMUM OF TWO BOLTS UNLESS NOTED OTHERWISE.
- DO NOT DRILL HOLES THROUGH STRUCTURAL STEEL MEMBERS EXCEPT AS SHOWN AND DETAILED ON STRUCTURAL DRAWINGS.
- 6. NON-STRUCTURAL CONNECTIONS FOR STEEL GRATING MAY USE 5/8" DIA. GALVANIZED ASTM A 307 BOLTS UNLESS NOTED OTHERWISE.
- 7. USE PRECAUTIONS & PROCEDURES PER AWS D1.1 WHEN WELDING GALVANIZED METALS.
- ALL EXISTING BEAM AND COLUMN DIMENSIONS SHALL BE FIELD VERIFY BY CONTRACTOR PRIOR TO FABRICATION. ANY DISCREPANCES BETWEEN EXISTING CONDITIONS AND THOSE SHOWN SHALL BE REPORTED TO DEWBERRY ENGINEER IMMEDIATELY.
- 9. CONNECTION DESIGN BY FABRICATOR WILL BE SUBJECT TO REVIEW AND APPROVAL BY ENGINEER.
- 10. ALL EXTERIOR STEEL WORK SHALL BE GALVANIZED IN ACCORDANCE WITH SPECIFICATION ASTM A123/A123M-00 HOT-DIP GALVANIZED FINISH UNLESS OTHERWISE NOTED. GALVANIZING SHALL BE PERFORMED AFTER SHOP FABRICATION TO THE GREATEST EXTENT POSSIBLE. ALL DINGS, SCRAPES, MARS, AND WELDS IN THE GALVANIZED AREAS SHALL BE REPAIRED. REPAIR DAMAGED GALVANIZED COATINGS ON GALVANIZED ITEMS WITH GALVANIZED REPAIR PAINT ACCORDING TO ASTM A780 AND MANUFACTURER'S WRITTEN INSTRUCTIONS, PRIOR TO COMPLETION OF WORK, TOUCHUP ALL DAMAGED GALVANIZED STEEL WITH APPROVED COLD ZINC, "GALVANOX", "DRY GALV", "ZINC-IT", OR APPROVED EQUIVALENT, IN ACCORDANCE WITH MANUFACTURERS GUIDELINES. TOUCHUP DAMAGED NON GALVANIZED STEEL WITH SAME PAINT APPLIED IN SHOP OR FIELD.
- 11. ALL WELDED COMPONENTS TO BE SHOP WELDED PRIOR TO INSTALLATION. NO WELDING ACTIVITIES IS PERMITTED DURING INSTALLATION OF PROPOSED EQUIPMENTS AND/OR HARDWARE ON SITE




VERIZON WIRELESS 118 FLANDERS ROAD WESTBOROUGH, MA 01581-3956

PORTER SQ MA

С	ONSTRUC	TION	DRAWINGS
0	04/14/21	FOR	SUBMITTAL



Dewberry Engineers Inc. 99 SUMMER STREET SUITE 700 BOSTON, MA 02110

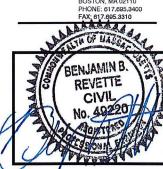

DRAWN	BY:	AJB

BBR

REVIEWED BY: CDH

PROJECT NUMBER: 50121487

JOB NUMBER: 50121974

SITE NUMBER

137887

SITE ADDRESS

CHECKED BY:


2067 MASSACHUSETTS AVENUE CAMBRIDGE, MA 02140

SHEET TITLE

GENERAL NOTES

SHEET NUMBER

GN-1

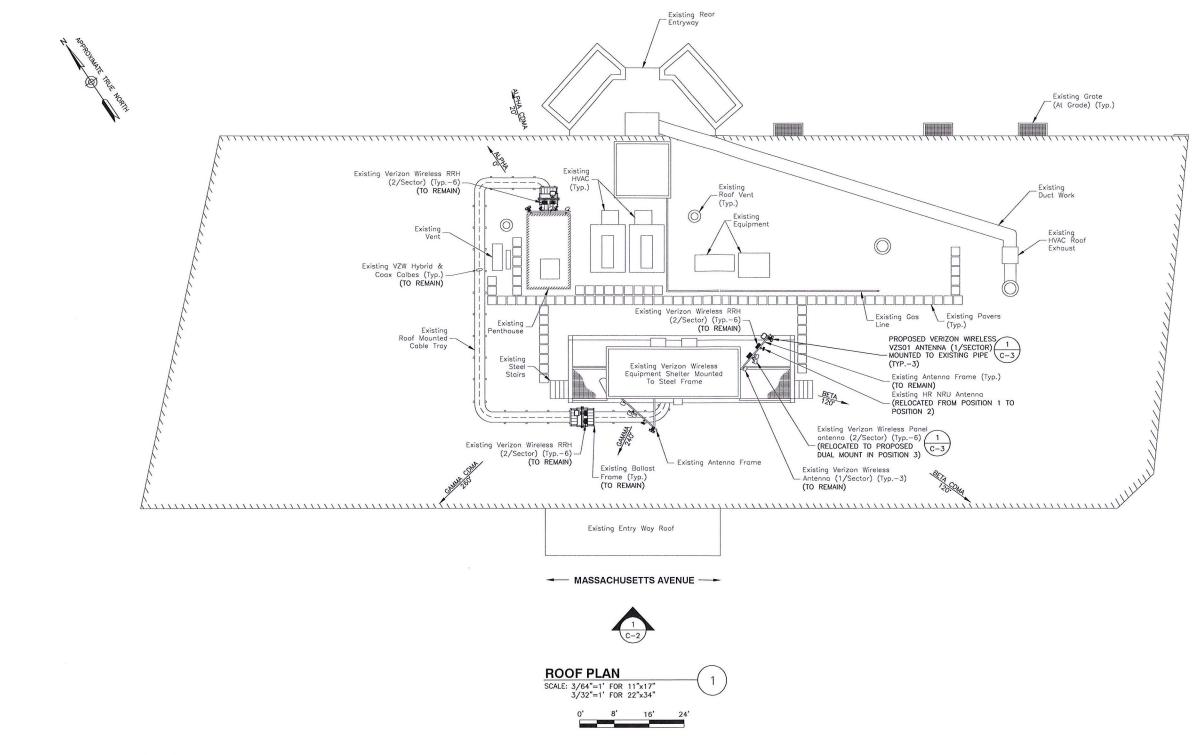

SITE NOTES:

- SOME EXISTING & PROPOSED INFORMATION NOT SHOWN FOR CLARITY.
- 2. NORTH ARROW SHOWN AS APPROXIMATE.
- 3. REUSE EXISTING ANTENNA MOUNTS & COAX. INSPECT FOR DAMAGE OR DECAY AND REPLACE AS NEEDED.
- INSTALL ALL PROPOSED EQUIPMENT IN ACCORDANCE WITH MANUFACTURER'S RECOMMENDATIONS & STRUCTURAL ASSESSMENT BY DEWBERRY ENGINEERS INC. DATED 04/08/21.



VERIZON WIRELESS 118 FLANDERS ROAD WESTBOROUGH, MA 01581-3956

PORTER SQ MA

CONSTRUCTION DRAWINGS

0 04/14/21 FOR SUBMITTAL



Dewberry Engineers Inc. 99 SUMMER STREET SUITE 700 BOSTON, MA 02110 PHONE: 617.695,3400 FAX; 617.695,3310



DRAWN BY: AJB

REVIEWED BY: CDH

CHECKED BY: BBR

PROJECT NUMBER: 50121487

JOB NUMBER: 50121974

SITE NUMBER

137887


SITE ADDRESS

2067 MASSACHUSETTS AVENUE CAMBRIDGE, MA 02140

SHEET TITLE

ROOF PLAN

SHEET NUMBER

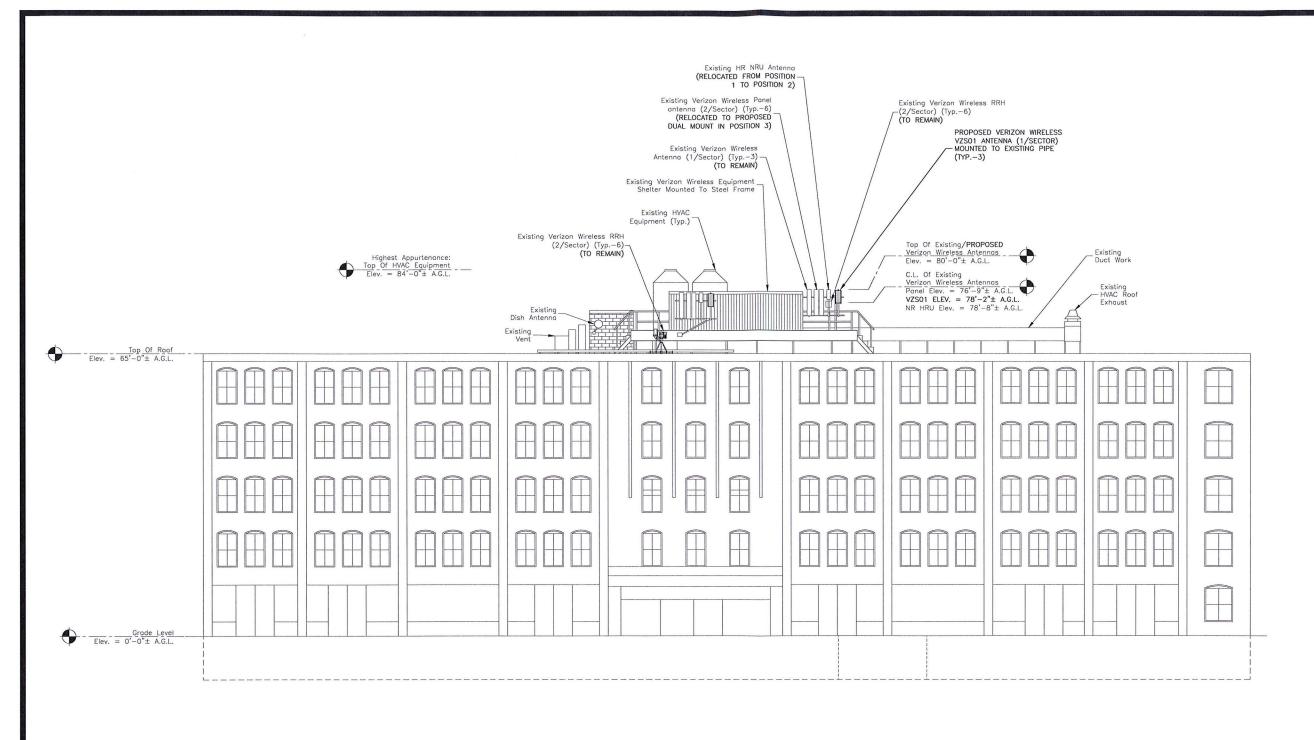

ELEVATION

SCALE: 3/64"=1' FOR 11"x17"
3/32"=1' FOR 22"x34"

0' 8' 16' 24'

SITE NOTES:

- SOME EXISTING & PROPOSED INFORMATION NOT SHOWN FOR CLARITY.
- 2. ELEVATIONS SHOWN AS APPROXIMATE.
- A.G.L. = ABOVE GROUND LEVEL
 C.L. = CENTERLINE
- 4. INSTALL ALL PROPOSED EQUIPMENT IN ACCORDANCE WITH MANUFACTURER'S RECOMMENDATIONS & STRUCTURAL ASSESSMENT BY DEWBERRY ENGINEERS INC. DATED 04/08/21.



VERIZON WIRELESS 118 FLANDERS ROAD WESTBOROUGH, MA 01581-3956

PORTER SQ MA

С	ONSTRUC	NOIT	DRAWINGS
0	04/14/21	FOR	SUBMITTAL



Dewberry Engineers Inc. 99 SUMMER STREET SUITE 700 BOSTON, MA 02110 PHONE: 617.695.3400 FAX: 617.695.3310



DRAWN BY:	AJB
REVIEWED BY:	CDH
CHECKED BY:	BBR

PROJECT NUMBER: 50121487

JOB NUMBER: 50121974

SITE NUMBER

137887


SITE ADDRESS

2067 MASSACHUSETTS AVENUE CAMBRIDGE, MA 02140


SHEET TITLE

ELEVATION

SHEET NUMBER

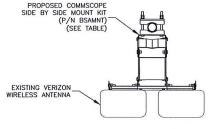

UPPER MOUNT

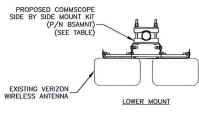


	COMMSCOPE P/I	N: BSAMNT MOUNT	TABLE	
COMMSCOPE P/N	SUPPORTED ANTENNAS	QUANTITY REQUIRED PER (2) ANTENNAS	NUMBER OF MOUNTING POINTS	GAP BETWEEN ANTENNAS
BSAMNT-SBS-1-2	SBNHH-1D65A/B/C NHH-65A/B/C-R2B	1	2	3-3/8"
BSAMNT-SBS-2-2	JAHH-65A/B/C-R3B JAHH-45A-R3B NHH-45A-R2B SBNHH-1D45A/B	1	2	2"
BSAMNT-SBS-2-3	JAHH-45B/C-R3B SBNHH-1D45C	1	3	2"

TABLE BASED ON POWER POINT PRESENTATION BY COMMSCOPE TITLED SIDE BY SIDE MOUNTS. CONTRACTOR TO VERIFY PART NUMBERS WITH MANUFACTURER PRIOR TO ORDERING. INSTALL PER MANUFACTURER RECOMMENDATIONS & SPECIFICATIONS.


- SPACING OF PROPOSED EQUIPMENT SHALL BE CONFIRMED AND PROPOSED MOUNTS SHALL NOT IMPEDE EQUIPMENT CLEARANCES. ACCESS TO EQUIPMENT SHALL BE MAINTAINED.
- 2. PROPOSED ANTENNA MOUNT SHALL BE INSTALLED ACCORDING TO MANUFACTURER SPECIFICATIONS.



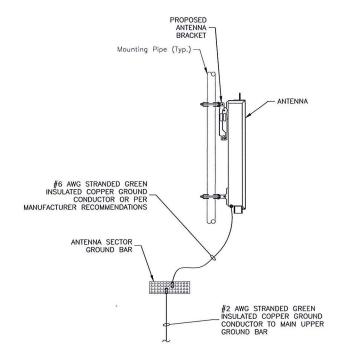

- VERIFY EXISTING GROUNDING SYSTEM IS INSTALLED PER VERIZON WIRELESS STANDARDS.
- BOND NEW EQUIPMENT INTO EXISTING GROUND SYSTEM IN ACCORDANCE WITH VERIZON WIRELESS STANDARDS AND MANUFACTURER'S RECOMMENDATIONS.




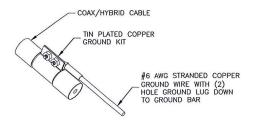


- DO NOT INSTALL CABLE GROUND KIT AT A BEND. ALWAYS DIRECT GROUND WIRE DOWN TO GROUND BAR.
- GROUNDING KIT SHALL BE TIN PLATED COPPER WITH TWO-HOLE LUG, SIZE PER COAX DIAMETER.
- 3. WEATHER SEAL GROUND KIT PER CARRIER REQUIREMENTS.
- 4. COAX CABLE GROUND KIT LOCATION & QUANTITY SHALL BE PER CARRIER SPECIFICATIONS & STANDARDS.

COAX/HYBRID GROUNDING DETAIL



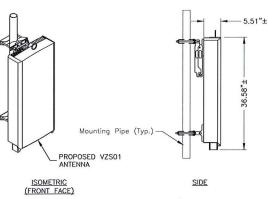

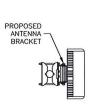

PLAN




ISOMETRIC (REAR FACE)

MODEL:	VZS01
DIMENSIONS:	35.1"H X 16.1"W X 5.5"D (NOT TO EXCEED)
WEIGHT:	87.1 LBS (NOT TO EXCEED)

INSTALL ALL EQUIPMENT PER MANUFACTURER'S RECOMMENDATIONS. USE APPROPRIATE MOUNTING HARDWARE FOR CONSTRUCTION TYPE.



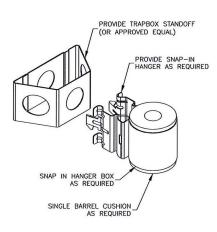

JUMPER MOUNT



VERIZON WIRELESS 118 FLANDERS ROAD WESTBOROUGH, MA 01581-3956

PORTER SQ MA

С	ONSTRUC	TION	I DRAWINGS	
0	04/14/21	FOR	SUBMITTAL	-



Dewberry Engineers Inc. 99 SUMMER STREET SUITE 700 BOSTON, MA 02110



DRAWN	BY:	AJB
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BBR

REVIEWED BY: CDH

PROJECT NUMBER: 50121487

50121974 JOB NUMBER:

SITE NUMBER

CHECKED BY

137887

SITE ADDRESS

2067 MASSACHUSETTS AVENUE CAMBRIDGE, MA 02140


SHEET TITLE

CONSTRUCTION DETAILS

SHEET NUMBER





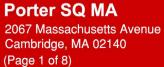













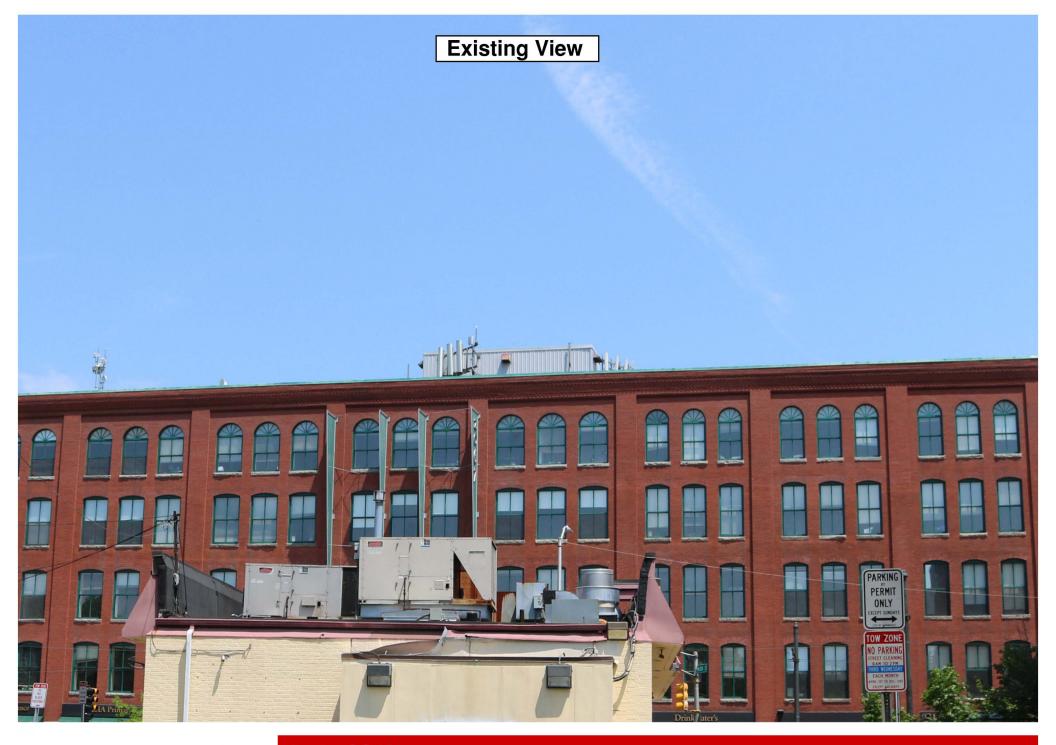





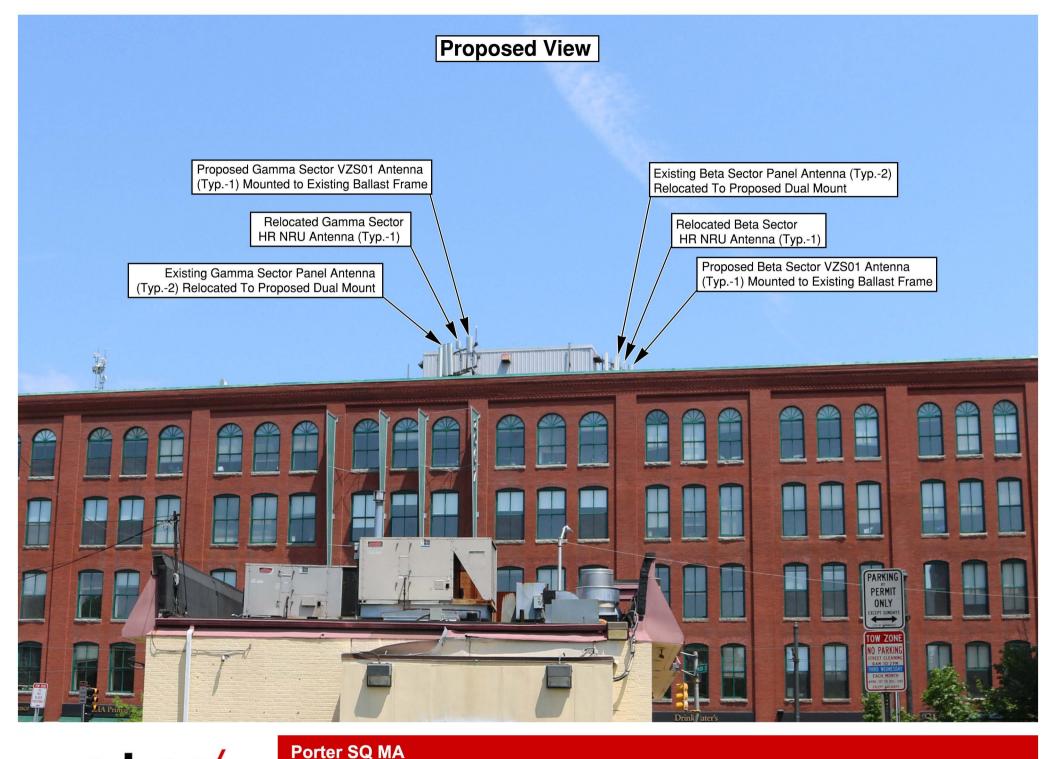







(Page 4 of 8)

Dewberry*

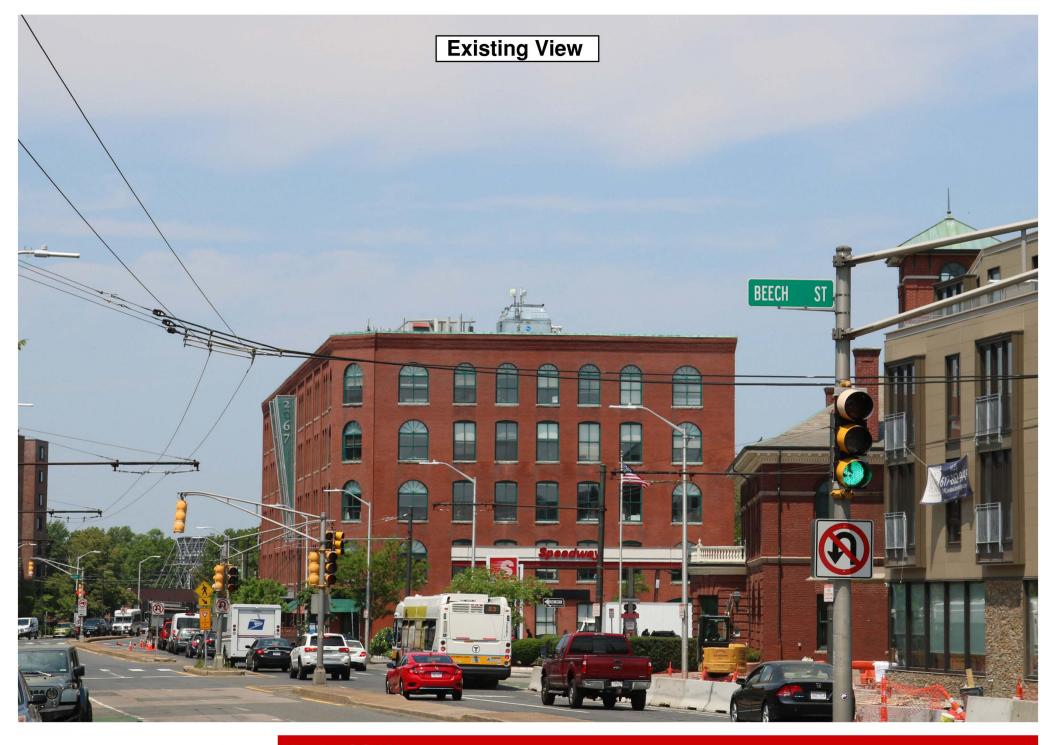





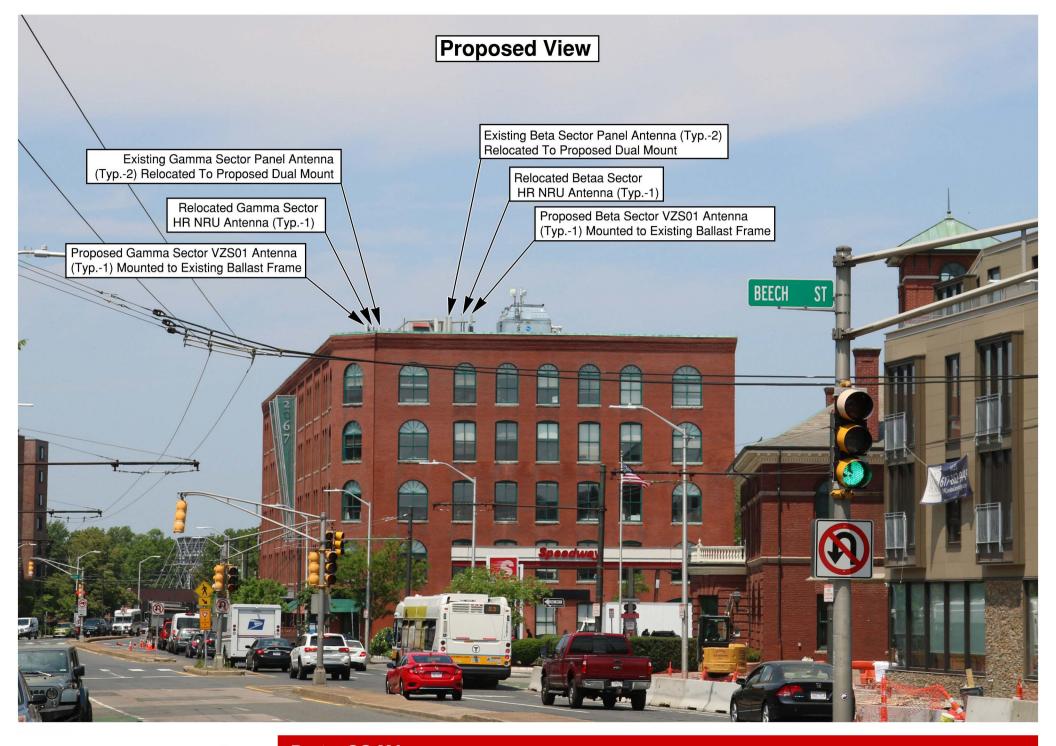

















(Page 8 of 8)

Dewberry*



Application
For
Modification to
Special Permit

2067 Massachusetts Avenue Cambridge, MA



Daniel D. Klasnick

Licensed in Massachusetts, New Hampshire and New York Desk: (781) 873-0021 - Mobile: (774) 249-2814 dklasnick@dkt-legal.com

June 8, 2021

City of Cambridge Board of Zoning Appeals 831 Massachusetts Avenue Cambridge, Massachusetts 02139

Re: **Application for Modification to Special Permit Building Mounted Mobile Communications Facility** Located at 2067 Massachusetts Avenue, Cambridge, Massachusetts

Dear Board Members:

Enclosed please find an Application to the Board of Zoning Appeals for a special permit for the modification of an existing building mounted mobile communications facility submitted on behalf of Cellco Partnership d/b/a Verizon Wireless.

In accordance with the Application requirements, please find enclosed the following:

- Application;
- Support Statements;
- Assessors GIS Block Map;
- Dimensional Form;
- Ownership Certificate, Notarized;
- Stamped Project Plans; and
- **Photo Simulations**

The Applicant would be happy to provide any additional information that you may require and would appreciate reasonable notice of any additional information you require in time to provide such information for the public hearing.

Should you require any additional information, please don't hesitate to contact me. Thank you very much for your cooperation.

Very truly yours,

DUVAL & KLASNICK LLC

Daniel D. Klasnick By:

Attorney at Law

GENERAL INFORMATION

	Permit	: <u>X</u>	Variance: _	Appe	eal:
PETITIO	NER: C	Cellco Partn	ership d/b/a Verizon Wi	ireless	
PETITIO	NER'S A	DDRESS: C	o Duval & Klasnick LLC	C, P.O. Box 254, Boxfo	rd, MA 01921
LOCATIO	N OF PR	OPERTY: 2	2067 Massachusetts Aven	ue	
TYPE OF	OCCUPA	NCY : Mobile	e Communications Facility	ZONING DISTRICT:	Business A-2
REASON I	FOR PET	ITION:			
_	A	dditions			New Structure
_	C	hange in	Use/Occupancy		Parking
_	C	onversion	n to Addi'l Dwelling	g Unit's	Sign
_	D	ormer			Subdivision
_	<u>X</u> 0		bile Communications Facil ler Section 6409(a) of Feder		equest
DESCRIP	TION OF	PETITION	IER'S PROPOSAL:		
				by relocating 6 antenn	as to 3 new proposed side
by side m	nounts ar	nd relocatin	ng 3 antennas to an existi	ng mount, installing 3	new antennas on an
'			<u> </u>	· · · · · · · · · · · · · · · · · · ·	
existing 1	mount ai	nd retainins	g 3 existing antennas all	at the same location m	ounted to the existing
			g 3 existing antennas all wall at a top height to ma		
sector fra	ames or j	penthouse v	wall at a top height to ma		
sector fra	ames or j	penthouse v	wall at a top height to ma	tch the existing anten	nas.
sector fra	ames or j	NING ORDI	wall at a top height to ma CNANCE CITED: 4.32.G.1 & Sec. 4.40 (Foot	ntch the existing anten	nas.
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sector fra SECTIONS Article Article Article Applican Applican Applican Applican	4.000 10.00 6409(a) nts for nts for nts for ional S	NING ORDI Section Section Section a Variar a Speciar an Appervices I	wall at a top height to ma ENANCE CITED: 4.32.G.1 & Sec. 4.40 (Foot 10.40 - 10.46 (Special Per Middle Class Tax Relief a ace must complete Pa al Permit must compl peal to the BZA Department must atta inal Signature(s):	inote 49 - Telecommunication and Job Creation Act (aleages 1-5 Lete Pages 1-4 and of a Zoning deach a statement of the Companiel D. Klassick attorned d/b/a Verizon Wireless (Printer P.O. Box 254	rations Facility) a Spectrum Act) a Spectrum Act) b 6 etermination by the concerning the reason. concerning the reason. concerning the reason.

SUPPORTING STATEMENT FOR A SPECIAL PERMIT

Please describe in complete detail how you meet each of the following criteria referring to the property and proposed changes or uses which are requested in your application. Attach sheets with additional information for special permits which have additional criteria, e.g.; fast food permits, comprehensive permits, etc., which must be met.

Granting the Special Permit requested for _______ (1ocation) would not be a detriment to the public interest because:

A) Requirements of the Ordinance can or will be met for the following reasons:

As demonstrated by the documents provided with this application and will be further discussed at the hearing on this matter, the modification satisfies the standards for an Eligible Facilities Request pursuant to Section 6409(a) of the Federal Spectrum Act. The proposed modification also satisfies the standards for the grant of a special permit. (For further details, please see attached narrative and supporting documents)

B) Traffic generated or patterns of access or egress would not cause congestion hazard, or substantial change in established neighborhood character for the following reasons:

The modification of the unmanned facility will not change existing traffic demand or impact ingress or egress. The modified facility will continue to generate only about one to two vehicles trips per month in a standard passenger vehicle. (For further details, please see attached narrative and supporting documents)

C) The continued operation of or the development of adjacent uses as permitted in the Zoning Ordinance would not be adversely affected by the nature of the proposed use for the following reasons:

The modified facility will have no adverse effects on the operation or development of adjacent uses. The modified facility will emit no light, odor, dust or glare and generates no unusual noise or other adverse impacts. (For further details, please see attached narrative and supporting documents)

Nuisance or hazard would not be created to the detriment of the health, safety and/or welfare of the occupant of the proposed use or the citizens of the City for the following reasons:

The modified facility will generate no additional traffic or other negative impacts on surrounding properties or within the City of Cambridge. The facility requires no water or sewer services and emits no light, odor, dust or glare and generates no unusual noise or other adverse impacts. The facility will be unoccupied with no employees or customers. The availability of wireless services enhances the health, safety and welfare of the community. (For further details, please see attached narrative and supporting documents)

E) For other reasons, the proposed use would not impair the integrity of the district or adjoining district or otherwise derogate from the intent or purpose of this ordinance for the following reasons:

The facility has been designed to minimize its visual impact and is in harmony with the general purpose of the zoning ordinance for this use and in accordance with the requirements for an Eligible Facilities Request under Section 6409(a). (*Please see attached narrative and supporting documents*)

(ATTACHMENT B - PAGE 6)

DIMENSIONAL INFORMATION

N/A (min N/A (min N/A No Change N/A (min N/A (min N/A No Change N/A (min N/A (min N/A No Change N/A (min N/A (m	No Change No Change	N/A (m N/A (m	min. min.) min.) min.) min.)
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N/A No Change N/A (max or area for each dwelling unit: N/A No Change N/A (min det): N/A No Change N/A (min det):	No Change No Change No Change No Change	N/A	nin.) in.) in.)
ZE OF LOT: WIDTH N/A No Change N/A (min bet: REAR N/A No Change N/A (min bet: REAR N/A No Change N/A (min bet: REAR N/A No Change N/A (min bet: RIGHT SIDE N/A No Change N/A (min bet: N/A No Change N	No Change No Change No Change	N/A (m	in.)
DEPTH Petbacks in FRONT N/A No Change N/A (min No Change) REAR N/A No Change N/A (min No Change) RIGHT SIDE N/A No Change N/A (min No Change) RIGHT SIDE N/A No Change N/A (min No Change) RIGHT SIDE N/A No Change N/A (min No Change) LENGTH WIDTH ATIO OF USABLE OPEN SPACE OLOT AREA: 3) N/A No Change N/A (min No Change)	No Change No Change	N/A (m N/A (m N/A (m N/A (m	in.) uin.)
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RIGHT SIDE N/A No Change N/A (min No Change) LENGTH WIDTH ATIO OF USABLE OPEN SPACE D LOT AREA: 3) N/A No Change N/A (min No Change)	No Change	N/A (m	
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o. OF DWELLING UNITS: N/A No Change N/A (max	No Change	N/A	in.
	No Change	N/A (m	ax.
O. OF PARKING SPACES: N/A No Change N/A (min./ma	No Change	N/A (min./	max)
O. OF LOADING AREAS: N/A No Change N/A (min	No Change	N/A (m	in.
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NO. OF LOADING AREAS: N/A No Change N/A N/A N/A	No Change No Change No Change	N/A (min./ N/A (min./ N/A (m	1
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^{1.} SEE CAMBRIDGE ZONING ORDINANCE ARTICLE 5.000, SECTION 5.30 (DISTRICT OF DIMENSIONAL REGULATIONS).

^{2.} TOTAL GROSS FLOOR AREA (INCLUDING BASEMENT 7'-0" IN HEIGHT AND ATTIC AREAS GREATER

THAN 5') DIVIDED BY LOT AREA.

3. OPEN SPACE SHALL NOT INCLUDE PARKING AREAS, WALKWAYS OR DRIVEWAYS AND SHALL HAVE A MINIMUM DIMENSION OF 15'.

CHECK LIST

PROPERTY LOCATION: 2067 Massachusetts Avenue	DATE:	June 8, 2021	<u>. </u>
PETITIONER OR REPRESENTATIVE: Cellco Partnership d/b/a c/o Duval & Klasnick LLC, P.O. Box 254, Boxford, MA		ireless	
ADDRESS & PHONE: (781) 873-0021 - Daniel D. Klasnick, Esquire			
BLOCK:181 LOT	:88		
PLEASE CHECK THAT YOU HAVE INCLUDED THE FOLLOWING W WILL NOT BE ACCEPTED FOR PROCESSING & SCHEDULING			APPLICATION DOCUMENTS AR
PROVIDED.			
PLEASE INCLUDE THIS CHECKLIST WITH YOUR APPLICATION. ALL DOCUMENTS ARE TO BE TYPED OR WRITTEN LEGIBLY.			
DOCUMENTS	REQUIRED		ENCLOSED
Application Form 3 Forms with Original Signatures	_X		_X
Supporting Statements - Scanned & 1 set to Zoning	X		X
Application Fee (You will receive invoice online)	X		X
Assessor's GIS "Block Map" (Available on line or At Engineering Dept 147 Hampshire Street)	_X		X
Dimensional Form - Refer to Cambridge Zoning Ordinance - Scanned & 1 set to Zoning (Subject to further review by Zoning Specialist)	X		X
Ownership Certificate, Notarized - Scanned & 1 set to Zoning	X		X
Floor Plans - Scanned & 1 set to Zoning	X		X
Elevations - Scanned & 1 set to Zoning	X		X
Certified Plot Plan - Scanned & 1 set to Zoning (By Registered Land Surveyor)	X		X
Photographs of Property - Scanned & 1 set to Zoning	X		X
Parking Plan (if relevant to your application) Scanned & 1 set to Zoning	N/A		N/A
FOR SUBDIVISION ALSO INCLUDE: Scanned & 1 set to Zoni	ng		
Proposed Deeds	N/A		N/A
Evidence of Separate Utilities **	N/A		N/A
Proposed Subdivision Plan	N/A		N/A
Petitioners are advised to refer to Attachment A (Pr	rocedures	for applying	to the Boar

of Zoning Appeal) & consult zoning staff for review.

It is advisable for the Petitioner to discuss the petition with the abutters as listed in the Zoning BZA Case file.

 $^{^{\}star}$ For Special Permits under Art. 4.32.G.1 (Communication Towers and Antennas), include a photo simulation.

^{**} Can be submitted after subdivision has been approved.

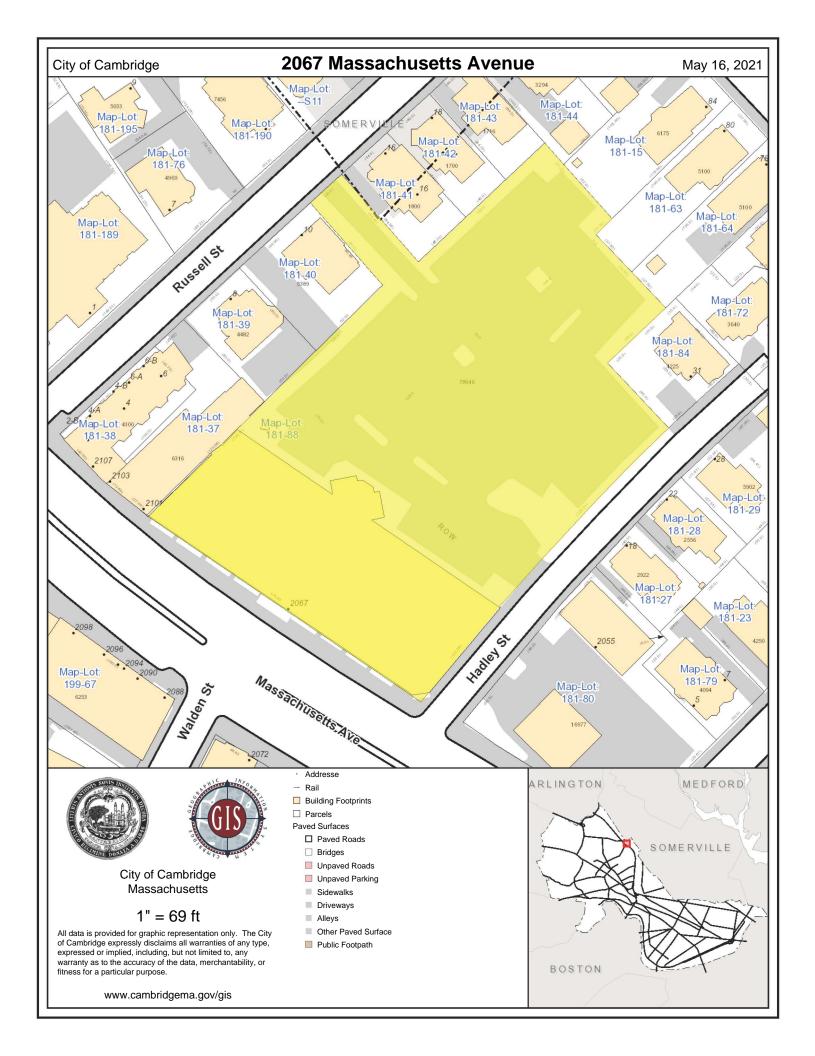


Exhibit 1 "ZBA Application Form – Ownership Information"

BZA APPLICATION FORM - OWNERSHIP INFORMATION

To be completed by OWNER, signed before a notary and returned to The Secretary of the Board of Zoning Appeals.

I/We	Henderson Carriage Limited Partnership (OWNER)
Addres	c/o The Davis Companies, 125 High Street, Suite 2111, Boston, MA 02110
State	that I/We own the property located at 2067 Massachusetts Avenue,
which	is the subject of this zoning application.
The re	ecord title of this property is in the name of Henderson Carriage Limited
Partn	ership
	ant to a deed of duly recorded in the date $\underline{04/23/1998}$, Middlesex South Registry of Deeds at Book $\underline{28494}$, Page $\underline{149}$; or
Middle	esex Registry District of Land Court, Certificate No.
Book _	Page
	SIGNATURE BY LAND OWNER OR AUTHORIZED TRUSTEE, OFFICER OR AGENT*
*Writt	ten evidence of Agent's standing to represent petitioner may be requested.
Common	wealth of Massachusetts, County of Suffolk
Jonath	nan G. Davis, as President of Davis Investment Corp., the sole Manager of
Hender	rson Carriage SPE General Partner LLC, the General Partner of Henderson
Carria	age Limited Partnership, personally appeared before me, this 26 ro of May,
2021,	and made oath that the above statement is true
My com	mission expires 5/14/24 (Notary Seal).

• If ownership is not shown in recorded deed, e.g. if by court order, recent deed, or inheritance, please include documentation.

Exhibit 2 "Plans"



PORTER SQ MA

2067 MASSSACHUSETTS AVENUE CAMBRIDGE, MA 02140

FUZE PROJECT ID: 16277392

PSLC: 137887



DEWBERRY ENGINEERS INC. 99 SUMMER ST. SUITE 700 BOSTON, MA 02110 PHONE # (617) 531-0800 CONTACT: BENJAMIN REVETTE, PE CONSTRUCTION VERIZON WIRELESS 118 FLANDERS ROAD WESTBOROUGH, MA 01581-3956
CONTACT: BENJAMIN REVETTE, PE CONSTRUCTION VERIZON WIRELESS 118 FLANDERS ROAD
CONSTRUCTION VERIZON WIRELESS 118 FLANDERS ROAD
VERIZON WIRELESS 118 FLANDERS ROAD
PROJECT TEAM

PMI ACCESSED AT:	HTTPS://PMI.VZWSMART.COM
SMART TOOL VENDOR PROJECT NUMBER:	N/A
VZW LOCATION CODE (PSLC):	137887
FUZE NUMBER:	16277395
MOUNT MODIFICATION REQUIRED?	NO
CONTRACTOR PMI	REQUIREMENTS
THIS DOCUMENT WAS DEVELOPED	TO REFLECT A SPECIFIC SIT

FACILITY IS UNMANNED AND NOT FOR HUMAN HABITATION.

	1.	RELOCATE (6) ANTENNAS TO (3) PROPOSED SIDE BY SIDE MOUNTS FROM POSITION 2 TO POSITION 3.
	2.	RELOCATE (3) EXISTING NR HRU ANTENNAS TO EXISTING MAST PIPE IN POSITION 2.
3	3.	INSTALL (3) NEW VZSO1 ANTENNAS ON EXISTING ANTENNA MOUNTING PIPE IN POSITION 1.
	4.	INSTALL NEW JUMPER CABLES AS REQUIRED BY RFDS.
ı		
ŀ	NC	OTE:
	1.	SCOPE OF WORK BASED ON ANTENNA REC FOR "PORTER_SQ_MA" DATED 11/09/20. VERIFY SCOPE OF WORK WITH FINAL RFDS PRIOR TO CONSTRUCTION.
		SCOPE OF WORK
	12.90	

ı	NO.	DESCRIPTION
-		
	T-1	TITLE SHEET
	GN-1	GENERAL NOTES
	C-1	ROOF PLAN
	C-2	ELEVATION
	C-3	CONSTRUCTION DETAILS
- 1		
- 1		
- 1		
-		
-		
1		
1		
		SHEET INDEX
•	- ALAN CONTRACT	

ver	izon ^v
	WIRELESS

VERIZON WIRELESS 118 FLANDERS ROAD WESTBOROUGH, MA 01581-3956

PORTER SQ MA

С	ONSTRUC	DRAWINGS	
0	04/14/21	FOR	SUBMITTAL



ewberry Engineers Inc. 99 SUMMER STREET SUITE 700 BOSTON, MA 02110 PHONE: 617.695,3400 FAX: 617.695,3310



DRAWN BY:	AJB
REVIEWED BY:	CDH
CHECKED BY:	BBR
PROJECT NUMBER:	50121487
JOB NUMBER:	50121974
SITE NUMBER	
137887	7
CITE ADDRECC	

2067 MASSACHUSETTS

AVENUE CAMBRIDGE, MA
02140

SHEET TITLE

TITLE SHEET

SHEET NUMBER

T - 1

GENERAL CONSTRUCTION NOTES:

- ALL WORK SHALL CONFORM TO ALL CURRENT APPLICABLE FEDERAL, STATE, AND LOCAL CODES, AND COMPLY WITH VERIZON WIRLLESS SPECIFICATIONS.
- CONTRACTOR SHALL CONTACT "DIG SAFE" (888-344-7233) FOR IDENTIFICATION OF UNDERGROUND UTILITIES PRIOR TO START OF CONSTRUCTION.
- 3. CONTRACTOR IS RESPONSIBLE FOR COORDINATING ALL REQUIRED INSPECTIONS.
- 4. ALL DIMENSIONS TO, OF, AND ON EXISTING BUILDINGS, DRAINAGE STRUCTURES, AND SITE IMPROVEMENTS SHALL BE VERIFIED IN FIELD BY CONTRACTOR WITH ALL DISCREPANCIES REPORTED TO THE ENGINEER.
- 5. DO NOT CHANGE SIZE OR SPACING OF STRUCTURAL FLEMENTS.
- 6. DETAILS SHOWN ARE TYPICAL: SIMILAR DETAILS APPLY TO SIMILAR CONDITIONS UNLESS OTHERWISE NOTED.
- 7. THESE DRAWINGS DO NOT INCLUDE NECESSARY COMPONENTS FOR CONSTRUCTION SAFETY WHICH IS THE SOLE
- 8. CONTRACTOR SHALL BRACE STRUCTURES UNTIL ALL STRUCTURAL ELEMENTS NEEDED FOR STABILITY ARE INSTALLED. THESE ELEMENTS ARE AS FOLLOWS: LATERAL BRACING, ANCHOR BOLTS, ETC.
- 9. CONTRACTOR SHALL DETERMINE EXACT LOCATION OF EXISTING UTILITIES, DRAIN PIPES, VENTS, ETC. BEFORE COMMENCING WORK.
- INCORRECTLY FABRICATED, DAMAGED, OR OTHERWISE MISFITTING OR NONCONFORMING MATERIALS OR CONDITIONS SHALL BE REPORTED TO THE OWNER PRIOR TO REMEDIAL OR CORRECTIVE ACTION. ANY SUCH REMEDIAL ACTION SHALL REQUIRE WRITTEN APPROVAL BY THE OWNER'S REPRESENTATIVE PRIOR TO PROCEEDING.
- 11. EACH CONTRACTOR SHALL COOPERATE WITH THE OWNER'S REPRESENTATIVE, AND COORDINATE HIS WORK WITH THE WORK OF OTHERS.
- 12. CONTRACTOR SHALL REPAIR ANY DAMAGE CAUSED BY CONSTRUCTION OF THIS PROJECT TO MATCH EXISTING PRE-CONSTRUCTION CONDITIONS TO THE SATISFACTION OF THE VERIZON WIRELESS CONSTRUCTION MANAGER.
- 13. ALL CABLE/CONDUIT ENTRY/EXIT PORTS SHALL BE WEATHERPROOFED DURING INSTALLATION USING A SILICONE SEALANT.
- WHERE EXISTING CONDITIONS DO NOT MATCH THOSE SHOWN IN THIS PLAN SET, CONTRACTOR WILL NOTIFY ENGINEER, VERIZON WIRELESS PROJECT CONSTRUCTION MANAGER, AND LANDLORD IMMEDIATELY.
- CONTRACTOR SHALL ENSURE ALL SUBCONTRACTORS ARE PROVIDED WITH A CURRENT SET OF DRAWINGS AND SPECIFICATIONS FOR THIS PROJECT.
- ALL ROOF WORK SHALL BE DONE BY A QUALIFIED AND EXPERIENCED ROOFING CONTRACTOR IN COORDINATION WITH ANY
 CONTRACTOR WARRANTING THE ROOF TO ENSURE THAT THE WARRANTY IS MAINTAINED.
- 17. CONTRACTOR SHALL REMOVE ALL RUBBISH AND DEBRIS FROM THE SITE AT THE END OF EACH DAY.
- 18. CONTRACTOR SHALL COORDINATE WORK SCHEDULE WITH LANDLORD AND TAKE PRECAUTIONS TO MINIMIZE IMPACT AND DISRUPTION OF OTHER OCCUPANTS OF THE FACILITY.
- 19. CONTRACTOR SHALL FURNISH VERIZON WIRELESS WITH THREE AS-BUILT SETS OF DRAWINGS UPON COMPLETION OF WORK.
- 20. ANTENNAS AND CABLES ARE TYPICALLY PROVIDED BY VERIZON WIRELESS. PRIOR TO SUBMISSION OF BID, CONTRACTOR SHALL COORDINATE WITH PROJECT MANAGER TO DETERMINE WHAT, IF ANY, ITEMS WILL BE PROVIDED BY VERIZON WIRELESS. ALL ITEMS NOT PROVIDED BY VERIZON WIRELESS SHALL BE PROVIDED AND INSTALLED BY THE CONTRACTOR. CONTRACTOR WILL INSTALL ALL ITEMS PROVIDED BY VERIZON WIRELESS.
- 21. PRIOR TO SUBMISSION OF BID, CONTRACTOR WILL COORDINATE WITH VERIZON WIRELESS PROJECT MANAGER TO DETERMINE IF ANY PERMITS WILL BE OBTAINED BY VERIZON WIRELESS. ALL REQUIRED PERMITS NOT OBTAINED BY VERIZON WIRELESS MUST BE OBTAINED, AND PAID FOR, BY THE CONTRACTOR.
- 22. GENERAL CONTRACTOR SHALL HAVE A LICENSED HVAC CONTRACTOR START THE HVAC UNITS, SYNCHRONIZE THE THERMOSTATS, ADJUST ALL SETTINGS ON EACH UNIT ACCORDING TO VERIZON WIRELESS CONSTRUCTION MANAGER'S SPECIFICATIONS, AND THOROUGHLY TEST AND BALANCE EACH UNIT TO ENSURE PROPER OPERATION PRIOR TO TURNING THE SITE OVER TO OWNER.
- 23. CONTRACTOR SHALL INSTALL ALL SITE SIGNAGE IN ACCORDANCE WITH VERIZON WIRELESS SPECIFICATIONS AND REQUIREMENTS
- 24. CONTRACTOR SHALL SUBMIT ALL SHOP DRAWINGS TO ENGINEER FOR REVIEW AND APPROVAL PRIOR TO FABRICATION
- UNLESS OTHERWISE NOTED VERIZON WIRELESS SHALL PROVIDE ALL REQUIRED RF MATERIAL FOR CONTRACTOR TO INSTALL, INCLUDING AMENIAS, TMA'S, BIAS-T'S, COMBINERS, PDU, DC BLOCKS, SURGE ARRESTORS, GPS ANTENNA, GPS SURGE ARRESTOR, COAXAL CABLE.
- PRIOR TO SUBMISSION OF BID, CONTRACTOR SHALL VERIFY ALL EQUIPMENT TO BE PROVIDED BY VERIZON WIRELESS FOR INSTALLATION BY CONTRACTOR.
- 27. ALL EQUIPMENT SHALL BE INSTALLED ACCORDING TO MANUFACTURER'S SPECIFICATIONS AND LOCATED ACCORDING TO VERIZON WIRELESS SPECIFICATIONS, AND AS SHOWN IN THESE PLANS.
- 28. DETAILS SHOWN ARE TYPICAL; SIMILAR DETAILS APPLY TO SIMILAR CONDITIONS UNLESS OTHERWISE NOTED.
- 29. THE CONTRACTOR SHALL SUPERVISE AND DIRECT THE PROJECT DESCRIBED HEREIN. THE CONTRACTOR SHALL BE SOLELY RESPONSIBLE FOR ALL THE CONSTRUCTION MEANS, METHODS, TECHNIQUES, SEQUENCES AND PROCEDURES AND FOR COORDINATING ALL PORTIONS OF THE WORK UNDER THE CONTRACT.
- 30. CONTRACTOR SHALL NOTIFY THE ENGINEER A MINIMUM OF 48 HOURS IN ADVANCE PRIOR TO CONSTRUCTION START, MORE SPECIFICALLY BEFORE; SEALING ANY FLOOR, WALL OR ROOF PENETRATION, FINAL UTILITY CONNECTIONS, POURING CONCRETE, BACKFILLING UTILITY TRENCHES AND STRUCTURAL POST OR MOUNTING CONNECTIONS, FOR ENGINEERING REVIEW AND INSPECTION.
- 31. SEAL PENETRATIONS THROUGH FIRE RATED AREAS WITH UL LISTED D FIRE CODE APPROVED MATERIALS.
- 32. REPAIR ANY DAMAGE DURING CONSTRUCTION TO MATCH EXISTING PRE-CONSTRUCTION CONDITIONS TO THE SATISFACTION OF THE CONSTRUCTION MANAGER AND LANDLORD.
- 33. ALL DISRUPTIVE WORK AND WORK WITHIN TENANT SPACES TO BE COORDINATED WITH BUILDING REPRESENTATIVE.

CODE SPECIFICATIONS:

- . ALL WORK SHALL COMPLY WITH THE FOLLOWING APPLICABLE CODES:
- MASSACHUSETTS STATE BUILDING CODE, 9TH EDITION, CONSISTENT WITH THE FOLLOWING CODES:
- 2015 INTERNATIONAL RESIDENTIAL CODE (IRC)
- 2015 INTERNATIONAL BUILDING CODE (IBC)
- 2015 INTERNATIONAL EXISTING BUILDING CODE (IBC)
- 2020 NATIONAL ELECTRICAL CODE (NEC)
- IN THE EVENT OF CONFLICT, THE MOST RESTRICTIVE CODE SHALL PREVAIL.
- 2. ALL STRUCTURAL WORK TO BE DONE IN ACCORDANCE WITH THE AMERICAN INSTITUTE OF STEEL CONSTRUCTION MANUAL, 13TH EDITION (AISC 13TH ED.)
- ALL CONCRETE WORK TO BE DONE IN ACCORDANCE WITH THE AMERICAN CONCRETE INSTITUTE (ACI 301) SPECIFICATIONS
 FOR STRUCTURAL CONCRETE FOR BUILDINGS (ACI 318) AND BUILDING CODE REQUIREMENTS FOR REINFORCED CONCRETE.
- ALL REINFORCING STEEL WORK TO BE DONE IN ACCORDANCE WITH THE (ACI 315) MANUAL OF STANDARD PRACTICE FOR DETAILING REINFORCED CONCRETE STRUCTURES.

GROUNDING NOTES:

- 1. GROUNDING SHALL COMPLY WITH NEC ART. 250.
- 2. GROUNDING CONDUCTORS SHALL BE #6 COPPER STRANDED WIRE WITH GREEN COLOR INSULATION FOR INDOOR USE.
- ALL GROUND CONNECTIONS TO BE BURNDY HYGROUND COMPRESSION TYPE CONNECTORS OR CADWELD EXOTHERMIC WELD DO NOT ALLOW BARE COPPER WIRE TO BE IN CONTACT WITH GALVANIZED STEEL.
- 4. ROUTE GROUNDING CONNECTORS ALONG THE SHORTEST AND STRAIGHTEST PATH POSSIBLE, EXCEPT AS OTHERWISE INDICATED. GROUNDING LEADS SHOULD NOT BE BENT AT RIGHT ANGLE. ALWAYS MAKE 12" RADIUS BENDS. #6 WIRE CAN BE BENT AT 6" RADIUS WHEN NECESSARY.
- CONNECTIONS TO GROUNDING BAR SHALL BE MADE WITH TWO HOLE COMPRESSION TYPE COPPER LUGS. APPLY OXIDE INHIBITING COMPOUND TO ALL LOCATIONS.
- TEST COMPLETED GROUNDING SYSTEM AND RECORD RESISTANCE VALUES FOR PROJECT CLOSE—OUT DOCUMENTATION. GROUND RESISTANCE SHALL NOT EXCEED 5 OHMS.
- 7. GROUNDING CONDUCTORS BETWEEN MGB AND WATERMAIN SHALL BE #2/0. BONDING JUMPERS FROM METALLIC SURFACES SHALL BE #2 MINIMUM. ALL GROUND CONDUCTORS AND BONDING JUMPERS SHALL BE SOFT DRAWN ANNEALED, TINNED, BARE STRANDED COPPER WIRE. COAXIAL CABLES SHALL BE GROUNDED AT A MINIMUM OF TWO LOCATIONS USING VERIZON PROVIDED GROUNDING KITS. EXACT LOCATIONS SHALL BE FINALIZED IN THE FIELD BY THE CONSTRUCTION MANAGER.

STRUCTURAL STEEL NOTES:

- STRUCTURAL STEEL SHALL CONFORM TO THE LATEST EDITION OF THE AISC "SPECIFICATION FOR THE DESIGN, FABRICATION AND ERECTION OF STRUCTURAL STEEL FOR BUILDINGS".
- 2. STRUCTURAL STEEL ROLLED SHAPES, PLATES, AND BARS SHALL CONFORM TO THE FOLLOWING ASTM

DESIGNATIONS:
ASTM A-992, GRADE 50
ASTM A-36
ASTM A-36
ASTM A-300, GRADE B
ASTM A-325, TYPE 5C OR N
E1554, GRADE 36
ASTM A-53, GRADE B
STEEL PIPE
ASTM A-53, GRADE B
STEEL PIPE
ASTM A-53, GRADE B

ALL W SHAPES, UNLESS NOTED OR A992 OTHERWISE.
ALL OTHER ROLLED SHAPES, PLATES AND BARS UNLESS NOTED OTHERWISE.
ALL OF CONNECTING STRUCTURAL MEMBERS.
ALL ANCHORS BOLTS, UNLESS NOTED OTHERWISE.
STEEL PIPE

- 3. ALL WELDING SHALL BE DONE USING E70XX ELECTRODES AND WELDING SHALL CONFORM TO AISC AND AWS D1.1 WHERE FILLET WELD SIZES ARE NOT SHOWN, PROVIDE THE MINIMUM SIZE PER TABLE 12.4 IN THE AISC "MANUAL OF STEEL CONSTRUCTION", 14TH EDITION. WHERE WELD LENGTH IS NOT INDICATED, USE FULL LENGTH WELD. AT THE COMPLETION OF ALL WELDING, ALL DAMAGE TO GALVANIZED COATING SHALL BE REPAIRED.
- BOLTED CONNECTIONS SHALL USE BEARING TYPE GALVANIZED ASTM A325 BOLTS (3/4" DIA.) SUPPLIED WITH A
 NUT AND WASHER UNDER TURNED END AND SHALL HAVE MINIMUM OF TWO BOLTS UNLESS NOTED OTHERWISE.
- DO NOT DRILL HOLES THROUGH STRUCTURAL STEEL MEMBERS EXCEPT AS SHOWN AND DETAILED ON STRUCTURAL DRAWINGS.
- 6. NON-STRUCTURAL CONNECTIONS FOR STEEL GRATING MAY USE 5/8" DIA. GALVANIZED ASTM A 307 BOLTS LINESS NOTED OTHERWISE
- 7. USE PRECAUTIONS & PROCEDURES PER AWS D1.1 WHEN WELDING GALVANIZED METALS.
- ALL EXISTING BEAM AND COLUMN DIMENSIONS SHALL BE FIELD VERIFY BY CONTRACTOR PRIOR TO FABRICATION. ANY DISCREPANCES BETWEEN EXISTING CONDITIONS AND THOSE SHOWN SHALL BE REPORTED TO DEWBERRY ENGINEER IMMEDIATELY.
- 9. CONNECTION DESIGN BY FABRICATOR WILL BE SUBJECT TO REVIEW AND APPROVAL BY ENGINEER.
- 10. ALL EXTERIOR STEEL WORK SHALL BE GALVANIZED IN ACCORDANCE WITH SPECIFICATION ASTM A123/A123M-00 HOT-DIP GALVANIZED FINISH UNLESS OTHERWISE NOTED. GALVANIZING SHALL BE PERFORMED AFTER SHOP FABRICATION TO THE GREATEST EXTENT POSSIBLE. ALL DINGS, SCRAPES, MARS, AND WELDS IN THE GALVANIZED AREAS SHALL BE REPAIRED. REPAIR DAMAGED GALVANIZED COATINGS ON GALVANIZED ITEMS WITH GALVANIZED OF REPAIR PAINT ACCORDING TO ASTM A780 AND MANUFACTURER'S WRITTEN INSTRUCTIONS, PRIOR TO COMPLETION OF WORK. TOUCHUP ALL DAMAGED GALVANIZED STEEL WITH APPROVED COLD ZING, "GALVANOX", "DRY GALV", "ZING-II", OR APPROVED COUNVALENT, IN ACCORDANCE WITH MANUFACTURERS GUIDELINES. TOUCHUP DAMAGED NON GALVANIZED STEEL WITH SAME PAINT APPLIED IN SHOP OR FIELD.
- 11. ALL WELDED COMPONENTS TO BE SHOP WELDED PRIOR TO INSTALLATION. NO WELDING ACTIVITIES IS PERMITTED DURING INSTALLATION OF PROPOSED EQUIPMENTS AND/OR HARDWARE ON SITE.




VERIZON WIRELESS 118 FLANDERS ROAD WESTBOROUGH, MA 01581-3956

PORTER SQ MA

С	ONSTRUC	DRAWINGS	
0	04/14/21	FOR	SUBMITTAL



Dewberry Engineers Inc. 99 SUMMER STREET SUITE 700 BOSTON, MA 02110 PHONE: 617.695,3400 FAX; 617.695,3310

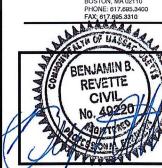

RAWN	BY:		AJB

REVIEWED BY: CDH

CHECKED BY: BBR

PROJECT NUMBER: 50121487

JOB NUMBER: 50121974

SITE NUMBER

137887

SITE ADDRESS


2067 MASSACHUSETTS AVENUE CAMBRIDGE, MA 02140

SHEET TITLE

GENERAL NOTES

SHEET NUMBER

GN-1

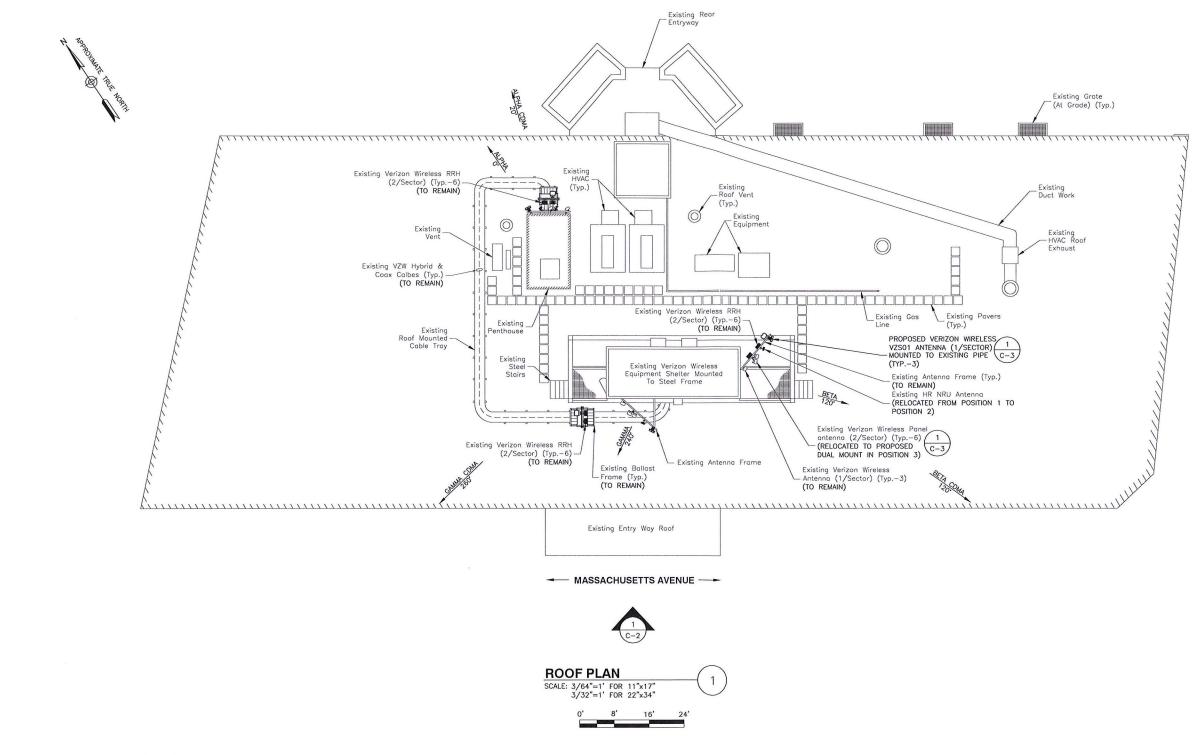

SITE NOTES:

- SOME EXISTING & PROPOSED INFORMATION NOT SHOWN FOR CLARITY.
- 2. NORTH ARROW SHOWN AS APPROXIMATE.
- 3. REUSE EXISTING ANTENNA MOUNTS & COAX. INSPECT FOR DAMAGE OR DECAY AND REPLACE AS NEEDED.
- INSTALL ALL PROPOSED EQUIPMENT IN ACCORDANCE WITH MANUFACTURER'S RECOMMENDATIONS & STRUCTURAL ASSESSMENT BY DEWBERRY ENGINEERS INC. DATED 04/08/21.



VERIZON WIRELESS 118 FLANDERS ROAD WESTBOROUGH, MA 01581-3956

PORTER SQ MA

CONSTRUCTION DRAWINGS

0 04/14/21 FOR SUBMITTAL



Dewberry Engineers Inc. 99 SUMMER STREET SUITE 700 BOSTON, MA 02110 PHONE: 617.695,3400 FAX; 617.695,3310



DRAWN BY: AJB

REVIEWED BY: CDH

CHECKED BY: BBR

PROJECT NUMBER: 50121487

JOB NUMBER: 50121974

SITE NUMBER

137887


SITE ADDRESS

2067 MASSACHUSETTS AVENUE CAMBRIDGE, MA 02140

SHEET TITLE

ROOF PLAN

SHEET NUMBER

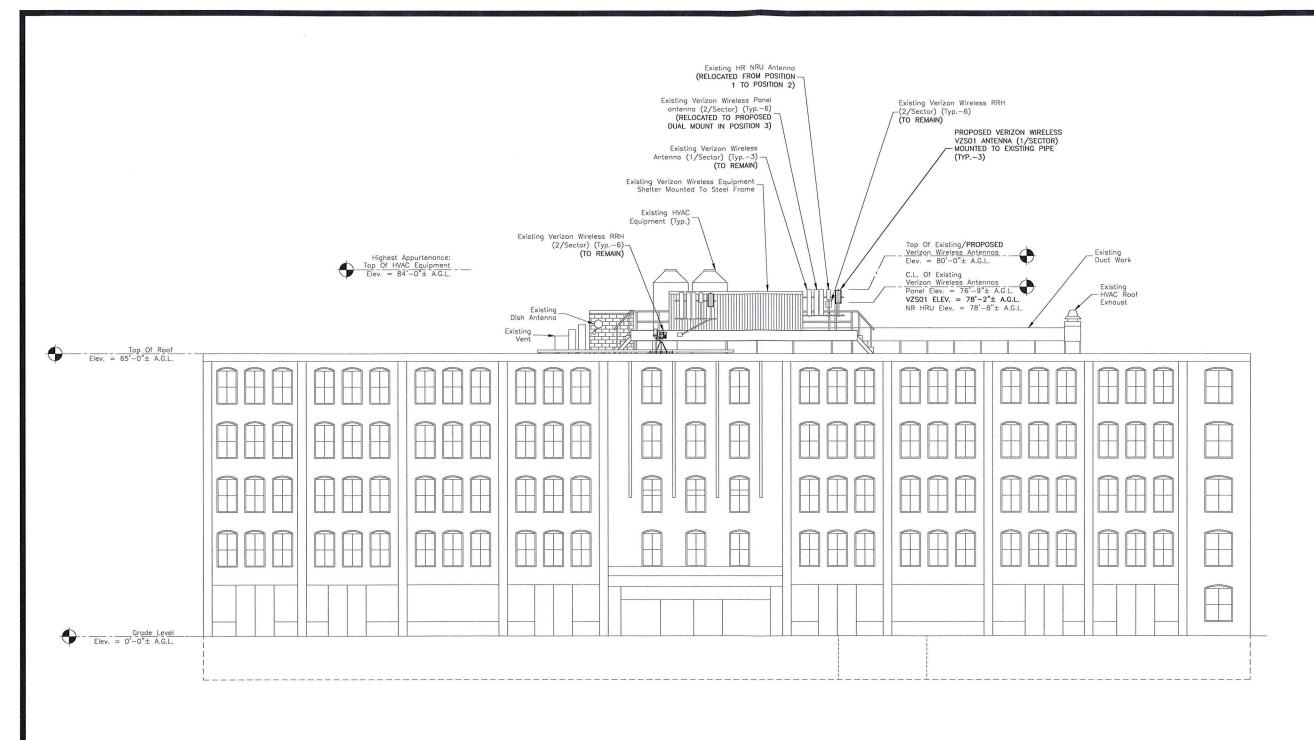

ELEVATION

SCALE: 3/64"=1' FOR 11"x17"
3/32"=1' FOR 22"x34"

0' 8' 16' 24'

SITE NOTES:

- SOME EXISTING & PROPOSED INFORMATION NOT SHOWN FOR CLARITY.
- 2. ELEVATIONS SHOWN AS APPROXIMATE.
- A.G.L. = ABOVE GROUND LEVEL
 C.L. = CENTERLINE
- 4. INSTALL ALL PROPOSED EQUIPMENT IN ACCORDANCE WITH MANUFACTURER'S RECOMMENDATIONS & STRUCTURAL ASSESSMENT BY DEWBERRY ENGINEERS INC. DATED 04/08/21.



VERIZON WIRELESS 118 FLANDERS ROAD WESTBOROUGH, MA 01581-3956

PORTER SQ MA

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0	04/14/21	FOR	SUBMITTAL



Dewberry Engineers Inc. 99 SUMMER STREET SUITE 700 BOSTON, MA 02110 PHONE: 617.695.3400 FAX: 617.695.3310



DRAWN BY:	AJB
REVIEWED BY:	CDH
CHECKED BY:	BBR

PROJECT NUMBER: 50121487

JOB NUMBER: 50121974

SITE NUMBER

137887


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2067 MASSACHUSETTS AVENUE CAMBRIDGE, MA 02140


SHEET TITLE

ELEVATION

SHEET NUMBER

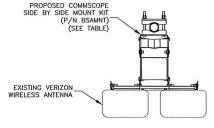

UPPER MOUNT

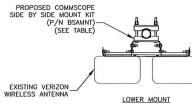


COMMSCOPE P/N: BSAMNT MOUNT TABLE						
COMMSCOPE P/N	SUPPORTED ANTENNAS	QUANTITY REQUIRED PER (2) ANTENNAS	NUMBER OF MOUNTING POINTS	GAP BETWEEN ANTENNAS		
BSAMNT-SBS-1-2	SBNHH-1D65A/B/C NHH-65A/B/C-R2B	1	2	3-3/8"		
BSAMNT-SBS-2-2	JAHH-65A/B/C-R3B JAHH-45A-R3B NHH-45A-R2B SBNHH-1D45A/B	1	2	2"		
BSAMNT-SBS-2-3	JAHH-45B/C-R3B SBNHH-1D45C	1	3	2"		

TABLE BASED ON POWER POINT PRESENTATION BY COMMSCOPE TITLED SIDE BY SIDE MOUNTS. CONTRACTOR TO VERIFY PART NUMBERS WITH MANUFACTURER PRIOR TO ORDERING. INSTALL PER MANUFACTURER RECOMMENDATIONS & SPECIFICATIONS.

NOTES:

- SPACING OF PROPOSED EQUIPMENT SHALL BE CONFIRMED AND PROPOSED MOUNTS SHALL NOT IMPEDE EQUIPMENT CLEARANCES, ACCESS TO EQUIPMENT SHALL BE MAINTAINED.
- 2. PROPOSED ANTENNA MOUNT SHALL BE INSTALLED ACCORDING TO MANUFACTURER SPECIFICATIONS.



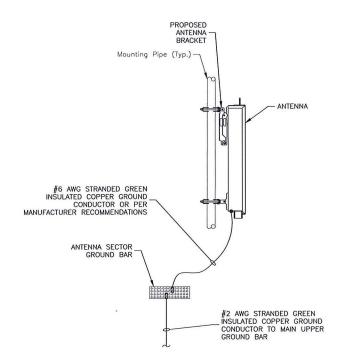


NOTES

- VERIFY EXISTING GROUNDING SYSTEM IS INSTALLED PER VERIZON WIRELESS STANDARDS.
- BOND NEW EQUIPMENT INTO EXISTING GROUND SYSTEM IN ACCORDANCE WITH VERIZON WIRELESS STANDARDS AND MANUFACTURER'S RECOMMENDATIONS.

TYPICAL ANTENNA
GROUNDING DETAIL
SCALE: N.T.S

3

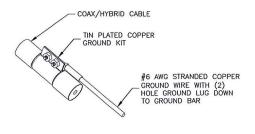



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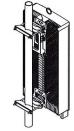
- DO NOT INSTALL CABLE GROUND KIT AT A BEND. ALWAYS DIRECT GROUND WIRE DOWN TO GROUND BAR.
- 2. GROUNDING KIT SHALL BE TIN PLATED COPPER WITH TWO-HOLE LUG, SIZE PER COAX DIAMETER.
- 3. WEATHER SEAL GROUND KIT PER CARRIER REQUIREMENTS.
- 4. COAX CABLE GROUND KIT LOCATION & QUANTITY SHALL BE PER CARRIER SPECIFICATIONS & STANDARDS.

COAX/HYBRID GROUNDING DETAIL
SCALE: N.T.S.





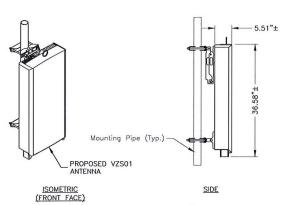

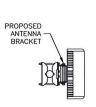

ISOMETRIC (REAR FACE)

MODEL: DIMENSIONS:

PLAN

S: 35.1"H X 16.1"W X 5.5"D (NOT TO EXCEED)


87.1 LBS (NOT TO EXCEED)

WEIGHT:

NOTES:

 INSTALL ALL EQUIPMENT PER MANUFACTURER'S RECOMMENDATIONS. USE APPROPRIATE MOUNTING HARDWARE FOR CONSTRUCTION TYPE.

PIPE MOUNTED ANTENNA DETAIL
SCALE: N.T.S.

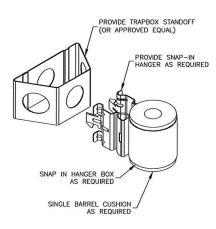

JUMPER MOUNT

verizon V

VERIZON WIRELESS 118 FLANDERS ROAD WESTBOROUGH, MA 01581-3956

PORTER SQ MA

С	ONSTRUC	TION	DRAWINGS
0	04/14/21	FOR	SUBMITTAL



Dewberry Engineers Inc. 99 SUMMER STREET SUITE 700 BOSTON, MA 02110



DRAWN	BY:	AJB
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BBR

REVIEWED BY: CDH

NEVICINES ST.

PROJECT NUMBER: 50121487

JOB NUMBER: 50121974

137887

SITE ADDRESS

2067 MASSACHUSETTS AVENUE CAMBRIDGE, MA 02140

SHEET TITLE

CHECKED BY

SITE NUMBER

CONSTRUCTION DETAILS

SHEET NUMBER


Exhibit 3 "Photo Simulations"










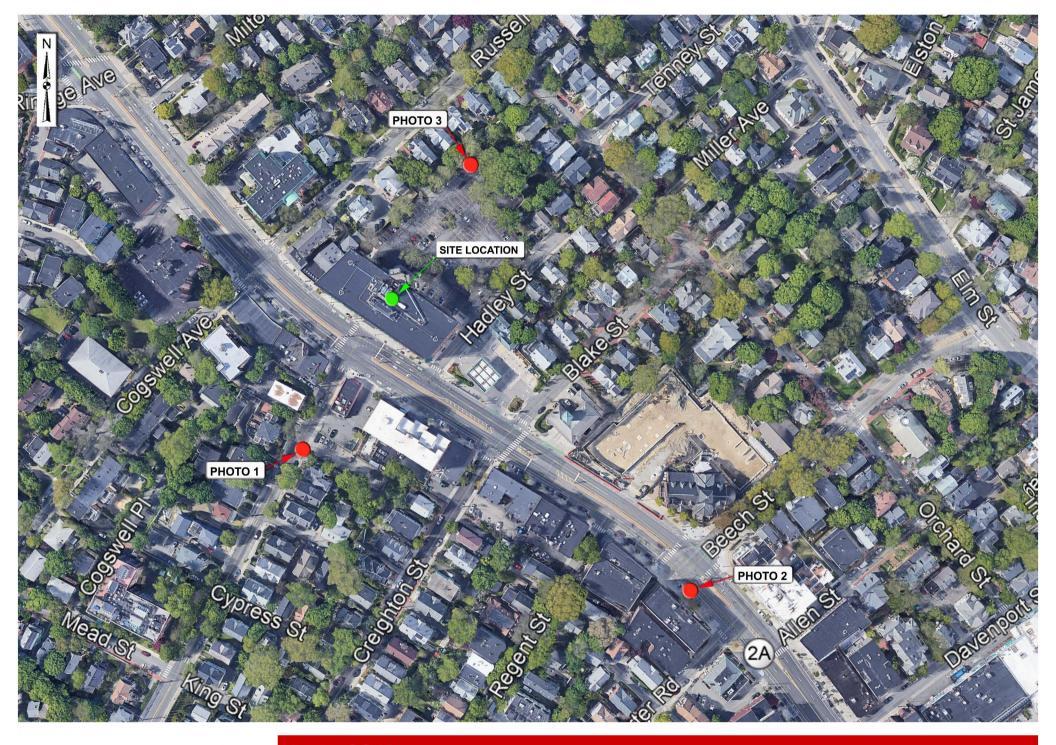






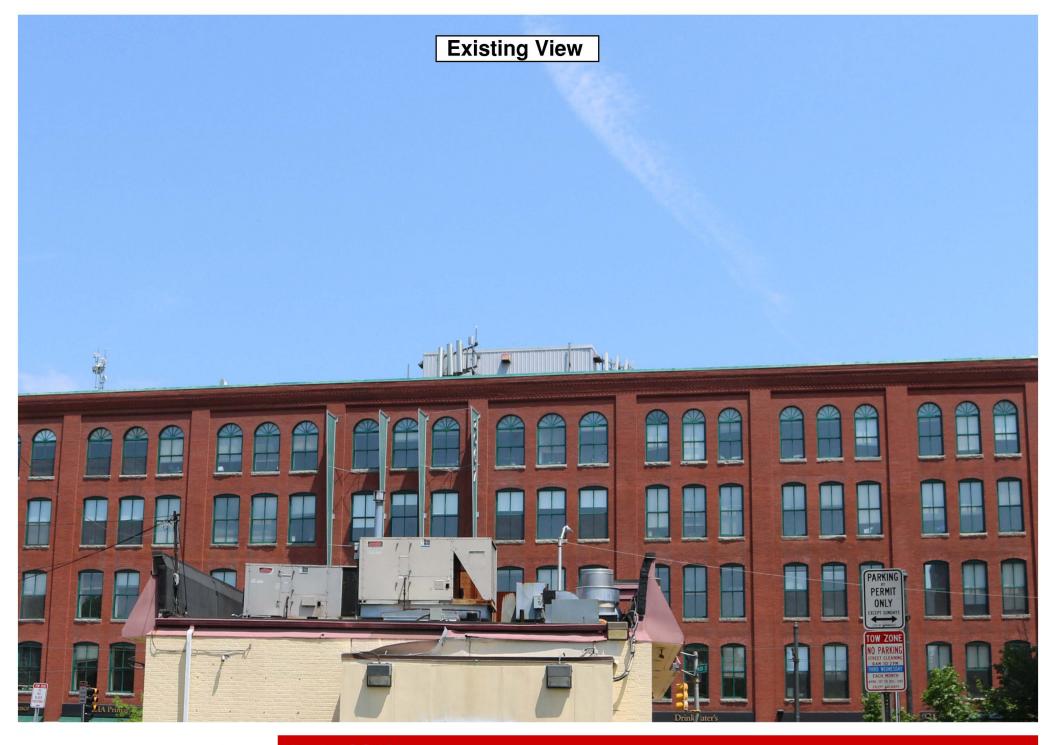






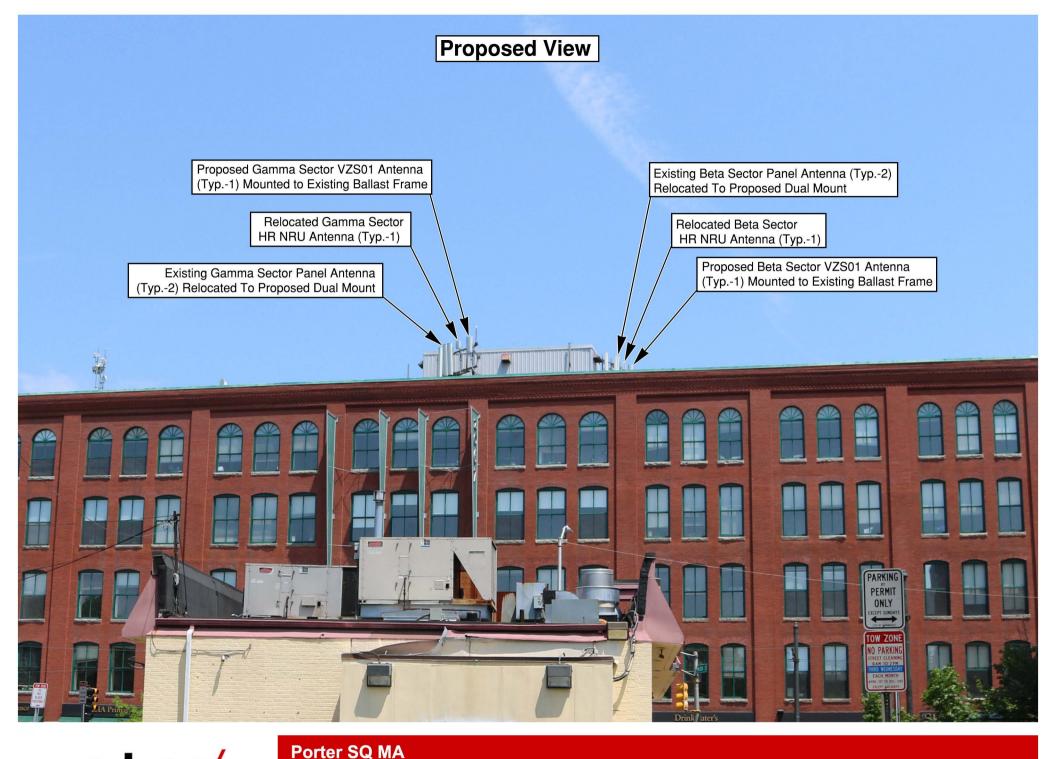






Dewberry*

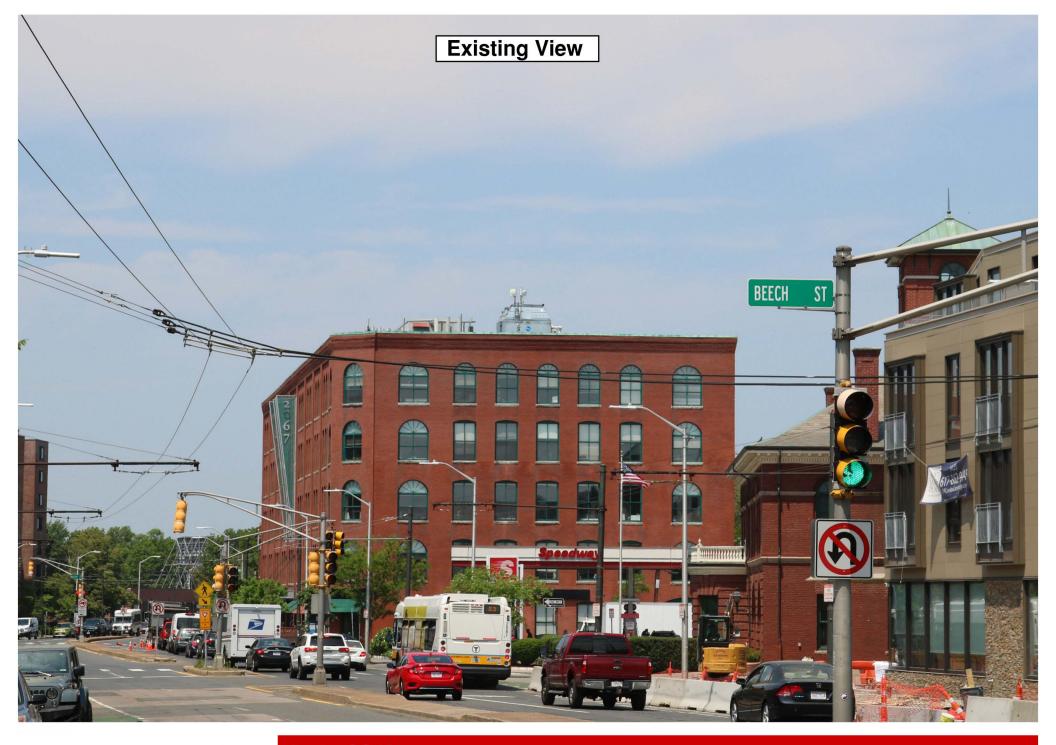







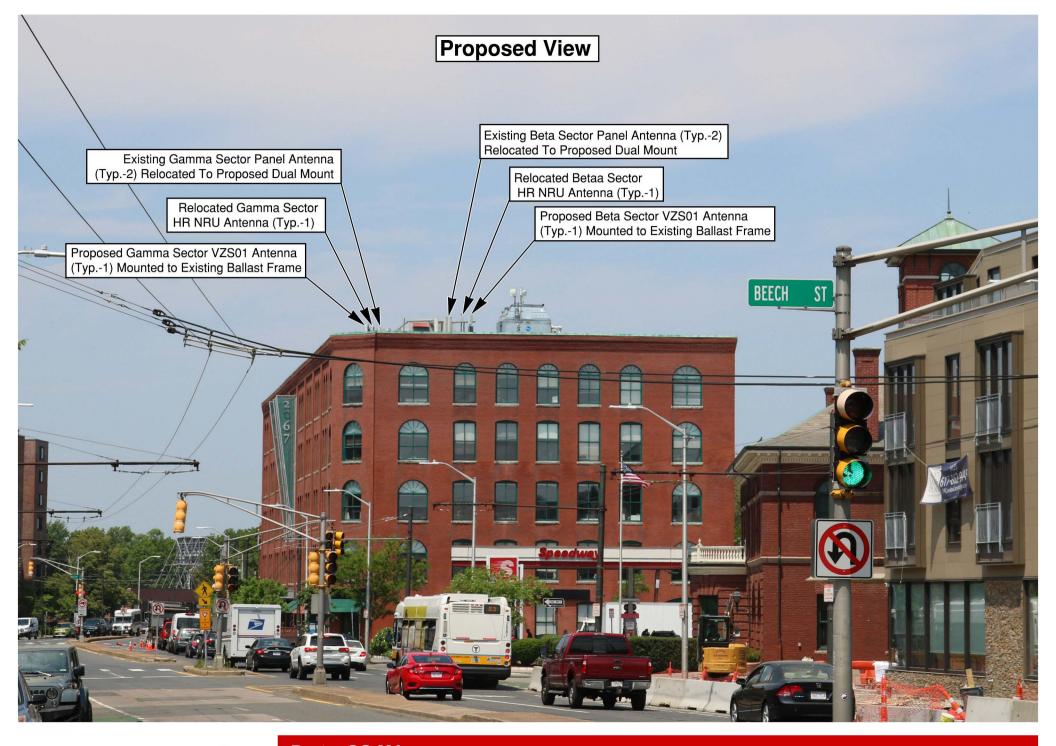



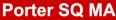

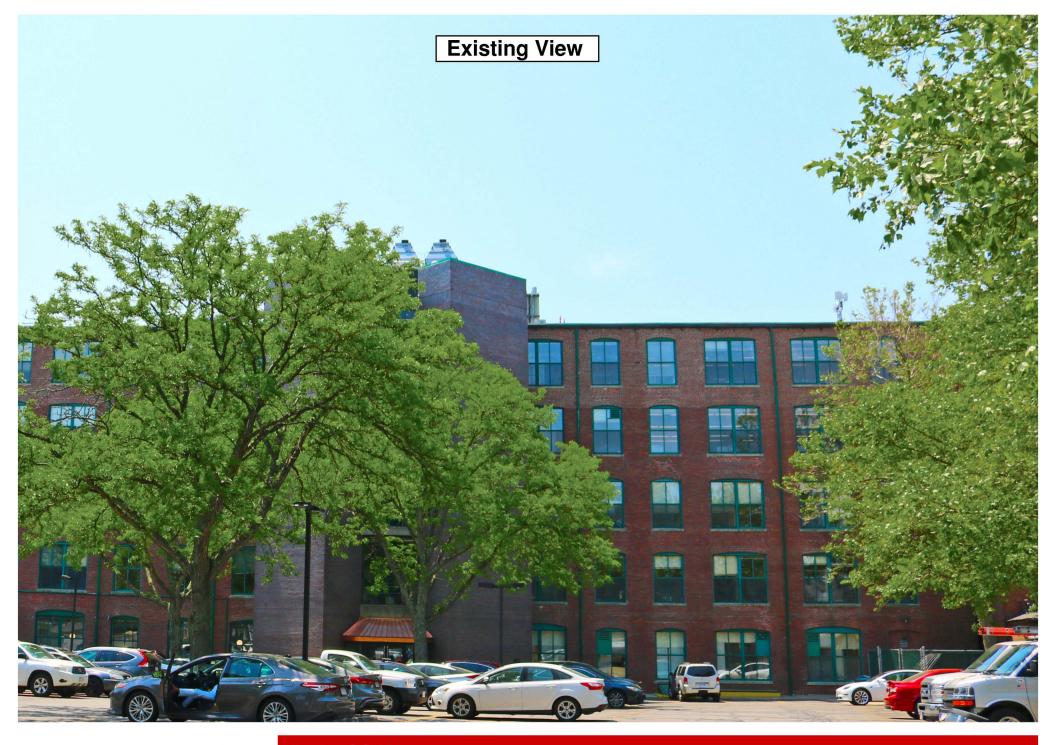









(Page 8 of 8)

Dewberry*

Exhibit 4 "FCC License to Operate"

REFERENCE COPY

This is not an official FCC license. It is a record of public information contained in the FCC's licensing database on the date that this reference copy was generated. In cases where FCC rules require the presentation, posting, or display of an FCC license, this document may not be used in place of an official FCC license.



Federal Communications Commission

Wireless Telecommunications Bureau

RADIO STATION AUTHORIZATION

LICENSEE: CELLCO PARTNERSHIP

ATTN: REGULATORY CELLCO PARTNERSHIP 5055 NORTH POINT PKWY, NP2NE ENGINEERING ALPHARETTA, GA 30022

Call Sign	File Number
WRBA936	
Radio	Service
UU - Upper Micro	wave Flexible Use
Serv	vice

FCC Registration Number (FRN): 0003290673

Grant Date 09-11-2018	Effective Date 02-27-2019		
Market Number BTA051		nel Block L1	Sub-Market Designator
	Market Boston		
1st Build-out Date 06-01-2024	2nd Build-out Date	3rd Build-out Date	4th Build-out Date

Waivers/Conditions:

Grant of the request to update licensee name is conditioned on it not reflecting an assignment or transfer of control (see Rule 1.948); if an assignment or transfer occurred without proper notification or FCC approval, the grant is void and the station is licensed under the prior name.

Conditions:

Pursuant to §309(h) of the Communications Act of 1934, as amended, 47 U.S.C. §309(h), this license is subject to the following conditions: This license shall not vest in the licensee any right to operate the station nor any right in the use of the frequencies designated in the license beyond the term thereof nor in any other manner than authorized herein. Neither the license nor the right granted thereunder shall be assigned or otherwise transferred in violation of the Communications Act of 1934, as amended. See 47 U.S.C. § 310(d). This license is subject in terms to the right of use or control conferred by §706 of the Communications Act of 1934, as amended. See 47 U.S.C. §606.

This license may not authorize operation throughout the entire geographic area or spectrum identified on the hardcopy version. To view the specific geographic area and spectrum authorized by this license, refer to the Spectrum and Market Area information under the Market Tab of the license record in the Universal Licensing System (ULS). To view the license record, go to the ULS homepage at http://wireless.fcc.gov/uls/index.htm?job=home and select "License Search". Follow the instructions on how to search for license information.

Licensee Name: CELLCO PARTNERSHIP

Call Sign: WRBA936 File Number: Print Date:

700 MHz Relicensed Area Information:

Market Name Buildout Deadline Buildout Notification Status

REFERENCE COPY

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Federal Communications Commission

Wireless Telecommunications Bureau

RADIO STATION AUTHORIZATION

LICENSEE: CELLCO PARTNERSHIP

ATTN: REGULATORY CELLCO PARTNERSHIP 5055 NORTH POINT PKWY, NP2NE ENGINEERING ALPHARETTA, GA 30022

Call Sign WRBA937	File Number			
Radio Service				
UU - Upper Micro	wave Flexible Use			
Serv	vice			

FCC Registration Number (FRN): 0003290673

Grant Date 09-11-2018	Effective Date 02-27-2019	Expiration Date 10-06-2028	Print Date
Market Number BTA051		tel Block	Sub-Market Designator
	Market Boston	- 1111	
1st Build-out Date 06-01-2024	2nd Build-out Date	3rd Build-out Date	4th Build-out Date

Waivers/Conditions:

Grant of the request to update licensee name is conditioned on it not reflecting an assignment or transfer of control (see Rule 1.948); if an assignment or transfer occurred without proper notification or FCC approval, the grant is void and the station is licensed under the prior name.

Conditions:

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This license may not authorize operation throughout the entire geographic area or spectrum identified on the hardcopy version. To view the specific geographic area and spectrum authorized by this license, refer to the Spectrum and Market Area information under the Market Tab of the license record in the Universal Licensing System (ULS). To view the license record, go to the ULS homepage at http://wireless.fcc.gov/uls/index.htm?job=home and select "License Search". Follow the instructions on how to search for license information.

Licensee Name: CELLCO PARTNERSHIP

Call Sign: WRBA937 File Number: Print Date:

700 MHz Relicensed Area Information:

Market Name Buildout Deadline Buildout Notification Status


Exhibit 5 "ZBA Decision"



City of Cambridge

MASSACHUSETTS

BOARD OF ZONING APPEAL

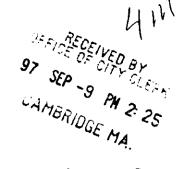

Business A-2 Zone

CASE NO:

7484

LOCATION:

2067 Mass Avenue

Cambridge, MA

BK 14828 Pg 253

PETITIONER:

Bell Atlantic Nynex Mobile

Paul J. Moriarty & Assoc.

RECORD OWENCE:

PETITION:

JONATHAN G. DAVIS & HAROLA H. DAVIS, TRUSTRES OF HENDERSON CARRIAGE DEVELOPMENT TRUST Special Permit: To establish telephone exchange use (cellular Communications) on roof of existing building with equipment shelter and roof antennas.

VIOLATIONS:

Art. 4.000. Sec. 4.32.G (Telephone Exchange).

DATE OF PUBLIC NOTICE:

June 3 & 10, 1997

DATE OF PUBLIC HEARING:

June 18, 1997

MEMBERS OF THE BOARD:

Lauren Curry - Chairperson michael wiggins - vice Chair

Charles Pierce John O'Connell Thomas Sieniewicz

ASSOCIATE MEMBERS:

šusan špuriock

Theodore Hartry Arch Horst

Laura Kershner James Danieł

David Gray Hanson

Marc Truant

Members of the Board of Zoning Appeal heard testimony and viewed materials submitted regarding the above request for relief from the requirements of the Cambridge Joning Ordinance.

The Board is familiar with the location of the potitioner's property, the layout and other characteristics as well as the surrounding district.

NSD 18/82/97 12:11:22

BK 27738 EG 053

Case No.: 7484

<u>Location:</u> 2067 Massachusetts Avenue <u>Petitioner:</u> Bell Atlantic Nynex Mobile

Paul J. Moriarty and Associates

On July 31, 1997, Attorney Paul Moriarty, Tony Befera, Bell Atlantic NYNEX Mobile, Peter Lew, Bell Atlantic, Mark Moriarty, of Paul J. Moriarty and Associates, appeared before the Board of Zoning Appeal seeking a special permit to establish a telephone exchange use (cellular communications) on the roof of an existing building with equipment shelter and roof antennas at 2067 Massachusetts Avenue. The applicants submitted plans, drawings and photographs detailing the proposed project.

At the June 19, 1997 BZA hearing, the petitioner requested that the case be continued until the next available date, July 31, 1997, so that the petitioner would be able to meet with North Cambridge Stabilization Committee to discuss the proposal.

At the July 31st hearing, Mr. Befera stated that Bell Atlantic NYNEX Mobile proposes to install a telephone exchange use as cellular communications on the roof of an existing building with equipment shelter and roof antennas at 2067 Massachusetts Avenue. He stated that the communication facility consists of a switch building that houses all the switching equipment, and panel antenna attached to a screen, which is proposing to enclose all of the equipment on the roof. He stated that the existing elevated penthouse, the existing cooling towers are in addition to the switch building and that the panelling antennae will be mounted to that screen and painted to match the screen. He further stated that the screen is to be extended around the entire perimeter and the existing roof so as to improve the sight lines of the installation, rather than having them broken up and that this screen is upon the request of the Planning Board. He indicated that this proposal provides a valuable service in private and public sectors and that the site has been designed with the help of the Planning Board to minimize the visual impact on the property and the surrounding area.

The Chair read into the record a letter, dated July 23, 1997, from Bell Atlantic from the Executive Office of Health and Human Services, Department of Public Health, Radiation Control Program. "Pursuant to your notification, of July 11, 1997, this is to advise you that approval, under Provisions of 105 CMR 122.021 has been granted to maintain the cellular facility at 2067 Massachusetts Avenue in Cambridge."

The Chair read into the record a letter to the business at Finnegan's Wake, dated July 17, 1997, regarding a complaint about the operation of the restaurant. He also read into the record a letter signed by Anne Kim, Hadley Street Representative; Jan Corash, Orchard Street Representative; and Gerald Sellier, Russell Street Representative, dated June 1, 1997, regarding various problems with the management site for over a year.

₩27738 # 054

Anne Kim, of 22 Hadley Street, stated that the property at 2067 Massachusetts Avenue has fallen into disrepair and that there is noise and drunken behavior from the parking lot. She stated that she is opposition to the proposal and she submitted to the file a petition including 112 people opposing the proposal. Joseph, Chair of the North Cambridge Stabilization Committee stated that he has three issues. The first issue is the historic aspect of the building, since it is on the National Historic Register and that this building will be affected by this proposal. The second that the North Cambridge Stabilization Committee voted unanimously to oppose this petition and that this project would not benefit the community from the point of view of the abutters. last issue is the health point due to the latest research of harmful public exposure to pulse microwave transmissions. He submitted an article from Microwave News published in Australia. Mr. Donald Haes, a consultant for Bell Atlantic stated that the Department of Public Health agrees with the limits that have been set by the Radiation Control Board and that this site would be in full compliance with the FCC.

Mr. Mark Moriarty read into the record a letter, dated July 14, 1997, from Charles M. Sullivan, Executive Director of the Cambridge Historical Commission, which stated:

"As we discussed last week, the Cambridge Historic Commission has no jurisdiction over the structure at 2067 Massachusetts Avenue.

However, this building is listed on the National Register of Historic Places. Telecommunication installations are licensed by the FCC, and under Section 106 of the National Historic Preservation Act of 1966 the Massachusetts Historic Commission must conduct a review to determine whether the proposed installation will have an effect on the historic character of the structure.

While the Cambridge Historical Commission has no actual jurisdiction, MHC often consults us on these matters. If you send the installation plans, I will review them and be prepared if they call."

The Chair moved that the special permit to establish a telephone exchange use for a cellular communications of the roof of the existing building with equipment shelter and roof antennas at 2067 Massachusetts Avenue be granted on the following conditions: 1) that the color of the surrounding fence that is going to be established, be a darker color consistent with the building, be subject to review and approval of the Historic Commission as to the color; 2) that if feasible the cooling tower color also match the surrounding fence, without substantially affecting the efficiency of the cooling towers; 3) that the petitioner obtain the approval of the Massachusetts Historic Commission for the installation; and 4) that there be no increase in the capacity of the system without going beyond what is going to be installed without further approval. Four members of the Board voted to grant the special permit, while one member abstained. Thus, the variance was granted.

BK 27738 10055

The Board based the decision upon the above findings and upon the following:

- 1) The meeting of the requirements of the Ordinance;
- 2) Traffic generated or patterns of access or egress would not cause congestion, hazard, or substantial change in the established neighborhood character;
- 3) The continued operation of or the development of adjacent uses as permitted in the Ordinance would not be adversely affected by the nature of the proposed use;
- 4) Nuisance or hazard would not be created to the detriment of the health, safety and/or welfare of the occupants of the proposed use, and;
- 5) The proposed use would not impair the integrity of the district or adjoining district or otherwise derogate from the Ordinance, and in fact be a significant improvement to the structure and benefit the neighborhood.

The Board of Zoning Appeal is empowered to waive local zoning regulations only. This decision therefore does not relieve the petitioner in any way from the duty to comply with local ordinances and regulation of other local agencies, including, but not limited to the Historical Commission, License Commission and/or compliance with requirements pursuant to the Building Code and other applicable codes.

Michael Wiggins, Vice-Chair

CITY OF CAMBRIDGE

NARRATIVE IN SUPPORT OF APPLICATION FOR MODIFICATION TO SPECIAL PERMIT

APPLICANT: Cellco Partnership d/b/a Verizon Wireless

SITE ADDRESS: 2067 Massachusetts Avenue

Cambridge, Massachusetts

ASSESSOR'S LOT I.D.: Map 181, Lot 88

ZONING DISTRICT: Business A-2 (BA-2)

BACKGROUND

This Narrative in Support of an Application for modification to a Special Permit, while reserving all rights, to modify an existing building mounted mobile communications facility ("Facility") is respectfully submitted by Cellco Partnership d/b/a Verizon Wireless ("Verizon Wireless") to the City of Cambridge, Board of Zoning Appeal ("Board"). Verizon Wireless seeks approval to further modify its existing Facility on the existing building at 2067 Massachusetts Avenue (the "Property").

This application is submitted with full reservation of Verizon Wireless' rights including without limitation Section 6409(a) of the federal Middle Class Tax Relief and Job Creation Act of 2012 also referred to as the "Spectrum Act." The Spectrum Act was passed to "advance wireless broadband service" for both public safety and commercial purposes. The modification to the existing Facility satisfies the standards for the modification of an eligible facility under the Spectrum Act.

APPLICANT'S INTEREST IN THE PROPERTY

Henderson Carriage Limited Partnership ("Owner") and Cellco Partnership d/b/a Verizon Wireless entered into a certain Lease Agreement by which Owner leased to Verizon Wireless building space and access/utility easement rights on a portion of the Owner's property located at 2067 Massachusetts Avenue being shown on Tax Map of the City of Cambridge at Map 181, Lot 88 for the location of Verizon Wireless' antennas and space for its equipment.

See Exhibit 1, ZBA Application Form - Ownership Information.

PROJECT DESCRIPTION

As noted on the attached plans and described in this application, the building owned by Henderson Carriage Limited Partnership is a 5-story brick building used for retail/office purposes (the "Building"). Verizon Wireless has installed and operates an existing Facility consisting of 3 sectors of 4 antennas each (12 in total) and equipment shelter on the rooftop of the Building. The existing antennas are installed in 3 separate sectors on the rooftop.

Facility Modification Details Total of Fifteen (15) Antennas with Remote Radio Heads

Verizon Wireless proposes to rooftop mount a total of fifteen (15) antennas through the relocation of six (6) antennas to three (3) new proposed side by side mounts and relocation of three (3) existing antennas to existing pipe mounts, installation of three (3) new antennas on existing pipe mounts and retaining three (3) existing antennas installed at the current location on pipe mounts as follows:

(a) Alpha Sector

Relocate two (2) antennas to new proposed side by side mount and relocate one (1) existing antenna to existing pipe mount, install one (1) new antenna on existing pipe mount and retain one (1) antenna installed at its current location on pipe mount on the rooftop penthouse. Total: 5 antennas and 2 remote radio heads. – *See Roof Plan Sheet C-1*.

(b) Beta Sector

Relocate two (2) antennas to new proposed side by side mount and relocate one (1) existing antenna to existing pipe mount, install one (1) new antenna on existing pipe mount and retain one (1) antenna installed at its current location on pipe mount on the existing rooftop antenna frame. Total: 5 antennas and 2 remote radio heads. – *See Roof Plan Sheet C-1*.

(c) Gamma Sector

Relocate two (2) antennas to new proposed side by side mount and relocate one (1) existing antenna to existing pipe mount, install one (1) new antenna on existing pipe mount and retain one (1) antenna installed at its current location on pipe mount on the rooftop existing antenna frame. Total: 5 antennas and 2 remote radio heads. – *See Roof Plan Sheet C-1*.

See Exhibit 2, Plans. See Exhibit 3, Photo Simulations

SATISFACTION OF ELIGIBLE FACILITIES REQUEST STANDARDS

On February 22, 2012, President Obama signed into law H.R. 3630, known as the "Middle Class Tax Relief and Job Creation Act of 2012," which then became Public Law 112-96 ("P.L. 112-96"). Section 6409(a) of P.L. 112-96 adds new language to the existing body of laws, regulations, and decisions pertaining to wireless facility zoning.²

Verizon Wireless respectfully submits the proposed modifications satisfy the standards for an eligible facility request pursuant to 47 U.S.C. §1455 and 47 C.F.R. §1.6100. In an effort to advance Congress' goal of facilitating the rapid deployment of qualified modifications, the Federal Communications Commission adopted rules in 2014 that clarified many of the terms of Section 6409(a). The Commission stated that the purpose of implementing the rules "will serve the public interest by providing guidance to all stakeholders on their rights and responsibilities under the provision, reducing the delays in the review process for wireless infrastructure modifications, and facilitating the rapid deployment of wireless infrastructure, thereby promoting the advanced wireless broadband services."

47 U.S. Code §1455(a) and 47 C.F.R. §1.6100(b) builds on the existing legal framework for wireless facilities by requiring permitting authorities to approve an eligible facilities request in an effort to streamline "the process for siting of a wireless facility by preempting the ability of State and local authorities to delay collocation of, removal of, and replacement of wireless transmission equipment." "Collocation" is defined as "the mounting or installation of transmission equipment on an eligible support structure for the purpose of transmitting and/or receiving radio frequency signals for communications purposes." The term "eligible support structure" means any structure that is a "tower" or "base station." A "base station" is defined as a structure or equipment that enables

(a) FACILITY MODIFICATIONS.—

- (1) IN GENERAL.—Notwithstanding section 704 of the Telecommunications Act of 1996 (Public Law 104–104) or any other provision of law, a State or local government may not deny, and shall approve, any eligible facilities request for a modification of an existing wireless tower or base station that does not substantially change the physical dimensions of such tower or base station.
- (2) ELIGIBLE FACILITIES REQUEST.—For purposes of this subsection, the term "eligible facilities request" means any request for modification of an existing wireless tower or base station that involves—
 - (A) collocation of new transmission equipment;
 - (B) removal of transmission equipment; or
 - (C) replacement of transmission equipment.
- (3) APPLICABILITY OF ENVIRONMENTAL LAWS.—Nothing in paragraph (1) shall be construed to relieve the Commission from the requirements of the National Historic Preservation Act or the National Environmental Policy Act of 1969.

¹ Middle Class Tax Relief and Job Creation Act of 2012, Pub L. No. 112-96, 126 Stat. 156 (2012).

² Section 6409(a) states:

³ See Accelerating of Broadband Deployment by Improving Wireless Facilities Siting Policies, Report and Order, 29 FCC Rcd 12865 (2014) ("2014 Order").

⁴ Id. At 12872.

⁵ 158 Cong. Rec. E237 (daily ed. Feb. 24, 2012) (statement of Rep. Upton).

Commission-licensed or authorized wireless communications and includes any structure other than a tower that supports or houses permitted equipment used for wireless communications services.⁶ The term "eligible facilities request" includes any request for modification of an existing wireless tower or base station that involves— (i) collocation of new transmission equipment; (ii) removal of transmission equipment; or (iii) replacement of transmission equipment.⁷

The Property constitutes a "base station" and an "eligible support structure" in that it currently exists and "supports and houses" wireless communication equipment that has been reviewed and approved under the City's zoning ordinance. The proposed modification to the Verizon Wireless antennas on the Property for the purpose of transmitting and receiving radio frequency signals for communication purposes constitutes a "replacement of transmission equipment" and the proposed addition of antennas is the "collocation of new transmission equipment."

Federal authorities clearly provide that an eligible facilities request must be approved if the installation does not result in a substantial change. The proposed modifications to the existing Verizon Wireless facility is an "eligible facilities request." Through its statutory mandate and given the lack of statutory definitions, the Federal Communications Commission has defined a substantial change under Section 6409(a) as follows:

- (i) For other eligible support structures (i.e., the "Building"), it increases the height of the structure by more than 10% or more than ten feet, whichever is greater There will be no increase in height. The relocated and proposed antennas will not be any higher.
- (ii) For other eligible support structures (i.e., the "Building"), it involves adding an appurtenance to the body of the structure that would protrude from the edge of the structure by more than six feet The proposed additional and relocated antennas will not protrude more than six feet from the ballasts.
- (iii) For any eligible support structure (i.e., the "Building"), it involves installation of more than the standard number of new equipment cabinets for the technology involved, but not to exceed four cabinets; or, it involves installation of any new equipment cabinets on the ground if there are no pre-existing ground cabinets associated with the structure The proposed modification does not involve the installation of new cabinets. All radio equipment will remain at the current location.
- (iv) It does not entail any excavation or deployment outside the current site The modification does not involve any excavation or deployment outside the current site.
- (v) It would not defeat the concealment elements of the eligible support structure **Verizon Wireless' modifications do not defeat any concealment elements as the**

⁶ 47 C.F.R. §1.6100(b)(1)

⁷ 47 U.S.C. § 1455(a)(2) and §1.6100(b)(3)

⁸ See 47 U.S.C. §1455(a) and 47 C.F.R. §1.6100(b)

relocated and new antennas mounted at the same location and height as the existing antennas.

(vi) It complies with conditions associated with the siting approval – **The** installation will remain compliant.

It is clear that state and local authorities have no power to deny a complying installation, and any attempt to do so would be in direct conflict with federal law. Having satisfied the standards for the modification of an eligible support structure that will not result in a substantial change, the Board may not deny the Section 6409(a) Modification. Consistent with that determination, the permitting is limited to non-discretionary permitting related to applicable building, structural and electrical codes. Additionally, when an applicant asserts in writing that a request for a modification is covered by this section, a State or local government may only require the applicant to provide documentation or information to the extent reasonably necessary to determining whether the request meets the requirements for an eligible facilities request. Further, the Federal Communications Commission also adopted rules that require local review subject to Section 6409(a) be completed within sixty (60) days. A Section 6409(a) request will be "deemed granted" if not approved within the sixty (60) day period.

SATISFACTION OF SPECIAL PERMIT REVIEW STANDARDS

Based on the description set forth herein, and as will be further demonstrated at the Public Hearing on this matter, the proposed modification of the Facility meets the location, height and site requirements of Section 4.32(g)(1), Section 4.40 (footnote 4) and Sections 10.40 - 10.46. Pursuant to Ordinance, the modification of the Facility is allowed upon the grant of a special permit from the Zoning Board of Appeals in the currently designated BA-2 zoning district.

While reserving all rights, Verizon Wireless' modification satisfies the standards set forth in Section 4.40 (footnote 4) and Sections 10.40 – 10.46 of the City of Cambridge, Zoning Ordinance.

1. The scope of or limitations imposed by any license secured from any state or federal agency having jurisdiction over such matters — **Verizon Wireless operates in compliance** with all of the rules and regulations promulgated by the Federal Communications Commission as required by its licensing.

See Exhibit 4, FCC License to Operate.

2. The extent to which the visual impact of the various elements of the proposed facility is minimized: (1) Through the use of existing mechanical elements on a building's roof or other features of the building as support and background, (2) Through the use of materials that in texture and color blend with the materials to which the facilities are attached, or (3) Other effective means to reduce the visual impact of the facility from off the site - Verizon Wireless proposes to mount a total of fifteen (15) antennas to the 3 existing mounts.

3. Where it is proposed to erect such a facility in any residential zoning district, the extent to which there is a demonstrated public need for the facility at the proposed locations, the existence of alternative, functionally suitable sites in nonresidential locations, the character of the prevailing uses in the area, and the prevalence of other, existing mechanical systems and equipment carried on or above the roof of nearby structures. The Board of Zoning Appeal shall grant a special permit to erect such a facility in a residential zoning district only upon a finding that nonresidential uses predominate in the vicinity of the proposed facility's location and that the telecommunication facility is not inconsistent with the character that does prevail in the surrounding neighborhood – The wireless use and modification of the Facility is consistent with the purpose of the Business A-2 District.

The proposed modification also satisfies the standards of Section 10.43 of the Ordinance for the grant of special permits. As noted above, the proposed modification will allow Verizon Wireless to improve wireless signal coverage and is an integral part of Verizon Wireless' network design in the City of Cambridge. The modification of the equipment detailed herein will aid in reaching Verizon Wireless' goal to provide enhanced service and communications in the City of Cambridge. The proposed modification will generate no traffic or other negative impacts on surrounding properties or the City of Cambridge. The Facility

requires no water or sewer services. The utilities will continue to be obtained from existing service. The Facility will continue to be unoccupied, with no employees or customers. The Facility will continue to be regularly maintained by qualified technicians to assure that the equipment operates at optimal condition so that no threat of explosion, fire or other danger to life or property occurs. Reliable wireless service also enhances community safety, because it is used by public safety officials as well as the public in times of crisis, natural disaster, inclement weather and similar circumstances.

It is a truism to state that it is absolutely essential that there is the necessary infrastructure to ensure access to reliable wireless services. The ability to utilize mobile devices has become so integral that the absence of reliable service certainly has a negative impact. The availability of reliable wireless service also provides greater access to 911 emergency services. Maintaining wireless service provides another tool for ensuring that emergencies can be reported as quickly as possible, which reduces the response times of public safety personnel.

Because the application is for the modification of equipment that provides wireless services, the proposal is subject to §704 of the federal Telecommunications Act of 1996 ("TCA"), codified at 47 U.S.C. §332(c)(7)(B). By way of background, the TCA is a federal law enacted in 1996 whose purpose is "[t]o promote competition and reduce regulation in order to secure lower prices and higher quality services for American telecommunications consumers and encourage the rapid deployment of new telecommunications technologies." To further this purpose, the TCA established national standards that apply to permitting for wireless facilities. These standards preempt inconsistent state and local laws, so they must be considered in making decisions related to wireless facilities.

The proposed modification of the existing Facility satisfies the criteria for granting a special permit, Verizon Wireless respectfully requests that the Board grant a special permit to modify the existing facility to allow for the proposed upgrade of this existing mobile communications system.

CONCLUSION

The availability of wireless communications service enhances community safety, and is increasingly relied upon by civil defense and other safety officers as well as the general public in times of crisis, natural disaster, bad storms or similar circumstances. Wireless communications service also provides a convenience to residents, and is an attractive feature and service to businesses. The proposed modification, by providing these services, will promote the health, safety, convenience and general welfare of the inhabitants of the City of Cambridge.

In compliance with Section 6409(a) of the federal Middle Class Tax Relief and Job Creation Act of 2012, the proposed modification constitutes an eligible facilities request entitled to approval. In the alternative, with all rights reserved, the proposed modification meets all the standards for a special permit pursuant to the City's Zoning Ordinance. Verizon Wireless respectfully requests that the Board vote to grant a special permit and any other relief pursuant to the City of Cambridge Zoning Ordinance, Massachusetts General Laws chapter 40A, and, the federal Telecommunications Act of 1996.

2067 Mass Avenue 182-41 182-57 182-42 182-69 17 Milton St 182-68 ROAD 38 Russell St 180-13 15 Milton St 18 Milton St 182-67 180-12 11 Milton St16 Milton St181-13 180-11 182-81 12 Milton St 83 Orchard St 181-12 180-10 181-11 26 Russell St 81 Orchard St 180-60 10 Milton St 181-206 'Aussell St 181-205 26 Russell St 180-9 181-204 9-B Russell St 79 Orchard St 77 Orchard St 181-14 9-A Russell St 20 Russell St 24 Russell St 180-55 75 Orchard St 181-65 181-203 9 Russell St ROAD 181-202 181-44 181-190 181-195 84 Orchard St. 181-201 18 Russell St 80 Orchard St 181-200 181-199 76 Orchard St 180-65 78 Orchard St 181-198 181-197 181-76 181-63 74 Orchard St 181-41 7 Russell St 181-196 181-64 10 Russell St 181-70 181-189 66 Orchard St 2131 Massachusetts Ave 68 Orehard St181-71 181-40 8 Russell 9 64 Orchard St 1 Russell St 181-72 6-B Russell St 6 Russell St adley St 181-84 4-B Russell St 4-A Russell 81₁₈₁₋₃₈ 181-67 2 Russell St 181-88 8 Hadley St Massachusetts Ave 181-20 Coosnell Ave 181-29 2103 Massachusetts Ave 22 Hadley St 199-32 2151 Massachusetts Ave 181-21 18 Hadley 3(181-28 2100 Massa busetts Ave 181-22 181-27 2067 Massachusetts Ave Hadleyst 21 Blake St 199-90 2005 Massachusetts Ave 181-23 2098 Massachusetts Ave 4 Cogswell Ave 15 Blake St 2096 Massachusetts Ave 2094-B Massachusetts Ave 2094 Massachusetts Ave 181-79 7 Blake St 2090 Massachusetts Ave 181-54 199-89 5 Blake St 2088 Massachusetts Ave 199-67 181-80 16 Blake S 181-53 Blakest 2072 Massachusetts Ave 199-152 5 Walden St 199-153 2050 Massachusetts Ave Massachusetts Ave 181-52 11 Walden St 200-22 2029 Massachusetts Ave 199-86 17 Walden St15 Walden St 2046 Massachusetts Ave 181-207 200-90 2044 Massachusetts Ave 1 Houston Pk 12 Walden St 199-120 199-112 19 Walden St 200-91 2038 Massachusetts Ave 200-79 4 Walden St 2036 Massachusetts Ave 2032 Massachusetts Ave 200-74 200-88 200-68 2030 Massachusetts Ave 199-113 200-81

2067 Mass Ave

199-67
COLANNINO, JOSEPH A., FRANCIS X., ROBERT ANTHONY J., MARIAN L. & MARIA C.
C/O RIVERSIDE MANAGEMENT
P.O.BOX 440317
W.SOMERVILLE, MA 02144

181-38 CHARLES, AMOS M.D. 2B RUSSELL STREET UNIT #3 CAMBRIDGE, MA 02139

181-72 HALL, ELIZABETH MEGAN & HONOR MACNAUGHTON 68 ORCHARD ST CAMBRIDGE, MA 02140

181-76 7 RUSSELL STREET INVESTMENTS, LLC 175 PALMER ST ARLINGTON, MA 02474

181-28 BOGSTAD, WILLIAM J. & LENORE J. COWEN 22 HADLEY STREET CAMBRIDGE, MA 02140-1305

181-42 & 26-F-4 IKELS, FREDERICK B. 7 PEPPERBUSH COURT GRAFTON, MA 01536

181-80
CHRISTOS POUTAHIDIS MANAGEMENT, LLC.
C/O HESS REALTY LLC,
PROPERTY TAX DEPT.
539 SOUTH MAIN ST
FINDLAY, OH 45840

181-40 VICTORY PROGRAMS, INC 965 MASS AVE BOSTON, MA 02118

199-90 JEFF-WILL CAMBRIDGE LLC 3 WINTHROP CIRC WESTON, MA 02493

181-37 JOHNSON, STEVEN A 2103 MASSACHUSETTS AVE #5 CAMBRIDGE, MA 02140 181-38
AE&A REALTY TRUST, AMOS CHARLES TRUSTEE

AE&A REALTY TRUST, AMOS CHARLES TRUST 2107 MASSACHUSETTS AVE CAMBRIDGE, MA 02139

181-44 & 26-F-2 OLSON, EVAN & ELIZABETH OLSON 24 RUSSELL ST CAMBRIDGE, MA 02140-1314

181-88 HENDERSON CARRIAGE LIMITED PARTNERSHIP C/O H.J. DAVIS DEVELOPMENT TRUST 125 HIGH STREET 21ST FL BOSTON, MA 02110

181-190 CASPAR, INC. 66 CANAL ST BOSTON, MA 02114

181-29 SCHULMAN, JOHANNA & MOIRA S. BARRETT 28 HADLEY ST CAMBRIDGE, MA 02140-1305

181-70 AYOUB, NANCY 74 ORCHARD STREET CAMBRIDGE, MA 02140

200-22 CC HRE 2072 MASS AVE LLC C/O CAPSTONE COMMUNITIES LLC PO BOX 610083 NEWTON HIGHLANDS, MA 02461

181-63 HUNZIKER, SUSAN M. 82 ORCHARD ST CAMBRIDGE, MA 02140

181-37 SAAD, LEONIDE C. 2103 MASS AVE., #1 CAMBRIDGE, MA 02140

181-37 SHIBABW, EYOB, A. & BETELEHEM MELAKU 2103 MASSACHUSETTS AVE., #8 CAMBRIDGE, MA 02140 181-64 DAHL, KATHRYN & STEPHEN FEIGE 76 ORCHARD ST CAMBRIDGE, MA 02140

DUVAL & KLASNICK LLC

BOXFORD, MA 01921

P.O BOX 254

C/O DANIEL D. KLASNICK, Esq.

181-27 HEAFITZ, ANDREW & ALISON HYND 18 HADLEY ST CAMBRIDGE, MA 02140

181-14 & 26-F-1 LEVINE, ELLIOT R. & FANYA S. SVERDLOV 26 RUSSELL ST CAMBRIDGE, MA 02140

181-41 & 26-F-5 HARP, DENNIS R. & DOMINIQUE Q. PHAM 16 RUSSELL ST CAMBRIDGE, MA 02140

181-76 7 RUSSELL STREET INVESTMENTS, LLC 175 PALMER ST ARLINGTON, MA 02474

200-90 CAMBRIDGE HOUSING AUTHORITY 675 MASSACHUSETTS AVE CAMBRIDGE, MA 02139

181-76 LYONS BROTHERS INVESTMENTS, LLC 175 PALMER ST ARLINGTON, MA 02474

181-37 JONES, CHRISTOPHER G. & REBECCA LOH 2103 MASS AVE. UNIT#9 CAMBRIDGE, MA 02140

181-38 HENDRICKSON, CAROL C. 2A RUSSELL STREET CAMBRIDGE, MA 02140 2067 Kass Are

181-38 CHATURVEDI SAUMYA ALVER BURAK HAN 4A RUSSELL ST - UNIT 4 CAMBRIDGE, MA 02140

181-39 DOAN, JOHN D. & ANNE M. QUE 8 RUSSELL ST., #1 CAMBRIDGE, MA 02139

181-43 & 26-F-3 THOMPSON, MARYANN & ROSENTHAL MORTON 20 RUSSELL ST CAMBRIDGE, MA 02140

181-15 BERDAN MICHAEL A CORASH JANET E TRS 84 ORCHARD ST CAMBRIDGE, MA 02140

181-37 JAS HOMEOWNERSHIP LLC C/O JST A START CORPORATION 1035 CAMBRIDGE ST #12 CAMBRIDGE, MA 02141-0003 181-37 FUENTES, CARLOS 2103 MASSACHUSETTS AVE., #6 CAMBRIDGE, MA 02140

181-39 PADOVANI, JOEL 8 RUSSELL ST. UNIT#3 CAMBRIDGE, MA 02139

181-38 HERSKOVITZ, BARTON S. & JUDITH R. SOKOL TRSTEES OF THE JUDITH R. SOKOL LIV TRT 6B RUSSELL ST CAMBRIDGE, MA 02140

181-38 6A ASSOCIATES LLC 164 PLEASANT ST ARLINGTON , MA 02476

26-G-8 RUSSELL STREET REALTY LLC 75 CAMBRIDGE PARKWAY #100 CAMBRIDGE, MA 02142 181-37 GRECO, KIRSTEN A. 2103 MASS AVE. UNIT#2 CAMBRIDGE, MA 02140

181-39 DOAN, JOHN D. & ANNE M. QUE 8 RUSSELL ST., #2 CAMBRIDGE, MA 02140

181-84
TUNG YUAN SHION, & SHU-LIN TUNG
TRS YUAN SHION TUNG TR ET AL
31 HADLEY ST
CAMBRIDGE, MA 02140

181-38
BACHER, JUDITH A.
TR. OF THE JUDITH A. BACHER REVOC TRT
4B RUSSELL ST UNIT 5
CAMBRIDGE, MA 02140

26-G-7 JOAN N. WATTMAN 21 RUSSELL STREET SOMERVILLE, MA 02144

CHESTERST ŀ 1 · 10 -THE REAL PROPERTY. B DROVE ST BOWERS AVE MILTON ST n Zit 12 1: 1170 14 Assessors Map City of
Somerville
Massachusetts

Location 17 RUSSELL ST Mblu 26/ G/ 8/ /

Acct# 02078014

RUSSELL STREET REALTY LLC Owner

Assessment \$1,754,400 PID 265

Building Count 1

Current Value

Assessment				
Valuation Year Improvements Land Total				
2021	\$552,300	\$1,202,100	\$1,754,400	

Owner of Record

Owner

RUSSELL STREET REALTY LLC

Sale Price Certificate \$100

Building Photo

Co-Owner Address

75 CAMBRIDGE PARKWAY #100

CAMBRIDGE, MA 02142

Book & Page 64347/318

Sale Date 10/09/2014

Instrument

1F

Ownership History

Ownership History						
Owner	Sale Price	Certificate	Book & Page	Instrument	Sale Date	
RUSSELL STREET REALTY LLC	\$100		64347/ 318	1F	10/09/2014	
LAVERTY CHARLES JR &	\$178,910		22780/ 333	L	12/30/1992	
FESSENSEN REALTY	\$0					

Building Information

Building 1: Section 1

Year Built:

1900

Living Area:

2,459

Replacement Cost:

\$793,060

Building Percent Good:

69

Replacement Cost

Less Depreciation:

\$547,200

Building Attributes		
Field Description		
Style	Conventional-Apts	
Model	Residential	

file:///C:/Users/mpacheco/AppData/Local/Temp/Low/UQZ0GPLQ.htm

Location 21 RUSSELL ST Mblu 26/ G/ 7/ /

Acct# 03120168 WATTMAN JOAN N

Assessment \$1,522,200 PID 5051

Building Count 1

Current Value

Assessment					
Valuation Year Improvements Land Total					
2021	\$618,100	\$904,100	\$1,522,200		

Owner of Record

Owner

WATTMAN JOAN N

Co-Owner Address

21 RUSSELL ST

SOMERVILLE, MA 02144

Sale Price

Certificate

Book & Page 49516/558

Sale Date

05/30/2007

\$811,890

Instrument 1N

Ownership History

Ownership History						
Owner Sale Price Certificate Book & Page Instrument Sa						
WATTMAN JOAN N	\$811,890		49516/ 558	1N	05/30/2007	
OHMART KEITH R & CHEN H ETAL TRSTEES	\$100		49163/ 510	1F	03/23/2007	
OHMART KEITH R	\$100		39998/ 491	1A	07/17/2003	
CHEN HELEN	\$45,000		13380/ 246			

Building Information

Building 1: Section 1

Year Built:

1920

Living Area:

3,837

Replacement Cost:

\$881,716

Building Percent Good:

Replacement Cost

Less Depreciation:	\$599,600		
	Building Attributes		
Field Description			
Style	Two Family		

Building Photo

Location 26 RUSSELL ST

Mblu 26/ F/ 1//

Acct# 15512150

Owner LEVINE ELLIOT &

Assessment \$363,000

PID 5040

Building Count 1

Current Value

Assessment				
Valuation Year	Improvements	Land	Total	
2021	\$65,100	\$297,900	\$363,000	

Owner of Record

Owner

LEVINE ELLIOT &

Co-Owner Address SVERDLOV FANYA

CAMBRIDGE, MA 02140

26 RUSSELL ST

Sale Price

Certificate

\$325,000

Book & Page 22882/ 015

Sale Date 02/08/1993

Instrument G

Ownership History

Ownership History					
Owner	Sale Price	Certificate	Book & Page	Instrument	Sale Date
LEVINE ELLIOT &	\$325,000		22882/ 015	G	02/08/1993
CASENDINO	\$0				

Building Information

Building 1: Section 1

Year Built:

1920

Living Area:

3,184

Replacement Cost:

\$803,528

Building Percent Good: Replacement Cost

Less Depreciation:

\$56,200

Building Attributes			
Field Description			
Style	Mansard		
Model	Residential		
Grade:	Average +10		

Building Photo

Location 24 RUSSELL ST

Mblu 26/ F/ 2/ /

Acct# 06247010

Owner OLSON EVAN E & ELIZABETH

Assessment \$469,600

PID 5041

Building Count 1

Current Value

Assessment					
Valuation Year Improvements Land Total					
2021	\$172,200	\$297,400	\$469,600		

Owner of Record

Owner

OLSON EVAN E & ELIZABETH

Sale Price

\$1,440,000

Co-Owner Address

24 RUSSELL ST

CAMBRIDGE, MA 02140

Certificate

Book & Page 48134/ 274

Sale Date

09/07/2006

Instrument 1G

Ownership History

Ownership History					
Owner	Sale Price	Certificate	Book & Page	Instrument	Sale Date
OLSON EVAN E & ELIZABETH	\$1,440,000		48134/ 274	1G	09/07/2006
SKANDALIS BETTE	\$509,500		25615/ 037	1G	08/30/1995
SEIFER A & DIENSTAG	\$0		_		

Building Information

Building 1: Section 1

Year Built:

1895

Living Area:

2,996

Replacement Cost:
Building Percent Good:

\$902,396 19

Replacement Cost

Less Depreciation:

\$171,500

Less Depreciation.	φ17 1,300			
Building Attributes				
Field	Description			
Style	Conventional			
Model	Residential			

Location 20 RUSSELL ST Mblu 26/ F/ 3/ /

08310201 Acct#

Owner **THOMPSON MARYANN &**

ROSENTHAL MORTON H

Assessment \$752,800 PID 5042

Building Count

Current Value

Assessment					
Valuation Year Improvements Land Total					
2021	\$390,400	\$362,400	\$752,800		

Owner of Record

Owner Co-Owner THOMPSON MARYANN & ROSENTHAL MORTON H

Sale Price \$990,000

Certificate

Address 20 RUSSELL ST Book & Page

CAMBRIDGE, MA 02138

Sale Date 02/21/2013

253366

Building Photo

Instrument

1G

Ownership History

Ownership History					
Owner	Sale Price	Certificate	Book & Page	Instrument	Sale Date
THOMPSON MARYANN & ROSENTHAL MORTON H	\$990,000		253366	1G	02/21/2013
HAZLETT ROBERT M & MARIE E	\$0				

Building Information

Building 1: Section 1

Year Built:

1897

Living Area:

2,811

Replacement Cost:

\$845,229 46

Building Percent Good:

Replacement Cost Less Depreciation:

\$388.800

Ecoo Depicolation.	4000,000	
Building Attributes		
Field	Description	
Style	Conventional	
Model	Residential	

Location 18 RUSSELL ST

Mblu 26/ F/ 4/ /

Acct# 09329035

Owner IKELS FREDERICK B

Assessment \$663,000

PID 5043

Building Count 1

Current Value

Assessment					
Valuation Year Improvements Land Total					
2021	\$280,300	\$382,700	\$663,000		

Owner of Record

Owner

IKELS FREDERICK B

Sale Price

\$100

Co-Owner Address

7 PEPPERBUSH ST

Certificate

Book & Page 35535/ 094

NORTH GRAFTON, MA 01536

Sale Date 0

05/24/2002

Instrument 1F

Ownership History

Ownership History					
Owner	Sale Price	Certificate	Book & Page	Instrument	Sale Date
KELS FREDERICK B	\$100		35535/ 094	1F	05/24/2002
IKELS CARL A	\$0				

Building Information

Building 1: Section 1

Year Built:

1890

Living Area:

3,160

Replacement Cost:

\$680,141 41

Building Percent Good: Replacement Cost

Less Depreciation:

\$278,900

Building Attributes			
Field Description			
Style	Two Family		
Model	Residential		
Grade:	Average +5		

Building Photo

Location 16 RUSSELL ST

Mblu 26/ F/ 5/ /

Acct# 19651026

Owner HARP DENNIS R &

Assessment \$859,800

PID 5044

Building Count 1

Current Value

Assessment					
Valuation Year Improvements Land Total					
2021	\$424,700	\$435,100	\$859,800		

Owner of Record

Owner

HARP DENNIS R &

Co-Owner Address PHAM DOMINIQUE Q 16 RUSSELL ST

NO CAMBRIDGE, MA 02140

Sale Price

\$323,000

Certificate

Book & Page 23814/ 034

Sale Date

10/26/1993

Instrument

00

Building Photo

Ownership History

Ownership History					
Owner	Sale Price	Certificate	Book & Page	Instrument	Sale Date
HARP DENNIS R &	\$323,000		23814/ 034	00	10/26/1993
STRYKER LILLIAN I	\$28,000		12932/ 582		01/19/1976

Building Information

Building 1 : Section 1

Year Built:

1920

Living Area:

3,278 \$738,849

Replacement Cost:
Building Percent Good:

57

Replacement Cost

Less Depreciation:

\$421,100

Building Attributes	
Field	Description
Style	Two Family
Model	Residential
Grade:	Average +5