

# **CITY OF CAMBRIDGE**

**BOARD OF ZONING APPEAL** 

831 Massachusetts Avenue, Cambridge MAZBZLDEC -6 AM II: 53

617-349-6100

OFFICE OF THE CITY CLERK DAMBRIDGE, MASSACHUSETTS

#### **BZA Application Form**

**BZA Number: 154854** 

	<u>General</u>	<u>I Information</u>
The undersigned hereby petitions	the Board of Zoning	Appeal for the following:
Special Permit: X	Variance:	Appeal:
PETITIONER: GS 22 Water Stre	et Project Owner, LLC	2
PETITIONER'S ADDRESS: 300	Park Avenue, 12th Flo	oor, NY, New York City 10022
LOCATION OF PROPERTY: 22	<u> Water St , Cambridge</u>	<u>e, MA</u>
TYPE OF OCCUPANCY: Reside	ntial -Commercial	ZONING DISTRICT: PUD-6
REASON FOR PETITION:		
/Telecommunication Facility (and	enna)/	
DESCRIPTION OF PETITION	IER'S PROPOSAL:	
including small-scale antennas in attached with this application. The	four (4) locations on t e Applicant also propo	ommunications facility on the rooftop of the building by the rooftop of the building, as further described on the Plans, oses to install an equipment cabinet and power panel ening on the rooftop of the Building.
SECTIONS OF ZONING ORDINA	ANCE CITED:	
Article: 4.000 Section: 4.40 (	G.1 (Telecommunication Footnote 49 (Telecome) (Special Permit).	· · · · · · · · · · · · · · · · · · ·
	Original Signature(s):	(Petitioner (s) / Owner)  Adam F. Biallard of Pince Lobal tye for Starry (Print Name)
Date:	Address: Tel. No. E-Mail Address:	ONE International Place # 3700 Boston MA 02110 617-456-8153 abrailland & prince lobel.com


#### BZA APPLICATION FORM - OWNERSHIP INFORMATION

To be completed by OWNER, signed before a notary and returned to The Secretary of the Board of Zoning Appeals.

I/We GS 22 Water Street Project Owner, LLC
Address: 300 Park Avenue, 12th Floor New York, NY 10022
State that I/We own the property located at 22 Water Street , which is the subject of this zoning application.
The record title of this property is in the name of GS 22 Water Street Project Owner, LLC
*Pursuant to a deed of duly recorded in the date, Middlesex South
County Registry of Deeds at Book, Page; or
Middlesex Registry District of Land Court, Certificate No.
Book Page .
SIGNATURE BY LAND OWNER OR AUTHORIZED TRUSTEE, OFFICER OR AGENT*  *Written evidence of Agent's standing to represent petitioner may be requested.
Commonwealth of Massachusetts, County of Plymoth
this 9 of Norman, 20 2/, and made oath that the above statement is true.
this 9 of Norman, 20 0/, and made oath that the above statement is true.
And Notary
ANDREW R. TACCINI  Notary Public  My commission expire Commonwealth of Massachusetts (Notary Seal).

 If ownership is not shown in recorded deed, e.g. if by court order, recent deed, or inheritance, please include documentation.

My Commission Expires May 27, 2022

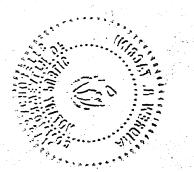

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NACOMY J. WEIGHT. Nesture Public Commonwheight of Mastrochuse May Committeen Espira. 1949 (27, 2022)

November 24, 2021

City of Cambridge Board of Zoning Appeals 831 Massachusetts Avenue Cambridge, MA 02139

Re:

Application for Special Permit

Property Address:

22 Water Street, Block 7, Lot 113 (the "Property")

Applicant:

Starry, Inc.

Dear Honorable Members of the Board of Zoning Appeals:

This firm represents Starry, Inc. ("Starry" or the "Applicant") in connection with an application for a special permit from the City of Cambridge Board of Zoning Appeals (the "Board"), to install a wireless communications facility on the Property. The Property is located in the PUD-6 zoning district, and pursuant to Article 4 Section 4.32G.1 of the City of Cambridge Zoning Ordinance (the "Ordinance"), the use of the Property for a wireless telecommunications facility is permitted by special permit from the Board. The Applicant's proposal satisfies the requirements for the grant of a special permit pursuant to Section 10-43 of the Ordinance.

The Applicant seeks to install and operate a wireless communications facility on the rooftop of the building by including small-scale antennas in four (4) locations on the rooftop of the building (the "Building"), as further described below and in the Plans, attached hereto and incorporated herein by reference (the "Plans"). The Applicant also proposes to install one (1) equipment cabinet and power panel that will be mounted to the base of the interior of the existing screening on the Building (the "Proposed Facility"). All visible antennas and supporting equipment will be painted to match the Building and the penthouse thereon.

#### I. Background

The Applicant is licensed by the Federal Communications Commission (the "FCC") to construct and operate a wireless communications broadband network in various markets throughout the country, including the Commonwealth of Massachusetts and in particular in the City of Cambridge. A copy of the Applicant's FCC license is attached hereto. The Applicant is in the process of designing and constructing a communications network to serve its customers, and one of the key design objectives of its systems is to provide seamless coverage. Starry's system operates on the 38.2 GHz and 38.6 GHz bands, and such a system requires a grid of

radio transmitting and receiving links located approximately .5 to 2 miles apart, depending on the location of existing and proposed installations in the surrounding area, the existing use of the network and the existing topography. This dynamic requires the antennas to be located in a location where the signal is not obstructed or degraded by other buildings or by topographical features such as hills.

#### II. Project Description

As noted above and as provided for in more detail on the Plans and on the Photograph Simulations, the Applicant proposes to install and operate a wireless telecommunications facility currently on the rooftop of the Building by installing twenty (20) small-scale antennas in four (4) locations on the rooftop of the Building. The average dimension of the proposed antennas is approximately 12-inches. The Applicant also proposes to install one (1) equipment cabinet that will be mounted to the base of the interior of the existing screening on the rooftop of the Building. As referenced on the attached Photograph Simulations, accompanying the Application, the antennas associated with the Applicant's Proposed Facility will extend above the height of the existing screening on the rooftop of the Building, and all visible antennas will be painted to match the Building and the screening thereon.

After installation, the Proposed Facility will be unmanned and will require infrequent maintenance visits. The only utilities required to operate this Proposed Facility are standard 120-volt electrical power as well as telephone service. These are presently in place at the Property. The traffic generated by the Proposed Facility will be less than two (2) vehicle trips per month by maintenance personnel who will inspect the Proposed Facility to ensure it remains in good working order. The Proposed Facility will comply with all applicable local, state and federal safety codes.

#### III. Legal Arguments

A. The Applicant complies with the Wireless Communications provisions set forth in Section 4.32(g), footnote 49 of the Ordinance

Pursuant to Section 4.32(g) of the Ordinance, the Applicant's proposed use for a wireless communications facility in the PUD-6 zoning district is permitted by special permit. The Applicant's Proposed Facility further complies with the provisions set forth in Section 4.32(g), footnote 49 of the Ordinance:

1. The Board of Zoning Appeal shall consider the scope of or limitations imposed by any license secured from any state or federal agency having jurisdiction over such matters.

Enclosed herewith is the Applicant's FCC license. The Applicant meets all requirements imposed by governmental authorities having jurisdiction over the Proposed Facility, including by the FCC, to provide wireless communications in this market area.

The intent of the U.S. Congress, when it enacted the Telecommunications Act of 1996 ("TCA") was to institute a framework to promote competition and innovation within the telecommunications industry. Under its license from the FCC, the Applicant is obligated to provide a reliable "product" (i.e. wireless communications service) to the population of the City of Cambridge. Likewise, consumer expectations for increasingly robust and reliable service requires competing service providers (including Starry) to identify and remedy existing gaps in reliable network coverage, or gaps that result from increasing subscriber voice and data traffic beyond the limits of existing network infrastructure. The Proposed Facility and corresponding relief requested are necessary to provide services to the Applicant's customers, as required by the FCC.

The Applicant investigated alternative sites in and around the defined geographic area within which its engineers determined that a facility must be located to provide service to its customers and to function effectively within its network of existing and planned facilities. This is an existing location that is being upgraded with new technology to provide the necessary coverage to the subject area of the City of Cambridge. Therefore, the Proposed Facility in the PUD-6 zoning district is necessary to provide service to the Applicant's customers, and is required to obtain the requested relief as a Special Permit to install and operate its wireless telecommunications facility.

2. The Board of Zoning Appeal shall consider the extent to which the visual impact of the various elements of the proposed facility is minimized: (1) through the use of existing mechanical elements on the building's roof or other features of the building as support and background, (2) through the use in materials that in texture and color blend with the materials to which the facilities are attached, or (3) other effective means to reduce the visual impact of the facility on the site.

The Applicant's Proposed Facility has a minimal visual impact on the existing facility and Building. The Proposed Facility will be installed on the rooftop of the Building and painted to match the existing color of the building.

As stated above, the Applicants submit that it has complied with all requirements, without waiving the argument that such relief is not required set forth in the Ordinance.

3. Where it is proposed to erect such a facility in any residential zoning district, the extent to which there is a demonstrated public need for the facility at the proposed locations, the existence of alternative, functionally suitable sites in nonresidential locations, the character of the prevailing uses in the area, and the prevalence of other existing mechanical systems and equipment carried on or above the roof of nearby structures. The Board of Zoning Appeal shall grant a special permit to erect such a facility in a residential zoning district only upon a finding that nonresidential uses predominate in the vicinity of the proposed facility's location and that the telecommunications facility is not inconsistent with the character that does prevail in the surrounding neighborhood.

The Applicant proposes to install its facility within the PUD-6 zoning district. To the extent that the City and the Board consider the PUD-6 a residential zoning district, the applicant provides that nonresidential uses predominate in this area. The Property and the Building thereon, are located adjacent to Route 28 and Monsignor O'Brien Highway, which is a major commercial and business thoroughfare in the City. Moreover, along Monsignor O'Brien Highway and to the south and west of the Building, there are numerous commercial and business uses. Also, the Massachusetts Bay Transpiration Authority industrial railway yard is directly to the North of the Building. Furthermore, there are numerous non-residential uses to the east of the Building.

The Applicant has design its proposal to conform to the characteristics of the building by installing the antenna mounts and supporting equipment behind the existing screen wall, and proposing to paint all visible antennas the color of the Building. Therefore, Applicant believes that nonresidential uses prevail in the vicinity of the Building and that the telecommunications facility is not inconsistent with the character that does prevail in the surrounding neighborhood.

- B. The Applicant complies with the Special Permit Criteria set forth in Section 10-43 of the Ordinance:
  - 1. The requirements of the Ordinance can be met:

As provided above, the Applicant has met the requirements set forth in Section 4.32(g), footnote 49 of the Ordinance.

2. Traffic generated or patterns of access or egress would not cause congestion hazard, or substantial change in established neighborhood character for the following reasons:

The proposed installation will not obstruct existing rights-of-way or pedestrian access and will not change the daily conditions of access, egress, traffic, congestion hazard, or character of the neighborhood. The installation will not require the addition of any new parking or loading spaces. The use is passive and will not change the current conditions or appearance surrounding the Building. The Proposed Facility will not produce any odors, fumes, noise or waste. There will be no need for water, sewer, or other municipal services.

As mentioned above, once modified, the facility will be unmanned and will only require infrequent visits by a technician, typically two times per month for routine diagnostics and/or maintenance, except in cases of emergency. These infrequent visits will not result in any material increase in traffic or disruption to patterns of access or egress that will cause congestion hazards or cause a substantial change in the established neighborhood character. The Applicant's maintenance personnel will make use of the existing access roads and parking at the Building.

3. The continued operation of or the development of adjacent uses as permitted in the Zoning Ordinance would not be adversely affected by the nature of the proposed use for the following reasons:

As described above and illustrated on the attached Photo Sims, the modification of the existing facility will produce a minimal change in the appearance of the Building. The modification of the existing facility will blend with the existing characteristics of the Building and the surrounding neighborhood. Moreover, the proposed installation will not generate any traffic, smoke, dust, heat, glare, discharge of noxious substances, nor will it pollute waterways or groundwater. Conversely, the surrounding properties and general public will benefit from the potential to enjoy improved wireless communication.

4. Nuisance or hazard would not be created to the detriment of the health, safety, and/or welfare of the occupant of the proposed use or the citizens of the City for the following reasons:

The operations of the Proposed Facility will not adversely impact the health, safety, and the welfare of the residents of the City of Cambridge. On the contrary, the proposed use will benefit the City and promote the safety and welfare of its residents, businesses and drivers by providing reliable state-of-the-art digital wireless data services. Further, the Proposed Facility will comply with all federal, state and local safety requirements including the standards established by the FCC, Federal Aviation Administration (FAA), the American Standards Institute (ANSI), and the Massachusetts Department of Public Health (MDPH).

Moreover, granting the requested relief will not be contrary to the public interest because:

- The proposed use complies with the Ordinance;
- The proposed location of the Facility is necessary for the effective deployment of the Applicant's network;
- The proposed Facility will comply in all respects with RF emission standards established by the FCC;
- The proposed Facility will not have any adverse effect on the value of land and buildings in the neighborhood or on the amenities thereof. The use will be passive and require no employees on the premises. Specifically, the proposed Facility will require approximately two vehicle trips per month by a service technician for routine maintenance and will require no water, septic, or other municipal services;
- The proposed Facility will promote and conserve the convenience and general welfare of the inhabitants of the City by enhancing telecommunication services;
- The proposed Facility will involve no overcrowding of land or undue concentration of population because it is an unmanned facility;
- The proposed Facility will preserve and increase the amenities of the City by enhancing telecommunications services;

- The proposed Facility will lessen the danger from fire and natural disasters by providing increased network access for emergency communications in the event of such fires and natural disasters;
- The proposed Facility will involve no adverse effects on public and private water supplies and indeed will utilize no water at all;
- The proposed Facility will facilitate the adequate provision of transportation by improving mobile telecommunications for business, personal, commuters and emergency uses;
- The proposed Facility will involve no adverse effects on drainage, schools, parks, open space, or other public amenities;
- The proposed Facility will involve no excessive noise or pollution to the environment;
- The proposed Facility will involve no adverse effects on historic sites;
- The proposed Facility will be an appropriate use of land in the City;
- The proposed Facility will be a benefit to the community by allowing for more competitive wireless telecommunications services to the residents and businesses of the City.

Accordingly, the Proposed Facility will not adversely impact the health, safety and/or welfare of the neighborhood or the residents of the City of Cambridge.

5. For other reasons, the proposed installation will not impair the integrity of the district or adjoining district or otherwise derogate from the intent or purpose of this ordinance for the following reasons:

The Applicant's' proposed Facility is designed to blend with the existing characteristics of the Building. Accordingly, the Applicant's proposed Facility's design results in a minimal impact on the underlying and adjacent zoning district and is consistent with the purpose and intent of the Ordinance. As mentioned above, the proposed installation will not generate any traffic, smoke, dust, heat, glare, discharge or noxious substances, nor will it pollute waterways or groundwater. Furthermore, the proposed Facility will not impair the integrity of the intent or purpose of the Ordinance because the proposed Facility:

- will not contribute to traffic congestion because the traffic produced thereby will be limited to a single vehicle for biweekly visits for routine maintenance checks;
- will conserve health by not producing any pollutants or wastes, while being in compliance with all applicable state and federal safety codes;
- will contribute to securing safety from fire, flood, panic and other dangers by providing more reliable wireless coverage with E911 enhanced emergency service and Global Positioning System technology;
- will not inhibit adequate light and air;
- will not contribute to overcrowding of land or the undue concentration of population;
- will encourage the most appropriate use of land throughout the City because the Property is currently used for public utilities;
- will increase the City's amenities by providing more reliable and competitive wireless coverage to the residents and businesses of Lawrence; and
- will encourage multiple uses of land thereby providing for orderly expansion and development.

As mentioned above, the proposed installation will not generate any traffic, smoke, dust, heat, glare, discharge or noxious substances, nor will it pollute waterways or groundwater.

6. The new use of the building construction is consistent with the Urban Design Objective set for tin Section 19.30 of the Ordinance:

Not Applicable. The Applicant is not proposing to construct a new building or structure.

#### IV. Conclusion

The Applicant hereby requests that the Board determine that installation of the wireless telecommunications facility will not have any adverse effect on the neighborhood within which the Property is located in particular, and the City of Cambridge as a whole. The findings are made in view of the particular characteristics of the Property and of the Applicant's proposed

siting and equipment, as detailed above. This Property is the most appropriate location for the installation and operation of the wireless communications facility.

For the foregoing reasons the Applicant respectfully requests that the Board grant the foregoing relief in the form of a Special Permit and such other relief as the Board deems necessary to allow the installation and operation of the Applicant's Proposed Facility.

Sincerely.

Adam F. Braillard 617-456-8153

adam.braillard@princelobel.com

**Enclosures** 

Location:

#### **BZA Application Form**

#### **DIMENSIONAL INFORMATION**

Applicant: GS 22 Water Street Project Owner, LLC

Present Use/Occupancy: Residential -Commercial

22 Water St., Cambridge, MA Zone: PUD-6

Phone: Requested Use/Occupancy: Telecommunications

		Existing Conditions	equested anditions	Ordinance Requirements	
TOTAL GROSS FLOOR AREA;		N/A	no change	N/A	(max.)
LOT AREA:		N/A	No Change	N/A	(min.)
RATIO OF GROSS FLOOR AREA TO LOT AREA; <sup>2</sup>		N/A	No Change	N/A	
LOT AREA OF EACH DWELLING UNIT		N/A	No Change	N/A	
SIZE OF LOT:	WIDTH	N/A	No Change	N/A	
	DEPTH	N/A	No Change	N/A	
SETBACKS IN FEET:	FRONT	N/A	No Change	N/A	
	REAR	N/A	No Change	N/A	
	LEFT SIDE	N/A	No Change	N/A	
	RIGHT SIDE	N/A	No Change	N/A	
SIZE OF BUILDING:	HEIGHT	163'	168'	200+	
	WIDTH	N/A	No Change	N/A	
RATIO OF USABLE OPEN SPACE TO LOT AREA:		N/A	No Change	N/A	
NO. OF DWELLING UNITS:		N/A	No Change	N/A	
NO. OF PARKING SPACES:		N/A	No Change	N/A	
NO. OF LOADING AREAS:		N/A	No Change	N/A	
DISTANCE TO NEAREST BLDG, ON SAME LOT		N/A	No Change	N/A	

Describe where applicable, other occupancies on the same lot, the size of adjacent buildings on same lot, and type of construction proposed, e.g; wood frame, concrete, brick, steel, etc.:

#### N/A

- 1. SEE CAMBRIDGE ZONING ORDINANCE ARTICLE 5.000, SECTION 5.30 (DISTRICT OF DIMENSIONAL REGULATIONS).
- 2. TOTAL GROSS FLOOR AREA (INCLUDING BASEMENT 7'-0" IN HEIGHT AND ATTIC AREAS GREATER THAN 5') DIVIDED BY LOT AREA.
- 3. OPEN SPACE SHALL NOT INCLUDE PARKING AREAS, WALKWAYS OR DRIVEWAYS AND SHALL HAVE A MINIMUM DIMENSION OF 15'.

# SITE NAME: LECHEMERE (VA)



# SITE ADDRESS: 22 WATER ST. CAMBRIDGE, MA 02141



38 CHAUNCY STREET 2ND FLOOR BOSTON, MA 02111



Dewberry Engineers Inc.
99 SUMMER STREET
SUITE 700
BOSTON, MA 02110
PHONE: 617.695.340

#### SITE INFORMATION AREA MAP DRAWING INDEX STARRY SITE NUMBER: MACAM0050 NO. TITLE SHEET STARRY SITE NAME: LECHMERE (VA) 300' PROPERTY RADIUS MAP SCOPE OF WORK: UNMANNED INTERNET SERVICE PROVIDER FACILITY Z-2 ROOF PLAN Z-3 EAST ELEVATION STARRY EQUIPMENT ON ROOF 7-4 WEST ELEVATION Z-5 NORTH ELEVATION BEHRINGER HARVARD 22 WATER ST. SITE LOCATION C/O MONOGRAM RESIDENTIAL TRUST 5800 GRANITE PARKWAY, SUITE 1000 SOUTH ELEVATION EQUIPMENT DETAILS-EQUIPMENT DETAILS-II Cambridge \*BASED ON CITY OF CAMBRIDGE ASSESSOR'S DATABASE Crossina DRAWN BY 42° 22' 22.51" N CHECKED BY: OAS LONGITUDE\*\*: APPROVED BY BBR 71° 04' 41.13" W \*\*BASED ON GOOGLE EARTH 5012229 PROJECT MAP/LOT 7/113 JOB #: 50122294 ZONING JURISDICTION: CITY OF CAMBRIDGE ZONING DRAWINGS ZONING DISTRICT: PUD-6

PROJECT DESCRIPTION

AREA MAP BASED ON OPENSTREETMAP OBTAINED ON 10/22/19.

THE SITE WILL CONSIST OF INSTALLING ANTENNAS ON THE ROOF. THESE ANTENNAS WILL BE MOUNTED TO THE EXISTING SCREENWALL STEEL FRAME. THE PROPOSED SITE SUPPORT CABINET & ASSOCIATED EQUIPMENT WILL BE ALSO MOUNTED ON THE SCREENWALL STEEL FRAME.

THIS IS AN UNMANNED INTERNET SERVICE PROVIDER FACILITY AND NOT FOR HUMAN HABITATION:

**GENERAL** 

CORRECT THE DISCREPANCIES AT THE CONTRACTOR'S EXPENSE.

- ADA COMPLIANCE NOT REQUIRED.
- POTABLE WATER OR SANITARY SERVICE IS NOT REQUIRED.
   NO OUTDOOR STORAGE OR ANY SOLID WASTE RECEPTACLES REQUIRED.
- CONTRACTOR SHALL VERIFY ALL PLANS, EXISTING DIMENSIONS, AND CONDITIONS ON JOB SITE. CONTRACTOR SHALL IMMEDIATELY NOTIFY THE ARCHITECT/ENGINEER IN WRITING OF ANY DISCREPANCIES BEFORE PROCEEDING WITH THE WORK. FAILURE TO

NOTIFY THE ARCHITECT/ENGINEER PLACE THE RESPONSIBILITY ON THE CONTRACTOR TO

3. NEW CONSTRUCTION WILL CONFORM TO ALL APPLICABLE CODES AND ORDINANCES. BUILDING CODE: MASSACHUSETTS STATE BUILDING CODE, 9TH EDITION (780CMR) ELECTRICAL CODE: NATIONAL ELECTRICAL CODE (LATEST EDITION) STRUCTURAL CODE: TIA/EIA-222-G STRUCTURAL STANDARDS FOR ANTENNA SUPPORTING STRUCTURES AND ANTENNAS.

SITE NUMBE

<u>SITE NAME:</u> LECHMERE (VA)

FOR REVIEW

SITE ADDRESS: 22 WATER ST. CAMBRIDGE, MA 02141

TITLE SHEET

SHEET NUMBER

#### SPECIAL CONSTRUCTION NOTE

DEWBERRY ENGINEERS INC. ASSUMES THAT THE BUILDING/STRUCTURE IS PROPERLY CONSTRUCTED AND MAINTAINED. ALL STRUCTURAL MEMBERS AND THEIR CONNECTION ARE ASSUMED TO BE IN GOOD CONDITION AND ARE FREE FROM DEFECTS WITH NO DETERIORATION TO ITS MEMBER CAPACITIES.

STARRY: DATE: \_\_\_\_\_\_

CONSTRUCTION \_\_\_\_\_\_ DATE: \_\_\_\_\_\_

LEASING/
SITE ACQUISITION: \_\_\_\_\_\_ DATE: \_\_\_\_\_\_

RF ENGINEER: \_\_\_\_\_\_ DATE: \_\_\_\_\_\_

ROOFTOP TELECOM \_\_\_\_\_\_\_ DATE: \_\_\_\_\_\_

SHEET INDEX


149'-0"± (ROOF LEVEL)

AREA OF WORK:
ROOFTOP & INSIDE BUILDING

**POWER COMPANY:** 

TELCO COMPANY:

**BUILDING HEIGHT:** 

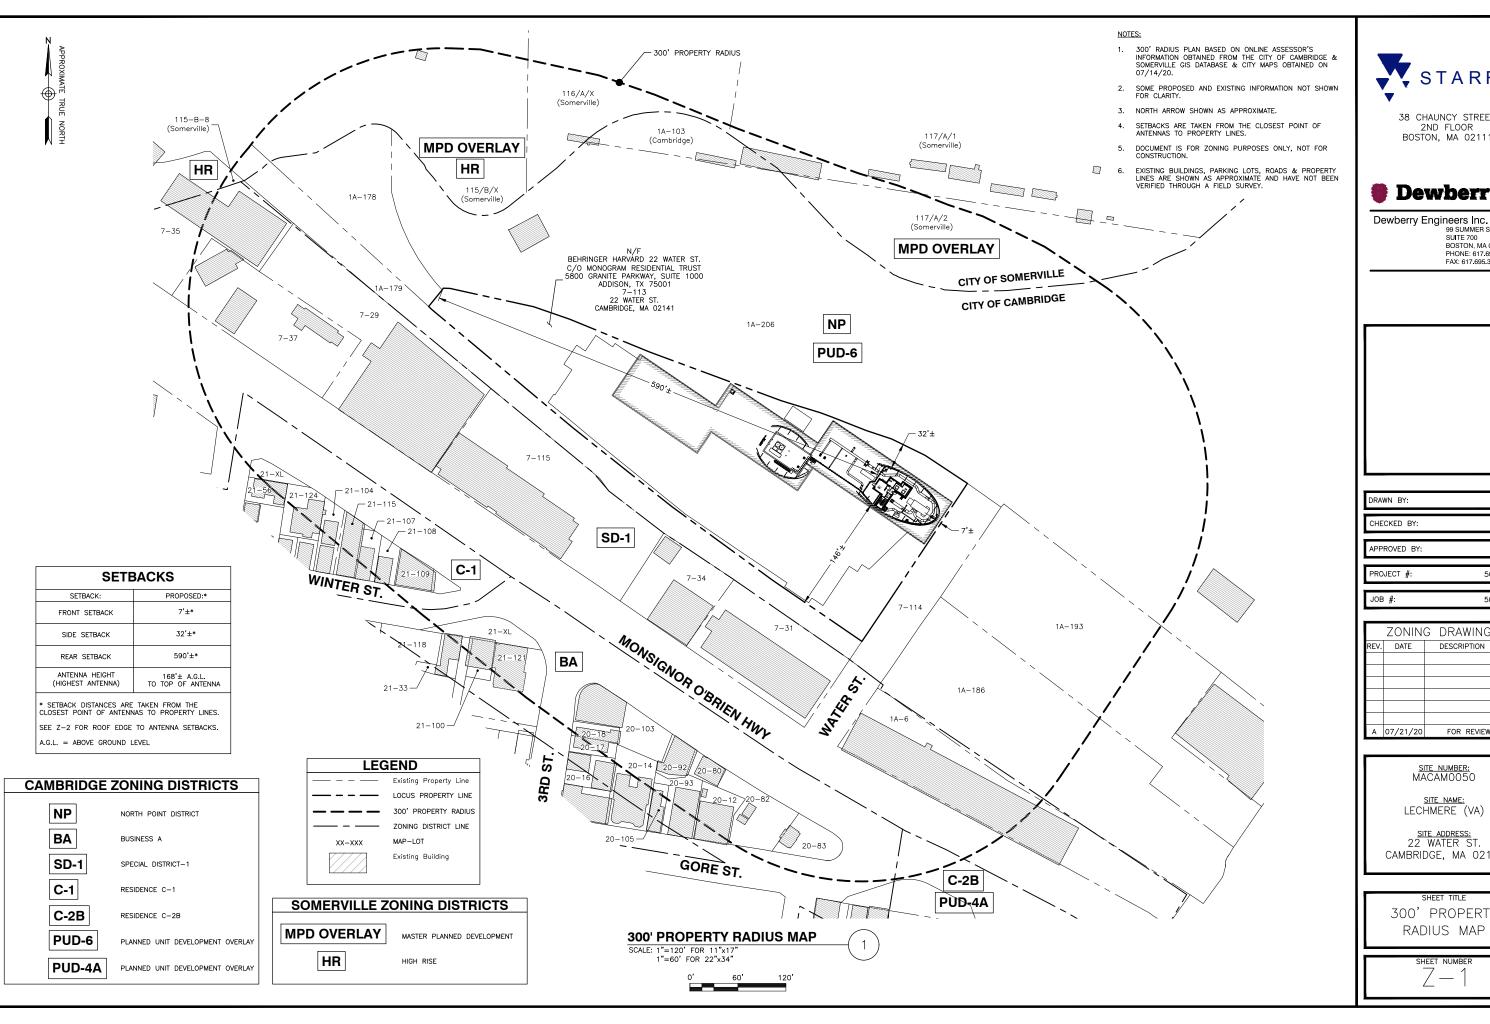





99 SUMMER STREET SUITE 700 BOSTON, MA 02110 PHONE: 617.695.3400 FAX: 617.695.3310

SK OAS

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50122290

50122294

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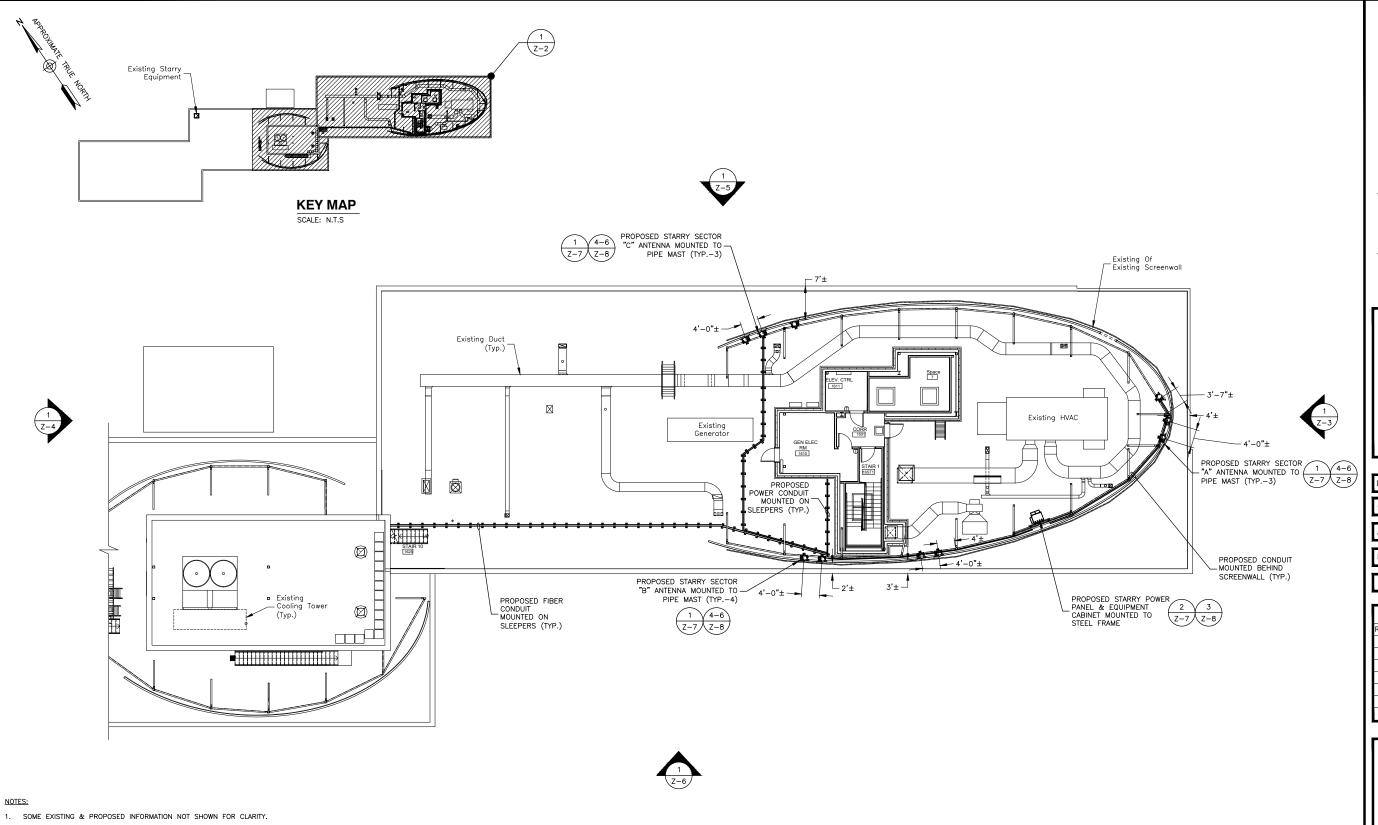
SITE NUMBER: MACAMO050

SITE NAME: LECHMERE (VA)

<u>SITE ADDRESS:</u> 22 WATER ST. CAMBRIDGE, MA 02141

300' PROPERTY RADIUS MAP

Z - 1





- NORTH ARROW SHOWN AS APPROXIMATE.
- 3. THIS IS FOR ZONING PURPOSES ONLY. NOT FOR CONSTRUCTION.
- PLANS BASED ON FIELD OBSERVATIONS DURING SITE VISIT BY DEWBERRY ENGINEERS INC. ON 10/22/19, GOOGLE EARTH, AND DRAWINGS BY SYMMES MAINI & MCKEE ASSOCIATES TITLED "22 WATER STREET RESIDENCES" REV1 DATED 10/22/13.
- EQUIPMENT LOCATION & ORIENTATION BASED ON STRUCTURAL ANALYSIS BY DEWBERRY ENGINEERS INC. DATED 06/12/20.
- STARRY REQUIRES (1) 2-POLE 60A CIRCUIT BREAKER TO BE INSTALLED IN AN EXISTING POWER PANEL INSIDE PENTHOUSE. SOURCE & ROUTING SHOWN PENDING ELECTRICAL LOAD STUDY.
- ALL PROPOSED FACADE MOUNTED ANTENNAS & CONDUITS SHALL BE PAINTED TO MATCH BUILDING. COORDINATE COLOR WITH STARRY CM AND BUILDING OWNER.







Dewberry Engineers Inc. 99 SUMMER STREET SUITE 700 BOSTON, MA 02110 PHONE: 617.695.3400 FAX: 617.695.3310



DRAWN BY: SK CHECKED BY: OAS APPROVED BY: BBR

PROJECT # 50122290

JOB #: 50122294

ı		ZONIN	G DRAWINGS
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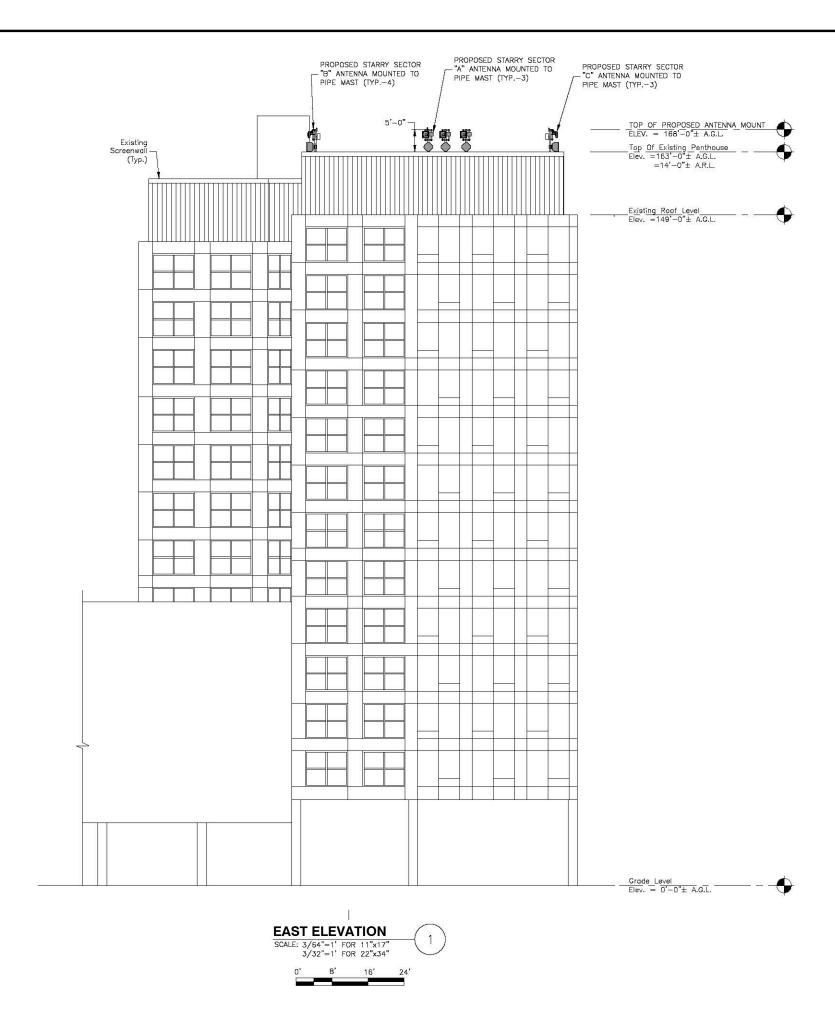
SITE NUMBER: MACAMO050

SITE NAME: LECHMERE (VA)

<u>SITE ADDRESS:</u> 22 WATER ST. CAMBRIDGE, MA 02141

SHEET TITLE

ROOF PLAN







Dewberry Engineers Inc. 99 SUMMER STREET SUITE 700 BOSTON, MA 02110 PHONE: 617.695.3400 FAX: 617.695.3310

DRAWN BY: SK

OAS

BBR

APPROVED BY:

CHECKED BY:

PROJECT #: 50122290

JOB #: 50122294

	ZONING	DRAWINGS
REV.	DATE	DESCRIPTION
Α	07/21/20	FOR REVIEW

SITE NUMBER
MACAMO05

<u>SITE NAME:</u> LECHMERE (VA)


SITE ADDRESS: 22 WATER ST. CAMBRIDGE, MA 02141

SHEET TITLE

EAST ELEVATION



- 1. SOME EXISTING & PROPOSED INFORMATION NOT SHOWN FOR CLARITY.
- 2. NORTH ARROW SHOWN AS APPROXIMATE.
- 3. THIS IS FOR ZONING PURPOSES ONLY, NOT FOR CONSTRUCTION.
- PLANS BASED ON FIELD OBSERVATIONS DURING SITE VISIT BY DEWBERRY ENGINEERS INC. ON 10/22/19, GOOGLE EARTH, AND DRAWINGS BY SYMMES MAINI & MCKEE ASSOCIATES TITLED "22 WATER STREET RESIDENCES" REV1 DATED 10/22/13.
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- 7. ALL PROPOSED FACADE MOUNTED ANTENNAS & CONDUITS SHALL BE PAINTED TO MATCH BUILDING. COORDINATE COLOR WITH STARRY CM AND BUILDING

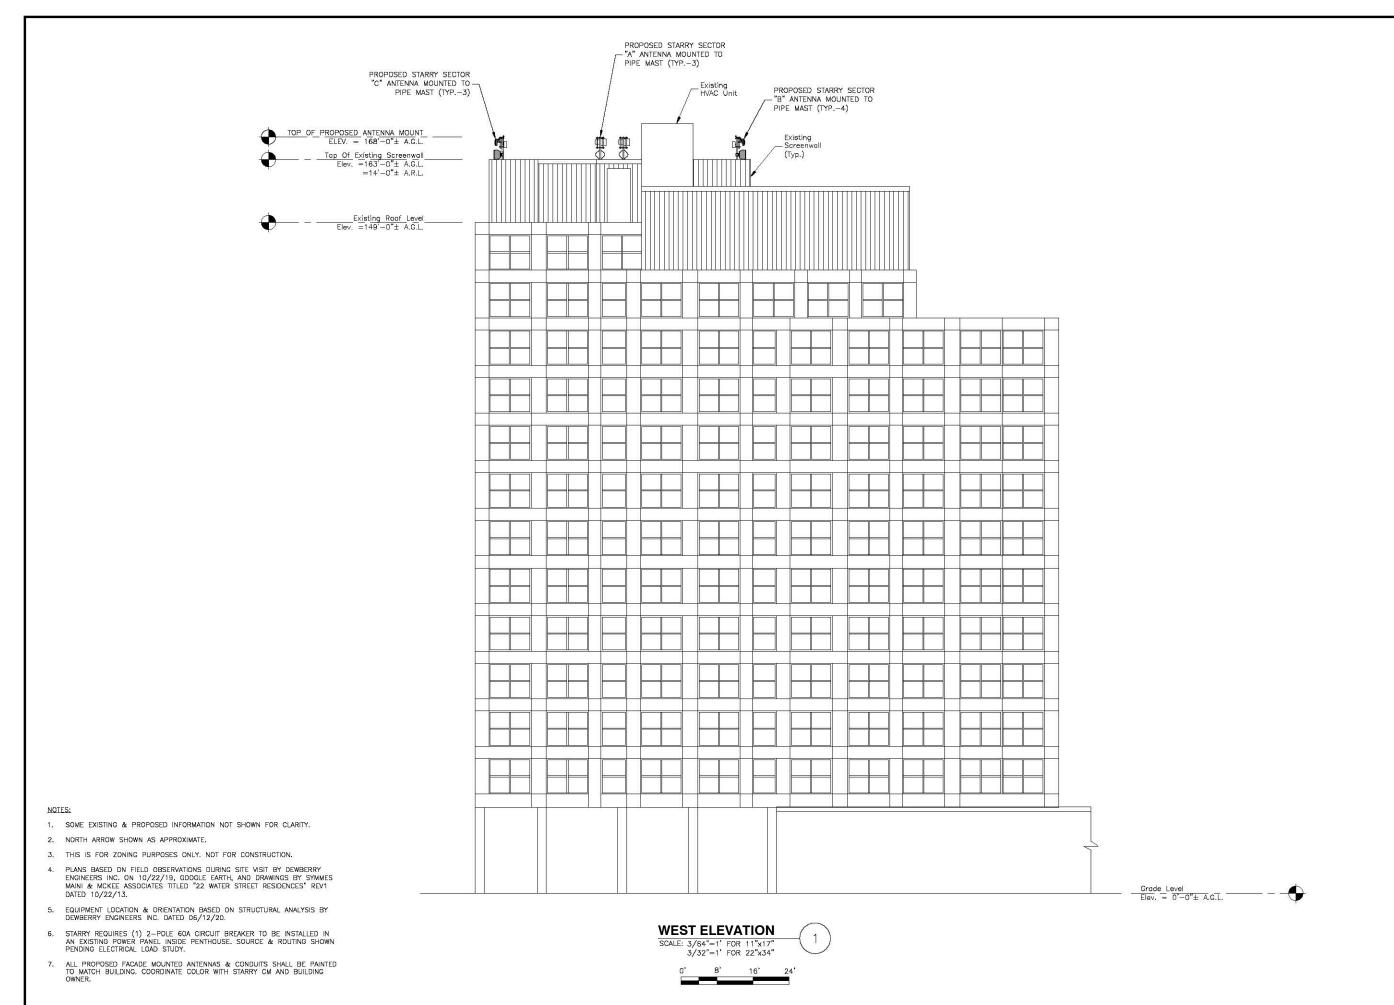





Dewberry Engineers Inc. 99 SUMMER STREET SUITE 700 BOSTON, MA 02110 PHONE: 617.695.3400 FAX: 617.695.3310

DRAWN BY: SK

CHECKED BY: OAS

APPROVED BY: BBR

PROJECT #: 50122290

JOB #: 50122294

	ZONING	DRAWINGS
REV.	DATE	DESCRIPTION
Α	07/21/20	FOR REVIEW


SITE NUMBER: MACAMOO5

<u>SITE NAME:</u> LECHMERE (VA)

SITE ADDRESS: 22 WATER ST. CAMBRIDGE, MA 02141

SHEET TITLE

WEST ELEVATION

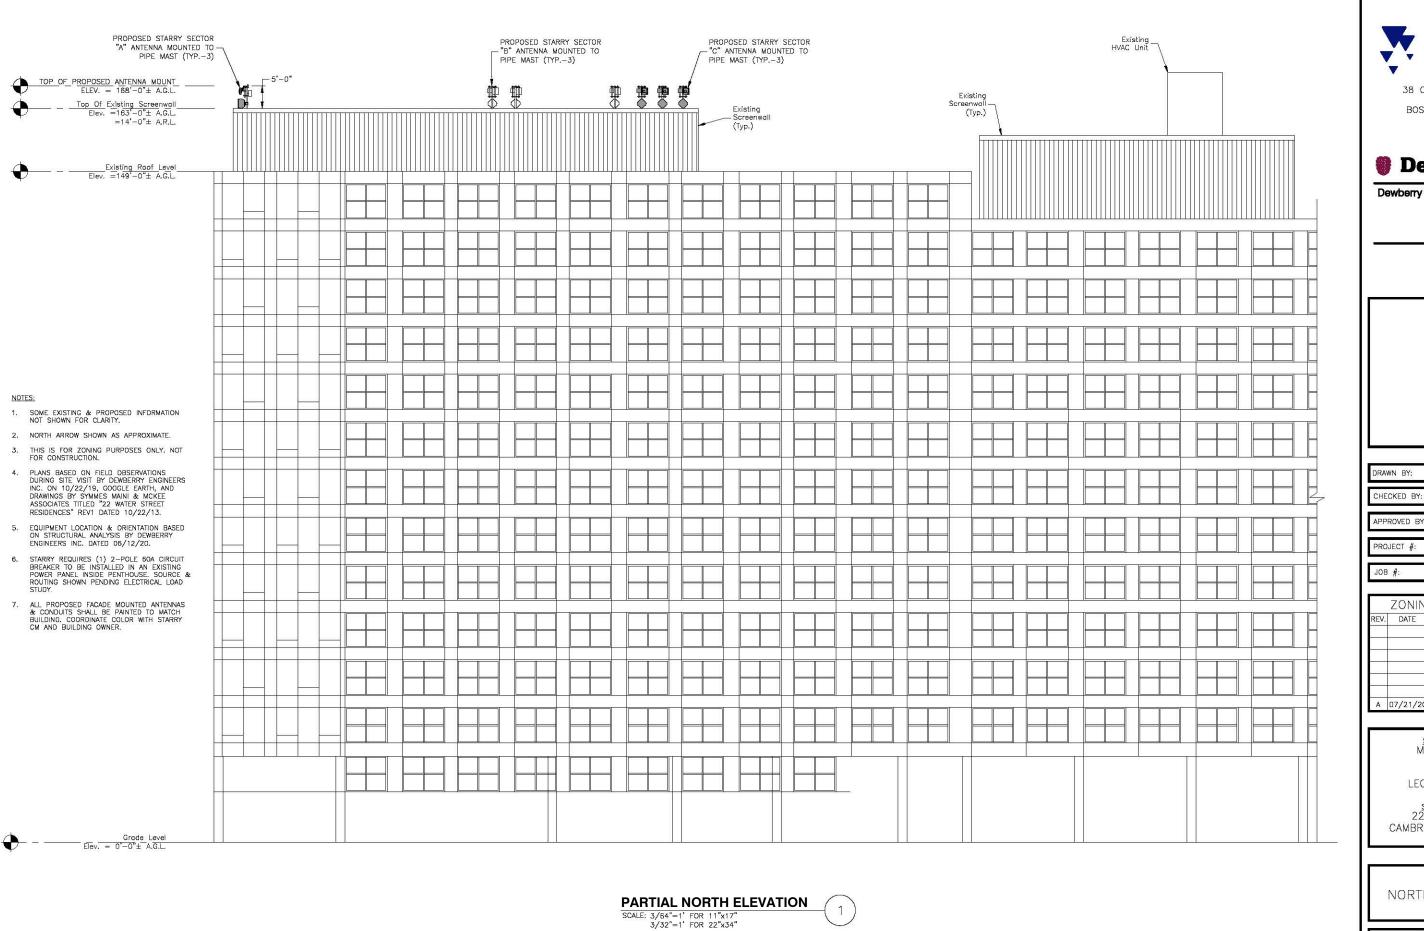

STARRY

38 CHAUNCY STREET 2ND FLOOR BOSTON, MA 02111



Dewberry Engineers Inc. 99 SUMMER STREET SUITE 700 BOSTON, MA 02110 PHONE: 617.695.3400 FAX: 617.695.3310

DRAWN BY: SK

OAS

BBR

APPROVED BY

PROJECT # 50122290

JOB #: 50122294

	ZONING	DRAWINGS
REV.	DATE	DESCRIPTION
A	07/21/20	FOR REVIEW

SITE NUMBER: MACAMO050


SITE NAME: LECHMERE (VA)

SITE ADDRESS: 22 WATER ST. CAMBRIDGE, MA 02141

SHEET TITLE

NORTH ELEVATION

Z - 5

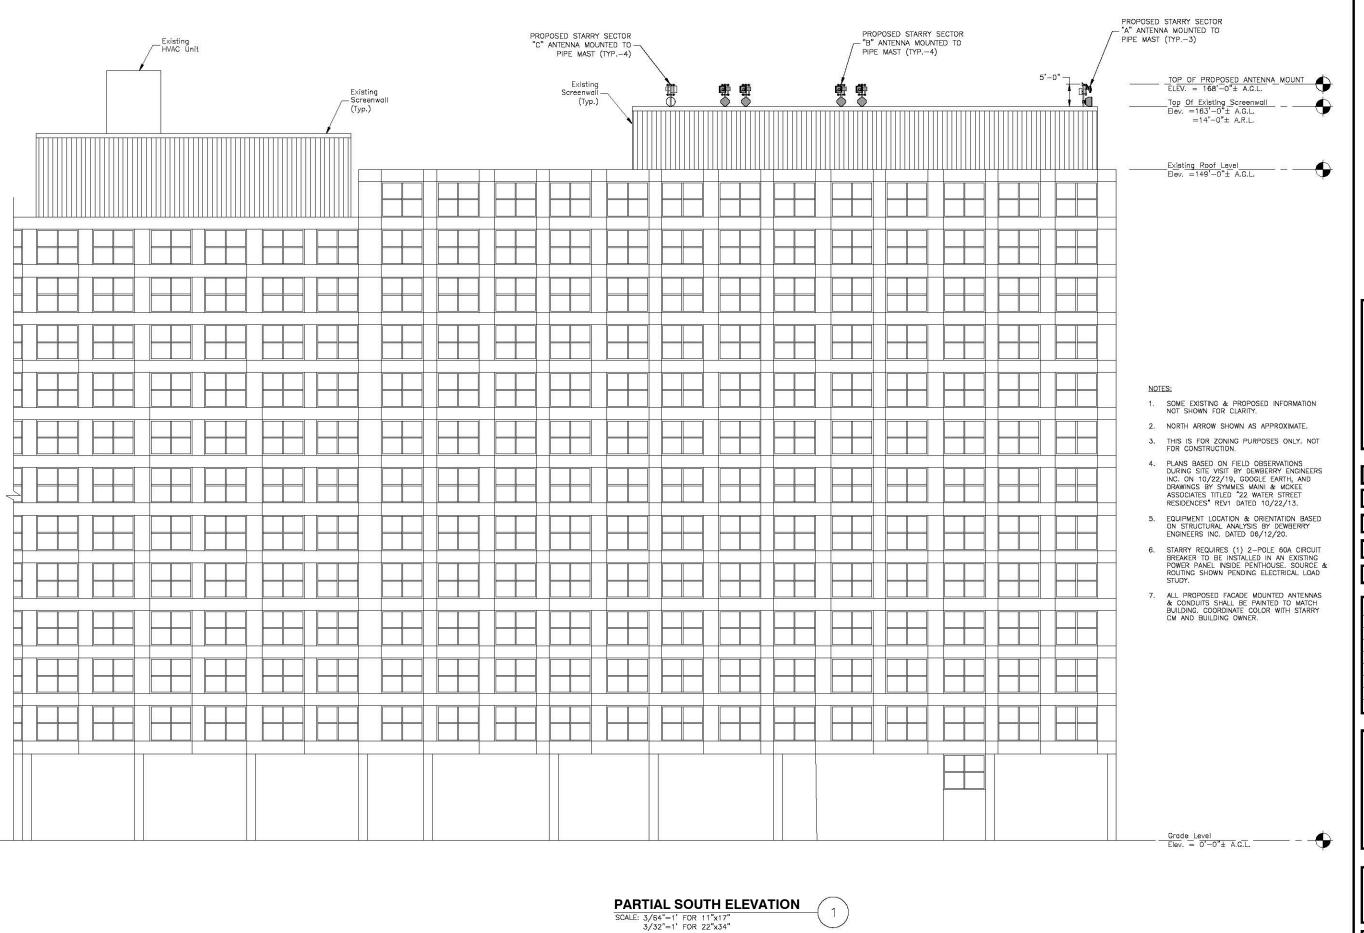





Dewberry Engineers Inc. 99 SUMMER STREET SUITE 700 BOSTON, MA 02110 PHONE: 817.895.3400 FAX: 617.895.3310

DRAWN BY: SK

OAS

BBR

50122290

50122294

APPROVED BY

CHECKED BY:

PROJECT #

JOB #:


ZONING DRAWINGS DATE DESCRIPTION FOR REVIEW A 07/21/20

SITE NUMBER: MACAMO050

SITE NAME: LECHMERE (VA)

SITE ADDRESS: 22 WATER ST. CAMBRIDGE, MA 02141

SOUTH ELEVATION

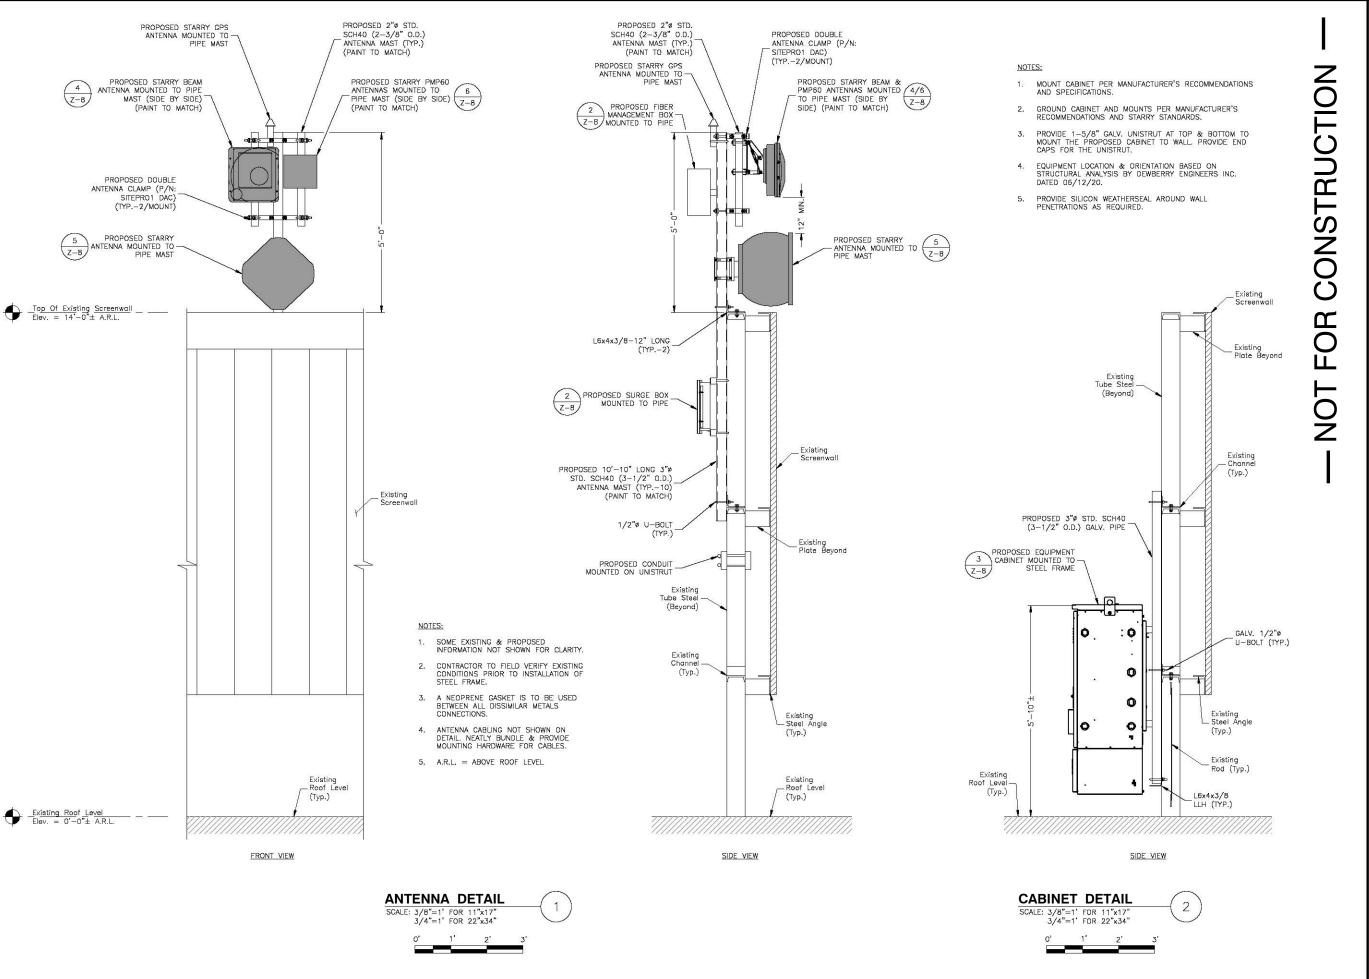





Dewberry Engineers Inc. 99 SUMMER STREET SUITE 700 BOSTON, MA 02110 PHONE: 617.895.3400 FAX: 617.695.3310

DRAWN BY: SK
CHECKED BY: OAS

BBR

50122294

PROJECT #: 50122290

APPROVED BY:

JOB #:

ZONING DRAWINGS

REV. DATE DESCRIPTION

A 07/21/20 FOR REVIEW


SITE NUMBER:
MACAMOO5O

SITE NAME:
LECHMERE (VA)

SITE ADDRESS:
22 WATER ST.
CAMBRIDGE, MA 02141

SHEET TITLE
EQUIPMENT DETAILS—

Z—7

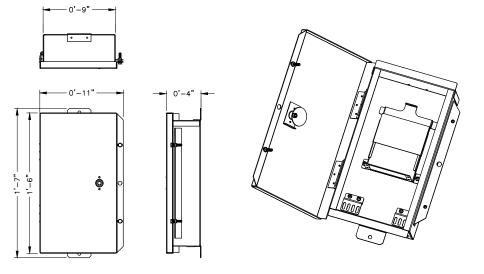

ENCLOSURE SPECIFICATIONS

CENTURY/TY-WOOD ESTC-12S-TM 17.8" 10.6" 4.4" MODEL: HEIGHT: WIDTH:

DEPTH:

**SURGE BOX DETAIL** 


- 1. FMB = FIBER MANAGEMENT BOX.
- MOUNT FMB & SURGE BOX TO ANTENNA MAST IN ACCORDANCE WITH MANUFACTURER RECOMMENDATIONS.



**ENCLOSURE SPECIFICATIONS** 

L-COM NB141207-000DR MODEL: 15.5" 13.5" 7.7" 8.8± LBS. HEIGHT: WIDTH: DEPTH: WEIGHT:

FIBER MANAGEMENT BOX / SCALE: N.T.S.

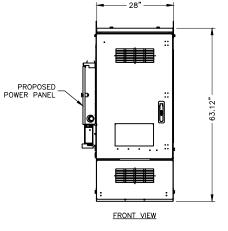

<u>TOP</u>

# 0

21.63" --

STRUCTION

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#### SIDE VIEW NOTES:

- MOUNT CABINET PER MANUFACTURER'S RECOMMENDATIONS AND SPECIFICATIONS.
- EQUIPMENT LOCATION & ORIENTATION BASED ON STRUCTURAL ANALYSIS BY DEWBERRY ENGINEERS INC. DATED 06/12/20.

#### CABINET SPECIFICATIONS

MANUF: CHARLES INDUSTRIES HEIGHT: DEPTH: 63.12" 21.63" WITDH: 28.00" WEIGHT: 1,000 LBS.

#### **EQUIPMENT CABINET**

3

#### GENERAL ANTENNA NOTES:

- 1. MOUNT EQUIPMENT PER MANUFACTURER'S RECOMMENDATIONS AND SPECIFICATIONS.
- GROUND EQUIPMENT AND MOUNTS PER MANUFACTURER'S RECOMMENDATIONS AND STARRY STANDARDS.
- CABLE CONNECTIONS NOT SHOWN FOR CLARITY.
- PROPOSED CABLES TO BE NEATLY BUNDLED & SECURED TO MAIN PIPE MAST.



#### ANTENNA SPECIFICATIONS

T.B.D. STARRY BEAM 200 16" 18" MODEL: LENGTH:

WIDTH: DEPTH: WEIGHT: 7.2" 39.6 LBS.

- MOUNT ANTENNA PER MANUFACTURER'S RECOMMENDATIONS AND SPECIFICATIONS.
- GROUND ANTENNA AND MOUNTS PER MANUFACTURER'S RECOMMENDATIONS AND STARRY STANDARDS.
- CONFIRM REQUIRED ANTENNAS WITH THE LATEST



#### ANTENNA SPECIFICATIONS

BRIDGEWAVE MANUF: MODEL: 80GHz FLEX4G-10000 DIAMETER: 24" DEPTH: 18" LENGTH: 27.3 LBS.

- MOUNT ANTENNA PER MANUFACTURER'S RECOMMENDATIONS AND SPECIFICATIONS.
- 2. GROUND ANTENNA AND MOUNTS PER MANUFACTURER'S RECOMMENDATIONS AND STARRY STANDARDS.
- CONFIRM REQUIRED ANTENNAS WITH THE LATEST ANTENNA DESIGN.



IGNITENET
METROLINQ 2.5G 60BM SECTOR MODEL: 7 48" LENGTH:

ANTENNA SPECIFICATIONS

2.36" 4.41 LBS. DEPTH: WEIGHT:

#### NOTES:

- MOUNT EQUIPMENT PER
  MANUFACTURER'S RECOMMENDATIONS AND SPECIFICATIONS.
- GROUND EQUIPMENT AND MOUNTS PER MANUFACTURER'S RECOMMENDATIONS AND STARRY STANDARDS.
- CONFIRM REQUIRED ANTENNAS WITH THE



**ANTENNA DOWNTILT BRACKET** 

**METROLINQ BEAMFORMING** (PMP60) ANTENNA DETAIL

# STARRY

38 CHAUNCY STREET 2ND FLOOR BOSTON, MA 02111



Dewberry Engineers Inc. 99 SUMMER STREET SUITE 700 BOSTON, MA 02110 PHONE: 617.695.3400 FAX: 617.695.3310

DRAWN BY: SK CHECKED BY: OAS

BBR

PROJECT 50122290

APPROVED BY

JOB #: 50122294

ı	1	ZONIN	G DRAWINGS
ı	REV.	DATE	DESCRIPTION
ı			
ı			
ı			
ı			
ı			
ı			
ı	Α	07/21/20	FOR REVIEW
п	_		

SITE NUMBER: MACAMO050

SITE NAME: LECHMERE (VA)

<u>SITE ADDRESS:</u> 22 WATER ST. CAMBRIDGE, MA 02141

SHEET TITLE

EQUIPMENT DETAILS-

Z-8

STARRY BEAM ANTENNA DETAIL 4

**BRIDGEWAVE 80GHz ANTENNA** 



is dependent upon weather conditions, season, sunlight, and viewer location.



LECHMERE (VA)

**DEWBERRY NO. 50122294** (Page 1 of 8)

Dewberry Engineers Inc. 99 Summer St. Suite 700 Boston, MA 02110













# **Proposed View**

Proposed Starry Mast With Proposed Antennas (Typ.)




LECHMERE (VA)
Photo 3B
View Facing West

View Facing West From North Street (Page 8 of 8)



22 Water SA.

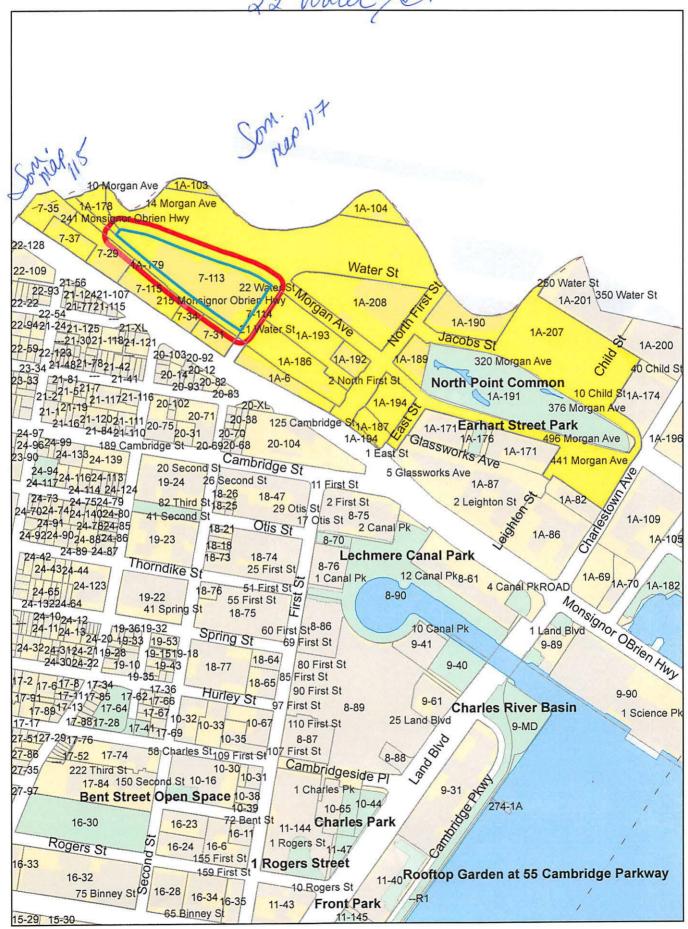

22 water St.

1A-104 -103-186-187-178-179/7-114117-A-1/A4 MASSACHUSETTS BAY TRANSPORTATION AUTHORITY 10 PARK PLAZA BOSTON, MA 02116

1A-6 CETEGEN BAKI & SHAYLIN A CETEGEN 169 MONSIGNOR O'BRIEN HWY - UNIT 409 CAMBRIDGE, MA 02141 PRINCE LOBEL TYE LLP
C/O ADAM F. BRAILLARD, ESQ.
ONE INTERNATIONAL PLACE – SUITE 3700
BOSTON, MA 02110

1A-6 HWANG MITCHELL 169 MONSIGNOR OBRIEN HGWY - UNIT 303 CAMBRIDGE, MA 02141 7-37 PECTEN PROPERTIES, LLC. 261 LEDYARD ST. NEW LONDON, CT 06320 7-31 NATRAJ HOSPITALITY LLC 14 HILL ST WOBURN, MA 01801

7-113

7-115 MONSIGNOR HOTEL, LLC 1359 HOOKSETT RD. HOOKSETT, NH 03106 7-29 EASTMAN BROOK LLC, 225 MONSIGNOR OBRIEN HWY CAMBRIDGE, MA 02141

BEHRINGER HARVARD 22 WATER STREET C/O MONOGRAM RESIDENTIAL TRUST 750 BERING DRIVE SUITE 300 HOUSTON, TX 77057

1A-6 MANDAVA, LAKSHMIBHAVANI VENKATA G. MEKA 169 MONSIGNOR OBRIEN HWY UNIT 810 CAMBRIDGE, MA 02141 1A-6 ARMAS, KROGEN R. CARRENO 169 MONSIGNOR OBRIEN HWY. - UNIT #507 CAMBRIDGE, MA 02141 1A-6 LU, CHEN 169 MONSIGNOR OBRIEN HWY. UNIT 504 CAMBRIDGE, MA 02141

1A-6 SIEGEL, MARC & MARIA ELENA CRUZ LOPEZ 169 MONSIGNOR OBRIEN HWY., #501 CAMBRIDGE, MA 02141 1A-6 R&L LLC 7755 VILLAGE DR BEAUMONT, TX 77713 1A-6
MEHTA, SHARAD & ALKA YADAV-MEHTA
TRUSTEES, THE GLASS CONDO REALTY TRS
6 FOX LANE
WESTBOROUGH, MA 01581

1A-6 YI, BORAM 169 MONSIGNOR OBRIEN HWY., #404 CAMBRIDGE, MA 02141 1A-6 MULABEGOVIC, SELMA 169 MONSIGNOR OBRIEN HWY. UNIT 401 CAMBRIDGE, MA 02140 1A-6 LEE, JOONG WON & KYUNG-A LEE 169 MONSIGNOR OBRIEN HWY - UNIT #309 CAMBRIDGE, MA 02141

1A-6 SHEN, DAN 36 DARTHMOUTH ST., #801 MALDEN, MA 02148 1A-6 SUN, JACK J. 169 MONSIGNOR OBRIEN HWY UNIT #206 CAMBRIDGE, MA 02141 1A-6 SAHAIDA, LYNN 169 MONSIGNOR OBRIEN HWY. - UNIT #506 CAMBRIDGE, MA 02141

1A-6 MELCHERT, GUSTAVO J. & INGRID C. NUNEZ 410 BUCKEYE TR WEST LAKE HILLS, TX 78746 1A-6 ZHAO, SHU QING 48 SOMERSET DR. GREAT NECK, NY 11020 1A-6 LYNN, BRIAN GARY 169 MONSIGNIOR OBRIEN HWY. - UNIT 412 CAMBRIDGE, MA 02141

1A-6 MOON, ROBERT P. 169 MONSIGNOR OBRIEN HWY. - UNIT #407 CAMBRIDGE, MA 02141 1A-6 SUN, PETER 169 MONSIGNOR O'BRIEN HGWY - UNIT #316 CAMBRIDGE, MA 02141 1A-6 HE, QUILING 221 BEACON ST., #3 SOMERVILLE, MA 02143

1A-6 YILMAZ, OMER H. 169 MONSIGNOR OBRIEN HWY., #312 CAMBRIDGE, MA 02141 1A-6 ABDINOOR, DANIEL 169 MONSIGNOR OBRIEN HWY. - UNIT#308 CAMBRIDGE, MA 02141 1A-6 TURNER IVY A. 169 MONSIGNOR OBRIEN HWY#215 CAMBRIDGE, MA 02141

294

22 water St.

1A-6 ARAGAKI, JULIANA N. & VITOR A. SERAFIM 169 MONSIGNOR OBRIEN HWY - UNIT#210 AMBRIDGE, MA 02141

KONG, JACK K. W. 169 MONSIGNOR OBRIEN HWY., #415 CAMBRIDGE, MA 02141

1A-6

1A-6 WALCOTT, LEGER L. 169 MSGN OBRIEN HWY.#410 CAMBRIDGE, MA 02139

1A-6 ARCHBOLD, JOSHUA 63 CLARENDON ST. BOSTON, MA 02116 1A-6 SOUTH BAY PROPERTIES LLC. 138 HAVERHILL ST. SUITE 104 ANDOVER, MA 01810 1A-6 APNA ESTATES LLC. 9 RAINBOW DRIVE NASHUA, NH 03062

1A-6 PEREIRA, ERIKA L. & ANTHONY RIGGILLO, JR 134 STURGES ST. MEDFORD, MA 02155

1A-6
CAMBRIDGE AFFORDABLE HOUSING
CORPORATION
362 GREEN ST
CAMBRIDGE, MA 02139

1A-6 GONSALVES, REX 169 MONSIGNOR OBRIEN HWY - UNIT #204 CAMBRIDGE, MA 02141

1A-6 KINZER, KIM 169 MONSIGNOR OBRIEN HWY. - UNIT #203 CAMBRIDGE, MA 02141 1A-6 YOUNG, GARRICK L. & AMY W. HUNG 169 MONSIGNOR OBRIEN HWY. - UNIT 408 CAMBRIDGE, MA 02141 1A-6 ROGUE ENDEAVOURS, LLC 149 HIGHLAND AVE. WINCHESTER, MA 01890

1A-6 GIBBONS, MARIA & MALTE BERNHOLZ 16452 SHADY VIEW LANE LOS GATOS, CA 95032 1A-6 SHEN, YICHEN 169 MONSIGNOR OBRIEN HWY. - UNIT 315 CAMBRIDGE, MA 02141 1A-6 HUANG, KEYU & SOPHIA DONGYAN ZHAO 29 DEWEY RD LEXINGTON, MA 02420

1A-6 NOVOSAD, JENNIFER 169 MONSIGNOR OBRIEN HWY., #306 CAMBRIDGE, MA 02141 1A-6 SOUTH BAY PROPERTIES LLC 1 138 HAVERHILL ST. SUITE 104 ANDOVER, MA 01810-1501 1A-6 ADIB, FADEL 169 MONSIGNOR OBRIEN HWY., #301 CAMBRIDGE, MA 02139

KOLOVSKI, VLADIMIR & MARIJA ATANASOVA 169 MONSIGNOR OBRIEN HWY. - UNIT#216 CAMBRIDGE, MA 02141

HEATH, MICHAEL & JACQUELINE HEATH 169 MONSIGNOR O'BRIEN HWY. - UNIT#214 CAMBRIDGE, MA 02141 1A-6 SUNG, PETER & VANESSA SUN TRUSTEE OF THE SUNG FAMILY TRUST 169 MONSIGNOR OBRIEN HWY #202 CAMBRIDGE, MA 02141

1A-6 BAU, HSIHSUAN 188 PROSPECT ST UNIT 3 CAMBRIDGE, MA 02139

1A-6

HUA, JI 169 MONSIGNOR O'BRIEN HWY UNT #808 CAMBRIDGE, MA 02141

1A-6

1A-6 MANDZHIEVA, IRINA 169 MONSIGNOR OBRIEN HWY, #804 CAMBRIDGE, MA 02141

1A-6 SINHA, MANAVENDRA KUMAR & SHALINI AWASTHI 169 MONSIGNOR OBRIEN HWY., #801 CAMBRIDGE, MA 02141

NIMMAGADDA, NAREN & VINOD NIMMAGADDA 169 MONSIGNOR OBRIEN HWY., #714 CAMBRIDGE, MA 02141 1A-6 BHOLA, PATRICK & LANA DINIC 169 MONSIGNOR OBRIEN HWY - UNIT #712 CAMBRIDGE, MA 02141

1A-6 LIMA, JENNIFER M. TRUSTEE OF THE LIMA REVOC LIVING TRUST 169 MONSIGNOR OBRIEN HWY UNIT #710 CAMBRIDGE, MA 02141 1A-6 WONG, LYNN 169 MONSIGNOR OBRIEN HWY., #709 CAMBRIDGE, MA 02141 1A-6 TSAI, ELLEN A. 169 MONSIGNOR OBRIEN HWY., #708 CAMBRIDGE, MA 02141 22 water St.

1A-6 BORGES, JOSE F. & MARIA E. BORGES A LIFE ESTATE 169 MONSIGNOR OBRIEN HWY. UNIT#704 CAMBRIDGE, MA 02141

1A-6 MAILOA, JONATHAN PRADANA 169 MONSIGNOR OBRIEN HWY UNIT #816 CAMBRIDGE, MA 02141

1A-6 MEHTA, SHARAD & ALKA YADAV-MEHTA 169 MONSIGNOR OBRIEN HWY., #612 CAMBRIDGE, MA 02141

1A-6 VA CAPITAL, LLC 16500 COLLINS AVENUE, #3052 SUNNY ISLES, FL 33160

1A-6
NAJIA, TOUFIC M. & DONNA M. NAJIA &
MOHAMAD ALI T. NAJIA
169 MONSIGNOR OBRIEN HWY., #815
CAMBRIDGE, MA 02141

1A-6 PARK, CHRISTOPHER & YUANSHU DENG 169 MONSIGNOR OBRIEN HWY., #609 CAMBRIDGE, MA 02139

1A-6 KRAVETS, GENNADIY 350 EAST 54TH ST., APT 5B NEW YORK, NY 10022

1A-6 JIN, GUOQIANG 169 MONSIGNOR OBRIEN HWY., #602 CAMBRIDGE, MA 02141

1A-6 SHIH, YI-HSIN 169 MONSIGNOR OBRIEN HWY., #811 CAMBRIDGE, MA 02141

1A-6 KIT TUNG IP 169 MONSIGNOR OBRIEN HWY., #415 CAMBRIDGE, MA 02141 1A-6 CHIAVOLI, ADAM P.& LAURA M. CHIAVOLI 169 MONSIGNOR OBRIEN HWY., #701 CAMBRIDGE, MA 02141

1A-6 PALL, HARPREET 259 EDGERSTOURNE RD PRINCETON , NJ 08540

1A-6 PORTNOY, MICHAEL & LINDA PORTNOY 169 MONSIGNOR OBRIEN HWY. - UNIT 606 CAMBRIDGE, MA 02141

1A-6 PATEL, NARENDRA & NISHA N. PATEL 422 WEST GROVE ST MIDDLEBORO, MA 02346

1A-6 LIANG, SHAOYANG & WEN CUI 169 MONSIGNOR OBRIEN HWY., #716 CAMBRIDGE, MA 02141

1A-6 PAVLAKOS, NICK 215 EAST 96TH ST., APT.#8J NEW YORK, NY 10128

1A-6 TRIVERI, CHAD M. 169 MONSIGNOR OBRIEN HWY - UNIT 615 CAMBRIDGE, MA 02141

1A-6 CAMBRIDGE AFFORDABLE HOUSING CORPORATION 362 GREEN ST CAMBRIDGE, MA 02141

1A-6 WANG, XIANZHE 169 MONSIGNOR OBRIEN HWY., #715 CAMBRIDGE, MA 02141

1A-6 YUN, GAO 169 MONSIGNOR OBRIEN HWY UNIT #604 CAMBRIDGE, MA 02141 1A-6 YEUNG, KAI KWAN & SEAN CURRAN 88 MORGAN ST #4304 JERSEY CITY, NJ 07302

1A-6 TAMULAITES, LINDA L. 688 POST LANE SOMERSET, NJ 08873

1A-6 HARRIS, CHRISTOPHER &SHARMAN E. GINGRICH TRS, THE CHRISTOPHER F. HARRIS TR 171 RIVER RD WEST NEWBURY, MA 01985

MATRANGA, LENA 169 MONSIGNOR OBRIEN HWY - UNIT# 508 CAMBRIDGE, MA 02139

1A-6 LI, CHENGYU 287 LANGLEY RD #38 NEWTON, MA 02459

1A-6 TAN, CHIA LIN 31 WINSLOW RD #3 CAMBRIDGE, MA 02138

1A-6 KIM, GIMAN & JIN SOOK KIM 8817 LONGWOOD ST FULTON, MD 20759

1A-6 VILLANI, DEBRA S. 169 MONSIGNOR OBRIEN HWY., # 814 CAMBRIDGE, MA 02141

1A-6 TAKAHASHI, IPPEI & DEAWN C. TAKAHASHI 169 MSGR O'BRIEN HWY.#707 CAMBRIDGE, MA 02139

1A-6 HE, SHUANG 270 PALFREY ST WATERTOWN, MA 02472 22 water St.

1A-6 ZHOU, YIZHOU 169 MONSIGNOR OBRIEN HWY. UNIT 510 CAMBRIDGE, MA 02141

CHENG, CHENG
169 MONSIGNOR OBRIEN HWY UNIT #509
CAMBRIDGE, MA 02139

1A-189-194-190-193 DW PROPCO W, LLC C/O DIVCO WEST 575 MARKET STREET - 35TH FLOOR SAN FRANCISCO, CA 94105

1A-6 LU KUANGYE 169 MONSIGNOR OBRIEN HWY UNIT 711 CAMBRIDGE, MA 02141 1A-6 REDDY HOMES LLC 79 CANTERBURY HILL RD ACTON, MA 01720

1A-6

1A-6 XU BO 45 BERNARD ST LEXINGTON, MA 02420

1A-6
PUFFER DAVID A
169 MONSIGNOR O BRIEN HWY - UNIT 214
CAMBRIDGE, MA 02141

7-34 JOHN FAHIMIAN, LLC 126 ADAMS ST MILTON, MA 02186 1A-208 DW PROPCO I LLC 575 MARKET ST 35TH FL SAN FRANCISCO, CA 94105

1A-6
WASSEN DAVID A & INYANG ISONG WASSEN
169 MONSIGNOR OBRIEN HWY - UNIT 512
CAMBRIDGE, MA 02141

7-35 SOMERBRIDGE HOTEL, LLC 10 CABOT ROAD - SUITE 209 MEDFORD , MA 02155

1A-6 SHEN, YING 169 MONSIGNOR OBRIEN HWY #413 CAMBRIDGE, MA 02141

1A-6 SONG HANHAN 169 MONSIGNOR OBRIEN HWY - UNIT 502 CAMBRIDGE, MA 02141

HILDENBRAND COLIN HOBBS MATTHEW 169 MONSIGNOR OBRIEN HIGHWAY #611 CAMBRIDGE, MA 02141 1A-6 URBAN, BRYAN J. DIANA .L URBAN 169 MONSIGNOR O'BRIEN HWY, UNIT 516 CAMBRIDGE, MA 02141

1A-6 JIN, LIN 169 MONSIGNOR OBRIEN HWY UNIT 402 CAMBRIDGE, MA 02141 1A-6 NINA INVESTMENT LLC C/O VMS PO BOX 600804 NEWTONVILLE, MA 02460 1A-192 DW PROPCO U LLC 301 HOWARD ST - STE 2100 SAN FRANCISCO, CA 94105

1A-6 JKBL 169 LLC 41 BARTLETT AVE LEXINGTON, MA 02420 1A-6 LI, BOYU HAINING ZHANG 169 MONSIGNOR O'BRIEN HWY 416 CAMBRIDGE, MA 02141 1A-6 YING, KENSILY 169 MONSIGNOR OBRIEN HWY #310 CAMBRIDGE, MA 02141


1A-6
ESTABROOKS, PAUL R. & LEIGHT B. TRUSTEES
OF THE P & L MIDDLESEX REALTY TRT
169 MONSIGNOR O'BRIEN HWY - UNIT #610
CAMBRIDGE, MA 02141


1A-6 MAO, WEIZHI LI ZHONGMING 169 MONSIGNOR O'BRIEN HWY - UNIT #513 CAMBRIDGE, MA 02141 1A-6 HASAN, MUBARAK S. & ALMAS Z. TRUSTEES OF THE HASAN REALTY TRUST 30 HANNAH NILES WAY BRAINTREE, MA 02184

1A-207 DW NP PROPERTY, LLC 575 MARKET ST. 35TH FLOOR C/O DIVCOWEST SAN FRANCISCO, CA 94105

NINA INVESTMENT LLC 169 MONSIGNOR OBRIEN HWY - UNIT 802 CAMBRIDGE, MA 02141 117/A/2 & A/3
CJUF III NORTHPOINT LLC
C/O CANYON CAPITAL REALTY AD LLC
2000 AVENUE OF THE STARS – 11<sup>TH</sup> FL.
LOS ANGELES, CA 90067

115/B/7 LABEN REALTY LLC 15 MCGRATH HWY SOMERVILLE, MA 02143 115/B/8
PREVITE ANTHONY D.
TR. MONSIGNOR O'BRIEN HWY TRUST
262 MCGRATH HWY
CAMBRIDGE, MA 02141

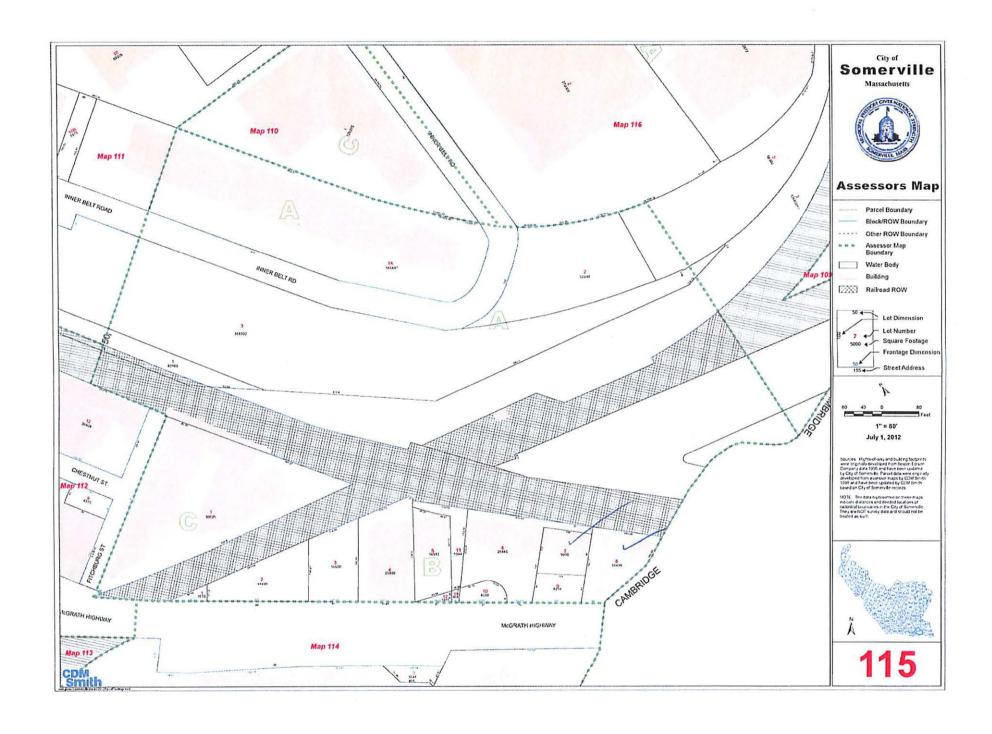

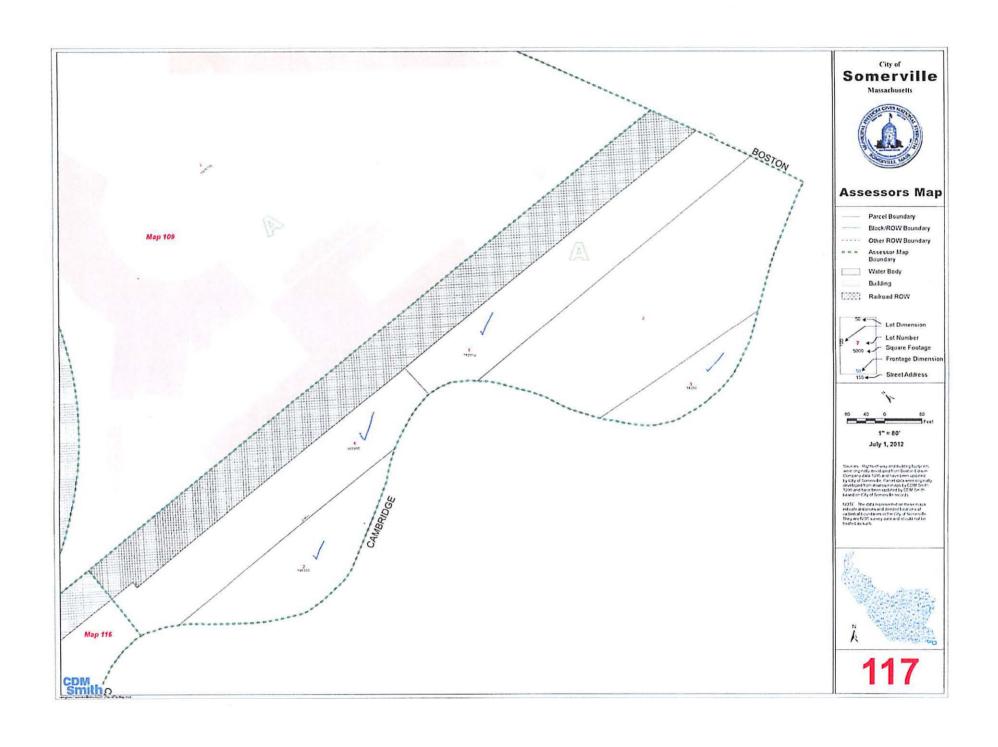

#### **0 INNER BELT RD**

Location 0 INNER BELT RD

Assessment \$6,179,200

Mblu 117/ A/ 1//

PID 1840

00870003 Acct#

Building Count 1

Owner MBTA

#### Current Value

	Assessment		
Valuation Year	Improvements	Land	Total
2016	\$0	\$6,179,200	\$6,179,200

#### Owner of Record

Owner

**MBTA** 

Co-Owner C/O MARK DOYLE R E DIRECTOR

Address

10 PARK PLAZA SUITE 5720

BOSTON, MA 02116

Sale Price \$2,000,000

Certificate

Book & Page 19013001

Sale Date

04/20/1994

Instrument 1E

#### **Ownership History**

Ownership History					
Owner	Sale Price	Certificate	Book & Page	Instrument	Sale Date
мвта	\$2,000,000		19013001	1E	04/20/1994
BOSTON & MAINE RAILROAD	\$0				

#### **Building Information**

#### Building 1 : Section 1

Year Built:

Living Area:

Replacement Cost:

**Building Percent** 

Good:

Replacement Cost

Less Depreciation:

50

Building Attributes			
Field	Description		
Style	Vacant Land		
Model			
Grade:			
Stories:			
Occupancy			
F			

#### **Building Photo**



(http://images.vgsi.com/photos/SomervilleMAPhotos//default.

#### O INNER BELT RD

Location 0 INNER BELT RD

Assessment \$9,236,100

Mblu 117/A/2//

PID 1841

Acct# 00870004 Building Count 1

Owner CJUF III NORTHPOINT LLC

#### **Current Value**

	Assessment		
Valuation Year	Improvements	Land	Total
2016	\$0	\$9,236,100	\$9,236,100

#### Owner of Record

Owner

CJUF III NORTHPOINT LLC

Sale Price

510

Co-Owner C/O CANYON CAPITAL RLTY AD LLC Address 2000 AVENUE OF THE STARS 11 FL

Certificate

Sale Date

Book & Page 55212/ 330

LOS ANGELES, CA 90067

08/20/2010

Instrument 1B

#### Ownership History

	Ov	vnership Histor	y		
Owner	Sale Price	Certificate	Book & Page	Instrument	Sale Date
CJUF III NORTHPOINT LLC	\$10		55212/ 330	18	08/20/2010
BOSTON & MAINE RAILROAD	s0				

#### **Building Information**

#### Building 1 : Section 1

Year Built:

Living Area:

0

Replacement Cost:

\$0

**Building Percent** 

Good:

Replacement Cost

Less Depreciation:

\$0

Building Attributes		
Field	Description	
Style	Vacant Land	
Model		
Grade:		
Stories:		
Occupancy		
F		

#### **Building Photo**



(http://images.vgsi.com/photos/SomervilleMAPhotos//default.

#### O INNER BELT RD

Location 0 INNER BELT RD

Assessment \$7,043,000

Mblu 117/ A/ 4/ /

PID 15500

Acct# 99000540

Building Count 1

Owner MBTA

#### **Current Value**

	Assessment		
Valuation Year	Improvements	Land	Total
2016	\$0	\$7,043,000	\$7,043,000

#### Owner of Record

Owner

MBTA

Co-Owner C/O MARK DOYLE R E DIRECTOR

Address

10 PARK PLAZA SUITE 5720

BOSTON, MA 02116

Sale Price SO

Certificate

Book & Page

Sale Date

#### **Ownership History**

		Ownership Histo	гу	
Owner	Sale Price	Certificate	Book & Page	Sale Date
TA	\$0			

#### **Building Information**

#### Building 1 : Section 1

Year Built:

Living Area:

0

Replacement Cost:

\$0

**Building Percent** 

Good:

Replacement Cost

Less Depreciation:

\$0

Building Attributes		
Field	Description	
Style	Vacant Land	
Model		
Grade:		
Stories:		
Occupancy		
Exterior Wall 1		
Exterior Wall 2		

#### **Building Photo**



(http://images.vgsi.com/photos/SomervilleMAPhotos//default.

#### **Building Layout**

Building Layout

#### O INNER BELT RD

Location 0 INNER BELT RD

Assessment \$1,387,300

Mblu 117/ A/ 3//

PID 1842

Acct# 00870005

Building Count 1

Owner CJUF III NORTHPOINT LLC

#### **Current Value**

	Assessment		
Valuation Year	Improvements	Land	Total
2016	\$0	\$1,387,300	\$1,387,300

#### Owner of Record

Owner

CJUF III NORTHPOINT LLC

Co-Owner C/O CANYON CAPITAL RLTY AD LLC

2000 AVENUE OF THE STARS 11 FL LOS ANGELES, CA 90067

Sale Price

\$10

Certificate

Book & Page 55212/ 330

Sale Date

08/20/2010

Instrument 1B

#### **Ownership History**

Ownership History					
Owner	Sale Price	Certificate	Book & Page	Instrument	Sale Date
CJUF III NORTHPOINT LLC	\$10		55212/ 330	1B	08/20/2010
BOSTON & MAINE RAILROAD	<b>\$0</b>				

#### **Building Information**

#### Building 1: Section 1

Year Built:

Living Area:

0

Replacement Cost:

\$0

**Building Percent** 

Good:

Replacement Cost

Less Depreciation:

Bullan	ng Attributes
Field	Description
Style	Vacant Land
Model	
Grade:	
Stories:	
Occupancy	Code Culto
C., Lauran 147-11 1	

#### **Building Photo**



(http://images.vgsi.com/photos/SomervilleMAPhotos//default.

#### 13-15 MCGRATH HWY

Location 13-15 MCGRATH HWY

**Assessment** \$1,626,300

Mblu 115/ B/ 7//

PID 109297

Acct# 01005180

**Building Count** 1

Owner LABEN REALTY LLC

#### **Current Value**

Assessment			
Valuation Year	Improvements	Land	Total
2016	\$432,400	\$1,193,900	\$1,626,300

#### **Owner of Record**

Owner LABEN REALTY LLC

Sale Price

\$4,150,000

Co-Owner Address

15 MCGRATH HWY

Certificate

Book & Page 50626/ 097

SOMERVILLE, MA 02143

Sale Date

01/23/2008

Instrument 1G

**Ownership History** 

Ownership History					
Owner	Sale Price	Certificate	Book & Page	Instrument	Sale Date
LABEN REALTY LLC	\$4,150,000		50626/ 097	1G	01/23/2008
PAINO ASSOC II LTD PTNERSHIP	\$1,076,700		29622/ 299	00	01/05/1999
PREVITE REALTY TRUST	\$100		24437/ 579	1A	04/07/1994

#### **Building Information**

#### **Building 1: Section 1**

Year Built:

1930

Living Area:

12736

Replacement Cost:

\$830,821

**Building Percent** 

44

Good:

Replacement Cost

Less Depreciation:

\$365,600

Building Attributes		
Field	Description	
STYLE	Store	
MODEL	Commercial	
Grade	Below Average	
Stories:	2	
Occupancy 1		

**Building Photo** 

#### 1 MCGRATH HWY

Location 1 MCGRATH HWY

Assessment \$1,273,500

Mblu 115/ B/ 8/ /

PID 1828

Acct# 01009020

Building Count 1

Owner PREVITE ANTHONY D TRUSTEE

#### **Current Value**

Assessment						
Valuation Year	Improvements	Land	Total			
2016	\$71,700	\$1,201,800	\$1,273,500			

#### Owner of Record

Owner

PREVITE ANTHONY D TRUSTEE

Co-Owner MONSIGNOR OBRIEN HWY TRUST

Address

262 MCGRATH HWY CAMBRIDGE, MA 02141

Sale Price

Certificate

Book & Page 20124/ 348

\$100

Sale Date Instrument 10/06/1989

#### **Ownership History**

Ownership History						
Owner	Sale Price	Certificate	Book & Page	Instrument	Sale Date	
PREVITE ANTHONY D TRUSTEE	\$100		20124/ 348	A	10/06/1989	
ANTHONY D. PREVITE	\$0					

#### **Building Information**

#### Building 1 : Section 1

Year Built:

1950

Living Area:

2160

Replacement Cost:

\$109,642

**Building Percent** 

Good:

Replacement Cost

Less Depreciation:

\$63,600

Building Attributes				
Field	Description			
STYLE	Coin-op CarWsh			
MODEL	Commercial			
Grade	Average			
Stories:	1			
Occupancy	1			
Exterior Wall 1	Brick/Masonry			

#### **Building Photo**



(http://images.vgsi.com/photos/SomervilleMAPhotos//\01\00 \90/30.jpg)



# City of Cambridge

MASSACHUSETTS

#### BOARD OF ZONING APPEAL

831 Mass Avenue, Cambridge, MA. (617) 349-6100

4 Bds

#### **BZA**

### POSTING NOTICE - PICK UP SHEET

The undersigned picked up the notice board for the Board of Zoning Appeals Hearing.

Name: Joseph Pereira	Date: 12/21/12
Address: 22 Water St.	·•
Case No. BZA-154854	
Hearing Date: $\frac{1/6/22}{}$	

Thank you, Bza Members



#### CITY OF CAMBRIDGE

**Community Development Department** 

IRAM FAROOQ
Assistant City Manager for
Community Development

To: Planning Board

From: Community Development Department (CDD) Staff

SANDRA CLARKE
Deputy Director
Chief of Administration

Date: December 29, 2021

KHALIL MOGASSABI Deputy Director Chief of Planning

Re:

Cellular Antenna Installation BZA-154854: 22 Water Street

The proposal involves the installation and operation of a new wireless antenna facility on the rooftop of 22 Water Street (Planning Board Special Permit PB-247). Seven (7) antennas are proposed to be installed on top of the existing rooftop mechanical screen, and associated equipment will be mounted behind the screen.

The proposed installation includes twenty small-scale antennas, that are grouped together into ten large antennas. The large antennas have a height of 5 feet and are sited prominently on top of the rooftop screen. All visible antennas are proposed to be painted to match the penthouse screening. As this is a new installation, consideration should be given to the principle of co-location and the potential for multiple, future carriers to locate on the same building.

Staff suggest careful review of the installation to determine if there are better ways to conceal the antennas, rather than mounting them on top of the penthouse screening. Consideration should also be given to how other carriers' antennas can be accommodated in the future. The following are suggestions to help improve the visual impacts of the proposed new installation:

- To the extent feasible, mount the antennas behind or on the face of the
  penthouse screen, and below the parapet line. This will provide a visual
  backdrop and minimize the obtrusiveness of the antennas against the skyline
  when viewed from ground level.
- To the extent feasible, consider using stealth enclosures or other screening devices to better conceal the antennas. It appears that such structures could easily be accommodated on the rooftop of 22 Water Street.
- 3. To ensure that this new installation can successfully accommodate multiple carriers without creating unnecessary visual clutter, a plan should be prepared that demonstrates potential installation opportunities. The plan should consider the following design principles:
  - Utilize stealth facilities to completely conceal antennas.

344 Broadway Cambridge, MA 02139 Voice: 617 349-4600 Fax: 617 349-4669 TTY: 617 349-4621

www.cambridgema.gov

- Employ a symmetrical, balanced design layout for all antennas.
- Avoid interrupting architectural lines, or horizontal or vertical reveals. Antennas should be positioned and spaced to complement the architecture of the building.
- Ensure antennas are the same length, width and depth, including existing antennas.
- Utilize the smallest mounting brackets available so that the antennas can be mounted as close as possible to the façade surface.

December 29, 2021 Page 2 of 2