

CITY OF CAMBRIDGE MASSACHUSETTS **BOARD OF ZONING APPEAL** 831 MASSACHUSETTS AVENUE CAMBRIDGE, MA 02139 617 349-6100

BZA APPLICATION FORM

Plan No: BZA-017115-2019


GENERAL INFORMATION

The undersigned hereby petitions the Board of Zoning Appeal for the following: Special Permit: Volume Variance: Appeal:
PETITIONER: 30 Berkshire Street LLC C/O James Hefferman, Navem Partners
PETITIONER'S ADDRESS: 18 Newbury Street, 4th Floor Boston, MA 02116
LOCATION OF PROPERTY: 30 Berkshire St Cambridge, MA
TYPE OF OCCUPANCY: 3 unit dwelling ZONING DISTRICT: Residence C-1 Zone
REASON FOR PETITION:
New Structure
DESCRIPTION OF PETITIONER'S PROPOSAL:
Variance: To construct three unit dwelling slightly bigger than the building that was damaged by fire in violation of dimensional standards.
As previously approved by the Board of Zoning of Appeal on August 28, 2017 (case no. BZA-013619-2017).
(To the extent required) Special Permit: To park cars within 5 feet from property line. (Approved on 8/28/17-5+11 vel.d)
SECTIONS OF ZONING ORDINANCE CITED:
Article 5.000 Section 5.31 (Table of Dimensional Requirements).
Article 6.000 Section 6.44.1.B & G (Parking Setbacks).
Original Signature(s): (Petitioner(s) / Owner) (Print Name)
Address: Bertsline Street LLC Ve Navan Portners LLC Boston, MA 02/16 Tel. No.: (617) 803-7622 E-Mail Address: jheffernen @ Javenparmers. Co

BZA APPLICATION FORM - OWNERSHIP INFORMATION

To be completed by OWNER, signed before a notary and returned to The Secretary of the Board of Zoning Appeals.

I/We_ 30 Berkshire Street, LLC (OWNER)
Address: c/o Navem Partners LLC, 18 Newbury Street, 4th Floor, Boston, MA 02116
State that I/We own the property located at 30 Berkshire Street, Units 1-3, Cambridge, MA
which is the subject of this zoning application.
The record title of this property is in the name of
30 Berkshire Street, LLC
*Pursuant to a deed of duly recorded in the date 3/1/2019 , Middlesex South
County Registry of Deeds at Book 72290 , Page 245 (Unit 1), 30 (Unit 2), 162 (Unit 3)
County Registry of Deeds at Book /2290, Page; or
Middlesex Registry District of Land Court, Certificate No
Book Page
SIGNATURE BY LAND OWNER OR AUTHORIZED TRUSTEE, OFFICER OR AGENT* A Many of 30 Bc holly Street, UC *Written evidence of Agent's standing to represent petitioner may be requested.
Commonwealth of Massachusetts, County of
The above-name Sames Heffernay personally appeared before me,
this of May, 2019, and made oath that the above statement is true.
The Notary Notary
My commission expires March 21, 2025 (Notary Seal).
If ownership is not shown in recorded deed, e.g. if by court order, recended deed, or inheritance, please include documentation.

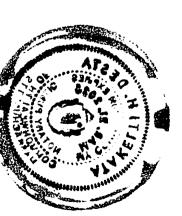

BZA APPLICATION FORM

SUPPORTING STATEMENT FOR A VARIANCE

EACH OF THE FOLLOWING REQUIREMENTS FOR A VARIANCE MUST BE ESTABLISHED AND SET FORTH IN COMPLETE DETAIL BY THE APPLICANT IN ACCORDANCE WITH MGL 40A, SECTION 10:

A) A Literal enforcement of the provisions of this Ordinance would involve a substantial hardship, financial or otherwise, to the petitioner or appellant for the following reasons:

The literal enforcement of the provisions would involve a substantial hardship to the petitioner; the hardship related to the structure being damaged by a fire in the neighborhood and that the rebuilding of the structure required some expansion in order to improve the safety and visual impact of the structure.

B) The hardship is owing to the following circumstances relating to the soil conditions, shape or topography of such land or structures and especially affecting such land or structures but not affecting generally the zoning district in which it is located for the following reasons:

The hardship owed to the shape of the nonconforming lot fully occupied by a structure, where any modifications would require zoning relief.

C) DESIRABLE RELIEF MAY BE GRANTED WITHOUT EITHER:

1) Substantial detriment to the public good for the following reasons:

The proposed structure would benefit the public that the structure that had been damaged by fire would not only be restored but improved by the work that is proposed.

- 2) Relief may be granted without nullifying or substantially derogating from the intent or purpose of this Ordinance for the following reasons:
 - Relief could be granted without substantial detriment to the public good or nullifying or substantially derogating from the intent and purpose of the ordinance.
- * If You have any questions as to whether you can establish all of the applicable legal requirements, you should consult with your own attorney.

BZA APPLICATION FORM

SUPPORTING STATEMENT FOR A SPECIAL PERMIT

Please describe in complete detail how you meet each of the following criteria referring to the property and proposed changes or uses which are requested in your application. Attach sheets with additional information for special permits which have additional criteria, e.g.; fast food permits, comprehensive permits, etc., which must be met.

Granting the Special Permit requested for 30 Berkshire St Cambridge, MA

	(location) would not be a detriment to the public interest because:
A)	Requirements of the Ordinance can or will be met for the following reasons:
B)	Traffic generated or patterns of access or egress would not cause congestion hazard, or substantial change in established neighborhood character for the following reasons:
<i>c</i>)	The continued operation of or the development of adjacent uses as permitted in the Zoning Ordinance would not be adversely affected by the nature of the proposed use for the following reasons:
<i>D</i>)	Nuisance or hazard would not be created to the detriment of the health, safety and/or welfare of the occupant of the proposed use or the citizens of the City for the following reasons:
E)	For other reasons, the proposed use would not impair the integrity of the district or adjoining district or otherwise derogate from the intent or purpose of this ordinance for the following reasons:

BZA APPLICATION FORM

DIMENSIONAL INFORMATION

APPLICANT: Navem Partners LLC PRESENT USE/OCCUPANCY: Multifamily

LOCATION: 30 Berkshire St Cambridge, MA ZONE: Residence C-1 Zone

PHONE:		REQUESTED US	SE/OCCUPANCY: Mult	tifamily		
		EXISTING CONDITIONS	REQUESTED CONDITIONS	ORDINANCE REQUIREMENTS		
TOTAL GROSS FLOOR AF	REA:	3660	3813	2294	(max.)	
LOT AREA:		3058	3058	5000	(min.)	
RATIO OF GROSS FLOOP	R AREA	1.2	1.2	.075	(max.)	
LOT AREA FOR EACH DW	ELLING UNIT:	0	Jnit 2: 1010SF,	1500SF	(min.)	
SIZE OF LOT:	WIDTH	37'8"	37'8"	50'0"	(min.)	
	DEPTH	85'0"	85'0"	0		
SETBACKS IN FEET:	FRONT	16'8"	16'8"	16'8"	(min.)	
	REAR	43'10"	38'9"	20'0"	(min.)	
	LEFT SIDE	0	0	0	(min.)	
	RIGHT SIDE	4'6"	4'6"	7'6"	(min.)	
SIZE OF BLDG.:	HEIGHT	35'0"	35'0"	35'0"	(max.)	
	LENGTH	35 ' 5 "	41'0"	0		
	WIDTH	36'6"	36'6"	0		
RATIO OF USABLE OPEN TO LOT AREA:	SPACE	60%	55%	30%	(min.)	
NO. OF DWELLING UNIT	<u>'S:</u>	3	3	0	(max.)	
NO. OF PARKING SPACE	<u>s:</u>	3	3	3	(min./max)	
NO. OF LOADING AREAS	i <u>:</u>	0	0	0	(min.)	
DISTANCE TO NEAREST ON SAME LOT:	BLDG.	N/A	N/A	N/A	(min.)	

Describe where applicable, other occupancies on same lot, the size of adjacent buildings on same lot, and type of construction proposed, e.g.; wood frame, concrete, brick, steel, etc.

Wood fram construction, similar size to surrounding buildings.

^{1.} SEE CAMBRIDGE ZONING ORDINANCE ARTICLE 5.000, SECTION 5.30 (DISTRICT OF DIMENSIONAL REGULATIONS).

TOTAL GROSS FLOOR AREA (INCLUDING BASEMENT 7'-0" IN HEIGHT AND ATTIC AREAS GREATER THAN 5')
DIVIDED BY LOT AREA.

^{3.} OPEN SPACE SHALL NOT INCLUDE PARKING AREAS, WALKWAYS OR DRIVEWAYS AND SHALL HAVE A MINIMUM DIMENSION OF 15'.



CITY OF CAMBRIDGE MASSACHUSETTS BOARD OF ZONING APPEAL 831 MASSACHUSETTS AVENUE CAMBRIDGE, MA 02139 617 349-6100

Plan No:

2019 MAY - 1 PM 3: 37

OFFICE OF THE CITY CLERK CAMBRIDGE MASSACHUSETTS

BZA APPLICATION FORM

GENERAL INFORMATION

The under	signed h	nereby peti	ions the Boa	rd of Zoning	Appeal fo	or the following:	
Special Pe	ermit :			Variance	:	<u>/</u>	Appeal:
PETITIONE	ER:	30 Berk	shire Stre	et LLC C/) James	Hefferman, Navem	Partners
PETITIONE	ER'S AD	DRESS:	18 New	bury Stree	et, 4th	Floor Boston, MA	02116
LOCATION	OF PR	OPERTY:	30 Berk	shire St	Cambrid	ge, MA	
TYPE OF C	OCCUPA	NCY:	3 unit dwe	elling		_ ZONING DISTRICT :	Residence C-1 Zone
REASON F	FOR PET		Structure				
DESCRIPT	ION OF	PETITIONE	R'S PROPOS	SAL:			
				it dwellir dimensior			the building that was
As previ			by the B	oard of Zo	oning of	Appeal on August	28, 2017 (case no.
(To the	extent	require	d) Specia	l Permit:	To park	cars within 5 fe	eet from property line.
		NING ORDI	NANCE CITE				
Article	Ord Baroner		-,	27 I	EL AND DOWN	imensional Requir	rements).
Article	-		_ 50001011	Original Sig		erking Setbacks).	lefter
					,	James 30 Berr	(Petitioner(s) / Owner) 88 Herran (Print Name) 18 Cure Street LLC
					Address Tel. No. :	Bosta	worry Street 4th Hoor
					iei. No	(61+)	208-10 NC





WARNING:

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concerning the contents, correctness and sufficiency of the attachment and its contents for their purposes. 3. to the extent permitted by law, all conditions and warranties concerning this document or any use to which they may be put (whether as to

quality, outcome, fitness, care, skill or otherwise) whether express or implied by statute, common law, equity, trade, custom or usage or otherwise are expressly excluded. 4. any person using or relying document releases and indemnifies and

will keep indemnified Joe The Architect LLC against all claims, liabilities, loss, costs and expenses arising directly or indirectly out of or in connection with such use or reliance including without limitation any misrepresentation, error or defect in this document.

Contractors to use Architectural drawings for set out. Contractors to check and verify all Dimensions on Site prior to Construction/Fabrication. Figured Dimensions take precedence over Scaled Dimensions. Any discrepancies should be immediately referred to the Architect. All work to comply with I.B.C. Statutory Authorities and relevant American Standards.

Index of Drawings

A000	COVER SHEET
LS001	LAND SURVEY PLAN SHOWING PROPOSED CONDOMINIUMS
SHT1	LAYOUT AND MATERIALS
SHT2	GRADING, DRAINAGE & UTILITIES
SHT3	DETAILS
A001	GENERAL NOTES, CODES, & REGULATIONS

DRAWING TITLE

ARCHITECTURAL GENERAL INFORMATION EXISTING/DEMOLITION SITE PLAN A020 PROPOSED SITE PLAN A021

A110 COMMON BASEMENT FLOOR PLAN A111 UNIT 1 FLOOR PLAN A112 UNIT 2 FLOOR PLAN A113 **UNIT 3 FLOOR PLAN** A114 **ROOF PLAN**

SHEET

NUMBER


A120 COMMON BASEMENT REFLECTED CEILING PLAN A121 UNIT 1 REFLECTED CEILING PLAN A122 UNIT 2 REFLECTED CEILING PLAN A123 UNIT 3 REFLECTED CEILING PLAN

NUMBER DRAWING TITLE A130 COMMON BASEMENT ARCHITECTURAL ELECTRIC & FINISH PLANS A131 UNIT 1 ARCHITECTURAL ELECTRIC & FINISH PLANS UNIT 2 ARCHITECTURAL ELECTRIC & FINISH PLANS A133 UNIT 3 ARCHITECTURAL ELECTRIC & FINISH PLANS EXTERIOR ELEVATIONS A201 EXTERIOR ELEVATIONS **BUILDING SECTIONS** A211 **BUILDING SECTIONS** WALL TYPE AND WINDOW SCHEDULE AND EQUIPMENT A300 A400 WALL SECTIONS A401 WALL SECTIONS A402 WALL SECTIONS ENLARGED WALL SECTIONS A430 DOOR LEGEND A431 SCHEDULES BASEMENT INTERIOR ELEVATIONS A601 BASEMENT INTERIOR ELEVATIONS UNIT 1 INTERIOR ELEVATIONS

SHEET

SHEET NUMBER DRAWING TITLE UNIT 1 INTERIOR ELEVATIONS UNIT 2 INTERIOR ELEVATIONS UNIT 2 INTERIOR ELEVATIONS UNIT 3 INTERIOR ELEVATIONS UNIT 3 INTERIOR ELEVATIONS **GENERAL NOTES** TYPICAL DETAILS TYPICAL DETAILS S0.3 FOUNDATION PLAN S1.0 FIRST FLOOR FRAMING PLAN SECOND FLOOR FRAMING PLAN S1.3 THIRD FLOOR FRAMING PLAN S1.4 ROOF FRAMING PLAN S2.1 SECTIONS S2.2 SECTIONS FIRE PROTECTION LEGEND, NOTES AND DETAILS F002 FIRE PROTECTION LEGEND, NOTES AND DETAILS F100 FIRE PROTECTION CEILING PLANS FIRE PROTECTION CEILING PLANS

SHEET NUMBER DRAWING TITLE E001 ELECTRICAL LEGEND, NOTES & SPECIFICATIONS E002 ELECTRICAL FIRE ALARM RISER E100 ELECTRICAL FIRE ALARM PLAN E101 ELECTRICAL FIRE ALARM PLAN H001 **HVAC LEGEND** H002 **HVAC SCHEDULES** HVAC DETAIL SHEET No. 1 H004 HVAC DETAIL SHEET No. 2 H005 HVAC SEQUENCES OF CONTROL H100 HVAC DUCTWORK PLAN H101 HVAC DUCTWORK PLAN HVAC DUCTWORK PLANS **HVAC PIPING PLANS** H201 **HVAC PIPING PLANS HVAC PIPING PLANS**

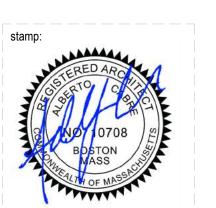

project number 092 drawing number A000 revision 8

07/13/2018



PROJECT NAME:

BERKSHIRE STREET RESIDENCE

30 Berkshire Street, Cambridge, MA 02141

Cambridge,

Berkshire

PROJ **30**

GENERAL NOTES

- 1. The work shall conform to the applicable building code, and other ordinances, codes and regulations listed in the specifications or on the drawings, and required by local building authorities. The governing codes, rules and regulations are collectively referred to as "the code". The contractor shall report any inconsistencies, conflicts or omissions he may discover to the architect for interpretation prior to performing the work.
- The general contractor shall contact owner or property manager to determine the rules of the building relative to construction; when and how deliveries can be made, what phases and types of construction may be done one regular or overtime basis, and in general any special building requirements which will affect the cost of all work borne by the general contractor. All work shall conform to all base building standard specifications and building regulations, which the contractor shall obtain prior to submission of bid.
- The general contractor shall be responsible for the sub-contractors receipt of complete sets of these documents, as well as all future addenda, field directives and change orders, etc.
- 4. Any contract document between parties shall be considered part of the general conditions of this work.
- The contractor shall coordinate with the building management the storage of all materials and shall provide protection as necessary to prevent vandalism and loss of materials by theft or damage sustained due to exposure to inappropriate environmental conditions and will make good any damage or losses at his own expense without charge to the owner.
- Where adjacent areas beyond the immediate construction area will be occupied during the construction period, the contractor shall: Conform to owners and tenant requirements for hours of construction
- operations, access to tenant spaces and allowable noise level during tenant business hours. Construction operations shall not block hallways or means of egress for tenants of building.
- Construction operations shall not cause interruptions of electrical services. To the tenants of the building without prior notification and approvals. Properly protected all floors, mail chutes and stair doors in public areas
- subject to construction traffic. Shoe wiping mats will be installed at all openings between construction areas and all public spaces. All active areas shall be kept clean and free from debris. Erect and maintain temporary bracing, lights, dustproof partitions, barricades, fences, and warning signs as necessary to prevent injury,
- noise, dust and inconvenience to other tenants, the public, and to prevent damage to adjacent construction which is to be left in place.
- All cutting, chasing, drilling or demolition of walls, slabs, etc. Requiring the use of jack hammers or other heavy hand or power tools shall be performed after regular business hours on an overtime basis if necessary, unless the building management and any affected tenants provide a written waiver expressly permitting otherwise.
- The contractor shall assume sole and complete responsibility for job site conditions during construction of this project including safety of all persons and property. This requirement shall apply continuously and not be limited to normal working hours. The contractor shall provide public protection as necessary and required by governing agencies, having jurisdiction, until client acceptance of
- The general contractor in solely responsible for the provision and maintenance of all bracing, shoring, enclosures, barriers or scaffolding required to provide a safe working environment as dictated by site conditions and the progress of
- 10. During the entire construction period, all exits, exit lighting, fire protection devises and alarms shall be continuously maintained, in conformance with local building code and other governing entity requirements. Unless otherwise noted, all existing, services and devices shall remain active.
- 11. The general contractor shall always protect the property of the client and the building owner. This includes but is not limited to windows, floor and ceiling finishes, public toilets, elevators, doors & bucks, electrical and air-conditioning equipment. The general contractor shall also properly protect any adjoining property, any damage to the same caused by the contractor's work or workmen must be made good, in a timely fashion, without delay. Patching and replacement of damaged work shall be done at the cost and expense of the contractor responsible for the damage. The general contractor shall be fully responsible for all his sub-contractors. If the contractor fails to complete the repairs in a timely fashion, said repairs will be made by a contractor selected by the owner's representative and back charged accordingly. Timely fashion includes, but is not limited to any amount of time which will limit the disruption of the operation of tenant's work places, the buildings operations, access and compromise safety or presents a health risk, etc.
- !. The contractor shall indemnify and save harmless the landlord, the tenant, and architect against any and all claims and demands for the damage to the property of any person, firm or individual or for personal injuries (including death) arising out of, or suffered while engaged in, or caused, in whole or in part, by the execution of the work; he shall well and truly defend the landlord, tenant and architect and shall pay all monies awarded for such damages or injuries (including death), all costs including attorney's fees sustained, and shall obtain a full acquaintance and release in favor of the landlord, tenant and architect, unless such liability results solely from the negligence of the landlord, tenant, architect, its agents or employees
- 13. The architect shall not be held responsible for the performance of any work, nor for the means and methods of construction chosen by the general contractor or any of his sub-contractors, nor shall he guarantee the performance of their
- 14. The contractor shall perform daily cleaning of the job site during the construction period and shall protect finished work from damage, immediately prior to tenant occupancy, the contractor shall perform final cleaning of the work area including, but not limited to, wet wiping of furniture, casework, and wall covering, washing and waxing of VCT flooring, and the vacuuming of carpet. All
- cleaning shall be in accordance with manufacturers' recommendations. 15. The general contractor is responsible to coordinate work of all sub-contractors and shall perform such miscellaneous work as may be necessary for them to complete their work. It is expected that the general contractor shall also closely coordinate his work with that of all other vendors retained by the client to assure
- that all schedules are met and that work proceeds without delay. 16. Bidders, before submitting proposals, shall visit and carefully examine the area affected by the work to familiarize themselves with the existing conditions and the difficulties that will affect the execution of the work. Submission of a proposal will be construed as evidence that such an examination has been made, and later claims will not be recognized for extra labor, equipment, or materials, required because of difficulties encountered which could have been reasonably foreseen had such an examination been made. The general contractor shall verify all conditions and dimensions on the job site and report any and all discrepancies and/or unusual conditions to the architect prior to
- finalizing bids or commencement of any construction. 7. The general contractor shall make known all limitations, exclusions, or modifications to the project during the bid selections period. All limitations, exclusions, or modifications not itemized in the bid proposal documents are presumed "included", in which case no additional monies will be allocated for
- 18. All work costs submitted for this project are furnished without obligation; the client reserves the right to accept or reject any proposal or part of any cost
- 19. Existing construction and dimensions shown are per existing drawings. All existing information must be verified in the field. Neither the owner nor the architects are responsible for accuracy of existing information. Existing construction conditions in areas where new work is not planned may be not completely shown.
- 20. Within one (1) week, (5 business days) of the award of this contracts, prior to mobilization for any work, the general contractor shall furnish a construction schedule showing chronologically the phases of his work, and all related work for the completion of the project. This schedule shall indicate all ordering lead times, length of time for each phase, its start and completion, with a projected completion date.
- 21. Contractor and subcontractors shall attend job meetings as required by this
- 22. The contractor shall obtain all permits for all site development work, pay all fees for permits, and check all governing authorities' specifications for but not limited to gutters, sidewalks, poles, and other structures, including the removal or relocation of existing utilities or other physical objects shown on plans or otherwise noted.
- 23. All required permits must be obtained from the fire department prior to start of
- 24. All costs for inspections and/or tests shall be the responsibility of the general contractor, unless noted otherwise.

- 25. The general contractor shall pay the expenses for all transportation; hoisting and elevator use charges on all his materials or equipment to the point of use, and shall be responsible for all unloading, checking and storage of the same regarding this
- 26. The general contractor shall make all arrangements, maintain and pay all costs for temporary water, plumbing, power, lighting, heating or ventilation as he may require to properly conduct his work.
- 27. Do not scale these drawings; written dimensions shall govern. Should any dimensional discrepancies be encountered, clarifications shall be obtained from the office of the architect.
- 28. Large scale details shall govern over smaller scale plans and elevations. 29. Install all equipment and materials as per manufacturers' recommendations. Any difficulties are to be reported to the architect immediately.
- 30. The contractor and each subcontractor shall warrantee all work performed by him directly for a minimum period of one (1) year. All defects occurring in the guaranteed period shall be corrected at no additional cost.
- 31. The site and buildings shall be maintained accessible to and functional for the physically handicapped. All ramps shall be fitted with a non-slip finish. 32. The client, architect, consultants and all inspectors from pertinent agencies shall be
- permitted access to the job site at all times during normal working hours. 33. The general contractor shall provide all labor, materials, and equipment as necessary to execute all work as shown on these drawings except where noted as not in contract (N.I.C.). Unless otherwise noted on these drawings or in the specifications as being not in contract or existing, all items, materials, etc., And the

installation of same are a part of the contract defined by these drawings and

- specifications. 34. Minor details not shown or specified, but necessary for proper construction of any part of the work, shall be included as if they were indicated in the drawings, unless otherwise agreed upon. Where the contract, construction notes or drawings call for any work of a more stringent nature than that required by the building code, or any other entity having jurisdiction over the work, the work of the more stringent nature
- called shall be furnished in all cases. 35. Details are intended to show the intent of the design. Minor modifications may be required to suit the field dimensions or conditions and such modifications shall be included as part of the work of the contract.
- 36. All work shall be executed in a workmanlike manner by mechanics and tradesmen skilled in their respective trades and in accordance with the best practices of the trades involved.
- 37. All work shall be plumb, level and true. The contractor lay out all work and establish all points, grades, lines and levels and assume full responsibility for the same. 38. All exterior wall dimensions are to face of concrete block or to face of stud, unless
- 39. The contractor shall confirm the availability and delivery times for all specified items upon receipt of the contract documents. Should any of the specified items availability pose a delay to the on-time completion of the project, the contractor shall notify the client immediately and propose an equivalent substitution if such a delay is not acceptable to the client.
- 40. Substitution of all equals shall be only as approved by the office of the architect. Where the term "or equal" is used the architect shall be the sole judge of equality based upon the information furnished by the contractor. Substitutions must be accepted in writing before they may be used.
- 41. The general contractor shall have received architect's approval for each sample submitted for all exposed materials, hardware and finishes required by this contract prior to the order placement, or use.
- 42. If the general contractor, the owner, or the owner's representative substitutes a material, method of attachment, revises a construction detail, or in any way alters the work such that in no longer conforms to these documents, without the written acceptance of the office of the architect; such action will relieve the architect of any responsibility or liability including but not limited to aesthetic consequences, subsequent failure(s) and personal or property damage attributable to this change.
- 43. The architect's approval or review of separate individual item(s) shall not constitute the review of and assembly in which the item functions within. 44. "Shop drawings" that contain excessive errors or that are incomplete or inadequate
- may be returned "unchecked" and any costs incurred for the resultant delays will be the responsibility of the contractor. 45. Approved "shop drawings" shall not relieve the contractor of obligations or responsibilities for deviations from the requirements of these contract documents,
- unless the office of the architect is notified of, and specifically approves of such deviations at the time of submission. 46. Approved "shop drawings" shall not relieve the general contractor's obligation for coordination nor waive responsibility for errors and omissions in the submittals,
- including "field measure" 47. Unless noted otherwise a minimum of 1" (one inch) clearance between property
- lines and any new construction like walls, footings, etc. Shall maintained. 48. Any changes in the scope of work, or in construction details, whether due to field conditions, or omissions, by the contractor, architect or owner, shall be documented by the architect and approved, prior to execution.
- 49. Should the general contractor claim that an issue, directed revision or change to the original contract involves additional cost under his contract, he shall give written notice within a period of not more than three (3) weeks (15 business days), but shall not proceeding to execute the work, until written approval for the change request is received. No such claims shall be valid unless so made. Unless otherwise agreed, no payment for such claims will be made until final settlement.
- 50. All claims for additional work will be submitted in writing for the client's approval. The contractor shall include a complete narrative description of the work to be performed as well as, materials to be used, the room number of the area or space being worked in and under whose authorization the work to be performed was
- 51. The presence of a representative of the architect on the job site does not imply concurrence with or the approval of any work. The general contractor shall call to the attention of the office of the architect, in writing, with any specific items for which acceptance is required.
- 52. Upon substantial completion of work the general contractor shall notify the office of the architect to prepare a "punch list" of corrections and unsatisfactory and/or incomplete work conditions. Final payment will be contingent on the completion of these items under the terms of the owner-contractor agreement.
- 53. The contractor shall maintain at the site, for the owner, one record copy of all drawings, permits, approved shop drawings, submittals and samples on which to record all changes during construction. Access to these shall be provided for the use of all trades, client representatives and the architect, during all phases of construction.
- 54. During construction, actual locations shall be indicated to scale in red ink on the owner's record drawings for all runs of mechanical and electrical work including concealed work which deviates from the drawings. Upon completion of the project, including all punch list items, this information shall be neatly transferred by the contractor to a set of drawings, which shall be marked "as built set" and copies shall be provided to both the owner and the architect. Within three (3) weeks (15 business days) of the receipt of the "as built set" approval for final payment to the contractor shall be granted or reasonable cause shown why such approval has been denied.
- 55. Prior to the completion of his work the general contractor shall assemble and furnish the client/owner, in a loose-leaf binder(s), a complete set of manufacturers catalogues, operating instructions, maintenance instructions and similar data, as well as all guarantee(s) for all equipment and operable devices furnished or installed by the general contractor under this contract, and shall orient and instruct the personnel designated by the client/owner in the operation of all such eauipment.
- 56. The contractor shall immediately notify the owner if mold, or asbestos is uncovered. The owner shall retain a qualified consultant who shall arrange for the prompt identification, testing, treatment, remediation and storage of the mold or asbestos as required by law and good construction practices. The architect shall bear no responsibility for work related to these materials.
- 57. The contractor is advised that the premise has not been tested for lead paint or other potentially hazardous materials. The contractor shall use all appropriate precautions in the carrying out of all construction operations which might disturb such materials.
- 58. All contractors shall carry property damage and public liability insurance as required by any governing agencies having jurisdiction and complying with statutory requirements for disability and workmen's compensation.

PROJECT DATA	
PROPERTY CLASS	CONDOMINIUM
STATE CLASS CODE	102
MAP/LOT	40-140-1
NEIGHBORHOOD	WELLINGTON HARRINGTON - NEIGHBORHOOD 3

CITY OF CAMBRIDGE ZONING ORDINANCE; INCLUDING AMMENDMENTS APPROVED BY THE CITY COUNCIL UP TO ORDINANCE #1382 ORDAINED ON MAY 25, 2016.

ZONING MAP OF THE CITY OF CAMBRIDGE ADOPTED FEB. 13, 1961 WITH CHANGES THROUGH AND INCLUDING ORDINANCE #1372 OF OCT. 19, 2015.

APPLICABLE CODES & REGULATIONS

BUILDING	-780 CMR Massachusetts state building code (MSBC) 9th edition -international building code (ibc) 2015
ENERGY	-International energy conservation code (IECC) 2015, with MA amendments
PLUMBING	-248 CMR 10.00 Massachusetts uniform state plumbing code -Massachusetts general law (MGL) chapter 128 section 26G (auto sprinkler system

-521 CMR Massachusetts Architectural Access Board (MAAB) 1/27/06 ACCESSIBILITY - 2010 American Disability Act (ADA) standards

DIMENSIONAL REGULATIONS DISTRICT C-1 MULTIFAMILY DWELLINGS

			BOARD ON 9/18/207 BZA-013619-2017
MINIMUM LOT SIZE	5,000SF	3,058SF	3,058SF
TOTAL FRONTAGE		37'-8"	37'-8"
FLOOR AREA RATIO (FAR)	2,294SF (.75)	3,660SF (1.2)	3,813SF (1.2)
MIN. LOT AREA/ DU	1,500SF		UNIT 1: 977SF UNIT 2: 1,010SF UNIT 3: 1,010SF

REQUIRED EXISTING

APPROVED BY ZONING

37'-8" 37'-8" MINIMUM LOT WIDTH **BUILDING HEIGHT** 35'-0" MAX | 35'-0" 35'-0" MINIMUM YARD DIMENSIONS (BASED ON BUILDING HEIGHT/LENGTH) FRONT SETBACK: (H+L)/4 16'-8"FT 16'-8"FT 16'-8"FT MIN SIDE SETBACK: (H+L)/5 7'-6" MIN 4'-6"FT 4'-6"FT MIN REAR SETBACK: (H+L)/4 38'-9"FT 20'-0" MIN 43'-10"FT OPEN SPACE MIN AS % 30% 60% 55% 917SF 1,838SF 1.687SF OF GROSS FLR AREA 5,015SF PROPOSED BUILDING AREA 4,630SF INCLUDING BASEMENT BALCONIES/DECK 0SF 168SF


DADKING DECILI ATIONS

PARKING REGULATIONS			
	REQUIRED	EXISTING	PROPOSED
PARKING SPACES PER DWELLING	1/DU	1/DU	1/DU
TOTAL PARKING SPACES	3	3	3

For Permit

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revision	revision description	date
1	ZBA REVIEW	06/14/201
2	ZBA REVIEW REV1	06/20/201
4	FOR PRICING	09/14/201
5	FOR PRICING	09/20/201
6	FOR PERMIT	09/27/201
7	NOT FOR CONSTRUCTION	06/04/201
8	FOR PERMIT/PRICING	07/13/201

BERKSHIRE STREET RESIDENCE

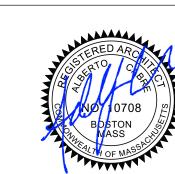30 Berkshire St., Cambridge, MA 02141

Krissy Ellsworth, Denyce Wicht, Michael 30 Berkshire Street, Cambridge, MA

JOE THE ARCHITECT

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website www.joethearchitect.com

drawing title **GENERAL NOTES, CODES, & REGULATIONS**

drawing scale As indicated | Approver

MOUNTING HEIGHTS - GENERAL COMPONENTS

EMERGENCY LIGHTING SHALL BE PROVIDED TO

COMPLY WITH ALL LOCAL, STATE AND FEDERAL

WITH DAILY USAGE OF SPACE.

STATE AND FEDERAL CODES.

EXIT

OPERATING

HARDWARE

PUBLIC RECEPTACLE DOOR

ABOVE

U.O.H.

COUNTER -

TELEPHONE MOUNTED

CODES. MOUNTING HEIGHT TO NOT INTERFERE

EXIT SIGNS SHALL BE PLACED SO THAT THEY ARE

THERMOSTAT

SWITCHES OR

- FACEPLATE TO MATCH PANEL

RECEPTACLES UNLESS

OTHERWISE NOTED.

DIMMERS

OUTLETS ?

READILY VISIBLE AND COMPLY WITH ALL LOCAL,

- 3" - 4" FOR

BRACKET

MOUNTED

EXTINGUISHERS

EXTINGUISHER

ELECTRICAL FIRE HOSE

CABINET, FULLY

RECESSED,

MOUNTED

OR SURFACE

RECESSED, SEMI-

FIRE

EXTINGUISHER

HIGHER THAN 48"

HANDLE NO

ABOVE THE

FINISH FLOOR.

FIRE EXTINGUISHER

FULLY RECESSED,

SEMI-RECESSED, OR

SURFACE MOUNTED

CABINET.

WHERE POSSIBLE,

LOCATED DIRECTLY

ABOVE LIGHT SWITCH

ALARM & SCONCE

WALL (SCALE FIGURE)

OR PULL STATION.

FIRE

STROBE

FIRE ALARM PULL

STATION

DEVICE SHALL BE

REFER TO ELEVATIONS & PLANS


FINISHED CEILING - VARIES; SEE RCP/

IN SPECIFIC LOCATIONS.


FINISHED FLOOR

FOR EXACT MOUNTING HEIGHTS OF DEVICES

MASTER ABBREVIATIONS LIST

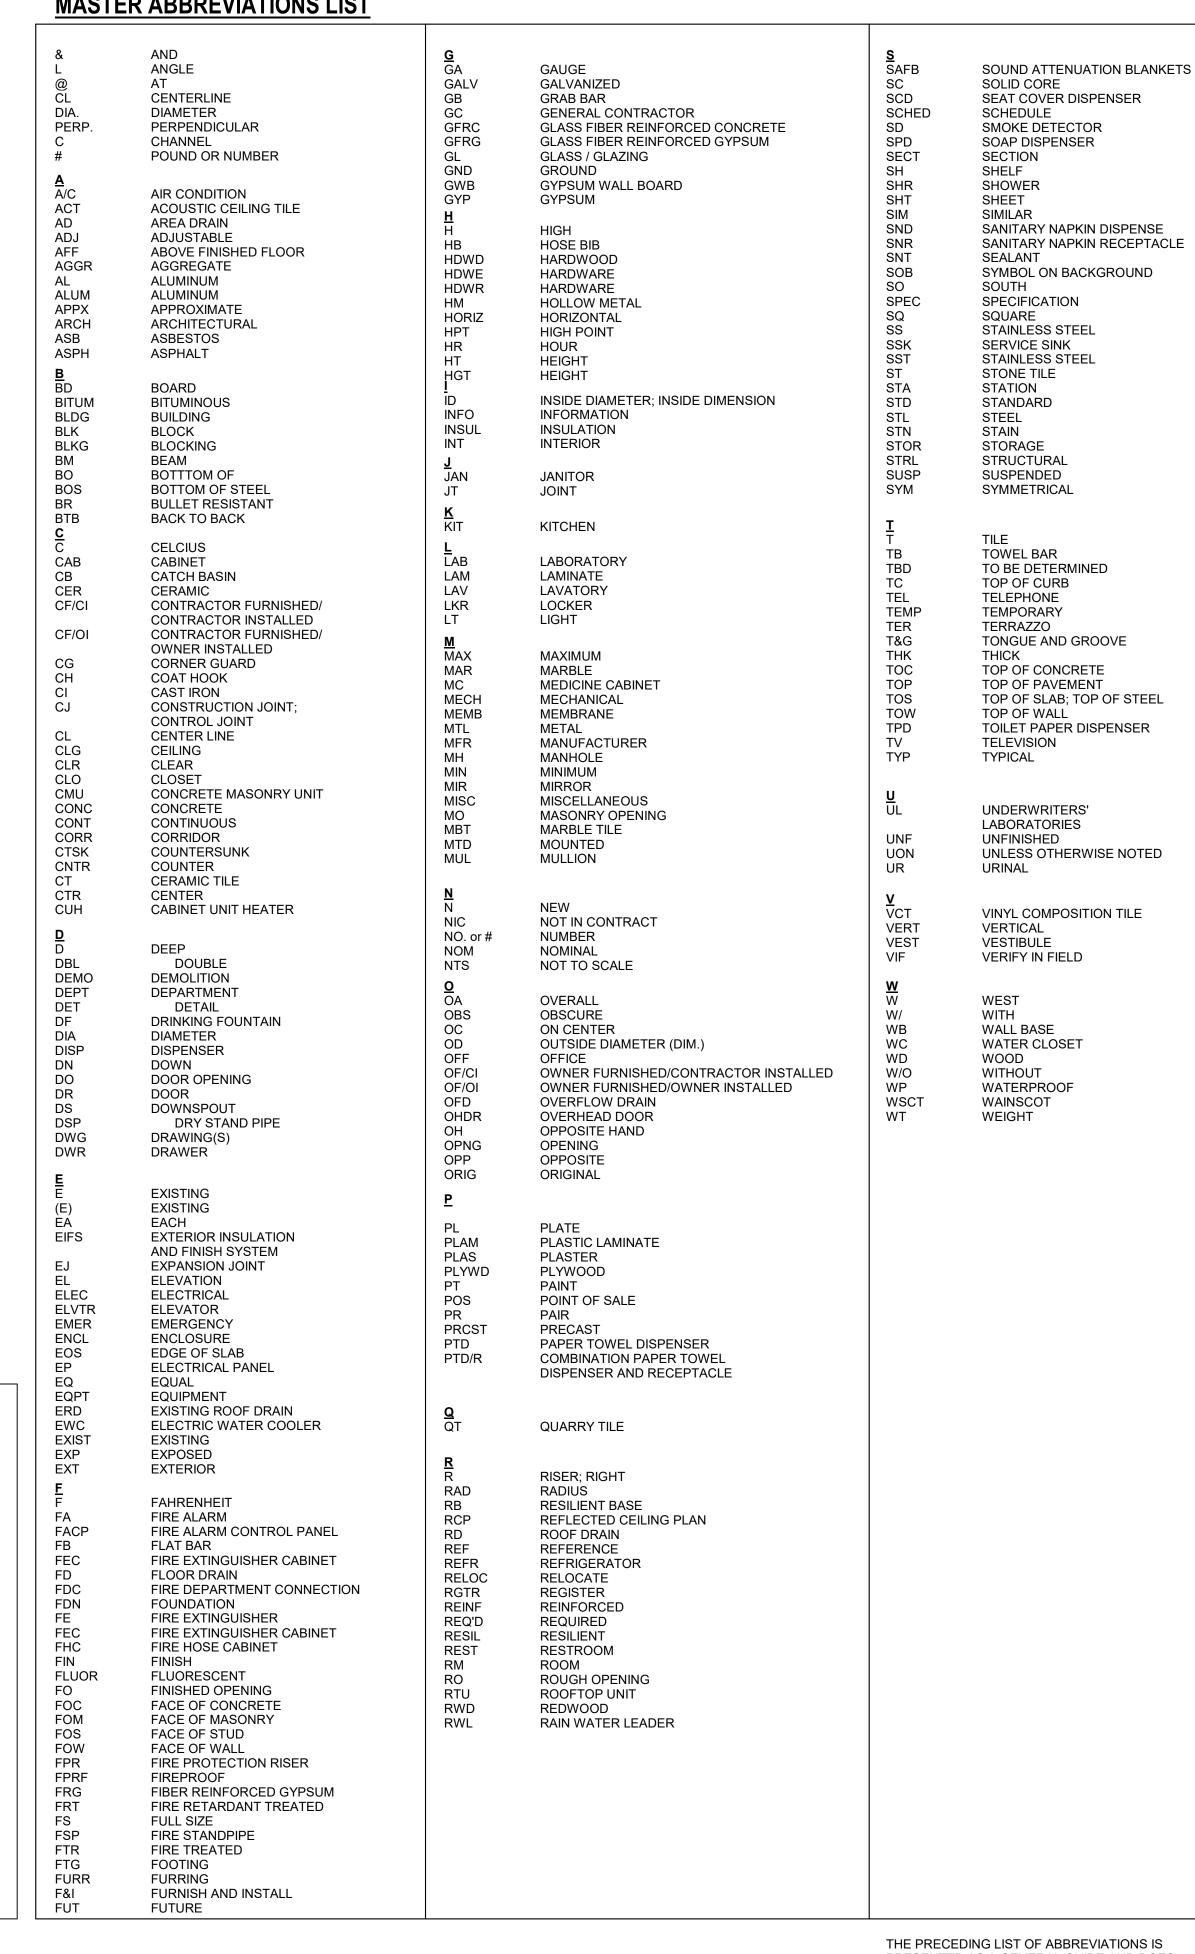

PRESENTED AS A GENERAL GUIDE AND DOES NOT NECESSARILY SHOW ALL ABBREVIATIONS USED. OTHER GENERALLY ACCEPTED ABBREVIATIONS MAY BE FOUND AMONG THE DRAWINGS. ALL ABBREVIATIONS SHOWN ABOVE MAY NOT BE USED WITHIN THIS DRAWING SET.

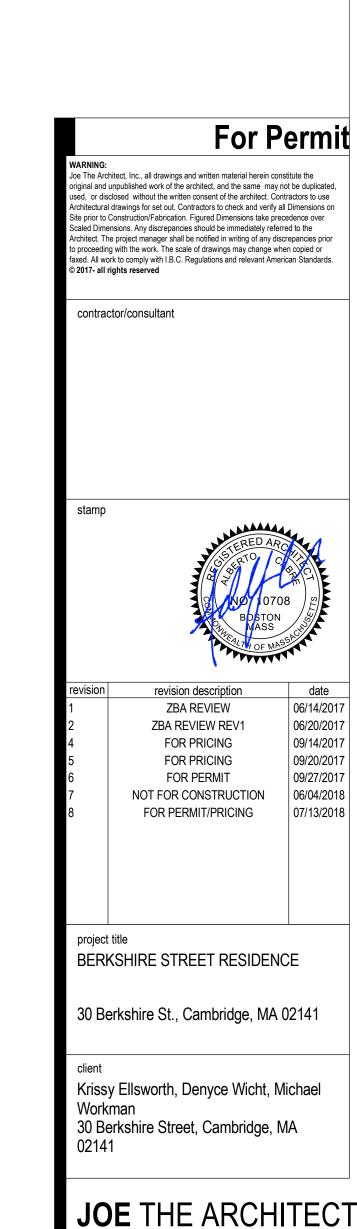

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ARCHITECTURAL

project number

drawing number


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GENERAL INFORMATION

drawing scale approver

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BERKSHIRE STREET

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For Permit

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drawing title

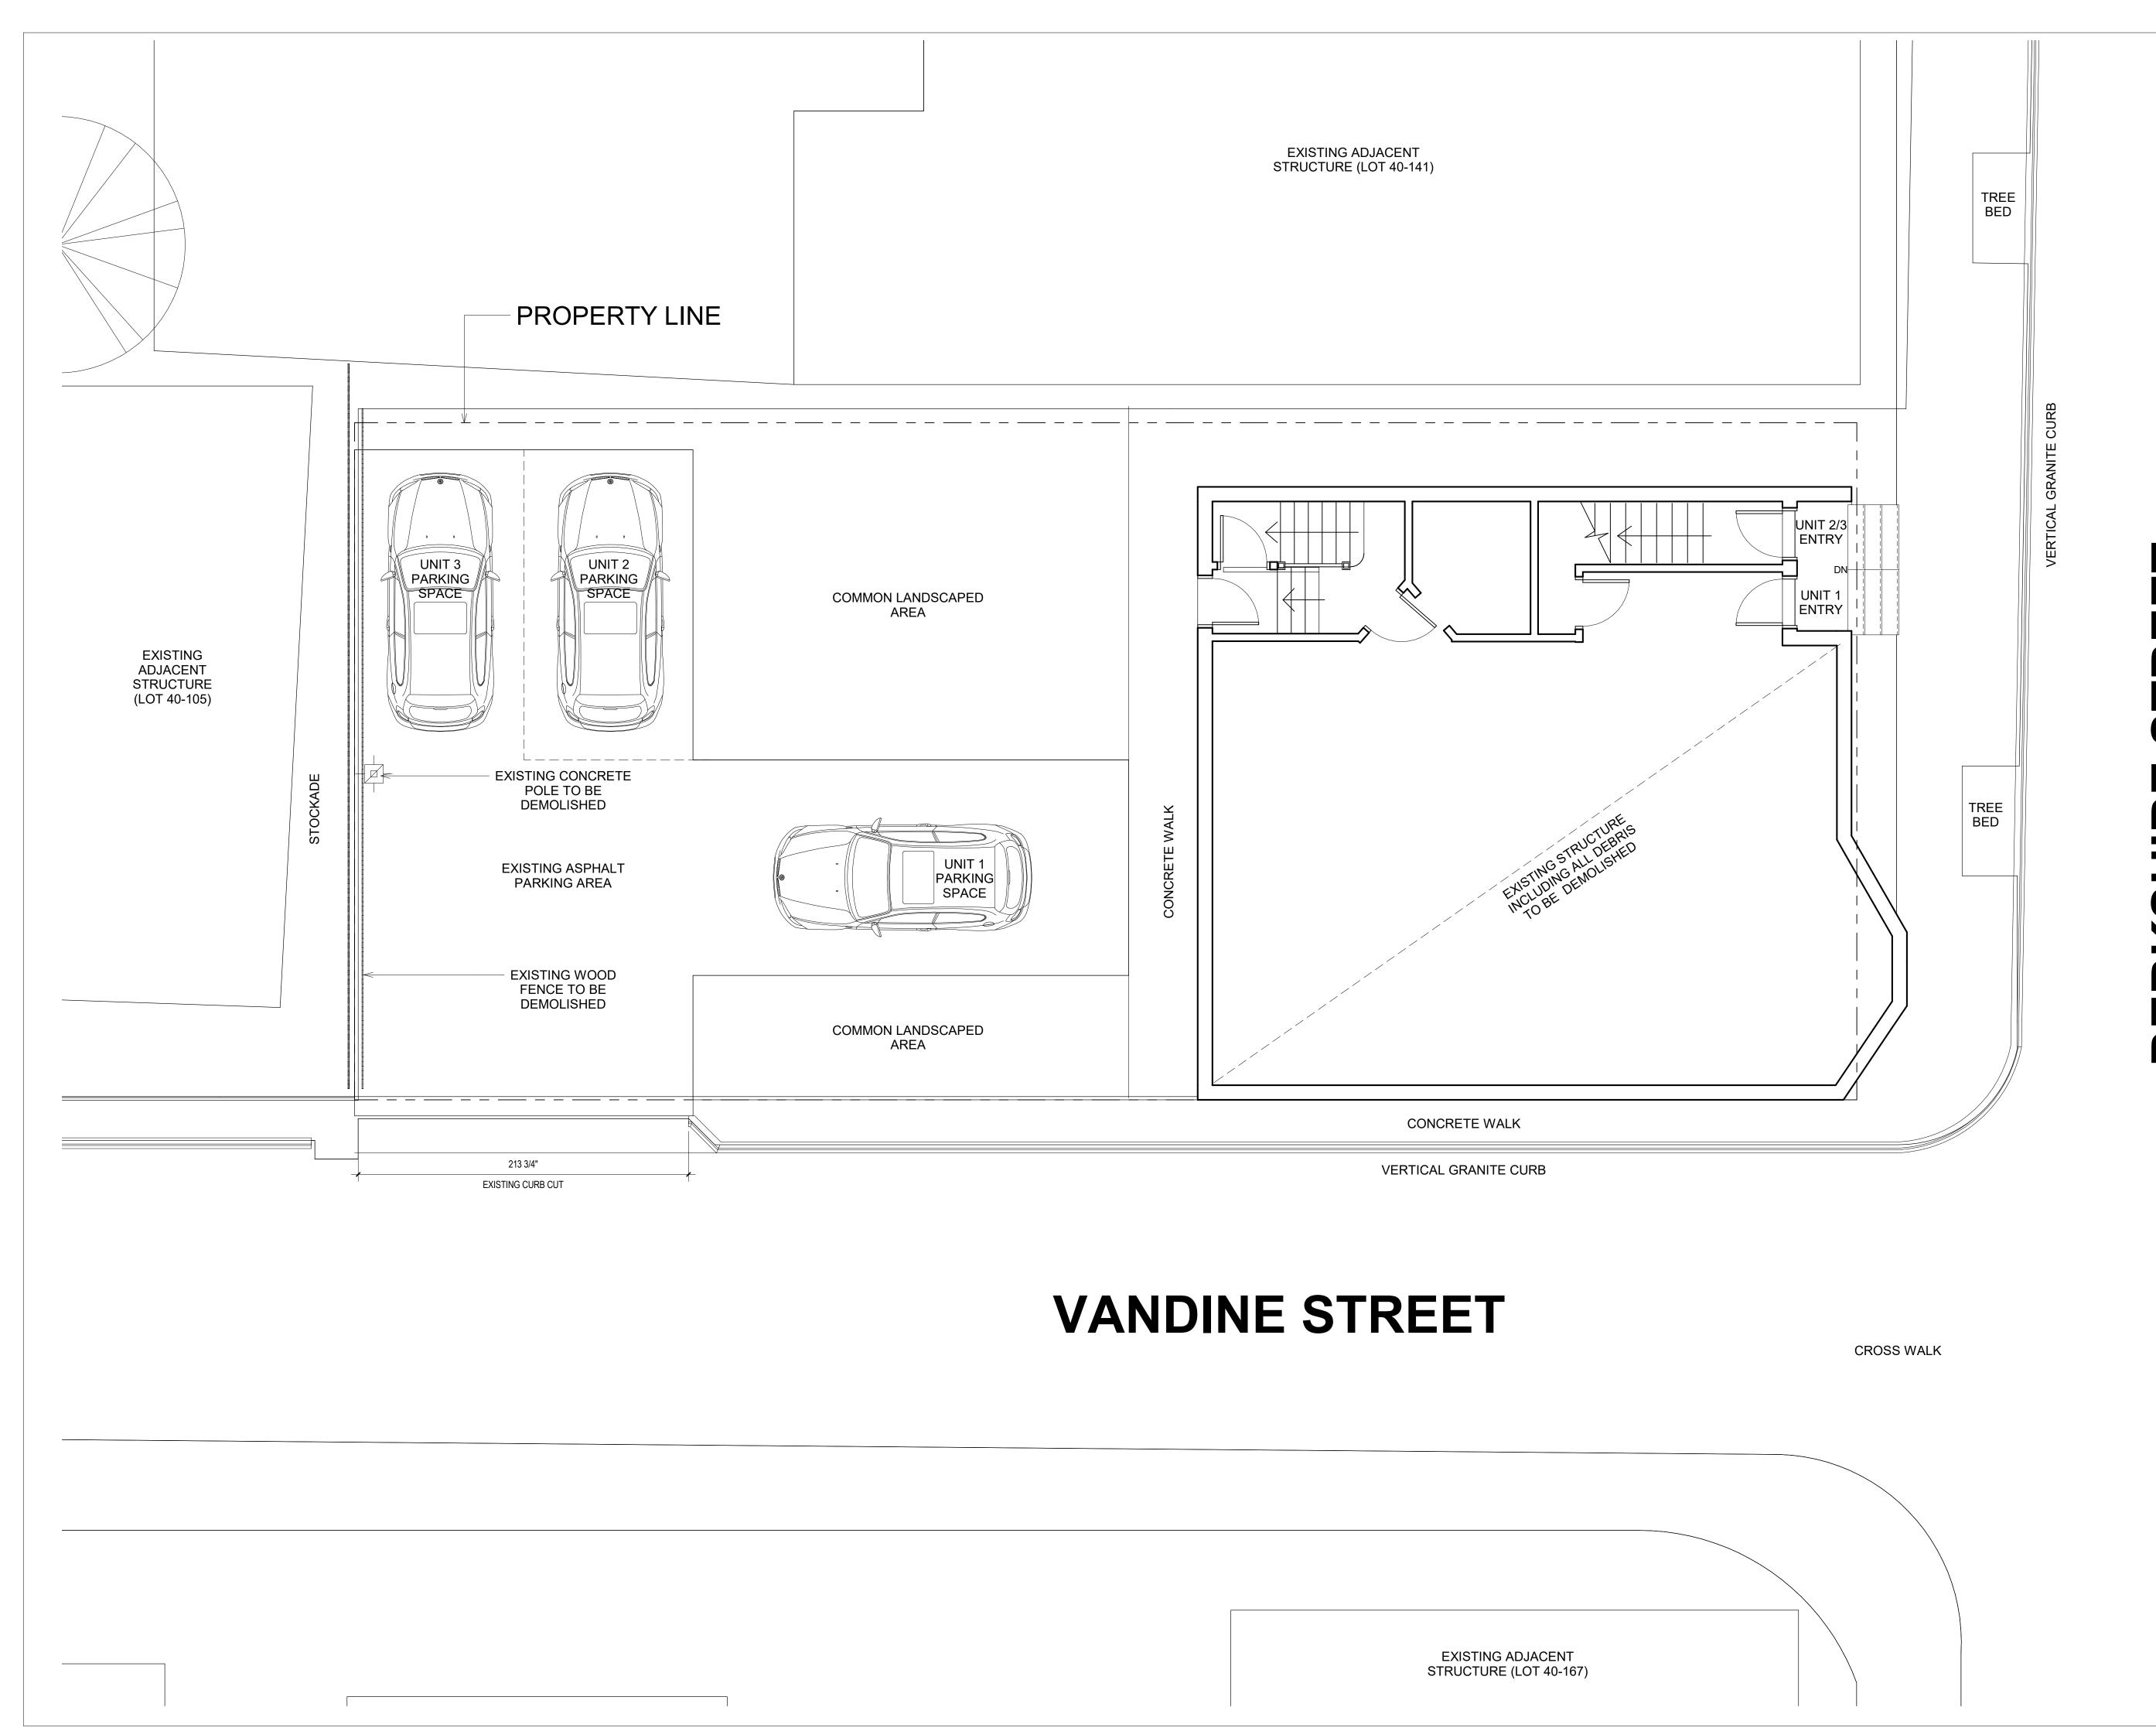
EXISTING/DEMOLITION SITE PLAN

project number drawing scale approver

1/4" = 1'-0" Approver

A020

) re·

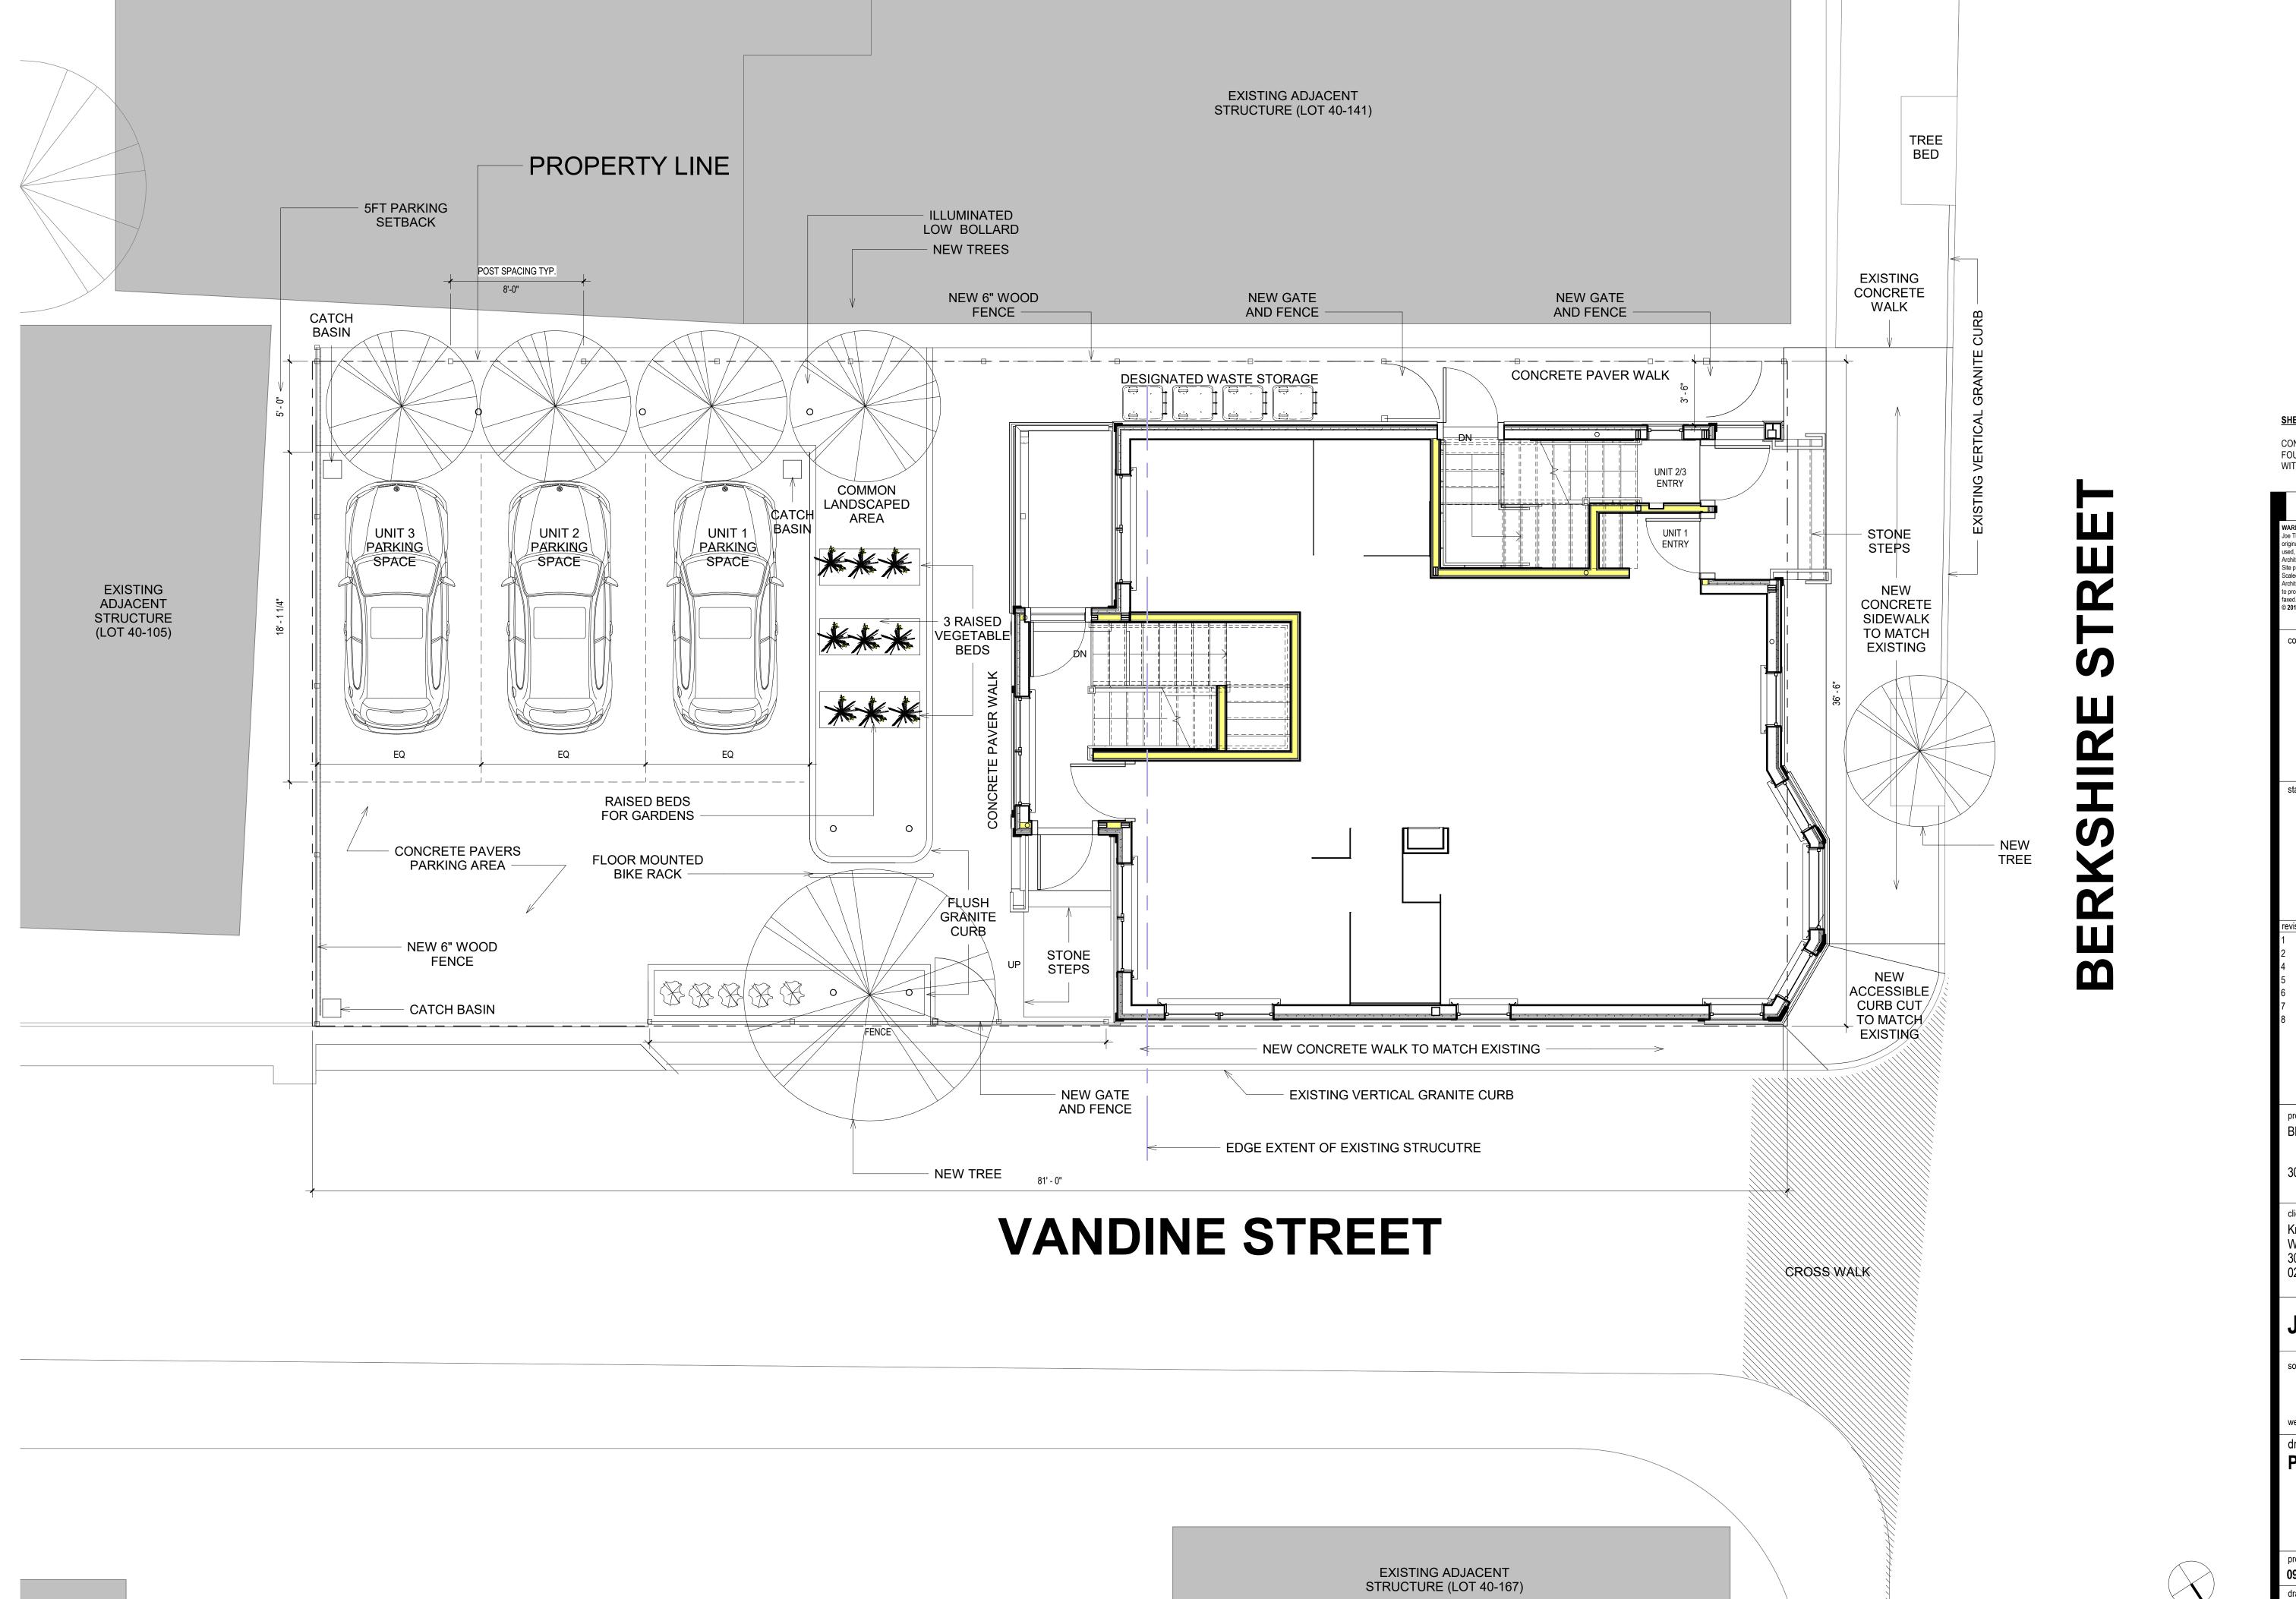

SHEET NOTES - ARCHITECTURAL SITE PLAN

CONTRACTOR TO COORDINATE FOUNDATION LOCATION SET OUT WITH LAND SURVEY DRAWINGS.

For Permit

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FOR PERMIT/PRICING	07/13/2018

BERKSHIRE STREET RESIDENCE

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PROPOSED SITE PLAN

drawing scale approver As indicated | Approver drawing number

PROPERTY LINE

Construction Notes

- See sheet A002 for abbreviations and typical mounting heights.
- See sheet A430 for partition type schedule and information.
- Use type "x" gwb on fire rated partitions.
 Keep door frames 4" clear on hinge side at all partition intersections expect at columns where
- partition intersections except at columns where clearance is provided for hardware.
 Use cementitious backer board ('Durock') or equal at

partitions scheduled to receive tile (U.O.N.). See

- finish plan for location of tile.

 6. Where furred partitions exceed maximum height, brace to adjacent structure.
- brace to adjacent structure.
 7. Provide level 5 finish at all partitions to receive wall
- Provide level 4 finish at all interior partitions, U.O.N.
 Provide flush drawall type access panels in partitions.
- 9. Provide flush drywall type access panels in partitions as required for service of building systems.
 10. Dimensioning: All partition dimensions shown are to face of stud. Dimensions noted as "clr." mean clear
- dimension to face of finish. -Dimensions noted as "R.O." mean dimension of clear rough opening between studs. All horizontal dimensions are shown on plans and vertical dimensions on interior & exterior elevations where relevant. Vertical dimensions are to top of subfloor, U.O.N. See door schedule for door sizes, door info and interior details.

 11. Align vertically & horizontally electrical wall devices
- including switches, outlets, fire alarm devices, exit signs, emergency lights, etc. When possible within code requirements, and where in close proximity to eachother U.O.N.

 12. See RCP for info regarding ceiling type finish,
- fixtures and all ceiling information.

 B. Provide blocking and backing as required within
- existing partitions and new partitions for all casework, shelving, countertops, toilet accessories, and owner supplied toilet accessories, and owner spplied equipment. Coordinate with shop drawings.

 4. Maintain integrity of existing fire resistant rated
- assemblies for all penetrations.

 15. Use water resistance GWB on all wet areas.

 16. All doors on 2H rated walls to be 1 1/2" rated door.
- All doors on 211 fated walls to be 1 1/2 fated door.

 G.C. to install acoustic insulation on all interior walls and ceilings
- 18. G.C. to coordinate all floor transition thickness with adequite floor thresholds that do not excede 1/2" reveal.
 19. G.C. to provide HVAC systems distribution shop
- drawings for architect and owner approval and coordination.

 20. G.C. to keep a continuous building thermal envelope wall R-20, roof R-38,
- basement wall R-10, floor R-30. In accordance with IBC energy efficiency Chapter 11.
 21. G.C. to coordinate all electral power for kitchen
- 22. Coordinate with all Consultant drawings as there may be additional items not seens on Architectural Floor Plans.

Construction Legend

Existing Construction to be Removed

Existing Construction to be Removed

Existing Door Assembly to Remain

Existing Door Assembly to be Removed

New Door Assembly

Not in Contract

Demolition

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MOY 10708

BOSTON

MASS

ion revision description date

ZBA REVIEW 06/14/2017

ZBA REVIEW REV1 06/20/2017

FOR PRICING 09/14/2017

FOR PRICING 09/20/2017

FOR PERMIT 09/27/2017

NOT FOR CONSTRUCTION 06/04/2018

FOR PERMIT/PRICING 07/13/2018

project title
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Workman 30 Berkshire Street, Cambridge, MA

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drawing title
COMMON BASEMENT
FLOOR PLAN


project number	drawing scale	approver
092	As indicated	AS
drawing number	•	revision

A110

Construction Notes

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 See sheet A430 for partition type schedule and
- Use type "x" gwb on fire rated partitions. Keep door frames 4" clear on hinge side at all partition intersections except at columns where
- clearance is provided for hardware. Use cementitious backer board ('Durock') or equal at partitions scheduled to receive tile (U.O.N.). See
- finish plan for location of tile. Where furred partitions exceed maximum height, brace to adjacent structure.
- Provide level 5 finish at all partitions to receive wall Provide level 4 finish at all interior partitions, U.O.N. Provide flush drywall type access panels in partitions
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- 15. Use water resistance GWB on all wet areas. 16. All doors on 2H rated walls to be 1 1/2" rated door.
- 17. G.C. to install acoustic insulation on all interior walls 18. G.C. to coordinate all floor transition thickness with
- 19. G.C. to provide HVAC systems distribution shop drawings for architect and owner approval and
- 20. G.C. to keep a continuous building thermal envelope - wall R-20, roof R-38, basement wall R-10, floor R-30. In accordance
- 22. Coordinate with all Consultant drawings as there may be additional items not seens on Architectural Floor

Construction Legend

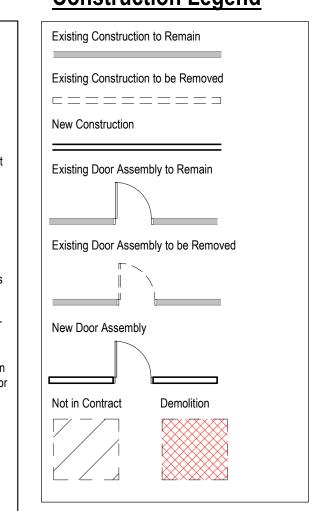

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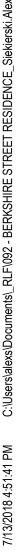
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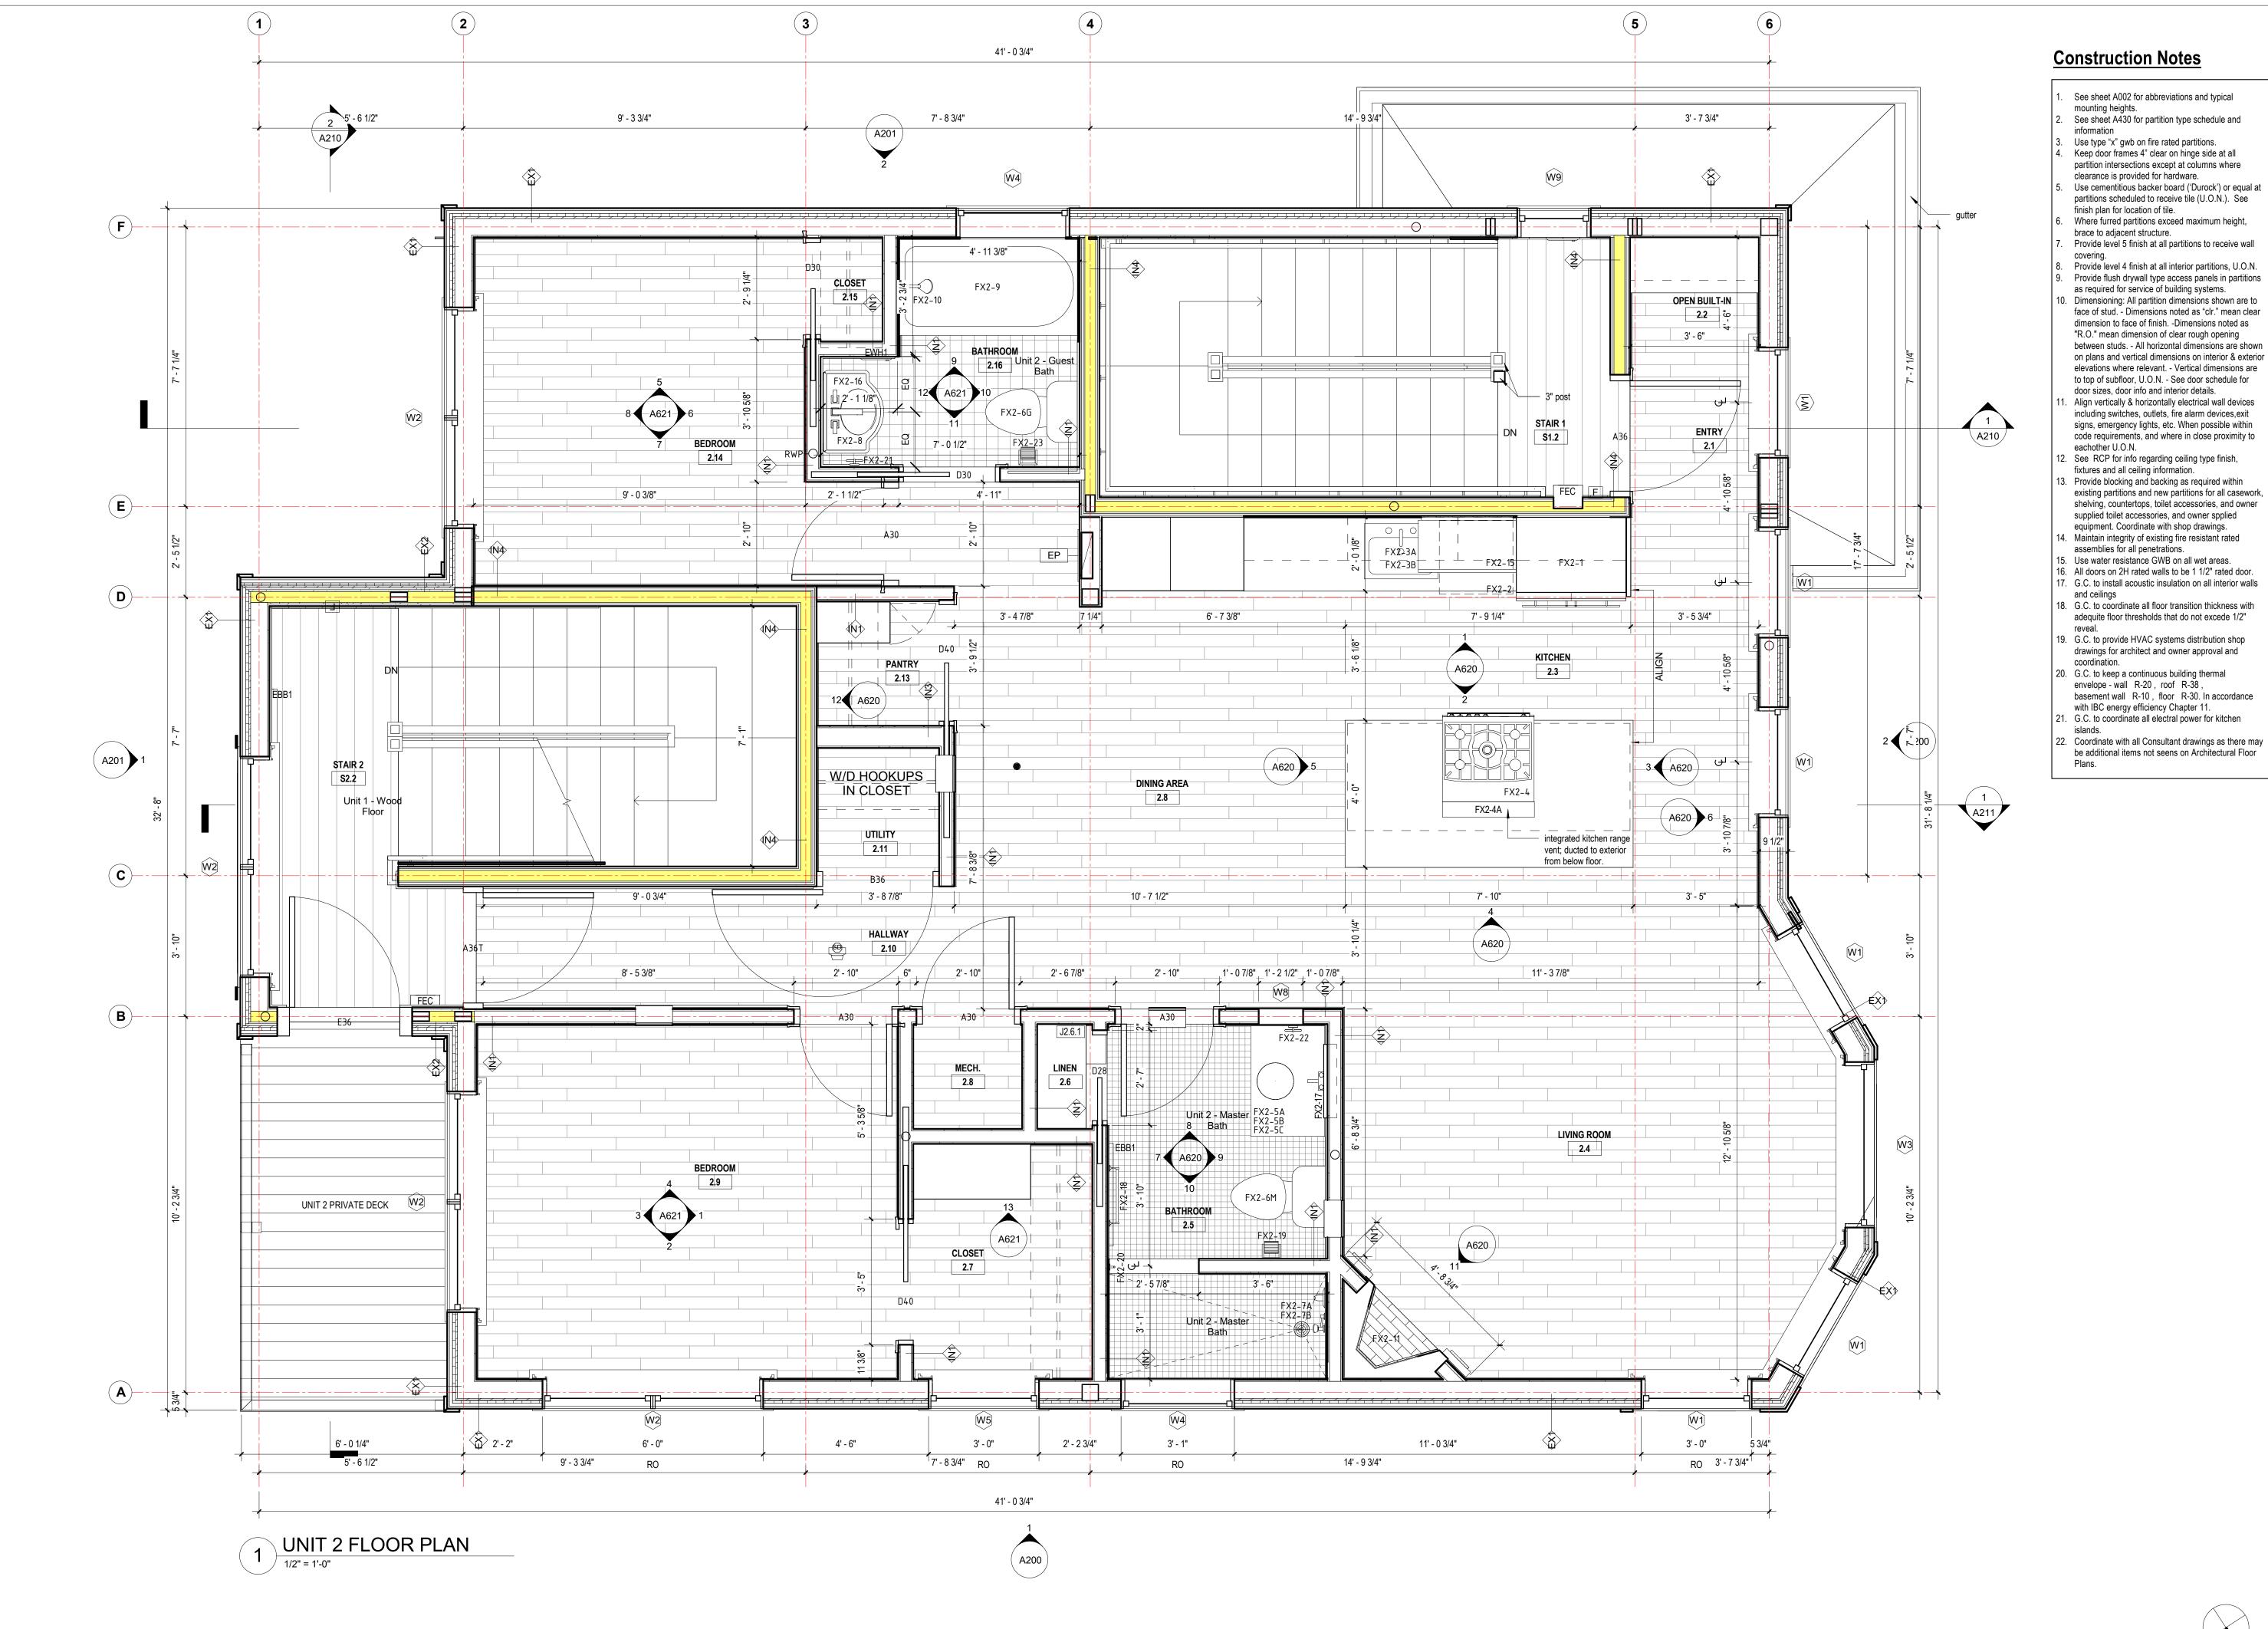
drawing title

UNIT 1 FLOOR PLAN

website www.joethearchitect.com

drawing scale approver As indicated | Approver drawing number






Construction Notes

- See sheet A002 for abbreviations and typical mounting heights.
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- fixtures and all ceiling information. 13. Provide blocking and backing as required within existing partitions and new partitions for all casework,
- shelving, countertops, toilet accessories, and owner supplied toilet accessories, and owner spplied equipment. Coordinate with shop drawings. 4. Maintain integrity of existing fire resistant rated
- assemblies for all penetrations. 15. Use water resistance GWB on all wet areas. 16. All doors on 2H rated walls to be 1 1/2" rated door.
- 18. G.C. to coordinate all floor transition thickness with adequite floor thresholds that do not excede 1/2"
- 19. G.C. to provide HVAC systems distribution shop drawings for architect and owner approval and
- 20. G.C. to keep a continuous building thermal envelope - wall R-20, roof R-38, basement wall R-10, floor R-30. In accordance
- 21. G.C. to coordinate all electral power for kitchen 22. Coordinate with all Consultant drawings as there may

Construction Legend

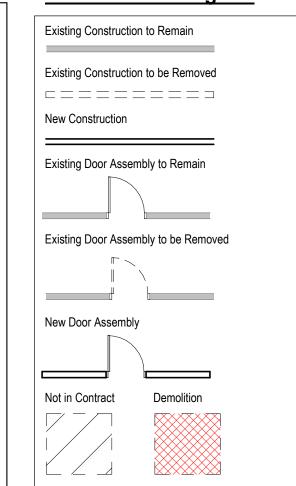

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	FOR PERMIT/PRICING	07/13/2018
		1

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drawing title **UNIT 2 FLOOR PLAN**

project number	drawing scale	ар
092	As indicated	4
drawing number		rev
A112	1	



14' - 9 3/4"

Construction Notes

Construction Legend

Existing Construction to Remain Existing Construction to be Removed New Construction

Existing Door Assembly to Remain

Existing Door Assembly to be Removed

New Door Assembly

Not in Contract Demolition

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website www.joethearchitect.com drawing title

UNIT 3 FLOOR PLAN

As indicated

drawing number

5' - 6 5/8"

9' - 3 3/4"

7' - 8 3/4"

(2)

Construction Notes

- See sheet A002 for abbreviations and typical
- mounting heights.
 See sheet A430 for partition type schedule and
- Use type "x" gwb on fire rated partitions. Keep door frames 4" clear on hinge side at all partition intersections except at columns where
- partitions scheduled to receive tile (U.O.N.). See finish plan for location of tile.
- Where furred partitions exceed maximum height,
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- 2. See RCP for info regarding ceiling type finish, fixtures and all ceiling information.
- existing partitions and new partitions for all casework, shelving, countertops, toilet accessories, and owner supplied toilet accessories, and owner spplied
- assemblies for all penetrations.
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- 19. G.C. to provide HVAC systems distribution shop
- 20. G.C. to keep a continuous building thermal envelope - wall R-20, roof R-38, basement wall R-10, floor R-30. In accordance
- 21. G.C. to coordinate all electral power for kitchen 22. Coordinate with all Consultant drawings as there may

Construction Legend

Existing Construction to Remain Existing Construction to be Removed

New Construction Existing Door Assembly to Remain

Existing Door Assembly to be Removed

New Door Assembly

Not in Contract Demolition

3. Provide blocking and backing as required within

14. Maintain integrity of existing fire resistant rated 5. Use water resistance GWB on all wet areas.

18. G.C. to coordinate all floor transition thickness with adequite floor thresholds that do not excede 1/2"


drawings for architect and owner approval and

with IBC energy efficiency Chapter 11.

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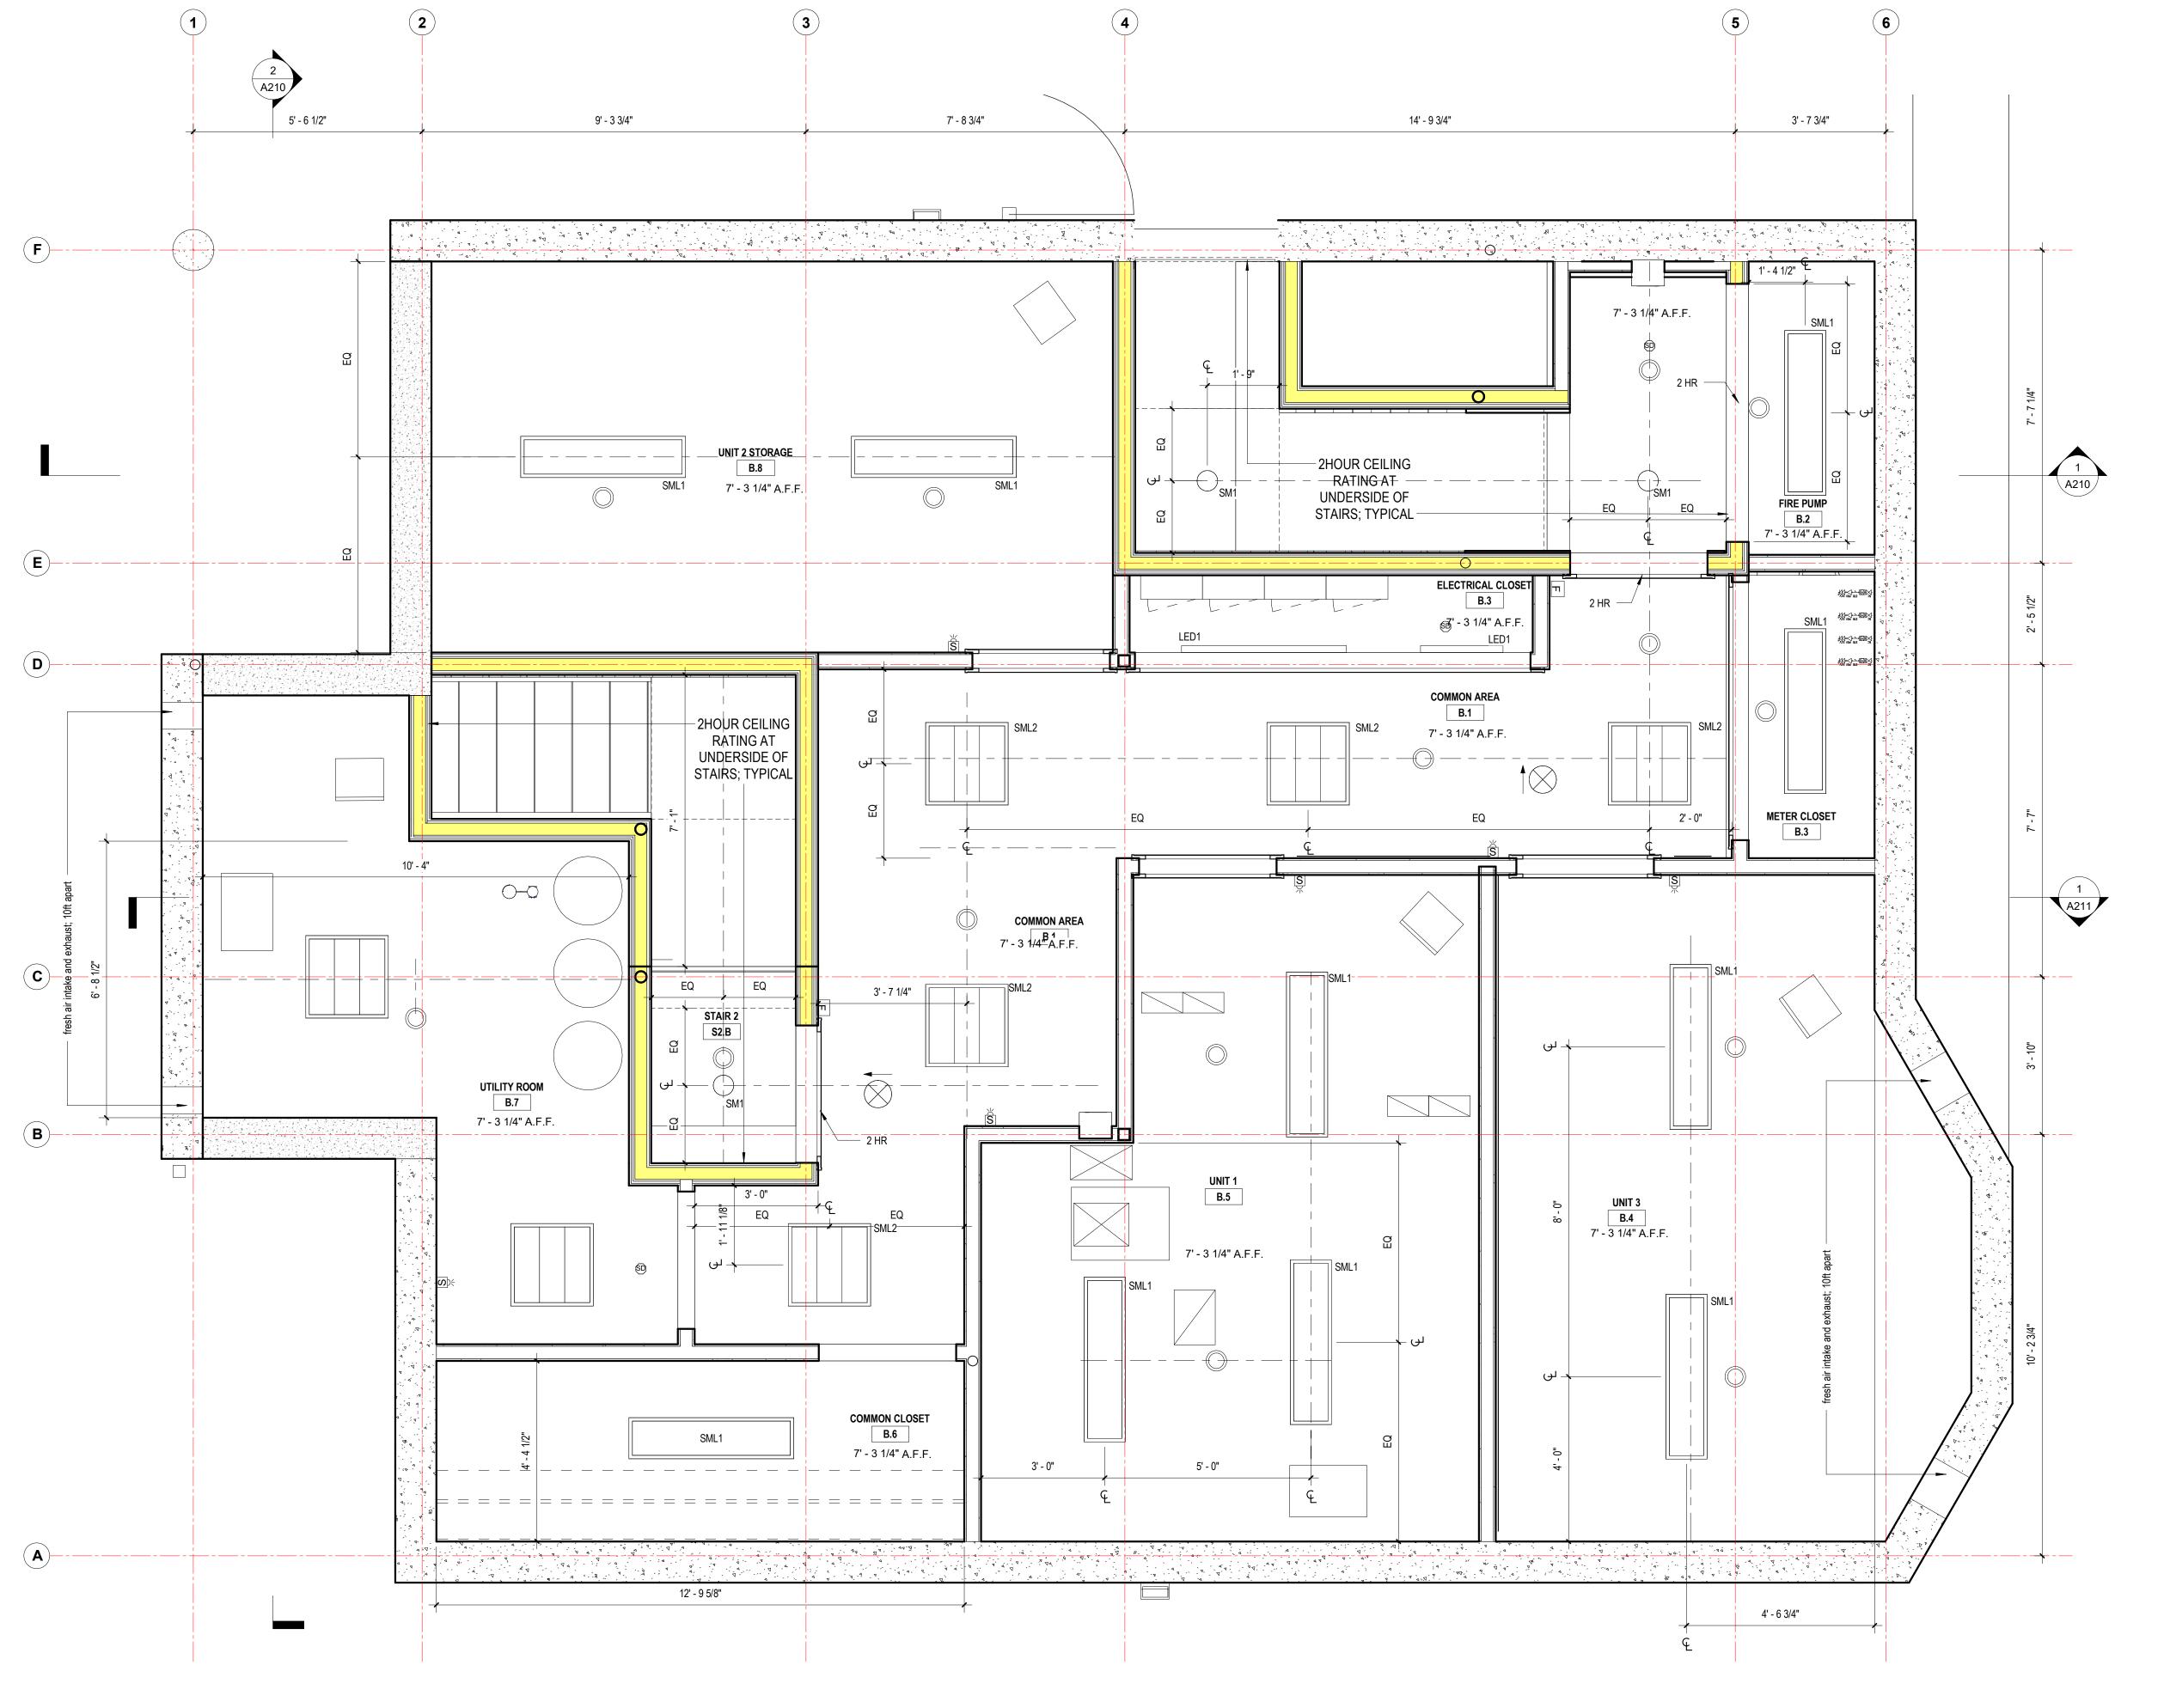
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website www.joethearchitect.com

drawing title **ROOF PLAN**

drawing scale approver As indicated Approver

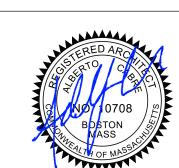



- LIGHTING, ELECTRICAL EQUIPMENT, HVAC EQUIPMENT, AND SPRINKLERS ARE TO BE MOUNTED ON CENTER OF ACT UNLESS OTHERWISE DIMENSIONED ON REFLECTED
- UNLESS OTHERWISE NOTED MULTIPLE SWITCHES IN A SINGLE LOCATION SHALL BE GANGED IN A SINGLE BOX AND
- ALL GWB CEILINGS TO BE PAINTED WHITE EGGSHELL U.O.N.
- IN FIXTURES. "BUG EYES" ARE NOT ACCEPTABLE, U.O.N.
- PROVIDE COATING MIXTURE OVER (E) FIREPROOFING TO PREVENT PARTICLES
- S.M.D., S.E.D., S.P.D., S.F.P.D. FOR RELEVANT INFO AND COORDINATION OF MECHANICAL, ELECTRICAL, PLUMBING AND FIRE PROTECTION ITEMS. ALIGN FIRE ALARM AND ALL OTHER
- WITH CEILING MOUNTED LIGHTING CENTER ALL BETWEEN ELEMENTS OR
- LIGHTS ARE TO BE MTD TO UNDERSIDE OF DECK U.O.N. - SPRINKLER LINES ARE TO BE MTD TO UNDERSIDE OF DECK. - PAINT ALL EXPOSED STEEL STRUCTURE & METAL DECK U.O.N., REFER TO RCP AND FINISH SCHEDULE FOR ADDITIONAL INFORMATION ALL FIRE SPRINKLER PIPING TO BE
- EQUIPMENT.
- INSTALL WATER RESISTANT GWB AT ALL WET LOCATION CEILINGS.
- MOULDING. G.C. TO COORDINATE CEILING HEIGHT
- SYSTEM SELECTED BY OWNER. SEE ARCHITECTURAL ELECTRICAL FOR
- SWITCHING. ALL HVAC DUCTWORK IN BASEMENT TO BE
- SEE INTERIOR ELEVATIONS FOR LOCATION OF WALL REGISTERS.

Reflected Ceiling Notes

- CEILING PLAN
- COVERED WITH A SINGLE PLATE
- PROVIDE EMERGENCY LIGHTING INTEGRAL
- FROM FALLING
- ELECTRIC DEVICES, w/LIGHTING AS INDICATED IN DRAWINGS. ALIGN CEILING DEVICES INCLUDING SMOKE DETECTORS, SPRINKLER HEADS, ETC., FIXTURES UNLESS OTHERWISE NOTED.
- WITHIN GRID IN BOTH DIRECTIONS U.O.N. AT TYP. EXPOSED CEILING: - RUN ALL ELECTRICAL CONDUITS TIGHT TO UNDERSIDE OF DECK IN JOIST BAYS, RUN ALL ELECTRICAL CONDUIT NEATLY AND PARALLEL TO STRUCTURE U.O.N.. - RUN EXPOSED DUCTWORK AS HIGH AS POSSIBLE & TIGHT TO PARALLEL TO INTERIOR PARTITIONS AND/OR STRUCTURE WHERE APPLICBLE U.O.N.. - PENDANT
- PAINTED BLACK U.O.N. PROVIDE UNISTRUT SUPPORTS AT ALL FIXTURES MOUNTED BELOW HVAC
- COORDINATE ALL LIGHTING WITH CROWN
- WITH ARCHITECT AFTER FINAL HVAC
- EXPOSED UNLESS OTHERWISE NOTED.
- COORDINATE WITH ALL CONSULTANT DRAWINGS AS ALL ITEMS MAY NOT BE DISPLAYED ON ARCHITECTURAL REFLECTED CEILING PLANS.

Ceiling Plan Legend

☐ EXH1 - BATHROOM EXHAUST FAN R - RECESSED FIXTURE □ □ □ □ WS - WALL SCONCE

P - PENDANT FIXTURE CF - CEILING FAN/LIGHT FIXTURE

LED - LINEAR LED STRIP SML - SURFACE MOUNTED LINEAR FIXTURE SMOKE DETECTOR

SPRINKLER FIRE ALARM EMERGENCY STROBE & HORN

EXIT SIGNAGE GYPSUM WALL BOARD


BEAD BOARD WOOD CEILING

CEILING

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BERKSHIRE STREET RESIDENCE

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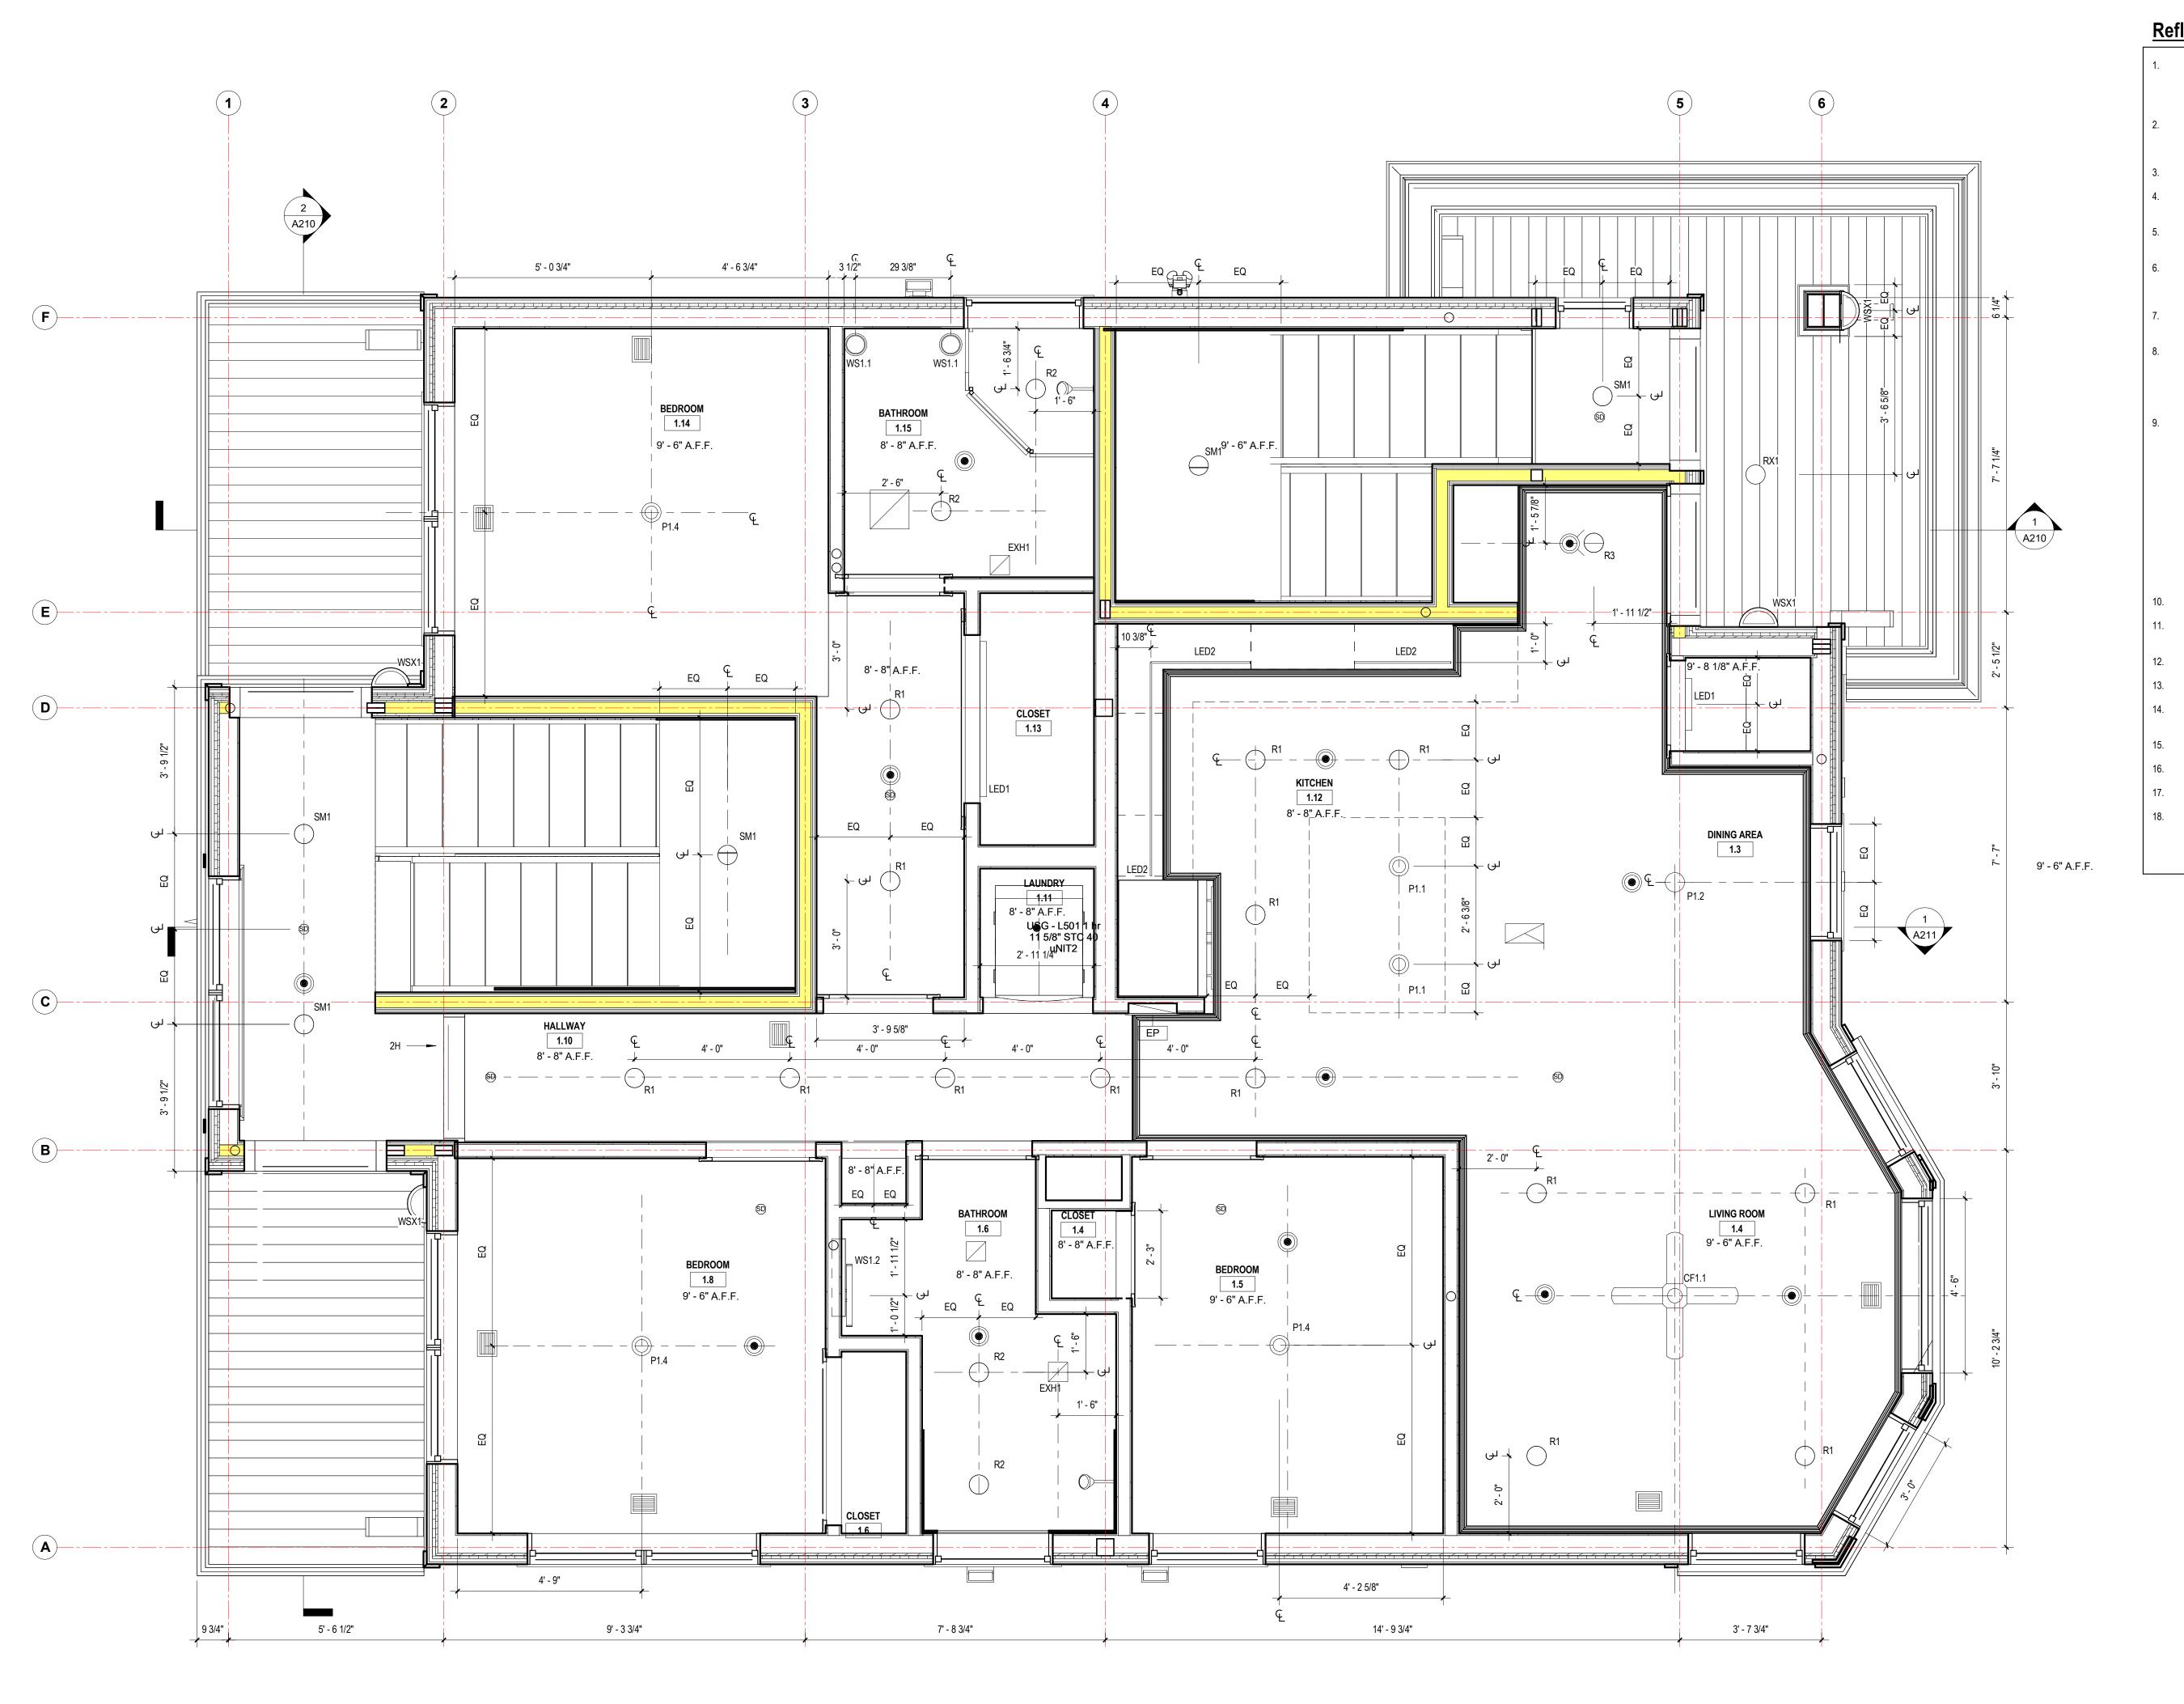
website www.joethearchitect.com

drawing title **COMMON BASEMENT** REFLECTED CEILING **PLAN**

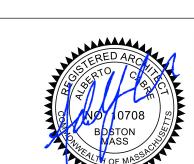drawing scale approver As indicated | Approver drawing number

BASEMENT REFELCTED CEILING PLAN





Reflected Ceiling Notes

- LIGHTING, ELECTRICAL EQUIPMENT, HVAC EQUIPMENT, AND SPRINKLERS ARE TO BE MOUNTED ON CENTER OF ACT UNLESS OTHERWISE DIMENSIONED ON REFLECTED CEILING PLAN

 UNLESS OTHERWISE NOTED MULTIPLE SWITCHES IN A SINGLE LOCATION SHALL BE GANGED IN A SINGLE BOX AND
- BE GANGED IN A SINGLE BOX AND
 COVERED WITH A SINGLE PLATE

 3. ALL GWB CEILINGS TO BE PAINTED WHITE
 EGGSHELL U.O.N.

 4. PROVIDE EMERGENCY LIGHTING INTEGRAL
 IN FIXTURES. "BUG EYES" ARE NOT
- ACCEPTABLE, U.O.N.

 5. PROVIDE COATING MIXTURE OVER (E)
 FIREPROOFING TO PREVENT PARTICLES
 FROM FALLING

 6. S.M.D., S.E.D., S.P.D., S.F.P.D. FOR
- 6. S.M.D., S.E.D., S.P.D., S.F.P.D. FOR RELEVANT INFO AND COORDINATION OF MECHANICAL, ELECTRICAL, PLUMBING AND FIRE PROTECTION ITEMS.

 7. ALIGN FIRE ALARM AND ALL OTHER ELECTRIC DEVICES, w/LIGHTING AS INDICATED IN DRAWINGS.
- INDICATED IN DRAWINGS.

 8. ALIGN CEILING DEVICES INCLUDING SMOKE DETECTORS, SPRINKLER HEADS, ETC., WITH CEILING MOUNTED LIGHTING FIXTURES UNLESS OTHERWISE NOTED. CENTER ALL BETWEEN ELEMENTS OR WITHIN GRID IN BOTH DIRECTIONS U.O.N.

 9. AT TYP. EXPOSED CEILING: RUN ALL ELECTRICAL CONDUITS TIGHT TO UNDERSIDE OF DECK IN JOIST BAYS. RUN

ALL ELECTRICAL CONDUIT NEATLY AND

- PARALLEL TO STRUCTURE U.O.N.. RUN EXPOSED DUCTWORK AS HIGH AS POSSIBLE & TIGHT TO PARALLEL TO INTERIOR PARTITIONS AND/OR STRUCTURE WHERE APPLICBLE U.O.N.. PENDANT LIGHTS ARE TO BE MTD TO UNDERSIDE OF DECK U.O.N. SPRINKLER LINES ARE TO BE MTD TO UNDERSIDE OF DECK. PAINT ALL EXPOSED STEEL STRUCTURE & METAL DECK U.O.N., REFER TO RCP AND FINISH SCHEDULE FOR ADDITIONAL INFORMATION
- 10. ALL FIRE SPRINKLER PIPING TO BE PAINTED BLACK U.O.N.
 11. PROVIDE UNISTRUT SUPPORTS AT ALL FIXTURES MOUNTED BELOW HVAC
- EQUIPMENT.

 12. INSTALL WATER RESISTANT GWB AT ALL WET LOCATION CEILINGS.

 13. COORDINATE ALL LIGHTING WITH CROWN
- MOULDING.

 14. G.C. TO COORDINATE CEILING HEIGHT WITH ARCHITECT AFTER FINAL HVAC SYSTEM SELECTED BY OWNER.
- 15. SEE ARCHITECTURAL ELECTRICAL FOR SWITCHING.
 16. ALL HVAC DUCTWORK IN BASEMENT TO BE EXPOSED UNLESS OTHERWISE NOTED.

DISPLAYED ON ARCHITECTURAL

REFLECTED CEILING PLANS.

17. SEE INTERIOR ELEVATIONS FOR LOCATION
OF WALL REGISTERS.
18. COORDINATE WITH ALL CONSULTANT
DRAWINGS AS ALL ITEMS MAY NOT BE

Ceiling Plan Legend

EXH1 - BATHROOM
EXHAUST FAN

R - RECESSED FIXTURE

WS - WALL SCONCE
P - PENDANT FIXTURE

CF - CEILING FAN/LIGHT
FIXTURE

LED - LINEAR LED STRIP

SML - SURFACE MOUNTED
LINEAR FIXTURE

SD SMOKE DETECTOR
SPRINKLER

FIS FIRE ALARM EMERGENCY

STROBE & HORN
EXIT SIGNAGE

GYPSUM WALL BOARD
CEILING

BEAD BOARD WOOD
CEILING

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 revision
 revision description
 date

 4
 FOR PRICING
 09/14/2017

 5
 FOR PRICING
 09/20/2017

 6
 FOR PERMIT
 09/27/2017

 7
 NOT FOR CONSTRUCTION
 06/04/2018

 8
 FOR PERMIT/PRICING
 07/13/2018

project title
BERKSHIRE STREET RESIDENCE

30 Berkshire St., Cambridge, MA 02141

client
Krissy Ellsworth, Denyce Wicht, Michael
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drawing title

UNIT 1 REFLECTED CEILING PLAN


project number drawing scale approver

O92 As indicated Approver

drawing number revision

A121

1 UNIT 1 REFLECTED CEILING PLAN
1/2" = 1'-0"

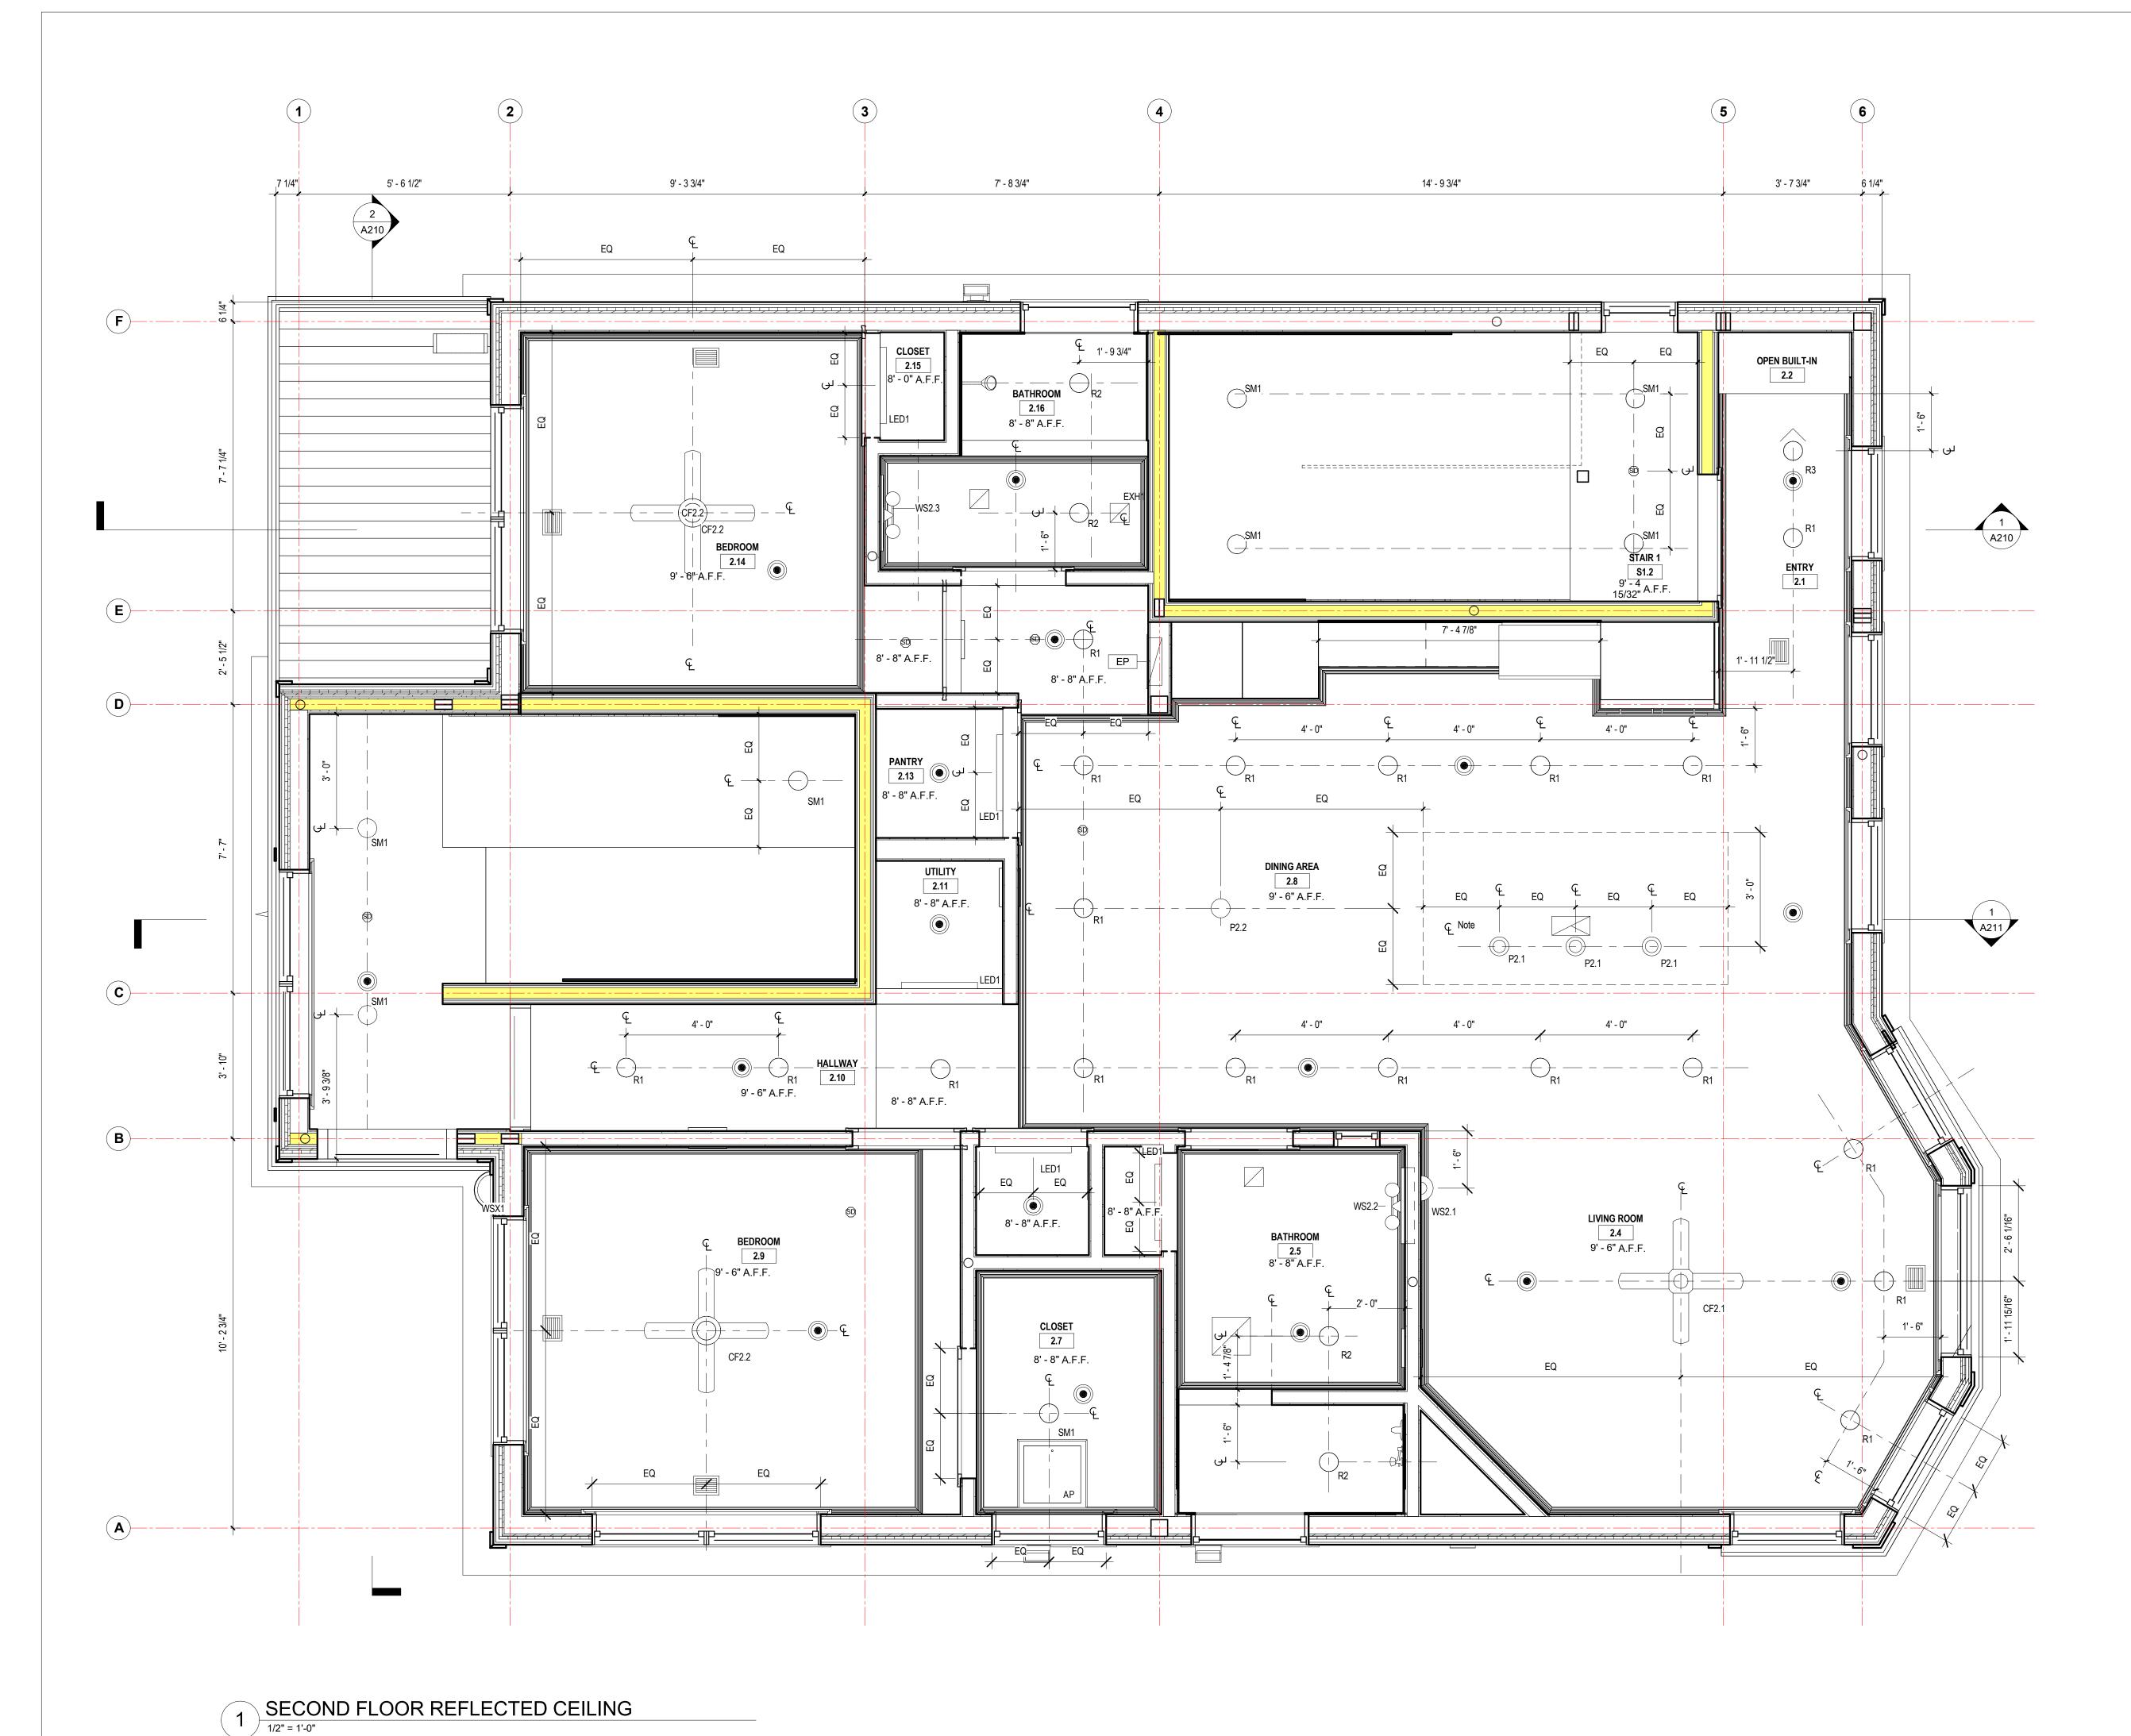

Reflected Ceiling Notes


- LIGHTING, ELECTRICAL EQUIPMENT, HVAC EQUIPMENT, AND SPRINKLERS ARE TO BE MOUNTED ON CENTER OF ACT UNLESS OTHERWISE DIMENSIONED ON REFLECTED CEILING PLAN
- UNLESS OTHERWISE NOTED MULTIPLE SWITCHES IN A SINGLE LOCATION SHALL BE GANGED IN A SINGLE BOX AND COVERED WITH A SINGLE PLATE
- ALL GWB CEILINGS TO BE PAINTED WHITE EGGSHELL U.O.N. PROVIDE EMERGENCY LIGHTING INTEGRAL
- IN FIXTURES. "BUG EYES" ARE NOT ACCEPTABLE, U.O.N. PROVIDE COATING MIXTURE OVER (E)

FIREPROOFING TO PREVENT PARTICLES

- FROM FALLING S.M.D., S.E.D., S.P.D., S.F.P.D. FOR RELEVANT INFO AND COORDINATION OF MECHANICAL, ELECTRICAL, PLUMBING AND
- FIRE PROTECTION ITEMS. ALIGN FIRE ALARM AND ALL OTHER ELECTRIC DEVICES, w/LIGHTING AS INDICATED IN DRAWINGS.
- ALIGN CEILING DEVICES INCLUDING SMOKE DETECTORS, SPRINKLER HEADS, ETC., WITH CEILING MOUNTED LIGHTING FIXTURES UNLESS OTHERWISE NOTED. CENTER ALL BETWEEN ELEMENTS OR WITHIN GRID IN BOTH DIRECTIONS U.O.N. AT TYP. EXPOSED CEILING: - RUN ALL
- ELECTRICAL CONDUITS TIGHT TO UNDERSIDE OF DECK IN JOIST BAYS. RUN ALL ELECTRICAL CONDUIT NEATLY AND PARALLEL TO STRUCTURE U.O.N.. - RUN EXPOSED DUCTWORK AS HIGH AS POSSIBLE & TIGHT TO PARALLEL TO INTERIOR PARTITIONS AND/OR STRUCTURE WHERE APPLICBLE U.O.N.. - PENDANT LIGHTS ARE TO BE MTD TO UNDERSIDE OF DECK U.O.N. - SPRINKLER LINES ARE TO BE MTD TO UNDERSIDE OF DECK. - PAINT ALL EXPOSED STEEL STRUCTURE & METAL DECK U.O.N., REFER TO RCP AND FINISH

SCHEDULE FOR ADDITIONAL INFORMATION

- ALL FIRE SPRINKLER PIPING TO BE PAINTED BLACK U.O.N. PROVIDE UNISTRUT SUPPORTS AT ALL FIXTURES MOUNTED BELOW HVAC
- EQUIPMENT. INSTALL WATER RESISTANT GWB AT ALL WET LOCATION CEILINGS.
- COORDINATE ALL LIGHTING WITH CROWN MOULDING.
- G.C. TO COORDINATE CEILING HEIGHT WITH ARCHITECT AFTER FINAL HVAC SYSTEM SELECTED BY OWNER.
- SEE ARCHITECTURAL ELECTRICAL FOR SWITCHING. ALL HVAC DUCTWORK IN BASEMENT TO BE
- EXPOSED UNLESS OTHERWISE NOTED. SEE INTERIOR ELEVATIONS FOR LOCATION OF WALL REGISTERS.
- COORDINATE WITH ALL CONSULTANT DRAWINGS AS ALL ITEMS MAY NOT BE DISPLAYED ON ARCHITECTURAL REFLECTED CEILING PLANS.

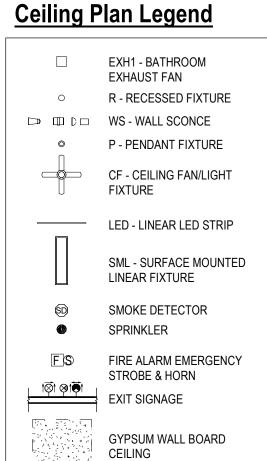

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BEAD BOARD WOOD

CEILING

contractor/consultant

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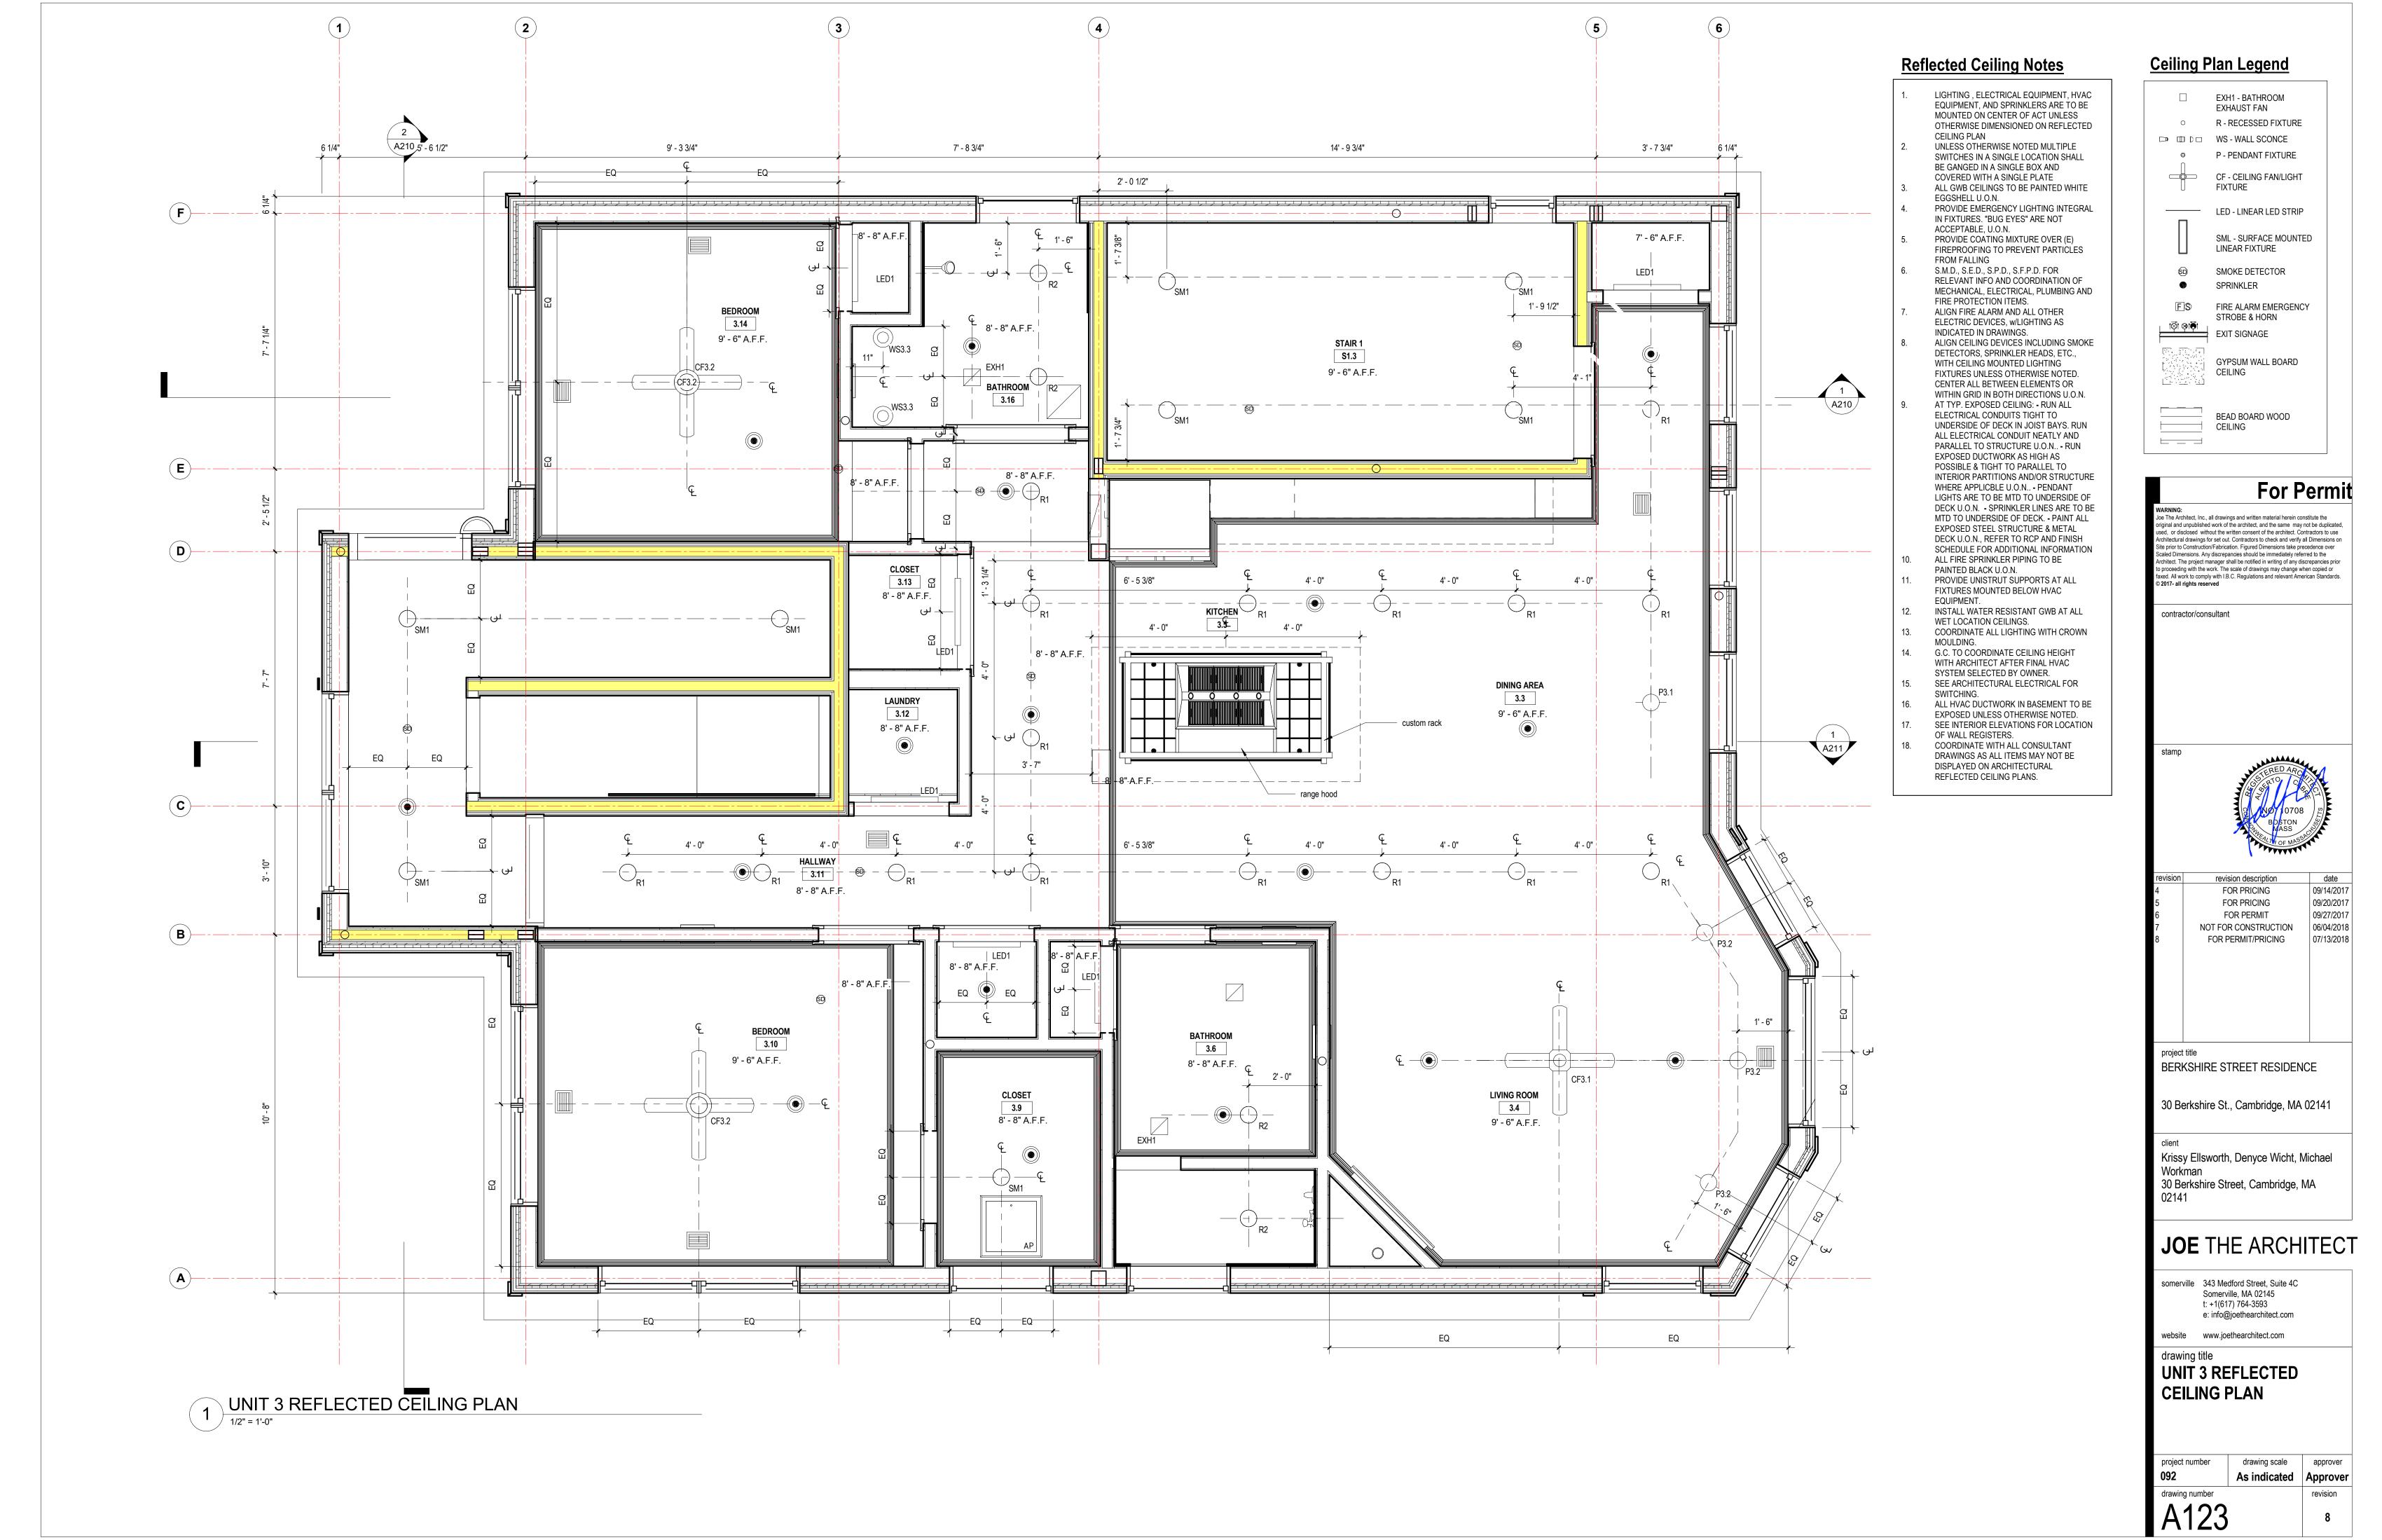
somerville 343 Medford Street, Suite 4C Somerville, MA 02145 t: +1(617) 764-3593 e: info@joethearchitect.com

drawing title

UNIT 2 REFLECTED CEILING PLAN

website www.joethearchitect.com

As indicated | Approver drawing number





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	BASEMENT FINISH LEGEND								
TAG	MATERIAL	LOCATION	DESCRIPTION						
PT1	Paint - 1	Common Area & Basement walls	TBD						
PT2	Paint - 2	Common Area & Basement trim	TBD						
PT3	Paint - 3	Common Area & Basement ceiling	TBD						
WB0	Base Board	Basement throughout	TBD						
CF0	Concrete Flooring	Basement throughout	TBD						

				LIGHTING FIXTURE SCHEDULE									
						Dimensions		$\overline{}$	Lamp				
Type Mark	Count	Description	Manufacturer	Model	W	D	Н	No.	Туре	Watts	Control	Mounting	Remarks
CF1.1	1	Ceiling Fan - Unit 1 - Living Room	Westinghouse Lighting Corporation	7801665 Matte Black w/ Frosted Glass		52" Dia		2	LED	60	ON/OFF	Ceiling	
CF2.1		Ceiling Fan - Unit 2 - Living Room	Craftmade Modern	Midoro - MO56		56" Dia	20 1/4"				ON/OFF	Ceiling	
		Ceiling Fan - Unit 2 - Bedrooms	minkaAire	F519-BN		52" Dia	11.5"	1	HAL		ON/OFF	Ceiling	
CF3.1		Ceiling Fan - Unit 3 - Living Room	minkaAire	F524-ABD		52" Dia	11.5"	+ -			ON/OFF	Ceiling	
		Ceiling Fan - Unit 3 - Bedrooms	minkaAire	F524-ABD		52" Dia	11.5"	+	+		ON/OFF	Ceiling	
FLX-1		Exterior Flood	Lithonia Lighting	OFLR 6LC 120 MO BZ	4 1/8"	7 5/8"	8 1/8"	6	LED	22	SENSOR	7'-6" AFF	Bronze Finish
		LED Closet Fixture	Bartco	BLT210-22-30-5-S2-SM-WH			_	1	LED		SENSOR		White Finish
	3	LED Under Cabinet Strip	Juno	SL212-20FT-30K-80CRI/DLDPS-60W-FPCZT				1	LED	2.2/ft	DIMMABLE	Under Cabinet	Clear
		LED Under Rail Strip	Klik	LPXL-28-F00-30K-1.9-A-FLD-SIM				1	LED		ON/OFF	Under Rail	T.B.D.
		Kitchen Pendant - Unit 1	West Elm	Sculptural Glass Globe Pendant -Small		8 1/2" Dia	8"	1	LED	40	DIMMABLE		
P1.2	1	Dining Room Pendant - Unit 1	Lighting Connection	Geometric Cage Lantern	20"		30"	4	LED	25	DIMMABLE		
P1.4		Guest Bedrooms - Unit 1	Latitude Run	SKU: LRUN6557	24"	24"	13"	3	LED		DIMMABLE		
P2.1	3	Kitchen Pendant - Unit 2	Elk Group International	10435/1		10" Dia	9"	1	LED	60	DIMMABLE		
P2.2	1	Dining Room Pendant - Unit 2	Meyda Lighting	25" Hyde Park T Mission 4 LT Chandelier	25"		35"	4	LED	60	DIMMABLE		
P3.1		Dining Room Pendant - Unit 3	West Elm	Eclipse Chandelier		36" Dia	35"	6	CFL	10	DIMMABLE	7'-6" AFF	
P3.2		Living Room Pendant - Unit 3						+			DIMMABLE		
R1		Recessed Downlight	USAI	P3RDF-15L2-30KS-F-WH-NC-120V-D21				1	LED	15	DIMMABLE		White Finish
R2		Recessed Downlight - Bathrooms	USAI	P3RDF-15L2-30KS-F-WH-NC-120V-D21				1	LED	15	DIMMABLE		White Finish
R3	2	Recessed Downlight - Directional	USAI	B3RAF-15L2-30KS-25-S-WH-NCIC-UNV-D21				1	LED	15	DIMMABLE		White Finish
RX1		Recessed Downlight - Exterior	USAI	P3RDF-15L2-30KS-F-WH-NC-120V-D21				1	LED	15	TIMER		White Finish
SM1		Surface Mounted Downlight	USAI	BLRD5-12C3-30KS-50-S-WH-RB-UNV-D2				1	LED				White Finish
SML1	10	Surface Mounted Troffer- 1X4	Lithonia Lighting	CLX-L48-3000LM-SEF-FDL-120-GZ10-30K-80C RI-WH				1	LED	22	ON/OFF		White Finish
SML2	7	Surface Mounted Troffer - 2X2	Lithonia Lighting	2TLX2-20L-FW-A12-120-EZ1-LP830				1	LED	18	ON/OFF		White Finish
WS1.1	2	Wall Sconce - Master Bathroom - Unit 1	Modern Forms	WS-W81625	25"	2 3/4"	3"	N/A	LED	20	ON/OFF	5'-6" AFF; Verical	
WS1.2	1	Wall Sconce - Guest Bathroom - Unit 1	Modern Forms	WS-W81619	19"	2 3/4"	3"	N/A	LED	15	ON/OFF	6'-6" AFF; Horizontal	
WS2.1	1	Wall Sconce - Living Room - Unit 2	TBD								DIMMABLE		
WS2.2	1												
WS2.3	1												
WS3.1	2	Wall Sconce - Master Bathroom - Unit 3									ON/OFF		
WS3.2	2	Wall Sconce - Master Bedroom - Unit 3	West Elm	Arc Mid-Century Sconce - Single	4"	6"	6"	1	CFL	13	DIMMABLE	5'-6" AFF; Upward	
WS3.3	2	Wall Sconce - Guest Bathroom - Unit 3									ON/OFF		
WSX1	7	Wall Sconce - Exterior - Entry	Norwell Lighting	Weymouth							TIMER		
WSX3	3	Wall Sconce - Exterior - Private Deck	Norwell Lighting	Weymouth							ON/OFF		
XP1	8	Exterior Post - Bollard	Lumen Pulse	MOB3201-120-L30-40K-S-Finish-NO		6" Dia	39"	1	LED	30	TIMER	N/A	T.B.D.
Grand total:	175						1			1	-1		




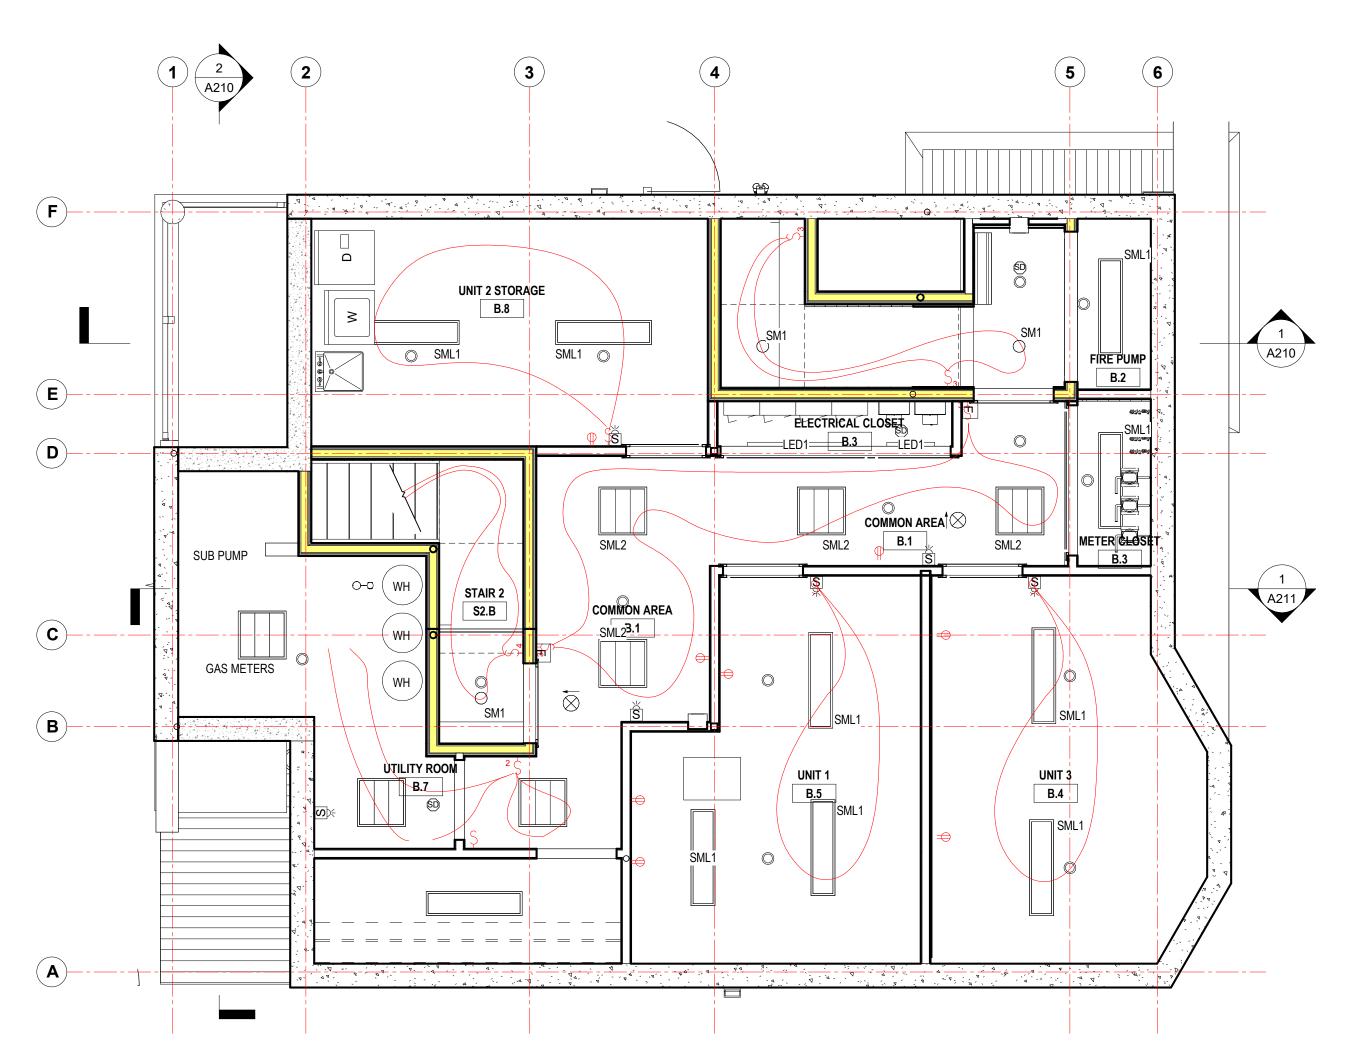


2 COMMON BASEMENT ELECTRICAL LAYOUT

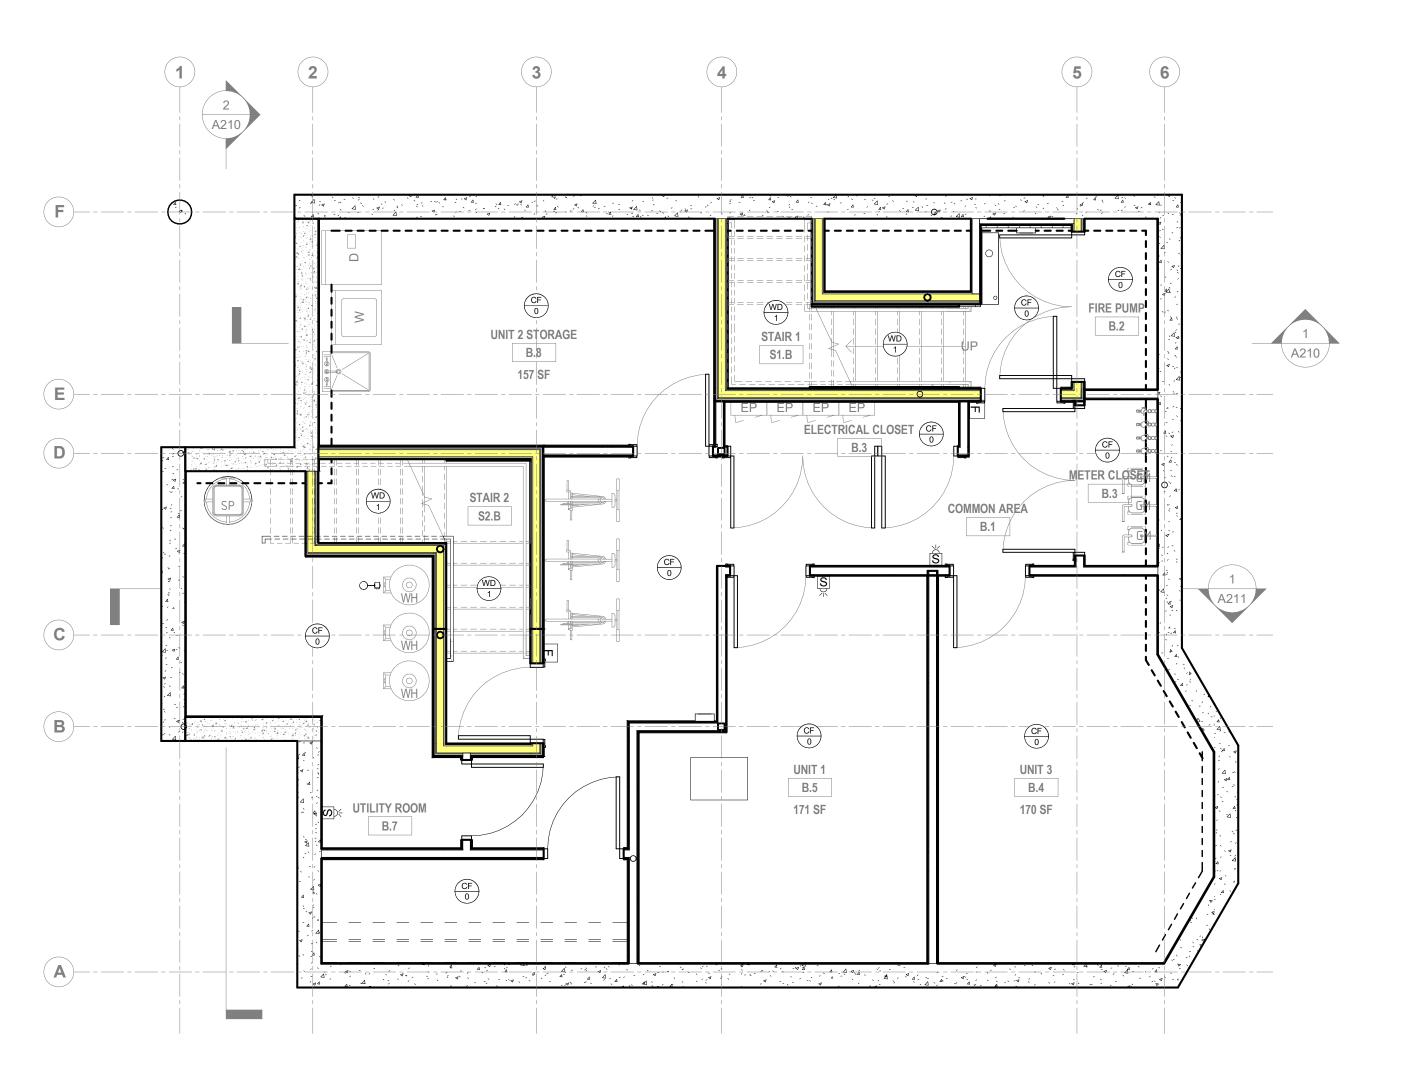1 COMMON BASEMENT FINISH PLAN
1/4" = 1'-0"



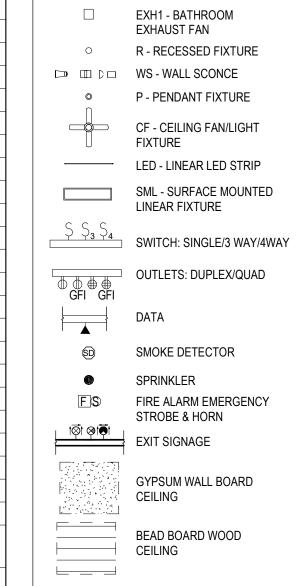

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revision	revision description	date
4	FOR PRICING	09/14/2017
5	FOR PRICING	09/20/2017
6	FOR PERMIT	09/27/2017
7	NOT FOR CONSTRUCTION	06/04/2018
8	FOR PERMIT/PRICING	07/13/2018
	1	
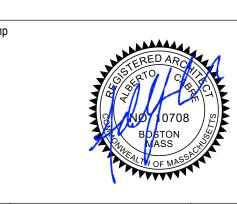
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client
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Workman
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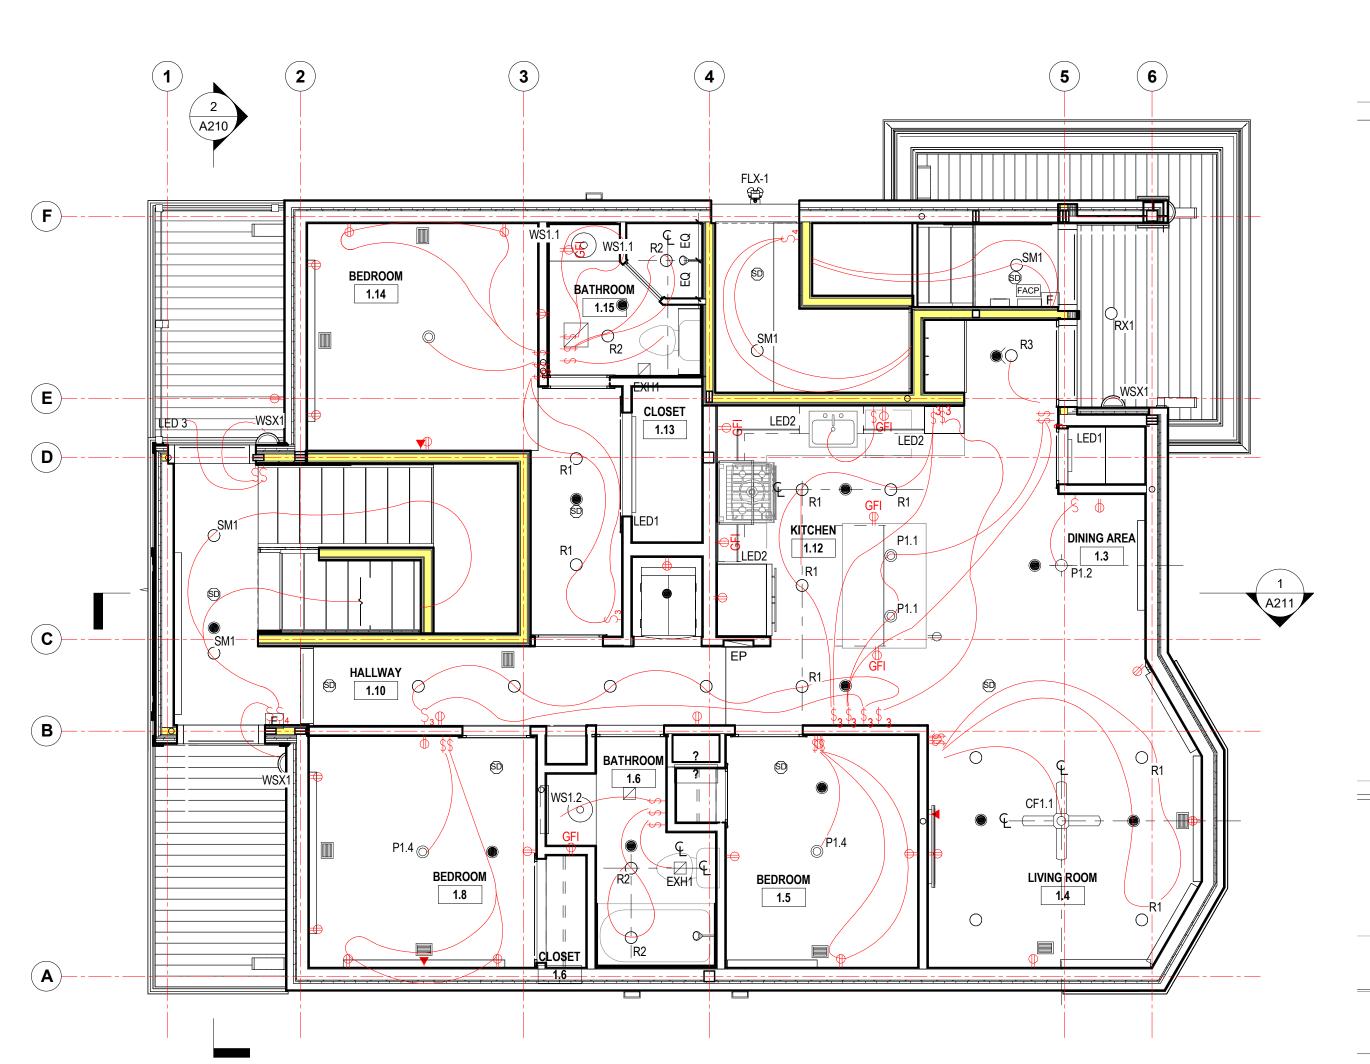
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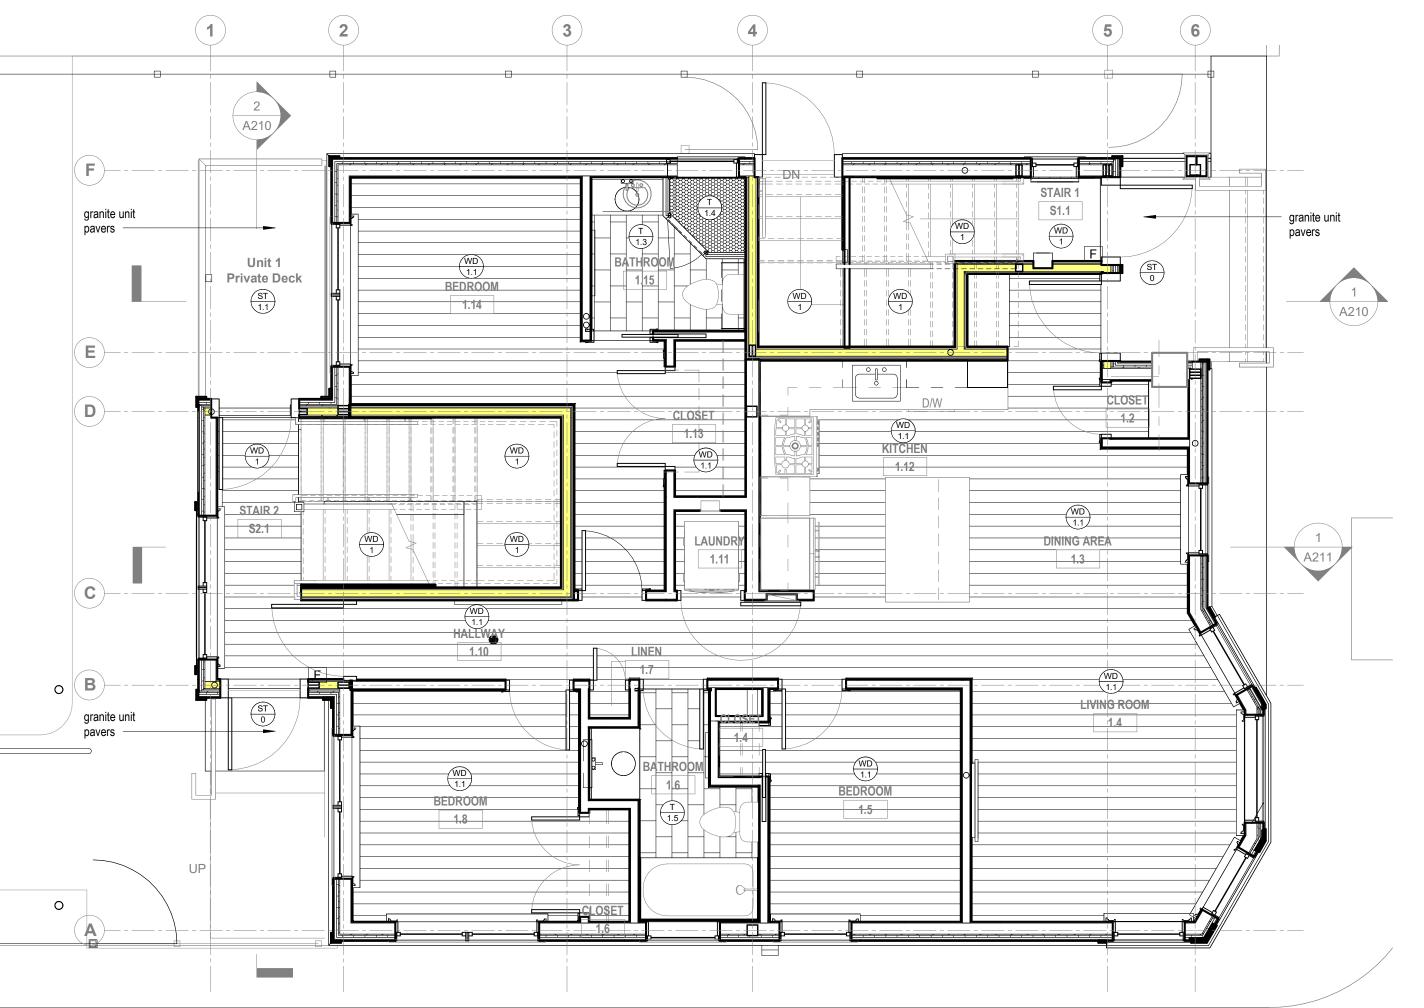
website www.joethearchitect.com
drawing title

COMMON BASEMENT
ARCHITECTURAL
ELECTRIC & FINISH
PLANS

project number	drawing scale	approver
092	As indicated	AS
drawing number		revision
A130		8

				LIGHTING FIXTURE SCHEDULE									
						Dimensions			Lamp				
Type Mark	Count	Description	Manufacturer	Model	W	D	Н	No.	Туре	Watts	Control	Mounting	Remarks
CF1.1	1	Ceiling Fan - Unit 1 - Living Room	Westinghouse Lighting Corporation	7801665 Matte Black w/ Frosted Glass		52" Dia		2	LED	60	ON/OFF (Ceiling	
CF2.1	1	Ceiling Fan - Unit 2 - Living Room	Craftmade Modern	Midoro - MO56		56" Dia	20 1/4"	4/2		25/60	ON/OFF (Ceiling	
CF2.2	2	Ceiling Fan - Unit 2 - Bedrooms	minkaAire	F519-BN		52" Dia	11.5"	1	HAL	100	ON/OFF (Ceiling	
CF3.1	1	Ceiling Fan - Unit 3 - Living Room	minkaAire	F524-ABD		52" Dia	11.5"				ON/OFF (Ceiling	
CF3.2	2	Ceiling Fan - Unit 3 - Bedrooms	minkaAire	F524-ABD		52" Dia	11.5"				ON/OFF (Ceiling	
FLX-1	1	Exterior Flood	Lithonia Lighting	OFLR 6LC 120 MO BZ	4 1/8"	7 5/8"	8 1/8"	6	LED	22	SENSOR 7	7'-6" AFF	Bronze Finish
LED1	15	LED Closet Fixture	Bartco	BLT210-22-30-5-S2-SM-WH				1	LED	10	SENSOR		White Finish
LED2	3	LED Under Cabinet Strip	Juno	SL212-20FT-30K-80CRI/DLDPS-60W-FPCZT				1	LED	2.2/ft	DIMMABLE U	Jnder Cabinet	Clear
LED3	3	LED Under Rail Strip	Klik	LPXL-28-F00-30K-1.9-A-FLD-SIM				1	LED	1.9	ON/OFF U	Jnder Rail	T.B.D.
P1.1	2	Kitchen Pendant - Unit 1	West Elm	Sculptural Glass Globe Pendant -Small		8 1/2" Dia	8"	1	LED	40	DIMMABLE 6	6'-0" AFF	
P1.2	1	Dining Room Pendant - Unit 1	Lighting Connection	Geometric Cage Lantern	20"		30"	4	LED	25	DIMMABLE 7	7'-6" AFF	
P1.4	3	Guest Bedrooms - Unit 1	Latitude Run	SKU: LRUN6557	24"	24"	13"	3	LED	60	DIMMABLE (Ceiling	
P2.1	3	Kitchen Pendant - Unit 2	Elk Group International	10435/1		10" Dia	9"	1	LED	60	DIMMABLE 6	6'-0" AFF	
P2.2	1	Dining Room Pendant - Unit 2	Meyda Lighting	25" Hyde Park T Mission 4 LT Chandelier	25"		35"	4	LED	60	DIMMABLE 7	7'-6" AFF	
P3.1	1	Dining Room Pendant - Unit 3	West Elm	Eclipse Chandelier		36" Dia	35"	6	CFL	10	DIMMABLE 7	7'-6" AFF	
P3.2	3	Living Room Pendant - Unit 3									DIMMABLE		
R1	49	Recessed Downlight	USAI	P3RDF-15L2-30KS-F-WH-NC-120V-D21				1	LED	15	DIMMABLE		White Finish
R2	12	Recessed Downlight - Bathrooms	USAI	P3RDF-15L2-30KS-F-WH-NC-120V-D21				1	LED	15	DIMMABLE		White Finish
R3	2	Recessed Downlight - Directional	USAI	B3RAF-15L2-30KS-25-S-WH-NCIC-UNV-D21				1	LED	15	DIMMABLE		White Finish
RX1	1	Recessed Downlight - Exterior	USAI	P3RDF-15L2-30KS-F-WH-NC-120V-D21				1	LED	15	TIMER		White Finish
SM1	21	Surface Mounted Downlight	USAI	BLRD5-12C3-30KS-50-S-WH-RB-UNV-D2				1	LED				White Finish
SML1	10	Surface Mounted Troffer- 1X4	Lithonia Lighting	CLX-L48-3000LM-SEF-FDL-120-GZ10-30K-80C RI-WH				1	LED	22	ON/OFF		White Finish
SML2	7	Surface Mounted Troffer - 2X2	Lithonia Lighting	2TLX2-20L-FW-A12-120-EZ1-LP830				1	LED	18	ON/OFF		White Finish
WS1.1	2	Wall Sconce - Master Bathroom - Unit 1	Modern Forms	WS-W81625	25"	2 3/4"	3"	N/A	LED	20	ON/OFF 5	5'-6" AFF; Verical	
WS1.2	1	Wall Sconce - Guest Bathroom - Unit 1	Modern Forms	WS-W81619	19"	2 3/4"	3"	N/A	LED	15	ON/OFF 6	6'-6" AFF; Horizontal	
WS2.1	1	Wall Sconce - Living Room - Unit 2	TBD								DIMMABLE		
WS2.2	1												
WS2.3	1												
WS3.1	2	Wall Sconce - Master Bathroom - Unit 3									ON/OFF		
WS3.2	2	Wall Sconce - Master Bedroom - Unit 3	West Elm	Arc Mid-Century Sconce - Single	4"	6"	6"	1	CFL	13	DIMMABLE 5	5'-6" AFF; Upward	
WS3.3	2	Wall Sconce - Guest Bathroom - Unit 3									ON/OFF	·	
WSX1	7	Wall Sconce - Exterior - Entry	Norwell Lighting	Weymouth							TIMER		
WSX3	3	Wall Sconce - Exterior - Private Deck	Norwell Lighting	Weymouth							ON/OFF		
XP1	8	Exterior Post - Bollard	Lumen Pulse	MOB3201-120-L30-40K-S-Finish-NO		6" Dia	39"	1	LED	30	TIMER 1	N/A	T.B.D.
Grand tota	175												






2 UNIT 1 ELECTRICAL LAYOUT

1/4" = 1'-0"






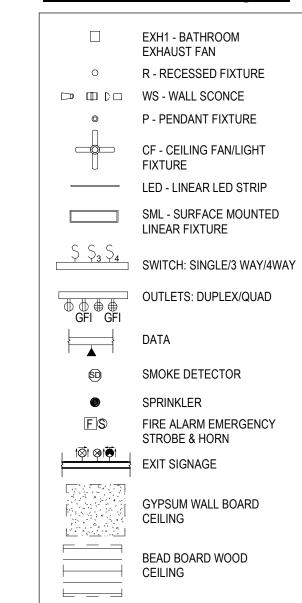

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contractor/consultant



revision description FOR PRICING 09/14/2017 FOR PRICING 09/20/2017 FOR PERMIT 09/27/2017 NOT FOR CONSTRUCTION FOR PERMIT/PRICING

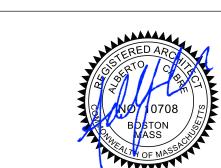BERKSHIRE STREET RESIDENCE

30 Berkshire St., Cambridge, MA 02141

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website www.joethearchitect.com


drawing title

UNIT 1 ARCHITECTURAL ELECTRIC & FINISH PLANS

project number	drawing scale	approver
092	As indicated	AS
drawing number		revision
A131		8


ΓAG	MATERIAL	LOCATION	DESCRIPTION
PT1	Paint - 1	Common Area walls	TBD
PT2	Paint - 2	Common Area trim	TBD
PT3	Paint - 3	Common Area ceiling	TBD
PT2.1	Paint - 2.1	Unit 2 walls: hallways, living, dining, kitchen	Benjamin Moore 962 Gray Mist- Eggshell
PT2.2	Paint - 2.2	Unit 2 master bedroom walls	Benjamin Moore 2147-60 Dark Linen - Eggshell
PT2.3	Paint - 2.3	Unit 2 trim	Benjamin Moore OC-117 Simply White - Semi-gloss
PT2.4	Paint - 2.4	Unit 2 ceiling	Benjamin Moore OC-117 Simply White - Flat
PT2.5	Paint - 2.5	Unit 2 master bathroom walls	TBD
PT2.6	Paint - 2.6	Unit 2 guest bedroom walls	TBD
PT2.7	Paint - 2.7	Unit 2 guest bathroom walls	TBD
T2.1	Tile - 2.1	Unit 2 Flooring throughout	Legna 6x36 Scur
T2.2	Tile - 2.2	Kitchen backsplash	Evolution Series 2x8 white
T2.3	Tile - 2.3	Fireplace surround	Golden Sand Quartzite Interlocking 6x24
T2.4	Tile - 2.4	Master bathroom floor	White pinwheel mosaic; TBD
T2.5	Tile -2.5	Master bathroom shower walls	Bacci Marmi Bianco Venatino Gioa 3x6 Polished
T2.6	Tile - 2.6	Guest bathroom floor	Seneca Tile Periwinkle 6x6 ceramic tile w/ delorean grey power grout
T2.7	Tile - 2.7	Guest bathroom shower surround	Neri white 3x6 white subway tile
T2.8	Tile - 2.8	Guest bathroom accent tile 1; 2 rows	Cepac Tile Serenity tranquil sky, basket weave
T2.9	Tile - 2.9	Guest bathroom accent tile 2; trim	Neri white rope
T2.10	Tile - 2.10	Guest bathroom accent tile 3; shower niche	Cepac Tile; TDB
WD1	Hardwood Flooring	Common Area Flooring (Levels 1 - 3 & Stairs)	TBD
WD2.1	Exterior Decking - 2.1	Exterior Decks	Azek TBD
BB2	Beadboard panneling	Unit 2 bathrooms & entry built in as indicated	White
WB2	Baseboard	Unit 2 thoughout	TBD

				LIGHTING FIXTURE SCHEDULE									
						Dimensions			Lamp				
Type Mark	Count	Description	Manufacturer	Model	W	D	Н	No.	Туре	Watts	Control	Mounting	Remarks
0=4.4	T.	Ja										To	
CF1.1	1	Ceiling Fan - Unit 1 - Living Room	Westinghouse Lighting Corporation	7801665 Matte Black w/ Frosted Glass		52" Dia		2	LED		ON/OFF	Ceiling	
CF2.1	1	Ceiling Fan - Unit 2 - Living Room	Craftmade Modern	Midoro - MO56		56" Dia	20 1/4"	4/2				Ceiling	
CF2.2	2	Ceiling Fan - Unit 2 - Bedrooms	minkaAire	F519-BN		52" Dia	11.5"	1	HAL		ON/OFF	Ceiling	
CF3.1	1	Ceiling Fan - Unit 3 - Living Room	minkaAire	F524-ABD		52" Dia	11.5"					Ceiling	
CF3.2	2	Ceiling Fan - Unit 3 - Bedrooms	minkaAire	F524-ABD		52" Dia	11.5"				ON/OFF	Ceiling	
FLX-1	1	Exterior Flood	Lithonia Lighting	OFLR 6LC 120 MO BZ	4 1/8"	7 5/8"	8 1/8"	6	LED		SENSOR	7'-6" AFF	Bronze Finish
LED1	15	LED Closet Fixture	Bartco	BLT210-22-30-5-S2-SM-WH				1	LED	10	SENSOR		White Finish
LED2	3	LED Under Cabinet Strip	Juno	SL212-20FT-30K-80CRI/DLDPS-60W-FPCZT				1	LED	2.2/ft [DIMMABLE	Under Cabinet	Clear
LED3	3	LED Under Rail Strip	Klik	LPXL-28-F00-30K-1.9-A-FLD-SIM				1	LED	1.9	ON/OFF	Under Rail	T.B.D.
P1.1	2	Kitchen Pendant - Unit 1	West Elm	Sculptural Glass Globe Pendant -Small		8 1/2" Dia	8"	1	LED	40 [I	DIMMABLE	6'-0" AFF	
P1.2	1	Dining Room Pendant - Unit 1	Lighting Connection	Geometric Cage Lantern	20"		30"	4	LED	25 [DIMMABLE	7'-6" AFF	
P1.4	3	Guest Bedrooms - Unit 1	Latitude Run	SKU: LRUN6557	24"	24"	13"	3	LED	60 I	DIMMABLE	Ceiling	
P2.1	3	Kitchen Pendant - Unit 2	Elk Group International	10435/1		10" Dia	9"	1	LED	60 [DIMMABLE	6'-0" AFF	
P2.2	1	Dining Room Pendant - Unit 2	Meyda Lighting	25" Hyde Park T Mission 4 LT Chandelier	25"		35"	4	LED	60 I	DIMMABLE	7'-6" AFF	
P3.1	1	Dining Room Pendant - Unit 3	West Elm	Eclipse Chandelier		36" Dia	35"	6	CFL	10 [DIMMABLE	7'-6" AFF	
P3.2	3	Living Room Pendant - Unit 3]	DIMMABLE		
R1	49	Recessed Downlight	USAI	P3RDF-15L2-30KS-F-WH-NC-120V-D21				1	LED	15 [DIMMABLE		White Finish
R2	12	Recessed Downlight - Bathrooms	USAI	P3RDF-15L2-30KS-F-WH-NC-120V-D21				1	LED	15 [DIMMABLE		White Finish
R3	2	Recessed Downlight - Directional	USAI	B3RAF-15L2-30KS-25-S-WH-NCIC-UNV-D21				1	LED	15 [DIMMABLE		White Finish
RX1	1	Recessed Downlight - Exterior	USAI	P3RDF-15L2-30KS-F-WH-NC-120V-D21				1	LED	15	TIMER		White Finish
SM1	21	Surface Mounted Downlight	USAI	BLRD5-12C3-30KS-50-S-WH-RB-UNV-D2				1	LED				White Finish
SML1	10	Surface Mounted Troffer- 1X4	Lithonia Lighting	CLX-L48-3000LM-SEF-FDL-120-GZ10-30K-80C RI-WH				1	LED	22 (ON/OFF		White Finish
SML2	7	Surface Mounted Troffer - 2X2	Lithonia Lighting	2TLX2-20L-FW-A12-120-EZ1-LP830				1	LED	18 (ON/OFF		White Finish
WS1.1	2	Wall Sconce - Master Bathroom - Unit 1	Modern Forms	WS-W81625	25"	2 3/4"	3"	N/A				5'-6" AFF; Verical	
WS1.2	1	Wall Sconce - Guest Bathroom - Unit 1	Modern Forms	WS-W81619	19"	2 3/4"	3"		LED			6'-6" AFF; Horizontal	
WS2.1	1	Wall Sconce - Living Room - Unit 2	TBD	7.5 115 12.5							DIMMABLE	, , , , , , , , , , , , , , , , , , ,	
WS2.2	1												
WS2.3	1												
WS3.1	2	Wall Sconce - Master Bathroom - Unit 3								(ON/OFF		
WS3.2	2	Wall Sconce - Master Bedroom - Unit 3	West Elm	Arc Mid-Century Sconce - Single	4"	6"	6"	1	CFL			5'-6" AFF; Upward	
WS3.3	2	Wall Sconce - Guest Bathroom - Unit 3	77 95t E.III	, as made sentary desires danger	•			•	0		ON/OFF	o o min, opmana	
WSX1	7	Wall Sconce - Exterior - Entry	Norwell Lighting	Weymouth							TIMER		
WSX3	3	Wall Sconce - Exterior - Private Deck	Norwell Lighting	Weymouth							ON/OFF		
XP1	8	Exterior Post - Bollard	Lumen Pulse	MOB3201-120-L30-40K-S-Finish-NO		6" Dia	39"	1	LED			N/A	T.B.D.
Grand total:	· 175	Extensi i oot Bollaid	Edition 1 dioc	10100001 120 200 4010 0 1 IIII311-140		J Dia	00	<u> </u>				1 4// 1	1.0.0.

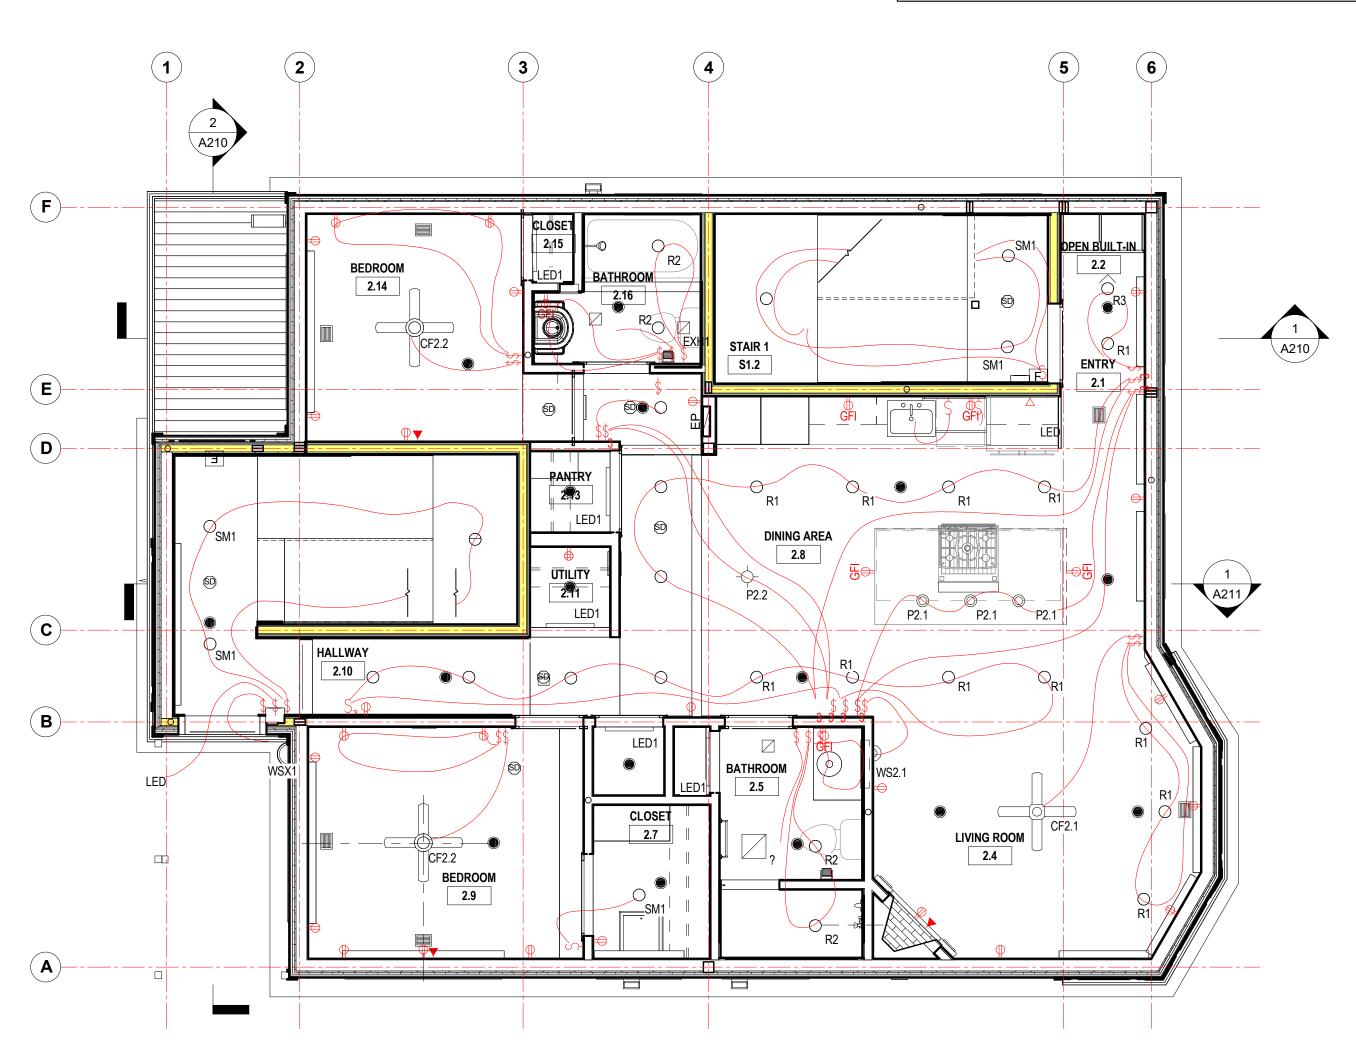

2 UNIT 2 ELECTRICAL LAYOUT

1/4" = 1'-0"

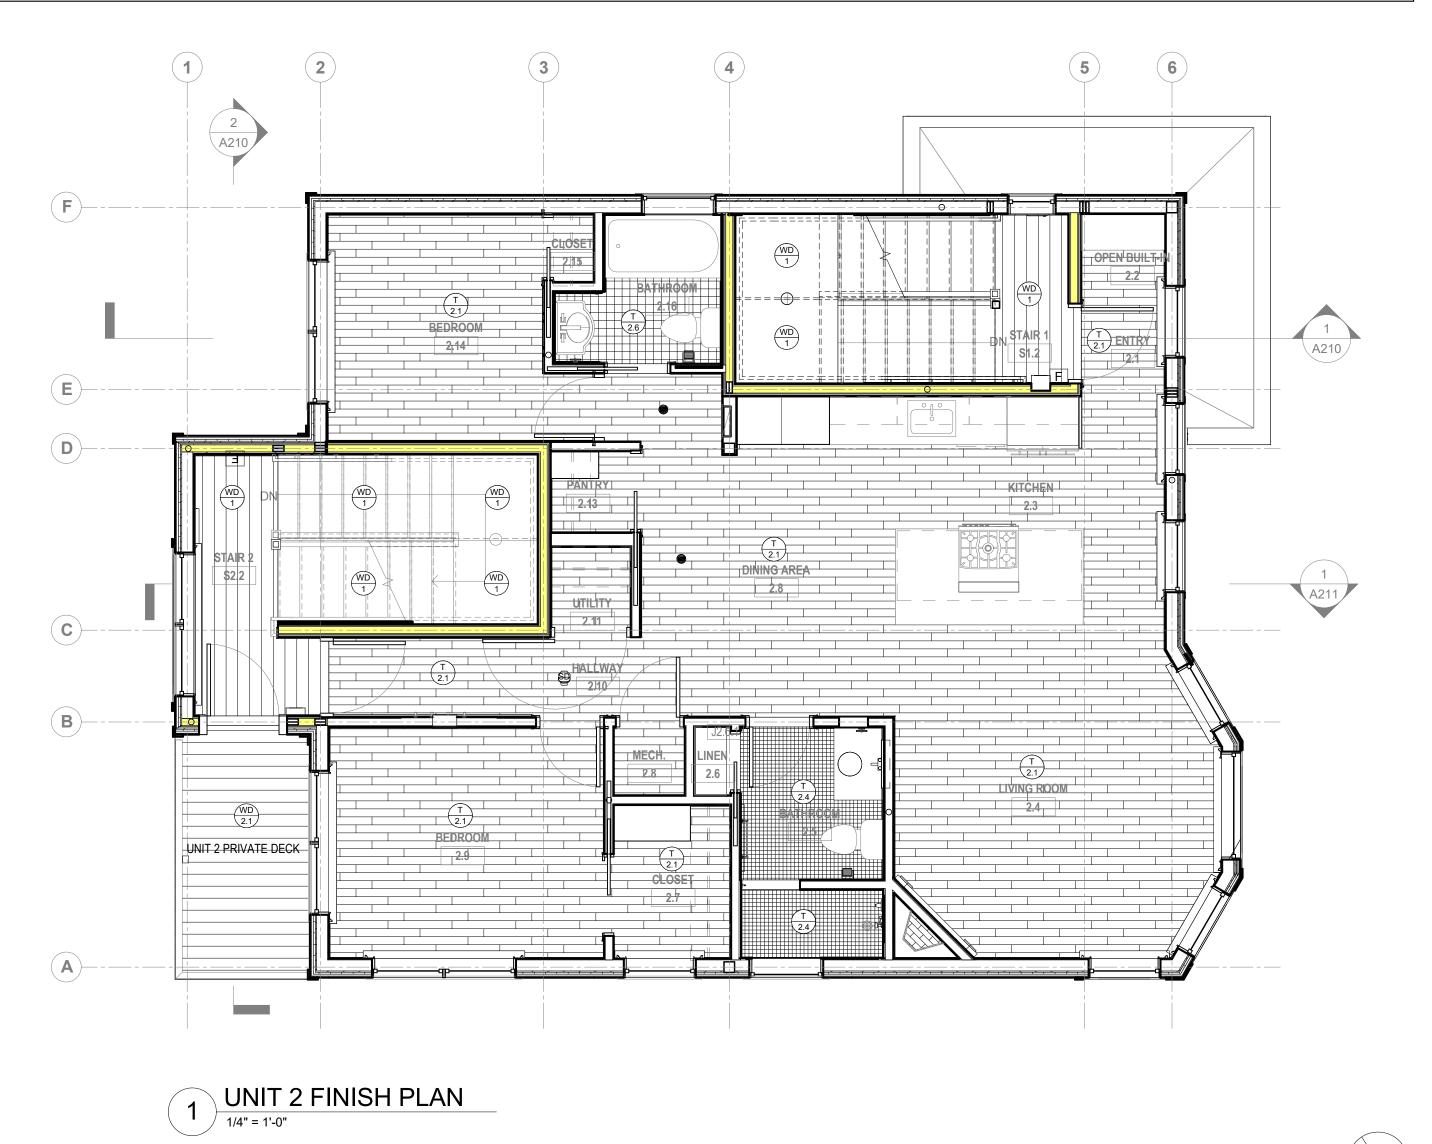

P - PENDANT FIXTURE

CF - CEILING FAN/LIGHT FIXTURE LED - LINEAR LED STRIP

□ □ □ □ WS - WALL SCONCE

Electrical Fixture Legend

☐ EXH1 - BATHROOM EXHAUST FAN R - RECESSED FIXTURE

SML - SURFACE MOUNTED LINEAR FIXTURE SWITCH: SINGLE/3 WAY/4WAY OUTLETS: DUPLEX/QUAD
GFI GFI

SMOKE DETECTOR


SPRINKLER FIRE ALARM EMERGENCY STROBE & HORN EXIT SIGNAGE

GYPSUM WALL BOARD CEILING $\overline{}$ BEAD BOARD WOOD BEAD BOAF CEILING

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revision description 09/14/2017 09/20/2017 FOR PRICING FOR PRICING FOR PERMIT 09/27/2017 06/04/2018 NOT FOR CONSTRUCTION FOR PERMIT/PRICING

BERKSHIRE STREET RESIDENCE

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website www.joethearchitect.com drawing title

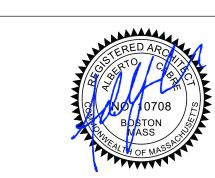
UNIT 2 ARCHITECTURAL ELECTRIC & FINISH PLANS

drawing scale As indicated drawing number




	LEVEL 3 FINISH LEGEND									
TAG	MATERIAL	LOCATION	DESCRIPTION							
PT1	Paint - 1	Common Area walls	TBD							
PT2	Paint - 2	Common Area trim	TBD							
PT3	Paint - 3	Common Area ceiling	TBD							
PT3.1	Paint - 3.1	Unit 3 throughout (excluding bathrooms)	TBD							
PT3.2	Paint - 3.2	Unit 3 bathroom walls	TBD							
PT3.3	Paint - 3.3	Unit 3 trim	Benjamin Moore OC-117 Simply White - Semi-gloss							
PT3.4	Paint - 3.4	Unit 3 ceiling	Benjamin Moore OC-117 Simply White - Flat							
T3.1	Tile - 3.1	Kitchen backsplash	TBD							
T3.2	Tile - 3.2	Fireplace surround	Tile; TBD							
T3.3	Tile - 3.3	Master Bathroom flooring	Craft Series 12x24 Cotton							
T3.4	Tile - 3.4	Master Bathroom shower surrounds	Craft Series 12x24 Cotton with Tec Silverado Power Grout							
T3.5	Tile - 3.5	Master Bathroom shower floor	Craft Series wool Basketweave Mosaic with Tec Mist Power Grout							
T3.6	Tile - 3.6	Guest Bathroom floor	Bits & Pieces 12x24 Pewter Smoke Matte with Tec Warm Taupe Power Grout							
T3.7	Tile - 3.7	Guest Bathroom walls	Alaska White 4x8 Flat Gloss with Tec Warm Taupe Power Grout							
T3.8	Tile - 3.8	Guest Bathroom walls	Alaska White 2x8 Bullnose Gloss with Tec Warm Taupe Power Grout							
WD1	Hardwood Flooring	Common Area Flooring (Levels 1 - 3 & Stairs)	TBD							
WD1	Hardwood Flooring	Unit 3 Flooring throughout (excluding bathrooms)	TBD							
WD3.1	Exterior Decking - 3.1	Exterior Decks	Azek TBD							
WB3	Baseboard	Unit 3 throughout	TBD							

				LIGHTING FIXTURE SCHEDULE									
						Lamp		Lamp					
Type Mark	Count	Description	Manufacturer	Model	W	D	Н	No.	Туре	Watts	Control	Mounting	Remarks
CF1.1	1	Ceiling Fan - Unit 1 - Living Room	Westinghouse Lighting Corporation	7801665 Matte Black w/ Frosted Glass		52" Dia		2	LED	60	ON/OFF	Ceiling	
CF2.1	1	Ceiling Fan - Unit 2 - Living Room	Craftmade Modern	Midoro - MO56		56" Dia	20 1/4"	4/2		25/60	ON/OFF	Ceiling	
CF2.2	2	Ceiling Fan - Unit 2 - Bedrooms	minkaAire	F519-BN		52" Dia	11.5"	1	HAL	100	ON/OFF	Ceiling	
CF3.1	1	Ceiling Fan - Unit 3 - Living Room	minkaAire	F524-ABD		52" Dia	11.5"				ON/OFF	Ceiling	
CF3.2	2	Ceiling Fan - Unit 3 - Bedrooms	minkaAire	F524-ABD		52" Dia	11.5"				ON/OFF	Ceiling	
FLX-1	1	Exterior Flood	Lithonia Lighting	OFLR 6LC 120 MO BZ	4 1/8"	7 5/8"	8 1/8"	6	LED	22	SENSOR	7'-6" AFF	Bronze Finish
LED1	15	LED Closet Fixture	Bartco	BLT210-22-30-5-S2-SM-WH				1	LED	10	SENSOR		White Finish
LED2	3	LED Under Cabinet Strip	Juno	SL212-20FT-30K-80CRI/DLDPS-60W-FPCZT				1	LED	2.2/ft	DIMMABLE	Under Cabinet	Clear
LED3	3	LED Under Rail Strip	Klik	LPXL-28-F00-30K-1.9-A-FLD-SIM				1	LED	1.9	ON/OFF	Under Rail	T.B.D.
P1.1	2	Kitchen Pendant - Unit 1	West Elm	Sculptural Glass Globe Pendant -Small		8 1/2" Dia	8"	1	LED	40	DIMMABLE	6'-0" AFF	
P1.2	1	Dining Room Pendant - Unit 1	Lighting Connection	Geometric Cage Lantern	20"		30"	4	LED	25	DIMMABLE	7'-6" AFF	
P1.4	3	Guest Bedrooms - Unit 1	Latitude Run	SKU: LRUN6557	24"	24"	13"	3	LED	60	DIMMABLE	Ceiling	
P2.1	3	Kitchen Pendant - Unit 2	Elk Group International	10435/1		10" Dia	9"	1	LED	60	DIMMABLE	6'-0" AFF	
P2.2	1	Dining Room Pendant - Unit 2	Meyda Lighting	25" Hyde Park T Mission 4 LT Chandelier	25"		35"	4	LED	60	DIMMABLE	7'-6" AFF	
P3.1	1	Dining Room Pendant - Unit 3	West Elm	Eclipse Chandelier		36" Dia	35"	6	CFL	10	DIMMABLE	7'-6" AFF	
P3.2	3	Living Room Pendant - Unit 3		·							DIMMABLE		
R1	49	Recessed Downlight	USAI	P3RDF-15L2-30KS-F-WH-NC-120V-D21				1	LED	15	DIMMABLE		White Finish
R2	12	Recessed Downlight - Bathrooms	USAI	P3RDF-15L2-30KS-F-WH-NC-120V-D21				1	LED	15	DIMMABLE		White Finish
R3	2	Recessed Downlight - Directional	USAI	B3RAF-15L2-30KS-25-S-WH-NCIC-UNV-D21				1	LED	15	DIMMABLE		White Finish
RX1	1	Recessed Downlight - Exterior	USAI	P3RDF-15L2-30KS-F-WH-NC-120V-D21				1	LED	15	TIMER		White Finish
SM1	21	Surface Mounted Downlight	USAI	BLRD5-12C3-30KS-50-S-WH-RB-UNV-D2				1	LED				White Finish
SML1	10	Surface Mounted Troffer- 1X4	Lithonia Lighting	CLX-L48-3000LM-SEF-FDL-120-GZ10-30K-80C RI-WH				1	LED	22	ON/OFF		White Finish
SML2	7	Surface Mounted Troffer - 2X2	Lithonia Lighting	2TLX2-20L-FW-A12-120-EZ1-LP830				1	LED	18	ON/OFF		White Finish
WS1.1	2	Wall Sconce - Master Bathroom - Unit 1	Modern Forms	WS-W81625	25"	2 3/4"	3"	N/A	LED	20	ON/OFF	5'-6" AFF; Verical	
WS1.2	1	Wall Sconce - Guest Bathroom - Unit 1	Modern Forms	WS-W81619	19"	2 3/4"	3"	N/A	LED	15	ON/OFF	6'-6" AFF; Horizontal	
WS2.1	1	Wall Sconce - Living Room - Unit 2	TBD								DIMMABLE		
WS2.2	1	,											
WS2.3	1												
WS3.1	2	Wall Sconce - Master Bathroom - Unit 3									ON/OFF		
WS3.2	2	Wall Sconce - Master Bedroom - Unit 3	West Elm	Arc Mid-Century Sconce - Single	4"	6"	6"	1	CFL	13	DIMMABLE	5'-6" AFF; Upward	
WS3.3	2	Wall Sconce - Guest Bathroom - Unit 3		, ,							ON/OFF		
WSX1	7	Wall Sconce - Exterior - Entry	Norwell Lighting	Weymouth							TIMER		
WSX3	3	Wall Sconce - Exterior - Private Deck	Norwell Lighting	Weymouth							ON/OFF		
XP1	8	Exterior Post - Bollard	Lumen Pulse	MOB3201-120-L30-40K-S-Finish-NO		6" Dia	39"	1	LED	30	TIMER	N/A	T.B.D.
Grand total:	175	1		<u> </u>		1			l	I -	1		

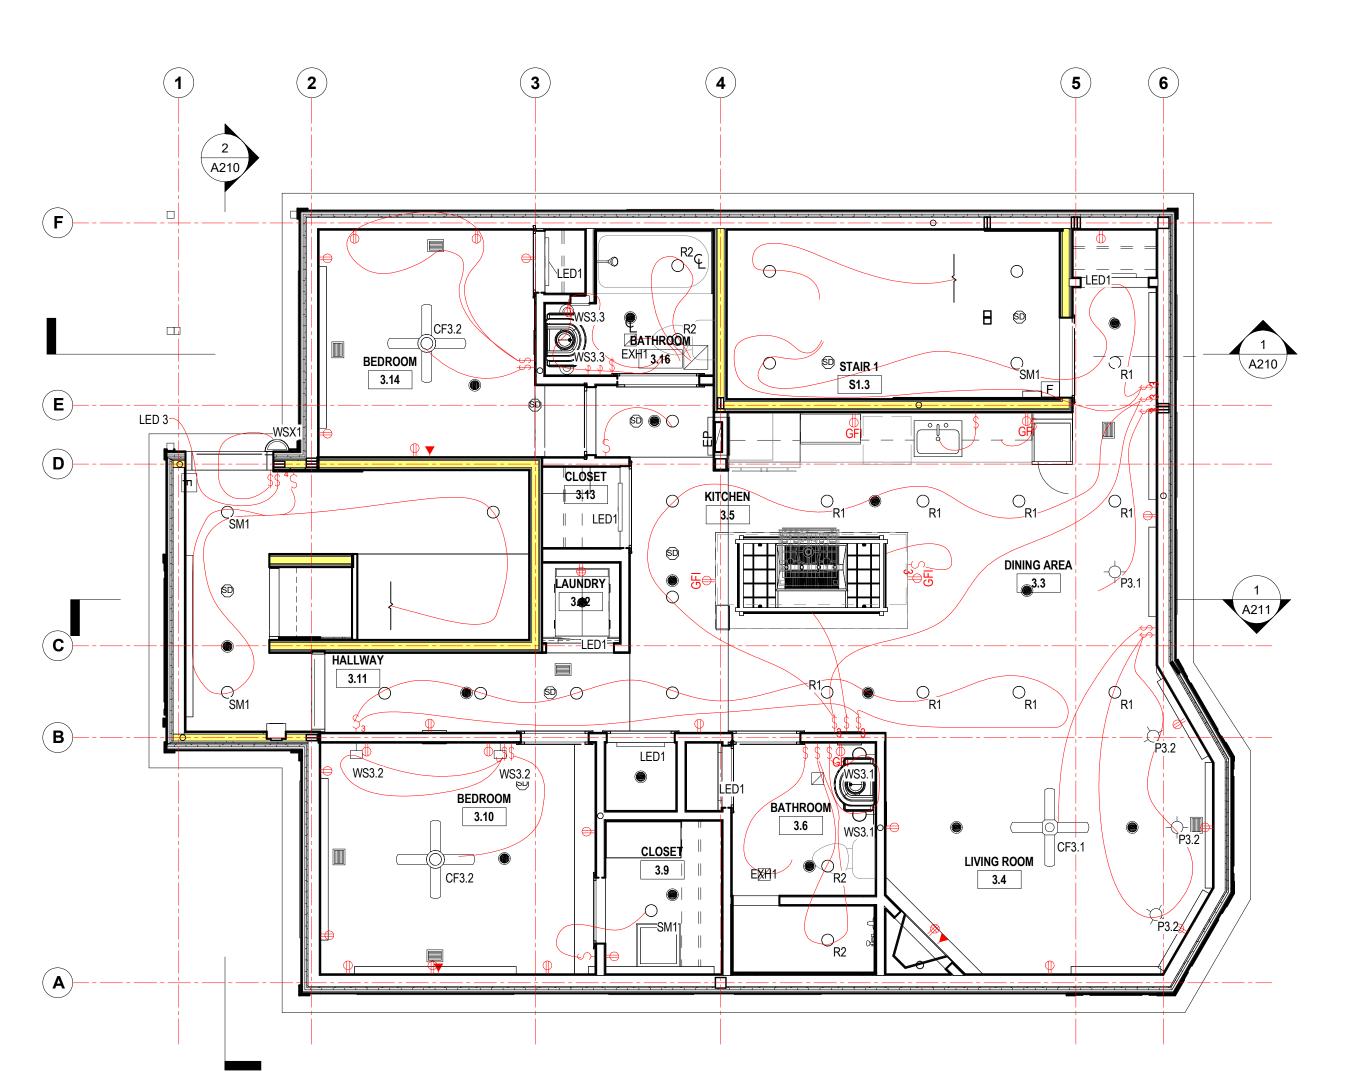

2 UNIT 3 ELECTRICAL LAYOUT


1/4" = 1'-0"

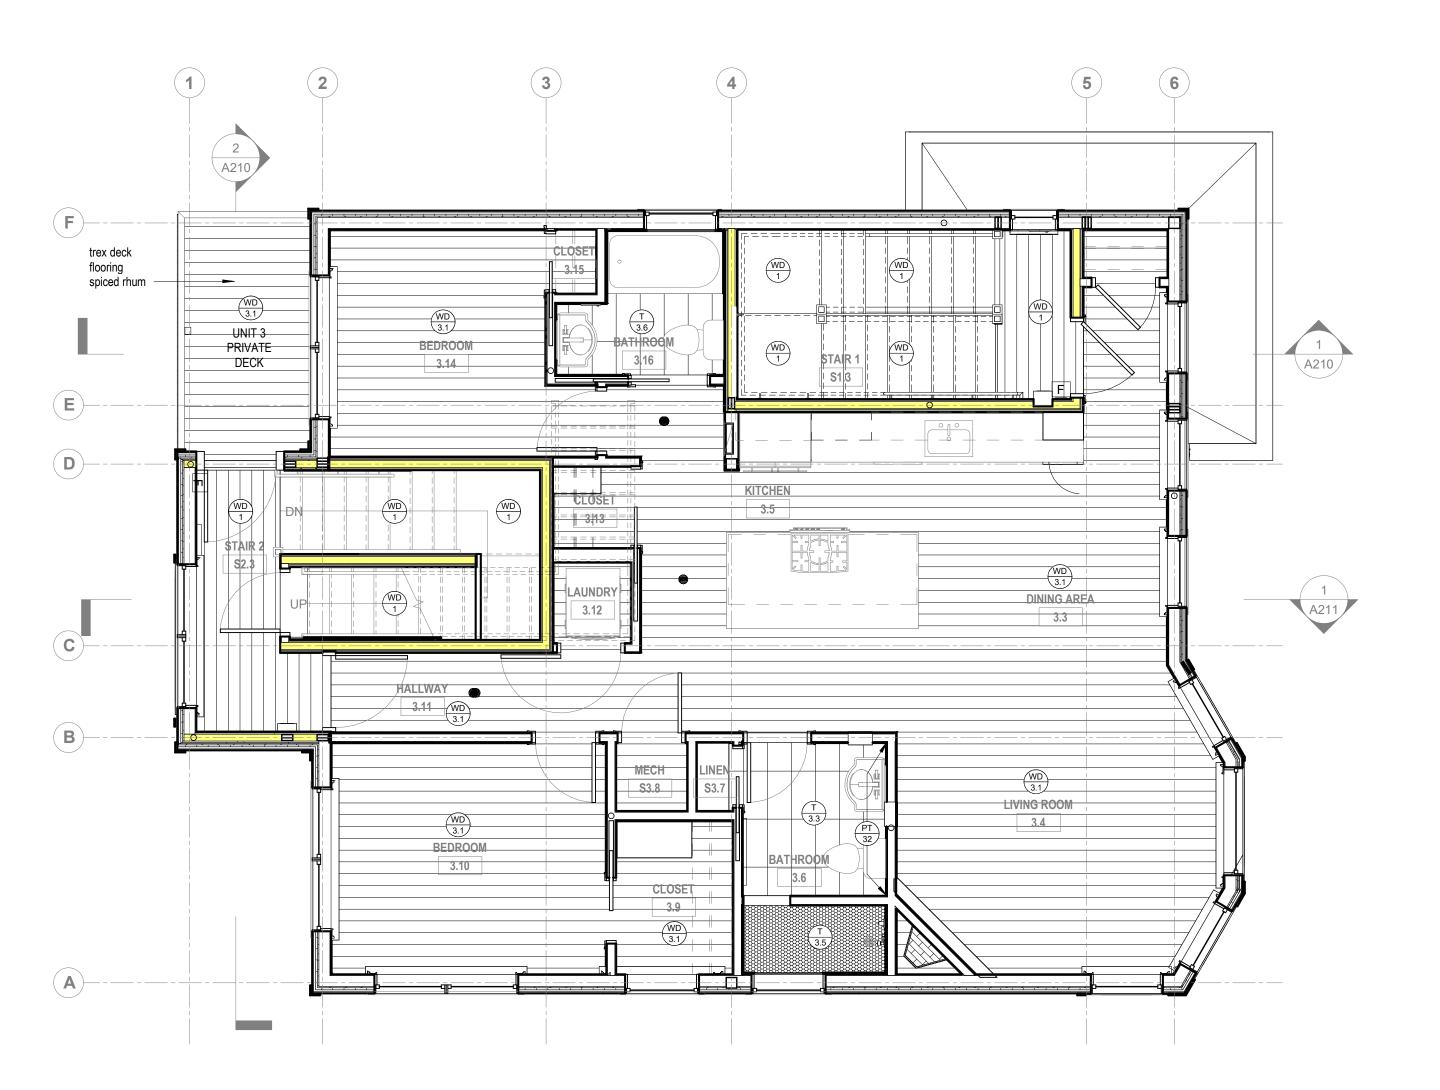

1 UNIT 3 FINISH PLAN
1/4" = 1'-0"




Electrical Fixture Legend

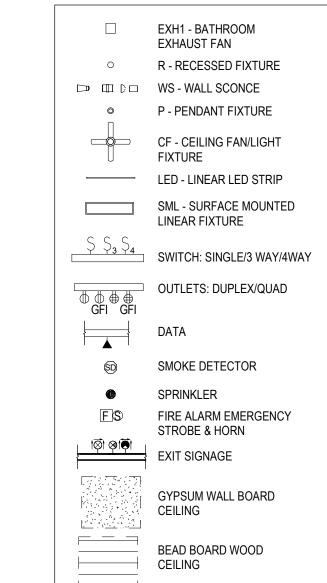



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revision	revision description	date
4	FOR PRICING	09/14/2017
5	FOR PRICING	09/20/2017
6	FOR PERMIT	09/27/2017
7	NOT FOR CONSTRUCTION	06/04/2018
8	FOR PERMIT/PRICING	07/13/2018
		1

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website www.joethearchitect.com

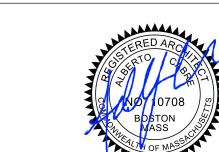
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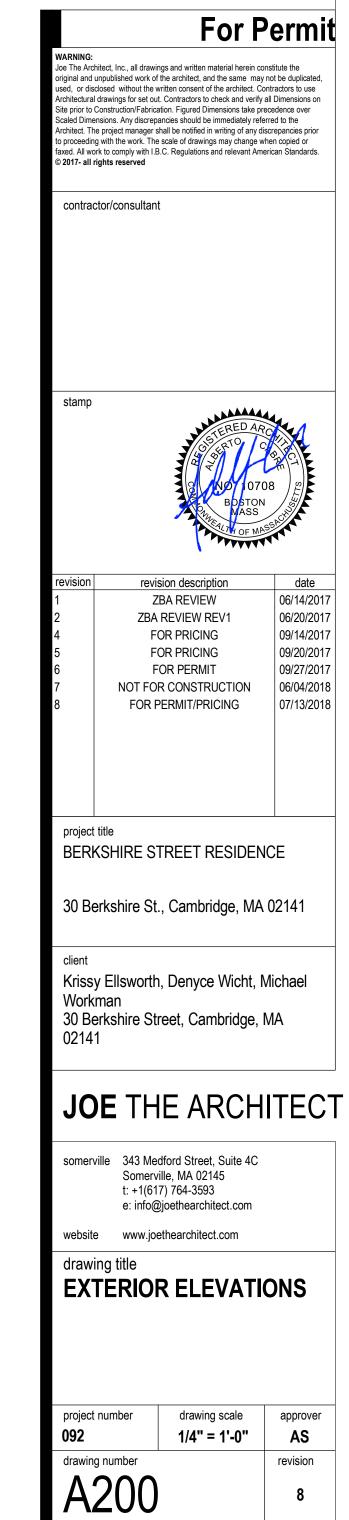
UNIT 3 ARCHITECTURAL ELECTRIC & FINISH PLANS


project number	drawing scale	approver
092	As indicated	AS
drawing number		revision
A133		8










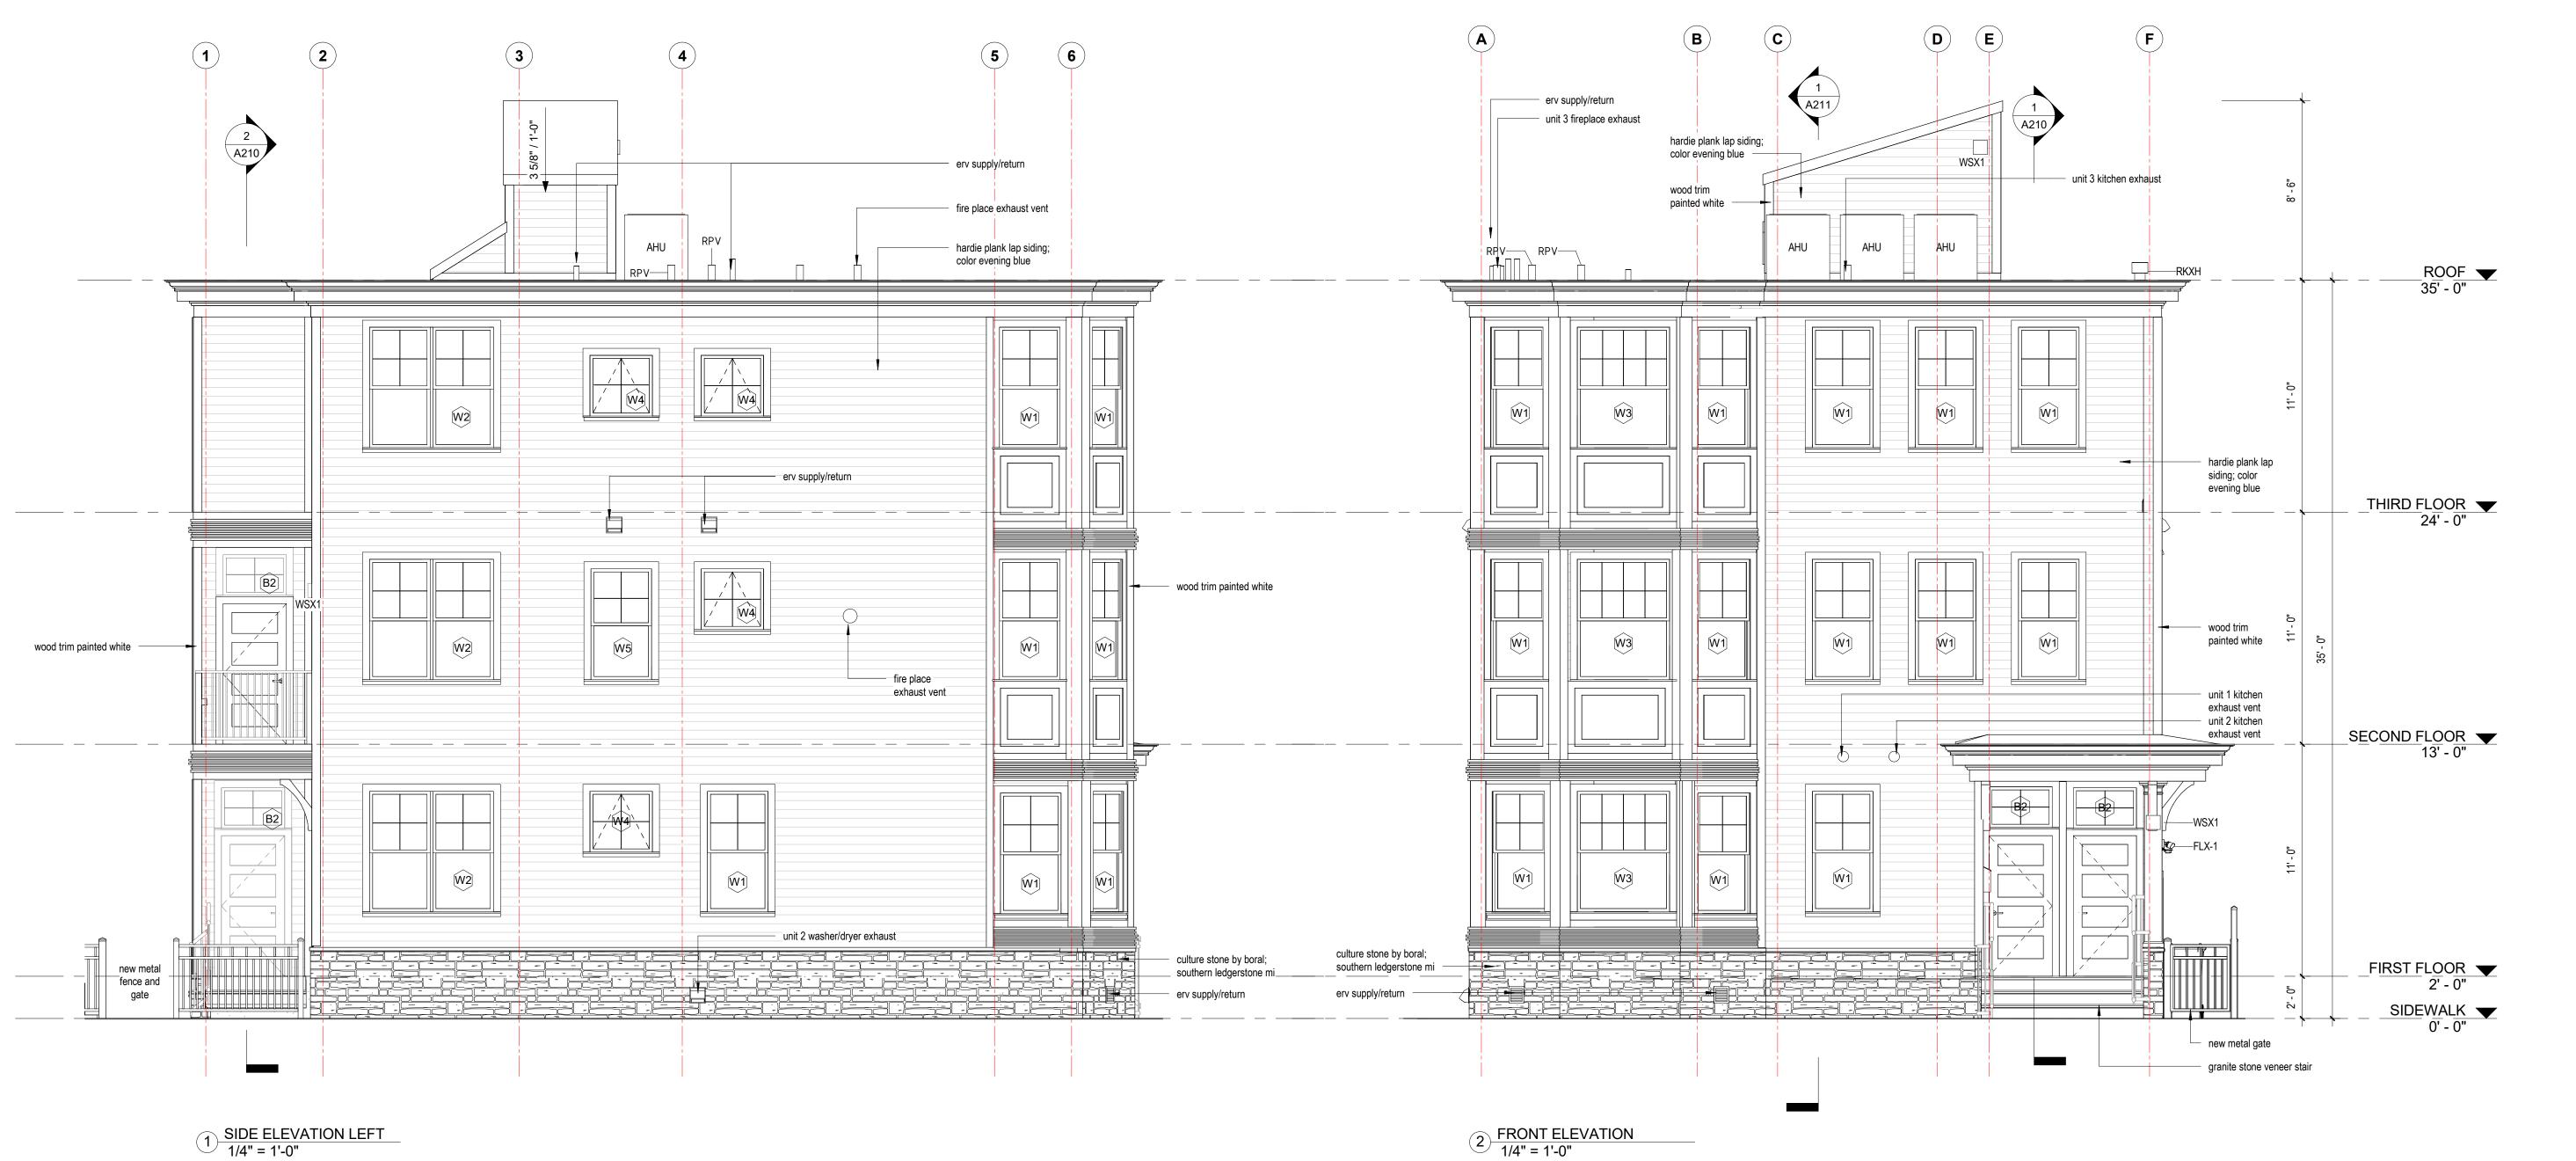


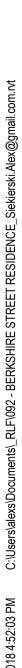

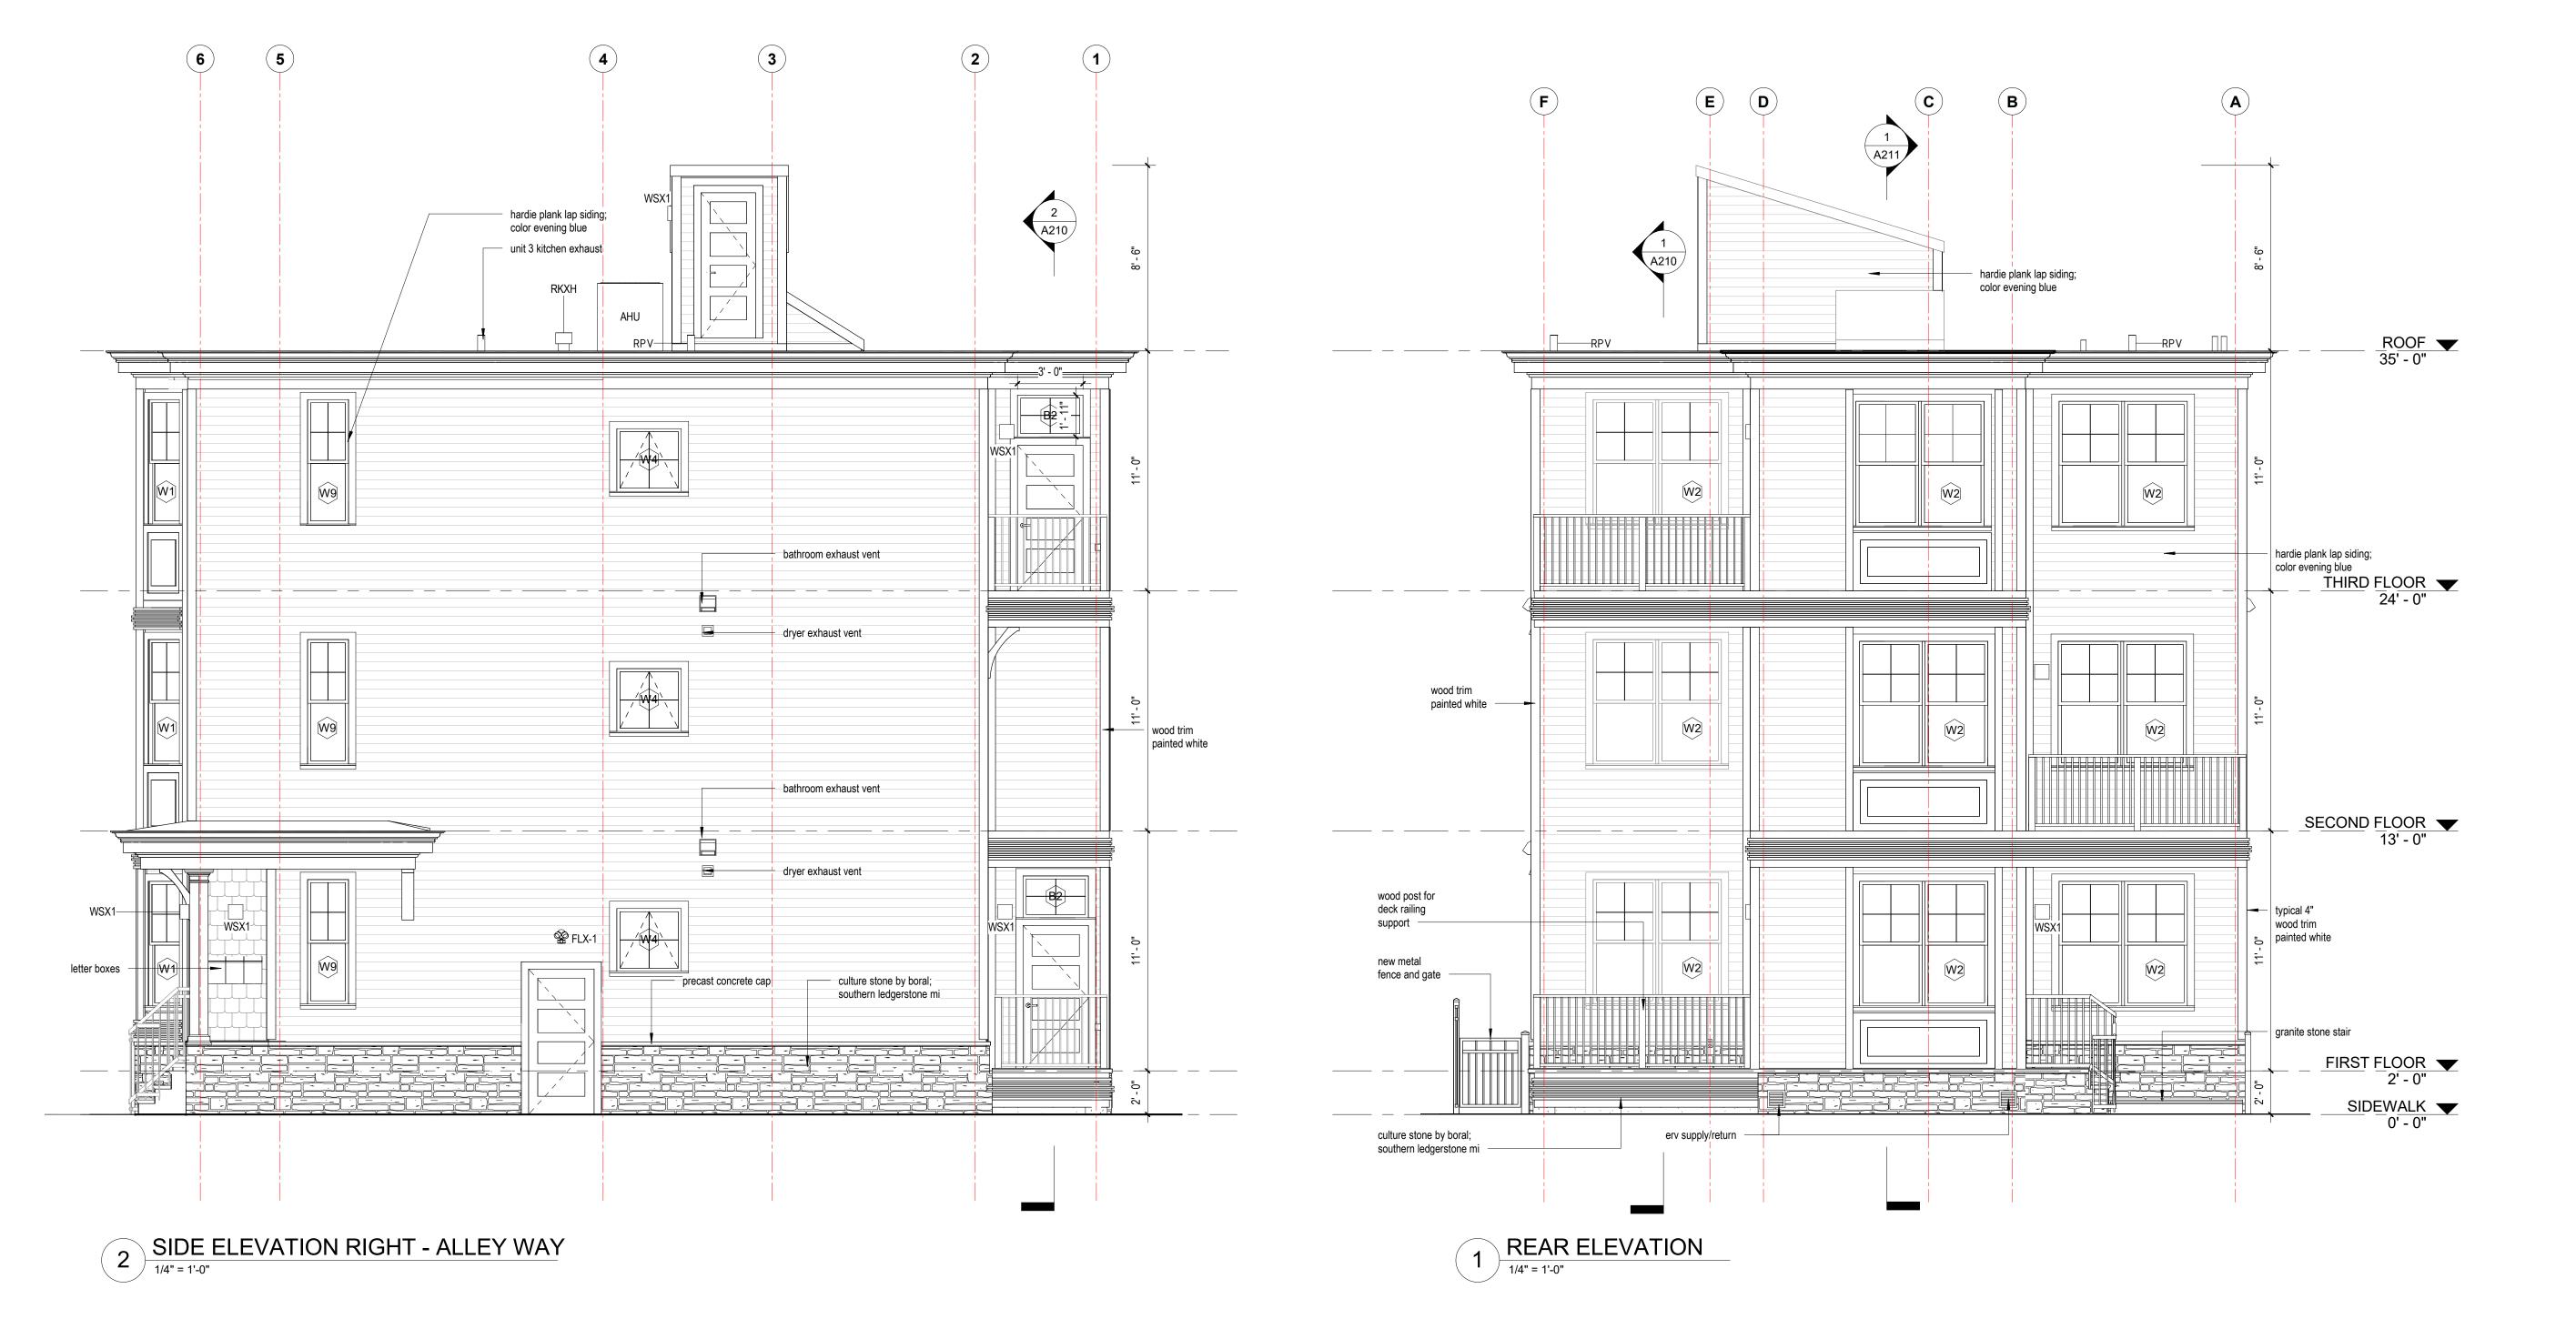

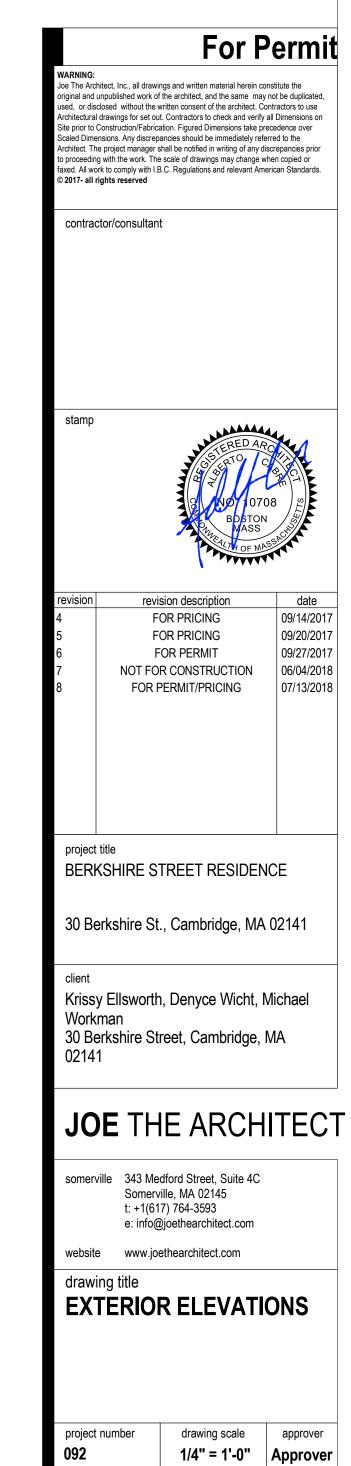


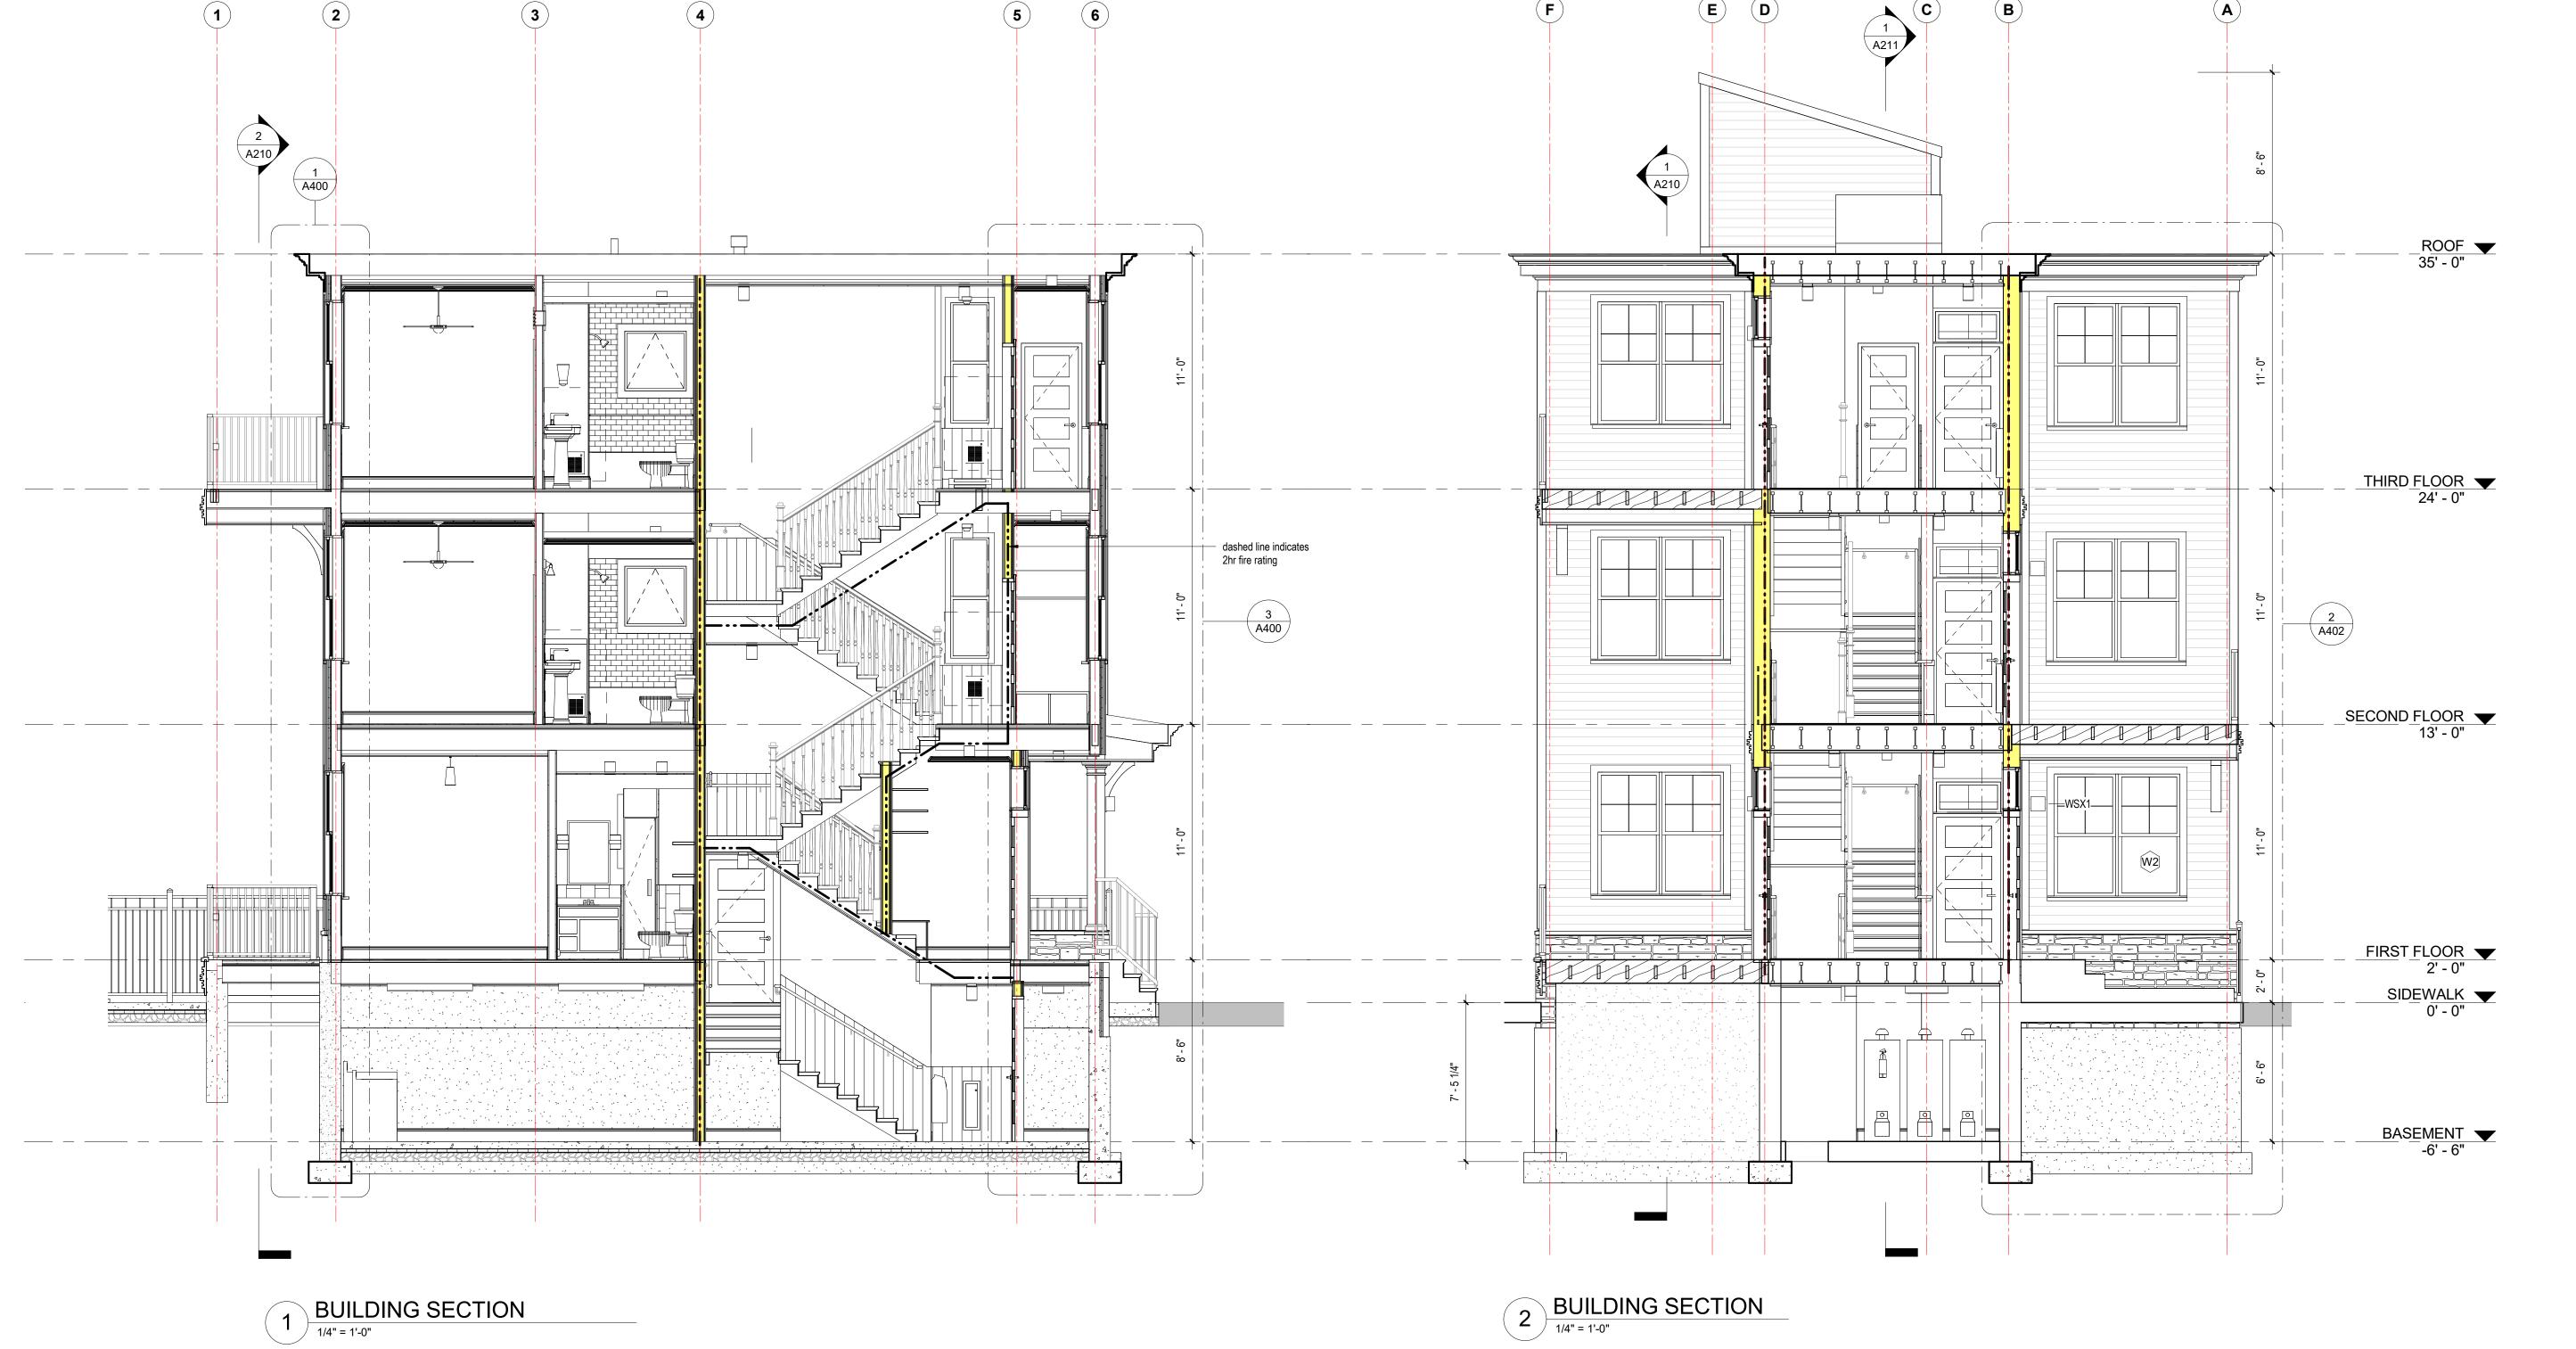


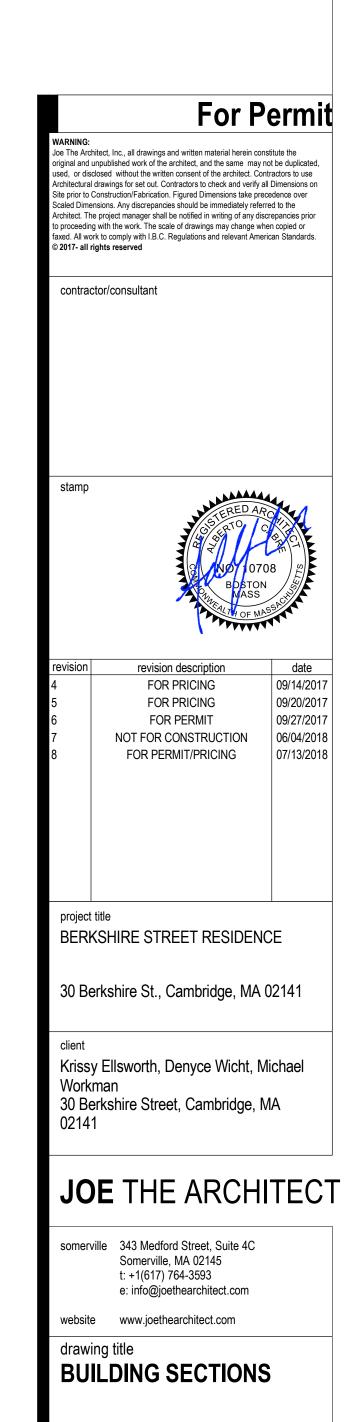

drawing scale approver

1/4" = 1'-0" Approver

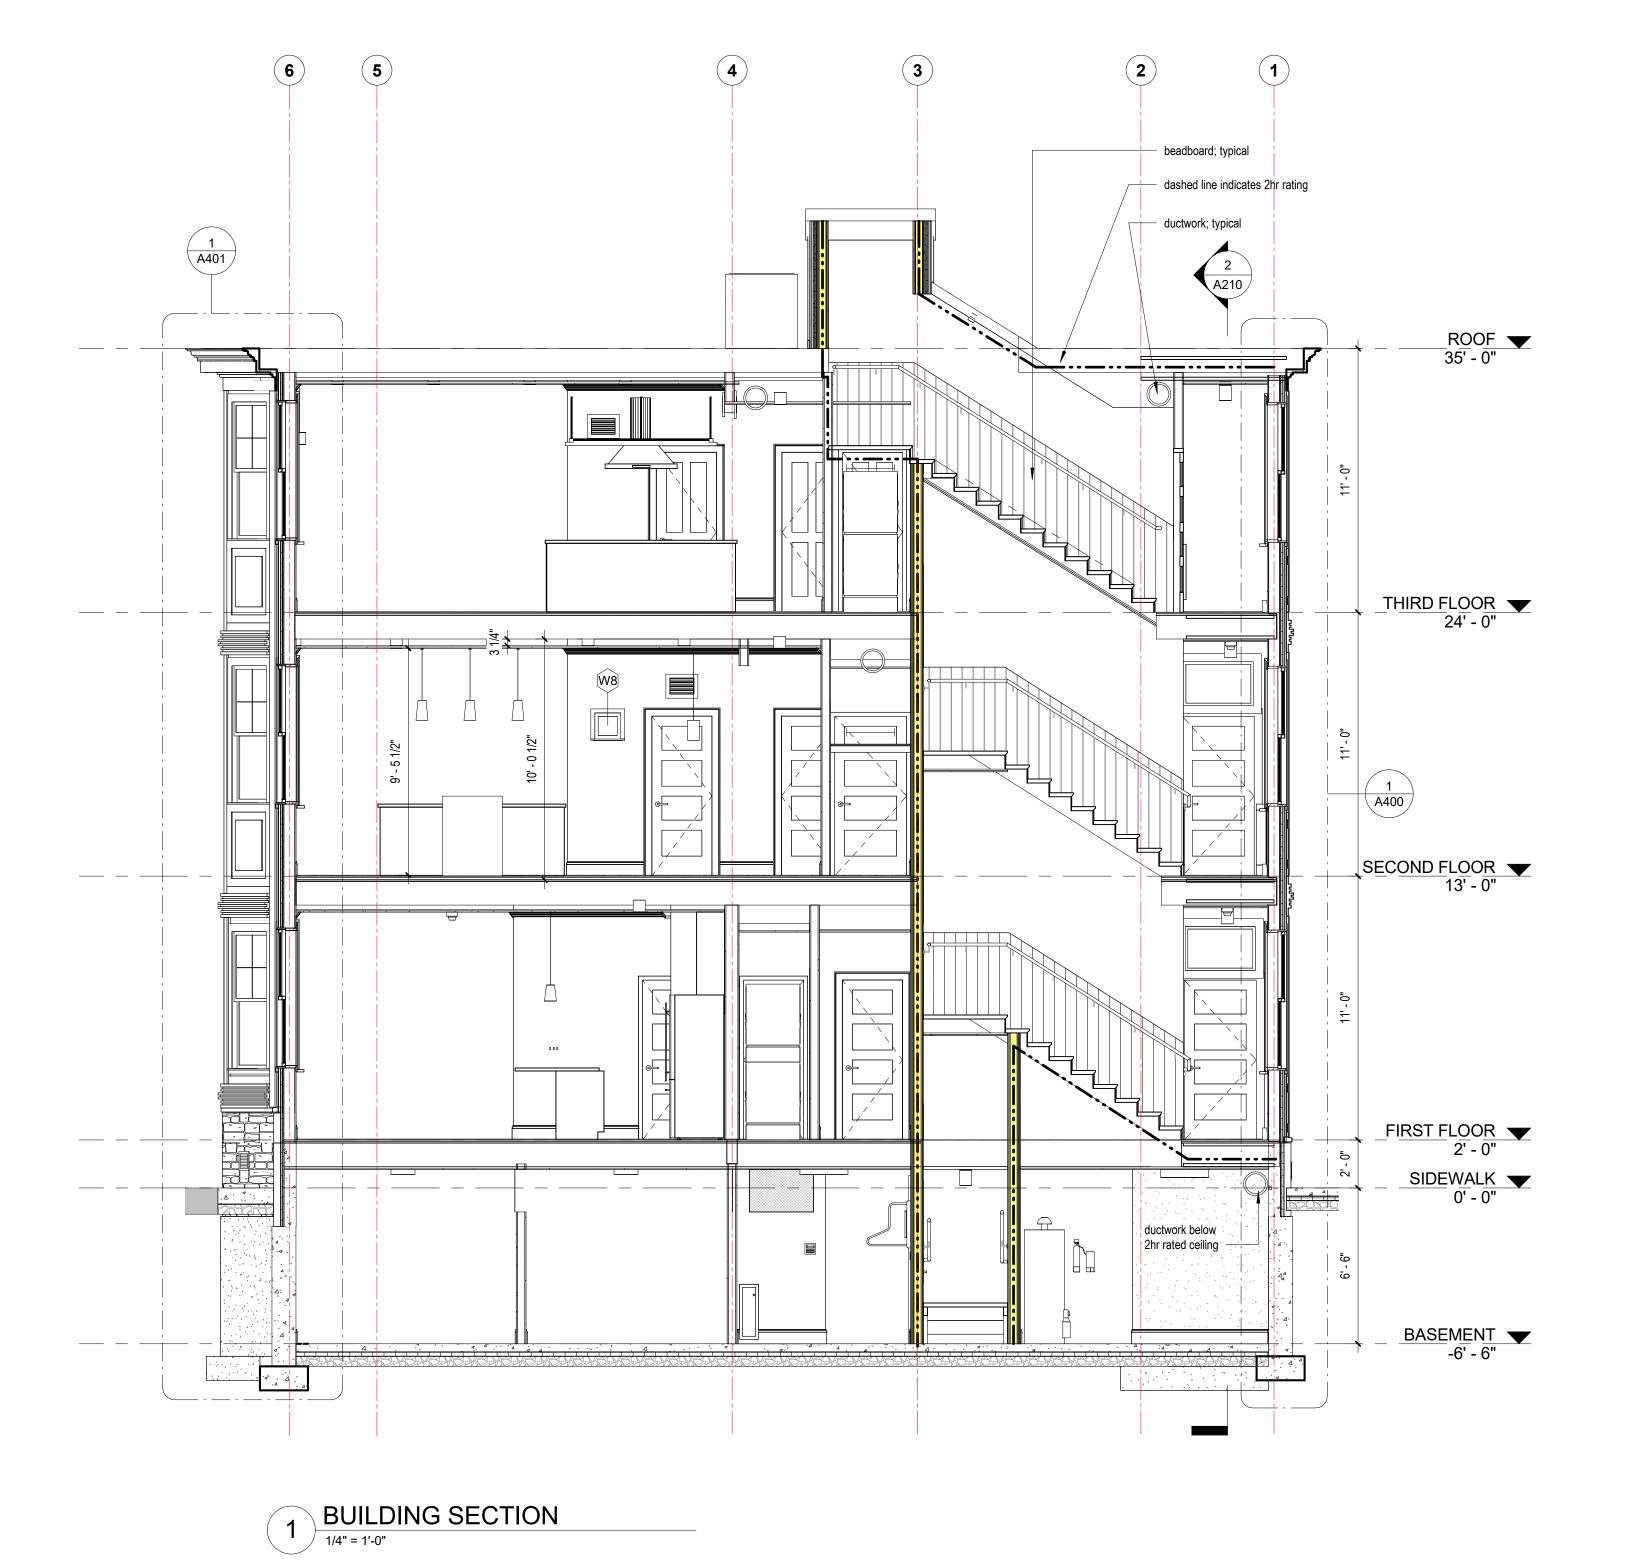

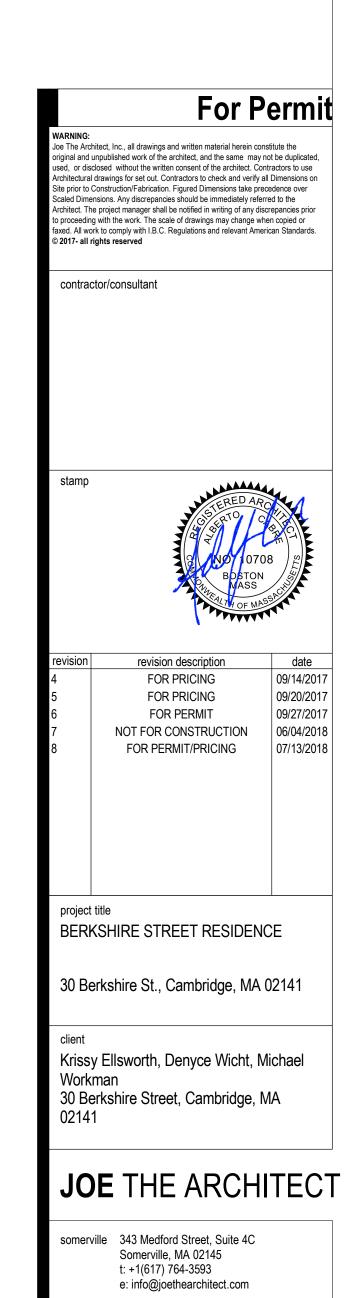


website www.joethearchitect.com


BUILDING SECTIONS

drawing scale approver 1/4" = 1'-0" Approver

drawing title



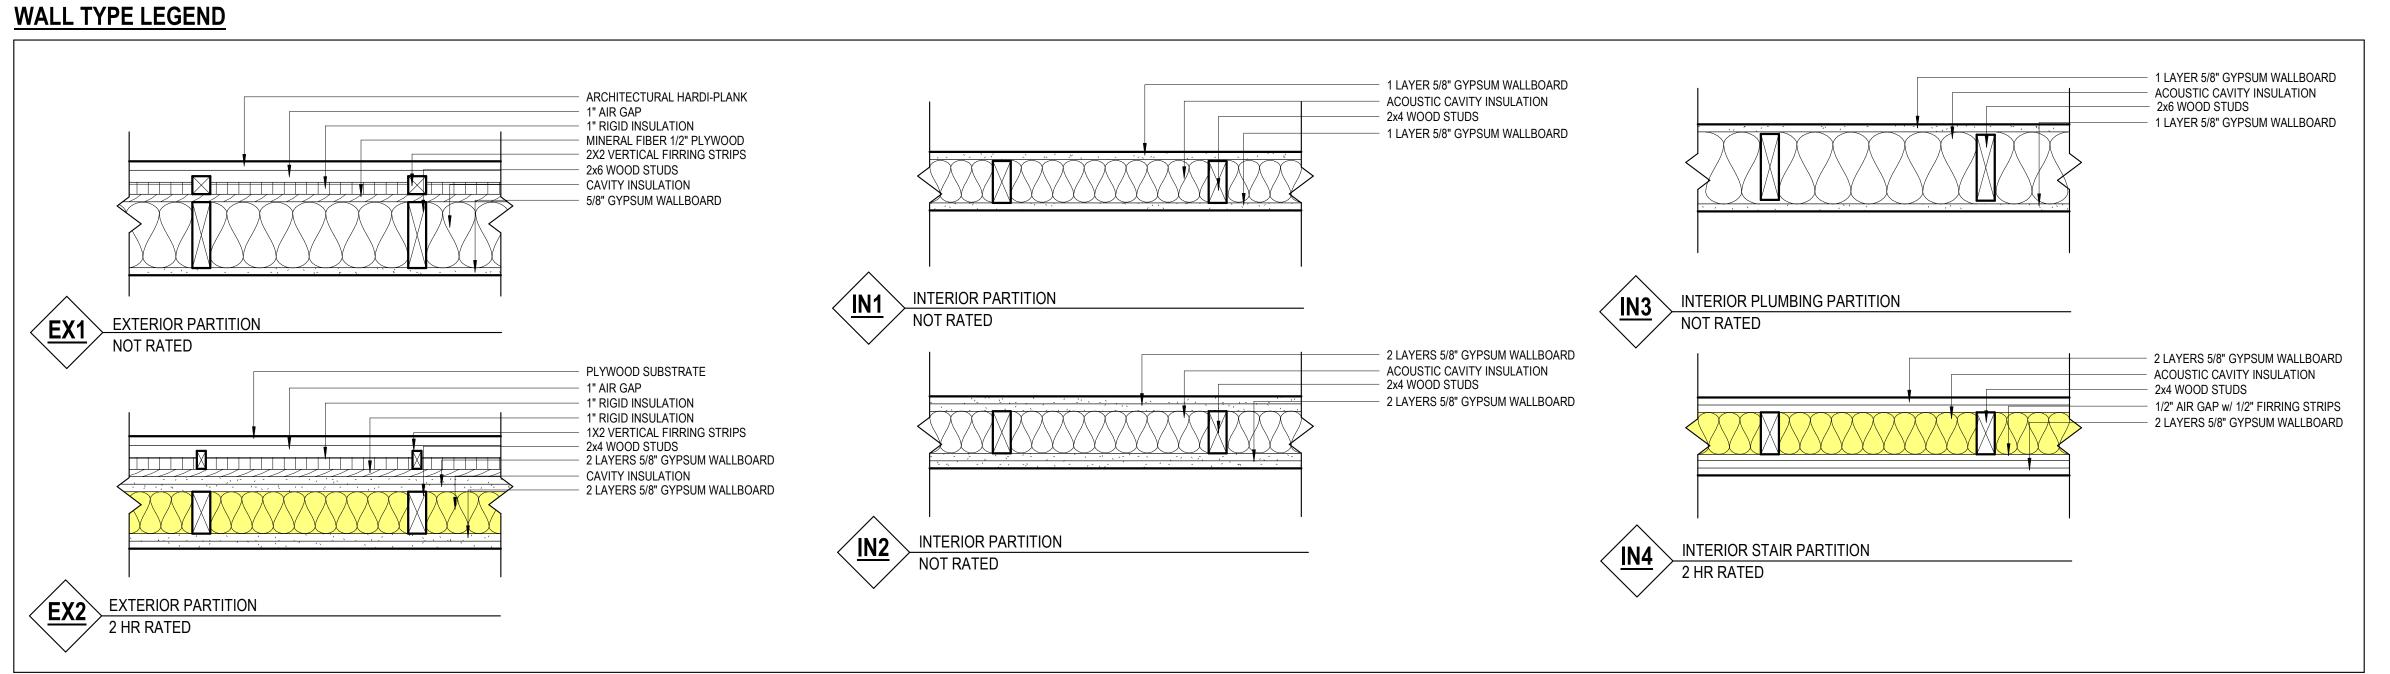

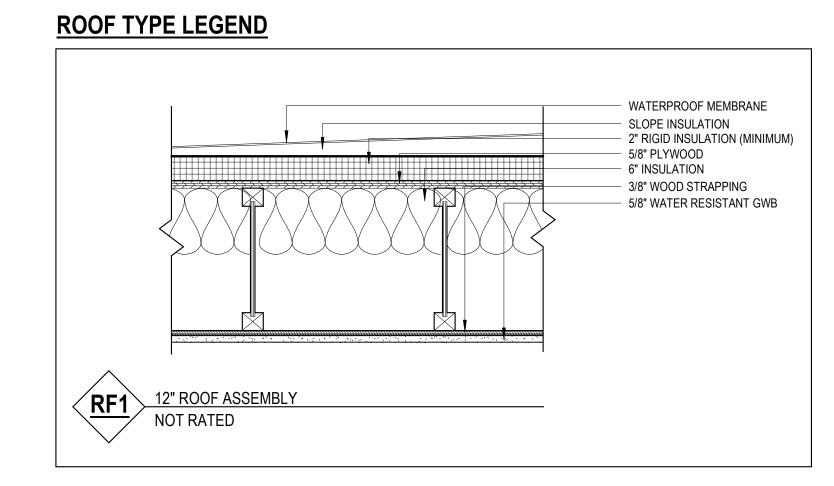

Window Notes

Unit 1 to have painted maple interior - black
 Unit 2 to have painted maple interior - white; W8 window type to be painted maple - white on both sides.
 Unit 3 to have painted maple interior - sandstone

WALL TYPE NOTES


See sheet A002 for abbreviations and typical mounting heights.

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stamp



evision	revision description	date
	FOR PRICING	09/14/2017
	FOR PRICING	09/20/2017
	FOR PERMIT	09/27/2017
	NOT FOR CONSTRUCTION	06/04/2018
	FOR PERMIT/PRICING	07/13/2018

project title
BERKSHIRE STREET RESIDENCE

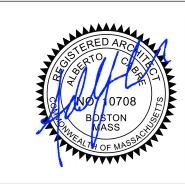30 Berkshire St., Cambridge, MA 02141

t

Krissy Ellsworth, Denyce Wicht, Michael Workman 30 Berkshire Street, Cambridge, MA

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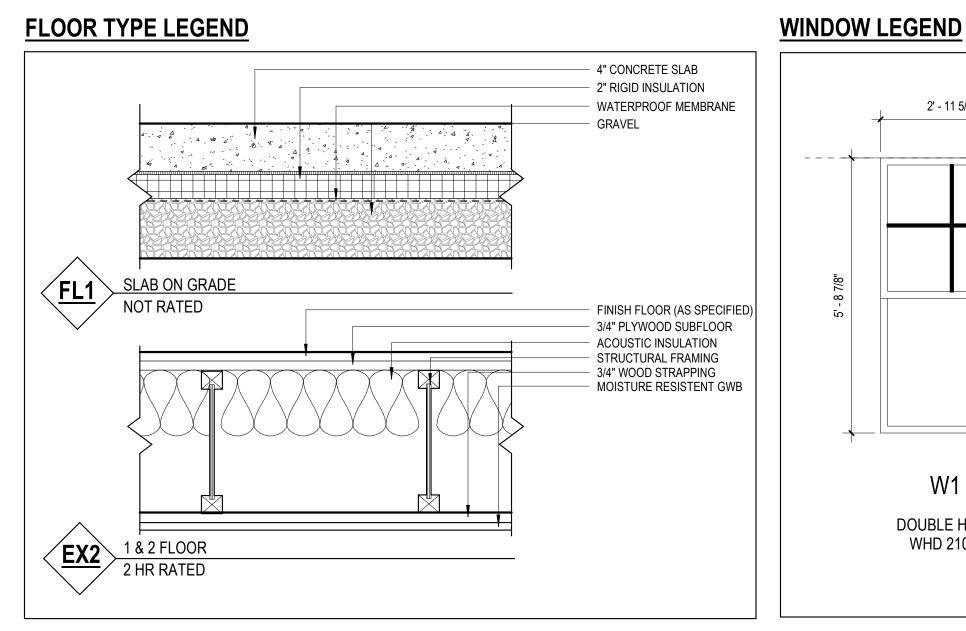
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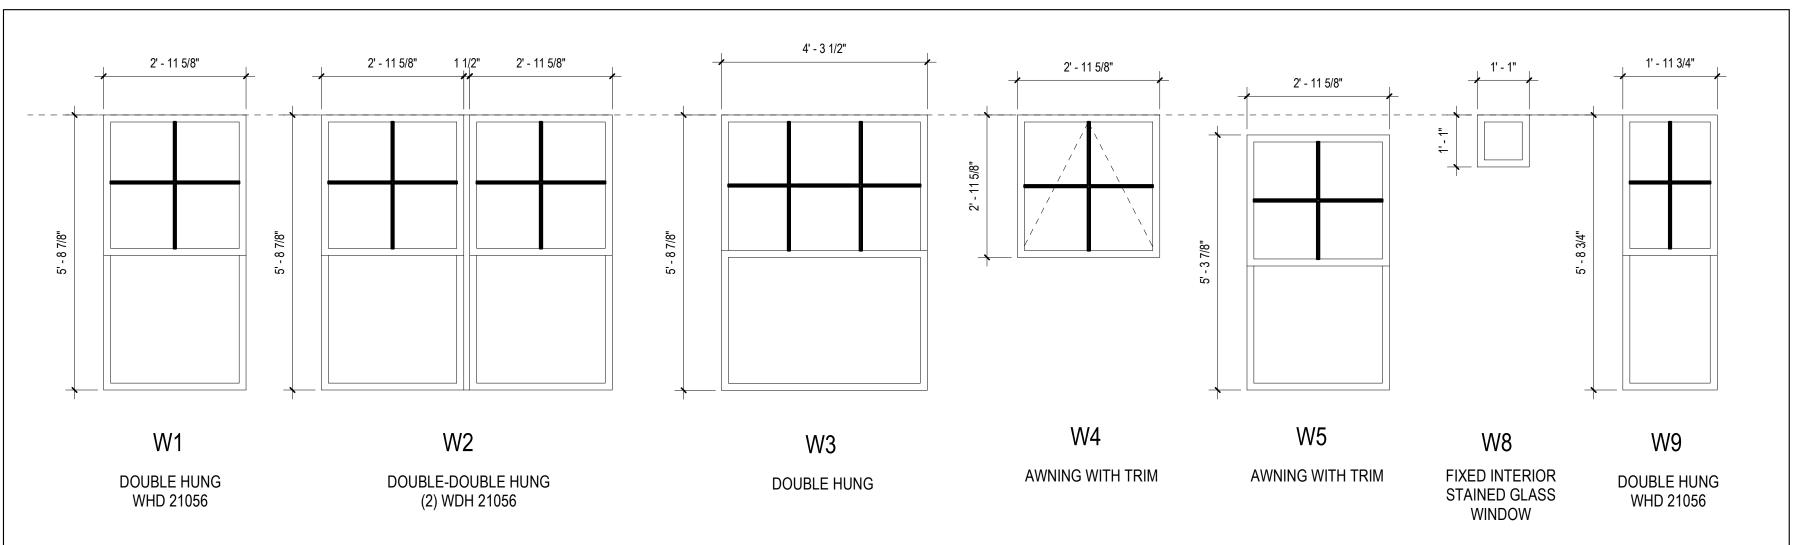
drawing title

WALL TYPE AND
WINDOW SCHEDULE
AND EQUIPMENT


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roject number	drawing scale	approver
92	As indicated	AS
rawing number	revision	
4300	8	





TYPE	SIZE					
MARK	WIDTH	HEIGHT	QUANTITY	TYPE	Manufacturer	Model
B2	3' - 1 1/2"	2' - 0 1/2"	6	35" x 24.5"	Andersen Corporation	400- Series
U	3' - 0"	2' - 0"	6	36" x 24"	Andersen Corporation	400- Series
W	2' - 6"	4' - 0"	1	30" x 48"	Andersen Corporation	400- Series
W1	3' - 0"	5' - 10"	17	36" x 70"	Andersen Corporation	400- Series
W2	6' - 0"	5' - 10"	12	72" x 70"	Andersen Corporation	400- Series
W3	4' - 6"	5' - 10"	3	54" x 70"	Andersen Corporation	400- Series
W4	3' - 1"	3' - 0"	7	37" x 36"	Andersen Corporation	400- Series
W5	3' - 0"	5' - 4 1/2"	1	36" x 65"		
W8	1' - 2 1/2"	1' - 2 1/2"	1	12" x 12"	Andersen Corporation	400- Series
W9	2' - 0"	5' - 10"	3	24" x 70"	Andersen Corporation	400- Series
W14	1' - 0"	0' - 8"	10	REGISTER 8X12	Andersen Corporation	400- Series
W15	3' - 1 1/2"	1' - 6 1/2"	3	32" x 18" 2" Trim		

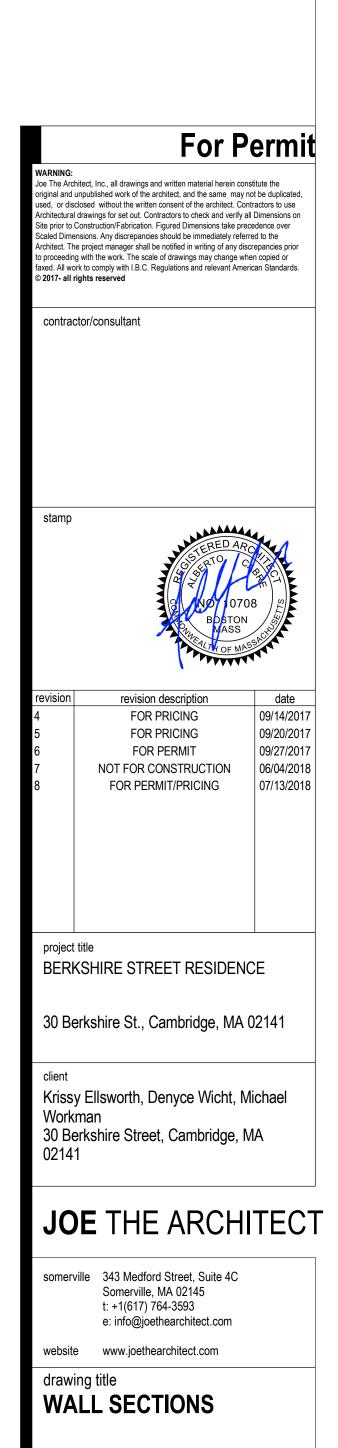

drawing scale

3/8" = 1'-0"


drawing number

A400


drawing title

WALL SECTIONS

3/8" = 1'-0" drawing number A401

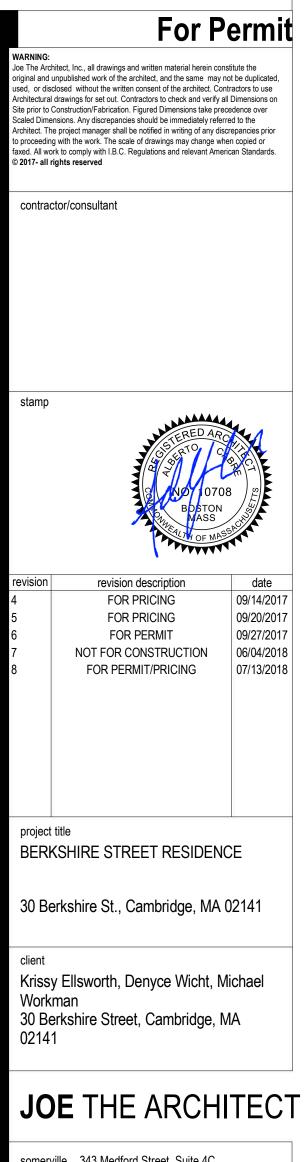



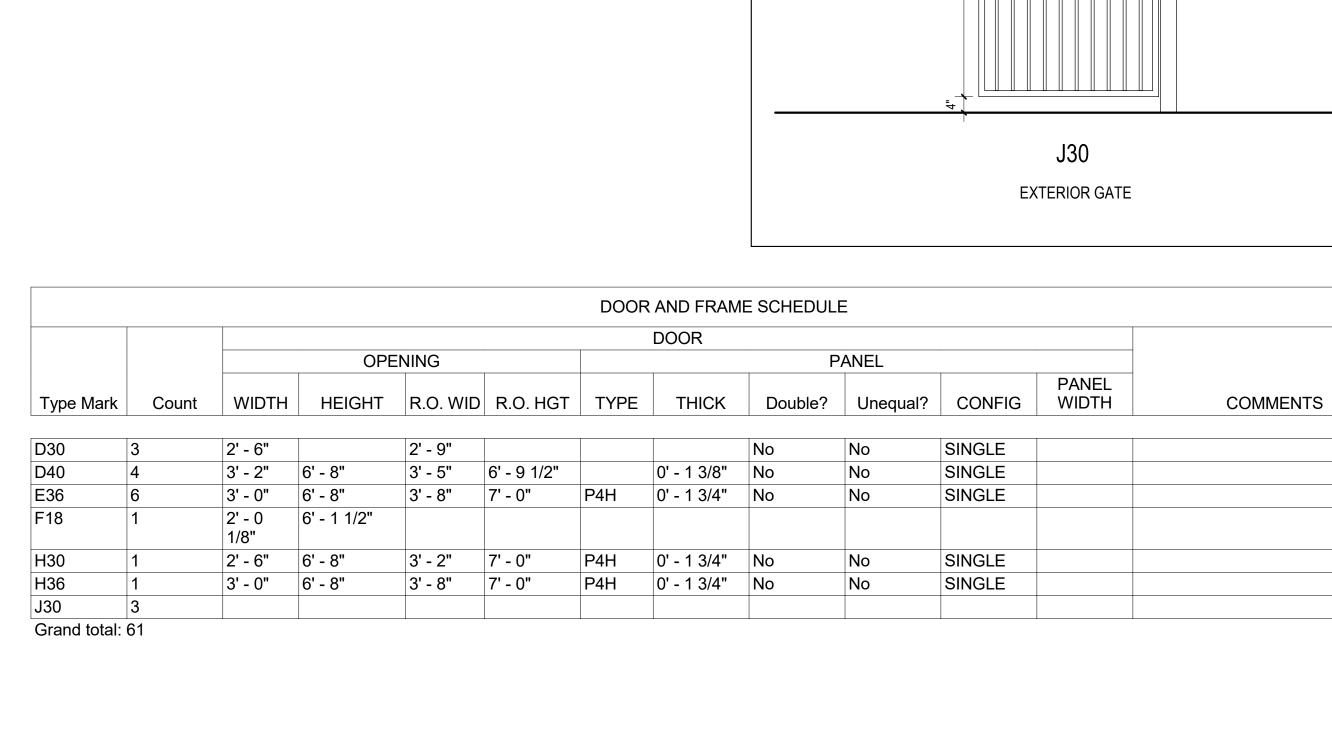



3rd floor door panels to be 4 panels vertical
 Unit 1 door hardware to be Schlage Latitude series; matte black lever harware.

harware.
3. Unit 2 door hardware to match kitchen hardware; oil-rubbed bronze.
4. Unit 2 entry doors to match knobs pull style and finish from common area

5. Unit 3 door hardware TBD.

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revision	revision description	date
4	FOR PRICING	09/14/201
5	FOR PRICING	09/20/201
6	FOR PERMIT	09/27/201
7	NOT FOR CONSTRUCTION	06/04/201
8	FOR PERMIT/PRICING	07/13/201

project title
BERKSHIRE STREET RESIDENCE

30 Berkshire St., Cambridge, MA 02141

nt esy Elleworth Dor

Krissy Ellsworth, Denyce Wicht, Michael Workman 30 Berkshire Street, Cambridge, MA 02141

JOE THE ARCHITECT

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rawing title

DOOR LEGEND

project number	drawing scale	approver
092	As indicated	AS
drawing number		revision
A430		8

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PANEL WIDTH COMMENTS WIDTH | HEIGHT | R.O. WID | R.O. HGT | TYPE Double? Unequal? CONFIG THICK SINGLE 1' - 4" | 6' - 8" 0' - 1 3/4" No SINGLE 0' - 1 3/4" No 2' - 6" 6' - 8" 2' - 10" | 6' - 10" 0' - 1 3/4" No SINGLE SINGLE 3' - 0" 6' - 8" 0' - 1 3/4" No 3' - 0" 6' - 8" SINGLE 0' - 1 3/4" No 4' - 0" 6' - 8" PAIR 4' - 4" 6' - 10" 0' - 1 9/16" Yes B30 SINGLE 2' - 6" 6' - 8" 2' - 10" 6' - 10" 0' - 1 3/4" No 3' - 0" 6' - 8" 3' - 4" 6' - 10" P4H 0' - 1 3/4" No SINGLE 0' - 1 9/16" Yes PAIR 6' - 0" 6' - 8" 6' - 9 9/16" P4H 5/32" 2' - 0" 6' - 8" 2' - 3" | 6' - 9 1/2" | P4H 0' - 1 3/8" No SINGLE 2' - 7" 6' - 9 1/2" P4V 0' - 1 3/8" No SINGLE 2' - 4" 6' - 8"

DOOR AND FRAME SCHEDULE

PANEL

DOOR

OPENING

Tues Mark	Manufacturer	Model	Description
Type Mark	Manufacturer	Model	Description
FX1-1	Bosch	SHXM98W75N	800 Series – Stainless Steel 24" Bar Handle Dishwasher
-X1-2A	Frigidaire	FPUR2919-D10	Frigidaire Undermount Stainles Stel Kitchen Sink, 10m Radius Corners, 16 Gauge, Dep Basin, 27"
-X1-2B	Delta	9159-BL-DST	Trinsic Single Handle Pull-Down Kitchen Faucet; Matte Black
=X1-3	Bosch	HGI8054UC	800 Series – Stainless Steel 30" Gas Slide-in Range
-X1-4	Bosch	B21CT80SNS	800 Series – Stainless Steel 36" Counter-Depth 3-Door Refrigerator
-X1-5	Moen	MT3293	ALIGN™ MOENTROL® Single-Handle Tub/Shower Trim Only
-X1-6G	ТОТО	cst744sl#01	Drake 2 Piece 1.6GPF Single Flush Elongated Toilet in Cotton White
X1-6M	ТОТО	cst744sl#01	Drake 2 Piece 1.6GPF Single Flush Elongated Toilet in Cotton White
X1-7A	Delta	T17259-SSLHD	Trinsic Bathroom 17 Series MC Shower Trim
X1-7B	Universal	58480-PK	Showering Components Shower Faucet with H2okinetic Technology
-X1-8A	Delta	559HA-DST	Trinsic Bathroom Single hole Bathroom Faucet with Drain Assembly and Diamond Seal Technology
X1-8B	Neuman	EBDG7757	36" Single Bathroom Vanity Set with Mirror
-X1-9A	New Yorker	KBCL1066	36" Single Bathroom Vanity Set
X1-9B	Trinsic	3559-MPU-DST	Bathroom Widespread Bathroom Faucet with Drain Assembly and Diamond Seal Technology
X1-10	American Standard	2461.028W	Cambridge 5ft. Left Drain Bathtub in White
X1-11	Electrolux	EFLS627U TT / IW	Electrolux FRONT LOAD WASHERS EFLS627U TT / IW
X1-12	Electrolux	EFME627U TT / IW	Electrolux ELECTRIC FRONT LOAD DRYER EFME627U TT / IW
X1-12 X1-13	Bosch	HMVP053U	Benchmark Series – Stainless Steel 30" Over The Range Convection Microwave
-X1-13 -X2-1	Kenmore	70343	Kenmore 70343 27.2 cu. ft. French Door Refrigerator - Stainless Steel
X2-1 X2-2	Kenmore	14753	Kenmore Elite 14753 24" Built-In Dishwasher - Stainless Steel
		11722-1	Under-mount Kitchen Sink
FX2-3A FX2-3B	Sterling		
FX2-3B	Konmoro	K-99262	Artifacts Kitchen Sink Faucet Swing Spout w/Spray Kenmere 32603 4.5 cu. ft. Slide In Cas Bange, Steinless Steel
FX2-4	Kenmore	32603	Kenmore 32603 4.5 cu. ft. Slide-In Gas Range - Stainless Steel
X2-4A	Thermador	UCVM30RS	30 Inch Downdraft Ventilation Masterpiece Series
X2-5A	Fairmont	1504-V30	Smithfeild 30" Vanity Med Grey
-X2-5B	Kohler	K-10577-4P	Bancroft Widespread Bathroom Sink Faucet
-X2-5C	Fairmont	T-3122	3/4" Marble/Granite Top
X2-6G	Kohler	K-6925	Adair Class Five Toilet
-X2-6M	Kohler	K-3639	Kohler Archer Toilet
FX2-7A	Kohler	K-72421	Awaken B110 Multifunction Handshower
FX2-7B	Kohler	T10595-4P-CP	Bancraft Trans Valve Trim White Cermatic Level Handel
FX2-8	Kohler	K-2362-8	Cimarron Pedestal Bathroom Sink
-X2-9	Kohler	K-716	Villager 5' Bath
X2-10	Kohler	K-TS461-4V	Memoirs Stately Rite-Temp Bath and Shower Valve Trim
FX2-11	Chaska	CSK-29-L	Chaska 29-Log Direcct Vent Gas Fireplace Insert
X2-12	Kenmore	41262	Front-Load Washer - White
FX2-13	Kenmore	81282	Kenmore Electric Dryer - White
X2-14	TBD	TBD	TBD
X2-15	Kenmore	80333	Kenmore 80333 1.7 cu. ft. Over-the-Range Microwave - Stainless Steel
-X2-16	Kohler	K-454-4V	Memoirs Stately Widespread Bathroom Sink Faucet
X2-17	Fairmont	1504-MC24	Smithfield 24" Medicine Cabinet
X2-18	Kohler	K-11411	Bancroft 24" Towel Bar
X2-19	Kohler	K-11415	Bancroft Toilet Tissue Holder
X2-20	Kohler	10555	Devonshire Robe Hook
X2-21	TBD	TBD	Towel Ring
X2-22	TBD	TBD	Towel Ring
X2-23	Kohler	K-490	Memoirs Stately Toilet Tissue Holder
X3-1	Kalamera	KRC-46DZB-TGD	Wine refrigerator 46 Bottle Dual Zone Built-in and Freestanding
X3-2A	Franke	PTX110-25	Pescar Kitchen Sink
X3-2B	Delta	9159-AR-DST	Trinsic Single Handle Pull-Down Kitchen Faucet
X3-2B X3-3	Bosch	SHS5AV55UC	Ascenta Scoop Handle Dishwasher
X3-4	Bosch	B21CL80SNS	800 Series Counter-Depth 4-Door Refrigerator
-X3-4 -X3-5	Bosch	HGI8054UC	800 Series Gas Slide-in Range
-x3-5 -x3-6	Chaska	CSK-29-L	Chaska 29-Log Direcct Vent Gas Fireplace Insert
-x3-0 -x3-7A	Mirabelle	MIRBR8010BN	BOCA RATON COLLECTION
			TRANSFER VALVE TRIM KIT
X3-7B	Mirabelle	MIRHS4020ECP	CUSTOM SHOWERING 5 FUNCTION HANDSHOWER
-X3-8G	American Standard	207AA.104	Estate Vormax Right Height Elongated Toilet; White
-X3-8M	American Standard	207AA.104	Estate Vormax Right Height Elongated Toilet; White
-X3-9A	American Standard	0282.008	"Retrospect" Pedestal Bathroom Sink WHITE 8" CC
-X3-9B	Mirabelle	MIRWSCBR801CP	Bcoa Raton Bathroom Sink Faucet; Polished Chrome
-X3-10A	LG	WM3770H_A	4.5 cu.ft. Front Load Washer w/ TurboWash
-X3-10B	LG	DLEX3370_/DLGX3371_	Ultra Large Capacity SteamDryer™ w/ NFC Tag On
-X3-11A	American Standard	0282.008	Estate Vormax Right Height Elongated Toilet; White
-X3-11B	Mirabelle	MIRWSCBR801CP	Bcoa Raton Bathroom Sink Faucet; Polished Chrome
70 110			· · · · · · · · · · · · · · · · · · ·
FX3-12	American Standard	2460.028W	Cambridge 5' Whirlpool and Bathing Pool

Multi-Category Schedule

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For Permit

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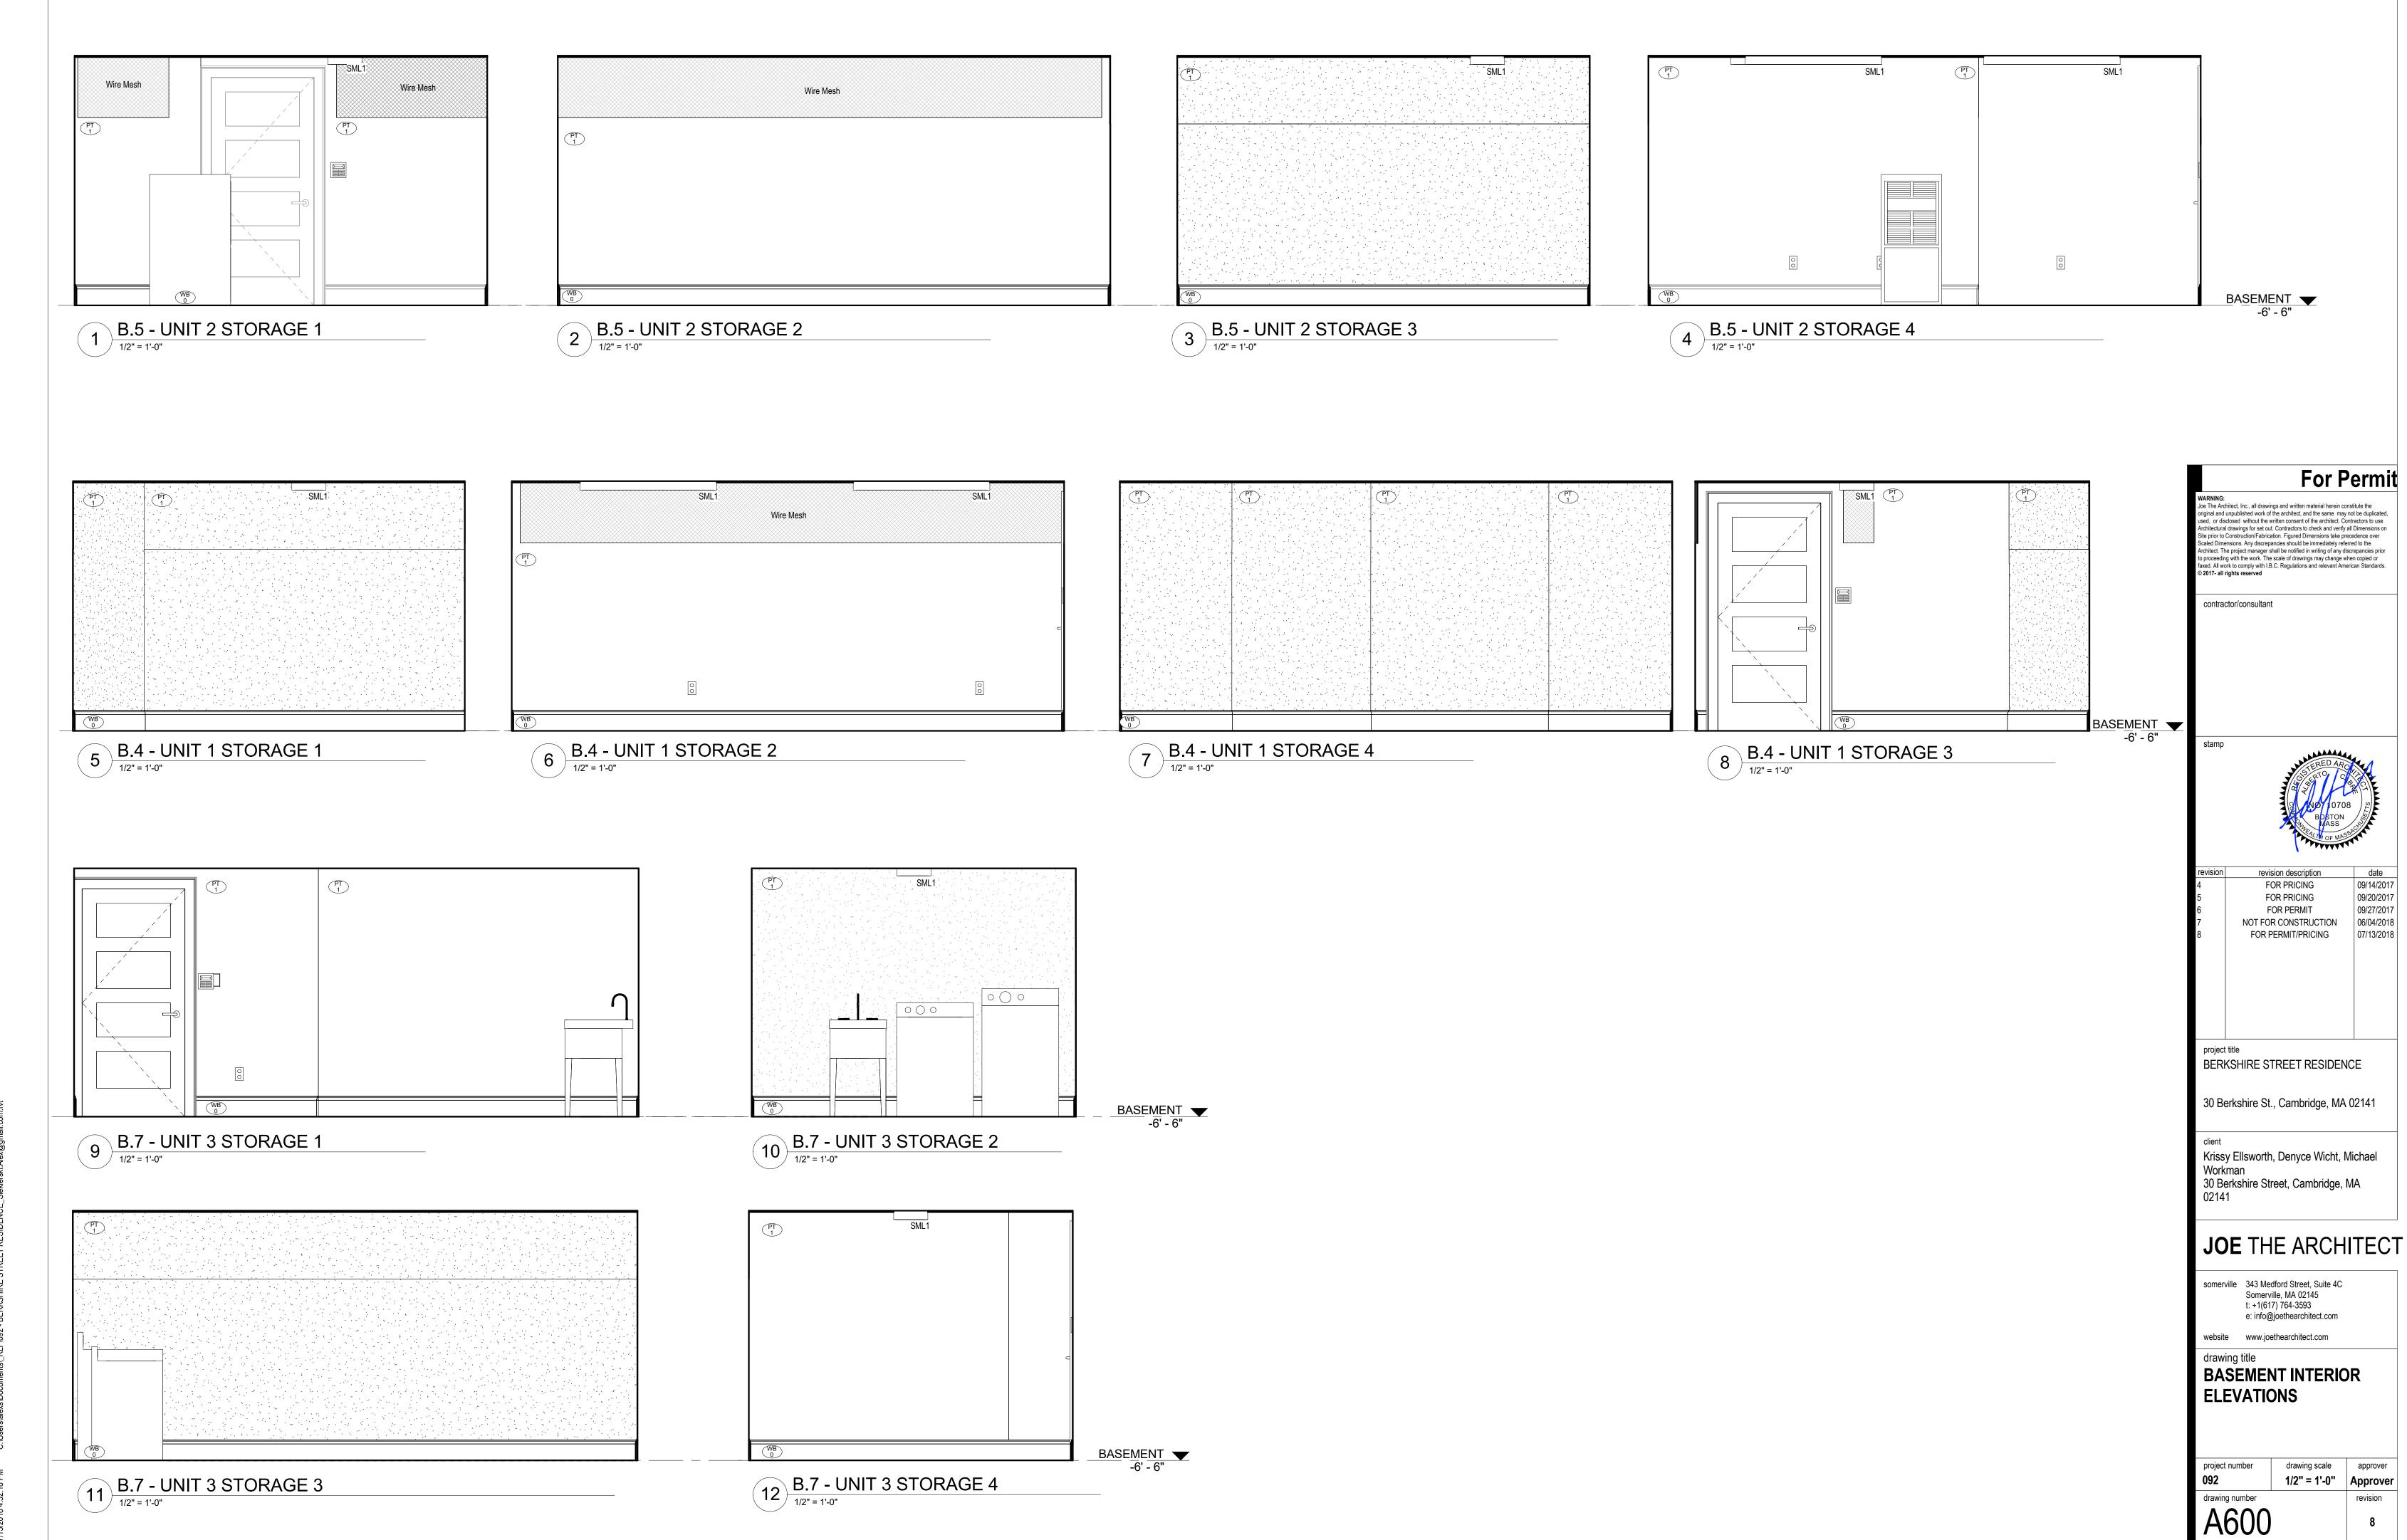
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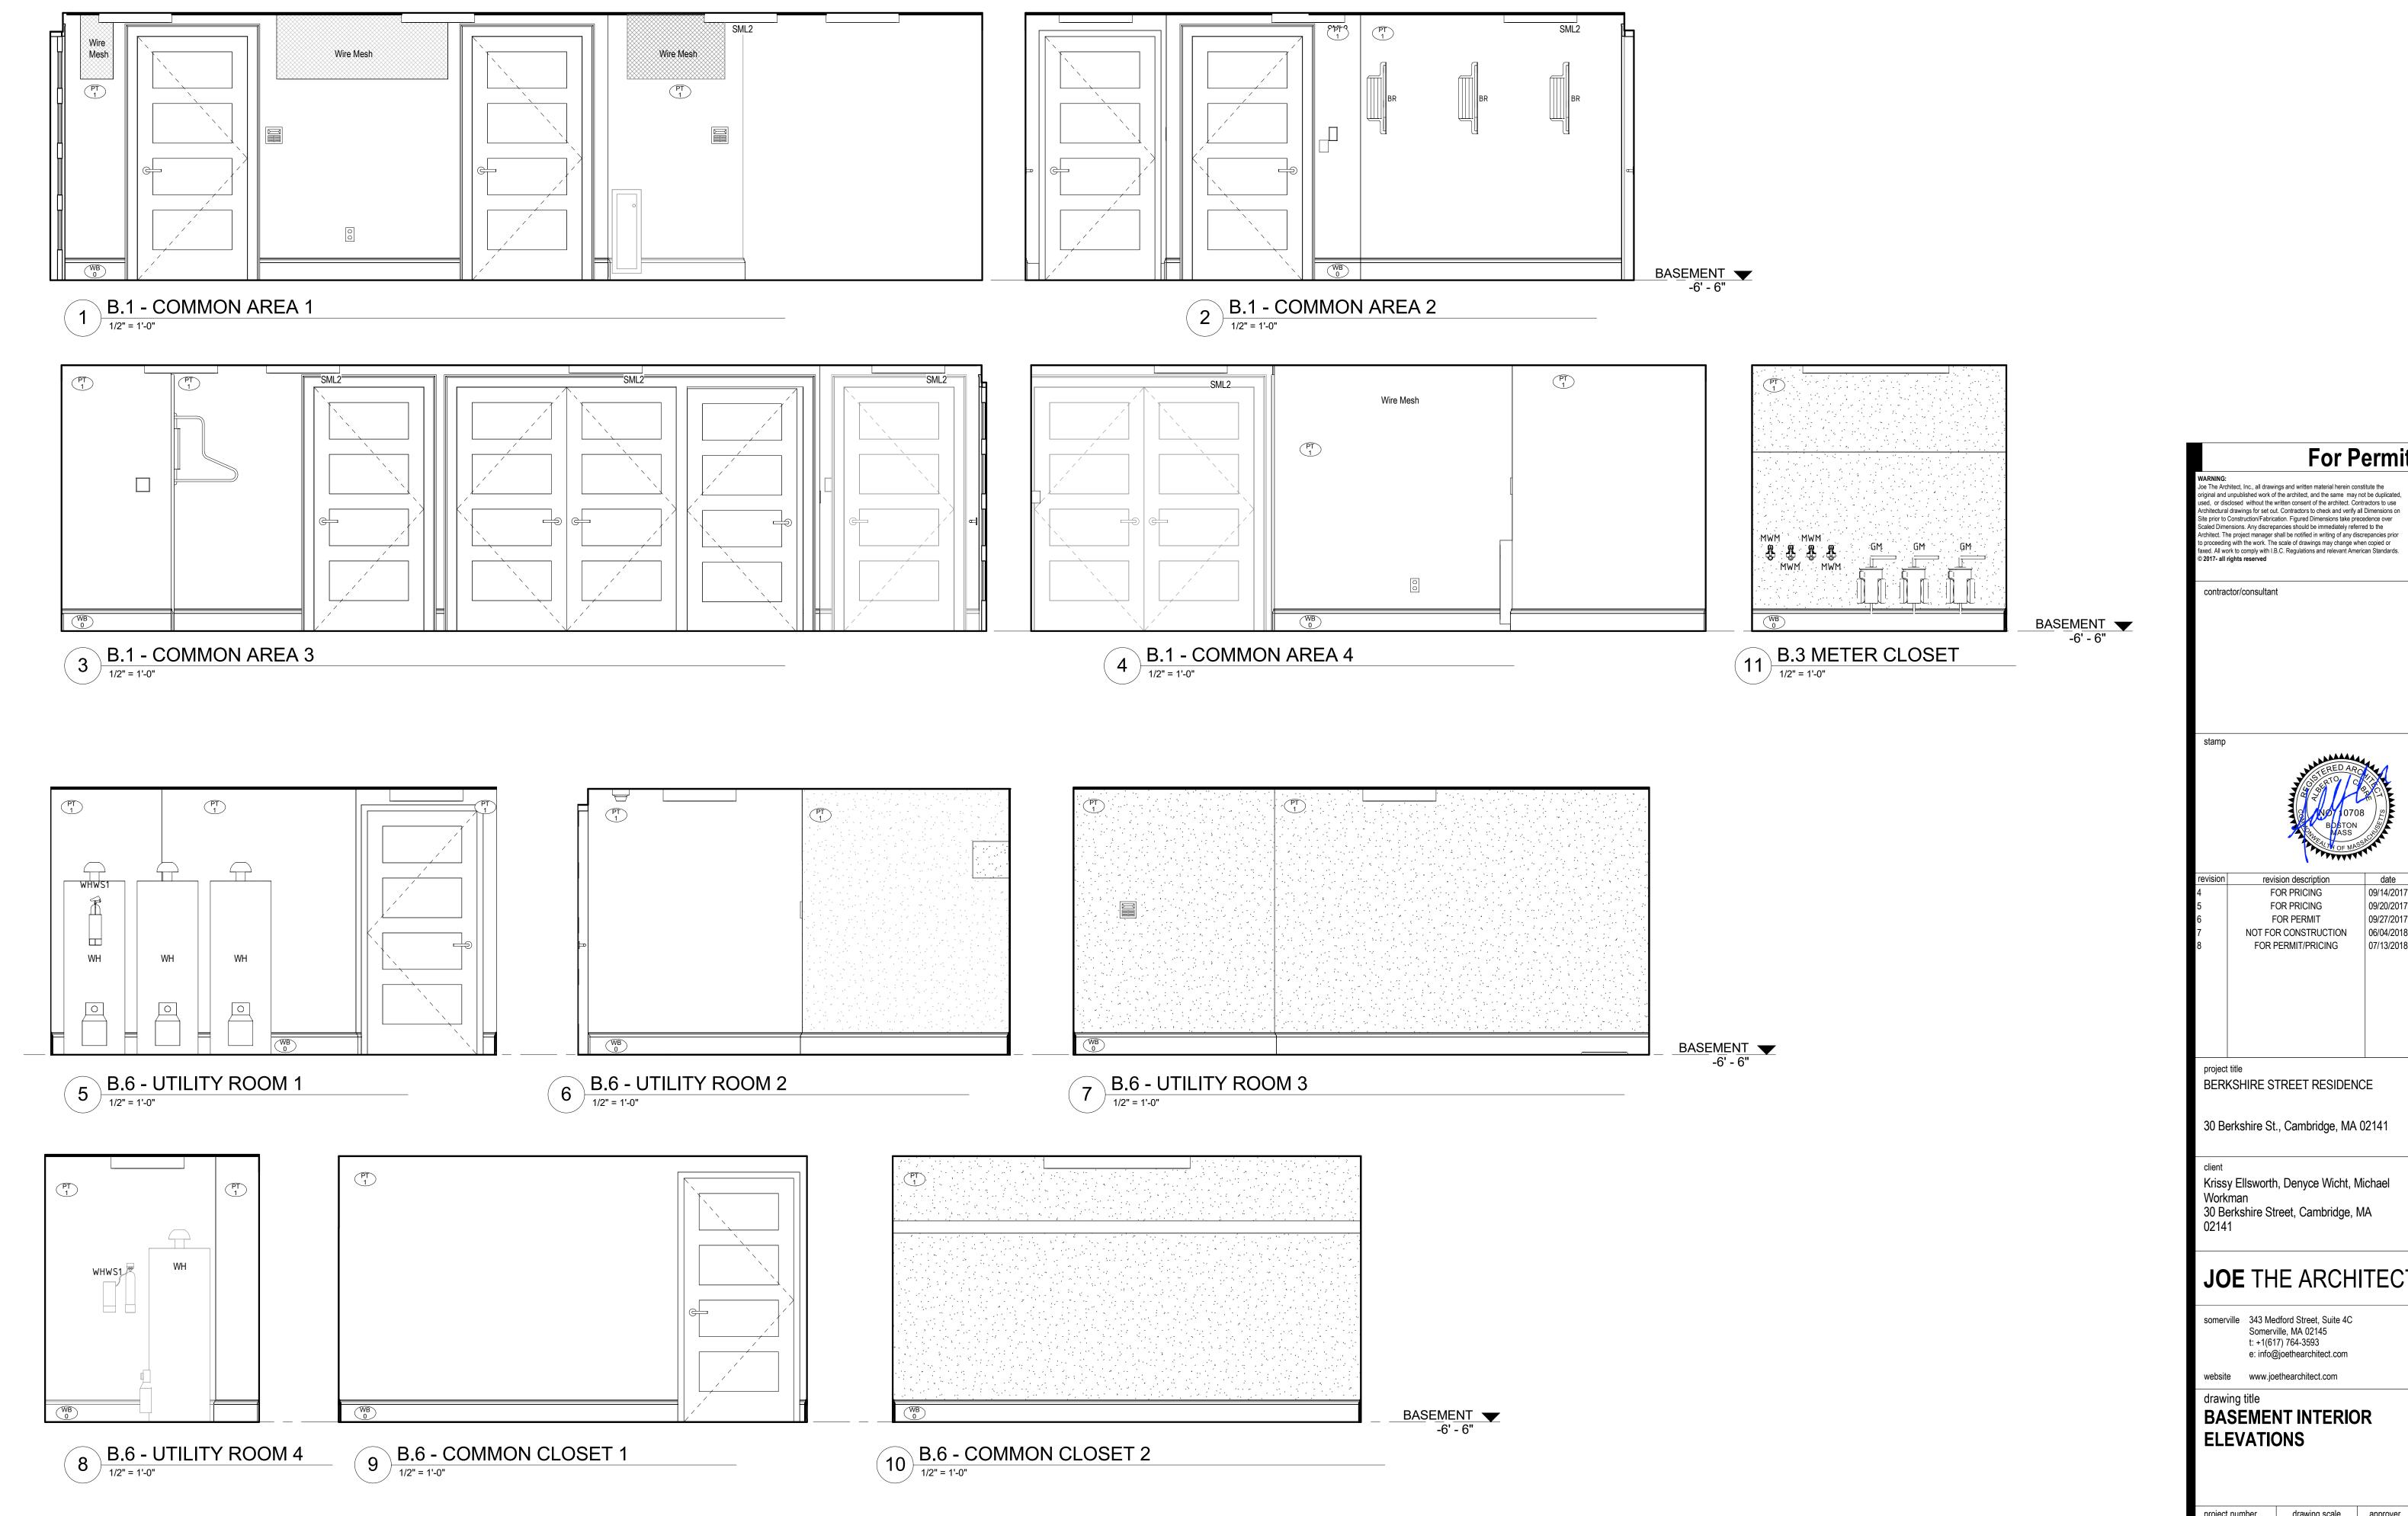
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drawing title
SCHEDULES

website www.joethearchitect.com

oject number	drawing scale	approver
92		Approver
awing number		revision
101		•





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revision description FOR PRICING

FOR PRICING FOR PERMIT

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09/14/2017 09/20/2017

09/27/2017

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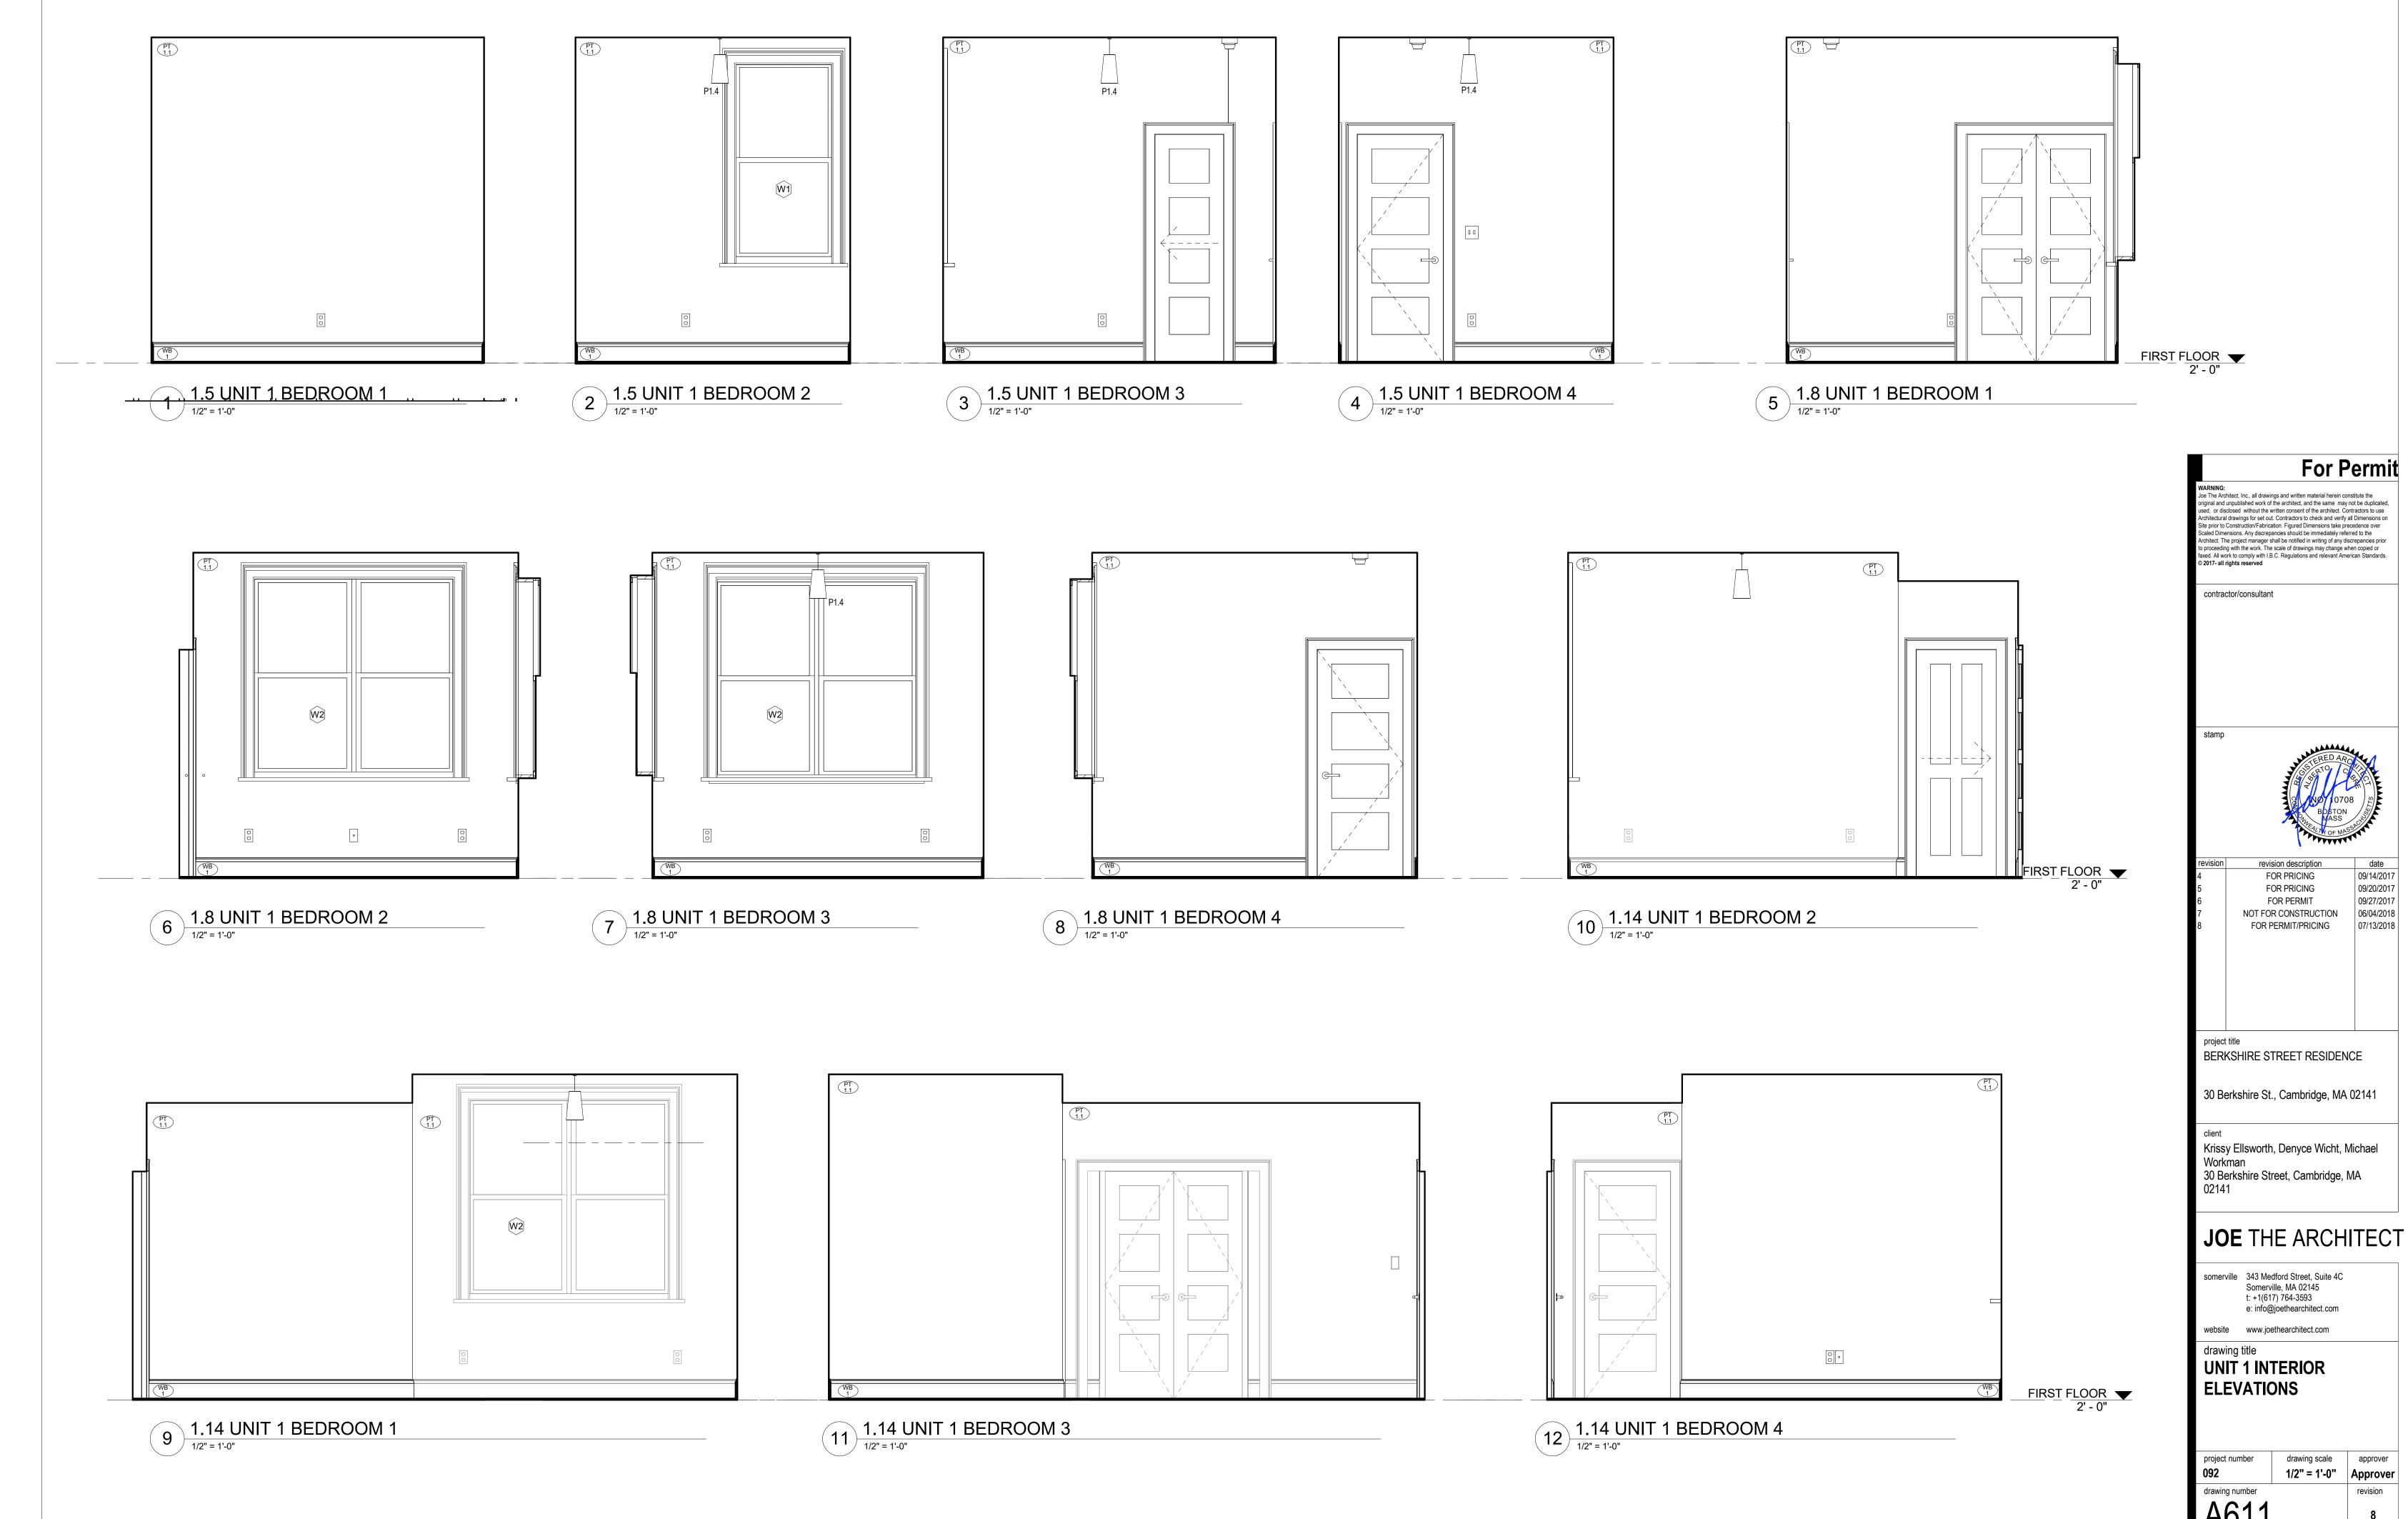
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BASEMENT INTERIOR ELEVATIONS

drawing scale approver 1/2" = 1'-0" Approver drawing number A601




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30 Berkshire Street, Cambridge, MA 02141

website www.joethearchitect.com drawing title

UNIT 2 INTERIOR ELEVATIONS

drawing scale approver 1/2" = 1'-0" Approver drawing number



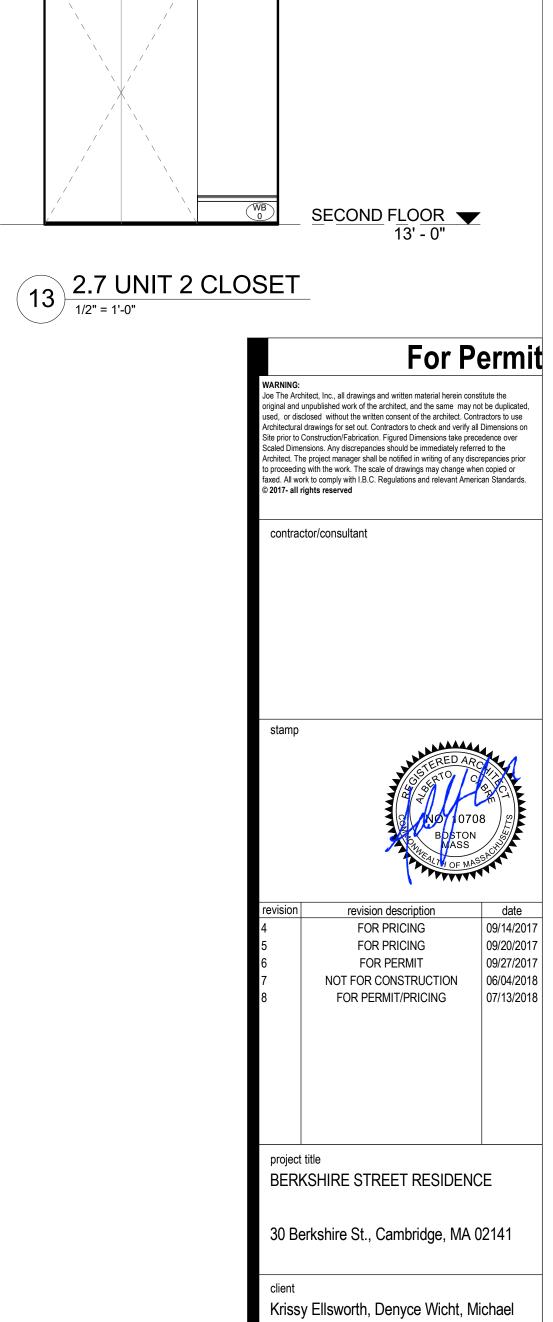














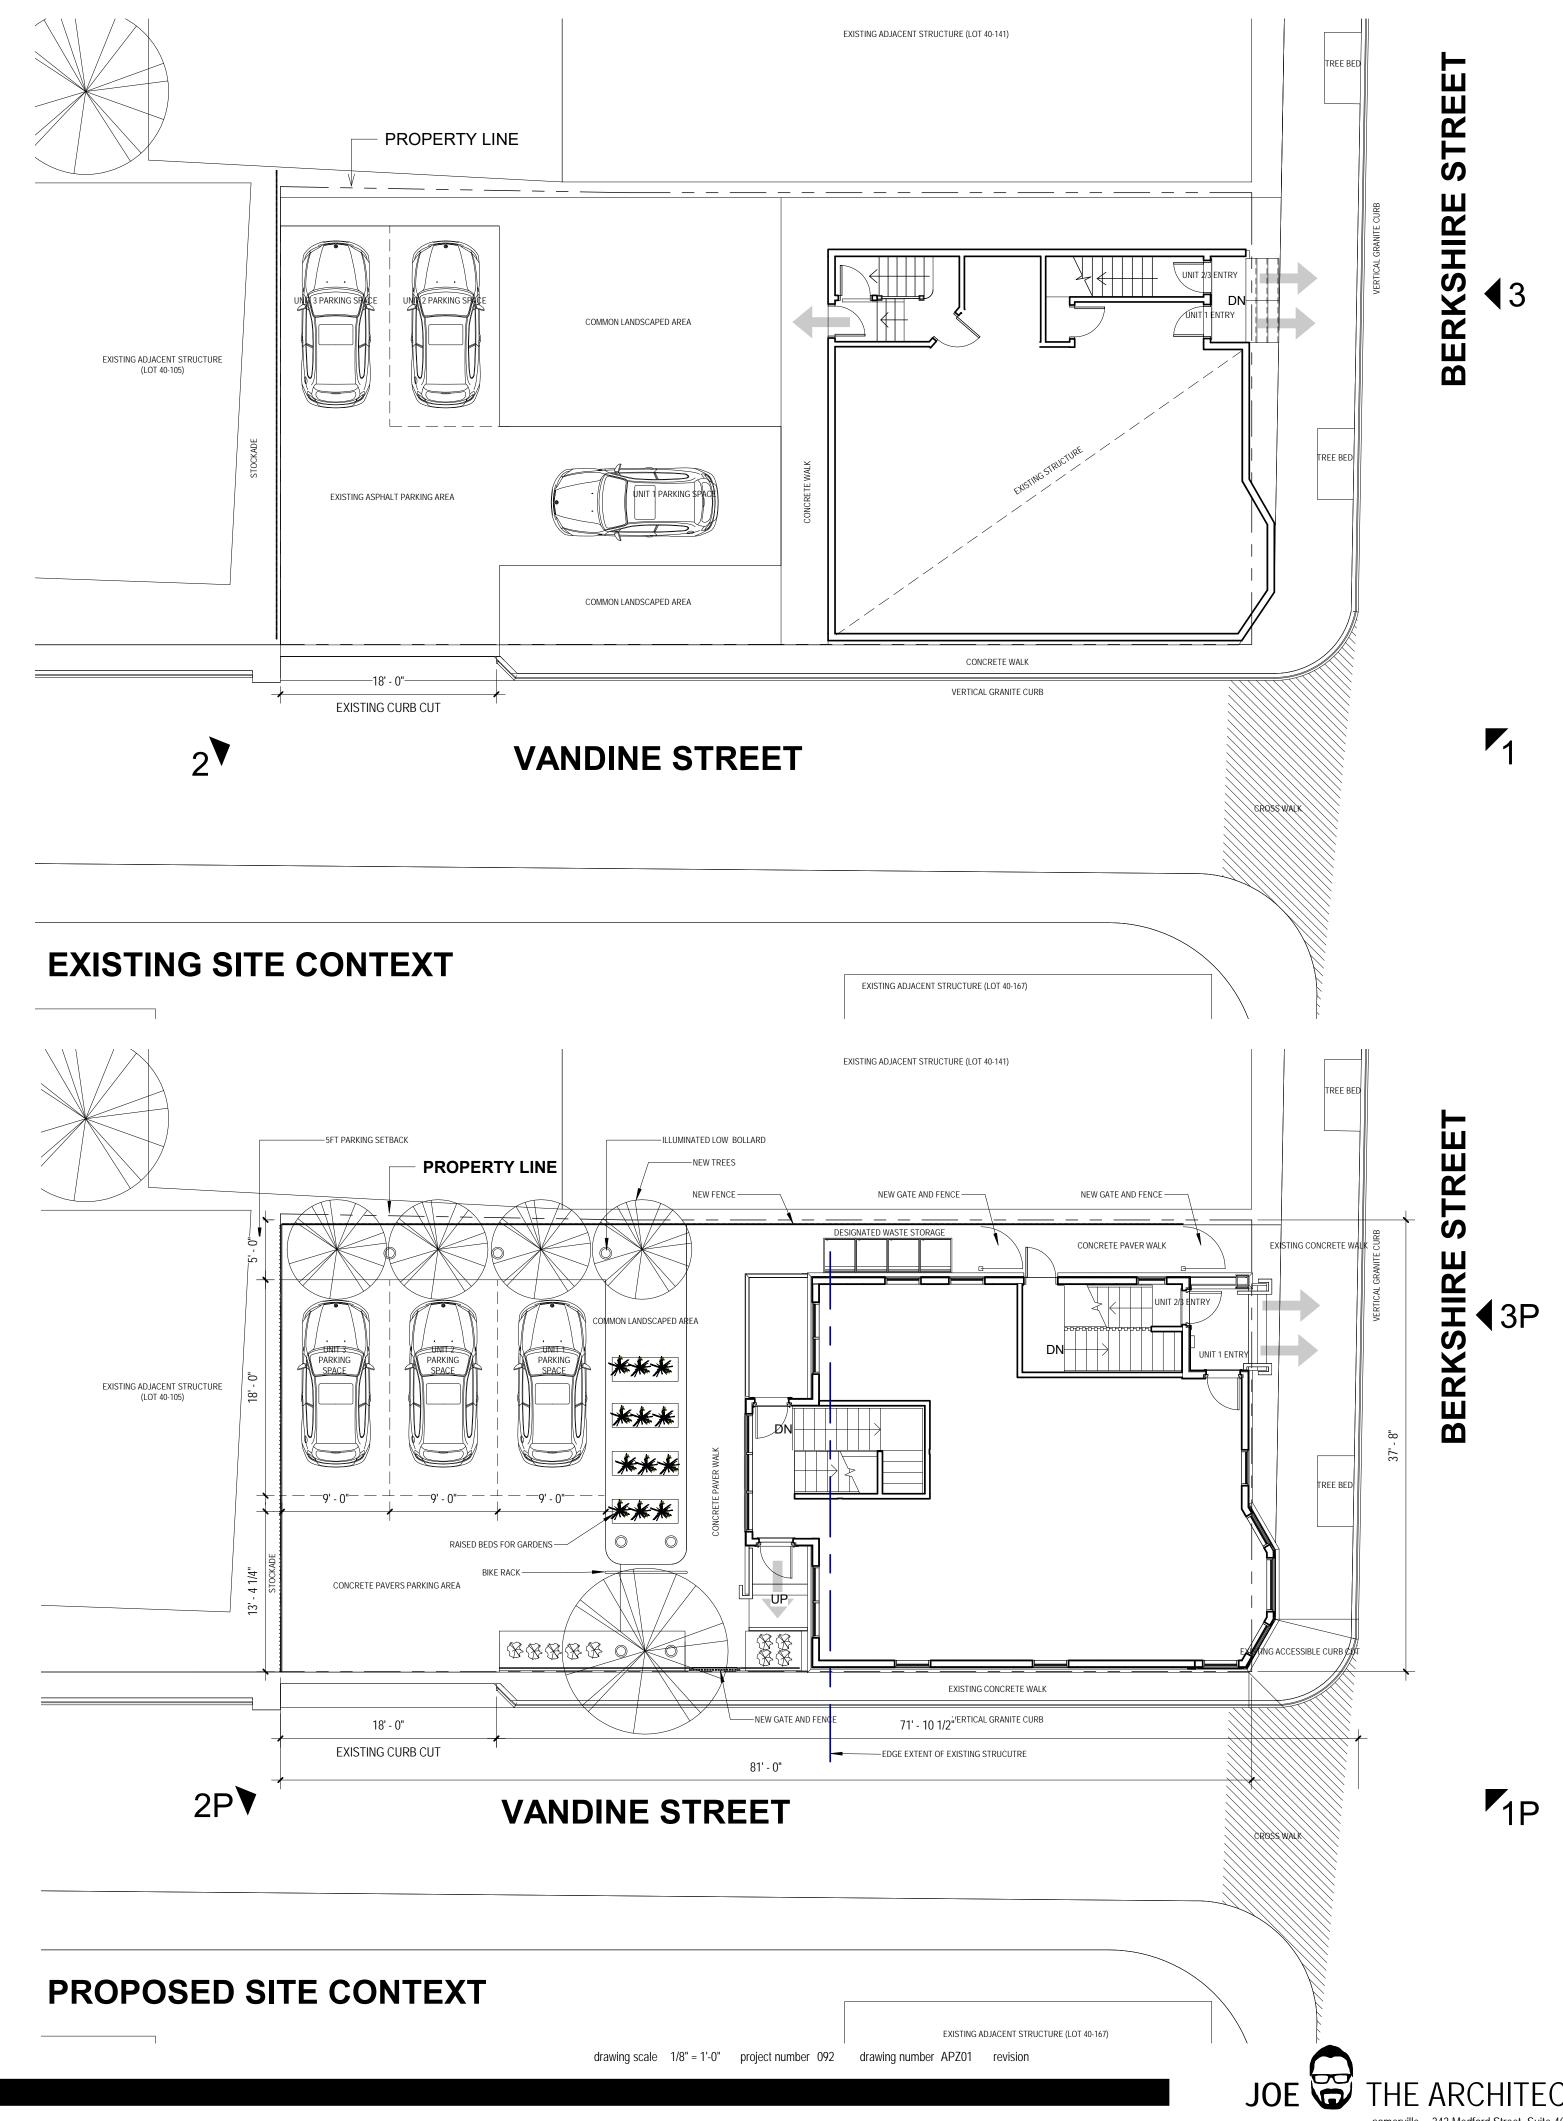

PROJECT DATA			
PROPERTY CLASS CONDOM	INIII IN <i>I</i> I		
STATE CLASS CODE 102	IIVIOIVI		
MAP/LOT 40-140-1 NEIGHBORHOOD WELLING	TON HARRINGTO	NI NIFICHR∩D	HUUD 3
CITY OF CAMBRIDGE ZONING ORDINANCE THE CITY COUNCIL UP TO ORDINANCE			
ZONING MAP OF THE CITY OF CAMBETHROUGH AND INCLUDING ORDINAN			WITH CHANGES
DIMENSIONAL REGULATIONS DISTRI	CT C-1 MULTIFA	MILY DWELLIN	GS
	REQUIRED	EXISTING	PROPOSED
MINIMUM LOT SIZE	5,000SF	3,058SF	3,058SF
TOTAL FRONTAGE		37'-8"	37'-8"
FLOOR AREA RATIO (FAR)	2,294SF (.75)	3,660SF (1.2)	3,813SF (1.2)
MIN. LOT AREA/ DU	1,500SF		UNIT 1: 977SF UNIT 2: 1,010SF UNIT 3: 1,010SF
MINIMUM LOT WIDTH	50'-0"	37'-8"	37'-8"
BUILDING HEIGHT	35'-0" MAX	35'-0"	35'-0"
MINIMUM YARD DIMENSIONS (BASED ON BUILDING HEIGHT/LENGT)	H)		
FRONT SETBACK: (H+L)/4	16'-8"FT	16'-8"FT	16'-8"FT
MIN SIDE SETBACK: (H+L)/5	7'-6" MIN	4'-6"FT	4'-6"FT
MIN REAR SETBACK: (H+L)/4	20'-0" MIN	43'-10"FT	38'-9"FT
OPEN SPACE MIN AS % OF GROSS FLR AREA	30% 917SF	60% 1,838SF	55% 1,687SF
PROPOSED BUILDING AREA INCLUDING BASEMENT		4,630SF	5,015SF
BALCONIES/DECK		0SF	168SF
PARKING REGULATIONS			
	REQUIRED	EXISTING	PROPOSED
PARKING SPACES PER DWELLING	1/DU	1/DU	1/DU
TOTAL PARKING SPACES	3	3	3
PARKING NOTES: 1. SPECIAL PERMIT GRANTING AI IN EXCESS OF THE MINIMUM.	JTHORITY MAY	REQUIRE VISITO	OR SPACES


Basement	Rear Stair Front Stair	Compliant
	<u> </u>	25sf
First Floor		70+45=115sf
Second Floor		70+78=148sf
Third Floor		69+49=118sf
Total		406sf Existing
	New Stair Diagram	New Stair Code Compliant
Basement	Rear Stair Front Stair	57sf+62sf= 119
First Floor		105+98=203sf
Second Floor		105+105=210s
Third Floor		104+106=210s
Total		742sf New
	Area Difference Diagram Rear Stair Front Stair	Area Delta Due to Code
Basement		119-25=94sf
First Floor		203-115=88sf
Second Floor		210-118=62sf
Third Floor		210-118=92sf
Total		336sf Delta





NARRATIVE


Diagrams depicted on this sheet indicate the existing building vertical circulation square footage which is not compliant to current code. Rebuilding the vertical circulation to the current code requirments within the existing building volume will result in a loss of livable square footage.

The area calculations above depict what the total area of a compliant stair would require. The proposed building footprint has been expanded to account for the lose in living space required to build code compliant circulation and retain equivalent livable square footage in the building.

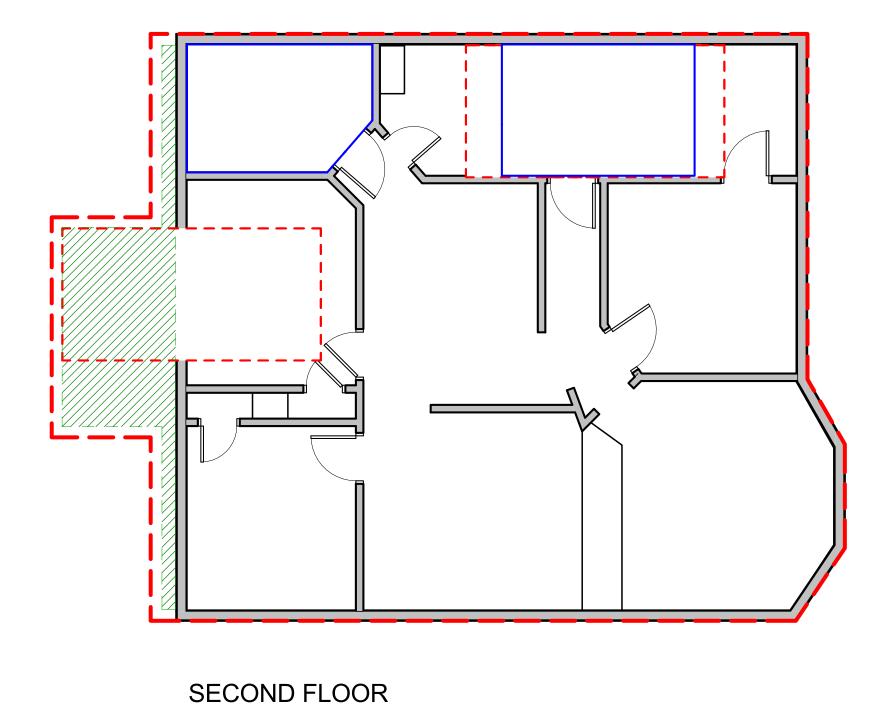

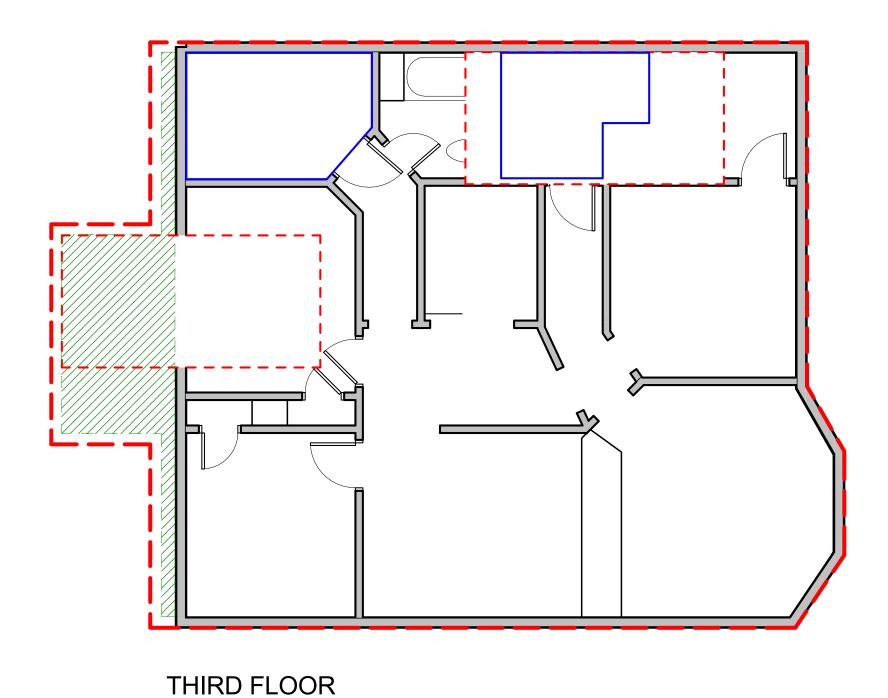

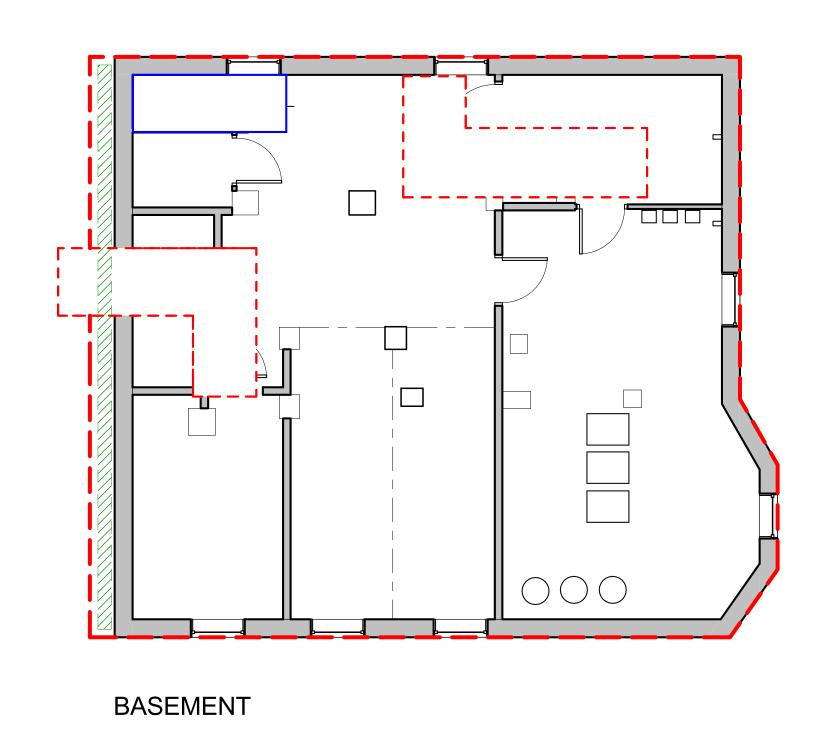

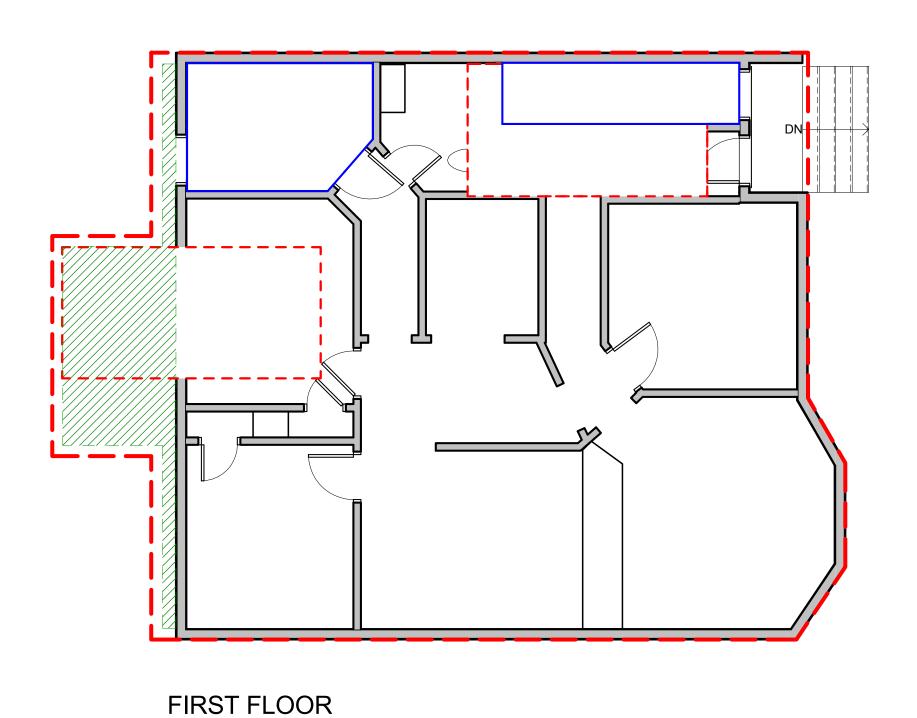

For Zoning






▲ 2P



BATHROOM BEDROOM BEDROOM

THIRD FLOOR UNIT 3

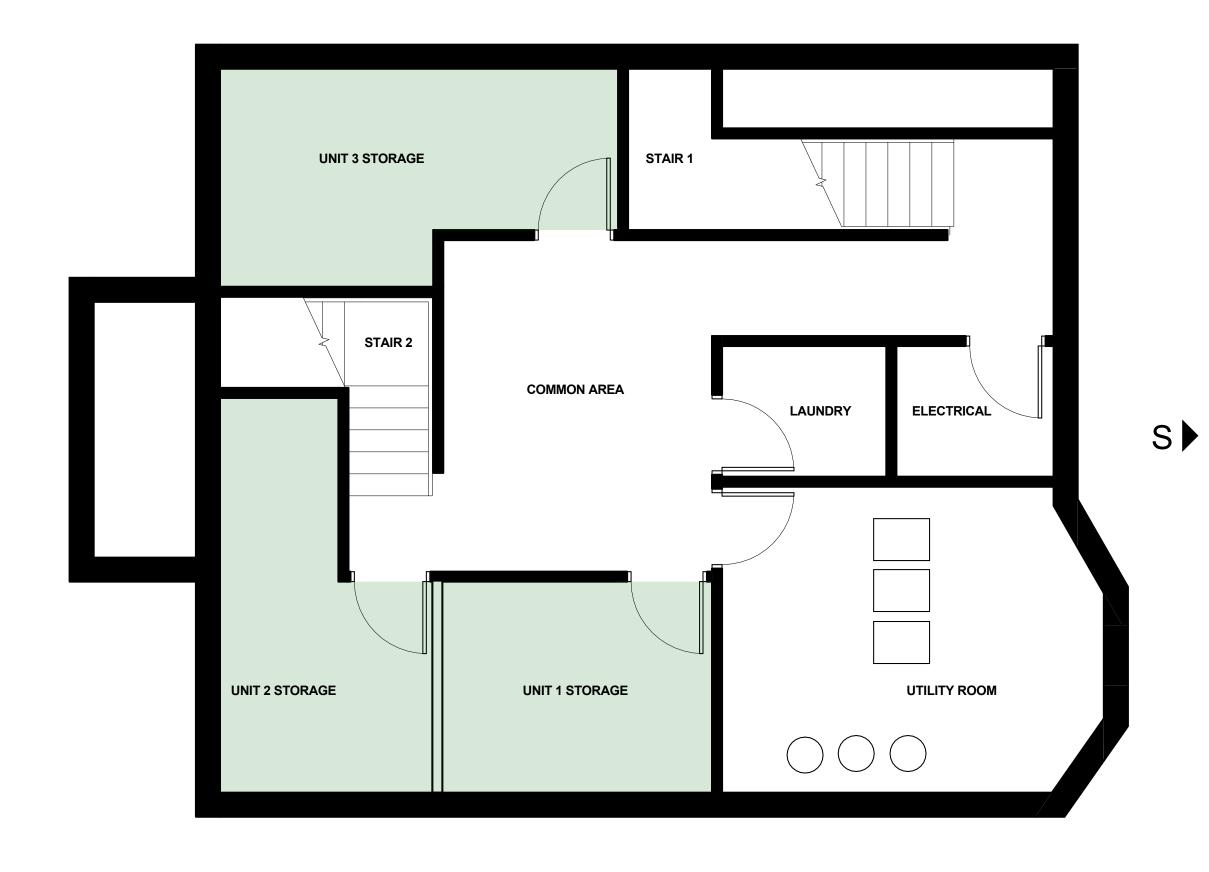

BASEMENT SHARED STORAGE AND UTILITY



BATHROOM BEDROOM LAUNDRY HALLWAY LIVING ROOM BEDROOM

FIRST FLOOR UNIT 1

drawing scale As indicated project number 092 drawing number APZ03 revision

For Zoning

◀ N



BERKSHIRE STREET VIEW



NORTH ELEVATION

EAST ELEVATION **Not For Construction**



VANDINE STREET VIEW



SOUTH ELEVATION



WEST ELEVATION










CONSTRUCTION NOTES

- PRIOR TO THE START OF ANY EXCAVATION FOR THE PROJECT, BOTH ON AND OFF THE SITE, THE CONTRACTOR SHALL NOTIFY DIGSAFE AND BE PROVIDED WITH A DIGSAFE NUMBER INDICATING THAT ALL EXISTING UTILITIES HAVE BEEN LOCATED AND MARKED.
- 2. CONTRACTOR TO ADJUST UTILITY ELEMENT MEANT TO BE FLUSH WITH GRADE (CLEAN—OUTS, UTILITY MANHOLES, CATCH BASINS, INLETS, ETC.) THAT IS AFFECTED BY SITE WORK OR GRADE CHANGES, WHETHER SPECIFICALLY NOTED ON PLANS OR NOT.
- 3. ALL CONSTRUCTION TO BE DONE IN ACCORDANCE WITH CITY OF CAMBRIDGE DPW AND ENGINEERING DEPARTMENT REQUIREMENTS.
- 4. ALL WORK TO BE DONE WITHIN PUBLIC RIGHT-OF-WAYS SHALL CONFORM TO THE REQUIREMENTS AND SPECIFICATIONS OF THE CITY OF CAMBRIDGE DEPARTMENT OF PUBLIC WORKS.
- THE LOCATIONS OF EXISTING UNDERGROUND UTILITIES ARE SHOWN IN AN APPROXIMATE WAY ONLY AND HAVE NOT BEEN INDEPENDENTLY VERIFIED BY THE OWNER OR ITS REPRESENTATIVE. THE CONTRACTOR SHALL DETERMINE THE EXACT LOCATION OF ALL EXISTING UTILITIES BEFORE COMMENCING—WORK, AND AGREES TO BE FULLY RESPONSIBLE FOR ANY AND ALL DAMAGES WHICH MAY BE OCCASIONED BY THE CONTRACTOR'S FAILURE TO EXACTLY LOCATE AND PRESERVE AND AND ALL UNDERGROUND UTILITIES.
- 6. WHERE AN EXISTING UTILITY IS FOUND TO CONFLICT WITH THE PROPOSED WORK, THE LOCATION, ELEVATION, AND SIZE OF THE UTILITY SHALL BE ACCURATELY DETERMINED WITHOUT DELAY BY THE CONTRACTOR, AND THE INFORMATION FURNISHED TO THE ENGINEER FOR RESOLUTION OF THE CONFLICT.
- THE CONTRACTOR SHALL ALTER THE MASONRY OF THE TOP SECTION OF ALL EXISTING DRAINAGE STRUCTURES AS NECESSARY FOR CHANGES IN GRADE, AND RESET ALL WATER AND DRAINAGE FRAMES, GRATES, AND BOXES TO THE PROPOSED FINISH SURFACE GRADE.
- 8. THE CONTRACTOR SHALL MAKE ALL ARRANGEMENTS FOR THE ALTERATION AND ADJUSTMENT OF ALL GAS, ELECTRIC, TELEPHONE, AND ANY OTHER PRIVATE UTILITIES BY THE UTILITY COMPANIES.
- 9. CONTRACTOR SHALL MAINTAIN, OR ADJUST TO NEW FINISH GRADE, AS NECESSARY ALL UTILITY AND SITE STRUCTURES SUCH AS: LIGHT POLES, SIGN POLES, MANHOLES, CATCH BASINS, HAND HOLES, WATER AND GAS GATES, HYDRANTS, ETC., FROM MAINTAINED UTILITY AND SITE SYSTEMS, UNLESS OTHERWISE NOTED OR DIRECTED BY OWNER'S REPRESENTATIVE.
- 10. ALL STORM DRAIN PIPES SHALL BE PVC PER ASTM D3034, SDR-35 AND ASTM D1784 WITH RUBBER GASKET JOINTS, UNLESS OTHERWISE NOTED.
- 11. AREAS OUTSIDE THE LIMITS OF PROPOSED WORK DISTURBED BY THE CONTRACTOR'S OPERATIONS SHALL BE RESTORED BY THE CONTRACTOR TO THEIR ORIGINAL CONDITION, AT THE CONTRACTOR'S EXPENSE.
- 12. PROTECT AND MAINTAIN EXISTING ON-SITE DRAINAGE STRUCTURES AND PIPES UNLESS OTHERWISE
- 3. WHERE PROPOSED GRADES MEET EXISTING GRADES, CONTRACTOR SHALL BLEND GRADES TO PROVIDE A SMOOTH TRANSITION BETWEEN EXISTING AND NEW WORK. PONDING AT TRANSITION AREAS WILL NOT BE ALLOWED.
- 14. CONTRACTOR SHALL MAINTAIN POSITIVE DRAINAGE AWAY FROM ALL BUILDING FOUNDATIONS, STRUCTURES AND PLANTING BEDS.
- 15. MAXIMUM SLOPE IN DISTURBED AREAS SHALL NOT EXCEED 3:1, UNLESS OTHERWISE NOTED.
- 16. ENSURE ALL EXISTING (TO REMAIN), AND PROPOSED MANHOLE COVERS PROPERLY IDENTIFY UTILITY SERVICED.
- 17. CONTRACTOR SHALL VERIFY EXISTING GRADES AND NOTIFY OWNER'S REPRESENTATIVE OF ANY DISCREPANCIES.
- CONTRACTOR TO ADJUST UTILITY ELEMENT MEANT TO BE FLUSH WITH GRADE (CLEAN-OUTS, UTILITY MANHOLES, CATCH BASINS, INLETS, ETC) THAT IS AFFECTED BY SITE WORK OR GRADE CHANGES, WHETHER SPECIFICALLY NOTED ON PLANS OR NOT.
- THE CONTRACTOR SHALL PROVIDE AN AS—BUILT PLAN SHOWING LOCATIONS AND TIE MEASUREMENTS
 TO ALL NEW UTILITY CONNECTIONS, INCLUDING BUT NOT LIMITED TO: MANHOLES, WYES, CATCH BASINS, AREA DRAINS, T—CONNECTIONS, ETC.
- 20. SCREENED IMAGES SHOW EXISTING CONDITIONS. WHERE EXISTING CONDITIONS LIE UNDER OR ARE IMPINGED UPON BY PROPOSED BUILDINGS AND/OR SITE ELEMENTS, THE EXISTING CONDITION WILL BE REMOVED, ABANDONED AND/OR CAPPED OR DEMOLISHED AS REQUIRED.
- 21. THE CONTRACTOR SHALL COORDINATE ALL GAS AND ELECTRIC SERVICE WORK WITH THE RESPECTIVE UTILITY COMPANY.
- 22. THE GENERAL CONTRACTOR SHALL CORDINATE WITH THESE PLANS WITH THE ARCHITECTURAL PLANS FOR ALL NEW SURFACES, EXTERIOR BUILDING (STAIR AND AREAWAYS), PLANTINGS AND ALL OTHER NEW SITE FEATURES.

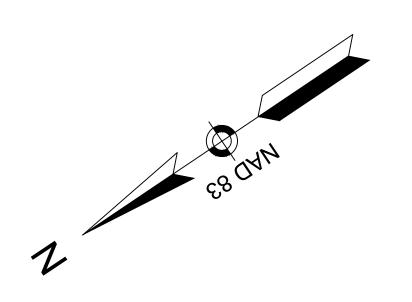

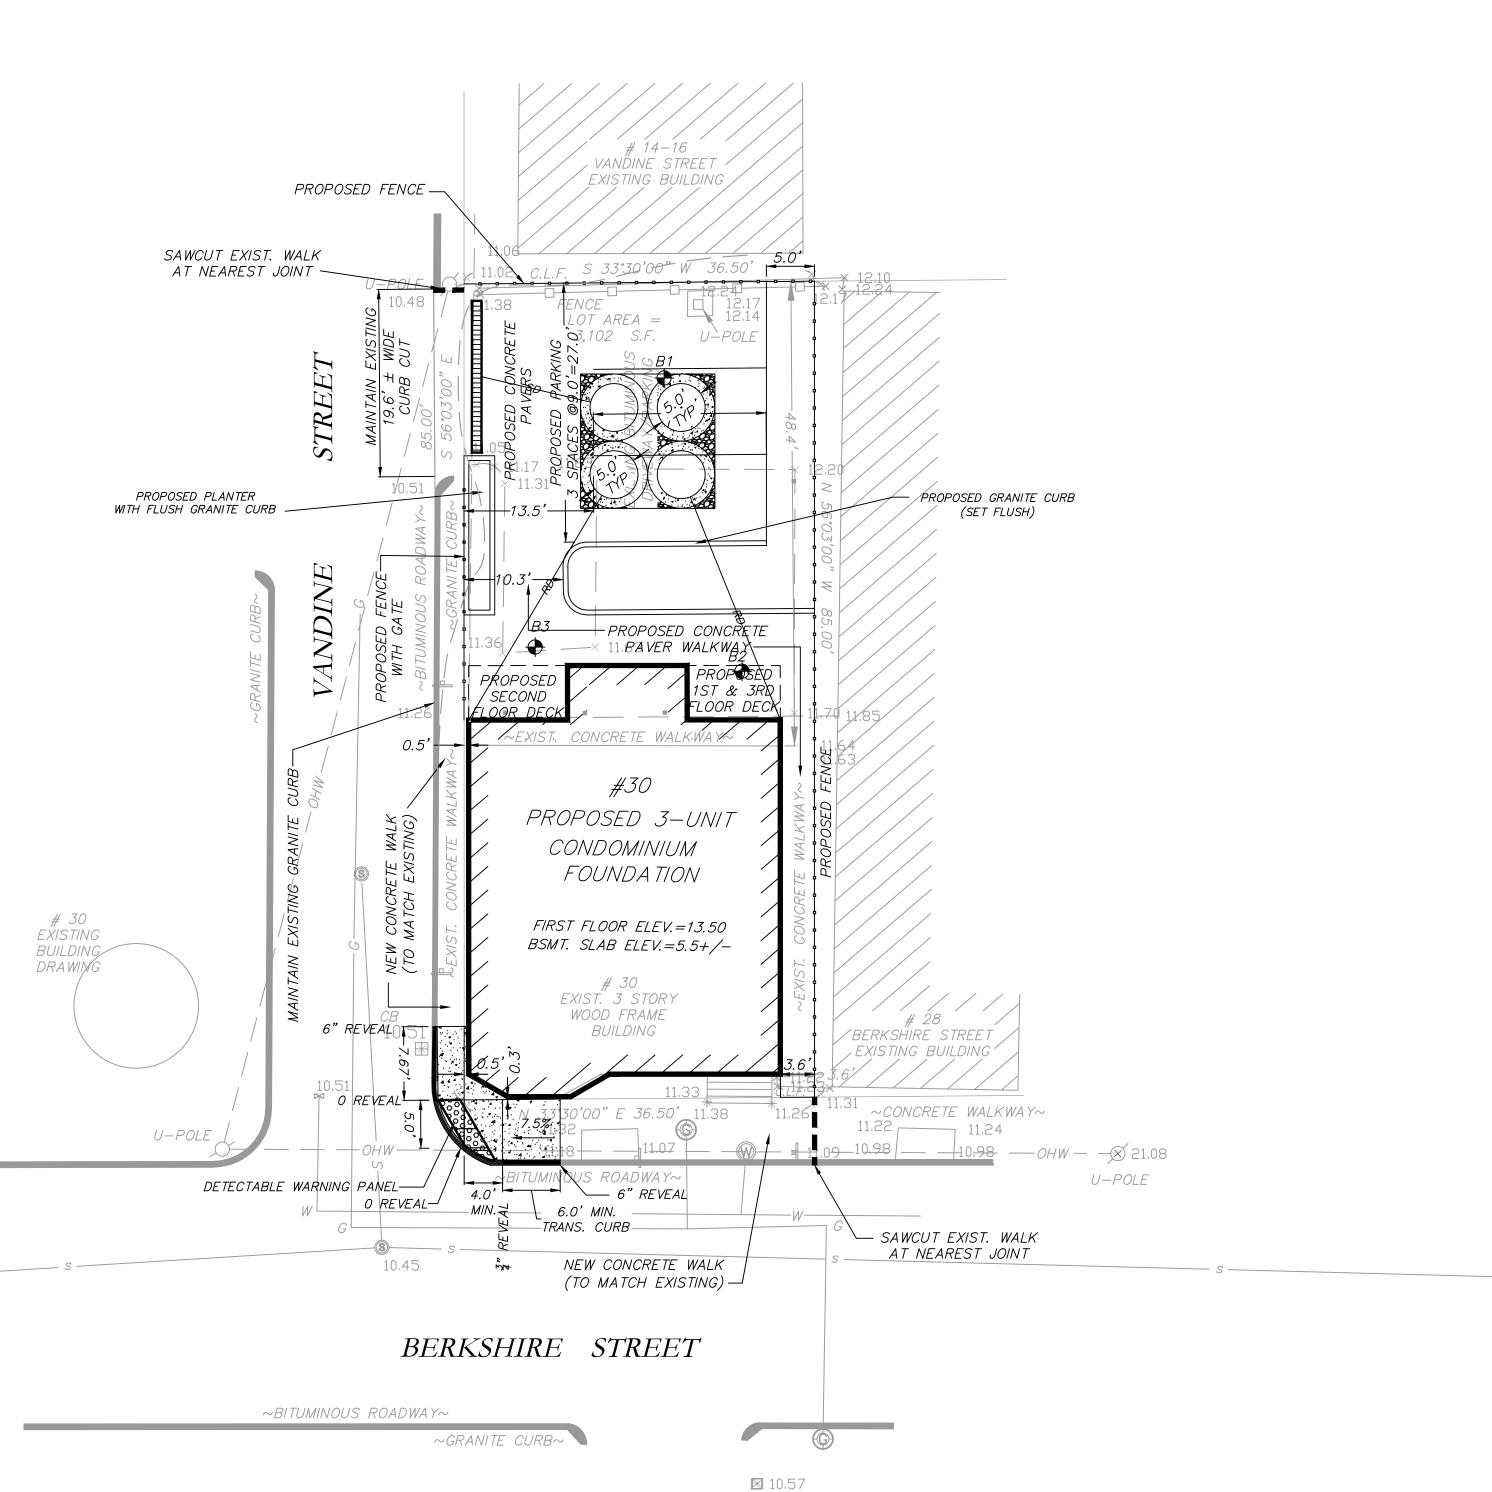

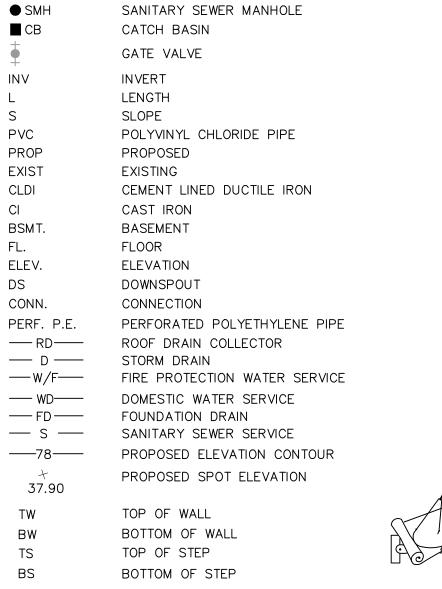

LEGEND:

CLEANOUT

STORM DRAIN MANHOLE


CO

DMH

Site Engineering Consultants, Inc.
55 Grape Shot Road
Sharon, Massachusetts 02067
TEL: (781) 784-0326
FAX: (781) 784-0492
CONSULTING CIVIL ENGINEERS

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website www.joethearchitect.com

drawing title

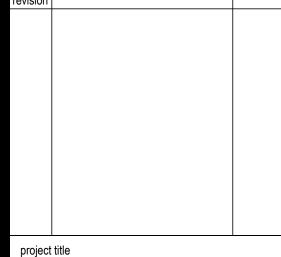
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LAYOUT &
MATERIALS

project number drawing scale approver


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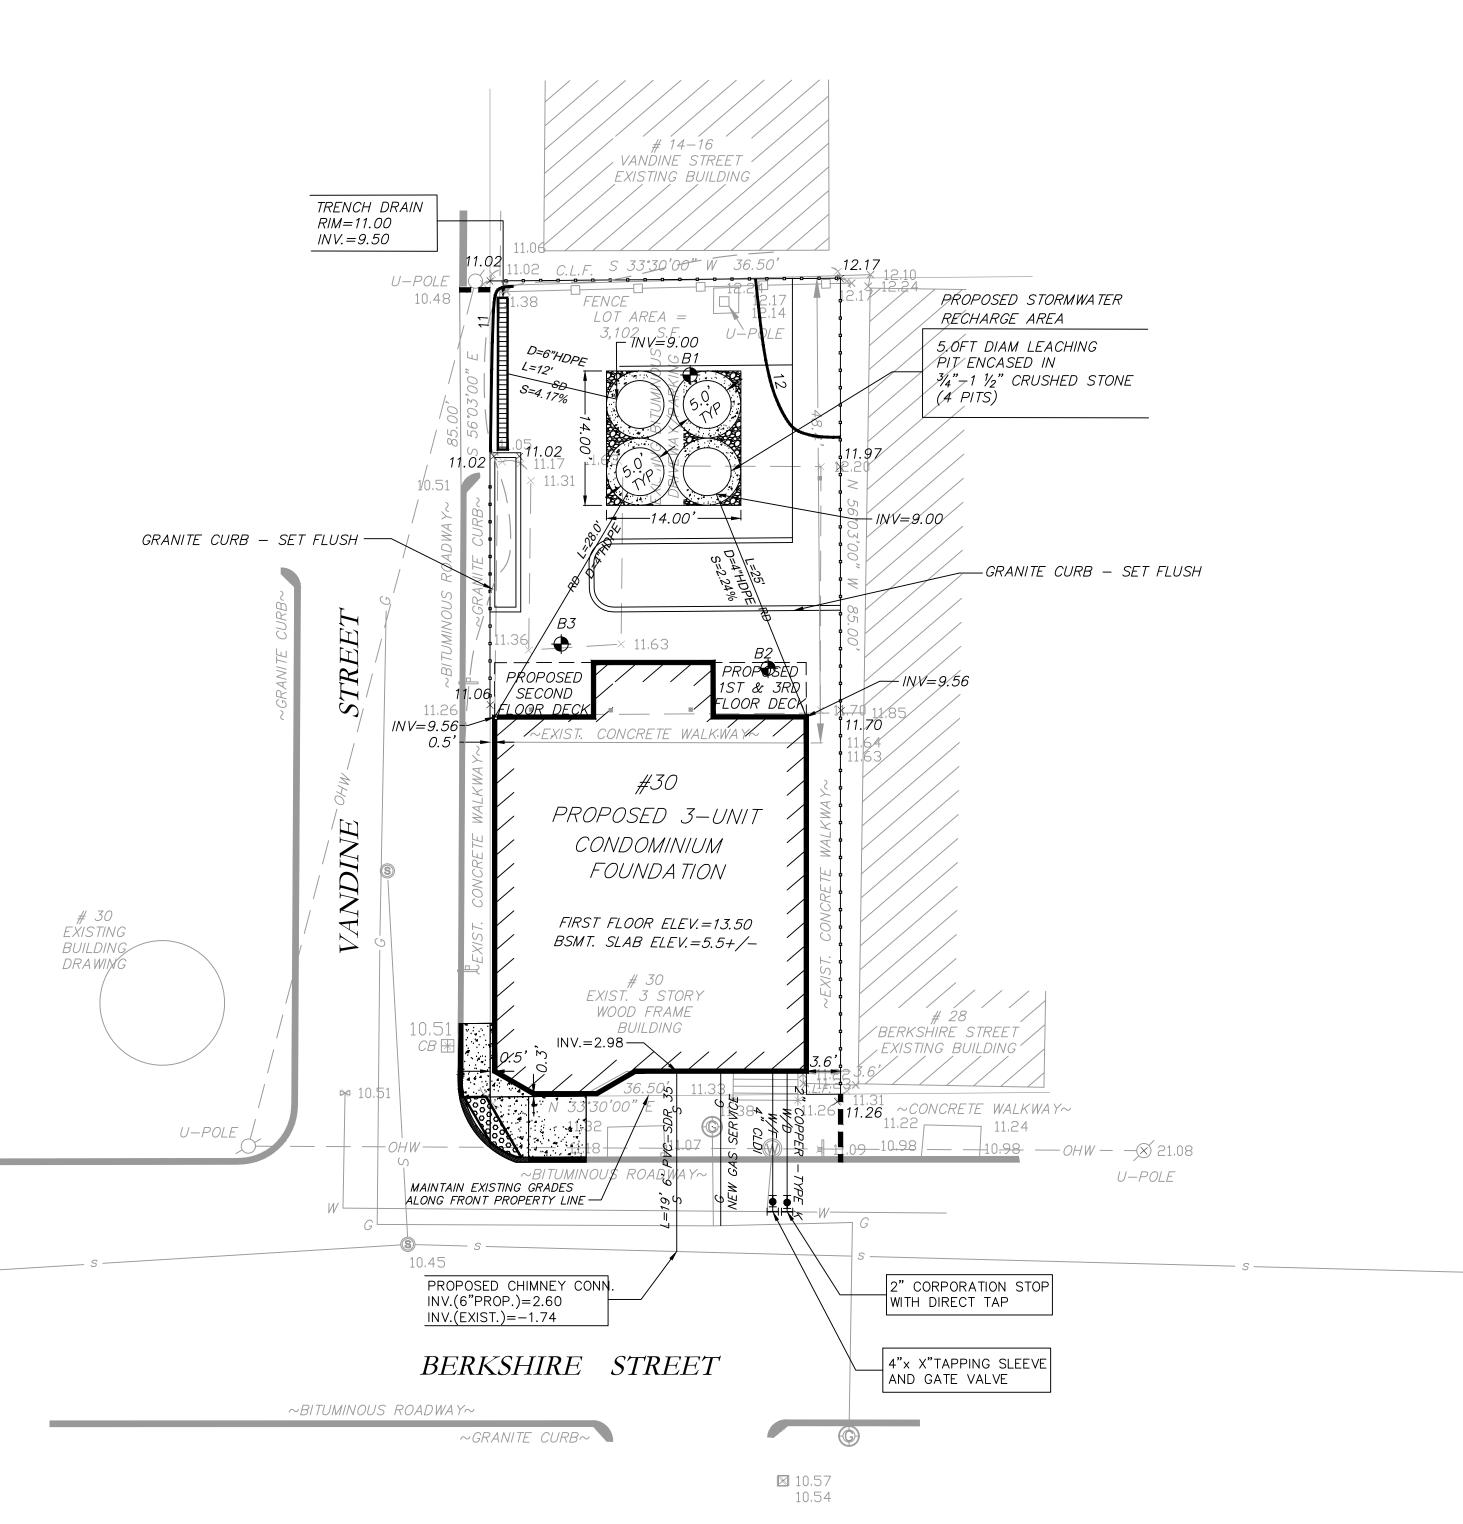
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CONSTRUCTION NOTES

- PRIOR TO THE START OF ANY EXCAVATION FOR THE PROJECT, BOTH ON AND OFF THE SITE, THE CONTRACTOR SHALL NOTIFY DIGSAFE AND BE PROVIDED WITH A DIGSAFE NUMBER INDICATING THAT ALL EXISTING UTILITIES HAVE BEEN LOCATED AND MARKED.
- CONTRACTOR TO ADJUST UTILITY ELEMENT MEANT TO BE FLUSH WITH GRADE (CLEAN-OUTS, UTILITY MANHOLES, CATCH BASINS, INLETS, ETC.) THAT IS AFFECTED BY SITE WORK OR GRADE CHANGES, WHETHER SPECIFICALLY NOTED ON PLANS OR NOT.
- ALL CONSTRUCTION TO BE DONE IN ACCORDANCE WITH CITY OF CAMBRIDGE DPW AND ENGINEERING DEPARTMENT REQUIREMENTS.
- ALL WORK TO BE DONE WITHIN PUBLIC RIGHT-OF-WAYS SHALL CONFORM TO THE REQUIREMENTS AND SPECIFICATIONS OF THE CITY OF CAMBRIDGE DEPARTMENT OF PUBLIC WORKS.
- THE LOCATIONS OF EXISTING UNDERGROUND UTILITIES ARE SHOWN IN AN APPROXIMATE WAY ONLY AND HAVE NOT BEEN INDEPENDENTLY VERIFIED BY THE OWNER OR ITS REPRESENTATIVE. THE CONTRACTOR SHALL DETERMINE THE EXACT LOCATION OF ALL EXISTING UTILITIES BEFORE COMMENCING WORK, AND AGREES TO BE FULLY RESPONSIBLE FOR ANY AND ALL DAMAGES WHICH MAY BE OCCASIONED BY THE CONTRACTOR'S FAILURE TO EXACTLY LOCATE AND PRESERVE AND AND ALL UNDERGROUND UTILITIES.
- WHERE AN EXISTING UTILITY IS FOUND TO CONFLICT WITH THE PROPOSED WORK, THE LOCATION, ELEVATION, AND SIZE OF THE UTILITY SHALL BE ACCURATELY DETERMINED WITHOUT DELAY BY THE CONTRACTOR, AND THE INFORMATION FURNISHED TO THE ENGINEER FOR RESOLUTION OF THE CONFLICT.
- THE CONTRACTOR SHALL ALTER THE MASONRY OF THE TOP SECTION OF ALL EXISTING DRAINAGE STRUCTURES AS NECESSARY FOR CHANGES IN GRADE, AND RESET ALL WATER AND DRAINAGE FRAMES, GRATES, AND BOXES TO THE PROPOSED FINISH SURFACE GRADE.
- THE CONTRACTOR SHALL MAKE ALL ARRANGEMENTS FOR THE ALTERATION AND ADJUSTMENT OF ALL GAS, ELECTRIC, TELEPHONE, AND ANY OTHER PRIVATE UTILITIES BY THE UTILITY COMPANIES.
- CONTRACTOR SHALL MAINTAIN, OR ADJUST TO NEW FINISH GRADE, AS NECESSARY ALL UTILITY AND SITE STRUCTURES SUCH AS: LIGHT POLES, SIGN POLES, MANHOLES, CATCH BASINS, HAND HOLES, WATER AND GAS GATES, HYDRANTS, ETC., FROM MAINTAINED UTILITY AND SITE SYSTEMS, UNLESS OTHERWISE NOTED OR DIRECTED BY OWNER'S REPRESENTATIVE.
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CO CLEANOUT DMH STORM DRAIN MANHOLE SANITARY SEWER MANHOLE SMH CATCH BASIN GATE VALVE INVERT LENGTH SLOPE PVC POLYVINYL CHLORIDE PIPE PROP PROPOSED **EXIST** EXISTING CEMENT LINED DUCTILE IRON CLDI CAST IRON BSMT. BASEMENT FLOOR ELEV. ELEVATION DS DOWNSPOUT CONN. CONNECTION PERFORATED POLYETHYLENE PIPE ROOF DRAIN COLLECTOR — RD— STORM DRAIN — W/F— FIRE PROTECTION WATER SERVICE DOMESTIC WATER SERVICE — WD—— FOUNDATION DRAIN SANITARY SEWER SERVICE PROPOSED ELEVATION CONTOUR ----78----PROPOSED SPOT ELEVATION 37.90 TOP OF WALL TW BOTTOM OF WALL TOP OF STEP BOTTOM OF STEP

LEGEND:

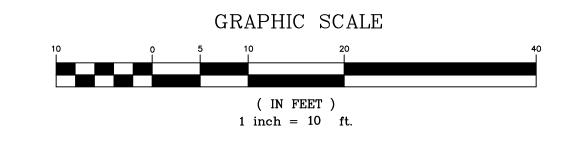Site Engineering Consultants, Inc. 55 Grape Shot Road Sharon, Massachusetts 02067 TEL: (781) 784-0326 FAX: (781) 784-0492 CONSULTING CIVIL ENGINEERS


For Permi be The Architect, Inc., all drawings and written material herein constitute the riginal and unpublished work of the architect, and the same may not be duplicated.
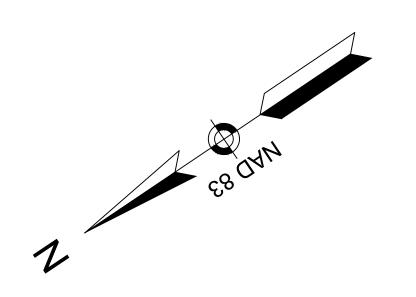
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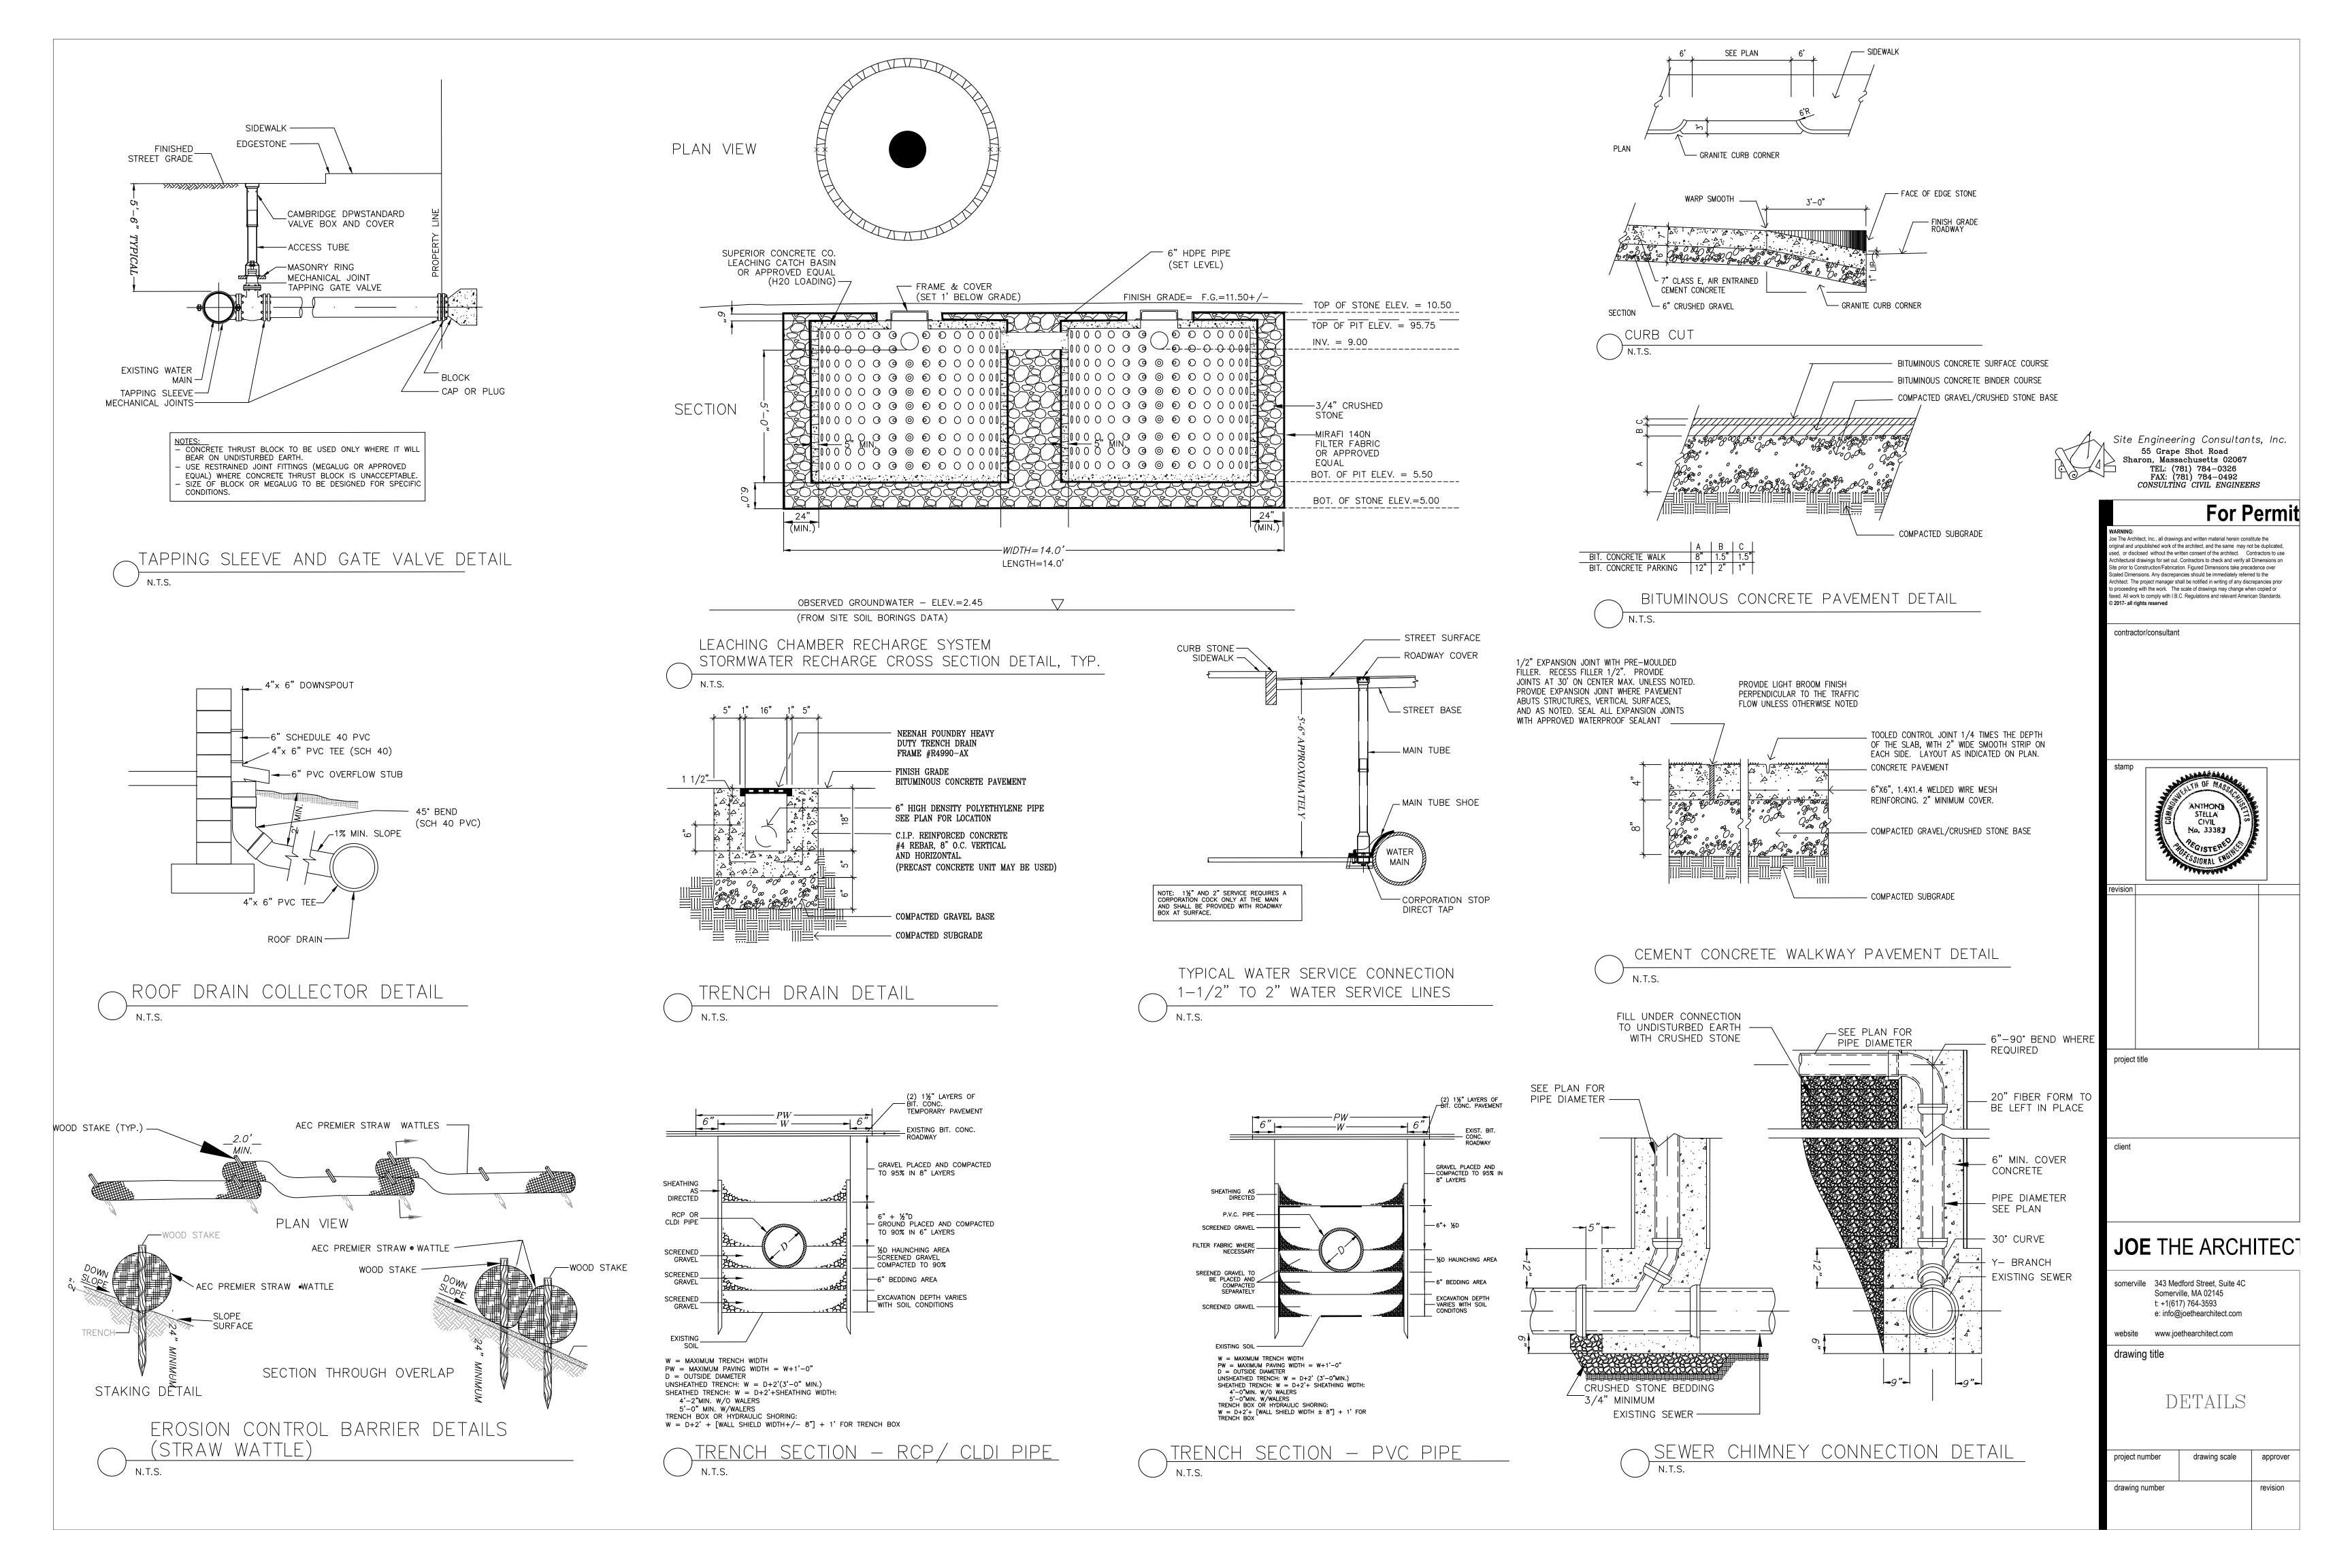
drawing title

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GRADING, DRAINAGE & UTILITIES

project number drawing scale approver As indicated drawing number


GRAPHIC SCALE (IN FEET) 1 inch = 10 ft.

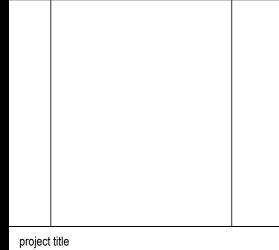

EXISTING LOT COVERAGE = (36.5%) 1,133.7 S.F. EXISTING OPEN SPACE = (22.3%) 692.6 S.F. PROPOSED LOT COVERAGE = (41.7%) 1,315.4 S.F. PROPOSED OPEN SPACE = (13.3%) 388.7 S.F. NOTES: THE EXISTING BUILDING AT # 30 IS TO BE REMOVED AND REPLACED WITH A NEW 3 STORY BUILDING. PROPOSED STORMWATER RECHARGE AREA PROPOSED STORMWATER OVERFLOW PROPOSED DRAINAGE DESIGNED BY CONNECTION TO STORM DRAIN "SITE ENGINEERING CONSULTANTS INC." S 33°30'00" W 36.50' 55 GRAPE SHOT ROAD SHARON, MA. 02141 PROPOSED ELEVATIONS BY "JOE THE ARCHITECT" 343 MEDFORD STREET SUITE4C MAINTAIN EXISTING # 14-16 SOMERVILLE, MA. 02145 19.6' ± WIDE VANDINE STREET CURB CUT PROPOSED PARKING EXISTING BUILDING 6"PVC 3 SPACES 9.0' X 18.0' ALL OFFSETS & DIMENSIONS TO THE EXISTING STRUCTURE (TYPICAL) ARE TO THE SIDING. ALL OFFSETS & DIMENSIONS C.L.F. S 33°30'00" W 36.50' TO THE PROPOSED STRUCTURE PROPOSED PLANTING AREA U-POLE ARE TO THE FOUNDATION. (POSSIBLE RAIN GARDEN) FENCE $U \stackrel{\searrow}{-} POLE$ BITUMINOUS LEGEND: PROPOSED 🔭 DRIVEWAY ~GRANITE CURB~ / PARKING ← TEST PIT PROPOSED CONCRETE ■ = CONC POST ~WALKWAY~ PROPOSED - = SIGN PROPOSED SECOND 1ST & 3RD FLOOR DECK G = GASFLOOR DECK LOT AREA = 3,102 S.F. W = WATERS = SEWERCB=CATCH BASIN C.L.F.=CHAIN LINK FENCE OHW=OVERHEAD WIRES PROPOSED 3-UNIT CONDOMINIUM FOUNDATION ~CONCRETE WALKWAY~ # 30 WALKOUT ELEV. = 56.6' BUILDING DRAWING PROPOSED BUILDING ELEVATIONS ARE BASED ON THE N.A.V.D. OF 1988 ROOF ELEV. = 48.1# 30 3 STORY N 33°30'00" E 36.50' WOOD FRAME PROPOSED WATER LINES TO BE CONNECTED TO EXISTING WATER LINE PER CITY OF CAMBRIDGE WATER DEPT. REQUIREMENTS. <u> BUILDING</u> THIRD FLOOR ELEV. = 37.1# 30 EXISTING w BERKSHIRE STREET BUILDING DRAWING # 28 BERKSHIRE STREET EXISTING BUILDING SECOND FLOOR ELEV. = 26.1' PROPOSED SEWER LINE TO BE CONNECTED TO EXISTING SEWER LINE PER CITY OF CAMBRIDGE D. P. W. REQUIREMENTS. ~CONCRETE WALKWAY~ N 33'30'00" E 36.50' FIRST FLOOR ELEV. = 15.1' U-POLE SIDEWALK ELEV. = 13.1~BITUMINOUS ROADWAY~ U-POLE BERKSHIRE STREET BERKSHIRE STREET RESIDENCE ~BITUMINOUS ROADWAY~ 30 Berkshire St., Cambridge, MA 02141 ~GRANITE CURB~ 🔾 Krissy Ellsworth, Denyce Wicht, Michael 30 Berkshire Street, Cambridge, MA **JOE** THE ARCHITECT somerville 343 Medford Street, Suite 4C Somerville, MA 02145 t: +1(617) 764-3593 e: info@joethearchitect.com website www.joethearchitect.com drawing title Dennis O'Brien P.L.S.

PROPOSED SITE PLAN

30 Berkshire St.

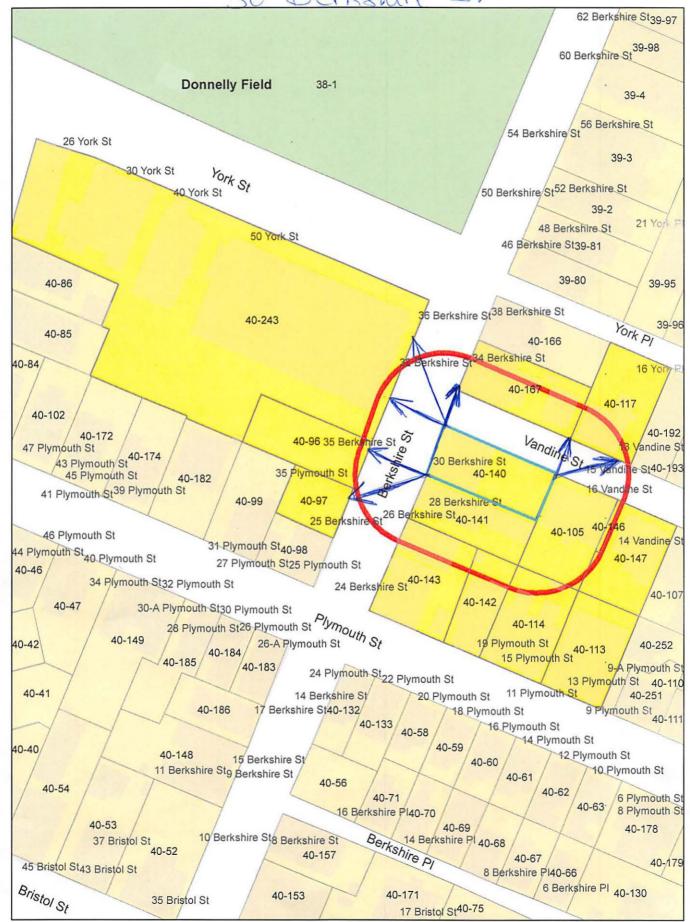

30 Berksline It

40-96 KHF PLYMOUTH LLC 1551 CENTRAL ST STOUGHTON, MA 02072

40-113 13 PLYMOUTH LLC 900 CUMMINGS DR., SUITE 215U BEVERLY, MA 01915

40-142 LUZ, HERCULANO F. & MARIA M. LUZ 19 PLYMOUTH ST CAMBRIDGE, MA 02141

40-167 GENTILE, JEAN F. A LIFE ESTATE 34 BERKSHIRE ST CAMBRIDGE, MA 02141

40-141
AL-RAWL, AHLAM, HASSAN, DUAA, & ALI
MOHAMMAD & CITY OF CAMBRIDGE TAX TITLE
28 BERKSHIRE ST., UNIT #2
CAMBRIDGE, MA 02141

40-140 WORKMAN, MICHAEL WHEELER 30 BERKSHIRE ST., #3 CAMBRIDGE, MA 02141

40-147 LEKSA, NINA CAROLINA 14 VANDINE ST., UNIT #3 CAMBRIDGE, MA 02141

40-146 CITY OF CAMBRIDGE C/O NANCY GLOWA CITY SOLICITOR 40-97
DELL'OLIO, RICHARD, ANDREW, LINDA, CARON
C/O 25-27 BERKSHIRE LLC
228 WESTERN AVE
CAMBRIDGE, MA 02139

40-114 PEONY REALTY, LLC 64 PARKER STREET NEWTON, MA 02459

40-143 BAIROS, JOAO DE ANDRADE 59 PLYMOUTH ST CAMBRIDGE, MA 02141

40-243
JAS CONSILIDATED PROPERTIES LLC C/O JAS CORPORATION
1035 CAMBRIDGE ST., #12
CAMBRIDGE, MA 02141

40-141 KING, MICHAEL ANTHONY 38 VAN HORN ST. WEST SPRINGFIELD, MA 01089

40-140 WICHT, DENYCE 218 THORNDIKE ST., #203 CAMBRIDGE, MA 02141

40-147 BUABBUD, GEORGE & JULIE BUABBUD 8 COUNTRY WAY SHREWSBURY, MA 01545

KRISSY M. ELLSWORTH, DENYCE WICHT MICHAEL WORKMAN 30 BERKSHIRE STREET CAMBRIDGE, MA 02141 NAVEM PARTNERS
C/O JAMES HEFFERMAN
18 NEWBURY STREET – 4TH FL.
BOSTON, MA 02116

40-117 JEAN SKOPETZ LLC 71 HINSTON RD EAST WEYMOUTH, MA 02189

40-105 ANNACONE, ANGELO L. AND MARION J. ANNACONE 2 HENRY STREET MEDFORD, MA 02155

40-141 JEFFREY, CHRISTINA C/O 28 BERKSHIRE STREET LLC 30 KATHERINE RD WATERTOWN, MA 02472

40-140
ELLSWORTH, KRISSY M.,RANDAL N. ELLSWORTH
& SILVIA E. ELLSWORTH
30 BERKSHIRE ST., UNIT #1
CAMBRIDGE, MA 02139

40-147 GREENE, BRIAN C. & VIRGINIA E. WALLACE 14 VANDINE ST., #1 CAMBRIDGE, MA 02141

40-146 CITY OF CAMBRIDGE C/O LOUIS DEPASQUALE, CITY MANAGER