

CITY OF CAMBRIDGE

BOARD OF ZONING APPEAL

831 Massachusetts Avenue, Cambridge MA 02139

617-349-6100

BZA Application Form

BZA Number: 272231

General Information


		Gene	<u>eral information</u>
The undersigned	hereby petitions	s the Board of Zonin	ng Appeal for the following:
Special Permit: _	X	Variance:	X Appeal:
PETITIONER: 4	2 tierney st IIc C	O Gerald mccarthy	
PETITIONER'S A	ADDRESS: 7 ne	bo , Medfield , Ma 0	2052
LOCATION OF P	ROPERTY: 41	<u> Fierney St , Cambr</u>	idge, MA
TYPE OF OCCU	PANCY: 1 family	!	ZONING DISTRICT: Residence B Zone
REASON FOR P	ETITION:		
DESCRIPTION	OF PETITION	ER'S PROPOSAL	. .
•			
Rebuild front stair	case to add heig	ght needed to enter	front doorway. Staircase is within the front yard setback
SECTIONS OF Z	ONING ORDINA	NCE CITED:	
Article: 5.000		Table of Dimension	
Article: 8.000 Article: 10.000		.d (Non-Conformino (Special Permit).	g Structure).
		Original	\mathcal{N}
		Signature(s):	(Petitioner (s) / Owner)
			Gerry Modelin-1
			(Print Name)
		Address:	11 Neboct Makend My
/ // />		Tel. No. E-Mail Address:	6176201863 ' ' ' ' ' ' ' ' ' ' ' ' ' ' ' ' ' ' '

BZA APPLICATION FORM - OWNERSHIP INFORMATION

To be completed by OWNER, signed before a notary and returned to The Secretary of the Board of Zoning Appeals.

I/We (CAN) J MCCANITY MANGE 4) TICING HOCK
Address: 11 NCBO ST MRDFIELD JA
State that I/We own the property located at 41 TIERNEY,
which is the subject of this zoning application.
The record title of this property is in the name of AI TIERNEY
*Pursuant to a deed of duly recorded in the date $\frac{911}{22}$, Middlesex South
County Registry of Deeds at Book 8/961, Page 227; or
Middlesex Registry District of Land Court, Certificate No. Book Page
SIGNATURE BY LAND OWNER OR AUTHORIZED TRUSTEE, OFFICER OR AGENT*
*Written evidence of Agent's standing to represent petitioner may be requested.
Commonwealth of Massachusetts, County of Middleser
The above-named Gorald J: McGatty personally appeared before me,
this $\frac{31}{100}$ of $\frac{100}{100}$, and made oath that the above statement is true.
Notary
My commission expires //20/w18 (Notary Seal). Glen F Sutherland Notary Public Commonwealth of Massachusetts Commission Exp. 01/20/2028

 If ownership is not shown in recorded deed, e.g. if by court order, recent deed, or inheritance, please include documentation.

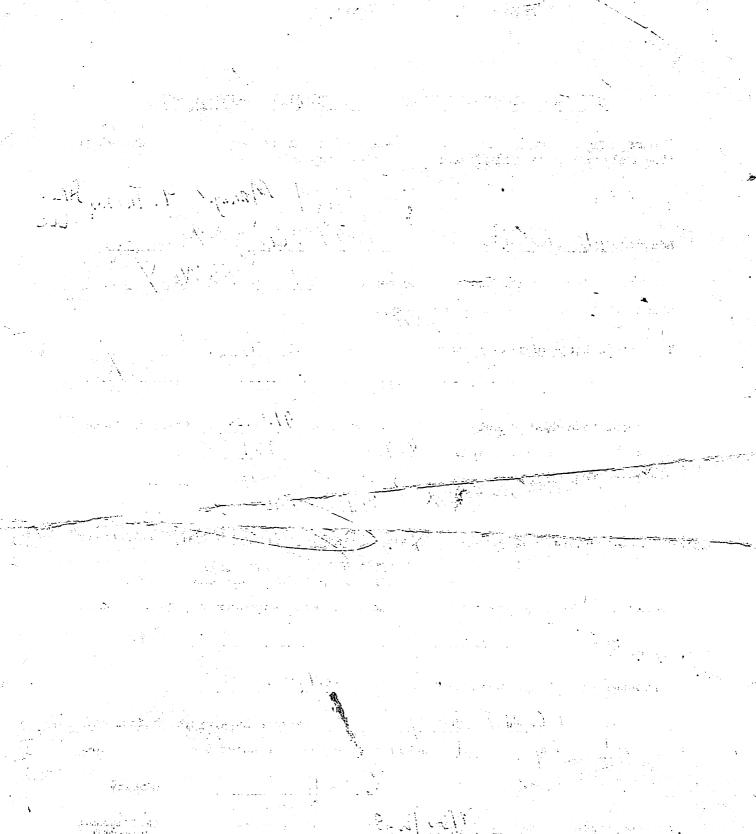

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BZA Application Form

SUPPORTING STATEMENT FOR A SPECIAL PERMIT

Please describe in complete detail how you meet each of the following criteria referring to the property and proposed changes or uses which are requested in your application. Attach sheets with additional information for special permits which have additional criteria, e.g.; fast food permits, comprehensive permits, etc., which must be met.

Granting the Special Permit requested for <u>41 Tierney St</u>, <u>Cambridge</u>, <u>MA</u> (location) would not be a detriment to the public interest because:

A) Requirements of the Ordinance can or will be met for the following reasons:

The existing staircase is being rebuilt in the same setback, there is no otherway to rebuild the stairs outside of the setback due to the position of the entrance to the house in the site. Even if we moved the front entrance with would be too significant of a cost, it would still be in the front yard setback. Hight and new location of staircase is non-conforming.

B) Traffic generated or patterns of access or egress would not cause congestion hazard, or substantial change in established neighborhood character for the following reasons:

The existing staircase is being rebuilt in the same setback, there is no otherway to rebuild the stairs outside of the setback due to the position of the entrance to the house in the site. Even if we moved the front entrance with would be too significant of a cost, it would still be in the front yard setback No matter where we put the stairs.

- The continued operation of or the development of adjacent uses as permitted in the Zoning Ordinance would not be adversely affected by the nature of the proposed use for the following reasons:
 - Slightly modifying existing staircase, height and location of proposed staircase that is non-conforming.
- Nuisance or hazard would not be created to the detriment of the health, safety, and/or welfare of the occupant of the proposed use or the citizens of the City for the following reasons:
 - Slightly modifying existing staircase, height and location of proposed staircase that is non-conforming. Proposed footprint is not much larger than existing.
- For other reasons, the proposed use would not impair the integrity of the district or adjoining district or otherwise derogate from the intent or purpose of this ordinance for the following reasons:
 - Slightly modifying existing staircase, height and location of proposed staircase that is non-conforming. Proposed footprint is not much larger than existing.

^{*}If you have any questions as to whether you can establish all of the applicable legal requirements, you should consult with an attorney.

BZA Application Form

SUPPORTING STATEMENT FOR A VARIANCE

EACH OF THE FOLLOWING REQUIREMENTS FOR A VARIANCE MUST BE ESTABLISHED AND SET FORTH IN COMPLETE DETAIL BY THE APPLICANT IN ACCORDANCE WITH MGL 40A, SECTION 10.

A) A literal enforcement of the provisions of this Ordinance would involve a substantial hardship, financial or otherwise, to the petitioner or appellant for the following reasons:

The existing staircase is being rebuilt in the same setback, there is no otherway to rebuild the stairs outside of the setback due to the position of the entrance to the house in the site. Even if we moved the front entrance with would be too significant of a cost, it would still be in the front yard setback. Height and location of staircase is non-conforming.

The hardship is owing to the following circumstances relating to the soil conditions, shape or topography of such land or structures and especially affecting such land or structures but not affecting generally the zoning district in which it is located for the following reasons:

THE EXISTING STAIRCASE IS BUILT IN THE FRONT YARD SETBACK BECAUSE OF THE PROXIMITY OF THE HOUSE TO THE STREET. THE ONLY WAY TO GAIN ACCESS TO THE FRONT DOOR IS BY VIOLATING THE FRONT YARD SET BACK DUE TO THE LOCATION OF THE HOUSE ON THE PROPERTY AND THE DISTRICTS SETBACK REQUIREMENTS

C) DESIRABLE RELIEF MAY BE GRANTED WITHOUT EITHER:

1) Desirable relief may be granted without substantial detriment to the public good for the following reasons:

THE PROPOSED STAIRCASE IS NOT A VASTLY DIFFERENT CHANGE FROM WHAT WAS THERE PREVIOUSLY, AND WILL BE A BEAUTIF NEW DESIGN WITH ATTRACTIVE MATERIALS RATHER THAN THE OLD PREVIOUS STAIRCASE.

Desirable relief may be granted without nullifying or substantially derogating from the intent or purpose of this Ordinance for the following reasons:

*HE ORGINAL STAIRCASE WAS NONCONFORMING, GRANTING RELIEF TO PLACE STAIRS BACK IN THE FRONT YARD SET BACK, WOULD NOT DEREGATE FROM THE INTENT OF THE ORDINANCE, BECAUSE THE STAIRS ARE GOING BACK IN SIMILAR LOCATION AND THIS WOULD BE BE ONLY FEASIBLE WAY TO ACCESS THE FRONT DOOR GIVEN THE LOCATION OF THE HOUSE ON THE LOT

*If you have any questions as to whether you can establish all of the applicable legal requirements, you should consult with an attorney.

BZA Application Form

DIMENSIONAL INFORMATION

Applicant: Location:

42 tierney st llc

41 Tierney St, Cambridge, MA

Phone:

6176201863

Present Use/Occupancy: 1 family

Zone: Residence B Zone

Requested Use/Occupancy: 1 family

		Existing Conditions	Requested Conditions	<u>Ordinance</u> <u>Requirements</u>	
TOTAL GROSS FLOOR AREA:		3284	3284	1577	(max.)
LOT AREA:		3154	3154	5000	(min.)
RATIO OF GROSS FLOOR AREA TO LOT AREA: ²		1.04	1.04	.5	
LOT AREA OF EACH DWELLING UNIT		3154	3154	2500	
SIZE OF LOT:	WIDTH	53.29	53.29	50	
	DEPTH	60	60	nA	
SETBACKS IN FEET:	FRONT	1	1	10	
	REAR	5.8	5.8	20	
	LEFT SIDE	8.3	8.3	7.5	
	RIGHT SIDE	15.5	12	11.7	
SIZE OF BUILDING:	HEIGHT	26	26	35	
	WIDTH	46	46	Na	
	LENGTH	36.2	36.2	Na	
RATIO OF USABLE OPEN SPACE TO LOT AREA:		1989	1980	1577	
NO. OF DWELLING UNITS:		1	1	1	
NO. OF PARKING SPACES:		2	2	0	
NO. OF LOADING AREAS:		0	0	0	
DISTANCE TO NEAREST BLDG. ON SAME LOT	·	Na	Na	Na	

Describe where applicable, other occupancies on the same lot, the size of adjacent buildings on same lot, and type of construction proposed, e.g; wood frame, concrete, brick, steel, etc.:

None

- 1. SEE CAMBRIDGE ZONING ORDINANCE ARTICLE 5.000, SECTION 5.30 (DISTRICT OF DIMENSIONAL REGULATIONS).
- 2. TOTAL GROSS FLOOR AREA (INCLUDING BASEMENT 7'-0" IN HEIGHT AND ATTIC AREAS GREATER THAN 5') **DIVIDED BY LOT AREA.**
- 3. OPEN SPACE SHALL NOT INCLUDE PARKING AREAS, WALKWAYS OR DRIVEWAYS AND SHALL HAVE A MINIMUM **DIMENSION OF 15'.**

ADDL	ADDITIONAL	MANUF OR MFR	MANUFACTURER
ALT	ALTERNATE	MATL	MATERIAL
AFF	ABOVE FINISH FLOOR	MAX	MAXIMUM
ASTM	AMERICAN SOCIETY FOR TESTING	MECH	MECHANICAL
7.01111	AND MATERIALS	MEMB	MEMBRANE
AWS	AMERICAN WELDING SOCIETY	MEP	MECHANICAL EQUIPMENT PAD
AB	ANCHOR BOLT	MID	MIDDLE
& OR	AND	MID-PT	MID-POINT
APPROX	APPROXIMATELY	MIN	MINIMUM
ARCH	ARCHITECT OR ARCHITECTURAL	MR	MOISTURE RESISTANT
@	AT		
		NFPA	NATIONAL FOREST PRODUCTS
BAL	BALANCE		ASSOCIATION
BETW	BETWEEN	NOM	NOMINAL
BM	BEAM	NWC	NORMAL WEIGHT CONCRETE
BRG	BEARING	N	NORTH
BLK	BLOCK	NIC	NOT IN CONTRACT
B OR BOT	BOTTOM	NTS	NOT TO SCALE
BEW	BOTTOM EACH WAY	NO OR #	NUMBER
BRKT	BRACKET		
BLDG	BUILDING	OC	ON CENTER
		OPNG	OPENING
CIP	CAST-IN-PLACE	OPP	OPPOSITE
CTRD	CENTERLINE	OD	OUTSIDE DIAMETER
	CENTERLINE	OF	OUTSIDE FACE
CLR	CLEAR	P.T.	PRESSURE TREATED
COL	COLUMN	PT	POINT
CONC	CONCRETE	PTD	PAINTED
CMU	CONCRETE MASONRY UNIT	PTB	POST-TENSIONED BAR
CONST	CONSTRUCTION	PSF	POUNDS PER SQUARE FOOT
CONSTJT OR (CONSTRUCTION JOINT	PSI	POUNDS PER SQUARE INCH
CONT	CONTINUOUS	PVC	POLYVINYL CHLORIDE
CJ	CONTROL JOINT	P/C	PRECAST CONCRETE
DET	DETAIL		
DIA OR Ø	DIAMETER	R	RADIUS
DIM	DIMENSION	REF	REFERENCE
DN	DOWN	REINF	REINFORCE, REINFORCING OR REINFORCEMENT
DWG	DRAWING	REQD	REQUIRED
DVVO	DIVIVIIIO	RD	ROOF DRAIN
			TOO! DIVIN
EA	EACH	S	SEALANT
ELECT	ELECTRICAL	SCH OR SCHED	SCHEDULE
EL OR 🕀	ELEVATION	SECT	SECTION
ELEV	ELEVATOR	SH	SHEET
EMBED	EMBEDMENT	SIM	SIMILAR
EQ	EQUAL	SOG	SLAB ON GRADE
EQUIP	EQUIPMENT	S	SOUTH
EXIST	EXISTING	SPECS	SPECIFICATIONS
EXP BOLT	EXPANSION BOLT	SPKR	SPRINKLER
EJ OR EXP JT	EXPANSION JOINT	SQ	SQUARE
EXT	EXTERIOR	STN STL	STAINLESS STEEL
	511 HOLL 54 OF	STD	STANDARD
FF	FINISH FACE	STL	STEEL
FT FIN	FEET OR FOOT FINISH	ST STL	STAINLESS STEEL
FIN FL	FINISHED FLOOR	STRUCT	STRUCTURAL
FPRF	FIREPROOF	SYM	SYMMETRICAL
FL	FLOOR	TEMP	TEMPERATURE OR
FD	FLOOR DRAIN	TEMP	TEMPORARY
FTG	FOOTING	THK	
FDN	FOUNDATION		THICK OR THICKNESS
GA	GAGE OR GAUGE	X	TIMES OR BY
GALV	GALVANIZED	TO T&B	TOP OF TOP AND BOTTOM
GWB or GYP	GYPSUM WALL BOARD	TOC	TOP OF CURB or CONCRETE
HGT	HEIGHT	TOS	TOP OF CORB OF CONCRETE
H OR HORIZ	HORIZONTAL	TOW	TOP OF WALL
HDR	HEADER	TYP	TYPICAL
INFO	INFORMATION	UNO	UNLESS NOTED OTHERWISE
INCL	INCLUDING OR INCLUSIVE		
ID	INSIDE DIAMETER	V OR VERT	VERTICAL
IF INSUL	INSIDE FACE INSULATION	VIF	VERIFY IN FIELD
INT	INTERIOR	W	WEST
INV	INVERT	WWPA	WESTERN WOOD PRODUCTS
JT	JOINT		ASSOCIATION
		W/	WITH
LWC	LIGHT WEIGHT CONCRETE	W/O	WITHOUT
LBS	POUNDS	WP	WORKING POINT

WORKING POINT

WP

TIERNEY STREET RESIDENCE

41 Tierney St., Cambridge, MA 02138

CODE ANALYSIS:

 APPLICABLE CODES BUILDING CODE: IRC 2015 & 780 CMR MASSACHUSETTS STATE BLDG CODE 9TH EDITION **ENERGY CODE: IECC 2021**

FIRE PREVENTION & ELECTRICAL CODE: 527 CMR

2. ZONING DISTRICT - RESIDENCE B

SETBACKS:			
	<u>ALLOWED</u>	EXISTING	PROPOSED
*FRONT:	25'	8'	NO CHANGE
RIGHT:	7.6"(SUM OF 20)	15.5'	NO CHANGE
LEFT:	7.6"(SUM OF 20)	8.3'	NO CHANGE
*REAR:	NA	NA	NA
HEIGHT:	35'	26'	NO CHANGE

*TIERNEY ST AND ORRIN ST ARE FRONT YARD SETBACKS. REAR YARD SETBACK DOES NOT APPLY.

F.A.R.: .5 LOT SIZE: 3,154 SF ALLOWED: 1,577 GSF EXISTING: 2.364GSF PROPOSED: 3,284 GSF (F.A.R.: 1.04) **BASEMENT: 957 GSF** FIRST FLOOR: 1,174 GSF SECOND FLOOR: 1,153 GSF

MECH/STORAGE/LAUNDRY: 224 GSF (NOT INCLUDED IN F.A.R.)

3. USABLE OPEN SPACE REQUIREMENTS: 50% REQUIRED U.O.S.: 1,577 SF PROPOSED U.O.S.: 1,980 SF (62.7%)

4. CHAPTER 3 - USE GROUP CLASSIFICATION :

SECTION 310.0 - R3 5. IECC CHAPTER 4

> R401.2.1 PRESCRIPTIVE COMPLIANCE OPTION R401 - BUILDING PERFORMANCE OPTION R404 - ELECTRICAL POWER AND LIGHT SYSTEM R408 - ADDITIONAL EFFICIENCY OPTIONS

225 CMR 22 - ENVELOPE REQUIREMENTS:

1.EXTERIOR WALLS:

2X6 WOOD FRAMING R30 MIN CAVITY OR R20 CAVITY W/ R5 CONTINUOS or R13 MIN CAVITY W/ 10R CONTINUOS or R20 CONTINUOS

BASEMENT: R15 CONTINUOUS OR R19 CAVITY W/ R5 CONTINUOS

2. VAPOR RETARDER:

CLASS I OR II AT INTERIOR/WARM SIDE OF EXTERIOR WALL FRAMING

2. FLOOR OVER UNCONDITIONED SPACE:

R30 MINIMUM 3. BASEMENT SLAB:

R10 CONTINUOS @ <4' BELOW GRADE

4. CEILING/ROOF R60 MINIMUM

5. WINDOWS:

DOUBLE PANE LOW E MIN. U-FACTOR: .30 6. EXTERIOR DOORS WITH GLAZING: DOUBLE PANE LOW E

MIN. U-FACTOR: .40


SYMBOL LEGEND

EXISTING WALL EXISTING WALL TO BE REMOVED

1HR RATED PARTITION (UL DESIGN U309) **EXISTING DOOR** PROPOSED DOOR

EXISTING DOOR TO BE REMOVED

Room name **ROOM TAG**

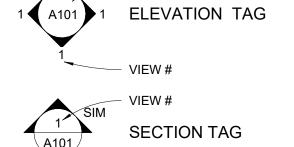

COMBO SMOKE/CO DETECTOR -KIDDE I12010SCO

COMBO SMOKE/CO DETECTOR (PHOTOELECTRIC) KIDDE KN-COPE-IC

A000	TITLE SHEET
A100	DEMO PLANS
A101	BASEMENT & 1ST FLOOR PLANS
A102	2ND FLOOR & ROOF PLAN
A200	PROPOSED ELEVATIONS
A201	EXISTING ELEVATIONS
S101	FOUNDATION & 1ST FLOOR FRAMING PLAN
S102	2ND FLOOR & ROOF FRAMING PLANS
S103	ENGINEERED FRAMING DETAILS

GENERAL NOTES:

- 1. WORK SHALL COMPLY WITH FEDERAL, STATE AND LOCAL BUILDING CODES AND REGULATIONS. UNLESS OTHERWISE AGREED UPON, THE CONTRACTOR IS RESPONSIBLE FOR SECURING ALL BUILDING PERMITS AS REQUIRED TO PERFORM HIS OR HER WORK AND WILL RETAIN AND PAY FOR ALL REQUIRED INSPECTIONS FOR THE DURATION OF CONSTRUCTION.
- 2. CONTRACTOR SHALL VERIFY ALL EXISTING CEILINGS AND EGRESS STAIRS ARE 1HR FIRE RATED. SINGLE LAYER OF PLASTER OR 5/8" GWB EACH SIDE OF INTERIOR PARTITION (UL DESIGN# L305), SINGLE 5/8" AT CEILINGS (UL DESIGN# L512). ALL REPLACEMENT PATCHING OR REPAIRING IS THE RESPONSIBILITY OF CONTRACTOR. CONTACT ARCHITECT IF RATING IS BELIEVED TO BE INHERENT IN EXISTING ASSEMBLY.
- 3. CONTRACTOR SHALL ENGAGE A LICENSED ELECTRICIAN FOR ALL
- 4. CONTRACTOR RESPONSIBLE FOR ALL PREPARATION WORK REQUIRED BY MANUFACTURER'S SPECIFICATIONS.
- 5. CONTRACTOR SHALL PROVIDE PRODUCT SUBMITTAL FOR SMOKE ALARM FIXTURES FOR APPORVAL
- 6. CONFLICTS BETWEEN SITE CONDITIONS AND DRAWINGS SHALL BE BROUGHT TO THE IMMEDIATE ATTENTION OF THE ARCHITECT OR THE APPROPRIATE
- 7. CONFIRM DIMENSIONS WITH THE ARCHITECT OR APPROPRIATE
- 8. CONTRACTOR TO NOTIFY ARCHITECT, AFTER LAYOUT AND PRIOR TO FRAMING, OF ANY DISCREPANCY, OMISSION, OR UNANTICIPATED FIELD CONDITIONS ALTER
- 9. CONTRACTOR TO NOTIFY ARCHITECT, AFTER LAYOUT AND PRIOR TO FRAMING IF DIMENSIONS INDICATED WITH "+/-" VARIES MORE THAN 3" FROM ACTUAL FIELD MEASURMENTS.
- 11. DAMAGED TO EXISTING OR NEW CONSTRUCTION CAUSED BY THE CONTRACTOR. HIS OR HER SUB-CONTRACTORS OR CREW IS THE RESPONSIBILITY

DRAWING LIST

SHEET# SHEET NAME

ELECTRICAL WORK AND IN COMPLIANCE WITH NFPA 70.

- CONSULTING ENGINEERS.
- CONSULTING ENGINEER.
- THE DESIGN INTENT.
- 10. CONTRACTOR RESPONSIBLE FOR ALL PREPARATION WORK REQUIRED BY MANUFACTURER'S SPECIFICATIONS.
- OF THE CONTRACTOR.

2" WOOD STUD FURRED (0HR)

DRAWING TITLE:

REVISIONS:

2 ISD REQUEST 11.8.23

ARCHITECT

suite #30

PROJECT:

Tierney St Residence

41 Tierney St

CLIENT:

275 Main St

Boston, MA 02129

PROJECT TEAM:

Cambridge, MA 02138

River Front Realty

S47 a

517 boston post rd

sudbury, ma 01776 p: 508.500.4730 www.s47a.com

TITLE SHEET


STAMP



CONSTRUCTION DOCUMENT PHASE

<u>As indicated</u>

DRAWING NUMBER:

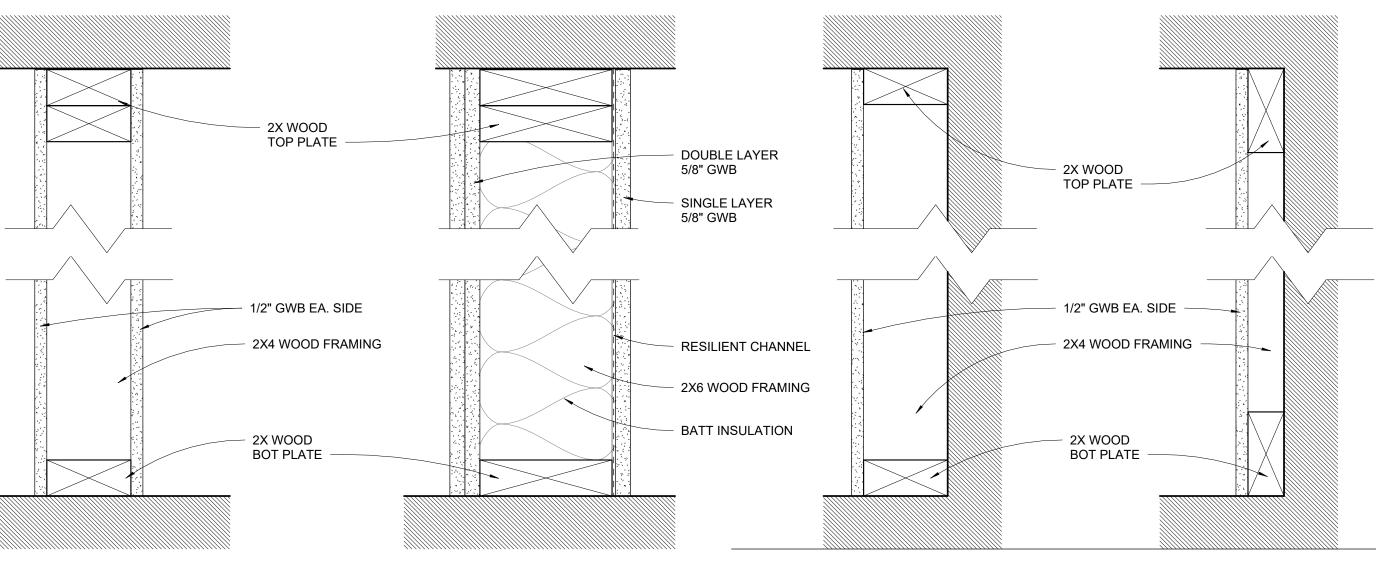

WOOD STUD FIRE RATED (1HR, STC 50)

UL #U305


4" WOOD STUD FURRED (0HR)

> PARTITION TYPES 3" = 1'-0"


WOOD STUD (0HR)

LBS

POUNDS

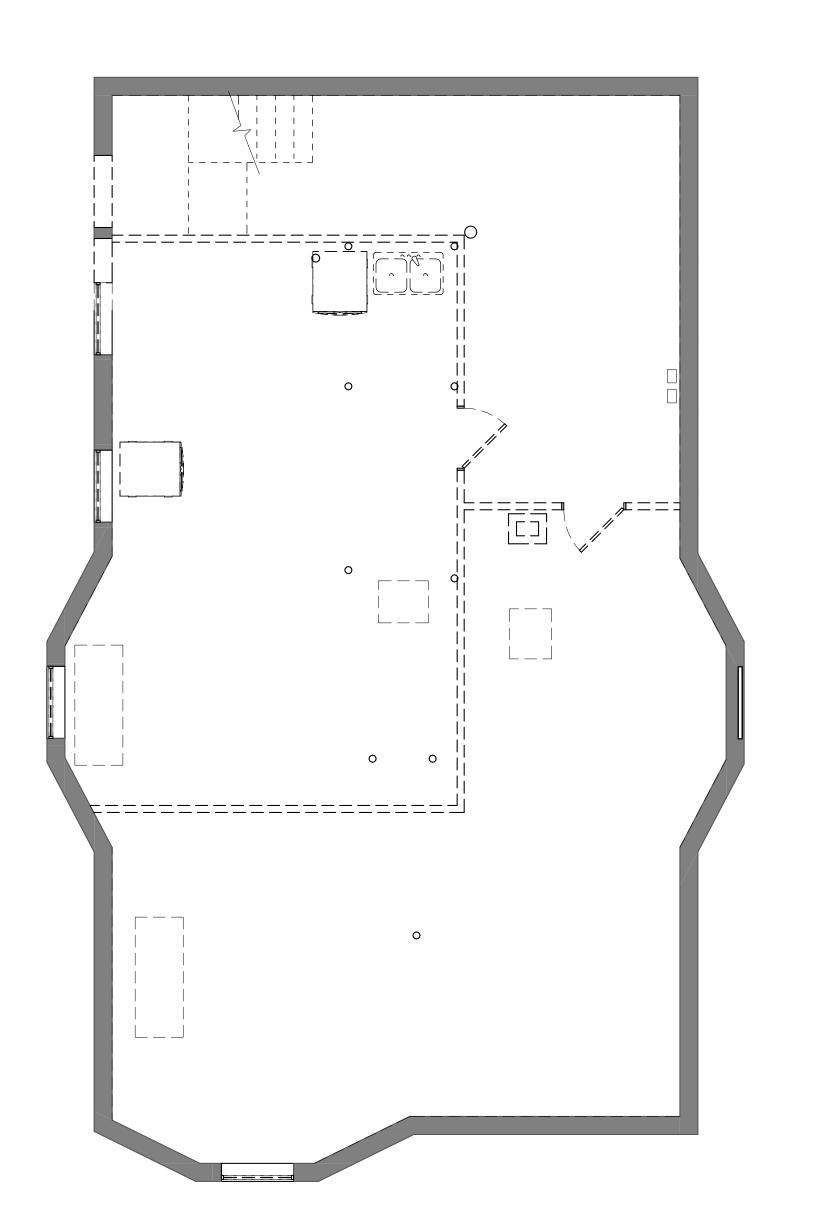

1 DEMO - BASEMENT 1/4" = 1'-0"

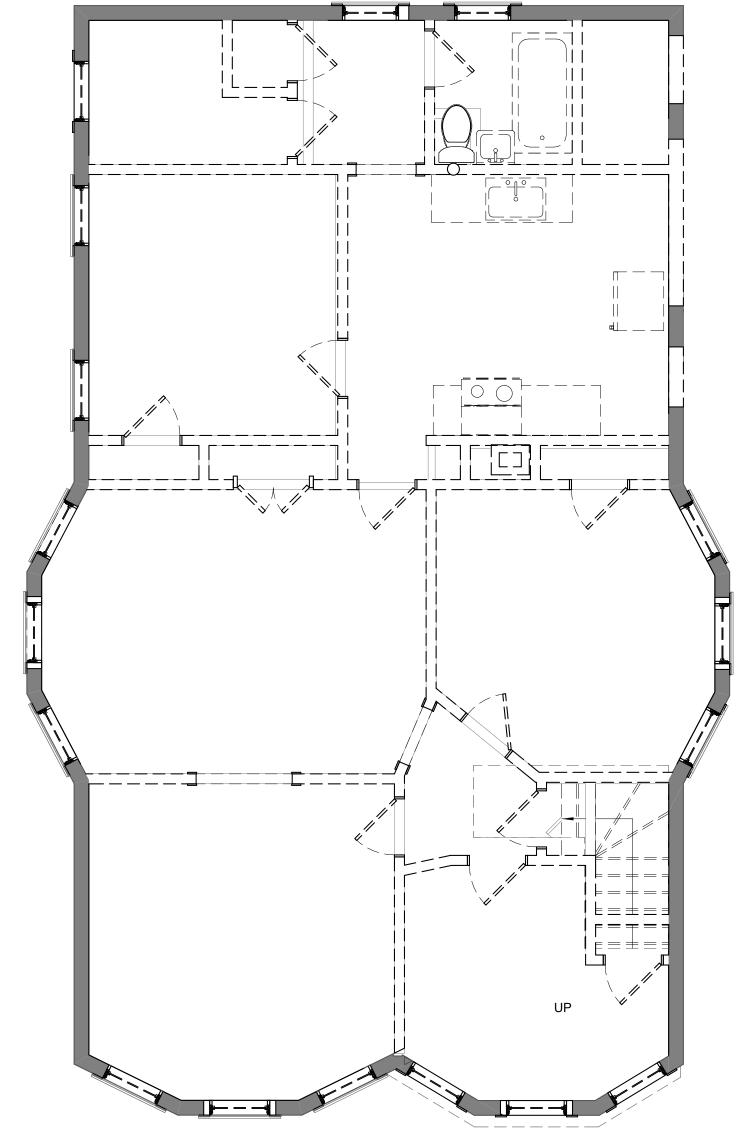

EXISTING WALL TO REMAIN [_ _ _ _ _] EXISTING WALL TO BE REMOVED ``忙」 EXISTING DOOR TO BE REMOVED

DEMO NOTES:

- EXISTING CEILING, FLOOR AND WALL FINISHES TO BE REMOVED AND EXISTING FRAMING EXPOSED.
- 2. EXISTING NON LOAD BEARING INTERIOR WALLS TO BE REMOVED.
- 3. EXISITNG DOORS AND WINDOWS TO BE REMOVED.
- 4. EXISTING PLUMBING AND PLUMBING FIXTURES TO BE REMOVED. 5. EXISTING ELECTRICAL WIRING AND FIXTURES.
- 6. EXISTING FIXTURES, CASEWORK, APPLIANCES TO BE REMOVED.

CLIENT:

ARCHITECT

suite #30

PROJECT: Tierney St

Residence

Cambridge, MA 02138

41 Tierney St

517 boston post rd

sudbury, ma 01776 p: 508.500.4730 www.s47a.com

River Front Realty


275 Main St Boston, MA 02129

PROJECT TEAM:

REVISIONS:

DRAWING TITLE:

DEMO PLANS

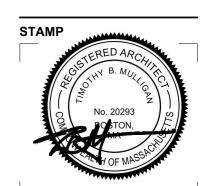



October 12, 2023
DATE OF ISSUE

CONSTRUCTION DOCUMENT PHASE

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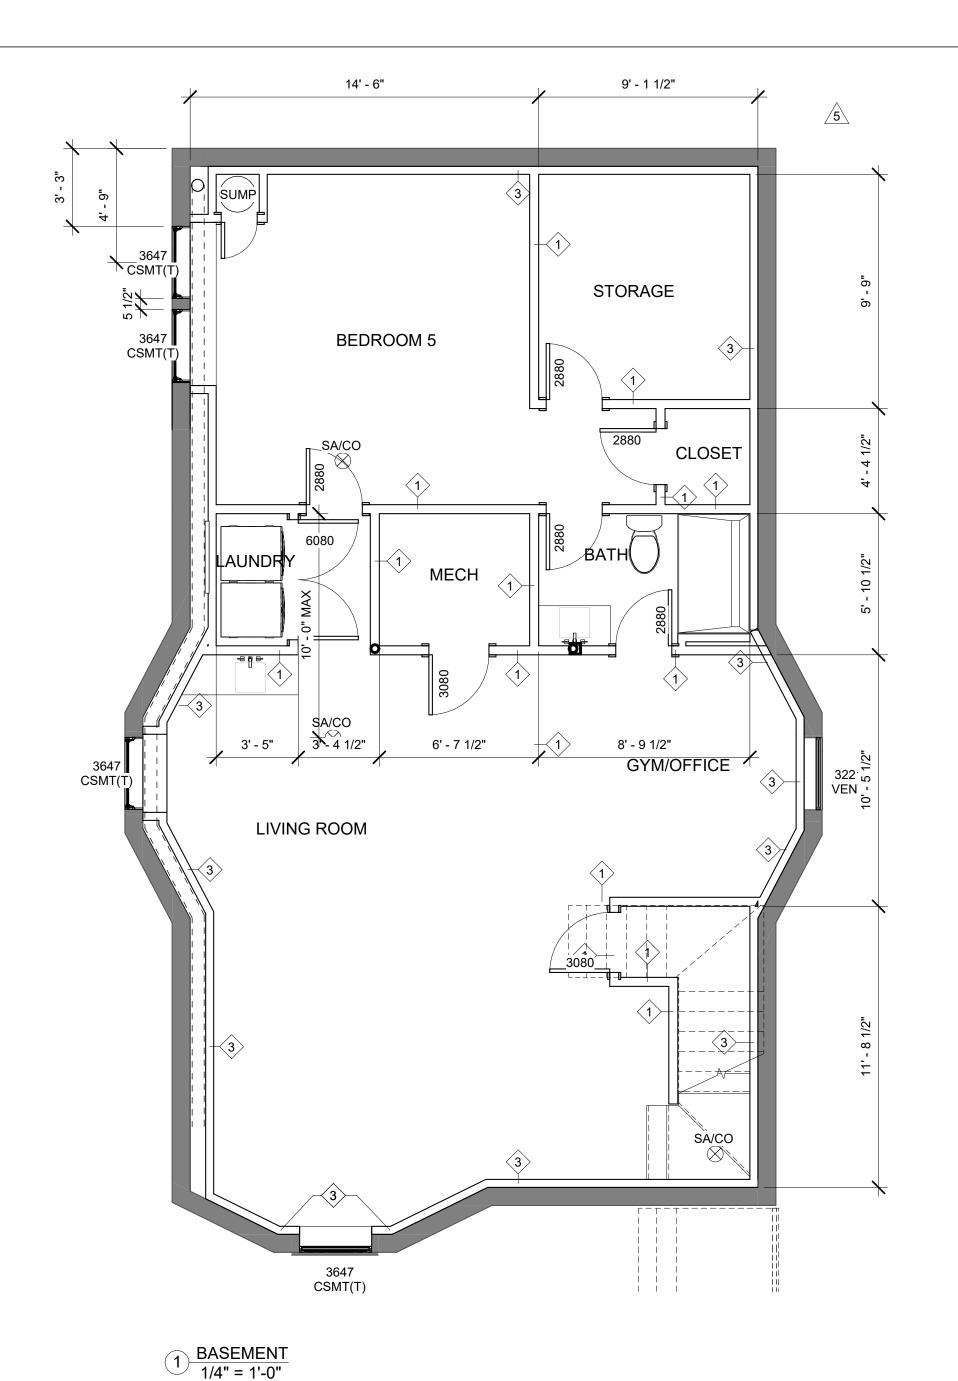
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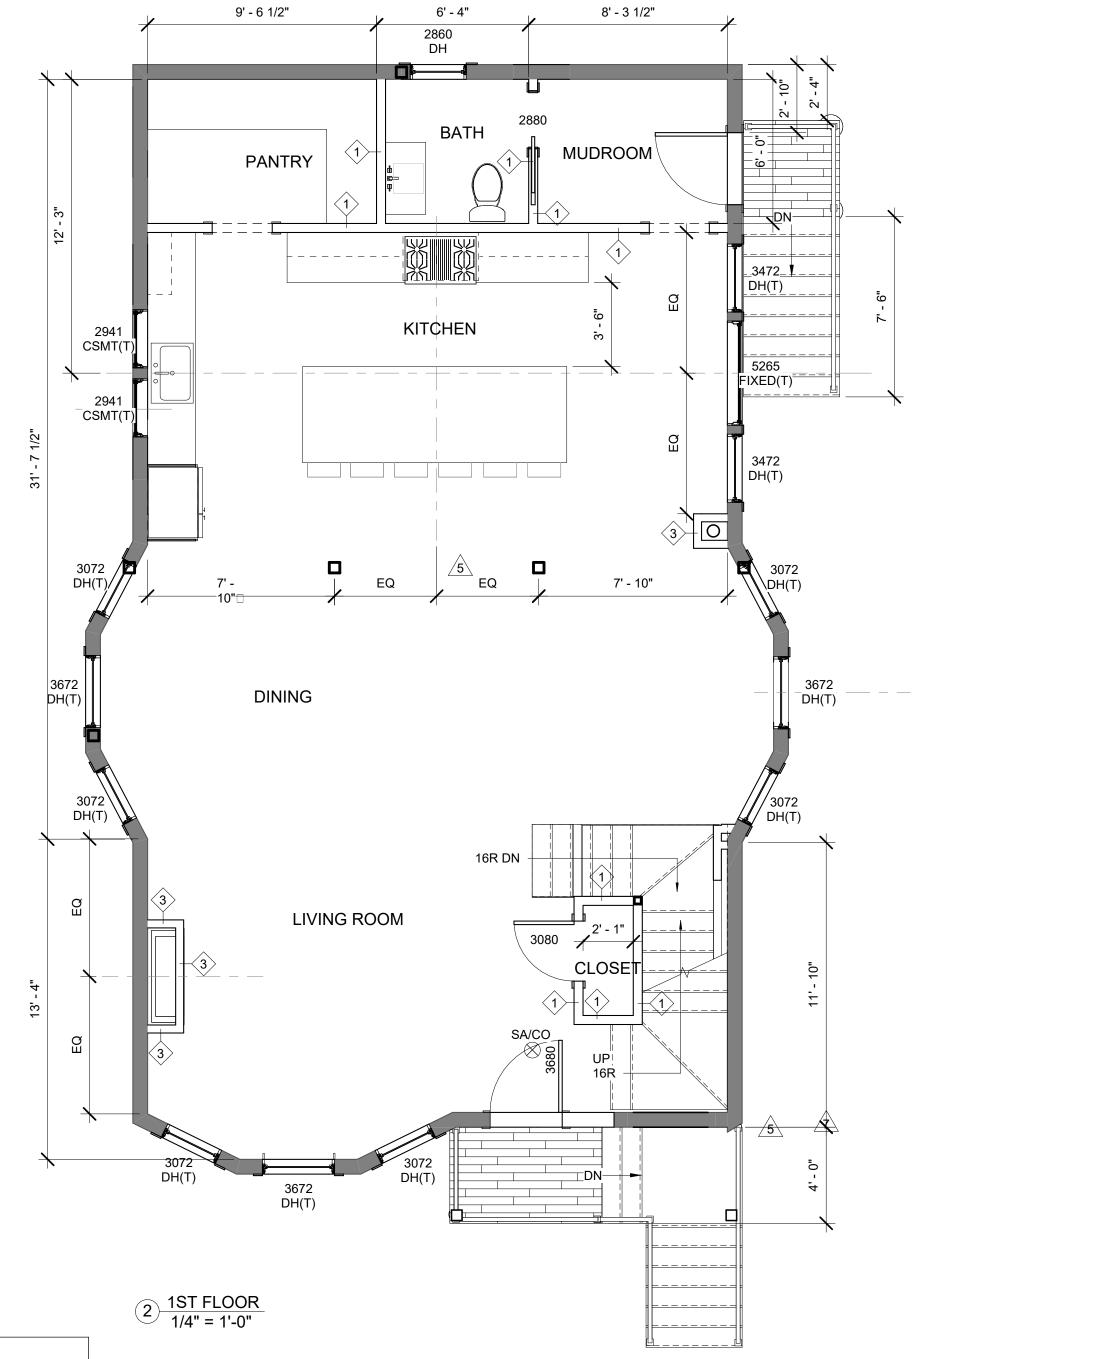


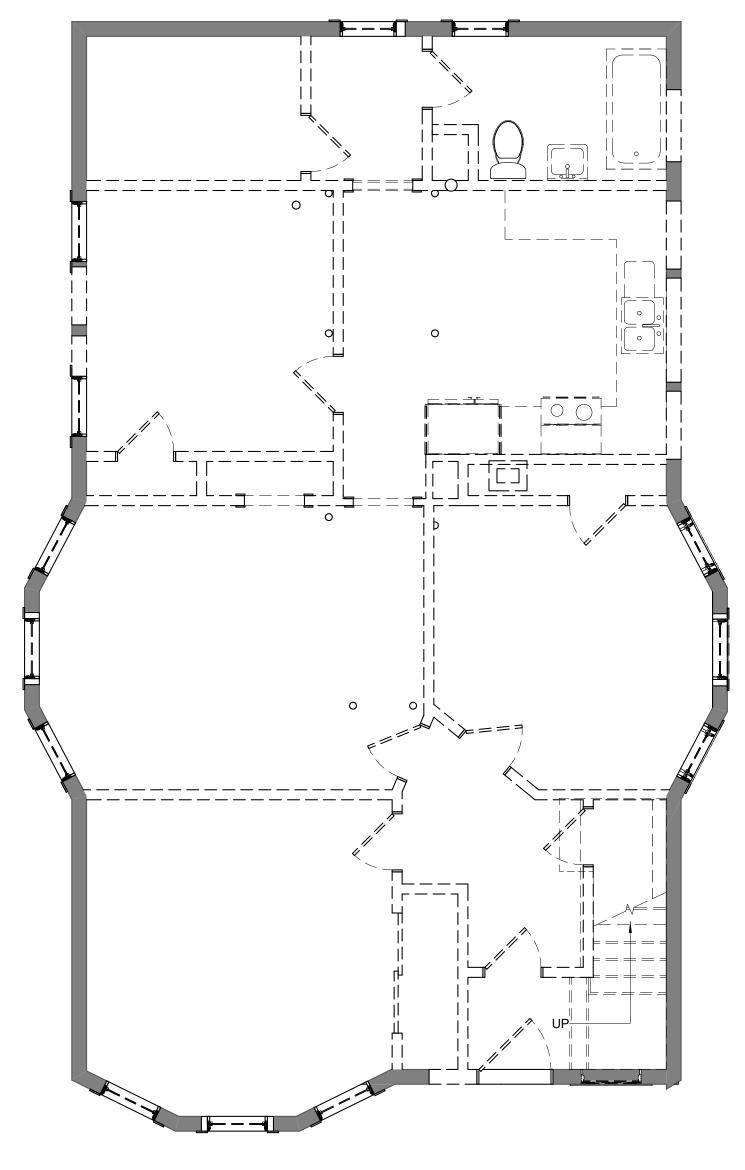

2 DEMO - 1ST FLOOR 1/4" = 1'-0"

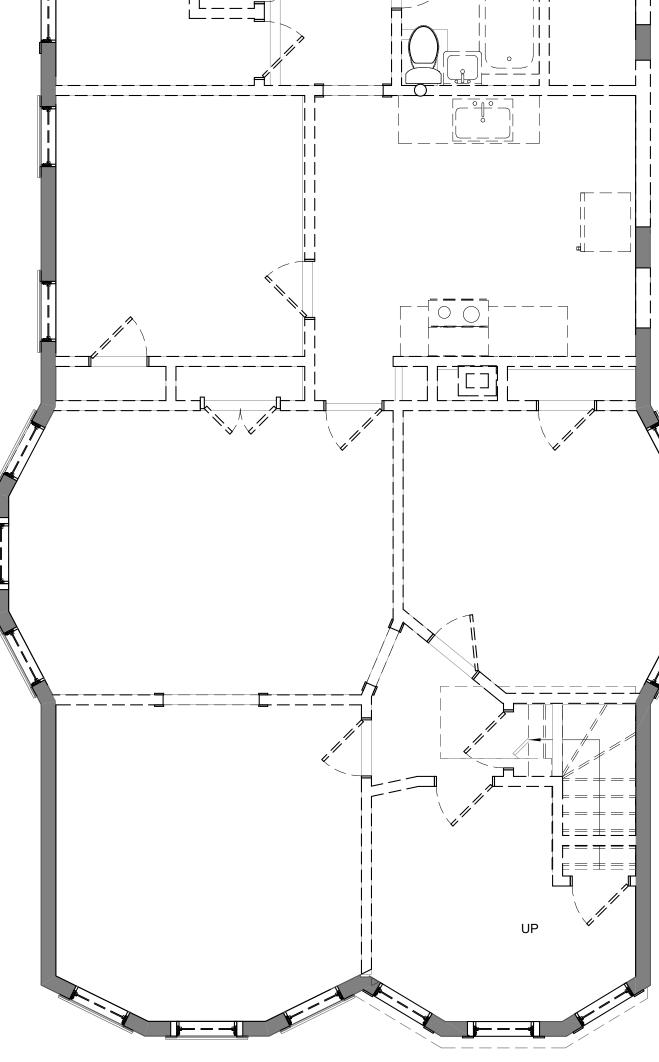3 <u>DEMO - 2ND FLOOR</u> 1/4" = 1'-0"





PLUMBING FIXTURE COUNT								
FIXTURE	BSMT	1ST FLR	2ND FLR	TOTAL				
SINK	2	2	4	9				
TOILET	2	1	3	6				
SHOWER	1	0	3	4				
LAUNDRY	0	1	0	1				
TOTAL FIX	TURE C	TNUC		20				

CS-WSP	See	Exterior sheathing per Table R602.3(3)	6" edges 12" field
wood structural panel	³ / ₈ "	Interior sheathing per Table R602.3(1) or R602.3(2)	Varies by fastener

TABLE R602.3(3) REQUIREMENTS FOR WOOD STRUCTURAL PANEL WALL SHEATHING USED TO RESIST WIND PRESSURES^{a, b, c}

MINIMUM NAIL		MINIMUM WOOD STRUCTURAL	MINIMUM NOMINAL MAXIMUM WALL PANEL STUD SPACING	PANEL NAIL SPACING		ULTIMATE DESIGN WIND SPEED Vult (mph)				
Size	Penetration (inches)	PANEL SPAN RATING	THICKNESS (inches)	(inches)	Edges (inches o.c.)	Field (inches o.c.)	Wind e	xposure c	ategory D	
6d Common (2.0" × 0.113")	1.5	24/0	3/8	16	6	12	140	115	110	
8d Common	1.75	24/16	7/16	16	6	12	170	140	135	
(2.5" × 0.131")	1./5	1.75 24/16		1/16	24/16	24	6	12	140	115

For St. 1 inch = 25.4 mm, 1 mile per hour = 0.447 m/s.

- a. Panel strength axis parallel or perpendicular to supports. Three-ply plywood sheathing with study spaced more than 16 inches on center shall be applied with panel strength axis perpendicular to supports.
- b. Table is based on wind pressures acting toward and away from building surfaces in accordance with Section R301.2. Lateral bracing requirements shall be in accordance with Section R602.10.
- c. Wood structural panels with span ratings of Wall-16 or Wall-24 shall be permitted as an alternate to panels with a 24/0 span rating. Plywood siding rated 16 o.c. or 24 o.c. shall be permitted as an alternate to panels with a 24/16 span rating. Wall-16 and Plywood siding 16 o.c. shall be used with study spaced not more than 16 inches on center.

RETURN PANEL BRACED WALL LINE BRACED WALL PANEL AT END OF BRACED WALL LINE END CONDITION 1	HOLD- DOWN DEVICE——BRACED WALL PANEL AT END OF BRACED WALL LINE END CONDITION 2
AB" MINIMUM BRACED WALL PANEL AT END OF BRACED WALL LINE END CONDITION 3	RETURN D' MAX FIRST BRACED WALL PANEL * SEE REQUIREMENTS END CONDITION 4
CONTINUOUSLY SHEATHED BRACED WALL LINE	REQUIREMENTS Return panel: 24" for braced wall lines sheathed with wood structural panels 32" for braced wall lines sheathed with structural fiberboard Distance D: 24" for braced wall lines sheathed with wood structural panels 32" for braced wall lines sheathed with structural fiberboard
HOLD-DOWN FIRST BRACED WALL PANEL END CONDITION 5	Hold-down 800 lbs capacity fastened to the edge of the braced wall panel closest to the corner and to the foundation or floor framing below

GENERAL NOTES:

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- 2. CONTRACTOR SHALL ENGAGE A LICENSED ELECTRICIAN FOR ALL ELECTRICAL WORK AND IN COMPLIANCE WITH NFPA 70.
- 3. CONTRACTOR RESPONSIBLE FOR ALL PREPARATION WORK REQUIRED BY MANUFACTURER'S SPECIFICATIONS.
- 4. CONTRACTOR SHALL PROVIDE PRODUCT SUBMITTAL FOR SMOKE ALARM FIXTURES FOR APPORVAL
- 5. CONFLICTS BETWEEN SITE CONDITIONS AND DRAWINGS SHALL BE BROUGHT TO THE IMMEDIATE ATTENTION OF THE ARCHITECT OR THE APPROPRIATE CONSULTING ENGINEERS.
- 6. CONFIRM DIMENSIONS WITH THE ARCHITECT OR APPROPRIATE CONSULTING ENGINEER.
- 7. CONTRACTOR TO NOTIFY ARCHITECT, AFTER LAYOUT AND PRIOR TO FRAMING, IF DIMENSIONS INDICATED WITH "+/-" VARIES MORE THAN 3" FROM ACTUAL FIELD MEASURMENTS.
- 8. CONTRACTOR RESPONSIBLE FOR ALL PREPARATION WORK REQUIRED BY MANUFACTURER'S SPECIFICATIONS.
- 9. DAMAGED TO EXISTING OR NEW CONSTRUCTION CAUSED BY THE CONTRACTOR, HIS OR HER SUB-CONTRACTORS OR CREW IS THE RESPONSIBILITY OF THE CONTRACTOR.
- 10. SLEEPING ROOM EMERGENCY ESCAPE & RESCUE REQUIREMENTS: MINIMUM ONE WDW PER BEDROOM:

5.7SF OPERABLE CLEAR AREA, 44" MAX SILL HGT

BRACED WALL NOTES:
THE FOLLOWING NOTES APPLY TO ALL EXTERIOR AND INTERIOR WALLS AND COMPLY WITH SECTION R602.10 FOR CONTINUOS SHEATHING WALL BRACING METHOD.

EXTERIOR WALLS:
1. 2X6 WOOD FRAMING @ 16" O.C. SGLE BOTTOM PLATE, DBL TOP PLATE. FASTEN SILL PLATE TO RIM JOIST W/ 3-16d NAILS @ 16" O.C. FASTEN TOP PLATE TO RIM JOIST W/ 8d NAILS @ 16" O.C.

2. MIN DBL TOP PLATE SPLICING SHALL BE 3" X 6" X .036" GALV STEEL PLATE FASTENED W/ (6) 8d BOX (2 1/2" X .113") NAILS EA SIDE OF SPLICE PER TABLE R602.3.2

3.FLOOR SILL PLATES TO BE ANCHORED TO FOUNDATION W/ MIN 1/2" ANCHOR BOLTS @ 6'-0" O.C. MAX., 7" MIN EMBED PER R403.1.6

4. CONTINOUS SHEATHING WOOD STRUCTURAL PANELS (CS-WSP) SHALL BE MIMIMUM 3/8" PER IRC TABLE 602.10.4.

5. CS-WSP SHEATHING SHALL BE FASTENED WITH 6d COMMON NAILS, MIN 1.5" PENETRATION, 6" O.C. EDGE AND 12" O.C. FIELD PER IRC IRC TABLE R602.73(3)

6.CS-WSP TO BE INSTALLED ON SHEATHABLE SURFACES INCLUDING AREAS ABOVE AND BELOW OPENINGS AND GABLE END WALLS.

7. CS-WSP SHEATHING SHALL OVERLAP OVER FLOOR FRAMING OR

FOUNDATION PER IRC R602.10.8

8. INSTALL 800LB HOLD DOWN DEVICE (SIMPSON LTTI-31 OR EQUAL) AT EACH END OF EXTERIOR CORNER PER END CONDITION #2 ON TABLE R602.10.7


9. INSTALL UPLIFT CONNECTORS (SIMPSON H2.5 OR EQUAL) AT EXTERIOR WALLS SUPPORTING ROOF FRAMING.

10. INSTALL MIN 1/2" GWB AT INTERIOR SIDE OF EXTERIOR WALLS FASTENED W/ NAILS OR SCREWS PER TABLE R702.3.5 AND 7" O.C. EDGES AND 7" O.C. FIELD.

INTERIOR PARTITIONS: 11. 2X4 MIN WOOD FRAMING @ 16" O.C., SGLE BOTTOM PLATE, DBL TOP PLATE. FASTEN SILL PLATE TO FLOOR JOIST OR FULL HGT BLOCKING W/ 3-16d NAILS @ 16" O.C. FASTEN TOP PLATE TO FULL


DEPTH BLOCKING W/ 8d NAILS @ 16" O.C.

12. GYPSUM WALL BOARD (GS) PANELS SHALL BE 1/2" MINIMUM AND FASTENED W/ NAILS OR SCREWS PER TABLE R702.3.5 AND 7" O.C. EDGES AND 7" O.C. FIELD.

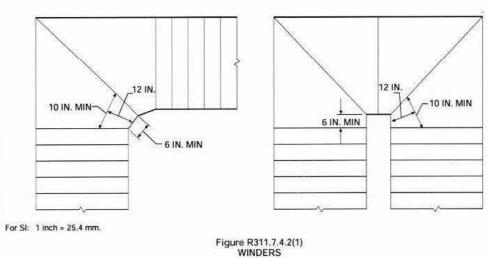

STAIR REQUIREMENTS: RISERS:8 1/4" MAX TREADS:10" MIN HANDRAILS: 34" MIN. TO 38" MAXIMUM ABOVE STAIR NOSING, BALUSTERS: 4" MAX CLEAR WIDTH

─ WINDER STAIRS

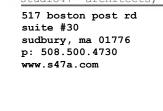

ARCHITECT

\$47 a

PROJECT: Tierney St Residence

> 41 Tierney St Cambridge, MA 02138

CLIENT:

River Front Realty

275 Main St


Boston, MA 02129

PROJECT TEAM:

REVISIONS: 2 ISD REQUEST 11.8.23 3 PLAN REV 1.10.24 5 PLAN REV TENTRY STAIRS 3.12.24


DRAWING TITLE:

BASEMENT & 1ST FLOOR **PLANS**

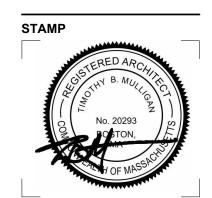

CONSTRUCTION DOCUMENT PHASE

DRAWING NUMBER:

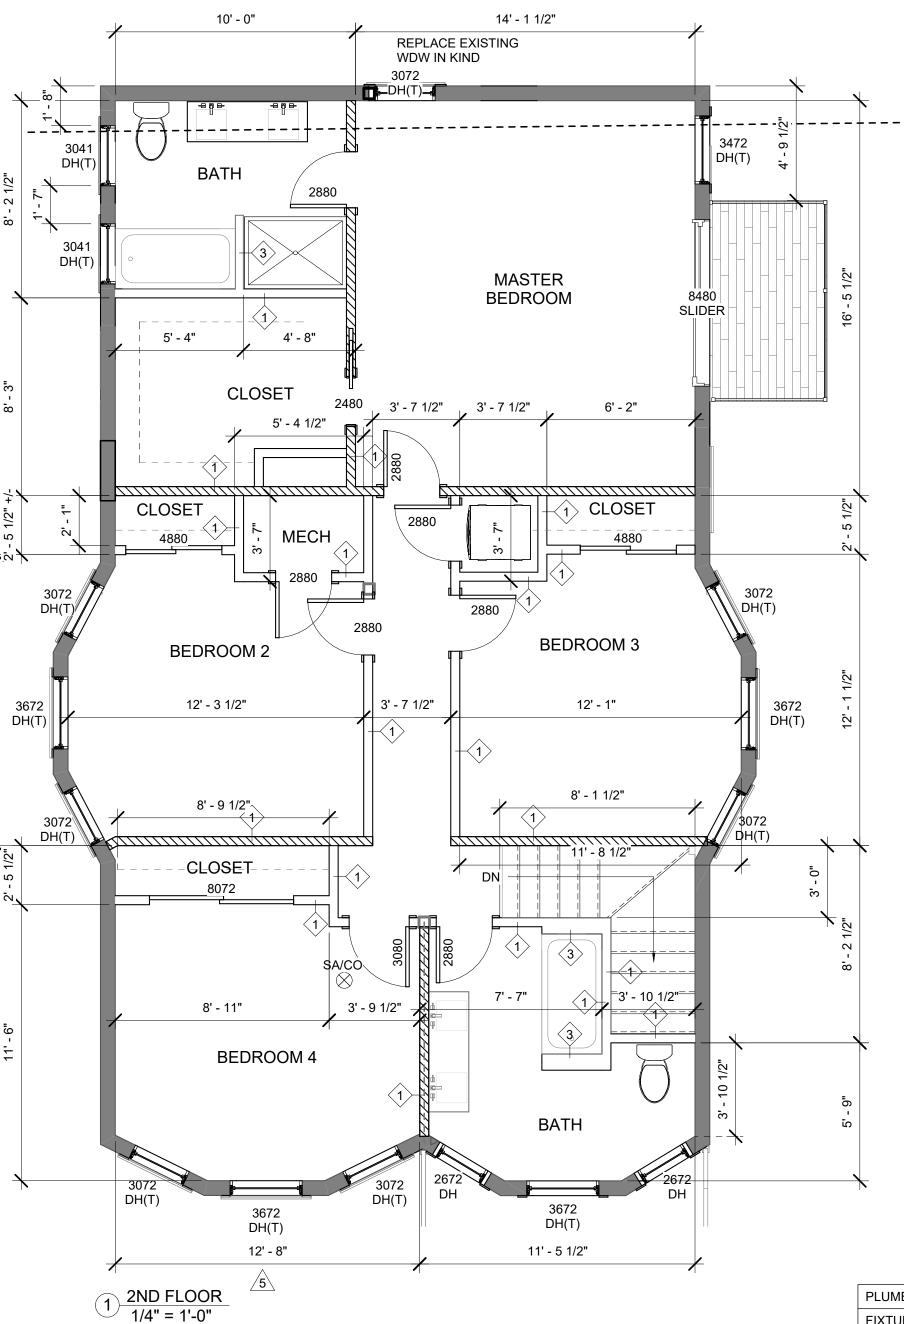

NEW MEMB ROOFING	
NEW MEMB ROOFING	

PLUMBING FIXTURE COUNT							
FIXTURE	BSMT	1ST FLR	2ND FLR	TOTAL			
SINK	2	2	4	9			
TOILET	2	1	3	6			
SHOWER	1	0	3	4			
LAUNDRY	0	1	0	1			
TOTAL FIX	20						

CS-WSP			Exterior sheathing per Table R602.3(3)	6" edges 12" field	
wood structural panel	3/8"		Interior sheathing per Table R602.3(1) or R602.3(2)	Varies by fastener	


TABLE R602.3(3) REQUIREMENTS FOR WOOD STRUCTURAL PANEL WALL SHEATHING USED TO RESIST WIND PRESSURESa, b, c

MINIMUM NAIL		MINIMUM WOOD STRUCTURAL	MINIMUM NOMINAL PANEL	MAXIMUM WALL STUD SPACING	PANEL NAIL SPACING		ULTIMATE DESIGN WIND SPEED Vult (mph)		
Size	Size Penetration (inches)	PANEL SPAN RATING	THICKNESS (inches)	(inches)	Edges (inches o.c.)	Field (inches o.c.)	Wind e	xposure c	ategory D
6d Common (2.0" × 0.113")	1.5	24/0	3/8	16	6	12	140	115	110
8d Common	1.75	24/16	7.	16	6	12	170	140	135
(2.5" × 0.131")	1.70	24/16	⁷ / ₁₆	24	6	12	140	115	110

For St. 1 inch = 25.4 mm, 1 mile per hour = 0.447 m/s.

- a. Panel strength axis parallel or perpendicular to supports. Three-ply plywood sheathing with studs spaced more than 16 inches on center shall be applied with panel strength axis perpendicular to supports.
- b. Table is based on wind pressures acting toward and away from building surfaces in accordance with Section R301.2. Lateral bracing requirements shall be in accordance with Section R602.10.
- c. Wood structural panels with span ratings of Wall-16 or Wall-24 shall be permitted as an alternate to panels with a 24/0 span rating. Plywood siding rated 16 o.c. or 24 o.c. shall be permitted as an alternate to panels with a 24/16 span rating. Wall-16 and Plywood siding 16 o.c. shall be used with stude spaced not more than 16 inches on center.

2 ROOF PLAN 1/4" = 1'-0"

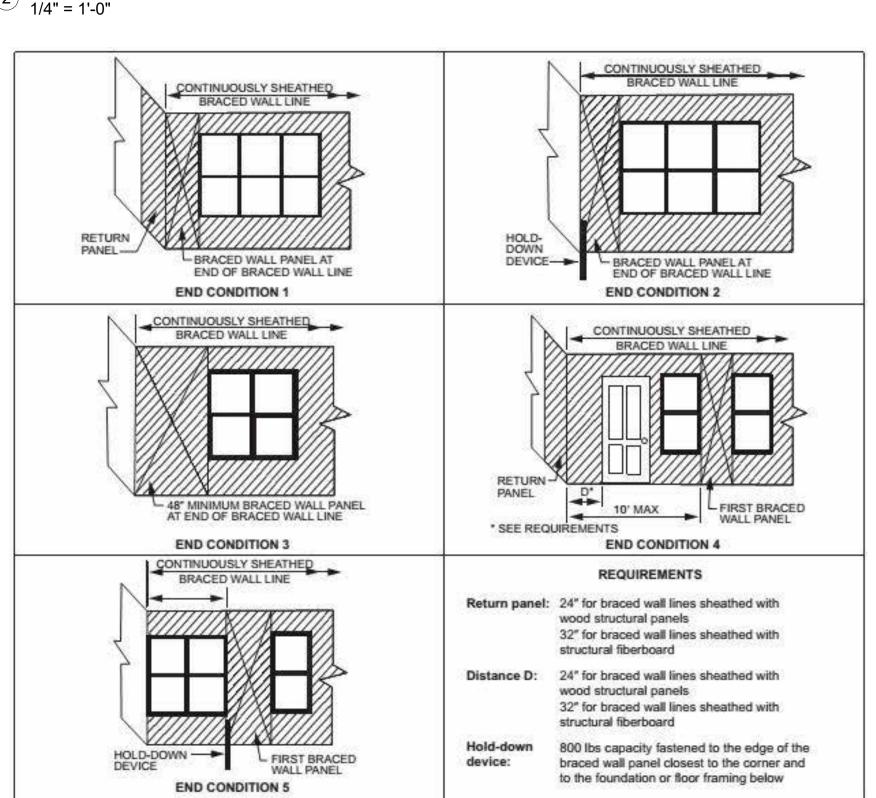

GENERAL NOTES:

- 1. WORK SHALL COMPLY WITH FEDERAL. STATE AND LOCAL BUILDING CODES AND REGULATIONS. UNLESS OTHERWISE AGREED UPON. THE CONTRACTOR IS RESPONSIBLE FOR SECURING ALL BUILDING PERMITS AS REQUIRED TO PERFORM HIS OR HER WORK AND WILL RETAIN AND PAY FOR ALL REQUIRED INSPECTIONS FOR THE DURATION OF CONSTRUCTION.
- 2. CONTRACTOR SHALL ENGAGE A LICENSED ELECTRICIAN FOR ALL ELECTRICAL WORK AND IN COMPLIANCE WITH NFPA 70.
- 3. CONTRACTOR RESPONSIBLE FOR ALL PREPARATION WORK REQUIRED BY MANUFACTURER'S SPECIFICATIONS.
- 4. CONTRACTOR SHALL PROVIDE PRODUCT SUBMITTAL FOR SMOKE ALARM FIXTURES FOR APPORVAL
- 5. CONFLICTS BETWEEN SITE CONDITIONS AND DRAWINGS SHALL BE BROUGHT TO THE IMMEDIATE ATTENTION OF THE ARCHITECT OR THE APPROPRIATE CONSULTING ENGINEERS.
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- 7. CONTRACTOR TO NOTIFY ARCHITECT, AFTER LAYOUT AND PRIOR TO FRAMING, IF DIMENSIONS INDICATED WITH "+/-" VARIES MORE THAN 3" FROM ACTUAL FIELD MEASURMENTS.
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- 9. DAMAGED TO EXISTING OR NEW CONSTRUCTION CAUSED BY THE CONTRACTOR, HIS OR HER SUB-CONTRACTORS OR CREW IS THE RESPONSIBILITY OF THE CONTRACTOR.
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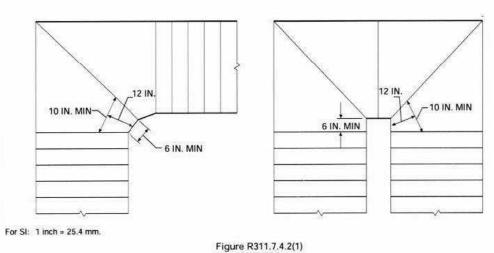
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W/ NAILS OR SCREWS PER TABLE R702.3.5 AND 7" O.C. EDGES AND 7" O.C. FIELD.

INTERIOR PARTITIONS: 11. 2X4 MIN WOOD FRAMING @ 16" O.C., SGLE BOTTOM PLATE, DBL TOP PLATE. FASTEN SILL PLATE TO FLOOR JOIST OR FULL HGT BLOCKING W/ 3-16d NAILS @ 16" O.C. FASTEN TOP PLATE TO FULL DEPTH BLOCKING W/ 8d NAILS @ 16" O.C.


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WINDERS

STAIR REQUIREMENTS: RISERS:8 1/4" MAX TREADS:10" MIN HANDRAILS: 34" MIN. TO 38" MAXIMUM ABOVE STAIR NOSING, BALUSTERS: 4" MAX CLEAR WIDTH

WINDER STAIRS 12" = 1'-0"



ARCHITECT S47 a

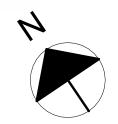517 boston post rd suite #30 sudbury, ma 01776 p: 508.500.4730 www.s47a.com

> PROJECT: Tierney St

Residence

41 Tierney St Cambridge, MA 02138

CLIENT:

River Front Realty


275 Main St Boston, MA 02129

PROJECT TEAM:

REVISIONS: ∑ PLAN REV

DRAWING TITLE:

2ND FLOOR & **ROOF PLAN**

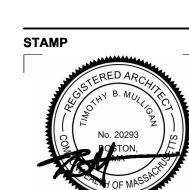

CONSTRUCTION

DOCUMENT PHASE

<u>As indicated</u>

DRAWING NUMBER:



ARCHITECT

517 boston post rd

 3 PLAN REV
 1.10.24

 5 PLAN REV
 2.6.24

 1 ENTRY STAIRS
 3.12.24

ELEVATIONS



4 EXISTING LEFT ELEVATION 1/4" = 1'-0"

3 EXISTING REAR ELEVATION 1/4" = 1'-0"

S47 a architects, inc

517 boston post rd

suite #30

suite #30 sudbury, ma 01776 p: 508.500.4730 www.s47a.com

PROJECT:
Tierney St
Residence

41 Tierney St
Cambridge, MA 02138

CLIENT:

River Front Realty

275 Main St Boston, MA 02129

PROJECT TEAM:

REVISIONS:

DRAWING TITLE:

EXISTING ELEVATIONS

STAMP



October 12, 2023
DATE OF ISSUE


CONSTRUCTION
DOCUMENT PHASE

1/4" = 1'-0"
SCALE

2325.00 PROJECT#

DRAWING NUMBER:

A201

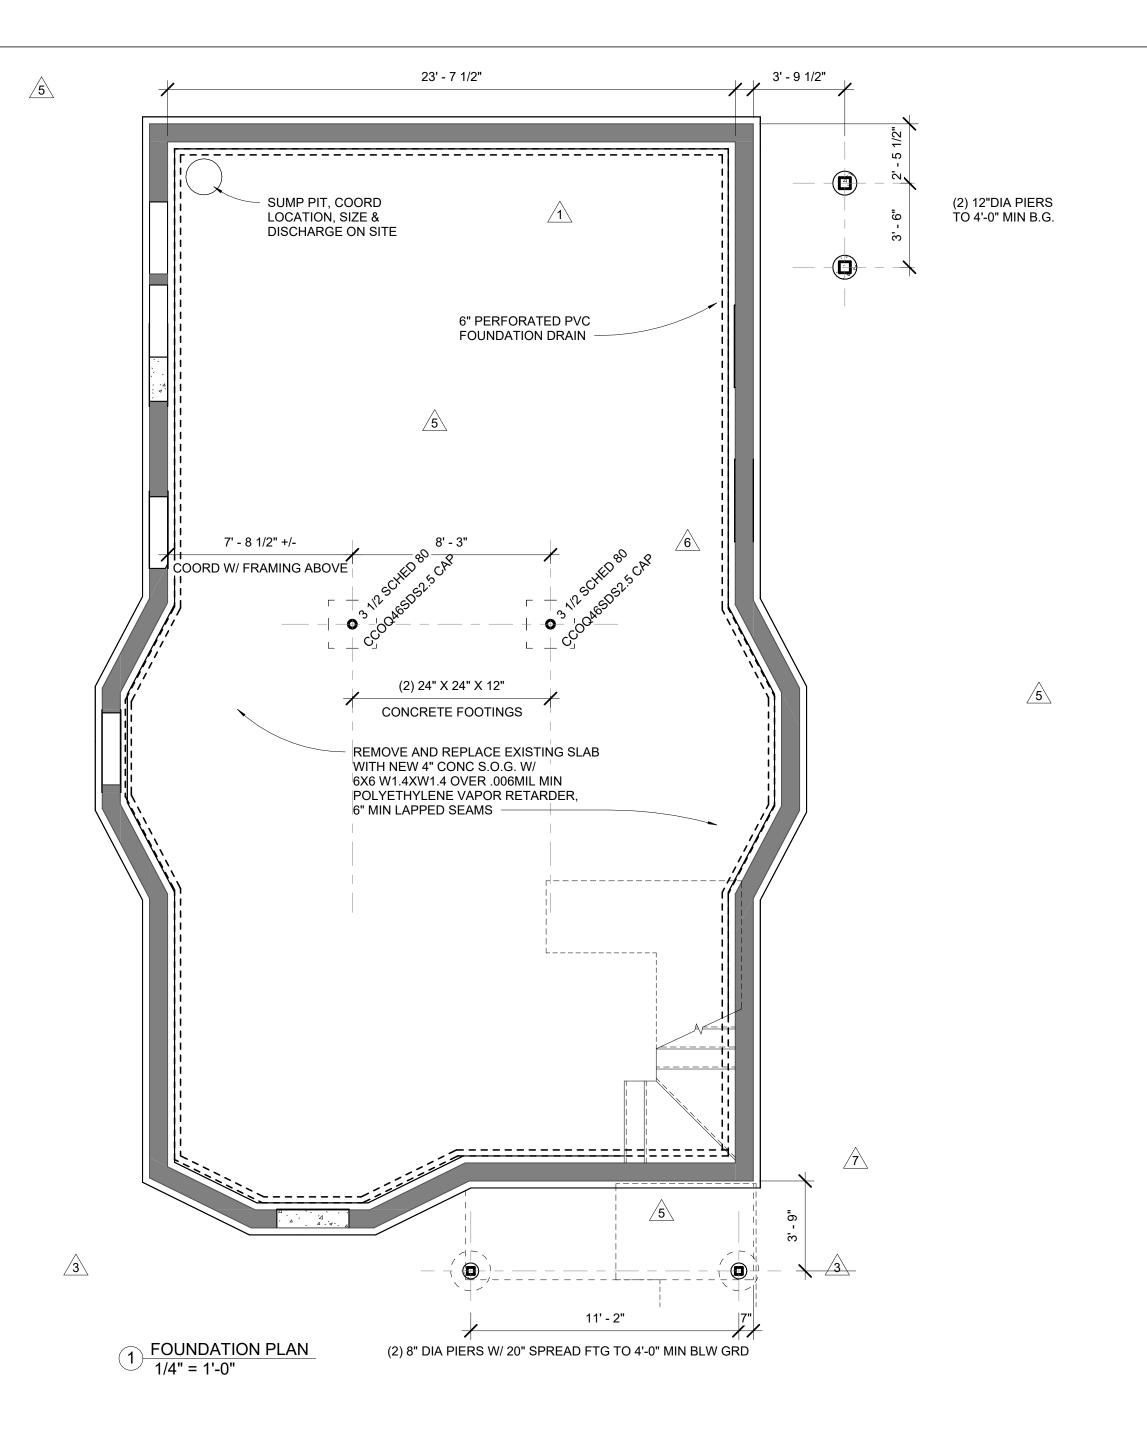

CONCRETE NOTES:

- 1. ALL CONCRETE WORK SHALL COMPLY WITH ACI 318: BUILDING CODE REQUIREMENTS FOR REINFORCED CONCRETE.
- 2. ALL CONCRETE SHALL COMPLY WITH ACI 301; SPECIFICATIONS FOR STRUCTURAL CONCRETE FOR BUILDINGS.
- 3. 3,000 MIN PSI COMPRESSIVE STRENGTH POST 28 DAYS
- 4. ALL CONCRETE TO BE POURED MONOLITHICALLY. UNO
- 5. CONCRETE FOUNDATIONS SHALL COMPLY WITH SECTION 18 OF IBC 2015 780CMR.
- STEEL REINFORCING SHALL COMPLY WITH ASTM 615 GRADE 60, U.N.O.

\wedge

FRAMING NOTES:


- 1. FRAMING BASED ON ASSUMPTIONS OF EXISTING CONDITIONS; ALERT ARCHITECT OF CONDITIONS THAT VARY FROM EXISTING LAYOUT
- 2. COMMODITY FRAMING GRADE TO BE DOUGLAS FIR #2 (EQUAL OR BETTER) ALL EXTERIOR FRAMING TO BE PRESSURE TREATED (P.T.)
- 3. ENGINEERED LUMBER PROPERTIES: LVL: Fb=3100psi PSL Fb=2650psi
- 4. ALL LUMBER IN CONTACT WITH CONCRETE TO BE PRESSURE TREATED (P.T.) .
- 5. INSTALL BTWN JOIST FULL DEPTH BLOCKING AT DROP BEAMS AND BEARING WALLS.
- 6. INSTALL SIMPSON JOIST HANGERS AT ALL FACE MOUNT JOIST, U.N.O.
- 7. INSTALL 3/4" T&G PLYWOOD SUB-FLOOR GLUE AND NAIL, TYP ALL FLOORS
- 8. NOTCHING OR DRILLING HOLES IN JOISTS TO BE APPROVED BY ENGINEER
- 9. SPLICE BEAMS AT SUPPORTS
- 10. INSULATE AT ALL WINDOWS AND EXTERIOR DOOR HEADERS.
- 11. LIVE LOADS: BEDROOMS

BEDROOMS 30 PSF
OTHER THAN BEDROOMS 40 PSF
EXTERIOR DECK 40 PSF
SNOW LOAD 50PSF

PROPOSED FRAMING

BRACE WALL BELOW

BRACE WALL ABOVE

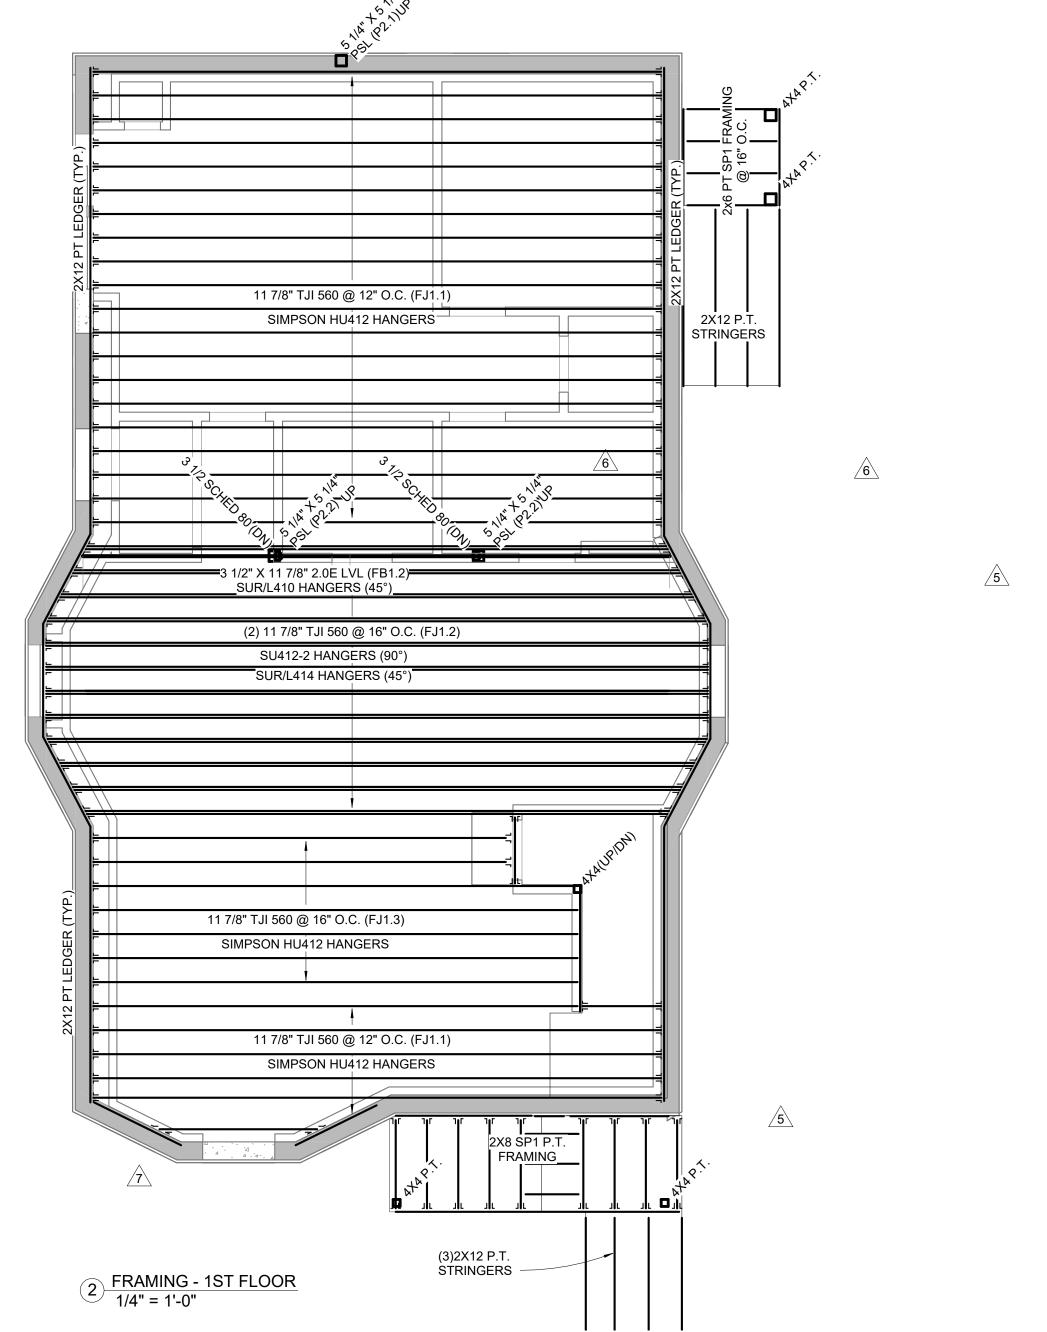

ARCHITECT

studio47 architects,

517 boston post rd
suite #30
sudbury, ma 01776
p: 508.500.4730

www.s47a.com

PROJECT:
Tierney St
Residence

41 Tierney St Cambridge, MA 02138

CLIENT:
River Front Realty

275 Main St Boston, MA 02129

PROJECT TEAM:

 REVISIONS:

 1 FOUNDATION
 7.26.19

 3 PLAN REV
 1.10.24

 5 PLAN REV
 2.6.24

 6 FRMING REV
 3.4.24

 7 ENTRY STAIRS
 3.12.24

DRAWING TITLE:

FOUNDATION & 1ST FLOOR FRAMING PLANS

STAMP



October 12, 2023
DATE OF ISSUE

CONSTRUCTION
DOCUMENT PHASE


1/4" = 1'-0"

SCALE

2325 00

DRAWING NUMBER:

S101

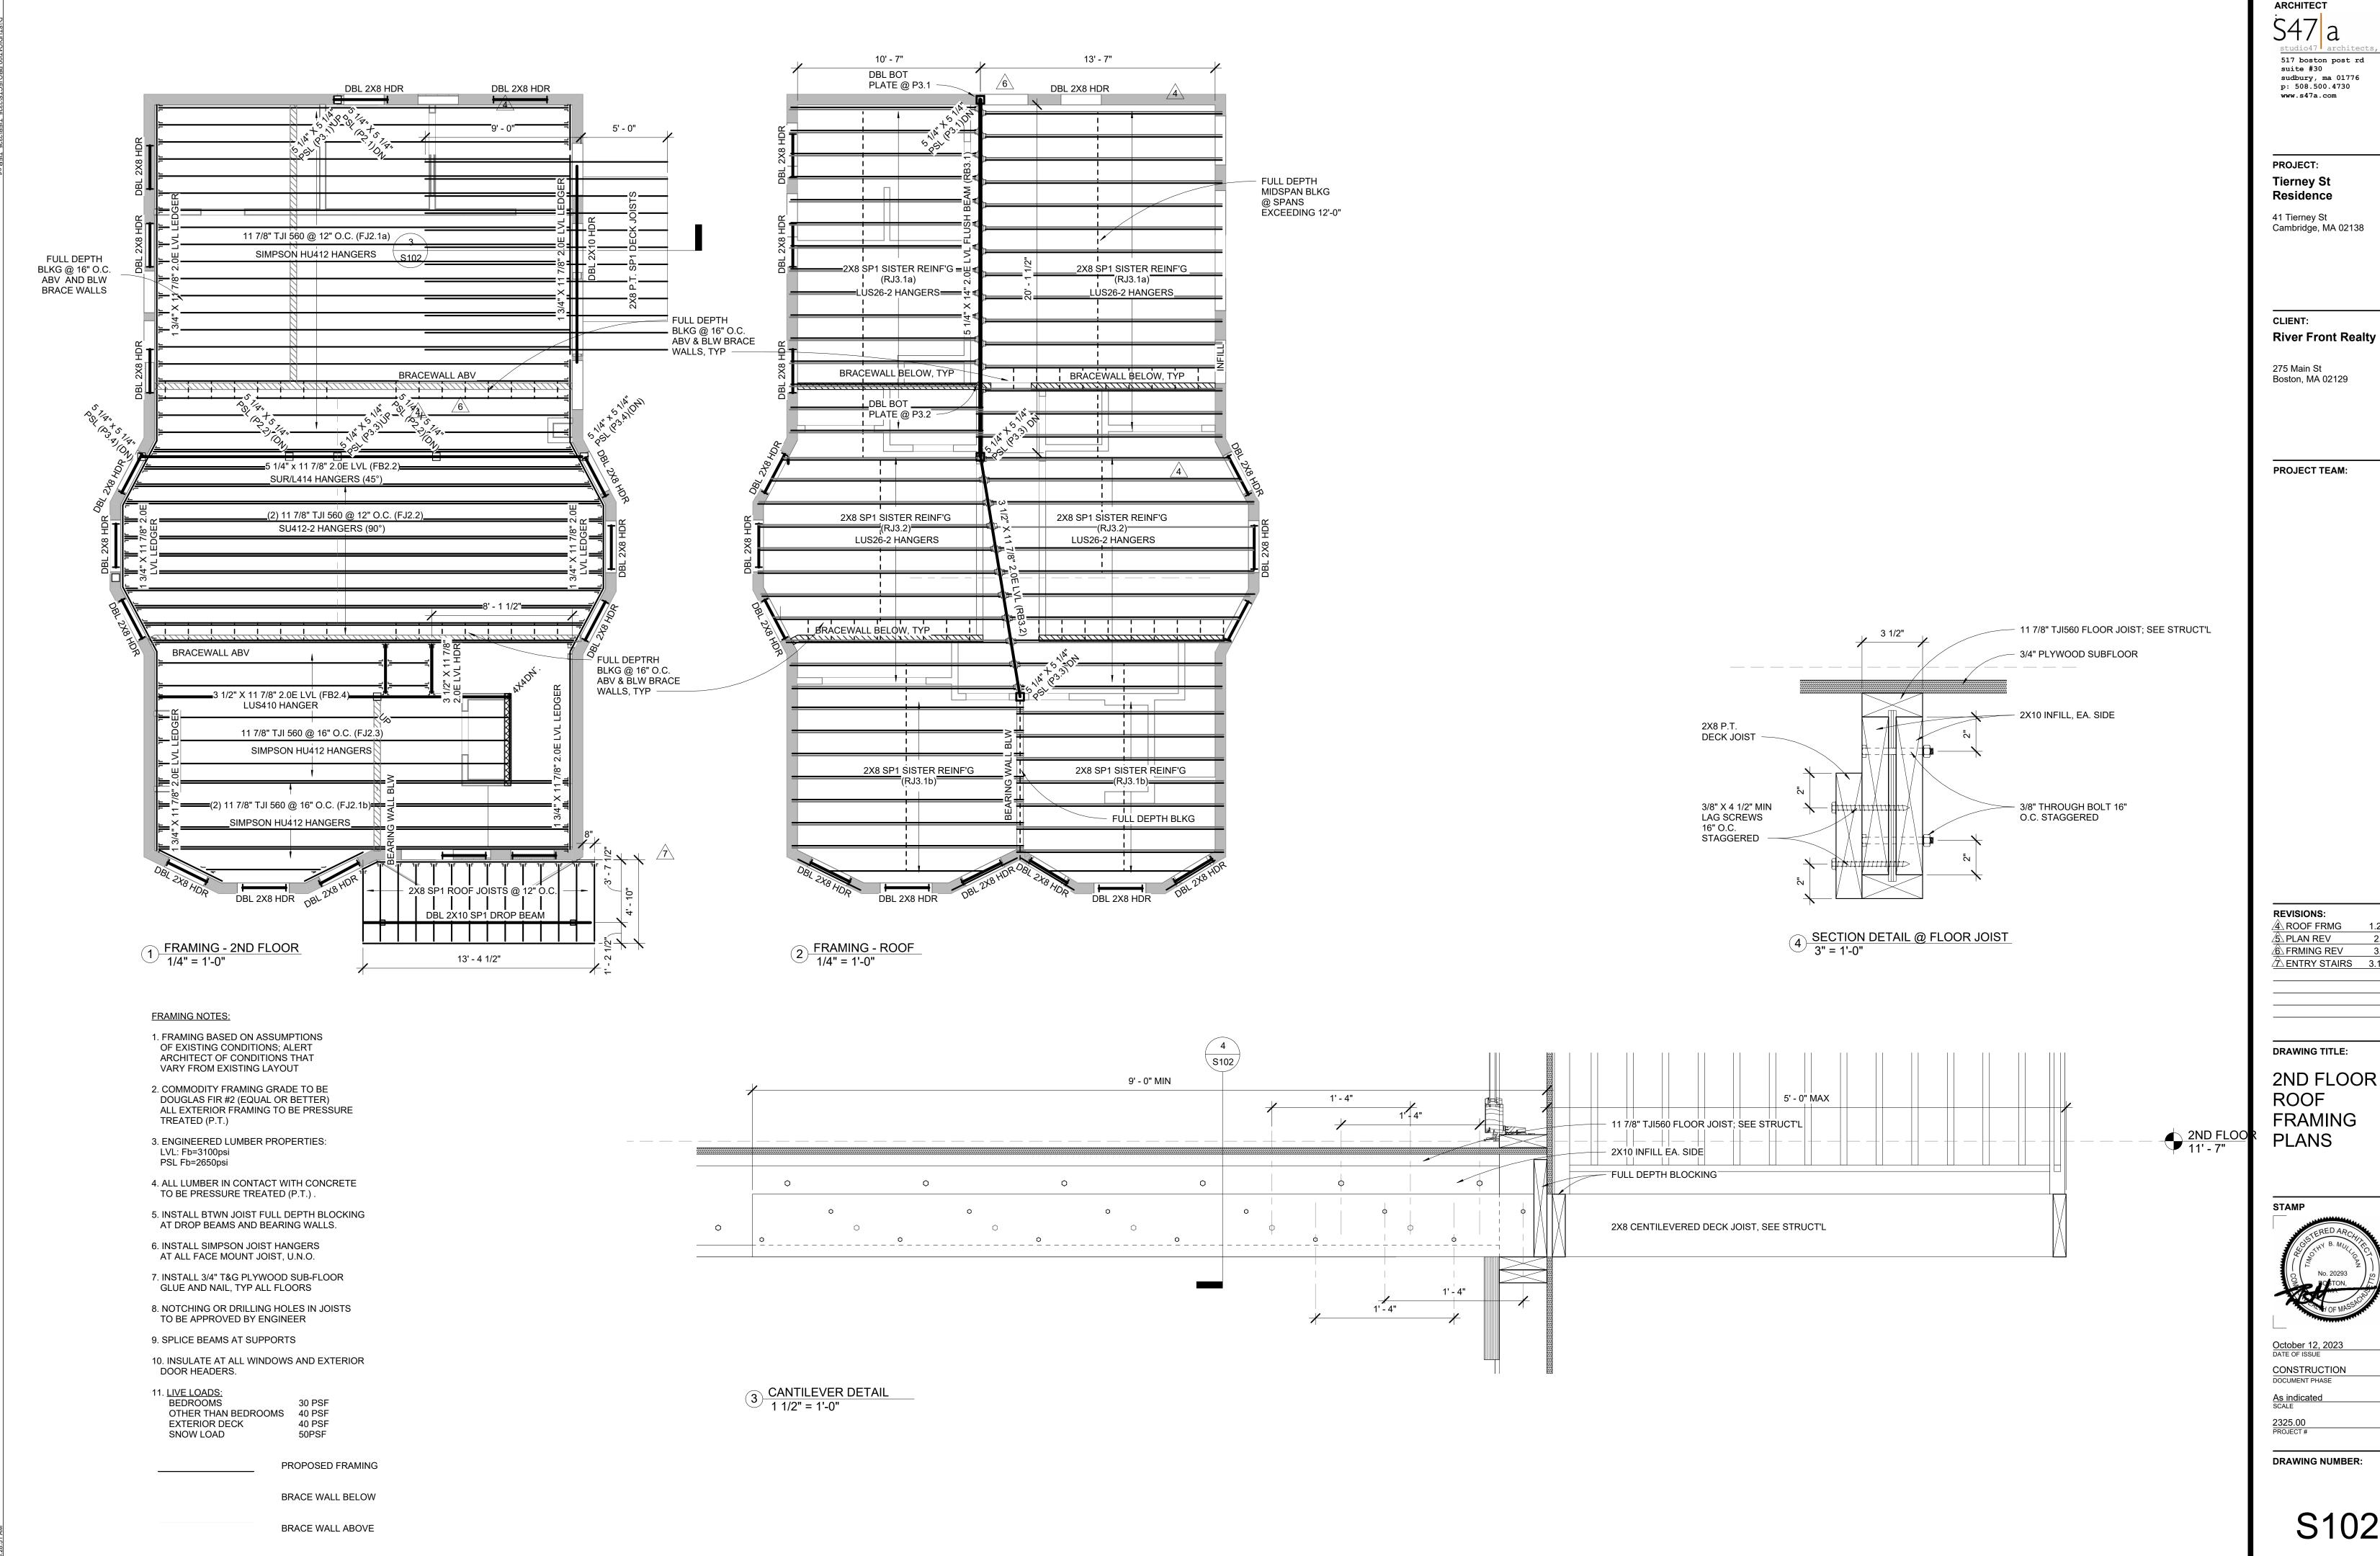

ARCHITECT


517 boston post rd sudbury, ma 01776

1.22.24 2.6.24 TENTRY STAIRS 3.12.24

2ND FLOOR &



S102

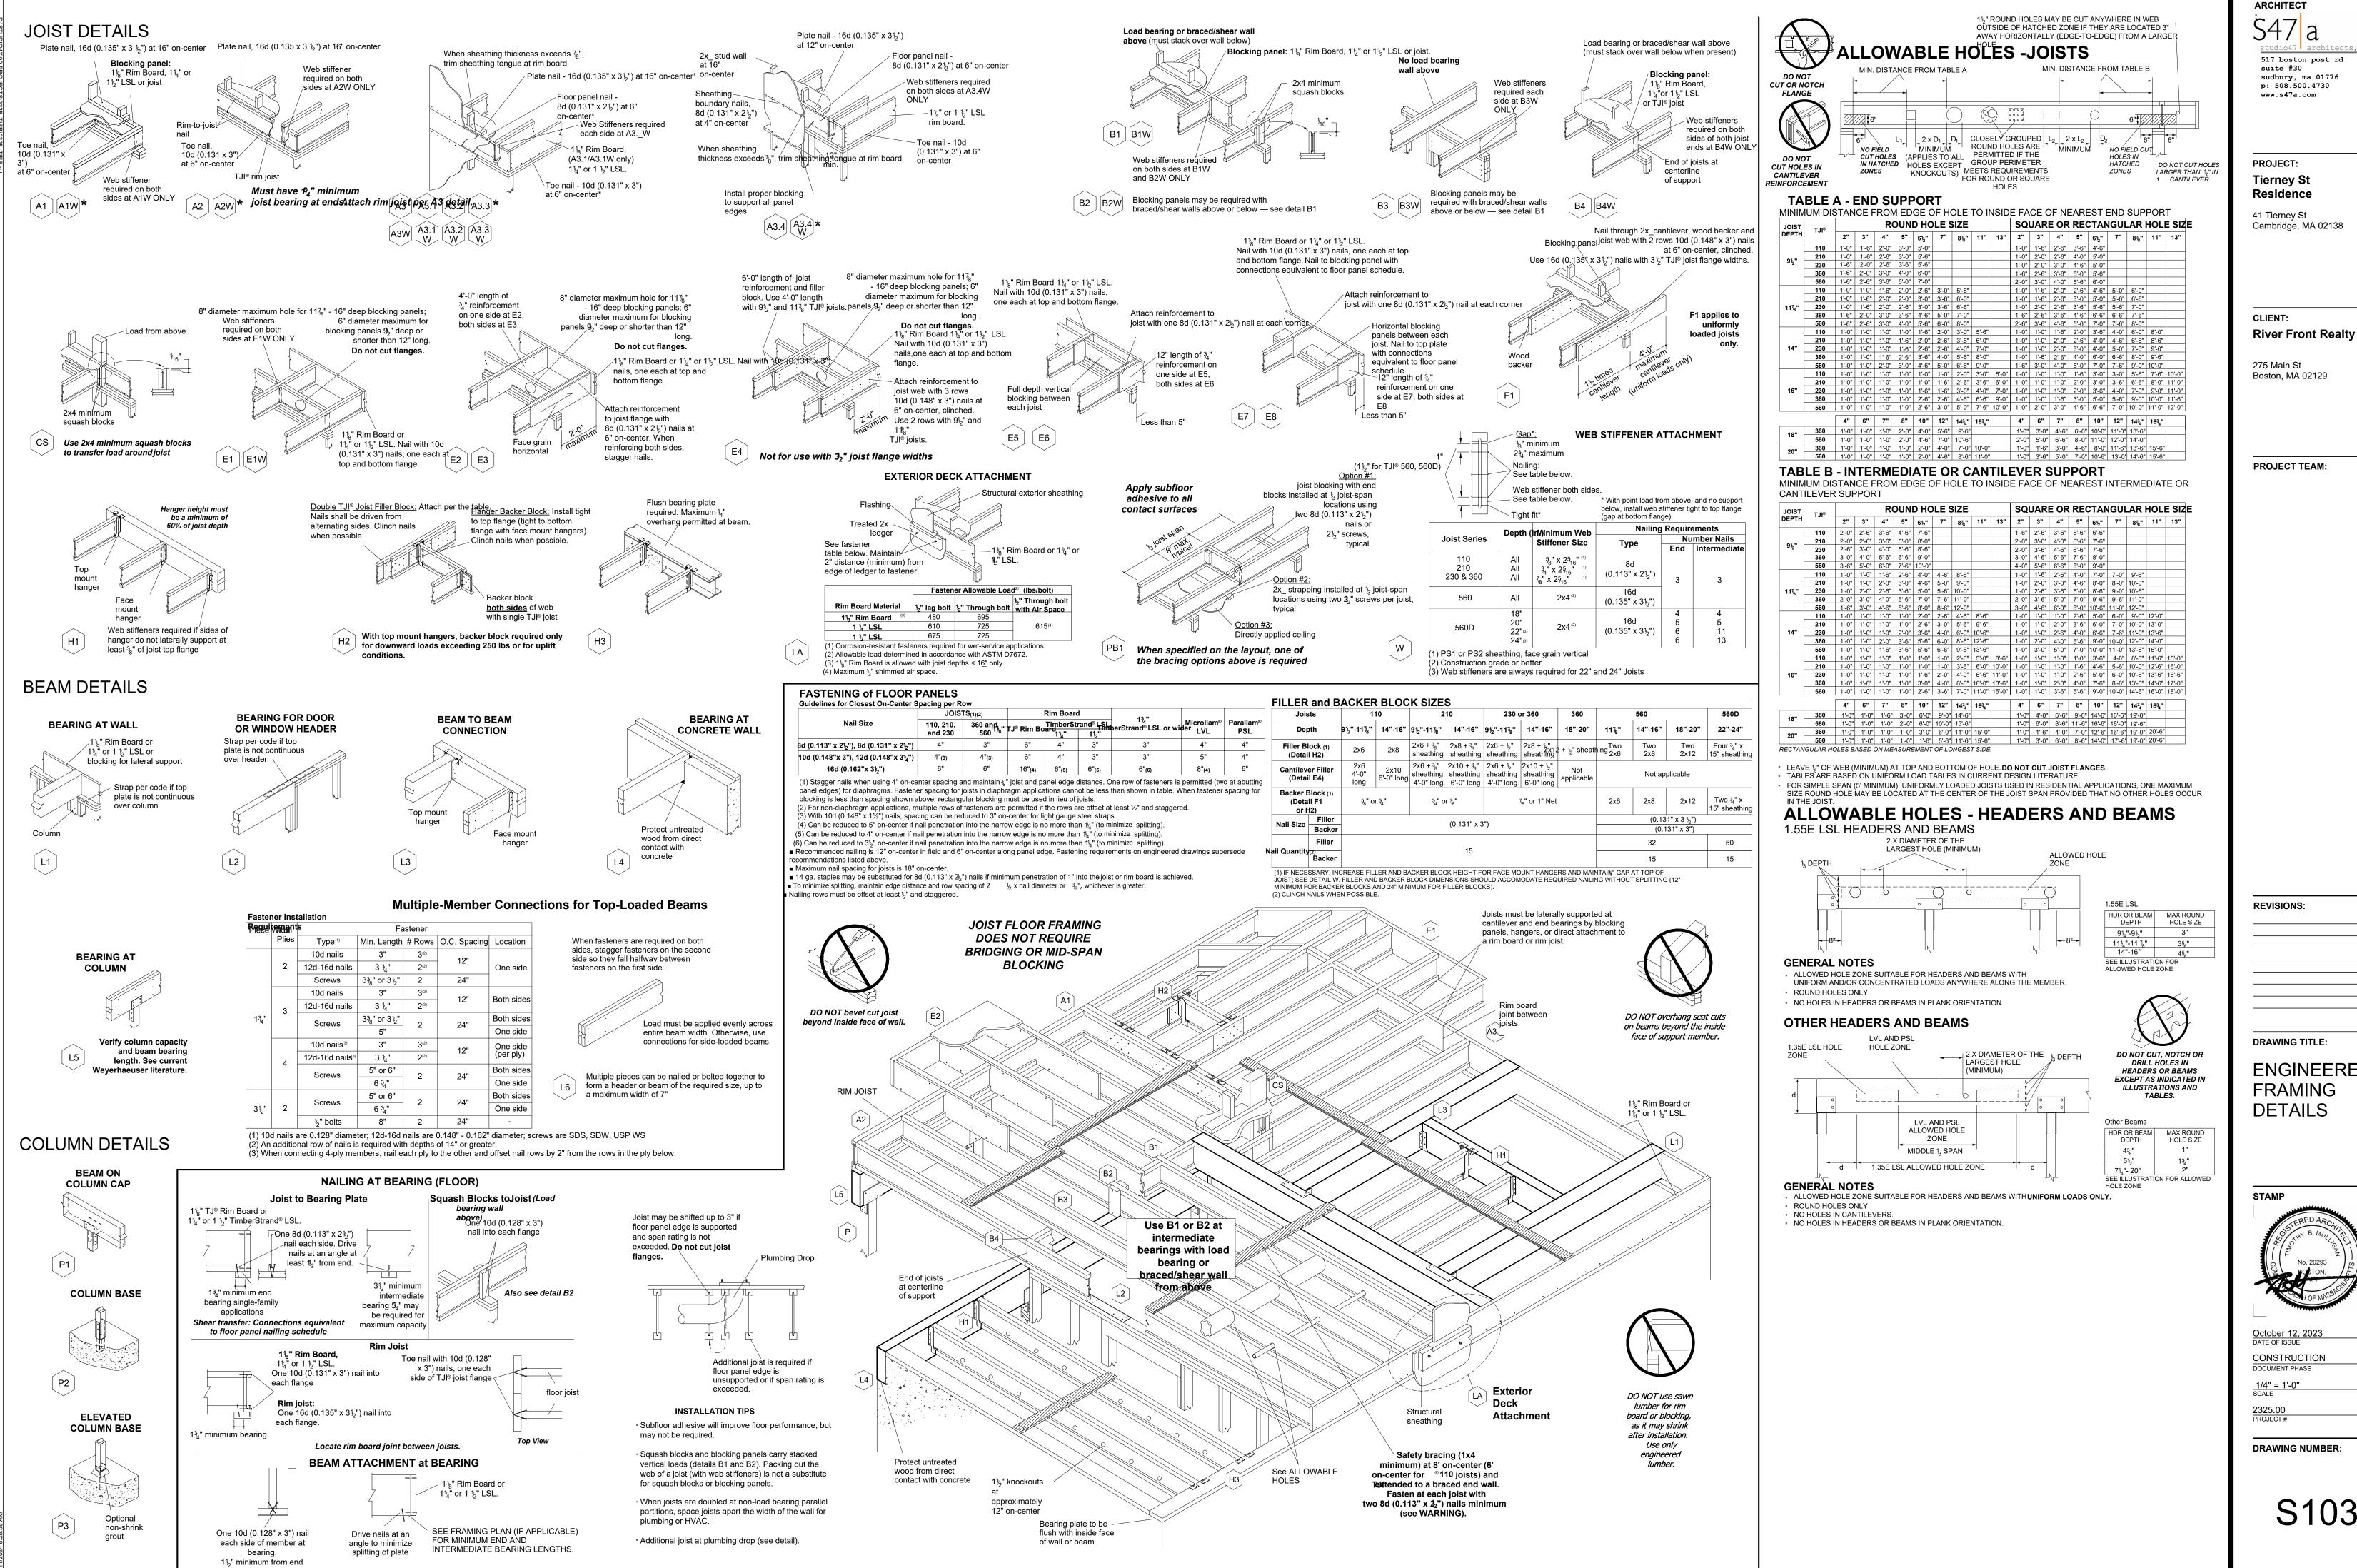

517 boston post rd

ENGINEERED

S103

REFERENCES

DEED BK. 34,800 PG. 365

PLAN BK. 89 PL. #14 BY W.A. MASON & SONS SURVEYORS MARCH 9, 1895

PLAN #957 OF 1989

PLAN #1553 OF 1987

ASSESSORS MAP 229 PCL. 32

CITY OF CAMBRIDGE ENGINEERING PLAN STR-11-22

SEW-17-44

CITY OF CAMBRIDGE AS-BUILT SEWERAGE & DRAINAGE PLAN DATED 11/26/1974

ZONING

25 ft.

ZONING DISTRICT

REQUIRED

5,000 S.F.

LOT FRONTAGE

F.A.R.

FRONT YARD

SIDE YARD

REQUIRED

0.5

Ft.

7.5 ft.


REAR YARD


PROVIDED
3,154± S.F.*
107.15 ft.
0.74*
8.0± ft.*
12.0± ft.
5.8± ft.*

5.8± ft.* 8.1± ft. NEW STAIR** 10.6± ft. UPPER LEVEL BALCONY**


* DENOTES PRE-EXISTING NON-CONFORMANCE TO CURRENT ZONING REGULATION. DWELLING WAS CONSTRUCTED PRIOR TO THE ADOPTION OF THE ZONING ACT BY THE STATE OF MASSACHUSETTS IN 1954

** DENOTES VIOLATION OF CURRENT ZONING REGULATION-VARIANCE REQUIRED

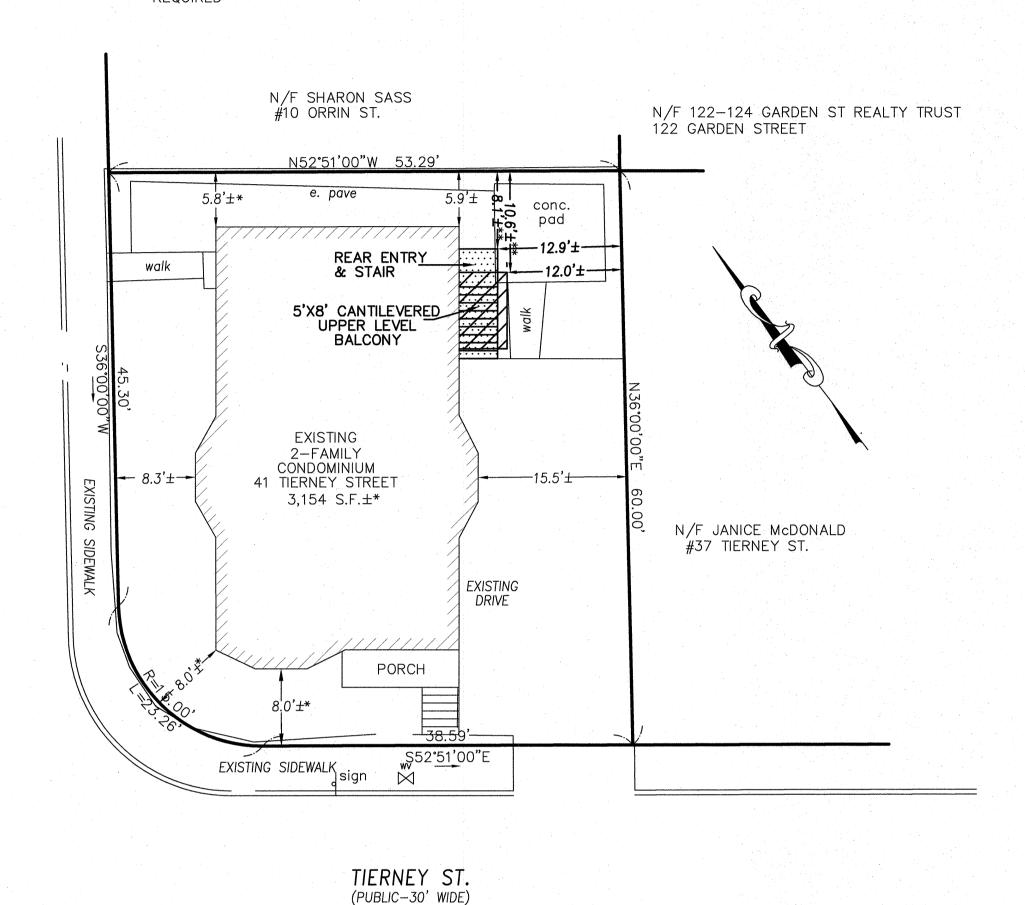

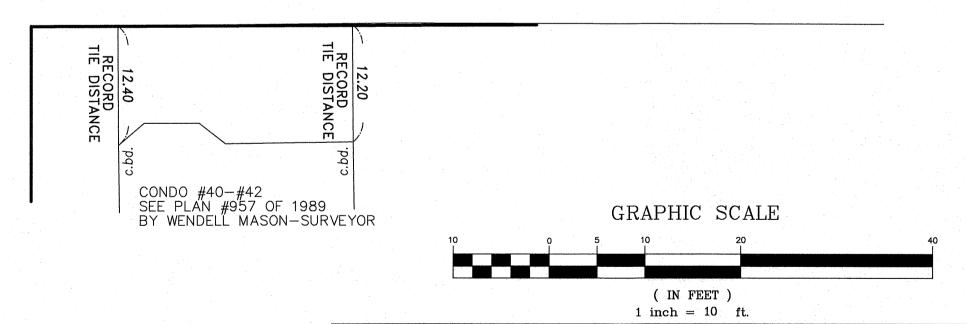

I HEREBY CERTIFY THAT THE DWELLING SHOWN HEREON IS AS ACTUALLY FIELD LOCATED BY INSTRUMENT SURVEY, CONFORMED TO THE ZONING REGULATIONS OF THE CITY OF CAMBRIDGE, MA AT THE TIME OF CONSTRUCTION, PROPOSED CONSTRUCTION CONFORMS — EXECEPT WHERE NOTED— TO THE ZONING REGULATIONS OF THE CITY OF CAMBRIDGE, MA.

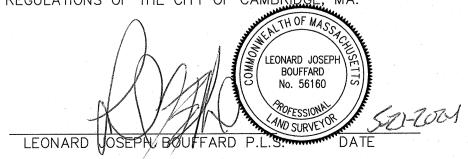

SITE PLAN 41 TIERNEY STREET CAMBRIDGE, MA FOR

41 TIERNEY STREET LIC

CIVIL ENVIRONMENTAL CONSULTANTS


8 OAK STREET PEABODY, MA 01960 978-531-1191


SHEET NO:

1 OF


DATE: 5/21/2024 JOB: 4620


DRAWN BY: L.J.B.

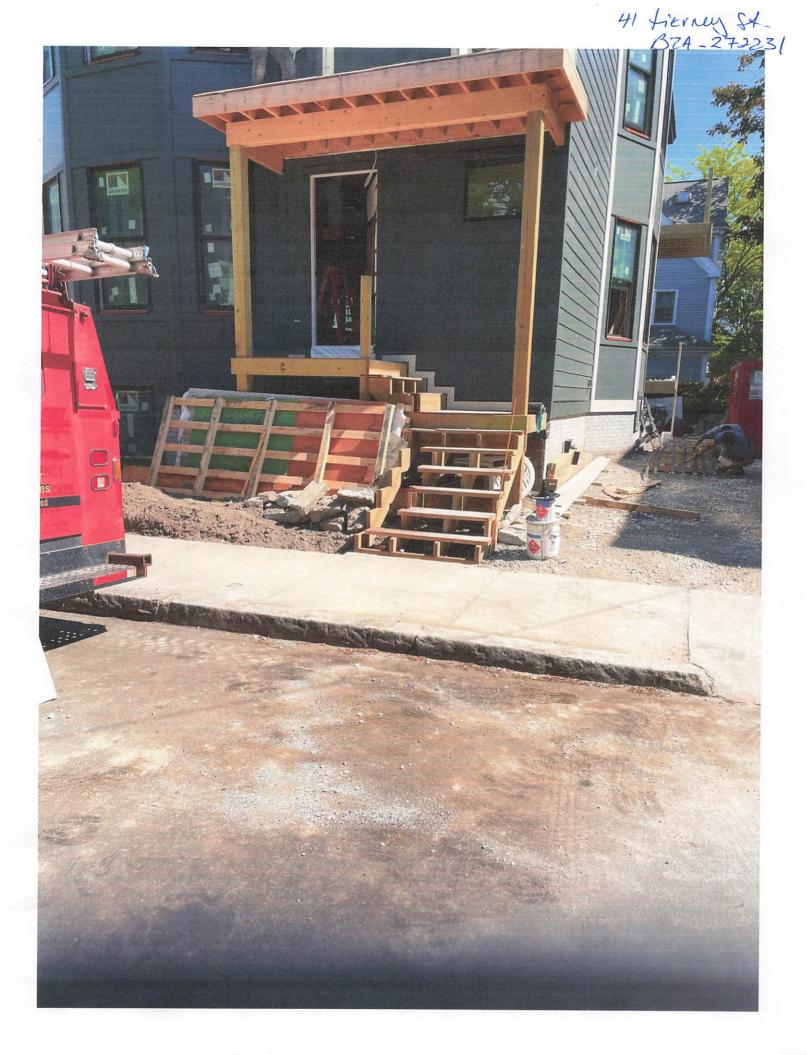

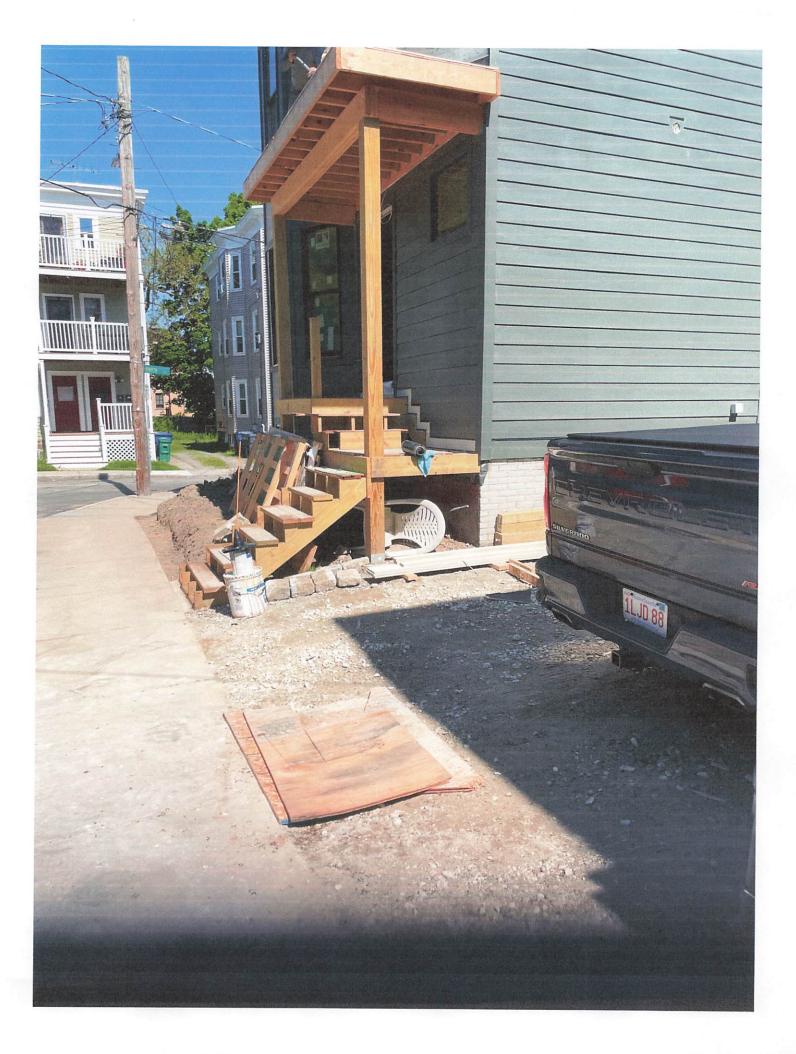



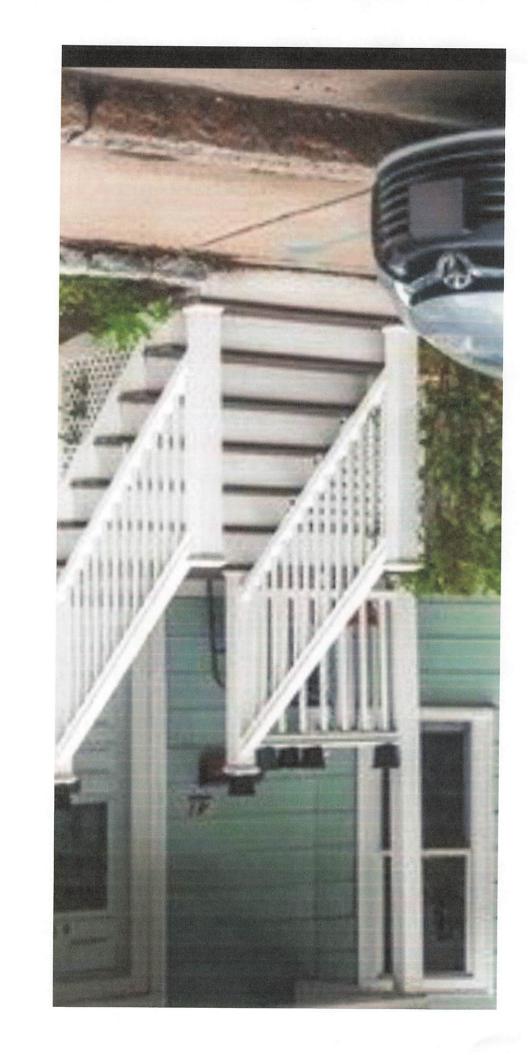

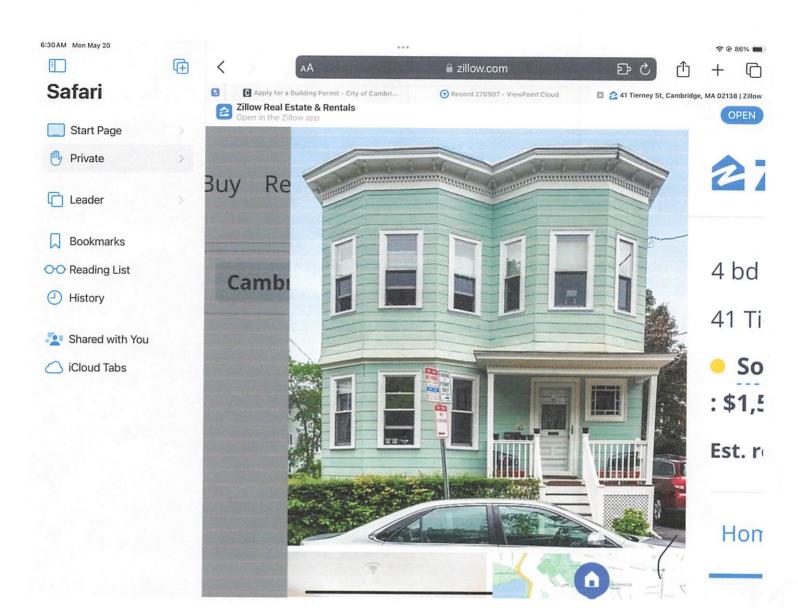

229-3 228-10 229-128 229-138 19-B Sherman St 32 Donnell St 228-8 Donnell St 228-6 131 Garden St 229-129 228-7 134 Garden St 228-11 229-113 228-5 129 Garden St 30 Donnell St 132 Garden St 130 Garden St 228-50 228-12 229-26 127 Garden St 229-114 28 Garden St 125 Garden St228-49 28 Donnell St 121 Garden St 123 Garden St 229-115 ROAD 229-25 26 Donnell St 229-68 119 Garden St228-3 117 Garden St 126 Garden St 229-24 229-69 229-153 124 Garden St122 Garden St 229-70 10 Orrin St 120 Garden St 11 Orrin St13 Orri 229-154 118 Garden St 229-28 229-23 229-71 19 Orrin St 17 Orrin St 229-29 229-32 229/22 229-143 41 Tierney 23 Orrin St Tierney St 229-31 229-20 3 229-30 42/Nerney St40 33 Tierney St 25 Orrin/St 229-142 38 Tierr Tierney St 229-34 34 Tierney Ş 229-164 30 Tierney St 229-35 229-36 20 Tierney St 229-134 229-49 23 Kelley St 229-37 21 Kelley St 6 Winslow St8 Winslow St 229-48 229-133 229-40 Kelley St 229-47 25 Kelley St 2 Winslow St 29 Kelley St 229-151 229-62 ROAD 229-41 229-110 229-63 123 Huron Ave 26 Kelley St 35 Kelley St 229-45 229-111 28 Kelley St 229-44 229-158 229-42

41 Gierney St.

229-20 RIMER, EDWARD S.III & 25 ORRIN ST UNIT B CAMBRIDGE, MA 02138

229-29 SULLIVAN, BRENDAN J. & PATRICIA R. TRST OF 118-120 GARDEN ST REALTY TR.

118-120 GARDEN ST CAMBRIDGE, MA 02138

229-154 SASS, SHARON 10 ORRIN ST CAMBRIDGE, MA 02138

229-71 JFM MARITAL, LLC C/O STEPHEN MCEVOY 15 DAY SCHOOL LANE BELMONT, MA 02478

229-36 SIMONS THOMAS W MARGARET Q SIMONS TRUSTEE 34 TIERNEY ST CAMBRIDGE, MA 02138

229-30
TAYLOR DAVID & NICOLE NEWENDORP
TRS THE NT HOLDING TR
33 TIERNEY ST
CAMBRIDGE, MA 02138

229-69 SCM FAMILY LLC 15 DAY SCHOOL LANE BELMONT, MA 02478 229-34

BOUTAUD, FREDERIC C.
TR. OF THE BOUTAUD FAMILY REALTY TR

5 FULTON RD

LEXINGTON, MA 02420

229-34

KREISBERG, SANFORD,

TR. THE SANDFORD KREISBERG REV TR

40-42 TIERNEY ST UNIT 3 CAMBRIDGE, MA 02138

229-20

WILLIAMS, SIMON F. & ELIZABETH J. WILLIAMS 23 ORRIN ST UNIT A CAMBRIDGE, MA 02138

229-28

SULLIVAN, BRENDAN J. & PATRICIA R. TR OF 122-124 GARDEN ST REALTY TR

118 GARDEN ST

CAMBRIDGE, MA 02138

229-35

PE TIERNEY STREET LLC

55 WENDELL ST

CAMBRIDGE, MA 02138

229-153

LIM. NICOLE SY HIROKAZU MIYAKE TRS

126 GARDEN ST

CAMBRIDGE, MA 02138

GERALD McCARTHY

11 NEBO

MEDFIELD, MA 02052

229-68

PENDERGAST, JOY K.

TR. 128 GARDEN ST CAMBRIDGE N.T

5645 AVISTA DR

SARASOTA, FL 34243

229-31

MCDONALD, JANICE L.

37 TIERNEY ST

CAMBRIDGE, MA 02138-1319

229-34

PELON PUTUKIAN

REALTY LIMITED LIABILITY PARNERSHIP

145 TRAPELO RD

LINCOLN, MA 01773

229-70

LEOFANTI, PAUL & JAY PABIAN,

TRS JOHN W. MCEVOY, MARY JANE WALSH, TRS &

CHRISTINE MCEVOY 80 CUSHING ST

BELMONT, MA 02478

229-32

41 TIERNEY STREET LLC

275 MAIN ST

BOSTON, MA 02129



CAMBRIDGE HISTORICAL COMMISSION

831 Massachusetts Avenue, 2nd Fl., Cambridge, Massachusetts 02139 Telephone: 617 349 4683 Fax: 617 349 3116 TTY: 617 349 6112

E-mail: histcomm@cambridgema.gov URL: http://www.cambridgema.gov/Historic

Bruce A. Irving, Chair, Susannah Barton Tobin, Vice Chair; Charles M. Sullivan, Executive Director Joseph V. Ferrara, Chandra Harrington, Elizabeth Lyster; Jo M. Solet, Yuting Zhang, Members Gavin W. Kleespies, Paula A. Paris, Kyle Sheffield, Alternates

Jurisdiction Advice

To the Owner of Property at 41 Tierney Street:

The above-referenced property is subject to the jurisdiction of the Cambridge Historical Commission (CHC) by reason of the status referenced below:
 Old Cambridge Historic District Fort Washington Historic District (M.G.L. Ch. 40C, City Code §2.78.050) Avon Hill Neighborhood Conservation District Half Crown – Marsh Neighborhood Conservation District Harvard Square Conservation District Mid Cambridge Neighborhood Conservation District Designated Landmark Property is being studied for designation: (City Code, Ch. 2.78., Article III, and various City Council Orders) Preservation Restriction or Easement (as recorded) X_ Structure is fifty years or more old and therefore subject to CHC review of any application for a demolition permit, if one is required by ISD. (City Code, Ch. 2.78, Article II). No jurisdiction: not a designated historic property and the structure is less than fifty years old. No local jurisdiction, but the property is listed on the National Register of Historic Places; CHC staff is available for consultation, upon request. Staff comments:
The Board of Zoning Appeal advises applicants to complete Historical Commission or Neighborhood Conservation District Commission reviews before appearing before the Board.
If a line indicating possible jurisdiction is checked, the owner needs to consult with the staff of the Historical Commission to determine whether a hearing will be required.
CHC staff initials SLB Date June 12, 2024
Received byuploaded to OpenGov DateJune 12, 2024 Relationship to project _emailed to BZA applicant
cc: Applicant Inspectional Services Department (BZA Case#272231)