

CITY OF CAMBRIDGE

BOARD OF ZONING APPEAL

831 Massachusetts Avenue, Cambridge MA 02139 2021 MAR 22 PM 2: 19

617-349-6100

BZA Application Form

BZA Number: 110664

| | | General I | <u>nformation</u> | |
|---|---|--|----------------------|--|
| The undersigned h | nereby petitions the | e Board of Zoning Ap | peal for the followi | ng: |
| Special Permit: | _X | Variance: | | Appeal: |
| | | | | |
| PETITIONER: Ce | llco Partnership d _/ | /b/a Verizon Wireles | s C/O Daniel D. Kla | asnick, Esquire of Duval & Klasnick |
| PETITIONER'S A | DDRESS: P. O. Bo | ox 254, Boxford, MA | 01921 | |
| LOCATION OF PI | ROPERTY: 545 Co | oncord Ave , Cambr | <u>ridge, MA</u> | |
| TYPE OF OCCUP | PANCY: Mobile Co | mmunications | ZONING DISTRIC | T: <u>Business A Zone</u> |
| REASON FOR PE | ETITION: | | | |
| /Telecommunicat | ion Facility (anten | na)/ | | |
| DESCRIPTION O | F PETITIONER'S | PROPOSAL: | | |
| antennas. With 6 all at a top height | antennas mounted to match the existi | to the existing pipe | mounts and 6 ante | ennas and installing 12 facade nnas stack mounted on a pipe mount atch color and texture of building). nistrut. |
| SECTIONS OF Z | ONING ORDINAN | CE CITED: | | |
| Article: 4.000 Article: 4.000 Article: 10.000 Article: 6409(a) | Section: 4.40 (Fo Section: 10.40-10 | (Telecommunication otnote 49 - Telecomm .46 (Special Permit) Class Tax Relief and J | nunications Facility | |
| | | Original Signature(s): | Danie (Pe | O lesonic etitioner (s) / Owner) |
| | | | Daniel D. 1. | Klasnick |
| | | | | (Print Name) |

Address:

Boxford, MA 01921

P.O. Box 254

1/5

Tel. No.

781-873-0021

Date: 3 · 18 · 2021

E-Mail Address: dklasnick@dkt-legal.com

BZA APPLICATION FORM - OWNERSHIP INFORMATION

| The Secretary of the Board of Zoning Appeals. |
|--|
| I/We Algoghos Atimizian PLEWISE PROPERTIES LLO |
| |
| Address: 545 Concord ave Cambridge |
| State that I/We own the property located at, |
| which is the subject of this zoning application. |
| The record title of this property is in the name of <u>Alewife Properties LLC</u> |
| *Pursuant to a deed of duly recorded in the date 10/19/2006 Middlesex South |
| County Registry of Deeds at Book 48345 , Page 504 ; or |
| Middlesex Registry District of Land Court, Certificate No. |
| Book Page SIGNATURE BY LAND OWNER OR AUTHORIZED TRUSTEE, OFFICER OR AGENT* |
| |
| *Written evidence of Agent's standing to represent petitioner may be requested. |
| |
| Commonwealth of Massachusetts, County of Maddlesey |
| The above-name Nigoghis Afinizian personally appeared before me; |
| this 19th of Jan, 2021, and made oath that the above statement is true. |
| Lathers M. Notaginilling |
| My commission expires (Notary Seal). If ownership is not shown in recorded deed, e.g. if by court order, respectively deed, or inheritance, please include documentation. |
| • If ownership is not shown in recorded deed, e.g. if by court order, research deed, or inheritance, please include documentation. |
| , vonnano |

BZA Application Form

SUPPORTING STATEMENT FOR A SPECIAL PERMIT

Please describe in complete detail how you meet each of the following criteria referring to the property and proposed changes or uses which are requested in your application. Attach sheets with additional information for special permits which have additional criteria, e.g.; fast food permits, comprehensive permits, etc., which must be met.

Granting the Special Permit requested for <u>545 Concord Ave</u>, <u>Cambridge</u>, <u>MA</u> (location) would not be a detriment to the public interest because:

A) Requirements of the Ordinance can or will be met for the following reasons:

As demonstrated by the documents provided with this application and will be further discussed at the hearing on this matter, the modification satisfies the standards for an Eligible Facilities Request pursuant to Section 6409(a) of the Federal Spectrum Act. The proposed modification also satisfies the

standards for the grant of a special permit. (For further details, please see attached narrative and supporting documents)

Traffic generated or patterns of access or egress would not cause congestion hazard, or substantial change in established neighborhood character for the following reasons:

The modification of the unmanned facility will not change existing traffic demand or impact ingress or egress. The modified facility will continue to generate only about one to two vehicles trips per month in a standard passenger vehicle. (For further details, please see attached narrative and supporting documents)

The continued operation of or the development of adjacent uses as permitted in the Zoning

Ordinance would not be adversely affected by the nature of the proposed use for the following reasons:

The modified facility will have no adverse effects on the operation or development of adjacent uses. The

modified facility will emit no light, odor, dust or glare and generates no unusual noise or other adverse

impacts. (For further details, please see attached narrative and supporting documents)

Nuisance or hazard would not be created to the detriment of the health, safety, and/or welfare of the occupant of the proposed use or the citizens of the City for the following reasons:

The modified facility will generate no additional traffic or other negative impacts on surrounding properties

or within the City of Cambridge. The facility requires no water or sewer services and emits no light, odor.

dust or glare and generates no unusual noise or other adverse impacts. The facility will be unoccupied with

no employees or customers. The availability of wireless services enhances the health, safety and welfare of

the community. (For further details, please see attached narrative and supporting documents)

E) For other reasons, the proposed use would not impair the integrity of the district or adjoining district

or otherwise derogate from the intent or purpose of this ordinance for the following reasons:

The facility has been designed to minimize its visual impact and is in harmony with the general purpose of the zoning ordinance for this use and in accordance with the requirements for an Eligible Facilities Request under Section 6409(a). (Please see attached narrative and supporting documents)

*If you have any questions as to whether you can establish all of the applicable legal requirements, you should consult with an attorney.

BZA Application Form

DIMENSIONAL INFORMATION

Doguestad

Applicant: Cellco Partnership d/b/a Verizon Wireless

Present Use/Occupancy:

Mobile Communications

<u>Facility</u>

Location: P.O. Box 254 545 Concord Avenue

Zone:

Ordinana

<u>Business A Zone</u> Mobile Communications

ipancy: Facility

Phone: 781-873-0021

Eviation

Requested Use/Occupancy:

| | | Existing Conditions | Requested Conditions | <u>Ordinance</u> <u>Requirements</u> | |
|--|---------------|------------------------|-------------------------|---|--------|
| TOTAL GROSS FLOOR AREA: | | Not Applicable | Not Applicable | Not Applicable | (max.) |
| LOT AREA: | | Not Applicable | Not Applicable | Not Applicable | (min.) |
| RATIO OF GROSS FLOOR AREA TO LOT AREA: 2 | | Not Applicable | Not Applicable | Not Applicable | |
| LOT AREA OF EACH DWELLING UNIT | | Not Applicable | Not Applicable | Not Applicable | |
| SIZE OF LOT: | WIDTH | Not Applicable | Not Applicable | Not Applicable | |
| | DEPTH | Not Applicable | Not Applicable | Not Applicable | |
| SETBACKS IN FEET | :FRONT | Not Applicable | Not Applicable | Not Applicable | |
| | REAR | Not Applicable | Not Applicable | Not Applicable | |
| | LEFT SIDE | Not Applicable | Not Applicable | Not Applicable | |
| | RIGHT SIDE | Not Applicable | Not Applicable | Not Applicable | |
| SIZE OF BUILDING: | HEIGHT | Not Applicable | Not Applicable | Not Applicable | |
| | WIDTH | Not Applicable | Not Applicable | Not Applicable | |
| RATIO OF USABLE OPEN SPACE TO LOT AREA: | | Not Applicable | Not Applicable | Not Applicable | |
| NO. OF DWELLING UNITS: | | Not Applicable | Not Applicable | Not Applicable | |
| NO. OF PARKING SPACES: | | Not Applicable | Not Applicable | Not Applicable | |
| NO. OF LOADING AREAS: | | Not Applicable | Not Applicable | Not Applicable | |
| DISTANCE TO NEAREST BLDG. ON SAME LOT | | Not Applicable | Not Applicable | Not Applicable | |

Describe where applicable, other occupancies on the same lot, the size of adjacent buildings on same lot, and type of construction proposed, e.g; wood frame, concrete, brick, steel, etc.

- 1. SEE CAMBRIDGE ZONING ORDINANCE ARTICLE 5.000, SECTION 5.30 (DISTRICT OF DIMENSIONAL REGULATIONS).
- 2. TOTAL GROSS FLOOR AREA (INCLUDING BASEMENT 7'-0" IN HEIGHT AND ATTIC AREAS GREATER THAN 5') DIVIDED BY LOT AREA.
- 3. OPEN SPACE SHALL NOT INCLUDE PARKING AREAS, WALKWAYS OR DRIVEWAYS AND SHALL HAVE A MINIMUM DIMENSION OF 15'.




FRESH POND MA HD

545 CONCORD AVENUE CAMBRIDGE, MA 02138

FUZE PROJECT ID: 16070524

PSLC: 137428

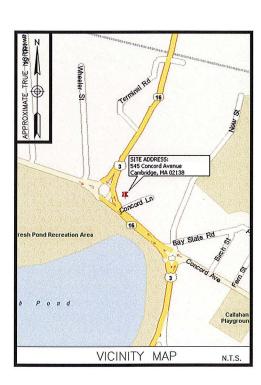

ENGINEER DEWBERRY ENGINEERS INC. 99 SUMMER ST. SUITE 700 BOSTON, MA 02110 PHONE # (617) 531-0800 CONTACT: BENJAMIN REVETTE, PE CONSTRUCTION VERIZON WIRELESS 118 FLANDERS ROAD WESTBOROUGH, MA 01581-3956

| PMI ACCESSED AT: | HTTPS://PMI.VZWSMART.COM |
|---|---|
| SMART TOOL VENDOR PROJECT NUMBER: | 10009990 |
| VZW LOCATION CODE (PSLC): | 137428 |
| FUZE NUMBER: | 16070524 |
| × | |
| PMI AND REQUIREMENTS ALSO ANALYSIS REPORT | EMBEDDED IN MOUNT |
| MOUNT MODIFICATION REQUIRED? | ? NO |
| VZW APPROVED SM | MART KIT VENDORS |
| REFER TO MOUNT MODIFICATION SMART KIT APPRO | |
| CONTRACTOR PM | REQUIREMENTS |
| | AND THE BUILDING AND THE STATE OF THE STATE |
| THIS DOCUMENT WAS DEVELOPED AND ITS SITE CONDITIONS AND I ANOTHER SITE OR WHEN OTHER OF THIS DOCUMENT IS AT THE | S NOT TO BE USED FOR CONDITIONS PERTAIN. REUSE |

F THIS DOCUMENT IS AT THE SOLE RISK OF THE USER.

FACILITY IS UNMANNED AND NOT FOR HUMAN HABITATION.

REMOVE (9) EXISTING ANTENNAS FROM POSITIONS 1, 2 & 3.

INSTALL (6) NEW PANEL ANTENNAS ON EXISTING PIPE MASTS IN POSITIONS 2 & 3.

INSTALL (3) NEW VZSO1 ANTENNAS & (3) NEW CBRS RRH WITH CLIP ON ANTENNA ON PROPOSED 6' PIPE MAST IN POSITION 1.

REMOVE (9) EXISTING RRHS.

INSTALL (6) NEW DUAL BAND RRHS ON EXISTING UNISTRUT.

INSTALL CBRS HYBRID JUMPERS & OTHER JUMPERS AS REQUIRED.

CAP & WEATHERPROOF UN—USED ANTENNA PORTS.

GROUND EXISTING PIPE MOUNTS PER VERIZON WIRELESS SPECIFICATIONS.

OTE: SCOPE OF WORK BASED ON ANTENNA REC FOR "FRESH_POND_MA" DATED 08/31/2020. VERIFY SCOPE OF WORK WITH FINAL RFDS PRIOR TO CONSTRUCTION.

SCOPE OF WORK

| T-1 TITLE SHEET GN-1 GENERAL NOTES A-1 ROOF PLAN A-2 SOUTH, WEST & EAST ELEVATIONS A-3 CONSTRUCTION DETAILS A-4 GROUNDING DETAILS A-5 SMART TOOL SECTOR PLANS & ELEVATIONS SHEET INDEX | SHT. NO. | DESCRIPTION |
|---|-------------|--------------------------------------|
| GN-1 GENERAL NOTES A-1 ROOF PLAN A-2 SOUTH, WEST & EAST ELEVATIONS A-3 CONSTRUCTION DETAILS A-4 GROUNDING DETAILS A-5 SMART TOOL SECTOR PLANS & ELEVATIONS | | |
| A-1 ROOF PLAN A-2 SOUTH, WEST & EAST ELEVATIONS A-3 CONSTRUCTION DETAILS A-4 GROUNDING DETAILS A-5 SMART TOOL SECTOR PLANS & ELEVATIONS | T-1 | TITLE SHEET |
| A-1 ROOF PLAN A-2 SOUTH, WEST & EAST ELEVATIONS A-3 CONSTRUCTION DETAILS A-4 GROUNDING DETAILS A-5 SMART TOOL SECTOR PLANS & ELEVATIONS | | OFFICE MOTES |
| A-2 SOUTH, WEST & EAST ELEVATIONS A-3 CONSTRUCTION DETAILS A-4 GROUNDING DETAILS A-5 SMART TOOL SECTOR PLANS & ELEVATIONS | GN-1 | GENERAL NOTES |
| A-2 SOUTH, WEST & EAST ELEVATIONS A-3 CONSTRUCTION DETAILS A-4 GROUNDING DETAILS A-5 SMART TOOL SECTOR PLANS & ELEVATIONS | A-1 | ROOF PLAN |
| A-3 CONSTRUCTION DETAILS A-4 GROUNDING DETAILS A-5 SMART TOOL SECTOR PLANS & ELEVATIONS | | SOUTH, WEST & EAST ELEVATIONS |
| A-5 SMART TOOL SECTOR PLANS & ELEVATIONS | A-3 | CONSTRUCTION DETAILS |
| | A-4 | GROUNDING DETAILS |
| SHEET INDEX | A-5 | SMART TOOL SECTOR PLANS & ELEVATIONS |
| SHEET INDEX | | |
| | | SHEET INDEX |
| | No care | |



VERIZON WIRELESS 118 FLANDERS ROAD WESTBOROUGH, MA 01581-3956

> FRESH POND MA HD

| C | ONSTRUC ⁻ | TION DRAWINGS |
|---|----------------------|---------------|
| 5 | | FOR SUBMITTAL |
| 4 | 01/22/21 | FOR SUBMITTAL |
| 3 | | FOR SUBMITTAL |
| 2 | 01/04/21 | FOR SUBMITTAL |
| 1 | 12/10/20 | FOR SUBMITTAL |
| 0 | 06/02/20 | FOR SUBMITTAL |



Dewberry Engineers Inc. 99 SUMMER STREET SUITE 700 BOSTON, MA 02110 PHONE: 617.095.3400 FAX: 617.095.3310



| DRAWN BY: | AJB |
|-----------------|----------|
| REVIEWED BY: | JCM |
| CHECKED BY: | BBR |
| PROJECT NUMBER: | 50121487 |
| JOB NUMBER: | 50121678 |
| SITE ADDRESS: | |

545 CONCORD AVENUE CAMBRIDGE, MA 02138

SHEET TITLE

TITLE SHEET

SHEET NUMBER

T - 1

GENERAL CONSTRUCTION NOTES:

- ALL WORK SHALL CONFORM TO ALL CURRENT APPLICABLE FEDERAL, STATE, AND LOCAL CODES, AND COMPLY WITH VERIZON WIRELESS SPECIFICATIONS.
- CONTRACTOR SHALL CONTACT "DIG SAFE" (888-344-7233) FOR IDENTIFICATION OF UNDERGROUND UTILITIES PRIOR TO START OF CONSTRUCTION.
- 3. CONTRACTOR IS RESPONSIBLE FOR COORDINATING ALL REQUIRED INSPECTIONS.
- ALL DIMENSIONS TO, OF, AND ON EXISTING BUILDINGS, DRAINAGE STRUCTURES, AND SITE IMPROVEMENTS SHALL BE VERIFIED IN FIELD BY CONTRACTOR WITH ALL DISCREPANCIES REPORTED TO THE ENGINEER.
- DO NOT CHANGE SIZE OR SPACING OF STRUCTURAL ELEMENTS.
- DETAILS SHOWN ARE TYPICAL; SIMILAR DETAILS APPLY TO SIMILAR CONDITIONS UNLESS OTHERWISE NOTED.
- THESE DRAWINGS DO NOT INCLUDE NECESSARY COMPONENTS FOR CONSTRUCTION SAFETY WHICH IS THE SOLE
- CONTRACTOR SHALL BRACE STRUCTURES UNTIL ALL STRUCTURAL ELEMENTS NEEDED FOR STABILITY ARE INSTALLED. THESE ELEMENTS ARE AS FOLLOWS: LATERAL BRACING, ANCHOR BOLTS, ETC.
- CONTRACTOR SHALL DETERMINE EXACT LOCATION OF EXISTING UTILITIES, DRAIN PIPES, VENTS, ETC. BEFORE COMMENCING
- INCORRECTLY FABRICATED, DAMAGED, OR OTHERWISE MISFITTING OR NONCONFORMING MATERIALS OR CONDITIONS SHALL BE REPORTED TO THE OWNER PRIOR TO REMEDIAL OR CORRECTIVE ACTION. ANY SUCH REMEDIAL ACTION SHALL REQUIRE WRITTEN APPROVAL BY THE OWNER'S REPRESENTATIVE PRIOR TO PROCEEDING.
- 11. EACH CONTRACTOR SHALL COOPERATE WITH THE OWNER'S REPRESENTATIVE, AND COORDINATE HIS WORK WITH THE WORK
- 12. CONTRACTOR SHALL REPAIR ANY DAMAGE CAUSED BY CONSTRUCTION OF THIS PROJECT TO MATCH EXISTING PRE-CONSTRUCTION CONDITIONS TO THE SATISFACTION OF THE VERIZON WIRELESS CONSTRUCTION MANAGER
- 13. ALL CABLE/CONDUIT ENTRY/EXIT PORTS SHALL BE WEATHERPROOFED DURING INSTALLATION USING A SILICONE SEALANT.
- 14. WHERE EXISTING CONDITIONS DO NOT MATCH THOSE SHOWN IN THIS PLAN SET, CONTRACTOR WILL NOTIFY ENGINEER, VERIZON WIRELESS PROJECT CONSTRUCTION MANAGER, AND LANDLORD IMMEDIATELY.
- 15. CONTRACTOR SHALL ENSURE ALL SUBCONTRACTORS ARE PROVIDED WITH A CURRENT SET OF DRAWINGS AND SPECIFICATIONS FOR THIS PROJECT.
- ALL ROOF WORK SHALL BE DONE BY A QUALIFIED AND EXPERIENCED ROOFING CONTRACTOR IN COORDINATION WITH ANY
 CONTRACTOR WARRANTING THE ROOF TO ENSURE THAT THE WARRANTY IS MAINTAINED.
- 17. CONTRACTOR SHALL REMOVE ALL RUBBISH AND DEBRIS FROM THE SITE AT THE END OF EACH DAY.
- 18. CONTRACTOR SHALL COORDINATE WORK SCHEDULE WITH LANDLORD AND TAKE PRECAUTIONS TO MINIMIZE IMPACT AND DISRUPTION OF OTHER OCCUPANTS OF THE FACILITY.
- 19. CONTRACTOR SHALL FURNISH VERIZON WIRELESS WITH THREE AS-BUILT SETS OF DRAWINGS UPON COMPLETION OF WORK.
- 20. ANTENNAS AND CABLES ARE TYPICALLY PROVIDED BY VERIZON WIRELESS. PRIOR TO SUBMISSION OF BID, CONTRACTOR SHALL COORDINATE WITH PROJECT MANAGER TO DETERMINE WHAT, IF ANY, ITEMS WILL BE PROVIDED BY VERIZON WIRELESS. ALL ITEMS NOT PROVIDED BY VERIZON WIRELESS SHALL BE PROVIDED AND INSTALLED BY THE CONTRACTOR. CONTRACTOR WILL INSTALL ALL ITEMS PROVIDED BY VERIZON WIRELESS.
- 21. PRIOR TO SUBMISSION OF BID, CONTRACTOR WILL COORDINATE WITH VERIZON WIRELESS PROJECT MANAGER TO DETERMINE IF ANY PERMITS WILL BE OBTAINED BY VERIZON WIRELESS. ALL REQUIRED PERMITS NOT OBTAINED BY VERIZON WIRELESS MUST BE OBTAINED, AND PAID FOR, BY THE CONTRACTOR.
- 22. GENERAL CONTRACTOR SHALL HAVE A LICENSED HVAC CONTRACTOR START THE HVAC LINITS. SYNCHRONIZE THE GENERAL CONTRACTOR SHALL HAVE A LICENSED HAVE CONTRACTOR START THE HAVE UNITS, STRICHRONIZE THE
 THERMOSTATS, ADJUST ALL SETTINGS ON EACH UNIT ACCORDING TO VERIZON WIRELESS CONSTRUCTION MANAGER'S
 SPECIFICATIONS, AND THOROUGHLY TEST AND BALANCE EACH UNIT TO ENSURE PROPER OPERATION PRIOR TO TURNING
 THE SITE OVER TO OWNER.
- 23. CONTRACTOR SHALL INSTALL ALL SITE SIGNAGE IN ACCORDANCE WITH VERIZON WIRELESS SPECIFICATIONS AND
- 24. CONTRACTOR SHALL SUBMIT ALL SHOP DRAWINGS TO ENGINEER FOR REVIEW AND APPROVAL PRIOR TO FABRICATION.
- 25. UNIESS OTHERWISE NOTED VERIZON WIRELESS SHALL PROVIDE ALL REQUIRED RE MATERIAL FOR CONTRACTOR TO INSTALL INCLUDING ANTENNAS, TMA'S, BIAS—T'S, COMBINERS, PDU, DC BLOCKS, SURGE ARRESTORS, GPS ANTENNA, GPS SURGE ARRESTOR, COAXIAL CABLE.
- 26. PRIOR TO SUBMISSION OF BID, CONTRACTOR SHALL VERIFY ALL EQUIPMENT TO BE PROVIDED BY VERIZON WIRELESS FOR INSTALLATION BY CONTRACTOR.
- 27. ALL EQUIPMENT SHALL BE INSTALLED ACCORDING TO MANUFACTURER'S SPECIFICATIONS AND LOCATED ACCORDING TO VERIZON WIRELESS SPECIFICATIONS, AND AS SHOWN IN THESE PLANS.
- 28. DETAILS SHOWN ARE TYPICAL; SIMILAR DETAILS APPLY TO SIMILAR CONDITIONS UNLESS OTHERWISE NOTED.
- 29. THE CONTRACTOR SHALL SUPERVISE AND DIRECT THE PROJECT DESCRIBED HEREIN. THE CONTRACTOR SHALL BE SOLELY RESPONSIBLE FOR ALL THE CONSTRUCTION MEANS, METHODS, TECHNIQUES, SEQUENCES AND PROCEDURES AND FOR COORDINATING ALL PORTIONS OF THE WORK UNDER THE CONTRACT.
- 30. CONTRACTOR SHALL NOTIFY THE ENGINEER A MINIMUM OF 48 HOURS IN ADVANCE PRIOR TO CONSTRUCTION START, MORE SPECIFICALLY BEFORE, SEALING ANY FLOOR, WALL OR ROOF PENETRATION, FINAL UTILITY CONNECTIONS, POURING CONCRETE, BACKFILLING UTILITY TRENCHES AND STRUCTURAL POST OR MOUNTING CONNECTIONS, FOR ENGINEERING REVIEW
- 31. SEAL PENETRATIONS THROUGH FIRE RATED AREAS WITH UL LISTED D FIRE CODE APPROVED MATERIALS.
- 32. REPAIR ANY DAMAGE DURING CONSTRUCTION TO MATCH EXISTING PRE-CONSTRUCTION CONDITIONS TO THE SATISFACTION OF THE CONSTRUCTION MANAGER AND LANDLORD
- 33. ALL DISRUPTIVE WORK AND WORK WITHIN TENANT SPACES TO BE COORDINATED WITH BUILDING REPRESENTATIVE

CODE SPECIFICATIONS:

- ALL WORK SHALL COMPLY WITH THE FOLLOWING APPLICABLE CODES:
- MASSACHUSETTS STATE BUILDING CODE, 9TH EDITION, CONSISTENT WITH THE FOLLOWING CODES:
- 2015 INTERNATIONAL RESIDENTIAL CODE (IRC)
- 2015 INTERNATIONAL BUILDING CODE (IBC)
 2015 INTERNATIONAL EXISTING BUILDING CODE (IBC)
- 2020 NATIONAL ELECTRICAL CODE (NEC)
- IN THE EVENT OF CONFLICT, THE MOST RESTRICTIVE CODE SHALL PREVAIL.
- ALL STRUCTURAL WORK TO BE DONE IN ACCORDANCE WITH THE AMERICAN INSTITUTE OF STEEL CONSTRUCTION MANUAL, 13TH EDITION (AISC 13TH ED.)
- ALL CONCRETE WORK TO BE DONE IN ACCORDANCE WITH THE AMERICAN CONCRETE INSTITUTE (ACL 301) SPECIFICATIONS FOR STRUCTURAL CONCRETE FOR BUILDINGS (ACI 318) AND BUILDING CODE REQUIREMENTS FOR REINFORCED CONCRETE
- ALL REINFORCING STEEL WORK TO BE DONE IN ACCORDANCE WITH THE (ACI 315) MANUAL OF STANDARD PRACTICE FOR DETAILING REINFORCED CONCRETE STRUCTURES.

GROUNDING NOTES:

- 1. GROUNDING SHALL COMPLY WITH NEC ART. 250.
- GROUNDING CONDUCTORS SHALL BE #6 COPPER STRANDED WIRE WITH GREEN COLOR INSULATION FOR INDOOR USE.
- ALL GROUND CONNECTIONS TO BE BURNDY HYGROUND COMPRESSION TYPE CONNECTORS OR CADWELD EXOTHERMIC WELD DO NOT ALLOW BARE COPPER WIRE TO BE IN CONTACT WITH
- 4. ROUTE GROUNDING CONNECTORS ALONG THE SHORTEST AND STRAIGHTEST PATH POSSIBLE, EXCEPT AS OTHERWISE INDICATED. GROUNDING LEADS SHOULD NOT BE BENT AT RIGHT ANGLE. ALWAYS MAKE 12" RADIUS BENDS. #6 WIRE CAN BE BENT AT 6" RADIUS WHEN NECESSARY.
- CONNECTIONS TO GROUNDING BAR SHALL BE MADE WITH TWO HOLE COMPRESSION TYPE COPPER LUGS. APPLY OXIDE INHIBITING COMPOUND TO ALL LOCATIONS.
- TEST COMPLETED GROUNDING SYSTEM AND RECORD RESISTANCE VALUES FOR PROJECT CLOSE-OUT DOCUMENTATION. GROUND RESISTANCE SHALL NOT EXCEED 5 OHMS.
- GROUNDING CONDUCTORS BETWEEN MGB AND WATERMAIN SHALL BE #2/0. BONDING JUMPERS FROM METALLIC SURFACES SHALL BE #2 MINIMUM. ALL GROUND CONDUCTORS AND BONDING JUMPERS SHALL BE SOFT DRAWN ANNEALED, TINNED, BARE STRANDED COPPER WIRE. COAXIAL CABLES SHALL BE GROUNDED AT A MINIMUM OF TWO LOCATIONS USING VERIZON PROVIDED GROUNDING KITS. EXACT LOCATIONS SHALL BE FINALIZED IN THE FIELD BY THE CONSTRUCTION MANAGER.

STRUCTURAL STEEL NOTES:

- 1. STRUCTURAL STEEL SHALL CONFORM TO THE LATEST EDITION OF THE AISC "SPECIFICATION FOR THE DESIGN, FABRICATION AND ERECTION OF STRUCTURAL STEEL FOR BUILDINGS".
- 2. STRUCTURAL STEEL ROLLED SHAPES, PLATES, AND BARS SHALL CONFORM TO THE FOLLOWING ASTM

ALL W SHAPES, UNLESS NOTED OR A992 OTHERWISE.
ALL OTHER ROLLED SHAPES, PLATES AND BARS UNLESS NOTED OTHERWISE.
HSS SECTION (SOUARE, RECTANGULAR, ROUND)
ALL BOLTS FOR CONNECTING STRUCTURAL MEMBERS.
ALL ANCHORS BOLTS, UNLESS NOTED OTHERWISE.
STEEL PIPE ASTM A-992, GRADE 50 ASTM A-36 ASTM A-36 ASTM A-500, GRADE B ASTM A-325, TYPE SC OR N F1554, GRADE 36 ASTM A-53, GRADE B

- ALL WELDING SHALL BE DONE USING E70XX ELECTRODES AND WELDING SHALL CONFORM TO AISC AND AWS D1.1 WHERE FILLET WELD SIZES ARE NOT SHOWN, PROVIDE THE MINIMUM SIZE PER TABLE J2.4 IN THE AISC "MANUAL OF STEEL CONSTRUCTION", 14TH EDITION. WHERE WELD LENGTH IS NOT INDICATED, USE FULL LENGTH WELD. AT THE COMPLETION OF ALL WELDING, ALL DAMAGE TO GALVANIZED COATING SHALL BE REPAIRED.
- BOLTED CONNECTIONS SHALL USE BEARING TYPE GALVANIZED ASTM A325 BOLTS (3/4" DIA.) SUPPLIED WITH A NUT AND WASHER UNDER TURNED END AND SHALL HAVE MINIMUM OF TWO BOLTS UNLESS NOTED OTHERWISE.
- 5. DO NOT DRILL HOLES THROUGH STRUCTURAL STEEL MEMBERS EXCEPT AS SHOWN AND DETAILED ON
- NON-STRUCTURAL CONNECTIONS FOR STEEL GRATING MAY USE 5/8" DIA. GALVANIZED ASTM A 307 BOLTS UNLESS NOTED OTHERWISE.
- 7. USE PRECAUTIONS & PROCEDURES PER AWS D1.1 WHEN WELDING GALVANIZED METALS.
- ALL EXISTING BEAM AND COLUMN DIMENSIONS SHALL BE FIELD VERIFY BY CONTRACTOR PRIOR TO FABRICATION. ANY DISCREPANCIES BETWEEN EXISTING CONDITIONS AND THOSE SHOWN SHALL BE REPORTED TO DEWBERRY ENGINEER IMMEDIATELY.
- 9. CONNECTION DESIGN BY FABRICATOR WILL BE SUBJECT TO REVIEW AND APPROVAL BY ENGINEER.
- 10. ALL EXTERIOR STEEL WORK SHALL BE GALVANIZED IN ACCORDANCE WITH SPECIFICATION ASTM A123/A123M-00 HOT-DIP GALVANIZED FINISH UNLESS OTHERWISE NOTED. GALVANIZING SHALL BE PERFORMED AFTER SHOP FABRICATION TO THE GREATEST EXTENT POSSIBLE. ALL DINGS, SCRAPES, MARS, AND WELDS IN THE GALVANIZED AREAS SHALL BE REPAIRED. REPAIR DAMAGED GALVANIZED COATINGS ON GALVANIZED ITEMS WITH GALVANIZED
- 11. ALL WELDED COMPONENTS TO BE SHOP WELDED PRIOR TO INSTALLATION. NO WELDING ACTIVITIES IS PERMITTED DURING INSTALLATION OF PROPOSED EQUIPMENTS AND/OR HARDWARE ON SITE




VERIZON WIRELESS 118 FLANDERS ROAD WESTBOROUGH, MA 01581-3956

> **FRESH POND** MA HD

| | С | ONSTRUC | TION | DRAWINGS |
|---|---|----------|------|-----------|
| | 5 | 00/19/01 | EOP | SUBMITTAL |
| ı | 4 | | | SUBMITTAL |
| ı | 3 | 01/07/21 | FOR | SUBMITTAL |
| ı | 2 | 01/04/21 | FOR | SUBMITTAL |
| ١ | 1 | 12/10/20 | FOR | SUBMITTAL |
| ı | 0 | 06/02/20 | FOR | SUBMITTAL |



Dewberry Engineers Inc. 99 SUMMER STREET SUITE 700 PHONE: 617.695.3400 FAX: 617.695.3310

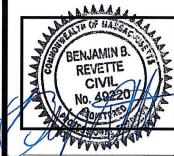

| DRAWN BY: | AJB |
|-----------------|----------|
| REVIEWED BY: | JCM |
| CHECKED BY: | BBR |
| PROJECT NUMBER: | 50121487 |
| JOB NUMBER: | 50121678 |

545 CONCORD AVENUE CAMBRIDGE, MA 02138


SHEET TITLE

SITE ADDRESS:

GENERAL NOTES

SHEET NUMBER

GN-1

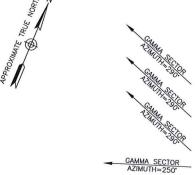


CONCORD AVENUE

| H | YBRID CABLE | SCHEDU | ILE* |
|--------|------------------------|---------------|----------------|
| SECTOR | HYBRID CABLE LENGTH | CABLE SIZE | CABLE COUNT |
| ALPHA | 205'± | 6x12 | 1 |
| ВЕТА | 205'± | 6x12 | 1 |
| GAMMA | 285'± | 6x12 | 1 |

*CONTRACTOR TO FIELD VERIFY HYBRID CABLE LENGTHS
PRIOR TO CONSTRUCTION. LENGTH IS ESTIMATED FROM THE
BASE EQUIPMENT OVP TO SECTOR OVP. NO HYBRID CABLES
ARE PROPOSED UNDER CURRENT SCOPE OF WORK.
CALCULATION BY: AJB

NOTES:

- . SOME EXISTING AND PROPOSED INFORMATION NOT SHOWN FOR CLARITY.
- 2. NORTH ARROW SHOWN AS APPROXIMATE.
- EXISTING ANTENNAS SHOWN AS APPROXIMATE. ELEVATION BASED ON EXISTING INFORMATION AND VISUAL INSPECTION AND HAVE NOT BEEN VERIFIED THROUGH AN ANTENNA MAPPING.
- ROOF PLAN BASED ON SITE VISIT ON 04/07/20 AND RFDS TITLED "FRESH_POND_MA" DATED 08/31/20.
- REUSE EXISTING ANTENNA MOUNTS AND COAX. INSPECT FOR DAMAGE OR DECAY AND REPLACE AS NEEDED.
- INSTALL PROPOSED EQUIPMENT IN ACCORDANCE WITH THE STRUCTURAL ASSESSMENT LETTER BY DEWBERRY DATED 12/08/20, FINAL MOUNT ANALYSIS REPORT BY MASER CONSULTING DATED 12/01/20, AND IN ACCORDANCE WITH MANUFACTURER RECOMMENDATIONS.
- ALL ANTENNAS TO BE PAINTED TO MATCH EXISTING BUILDING COLOR & TEXTURE. PROPOSED VZS01 ANTENNAS TO UTILIZE 3M WRAP TO MATCH.

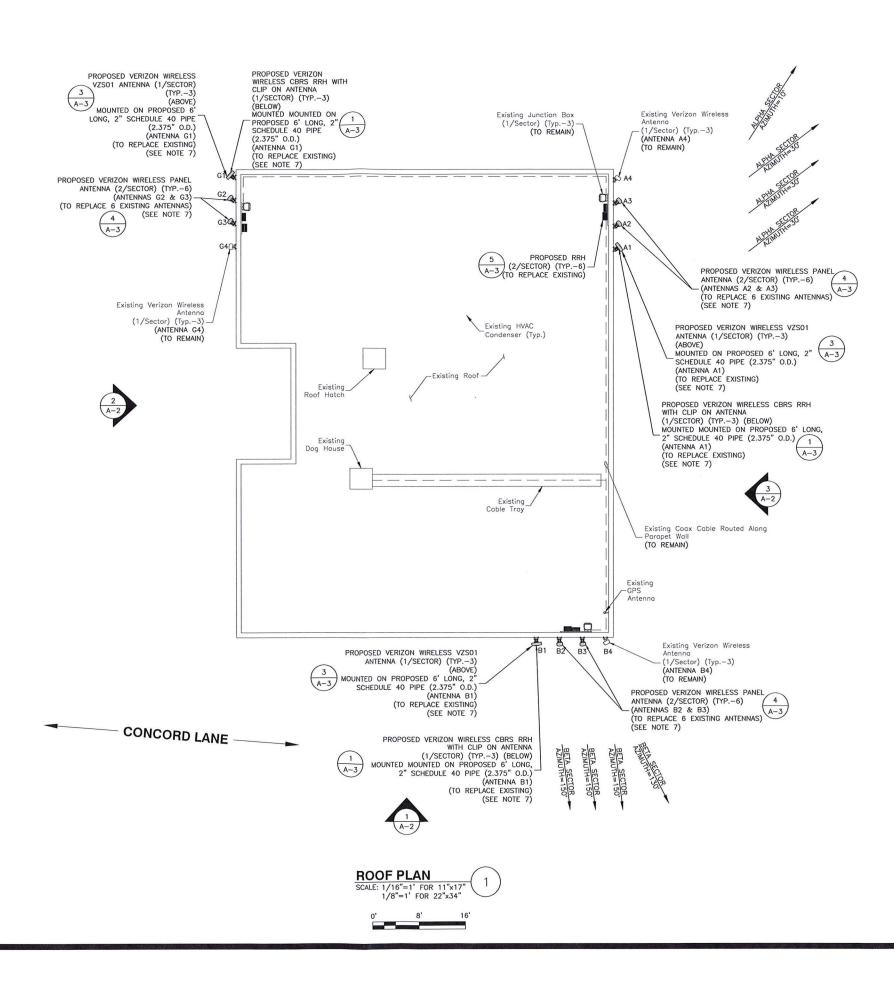




VERIZON WIRELESS 118 FLANDERS ROAD WESTBOROUGH, MA 01581-3956

FRESH POND MA HD

| | C | ONSTRUC [*] | ΓΙΟΝ | DRAWINGS |
|-----|---|----------------------|------|-----------|
| - | | | | |
| - 1 | 5 | | | SUBMITTAL |
| - | 4 | | | SUBMITTAL |
| - | 3 | | | SUBMITTAL |
| - | 2 | | | SUBMITTAL |
| | 1 | 12/10/20 | FOR | SUBMITTAL |
| - | 0 | 06/02/20 | FOR | SUBMITTAL |



Dewberry Engineers Inc. 99 SUMMER STREET SUITE 700 BOSTON, MA 02110 PHONE: 017.095.3400 FAX: 017.095.3310

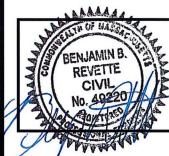

| DRAWN BY: | AJE |
|-----------|-----|
|-----------|-----|

REVIEWED BY: JCM

CHECKED BY: BBR

PROJECT NUMBER: 50121487

JOB NUMBER: 50121678

SITE ADDRESS:


545 CONCORD AVENUE CAMBRIDGE, MA 02138

SHEET TITLE

ROOF PLAN

SHEET NUMBER

A-1

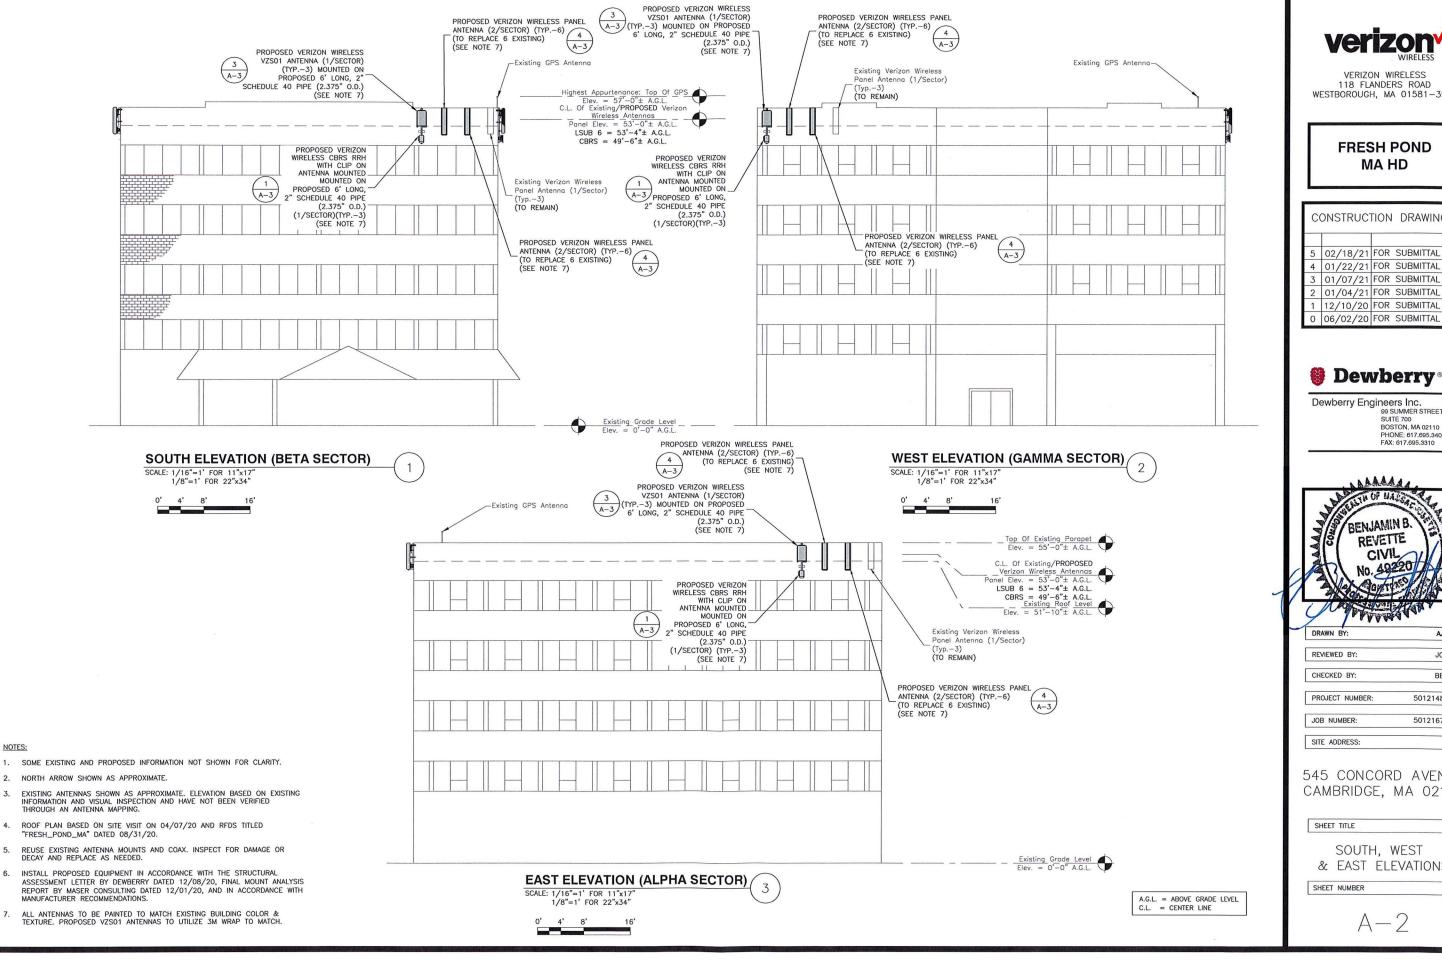

verizon^v


VERIZON WIRELESS 118 FLANDERS ROAD WESTBOROUGH, MA 01581-3956

> FRESH POND MA HD

CONSTRUCTION DRAWINGS 5 02/18/21 FOR SUBMITTAL 4 01/22/21 FOR SUBMITTAL 3 01/07/21 FOR SUBMITTAL 2 01/04/21 FOR SUBMITTAL 1 12/10/20 FOR SUBMITTAL




Dewberry Engineers Inc. 99 SUMMER STREET SUITE 700 BOSTON, MA 02110 PHONE: 617.695.3400 FAX: 617.695.3310

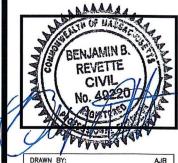

JCM BBR 50121487 50121678

545 CONCORD AVENUE CAMBRIDGE, MA 02138

& EAST ELEVATIONS

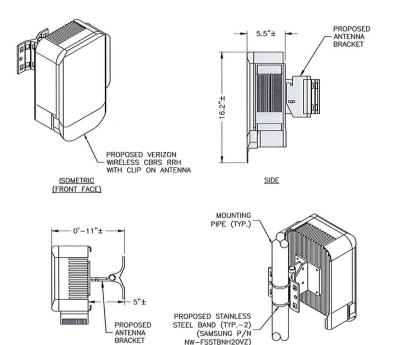


NOTES:

PLAN


- INSTALL ALL EQUIPMENT PER MANUFACTURER'S RECOMMENDATIONS. USE APPROPRIATE MOUNTING HARDWARE FOR CONSTRUCTION TYPE.
- ANTENNAS ARE SHOWN PERPENDICULAR TO BUILDING FACADE. ANTENNAS WILL BE REQUIRED TO BE PANNED TO MEET REQUIRED AZIMUTHS.
- 3. ANTENNA WEIGHT: 20 LBS.
- CONTRACTOR TO UTILIZE 3M WRAP FOR ALL ANTENNAS TO MATCH SURROUNDING AREAS, INSTALL 3M WRAP ON ANTENNAS PER MANUFACTURER'S SPECIFICATION & RECOMMENDATIONS.



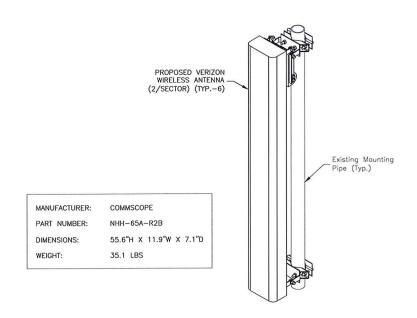

ISOMETRIC (REAR FACE)




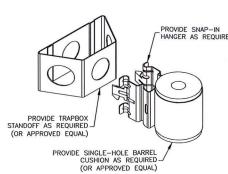

NOTE:

 PROVIDE C-CLAMP SUPPORTS & STAINLESS STEEL HOSE CLAMPS AS REQUIRED BY SITE CONDITIONS.

NR HRU JUMPER MOUNT SCALE: N.T.S. 2

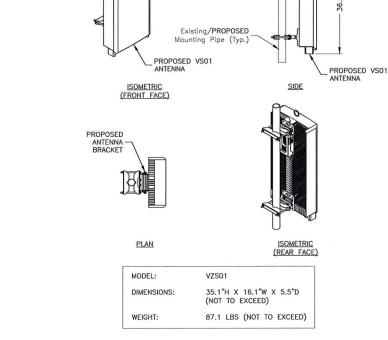


NOTES:

I. INSTALL ALL EQUIPMENT PER MANUFACTURER'S RECOMMENDATIONS. USE APPROPRIATE MOUNTING HARDWARE FOR CONSTRUCTION TYPE.

---- 5.51"±

VZS01 PIPE MOUNTED ANTENNA DETAIL

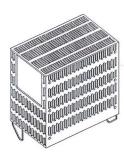

LTE 700/850

| MANUFACTURER: | SAMSUNG |
|---------------|-------------------------|
| MODEL: | 700/850 RRH |
| DIMENSIONS: | 15.0"H X 15.0"W X 8.1"D |
| WEIGHT: | 82.0 LBS |

NOTE:

LTE PCS/AWS RRH

97.5 LBS

15.0"H X 15.9"W X 10.0"D

LTE PCS/AWS

MANUFACTURER: SAMSUNG

MODEL:

WEIGHT:

DIMENSIONS:

 CONTRACTOR TO VERIFY WITH CONSTRUCTION MANAGER FOR FINAL MANUFACTURER SPECIFICATIONS PRIOR TO CONSTRUCTION.

REMOTE UNIT DETAILS SCALE: N.T.S. 5




VERIZON WIRELESS 118 FLANDERS ROAD WESTBOROUGH, MA 01581-3956

FRESH POND MA HD

| CONSTRUCTION DRAWINGS | | | | | |
|-----------------------|----------|-----|-----------|--|--|
| 5 | 02/18/21 | FOR | SUBMITTAL | | |
| 4 | 01/22/21 | FOR | SUBMITTAL | | |
| 3 | | | SUBMITTAL | | |
| 2 | 01/04/21 | FOR | SUBMITTAL | | |
| 1 | | | SUBMITTAL | | |
| 0 | 06/02/20 | FOR | SUBMITTAL | | |



Dewberry Engineers Inc. 99 SUMMER STREET SUITE 700 BOSTON, MA 02110 PHONE: 617.695.3400 FAX: 617.695.3310

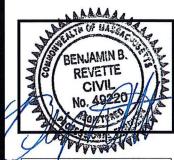

| DRAWN BY: | AJB |
|--------------|-----|
| REVIEWED BY: | JCM |

CHECKED BY: BBR

PROJECT NUMBER: 50121487

JOB NUMBER: 50121678

SITE ADDRESS:


545 CONCORD AVENUE CAMBRIDGE, MA 02138

SHEET TITLE

CONSTRUCTION DETAILS

SHEET NUMBER


A-3

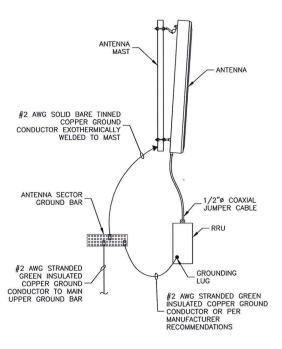

NOTES:

- VERIFY EXISTING GROUNDING SYSTEM IS INSTALLED PER VERIZON WIRELESS STANDARDS.
- BOND NEW EQUIPMENT INTO EXISTING GROUND SYSTEM IN ACCORDANCE WITH VERIZON WIRELESS STANDARDS AND MANUFACTURER'S RECOMMENDATIONS.




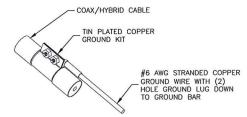

NOTE

- DO NOT INSTALL CABLE GROUND KIT AT A BEND. ALWAYS DIRECT GROUND WIRE DOWN TO GROUND BAR.
- 2. GROUNDING KIT SHALL BE TIN PLATED COPPER WITH TWO-HOLE LUG, SIZE PER COAX DIAMETER.
- 3. WEATHER SEAL GROUND KIT PER CARRIER REQUIREMENTS.
- COAX CABLE GROUND KIT LOCATION & QUANTITY SHALL BE PER CARRIER SPECIFICATIONS & STANDARDS.




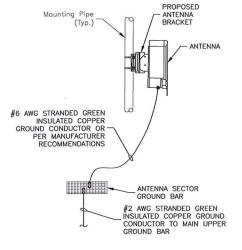

NOTES:

- 1. VERIFY EXISTING GROUNDING SYSTEM IS INSTALLED PER VERIZON WIRELESS STANDARDS.
- 2. BOND NEW EQUIPMENT INTO EXISTING GROUND SYSTEM IN ACCORDANCE WITH VERIZON WIRELESS STANDARDS AND MANUFACTURER'S RECOMMENDATIONS.



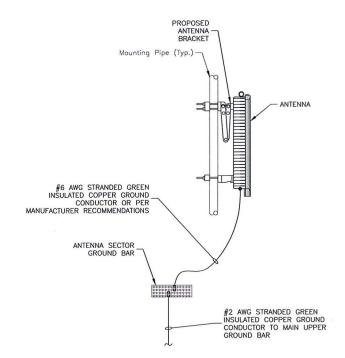

NOTES:

- 1. VERIFY EXISTING GROUNDING SYSTEM IS INSTALLED PER VERIZON WIRELESS STANDARDS.
- BOND NEW EQUIPMENT INTO EXISTING GROUND SYSTEM IN ACCORDANCE WITH VERIZON WIRELESS STANDARDS AND MANUFACTURER'S RECOMMENDATIONS.






VERIZON WIRELESS 118 FLANDERS ROAD WESTBOROUGH, MA 01581-3956

FRESH POND MA HD

| CONSTRUCTION DRAWINGS | | | | | | |
|-----------------------|----------|---------------|--|--|--|--|
| 5 | 02/18/21 | FOR SUBMITTAL | | | | |
| 4 | 01/22/21 | FOR SUBMITTAL | | | | |
| 3 | | FOR SUBMITTAL | | | | |
| 2 | 01/04/21 | FOR SUBMITTAL | | | | |
| 1 | 12/10/20 | FOR SUBMITTAL | | | | |
| 0 | 06/02/20 | FOR SUBMITTAL | | | | |



Dewberry Engineers Inc. 98 SUMMER STREET SUITE 700 BOSTON, MA 02110 PHONE: 617.695.3400 FAX: 617.695.3310

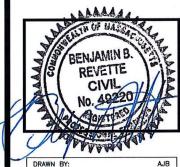

| DICAME DE. | 700 |
|-----------------|----------|
| REVIEWED BY: | JCM |
| CHECKED BY: | BBR |
| PROJECT NUMBER: | 50121487 |
| JOB NUMBER: | 50121678 |
| CITE ADDDECC: | |


545 CONCORD AVENUE CAMBRIDGE, MA 02138


SHEET TITLE


GROUNDING DETAILS

SHEET NUMBER

A-4

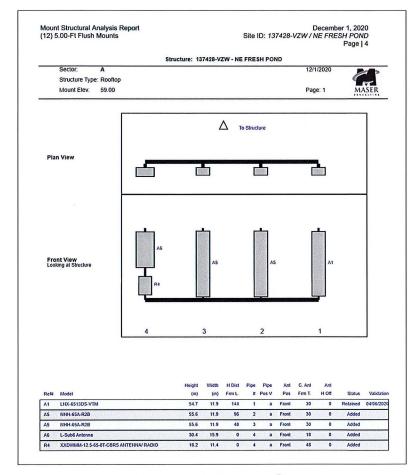

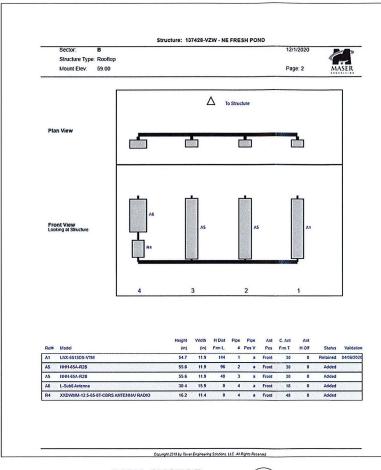

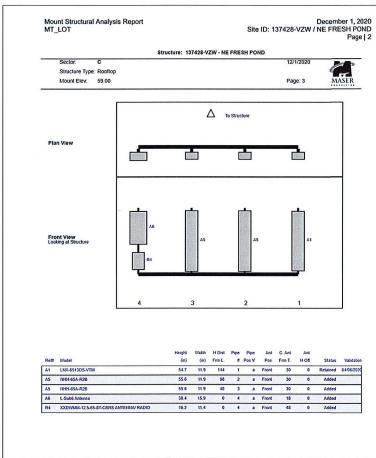

ALPHA SECTOR
SCALE: N.T.S.

BETA SECTOR
SCALE: N.T.S.

2

GAMMA SECTOR
SCALE: N.T.S.

3)

NOTE:

 SECTOR PLANS AND ELEVATIONS TAKEN FROM MOUNT ANALYSIS: SMART TOOL# 10009990, MASER PROJECT # 20777022A, FUZE # 16070588 BY MASER CONSULTING P.A. DATED 10/09/2020.




VERIZON WIRELESS 118 FLANDERS ROAD WESTBOROUGH, MA 01581-3956

FRESH POND MA HD

| С | ONSTRUC [*] | ΓΙΟΝ | DRAWINGS |
|---|----------------------|------|-----------|
| 5 | 02/18/21 | FOR | SUBMITTAL |
| 4 | | | SUBMITTAL |
| 3 | 01/07/21 | FOR | SUBMITTAL |
| 2 | 01/04/21 | FOR | SUBMITTAL |
| 1 | 12/10/20 | FOR | SUBMITTAL |
| 0 | 06/02/20 | FOR | SUBMITTAL |



Dewberry Engineers Inc. 99 SUMMER STREET SUITE 700 BOSTON, MA 02110 PHONE: 617.095.3400 FAX: 617.695.3310

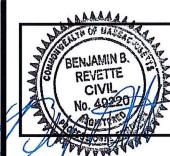

| DRAWN BY: | AJB |
|-----------------|----------|
| REVIEWED BY: | JCM |
| CHECKED BY: | BBR |
| PROJECT NUMBER: | 50121487 |
| JOB NUMBER: | 50121678 |
| SITE ADDRESS: | |


545 CONCORD AVENUE CAMBRIDGE, MA 02138

SHEET TITLE

SMART TOOL SECTOR PLANS & ELEVATIONS

SHEET NUMBER

A - 5

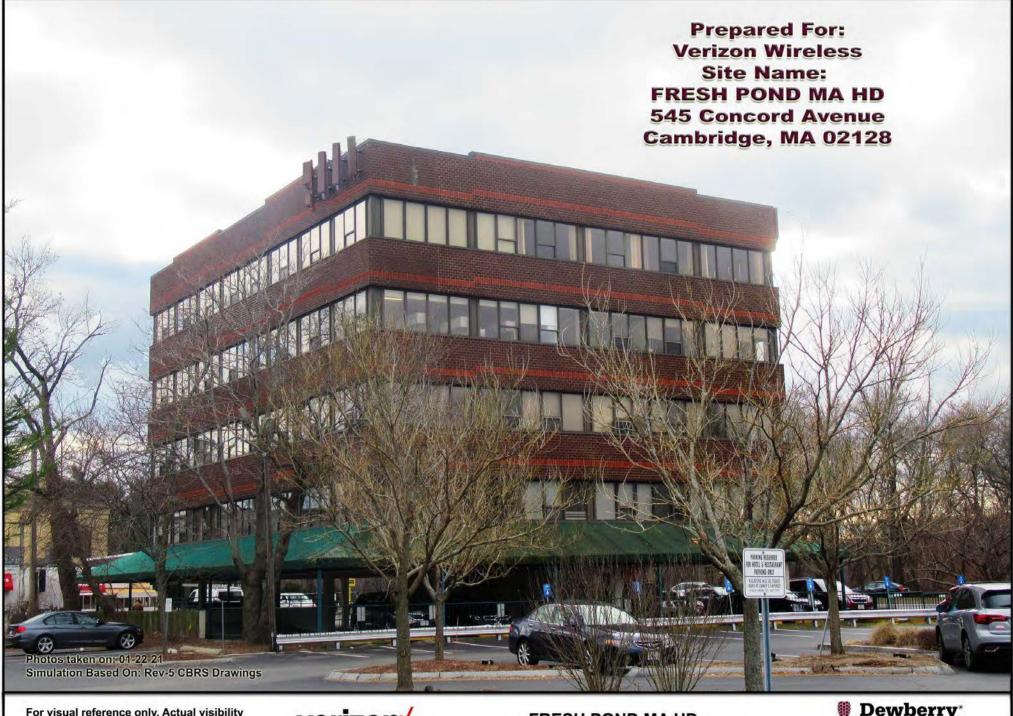

For visual reference only. Actual visibility is dependent upon weather conditions, season, sunlight, and viewer location.




FRESH POND MA HD

DEWBERRY NO. 50121497 (Page 1 of 8)



Dewberry Engineers Inc. 99 Summer St. Suite 700 Boston, MA 02110

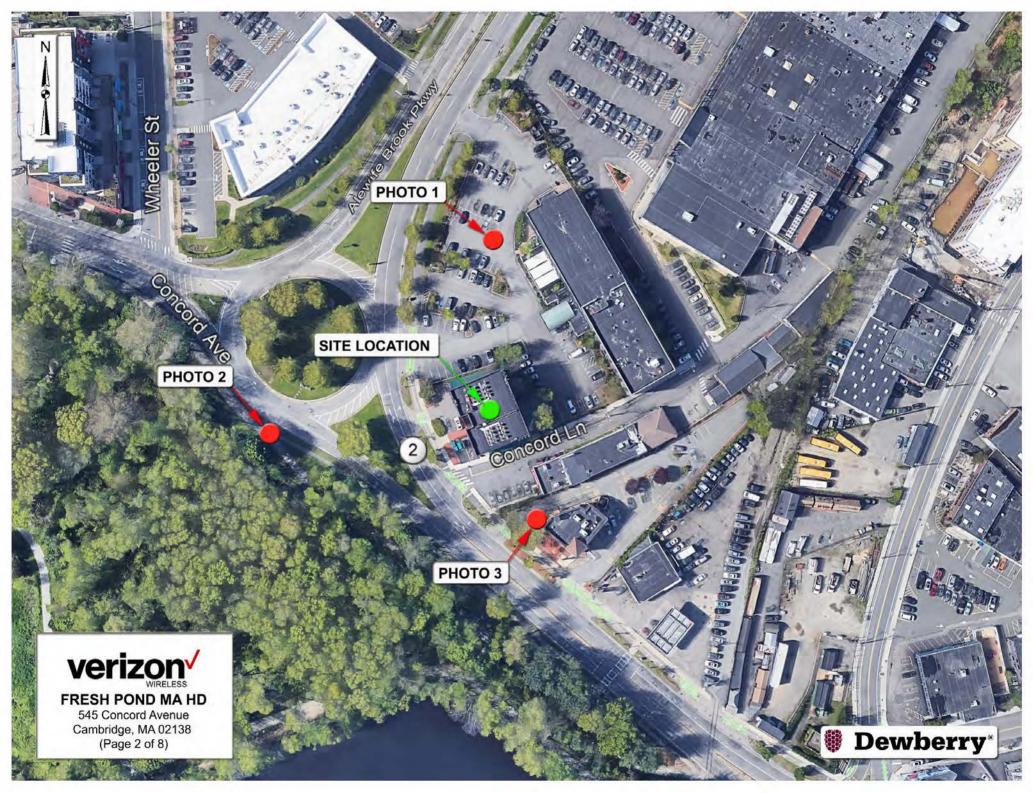





Proposed Alpha Sector Panel Antenna (Typ.-2) (To Replace Existing)

Existing Alpha Sector Antenna (Typ.-1) (To Remain)

Proposed Alpha Sector VZS01 Antenna

Proposed Alpha Sector CBRS RRU With Clip On Antenna



FRESH POND MA HD Photo 1B

View Facing South From Northern Parking Lot (Page 4 of 8)













Application
For
Modification to
Special Permit

545 Concord Avenue Cambridge, MA



Daniel D. Klasnick

Licensed in Massachusetts, New Hampshire and New York Desk: (781) 873-0021 - Mobile: (774) 249-2814 dklasnick@dkt-legal.com

March 7, 2021

City of Cambridge Board of Zoning Appeals 831 Massachusetts Avenue Cambridge, Massachusetts 02139

Re: **Application for Modification to Special Permit Building Mounted Mobile Communications Facility** Located at 545 Concord Avenue, Cambridge, Massachusetts

Dear Board Members:

Enclosed please find an Application to the Board of Zoning Appeals for a special permit for the modification of an existing building mounted mobile communications facility submitted on behalf of Cellco Partnership d/b/a Verizon Wireless.

In accordance with the Application requirements, please find enclosed the following:

- Application;
- Support Statements;
- Assessors GIS Block Map;
- Dimensional Form;
- Ownership Certificate, Notarized;
- Stamped Project Plans; and
- **Photo Simulations**

The Applicant would be happy to provide any additional information that you may require and would appreciate reasonable notice of any additional information you require in time to provide such information for the public hearing.

Should you require any additional information, please don't hesitate to contact me. Thank you very much for your cooperation.

Very truly yours,

DUVAL & KLASNICK LLC

Daniel D. Klasnick By:

Attorney at Law

GENERAL INFORMATION

| Special | Permit | : <u>X</u> | Variance: | Appe | eal: | |
|----------------------|-----------------------------|--|---|--|---------------------|-------|
| PETITION | ER: C | ellco Part | nership d/b/a Verizon Wirel | ess | | |
| PETITION | IER'S A | DDRESS: | c/o Duval & Klasnick LLC, | P.O. Box 254, Boxford, M | A 01921 | |
| LOCATION | OF PR | OPERTY: | 545 Concord Avenue | | | |
| | | F | obile Communications acility | ZONING DISTRICT: | Business A | |
| REASON E | | ddition: | 9 | | New Struct | ura |
| | | | n Use/Occupancy | | New Struct | ule |
| | | | on to Addi'l Dwellin | | Farking Sign | |
| | | | on to Addi i Dwellin | .g onit s | Sign Subdivision | n |
| _ | | ormer | | | | [] |
| | | _ | Mobile Communications Fac inder Section 6409(a) of Fed | | equest | |
| ESCRIP | ION OF | ' PETITI | ONER'S PROPOSAL: | | | |
| SECTIONS | of zo | NING OF | DINANCE CITED: | | | |
| | | - | 4.32.G.1 & Sec. 4.40 (Foo | | cations Facility) | _ |
| | | • | n 10.40 - 10.46 (Special Pe | | | _ |
| Article | 6409(a) | Section | n Middle Class Tax Relief | and Job Creation Act (al | ka Spectrum Act) | _ |
| Applicar Applicar | nts for nts fo onal S | a <mark>Spec</mark> r an ervices | ance must complete Pial Permit must compAppeal to the BZA Department must att | lete Pages 1-4 and of a Zoning d | etermination | |
| | | Or | ginal Signature(s): | /s/ Daniel D. Klasnick | | |
| | | | | (Petitione Daniel D. Klasnick attorne d/b/a Verizon Wireless | | , |
| | | | Address: | (Prin P.O. Box 254 | t Name) | |
| | | | Address: | Boxford, MA 01921 | | |
| | | | Tel. No.: | (781) 873-0021 | | |
| | | | | ress: dklasnick@dkt-legal | Lcom | |
| | | | E-Mail Add | LESS: UNIUSINCA WURI-10gd | | |
| ate: | March 7, | 2021 | | | | |

SUPPORTING STATEMENT FOR A SPECIAL PERMIT

Please describe in complete detail how you meet each of the following criteria referring to the property and proposed changes or uses which are requested in your application. Attach sheets with additional information for special permits which have additional criteria, e.g.; fast food permits, comprehensive permits, etc., which must be met.

Granting the Special Permit requested for _________ 545 Concord Avenue ______ (location) would not be a detriment to the public interest because:

A) Requirements of the Ordinance can or will be met for the following reasons:

As demonstrated by the documents provided with this application and will be further discussed at the hearing on this matter, the modification satisfies the standards for an Eligible Facilities Request pursuant to Section 6409(a) of the Federal Spectrum Act. The proposed modification also satisfies the standards for the grant of a special permit. (For further details, please see attached narrative and supporting documents)

B) Traffic generated or patterns of access or egress would not cause congestion hazard, or substantial change in established neighborhood character for the following reasons:

The modification of the unmanned facility will not change existing traffic demand or impact ingress or egress. The modified facility will continue to generate only about one to two vehicles trips per month in a standard passenger vehicle. (For further details, please see attached narrative and supporting documents)

C) The continued operation of or the development of adjacent uses as permitted in the Zoning Ordinance would not be adversely affected by the nature of the proposed use for the following reasons:

The modified facility will have no adverse effects on the operation or development of adjacent uses. The modified facility will emit no light, odor, dust or glare and generates no unusual noise or other adverse impacts. (For further details, please see attached narrative and supporting documents)

Nuisance or hazard would not be created to the detriment of the health, safety and/or welfare of the occupant of the proposed use or the citizens of the City for the following reasons:

The modified facility will generate no additional traffic or other negative impacts on surrounding properties or within the City of Cambridge. The facility requires no water or sewer services and emits no light, odor, dust or glare and generates no unusual noise or other adverse impacts. The facility will be unoccupied with no employees or customers. The availability of wireless services enhances the health, safety and welfare of the community. (For further details, please see attached narrative and supporting documents)

E) For other reasons, the proposed use would not impair the integrity of the district or adjoining district or otherwise derogate from the intent or purpose of this ordinance for the following reasons:

The facility has been designed to minimize its visual impact and is in harmony with the general purpose of the zoning ordinance for this use and in accordance with the requirements for an Eligible Facilities Request under Section 6409(a). (*Please see attached narrative and supporting documents*)

(ATTACHMENT B - PAGE 6)

DIMENSIONAL INFORMATION

APPLICANT: Cellco Partnership d/b/a Verizon Wireless PRESENT USE/OCCUPANCY: Mobile Communications Facility 545 Concord Avenue **Business A** LOCATION: ZONE: REQUESTED USE/OCCUPANCY: Mobile Communications Facility PHONE: (781) 873-0021 EXISTING REQUESTED ORDINANCE CONDITIONS CONDITIONS REQUIREMENTS¹ N/A No Change N/A TOTAL GROSS FLOOR AREA: (max.) N/A N/A LOT AREA: (min.) RATIO OF GROSS FLOOR AREA N/A N/A No Change TO LOT AREA: (max.) No Change N/A N/A LOT AREA FOR EACH DWELLING UNIT: (min.) N/A N/A SIZE OF LOT: WIDTH (min.) DEPTH N/A N/A No Change Setbacks in FRONT (min.) Feet: No Change N/A N/A REAR (min.) N/A N/A No Change LEFT SIDE (min.) N/A N/A No Change RIGHT SIDE (min.) N/A No Change N/A SIZE OF BLDG.: HEIGHT (max.) LENGTH WIDTH RATIO OF USABLE OPEN SPACE TO LOT AREA: 3) N/A N/A No Change (min.) No Change N/A NO. OF DWELLING UNITS: N/A (max.) No Change N/A N/A NO. OF PARKING SPACES: (min./max) No Change N/A N/A NO. OF LOADING AREAS: (min.) N/A N/A No Change DISTANCE TO NEAREST BLDG. (min.) ON SAME LOT: Describe where applicable, other occupancies on same lot, the size of adjacent buildings on same lot, and type of construction proposed, e.g.; wood frame, concrete, brick, steel, etc. The proposed installation involves the modification of an existing Mobile Communications Facility that satisfies the standards of an eligible facilities request under Section 6409(a) of the Federal Spectrum Act.

^{1.} SEE CAMBRIDGE ZONING ORDINANCE ARTICLE 5.000, SECTION 5.30 (DISTRICT OF DIMENSIONAL REGULATIONS).

^{2.} TOTAL GROSS FLOOR AREA (INCLUDING BASEMENT 7'-0" IN HEIGHT AND ATTIC AREAS GREATER THAN 5') DIVIDED BY LOT AREA.

^{3.} OPEN SPACE SHALL NOT INCLUDE PARKING AREAS, WALKWAYS OR DRIVEWAYS AND SHALL HAVE A MINIMUM DIMENSION OF 15'.

CHECK LIST

PROPERTY LOCATION: 545 Concord Avenue

DATE: March 7, 2021

| PETITIONER OR REPRESENTATIVE: Cellco Partnership d/b/a Ver | | | | |
|---|--------------|--------------|-----------------------|--------|
| ADDRESS & PHONE: (781) 873-0021 - Daniel D. Klasnick, Esquire | | | | |
| BLOCK: 265A LOT | :31 | | | |
| PLEASE CHECK THAT YOU HAVE INCLUDED THE FOLLOWING WILL NOT BE ACCEPTED FOR PROCESSING & SCHEDULING PROVIDED. | | | APPLICAT DOCUMENTS | |
| PLEASE INCLUDE THIS CHECKLIST WITH YOUR APPLICATION. ALL DOCUMENTS ARE TO BE TYPED OR WRITTEN LEGIBLY. | | | | |
| DOCUMENTS | REQUIRED | | ENCLOSED |) - |
| Application Form 3 Forms with Original Signatures | _X | | X | - |
| Supporting Statements - Scanned & 1 set to Zoning | _X | | X | - |
| Application Fee (You will receive invoice online) | X | | X | _ |
| Assessor's GIS "Block Map" (Available on line or At Engineering Dept 147 Hampshire Street) | X | | X | - |
| Dimensional Form - Refer to Cambridge Zoning Ordinance - Scanned & 1 set to Zoning (Subject to further review by Zoning Specialist) | _X | | _X | - |
| Ownership Certificate, Notarized - Scanned & 1 set to Zoning | _X | | X | - |
| Floor Plans - Scanned & 1 set to Zoning | _X | | X | _ |
| Elevations - Scanned & 1 set to Zoning | _X | | X | _ |
| Certified Plot Plan - Scanned & 1 set to Zoning (By Registered Land Surveyor) | _X | | X | - |
| Photographs of Property - Scanned & 1 set to Zoning | _X | | _X | _ |
| Parking Plan (if relevant to your application) Scanned & 1 set to Zoning | _N/A | | N/A | - |
| FOR SUBDIVISION ALSO INCLUDE: Scanned & 1 set to Zoni: | ng | | | |
| Proposed Deeds | N/A | | N/A | _ |
| Evidence of Separate Utilities ** | N/A | | N/A | _ |
| Proposed Subdivision Plan | N/A | | N/A | _ |
| Petitioners are advised to refer to Attachment A (Pr | cocedures fo | r applying | g to the B | oard |


d

of Zoning Appeal) & consult zoning staff for review.

It is advisable for the Petitioner to discuss the petition with the abutters as listed in the Zoning BZA Case file.

 $^{^{\}star}$ For Special Permits under Art. 4.32.G.1 (Communication Towers and Antennas), include a photo simulation.

^{**} Can be submitted after subdivision has been approved.

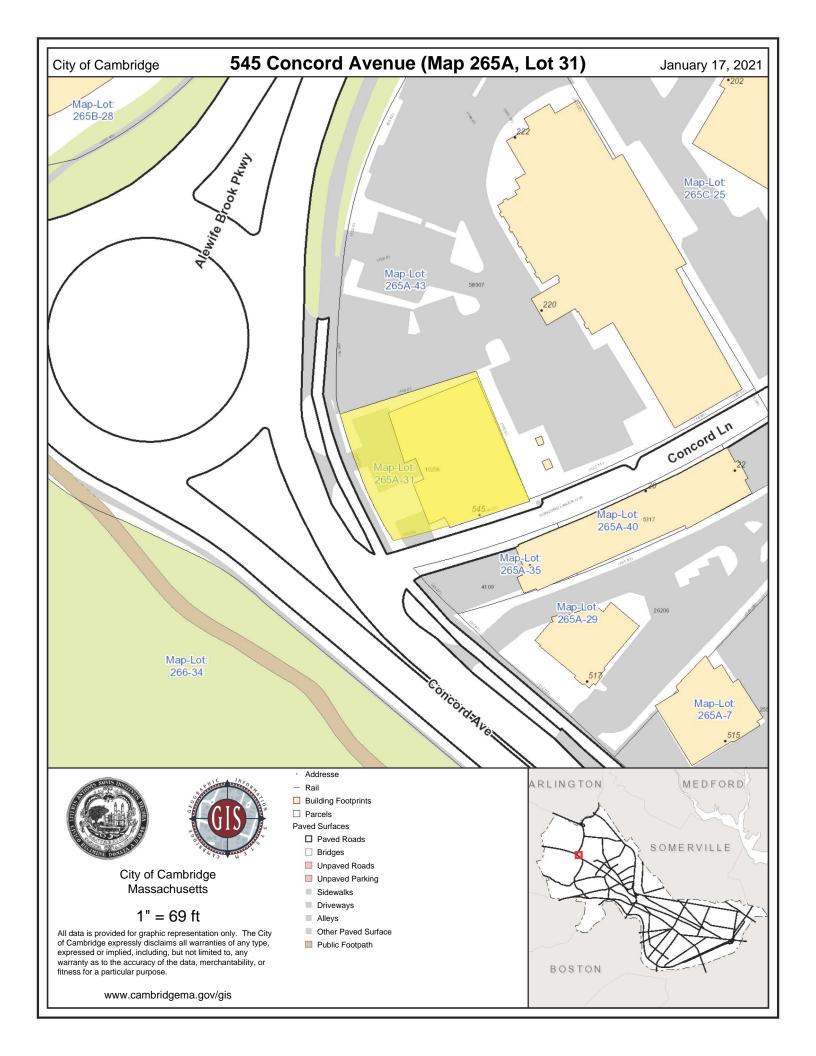

CITY OF CAMBRIDGE

NARRATIVE IN SUPPORT OF APPLICATION TO MODIFY SPECIAL PERMIT

APPLICANT: Cellco Partnership d/b/a Verizon Wireless

SITE ADDRESS: 545 Concord Avenue

Cambridge, Massachusetts

ASSESSOR'S LOT I.D.: Map 265A, Lot 31

ZONING DISTRICT: Business A

BACKGROUND

This Narrative in Support of an Application to Modify Special Permit, *while reserving all rights*, to modify an existing building mounted mobile communications facility ("Facility") is respectfully submitted by Cellco Partnership d/b/a Verizon Wireless ("Verizon Wireless") to the City of Cambridge, Board of Zoning Appeal ("Board"). Verizon Wireless seeks approval to further modify its existing Facility approved by special permit Case No: #7530 on the existing building at 545 Concord Avenue (the "Property").

This application is submitted with full reservation of Verizon Wireless' rights including without limitation Section 6409(a) of the federal Middle Class Tax Relief and Job Creation Act of 2012 also referred to as the "Spectrum Act." The Spectrum Act was passed to "advance wireless broadband service" for both public safety and commercial purposes. The modification to the existing Facility satisfies the standards for the modification of an eligible facility under the Spectrum Act.

APPLICANT'S INTEREST IN THE PROPERTY

Alewife Properties, LLC ("Owner") and Cellco Partnership d/b/a Verizon Wireless entered into a certain Lease Agreement by which Owner leased to Verizon Wireless building space and access/utility easement rights on a portion of the Owner's property located at 545 Concord Avenue being shown on Tax Map of the City of Cambridge at Map 265A, Lot 31 for the location of Verizon Wireless' antennas and space for its equipment.

See Exhibit 1, ZBA Application Form - Ownership Information.

PROJECT DESCRIPTION

As noted on the attached plans and described in this application, the building owned by Alewife Properties, LLC is a 4-story brick building used for office purposes (the "Building"). Verizon Wireless has installed and operates an existing Facility consisting of 3 sectors of 4 antennas each (12 in total) and an equipment room in the Building. The existing antennas are installed on 3 separate facade mounts (painted to match) on the side of the Building.

Facility Modification Details Total of Fifteen (15) Antennas with Remote Radio Heads

Verizon Wireless proposes to façade mount a total of fifteen (15) antennas (painted or covered to match color and texture of building) through replacing nine (9) façade mounted antennas and installing twelve (12) new façade mounted antennas with six (6) remote radio heads mounted behind the parapet on the rooftop as follows:

(a) Alpha Sector

Remove 3 façade mounted antennas. Install 4 new façade mounted antennas (painted and covered to match color and texture of building) with 2 antennas mounted to the existing pipe mounts, 2 antennas stack mounted on a pipe mount all at a top height to match the existing antennas. Install 2 remote radio heads on the rooftop behind the parapet. Total: 5 antennas and 2 remote radio heads. – *See Roof Plan Sheet A-1*.

(b) Beta Sector

Remove 3 façade mounted antennas. Install 4 new façade mounted antennas (painted and covered to match color and texture of building) with 2 antennas mounted to the existing pipe mounts, 2 antennas stack mounted on a pipe mount all at a top height to match the existing antennas. Install 2 remote radio heads on the rooftop behind the parapet. Total: 5 antennas and 2 remote radio heads. – *See Roof Plan Sheet A-1*.

(c) Gamma Sector

Remove 3 façade mounted antennas. Install 4 new façade mounted antennas (painted and covered to match color and texture of building) with 2 antennas mounted to the existing pipe mounts, 2 antennas stack mounted on a pipe mount all at a top height to match the existing antennas. Install 2 remote radio heads on the rooftop behind the parapet. Total: 5 antennas and 2 remote radio heads. – *See Roof Plan Sheet A-1*.

See Exhibit 2, Plans. See Exhibit 3, Photo Simulations

SATISFACTION OF ELIGIBLE FACILITIES REQUEST STANDARDS

On February 22, 2012, President Obama signed into law H.R. 3630, known as the "Middle Class Tax Relief and Job Creation Act of 2012," which then became Public Law 112-96 ("P.L. 112-96"). Section 6409(a) of P.L. 112-96 adds new language to the existing body of laws, regulations, and decisions pertaining to wireless facility zoning.²

Verizon Wireless respectfully submits the proposed modifications satisfy the standards for an eligible facility request pursuant to 47 U.S.C. §1455 and 47 C.F.R. §1.6100. In an effort to advance Congress' goal of facilitating the rapid deployment of qualified modifications, the Federal Communications Commission adopted rules in 2014 that clarified many of the terms of Section 6409(a). The Commission stated that the purpose of implementing the rules "will serve the public interest by providing guidance to all stakeholders on their rights and responsibilities under the provision, reducing the delays in the review process for wireless infrastructure modifications, and facilitating the rapid deployment of wireless infrastructure, thereby promoting the advanced wireless broadband services."

47 U.S. Code §1455(a) and 47 C.F.R. §1.6100(b) builds on the existing legal framework for wireless facilities by requiring permitting authorities to approve an eligible facilities request in an effort to streamline "the process for siting of a wireless facility by preempting the ability of State and local authorities to delay collocation of, removal of, and replacement of wireless transmission equipment." "Collocation" is defined as "the mounting or installation of transmission equipment on an eligible support structure for the purpose of transmitting and/or receiving radio frequency signals for communications purposes." The term "eligible support structure" means any structure that is a "tower" or "base station." A "base station" is defined as a structure or equipment that enables Commission-licensed or authorized wireless communications and includes any structure other than a tower that supports or houses permitted equipment used for wireless

(a) FACILITY MODIFICATIONS.—

¹ Middle Class Tax Relief and Job Creation Act of 2012, Pub L. No. 112-96, 126 Stat. 156 (2012).

² Section 6409(a) states:

⁽¹⁾ IN GENERAL.—Notwithstanding section 704 of the Telecommunications Act of 1996 (Public Law 104–104) or any other provision of law, a State or local government may not deny, and shall approve, any eligible facilities request for a modification of an existing wireless tower or base station that does not substantially change the physical dimensions of such tower or base station.

(2) ELIGIBLE FACILITIES REQUEST.—For purposes of this subsection, the term "eligible"

⁽²⁾ ELIGIBLE FACILITIES REQUEST.—For purposes of this subsection, the term "eligible facilities request" means any request for modification of an existing wireless tower or base station that involves—

⁽A) collocation of new transmission equipment;

⁽B) removal of transmission equipment; or

⁽C) replacement of transmission equipment.

⁽³⁾ APPLICABILITY OF ENVIRONMENTAL LAWS.—Nothing in paragraph (1) shall be construed to relieve the Commission from the requirements of the National Historic Preservation Act or the National Environmental Policy Act of 1969.

³ See Accelerating of Broadband Deployment by Improving Wireless Facilities Siting Policies, Report and Order, 29 FCC Rcd 12865 (2014) ("2014 Order").

⁴ Id. At 12872.

⁵ 158 Cong. Rec. E237 (daily ed. Feb. 24, 2012) (statement of Rep. Upton).

communications services.⁶ The term "eligible facilities request" includes any request for modification of an existing wireless tower or base station that involves— (i) collocation of new transmission equipment; (ii) removal of transmission equipment; or (iii) replacement of transmission equipment.⁷

The Property constitutes a "base station" and an "eligible support structure" in that it currently exists and "supports and houses" wireless communication equipment that has been reviewed and approved under the City's zoning ordinance. The proposed replacement of the Verizon Wireless antennas and remote heads on the Property for the purpose of transmitting and receiving radio frequency signals for communication purposes constitutes a "replacement of transmission equipment" and the proposed addition of antennas is the "collocation of new transmission equipment."

Federal authorities clearly provide that an eligible facilities request must be approved if the installation does not result in a substantial change. The proposed modifications to the existing Verizon Wireless facility is an "eligible facilities request." Through its statutory mandate and given the lack of statutory definitions, the Federal Communications Commission has defined a substantial change under Section 6409(a) as follows:

- (i) For other eligible support structures (i.e., the "Building"), it increases the height of the structure by more than 10% or more than ten feet, whichever is greater There will be no increase in height. The proposed facade mounted antennas will not be any higher and the remote radio heads will be behind existing parapet wall.
- (ii) For other eligible support structures (i.e., the "Building"), it involves adding an appurtenance to the body of the structure that would protrude from the edge of the structure by more than six feet The proposed replacement antennas will not protrude more than six feet from the edge of the building.
- (iii) For any eligible support structure (i.e., the "Building"), it involves installation of more than the standard number of new equipment cabinets for the technology involved, but not to exceed four cabinets; or, it involves installation of any new equipment cabinets on the ground if there are no pre-existing ground cabinets associated with the structure The proposed modification does not involve the installation of new cabinets. All radio equipment will remain at the current location.
- (iv) It does not entail any excavation or deployment outside the current site **The** modification does not involve any excavation or deployment outside the current site.
- (v) It would not defeat the concealment elements of the eligible support structure Verizon Wireless' modifications do not defeat any concealment elements the replacement antennas mounted to the façade at the same location and height as the

⁶ 47 C.F.R. §1.6100(b)(1)

⁷ 47 U.S.C. § 1455(a)(2) and §1.6100(b)(3)

⁸ See 47 U.S.C. §1455(a) and 47 C.F.R. §1.6100(b)

replaced antennas will be painted and covered to match the color and texture of the building.

(vi) It complies with conditions associated with the siting approval – **The** installation will remain compliant.

It is clear that state and local authorities have no power to deny a complying installation, and any attempt to do so would be in direct conflict with federal law. Having satisfied the standards for the modification of an eligible support structure that will not result in a substantial change, the Board may not deny the Section 6409(a) Modification. Consistent with that determination, the permitting is limited to non-discretionary permitting related to applicable building, structural and electrical codes. Additionally, when an applicant asserts in writing that a request for a modification is covered by this section, a State or local government may only require the applicant to provide documentation or information to the extent reasonably necessary to determining whether the request meets the requirements for an eligible facilities request. Further, the Federal Communications Commission also adopted rules that require local review subject to Section 6409(a) be completed within sixty (60) days. A Section 6409(a) request will be "deemed granted" if not approved within the sixty (60) day period.

SATISFACTION OF SPECIAL PERMIT REVIEW STANDARDS

Based on the description set forth herein, and as will be further demonstrated at the Public Hearing on this matter, the proposed modification of the Facility meets the location, height and site requirements of Section 4.32(g)(1), Section 4.40 (footnote 4) and Sections 10.40 - 10.46. Pursuant to Ordinance, the modification of the Facility is allowed upon the grant of a special permit from the Zoning Board of Appeals in the currently designated Business A zoning district.

While reserving all rights, Verizon Wireless' modification satisfies the standards set forth in Section 4.40 (footnote 4) and Sections 10.40 – 10.46 of the City of Cambridge, Zoning Ordinance.

1. The scope of or limitations imposed by any license secured from any state or federal agency having jurisdiction over such matters — **Verizon Wireless operates in compliance** with all of the rules and regulations promulgated by the Federal Communications Commission as required by its licensing.

See Exhibit 4, FCC License to Operate.

2. The extent to which the visual impact of the various elements of the proposed facility is minimized: (1) Through the use of existing mechanical elements on a building's roof or other features of the building as support and background, (2) Through the use of materials that in texture and color blend with the materials to which the facilities are attached, or (3) Other effective means to reduce the visual impact of the facility from off the site - Verizon Wireless proposes to mount a total of 15 antennas by retaining 3 existing antennas and installing 12 new antennas to the façade (painted and covered

to match the color and texture of the building) with remote radio heads hidden behind the parapet wall.

3. Where it is proposed to erect such a facility in any residential zoning district, the extent to which there is a demonstrated public need for the facility at the proposed locations, the existence of alternative, functionally suitable sites in nonresidential locations, the character of the prevailing uses in the area, and the prevalence of other, existing mechanical systems and equipment carried on or above the roof of nearby structures. The Board of Zoning Appeal shall grant a special permit to erect such a facility in a residential zoning district only upon a finding that nonresidential uses predominate in the vicinity of the proposed facility's location and that the telecommunication facility is not inconsistent with the character that does prevail in the surrounding neighborhood – The wireless use and modification of the Facility is consistent with the purpose of the Business A Zoning District.

The proposed modification also satisfies the standards of Section 10.43 of the Ordinance for the grant of special permits. As noted above, the proposed modification will allow Verizon Wireless to improve wireless signal coverage and is an integral part of Verizon Wireless' network design in the City of Cambridge. The modification of the equipment detailed herein will aid in reaching Verizon Wireless' goal to provide enhanced service and communications in the City of Cambridge. The proposed modification will generate no traffic or other negative impacts on surrounding properties or the City of Cambridge. The Facility requires no water or sewer services. The utilities will continue to be obtained from existing service. The Facility will continue to be unoccupied, with no employees or customers. The Facility will continue to be regularly maintained by qualified technicians to assure that the equipment operates at optimal condition so that no threat of explosion, fire or other danger to life or property occurs. Reliable wireless service also enhances community safety, because it is used by public safety officials as well as the public in times of crisis, natural disaster, inclement weather and similar circumstances.

It is a truism to state that it is absolutely essential that there is the necessary infrastructure to ensure access to reliable wireless services. The ability to utilize mobile devices has become so integral that the absence of reliable service certainly has a negative impact. The availability of reliable wireless service also provides greater access to 911 emergency services. Maintaining wireless service provides another tool for ensuring that emergencies can be reported as quickly as possible, which reduces the response times of public safety personnel.

Because the application is for the modification of equipment that provides wireless services, the proposal is subject to §704 of the federal Telecommunications Act of 1996 ("TCA"), codified at 47 U.S.C. §332(c)(7)(B). By way of background, the TCA is a federal law enacted in 1996 whose purpose is "[t]o promote competition and reduce regulation in order to secure lower prices and higher quality services for American telecommunications consumers and encourage the rapid deployment of new telecommunications technologies." To further this purpose, the TCA established national standards that apply to permitting for

wireless facilities. These standards preempt inconsistent state and local laws, so they must be considered in making decisions related to wireless facilities.

The proposed modification of the existing Facility satisfies the criteria for granting a special permit, Verizon Wireless respectfully requests that the Board grant a special permit to modify the existing facility to allow for the proposed upgrade of this existing mobile communications system.

CONCLUSION

The availability of wireless communications service enhances community safety, and is increasingly relied upon by civil defense and other safety officers as well as the general public in times of crisis, natural disaster, bad storms or similar circumstances. Wireless communications service also provides a convenience to residents, and is an attractive feature and service to businesses. The proposed modification, by providing these services, will promote the health, safety, convenience and general welfare of the inhabitants of the City of Cambridge.

In compliance with Section 6409(a) of the federal Middle Class Tax Relief and Job Creation Act of 2012, the proposed modification constitutes an eligible facilities request entitled to approval. In the alternative, with all rights reserved, the proposed modification meets all the standards for a special permit pursuant to the City's Zoning Ordinance. Verizon Wireless respectfully requests that the Board vote to grant a special permit and any other relief pursuant to the City of Cambridge Zoning Ordinance, Massachusetts General Laws chapter 40A, and, the federal Telecommunications Act of 1996.

Exhibit 1 "ZBA Application Form – Ownership Information"

BZA APPLICATION FORM - OWNERSHIP INFORMATION

| To be completed by OWNER, signed before a notary and returned to The Secretary of the Board of Zoning Appeals. |
|---|
| I/We Algoghos Atmizian Primire Perpenses LLO |
| Address: 545 Concord ave Cambridge |
| State that I/We own the property located at $Mass$, |
| which is the subject of this zoning application. |
| The record title of this property is in the name of <u>Alewife Properties LLC</u> |
| *Pursuant to a deed of duly recorded in the date $10/19/2006$ Middlesex South |
| County Registry of Deeds at Book <u>48345</u> , Page <u>504</u> ; or |
| Middlesex Registry District of Land Court, Certificate No |
| SIGNATURE BY LAND OWNER OR AUTHORIZED TRUSTEE, OFFICER OR AGENT* |
| *Written evidence of Agent's standing to represent petitioner may be requested. |
| Commonwealth of Massachusetts, County of Malles |
| The above-name Nigoghis Atinizian personally appeared before me, |
| this 15th of Jan, 2021, and made oath that the above statement is true. |
| Notarining P. Milling |
| My commission expires (Notary Seal). If ownership is not shown in recorded deed, e.g. if by court order, ressail deed, or inheritance, please include documentation. |
| • If ownership is not shown in recorded deed, e.g. if by court order, ressauded, or inheritance, please include documentation. |

Exhibit 2 "Plans"




FRESH POND MA HD

545 CONCORD AVENUE CAMBRIDGE, MA 02138

FUZE PROJECT ID: 16070524

PSLC: 137428

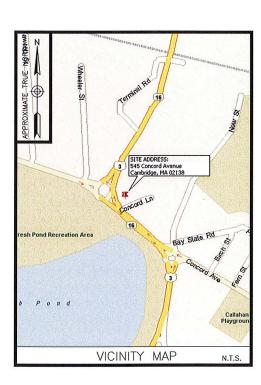

ENGINEER DEWBERRY ENGINEERS INC. 99 SUMMER ST. SUITE 700 BOSTON, MA 02110 PHONE # (617) 531-0800 CONTACT: BENJAMIN REVETTE, PE CONSTRUCTION VERIZON WIRELESS 118 FLANDERS ROAD WESTBOROUGH, MA 01581-3956

| PMI ACCESSED AT: | HTTPS://PMI.VZWSMART.COM | | |
|---|--|--|--|
| SMART TOOL VENDOR PROJECT NUMBER: | 10009990 | | |
| VZW LOCATION CODE (PSLC): | 137428 | | |
| FUZE NUMBER: | 16070524 | | |
| × | | | |
| PMI AND REQUIREMENTS ALSO EMBEDDED IN MOUNT ANALYSIS REPORT | | | |
| MOUNT MODIFICATION REQUIRED? | | | |
| VZW APPROVED SMART KIT VENDORS | | | |
| REFER TO MOUNT MODIFICATION DRAWINGS PAGE FOR YZW SMART KIT APPROVED VENDORS | | | |
| CONTRACTOR PM | REQUIREMENTS | | |
| AND SAID DOWN THE RESIDENCE OF THE PARTY OF | | | |
| THIS DOCUMENT WAS DEVELOPED AND ITS SITE CONDITIONS AND I ANOTHER SITE OR WHEN OTHER OF THIS DOCUMENT IS AT THE | S NOT TO BE USED FOR CONDITIONS PERTAIN. REUSE | | |

F THIS DOCUMENT IS AT THE SOLE RISK OF THE USER.

FACILITY IS UNMANNED AND NOT FOR HUMAN HABITATION.

REMOVE (9) EXISTING ANTENNAS FROM POSITIONS 1, 2 & 3.

INSTALL (6) NEW PANEL ANTENNAS ON EXISTING PIPE MASTS IN POSITIONS 2 & 3.

INSTALL (3) NEW VZSO1 ANTENNAS & (3) NEW CBRS RRH WITH CLIP ON ANTENNA ON PROPOSED 6' PIPE MAST IN POSITION 1.

REMOVE (9) EXISTING RRHS.

INSTALL (6) NEW DUAL BAND RRHS ON EXISTING UNISTRUT.

INSTALL CBRS HYBRID JUMPERS & OTHER JUMPERS AS REQUIRED.

CAP & WEATHERPROOF UN—USED ANTENNA PORTS.

GROUND EXISTING PIPE MOUNTS PER VERIZON WIRELESS SPECIFICATIONS.

OTE: . SCOPE OF WORK BASED ON ANTENNA REC FOR "FRESH_POND_MA" DATED 08/31/2020. VERIFY SCOPE OF WORK WITH FINAL RFDS PRIOR TO CONSTRUCTION.

SCOPE OF WORK

| T-1 TITLE SHEET GN-1 GENERAL NOTES A-1 ROOF PLAN A-2 SOUTH, WEST & EAST ELEVATIONS A-3 CONSTRUCTION DETAILS A-4 GROUNDING DETAILS A-5 SMART TOOL SECTOR PLANS & ELEVATIONS SHEET INDEX | SHT. NO. | DESCRIPTION | | |
|---|-------------|--------------------------------------|--|--|
| GN-1 GENERAL NOTES A-1 ROOF PLAN A-2 SOUTH, WEST & EAST ELEVATIONS A-3 CONSTRUCTION DETAILS A-4 GROUNDING DETAILS A-5 SMART TOOL SECTOR PLANS & ELEVATIONS | | | | |
| A-1 ROOF PLAN A-2 SOUTH, WEST & EAST ELEVATIONS A-3 CONSTRUCTION DETAILS A-4 GROUNDING DETAILS A-5 SMART TOOL SECTOR PLANS & ELEVATIONS | T-1 | TITLE SHEET | | |
| A-1 ROOF PLAN A-2 SOUTH, WEST & EAST ELEVATIONS A-3 CONSTRUCTION DETAILS A-4 GROUNDING DETAILS A-5 SMART TOOL SECTOR PLANS & ELEVATIONS | | OFFICE MOTES | | |
| A-2 SOUTH, WEST & EAST ELEVATIONS A-3 CONSTRUCTION DETAILS A-4 GROUNDING DETAILS A-5 SMART TOOL SECTOR PLANS & ELEVATIONS | GN-1 | GENERAL NOTES | | |
| A-2 SOUTH, WEST & EAST ELEVATIONS A-3 CONSTRUCTION DETAILS A-4 GROUNDING DETAILS A-5 SMART TOOL SECTOR PLANS & ELEVATIONS | A-1 | ROOF PLAN | | |
| A-3 CONSTRUCTION DETAILS A-4 GROUNDING DETAILS A-5 SMART TOOL SECTOR PLANS & ELEVATIONS | | SOUTH, WEST & EAST ELEVATIONS | | |
| A-5 SMART TOOL SECTOR PLANS & ELEVATIONS | A-3 | CONSTRUCTION DETAILS | | |
| | A-4 | GROUNDING DETAILS | | |
| SHEET INDEX | A-5 | SMART TOOL SECTOR PLANS & ELEVATIONS | | |
| SHEET INDEX | | | | |
| | | SHEET INDEX | | |
| | No care | | | |



VERIZON WIRELESS 118 FLANDERS ROAD WESTBOROUGH, MA 01581-3956

> FRESH POND MA HD

| CONSTRUCTION DRAWINGS | | | | |
|-----------------------|----------|---------------|--|--|
| 5 | | FOR SUBMITTAL | | |
| 4 | 01/22/21 | FOR SUBMITTAL | | |
| 3 | | FOR SUBMITTAL | | |
| 2 | 01/04/21 | FOR SUBMITTAL | | |
| 1 | 12/10/20 | FOR SUBMITTAL | | |
| 0 | 06/02/20 | FOR SUBMITTAL | | |



Dewberry Engineers Inc. 99 SUMMER STREET SUITE 700 BOSTON, MA 02110 PHONE: 617.095.3400 FAX: 617.095.3310



| DRAWN BY: | AJB |
|-----------------|----------|
| REVIEWED BY: | JCM |
| CHECKED BY: | BBR |
| PROJECT NUMBER: | 50121487 |
| JOB NUMBER: | 50121678 |
| SITE ADDRESS: | |

545 CONCORD AVENUE CAMBRIDGE, MA 02138

SHEET TITLE

TITLE SHEET

SHEET NUMBER

T - 1

GENERAL CONSTRUCTION NOTES:

- ALL WORK SHALL CONFORM TO ALL CURRENT APPLICABLE FEDERAL, STATE, AND LOCAL CODES, AND COMPLY WITH VERIZON WIRELESS SPECIFICATIONS.
- CONTRACTOR SHALL CONTACT "DIG SAFE" (888-344-7233) FOR IDENTIFICATION OF UNDERGROUND UTILITIES PRIOR TO START OF CONSTRUCTION.
- 3. CONTRACTOR IS RESPONSIBLE FOR COORDINATING ALL REQUIRED INSPECTIONS.
- ALL DIMENSIONS TO, OF, AND ON EXISTING BUILDINGS, DRAINAGE STRUCTURES, AND SITE IMPROVEMENTS SHALL BE VERIFIED IN FIELD BY CONTRACTOR WITH ALL DISCREPANCIES REPORTED TO THE ENGINEER.
- DO NOT CHANGE SIZE OR SPACING OF STRUCTURAL ELEMENTS.
- DETAILS SHOWN ARE TYPICAL; SIMILAR DETAILS APPLY TO SIMILAR CONDITIONS UNLESS OTHERWISE NOTED.
- THESE DRAWINGS DO NOT INCLUDE NECESSARY COMPONENTS FOR CONSTRUCTION SAFETY WHICH IS THE SOLE
- CONTRACTOR SHALL BRACE STRUCTURES UNTIL ALL STRUCTURAL ELEMENTS NEEDED FOR STABILITY ARE INSTALLED. THESE ELEMENTS ARE AS FOLLOWS: LATERAL BRACING, ANCHOR BOLTS, ETC.
- CONTRACTOR SHALL DETERMINE EXACT LOCATION OF EXISTING UTILITIES, DRAIN PIPES, VENTS, ETC. BEFORE COMMENCING
- INCORRECTLY FABRICATED, DAMAGED, OR OTHERWISE MISFITTING OR NONCONFORMING MATERIALS OR CONDITIONS SHALL BE REPORTED TO THE OWNER PRIOR TO REMEDIAL OR CORRECTIVE ACTION. ANY SUCH REMEDIAL ACTION SHALL REQUIRE WRITTEN APPROVAL BY THE OWNER'S REPRESENTATIVE PRIOR TO PROCEEDING.
- 11. EACH CONTRACTOR SHALL COOPERATE WITH THE OWNER'S REPRESENTATIVE, AND COORDINATE HIS WORK WITH THE WORK
- 12. CONTRACTOR SHALL REPAIR ANY DAMAGE CAUSED BY CONSTRUCTION OF THIS PROJECT TO MATCH EXISTING PRE-CONSTRUCTION CONDITIONS TO THE SATISFACTION OF THE VERIZON WIRELESS CONSTRUCTION MANAGER
- 13. ALL CABLE/CONDUIT ENTRY/EXIT PORTS SHALL BE WEATHERPROOFED DURING INSTALLATION USING A SILICONE SEALANT.
- 14. WHERE EXISTING CONDITIONS DO NOT MATCH THOSE SHOWN IN THIS PLAN SET, CONTRACTOR WILL NOTIFY ENGINEER, VERIZON WIRELESS PROJECT CONSTRUCTION MANAGER, AND LANDLORD IMMEDIATELY.
- 15. CONTRACTOR SHALL ENSURE ALL SUBCONTRACTORS ARE PROVIDED WITH A CURRENT SET OF DRAWINGS AND SPECIFICATIONS FOR THIS PROJECT.
- ALL ROOF WORK SHALL BE DONE BY A QUALIFIED AND EXPERIENCED ROOFING CONTRACTOR IN COORDINATION WITH ANY
 CONTRACTOR WARRANTING THE ROOF TO ENSURE THAT THE WARRANTY IS MAINTAINED.
- 17. CONTRACTOR SHALL REMOVE ALL RUBBISH AND DEBRIS FROM THE SITE AT THE END OF EACH DAY.
- 18. CONTRACTOR SHALL COORDINATE WORK SCHEDULE WITH LANDLORD AND TAKE PRECAUTIONS TO MINIMIZE IMPACT AND DISRUPTION OF OTHER OCCUPANTS OF THE FACILITY.
- 19. CONTRACTOR SHALL FURNISH VERIZON WIRELESS WITH THREE AS-BUILT SETS OF DRAWINGS UPON COMPLETION OF WORK.
- 20. ANTENNAS AND CABLES ARE TYPICALLY PROVIDED BY VERIZON WIRELESS. PRIOR TO SUBMISSION OF BID, CONTRACTOR SHALL COORDINATE WITH PROJECT MANAGER TO DETERMINE WHAT, IF ANY, ITEMS WILL BE PROVIDED BY VERIZON WIRELESS. ALL ITEMS NOT PROVIDED BY VERIZON WIRELESS SHALL BE PROVIDED AND INSTALLED BY THE CONTRACTOR. CONTRACTOR WILL INSTALL ALL ITEMS PROVIDED BY VERIZON WIRELESS.
- 21. PRIOR TO SUBMISSION OF BID, CONTRACTOR WILL COORDINATE WITH VERIZON WIRELESS PROJECT MANAGER TO DETERMINE IF ANY PERMITS WILL BE OBTAINED BY VERIZON WIRELESS. ALL REQUIRED PERMITS NOT OBTAINED BY VERIZON WIRELESS MUST BE OBTAINED, AND PAID FOR, BY THE CONTRACTOR.
- 22. GENERAL CONTRACTOR SHALL HAVE A LICENSED HVAC CONTRACTOR START THE HVAC LINITS. SYNCHRONIZE THE GENERAL CONTRACTOR SHALL HAVE A LICENSED HAVE CONTRACTOR START THE HAVE UNITS, STRICHRONIZE THE
 THERMOSTATS, ADJUST ALL SETTINGS ON EACH UNIT ACCORDING TO VERIZON WIRELESS CONSTRUCTION MANAGER'S
 SPECIFICATIONS, AND THOROUGHLY TEST AND BALANCE EACH UNIT TO ENSURE PROPER OPERATION PRIOR TO TURNING
 THE SITE OVER TO OWNER.
- 23. CONTRACTOR SHALL INSTALL ALL SITE SIGNAGE IN ACCORDANCE WITH VERIZON WIRELESS SPECIFICATIONS AND
- 24. CONTRACTOR SHALL SUBMIT ALL SHOP DRAWINGS TO ENGINEER FOR REVIEW AND APPROVAL PRIOR TO FABRICATION.
- 25. UNIESS OTHERWISE NOTED VERIZON WIRELESS SHALL PROVIDE ALL REQUIRED RE MATERIAL FOR CONTRACTOR TO INSTALL INCLUDING ANTENNAS, TMA'S, BIAS—T'S, COMBINERS, PDU, DC BLOCKS, SURGE ARRESTORS, GPS ANTENNA, GPS SURGE ARRESTOR, COAXIAL CABLE.
- 26. PRIOR TO SUBMISSION OF BID, CONTRACTOR SHALL VERIFY ALL EQUIPMENT TO BE PROVIDED BY VERIZON WIRELESS FOR INSTALLATION BY CONTRACTOR.
- 27. ALL EQUIPMENT SHALL BE INSTALLED ACCORDING TO MANUFACTURER'S SPECIFICATIONS AND LOCATED ACCORDING TO VERIZON WIRELESS SPECIFICATIONS, AND AS SHOWN IN THESE PLANS.
- 28. DETAILS SHOWN ARE TYPICAL; SIMILAR DETAILS APPLY TO SIMILAR CONDITIONS UNLESS OTHERWISE NOTED.
- 29. THE CONTRACTOR SHALL SUPERVISE AND DIRECT THE PROJECT DESCRIBED HEREIN. THE CONTRACTOR SHALL BE SOLELY RESPONSIBLE FOR ALL THE CONSTRUCTION MEANS, METHODS, TECHNIQUES, SEQUENCES AND PROCEDURES AND FOR COORDINATING ALL PORTIONS OF THE WORK UNDER THE CONTRACT.
- 30. CONTRACTOR SHALL NOTIFY THE ENGINEER A MINIMUM OF 48 HOURS IN ADVANCE PRIOR TO CONSTRUCTION START, MORE SPECIFICALLY BEFORE, SEALING ANY FLOOR, WALL OR ROOF PENETRATION, FINAL UTILITY CONNECTIONS, POURING CONCRETE, BACKFILLING UTILITY TRENCHES AND STRUCTURAL POST OR MOUNTING CONNECTIONS, FOR ENGINEERING REVIEW
- 31. SEAL PENETRATIONS THROUGH FIRE RATED AREAS WITH UL LISTED D FIRE CODE APPROVED MATERIALS.
- 32. REPAIR ANY DAMAGE DURING CONSTRUCTION TO MATCH EXISTING PRE-CONSTRUCTION CONDITIONS TO THE SATISFACTION OF THE CONSTRUCTION MANAGER AND LANDLORD
- 33. ALL DISRUPTIVE WORK AND WORK WITHIN TENANT SPACES TO BE COORDINATED WITH BUILDING REPRESENTATIVE

CODE SPECIFICATIONS:

- ALL WORK SHALL COMPLY WITH THE FOLLOWING APPLICABLE CODES:
- MASSACHUSETTS STATE BUILDING CODE, 9TH EDITION, CONSISTENT WITH THE FOLLOWING CODES:
- 2015 INTERNATIONAL RESIDENTIAL CODE (IRC)
- 2015 INTERNATIONAL BUILDING CODE (IBC)
 2015 INTERNATIONAL EXISTING BUILDING CODE (IBC)
- 2020 NATIONAL ELECTRICAL CODE (NEC)
- IN THE EVENT OF CONFLICT, THE MOST RESTRICTIVE CODE SHALL PREVAIL.
- ALL STRUCTURAL WORK TO BE DONE IN ACCORDANCE WITH THE AMERICAN INSTITUTE OF STEEL CONSTRUCTION MANUAL, 13TH EDITION (AISC 13TH ED.)
- ALL CONCRETE WORK TO BE DONE IN ACCORDANCE WITH THE AMERICAN CONCRETE INSTITUTE (ACL 301) SPECIFICATIONS FOR STRUCTURAL CONCRETE FOR BUILDINGS (ACI 318) AND BUILDING CODE REQUIREMENTS FOR REINFORCED CONCRETE
- ALL REINFORCING STEEL WORK TO BE DONE IN ACCORDANCE WITH THE (ACI 315) MANUAL OF STANDARD PRACTICE FOR DETAILING REINFORCED CONCRETE STRUCTURES.

GROUNDING NOTES:

- 1. GROUNDING SHALL COMPLY WITH NEC ART. 250.
- GROUNDING CONDUCTORS SHALL BE #6 COPPER STRANDED WIRE WITH GREEN COLOR INSULATION FOR INDOOR USE.
- ALL GROUND CONNECTIONS TO BE BURNDY HYGROUND COMPRESSION TYPE CONNECTORS OR CADWELD EXOTHERMIC WELD DO NOT ALLOW BARE COPPER WIRE TO BE IN CONTACT WITH
- 4. ROUTE GROUNDING CONNECTORS ALONG THE SHORTEST AND STRAIGHTEST PATH POSSIBLE, EXCEPT AS OTHERWISE INDICATED. GROUNDING LEADS SHOULD NOT BE BENT AT RIGHT ANGLE. ALWAYS MAKE 12" RADIUS BENDS. #6 WIRE CAN BE BENT AT 6" RADIUS WHEN NECESSARY.
- CONNECTIONS TO GROUNDING BAR SHALL BE MADE WITH TWO HOLE COMPRESSION TYPE COPPER LUGS. APPLY OXIDE INHIBITING COMPOUND TO ALL LOCATIONS.
- TEST COMPLETED GROUNDING SYSTEM AND RECORD RESISTANCE VALUES FOR PROJECT CLOSE-OUT DOCUMENTATION. GROUND RESISTANCE SHALL NOT EXCEED 5 OHMS.
- GROUNDING CONDUCTORS BETWEEN MGB AND WATERMAIN SHALL BE #2/0. BONDING JUMPERS FROM METALLIC SURFACES SHALL BE #2 MINIMUM. ALL GROUND CONDUCTORS AND BONDING JUMPERS SHALL BE SOFT DRAWN ANNEALED, TINNED, BARE STRANDED COPPER WIRE. COAXIAL CABLES SHALL BE GROUNDED AT A MINIMUM OF TWO LOCATIONS USING VERIZON PROVIDED GROUNDING KITS. EXACT LOCATIONS SHALL BE FINALIZED IN THE FIELD BY THE CONSTRUCTION MANAGER.

STRUCTURAL STEEL NOTES:

- 1. STRUCTURAL STEEL SHALL CONFORM TO THE LATEST EDITION OF THE AISC "SPECIFICATION FOR THE DESIGN, FABRICATION AND ERECTION OF STRUCTURAL STEEL FOR BUILDINGS".
- 2. STRUCTURAL STEEL ROLLED SHAPES, PLATES, AND BARS SHALL CONFORM TO THE FOLLOWING ASTM

ALL W SHAPES, UNLESS NOTED OR A992 OTHERWISE.
ALL OTHER ROLLED SHAPES, PLATES AND BARS UNLESS NOTED OTHERWISE.
HSS SECTION (SOUARE, RECTANGULAR, ROUND)
ALL BOLTS FOR CONNECTING STRUCTURAL MEMBERS.
ALL ANCHORS BOLTS, UNLESS NOTED OTHERWISE.
STEEL PIPE ASTM A-992, GRADE 50 ASTM A-36 ASTM A-36 ASTM A-500, GRADE B ASTM A-325, TYPE SC OR N F1554, GRADE 36 ASTM A-53, GRADE B

- ALL WELDING SHALL BE DONE USING E70XX ELECTRODES AND WELDING SHALL CONFORM TO AISC AND AWS D1.1 WHERE FILLET WELD SIZES ARE NOT SHOWN, PROVIDE THE MINIMUM SIZE PER TABLE J2.4 IN THE AISC "MANUAL OF STEEL CONSTRUCTION", 14TH EDITION. WHERE WELD LENGTH IS NOT INDICATED, USE FULL LENGTH WELD. AT THE COMPLETION OF ALL WELDING, ALL DAMAGE TO GALVANIZED COATING SHALL BE REPAIRED.
- BOLTED CONNECTIONS SHALL USE BEARING TYPE GALVANIZED ASTM A325 BOLTS (3/4" DIA.) SUPPLIED WITH A NUT AND WASHER UNDER TURNED END AND SHALL HAVE MINIMUM OF TWO BOLTS UNLESS NOTED OTHERWISE.
- 5. DO NOT DRILL HOLES THROUGH STRUCTURAL STEEL MEMBERS EXCEPT AS SHOWN AND DETAILED ON
- NON-STRUCTURAL CONNECTIONS FOR STEEL GRATING MAY USE 5/8" DIA. GALVANIZED ASTM A 307 BOLTS UNLESS NOTED OTHERWISE.
- 7. USE PRECAUTIONS & PROCEDURES PER AWS D1.1 WHEN WELDING GALVANIZED METALS.
- ALL EXISTING BEAM AND COLUMN DIMENSIONS SHALL BE FIELD VERIFY BY CONTRACTOR PRIOR TO FABRICATION. ANY DISCREPANCIES BETWEEN EXISTING CONDITIONS AND THOSE SHOWN SHALL BE REPORTED TO DEWBERRY ENGINEER IMMEDIATELY.
- 9. CONNECTION DESIGN BY FABRICATOR WILL BE SUBJECT TO REVIEW AND APPROVAL BY ENGINEER.
- 10. ALL EXTERIOR STEEL WORK SHALL BE GALVANIZED IN ACCORDANCE WITH SPECIFICATION ASTM A123/A123M-00 HOT-DIP GALVANIZED FINISH UNLESS OTHERWISE NOTED. GALVANIZING SHALL BE PERFORMED AFTER SHOP FABRICATION TO THE GREATEST EXTENT POSSIBLE. ALL DINGS, SCRAPES, MARS, AND WELDS IN THE GALVANIZED AREAS SHALL BE REPAIRED. REPAIR DAMAGED GALVANIZED COATINGS ON GALVANIZED ITEMS WITH GALVANIZED ARCAS SPALL BY REPAIRED NAMED WAS AND MANUFACTURER'S WRITTEN INSTRUCTIONS, PRIOR TO COMPLETION OF WORK. TOUCHUP ALL DAMAGED GALVANIZED STEEL WITH APPROVED COLD ZINC, "GALVANOX", "DRY GALV", "ZINC—IT", OR APPROVED EQUIVALENT, IN ACCORDANCE WITH MANUFACTURERS GUIDELINES. TOUCHUP DAMAGED NON GALVANIZED STEEL WITH SAME PAINT APPLIED IN SHOP OR FIELD.
- 11. ALL WELDED COMPONENTS TO BE SHOP WELDED PRIOR TO INSTALLATION. NO WELDING ACTIVITIES IS PERMITTED DURING INSTALLATION OF PROPOSED EQUIPMENTS AND/OR HARDWARE ON SITE




VERIZON WIRELESS 118 FLANDERS ROAD WESTBOROUGH, MA 01581-3956

> **FRESH POND** MA HD

| | CONSTRUCTION DRAWINGS | | | | | |
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| ı | 2 | 01/04/21 | FOR | SUBMITTAL | | |
| ١ | 1 | 12/10/20 | FOR | SUBMITTAL | | |
| ı | 0 | 06/02/20 | FOR | SUBMITTAL | | |



Dewberry Engineers Inc. 99 SUMMER STREET SUITE 700 PHONE: 617.695.3400 FAX: 617.695.3310

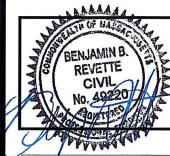

| DRAWN BY: | AJB |
|-----------------|----------|
| REVIEWED BY: | JCM |
| CHECKED BY: | BBR |
| PROJECT NUMBER: | 50121487 |
| JOB NUMBER: | 50121678 |

545 CONCORD AVENUE CAMBRIDGE, MA 02138


SHEET TITLE

SITE ADDRESS:

GENERAL NOTES

SHEET NUMBER

GN-1

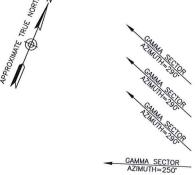


CONCORD AVENUE

| H | YBRID CABLE | SCHEDU | ILE* |
|-------------|------------------------|---------------|----------------|
| SECTOR | HYBRID CABLE LENGTH | CABLE SIZE | CABLE COUNT |
| ALPHA 205'± | | 6x12 | 1 |
| BETA 205'± | | 6x12 | 1 |
| GAMMA 285'± | | 6x12 | 1 |

*CONTRACTOR TO FIELD VERIFY HYBRID CABLE LENGTHS
PRIOR TO CONSTRUCTION. LENGTH IS ESTIMATED FROM THE
BASE EQUIPMENT OVP TO SECTOR OVP. NO HYBRID CABLES
ARE PROPOSED UNDER CURRENT SCOPE OF WORK.
CALCULATION BY: AJB

NOTES:

- . SOME EXISTING AND PROPOSED INFORMATION NOT SHOWN FOR CLARITY.
- 2. NORTH ARROW SHOWN AS APPROXIMATE.
- EXISTING ANTENNAS SHOWN AS APPROXIMATE. ELEVATION BASED ON EXISTING INFORMATION AND VISUAL INSPECTION AND HAVE NOT BEEN VERIFIED THROUGH AN ANTENNA MAPPING.
- ROOF PLAN BASED ON SITE VISIT ON 04/07/20 AND RFDS TITLED "FRESH_POND_MA" DATED 08/31/20.
- REUSE EXISTING ANTENNA MOUNTS AND COAX. INSPECT FOR DAMAGE OR DECAY AND REPLACE AS NEEDED.
- INSTALL PROPOSED EQUIPMENT IN ACCORDANCE WITH THE STRUCTURAL ASSESSMENT LETTER BY DEWBERRY DATED 12/08/20, FINAL MOUNT ANALYSIS REPORT BY MASER CONSULTING DATED 12/01/20, AND IN ACCORDANCE WITH MANUFACTURER RECOMMENDATIONS.
- ALL ANTENNAS TO BE PAINTED TO MATCH EXISTING BUILDING COLOR & TEXTURE. PROPOSED VZS01 ANTENNAS TO UTILIZE 3M WRAP TO MATCH.

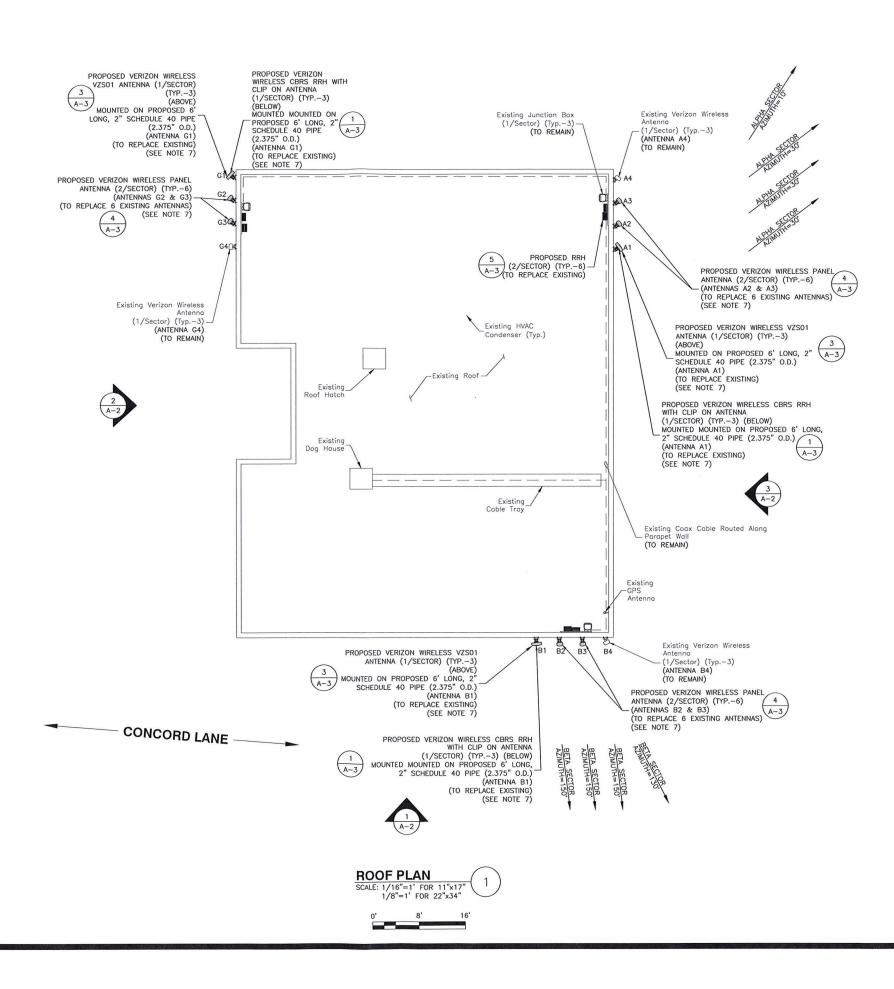




VERIZON WIRELESS 118 FLANDERS ROAD WESTBOROUGH, MA 01581-3956

FRESH POND MA HD

| | CONSTRUCTION DRAWINGS | | | | |
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| - | 2 | | | SUBMITTAL | |
| | 1 | 12/10/20 | FOR | SUBMITTAL | |
| - 1 | 0 | 06/02/20 | FOR | SUBMITTAL | |



Dewberry Engineers Inc. 99 SUMMER STREET SUITE 700 BOSTON, MA 02110 PHONE: 017.095.3400 FAX: 017.095.3310

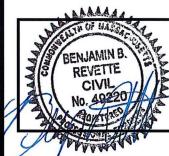

| DRAWN BY: | AJE |
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REVIEWED BY: JCM

CHECKED BY: BBR

PROJECT NUMBER: 50121487

JOB NUMBER: 50121678

SITE ADDRESS:


545 CONCORD AVENUE CAMBRIDGE, MA 02138

SHEET TITLE

ROOF PLAN

SHEET NUMBER

A-1

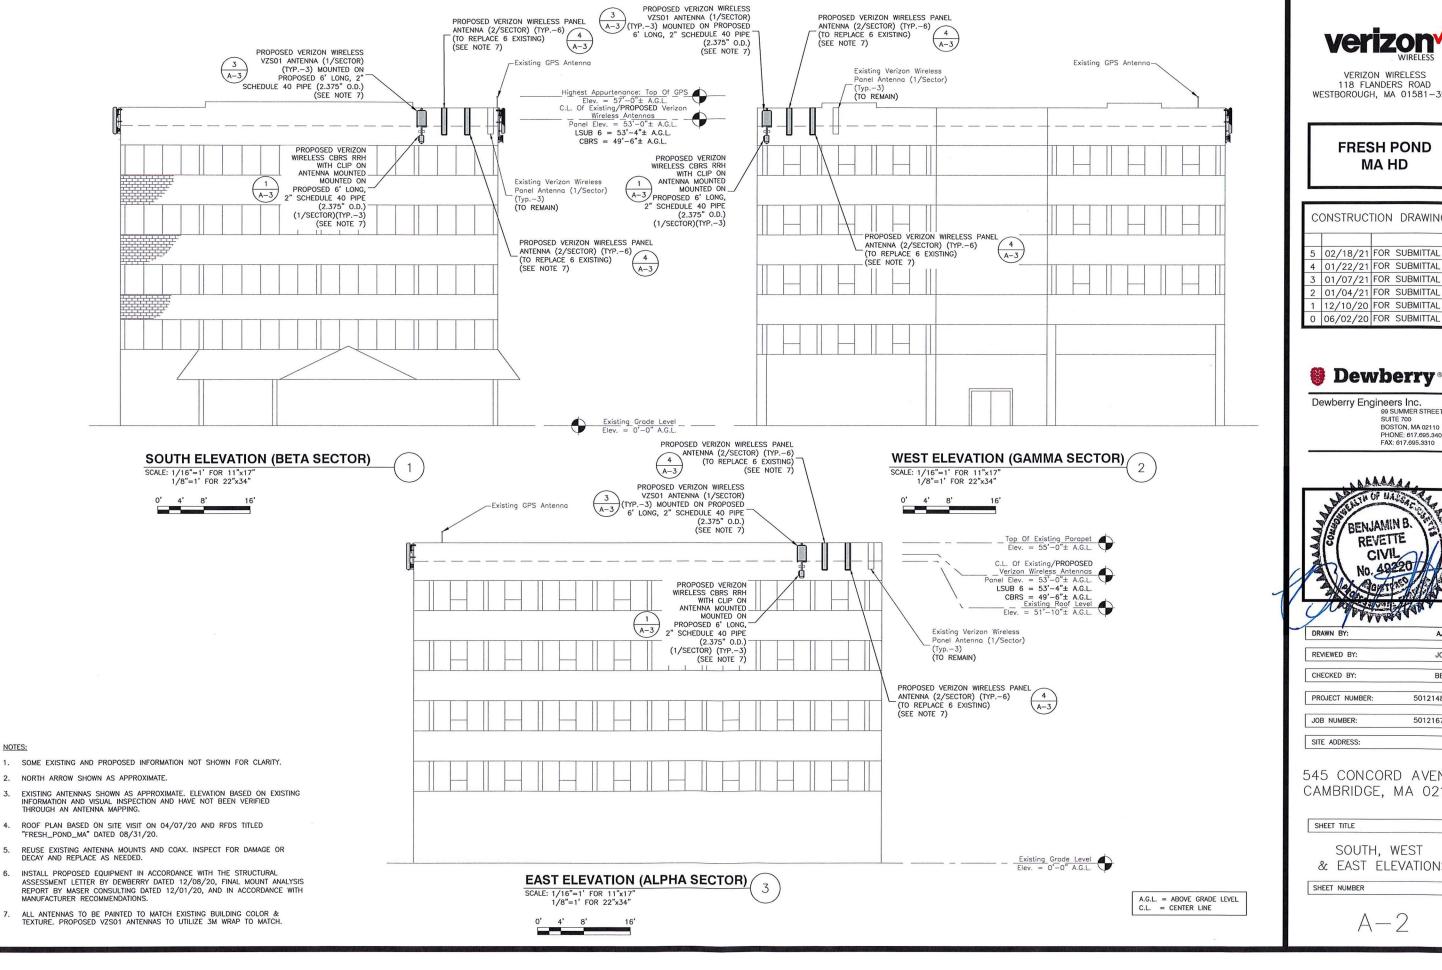

verizon^v


VERIZON WIRELESS 118 FLANDERS ROAD WESTBOROUGH, MA 01581-3956

> FRESH POND MA HD

CONSTRUCTION DRAWINGS 5 02/18/21 FOR SUBMITTAL 4 01/22/21 FOR SUBMITTAL 3 01/07/21 FOR SUBMITTAL 2 01/04/21 FOR SUBMITTAL 1 12/10/20 FOR SUBMITTAL




Dewberry Engineers Inc. 99 SUMMER STREET SUITE 700 BOSTON, MA 02110 PHONE: 617.695.3400 FAX: 617.695.3310

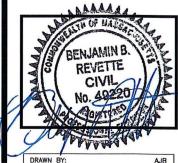

JCM BBR 50121487 50121678

545 CONCORD AVENUE CAMBRIDGE, MA 02138

& EAST ELEVATIONS

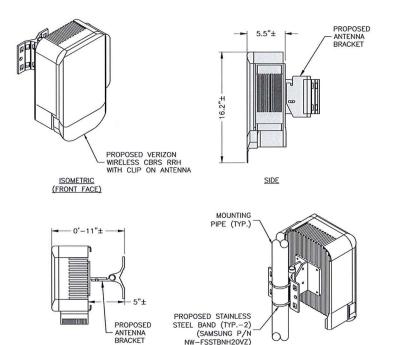


NOTES:

PLAN


- INSTALL ALL EQUIPMENT PER MANUFACTURER'S RECOMMENDATIONS. USE APPROPRIATE MOUNTING HARDWARE FOR CONSTRUCTION TYPE.
- ANTENNAS ARE SHOWN PERPENDICULAR TO BUILDING FACADE. ANTENNAS WILL BE REQUIRED TO BE PANNED TO MEET REQUIRED AZIMUTHS.
- 3. ANTENNA WEIGHT: 20 LBS.
- CONTRACTOR TO UTILIZE 3M WRAP FOR ALL ANTENNAS TO MATCH SURROUNDING AREAS, INSTALL 3M WRAP ON ANTENNAS PER MANUFACTURER'S SPECIFICATION & RECOMMENDATIONS.



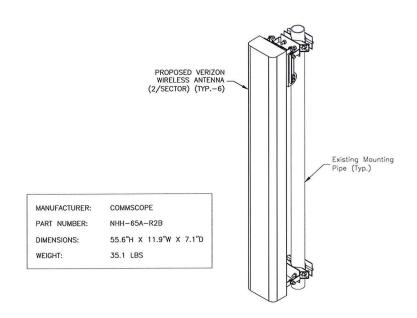

ISOMETRIC (REAR FACE)




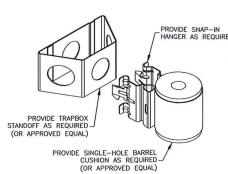

NOTE:

 PROVIDE C-CLAMP SUPPORTS & STAINLESS STEEL HOSE CLAMPS AS REQUIRED BY SITE CONDITIONS.

NR HRU JUMPER MOUNT SCALE: N.T.S. 2

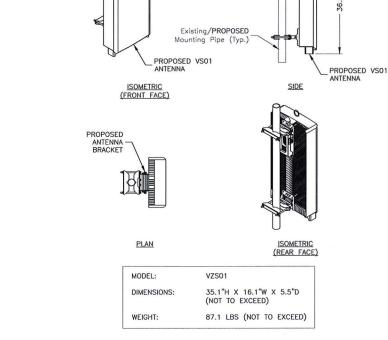


NOTES:

I. INSTALL ALL EQUIPMENT PER MANUFACTURER'S RECOMMENDATIONS. USE APPROPRIATE MOUNTING HARDWARE FOR CONSTRUCTION TYPE.

---- 5.51"±

VZS01 PIPE MOUNTED ANTENNA DETAIL

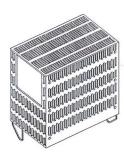

LTE 700/850

| MANUFACTURER: | SAMSUNG |
|---------------|-------------------------|
| MODEL: | 700/850 RRH |
| DIMENSIONS: | 15.0"H X 15.0"W X 8.1"D |
| WEIGHT: | 82.0 LBS |

NOTE:

LTE PCS/AWS RRH

97.5 LBS

15.0"H X 15.9"W X 10.0"D

LTE PCS/AWS

MANUFACTURER: SAMSUNG

MODEL:

WEIGHT:

DIMENSIONS:

 CONTRACTOR TO VERIFY WITH CONSTRUCTION MANAGER FOR FINAL MANUFACTURER SPECIFICATIONS PRIOR TO CONSTRUCTION.

REMOTE UNIT DETAILS SCALE: N.T.S. 5




VERIZON WIRELESS 118 FLANDERS ROAD WESTBOROUGH, MA 01581-3956

FRESH POND MA HD

| CONSTRUCTION DRAWINGS | | | | |
|-----------------------|----------|-----|-----------|--|
| 5 | 02/18/21 | FOR | SUBMITTAL | |
| 4 | 01/22/21 | FOR | SUBMITTAL | |
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| 2 | 01/04/21 | FOR | SUBMITTAL | |
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| 0 | 06/02/20 | FOR | SUBMITTAL | |



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| DRAWN BY: | AJB |
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| REVIEWED BY: | JCM |

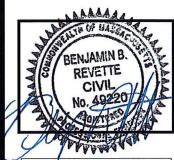CHECKED BY: BBR

PROJECT NUMBER: 50121487

JOB NUMBER: 50121678

SITE ADDRESS:


545 CONCORD AVENUE CAMBRIDGE, MA 02138

SHEET TITLE

CONSTRUCTION DETAILS

SHEET NUMBER


A-3

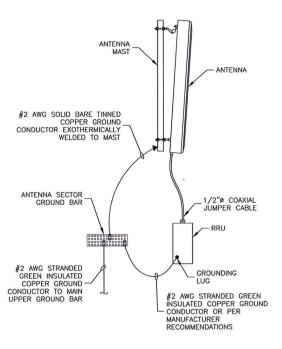

NOTES:

- VERIFY EXISTING GROUNDING SYSTEM IS INSTALLED PER VERIZON WIRELESS STANDARDS.
- BOND NEW EQUIPMENT INTO EXISTING GROUND SYSTEM IN ACCORDANCE WITH VERIZON WIRELESS STANDARDS AND MANUFACTURER'S RECOMMENDATIONS.




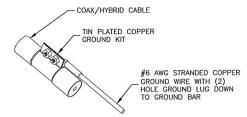

NOTE

- DO NOT INSTALL CABLE GROUND KIT AT A BEND. ALWAYS DIRECT GROUND WIRE DOWN TO GROUND BAR.
- 2. GROUNDING KIT SHALL BE TIN PLATED COPPER WITH TWO-HOLE LUG, SIZE PER COAX DIAMETER.
- 3. WEATHER SEAL GROUND KIT PER CARRIER REQUIREMENTS.
- COAX CABLE GROUND KIT LOCATION & QUANTITY SHALL BE PER CARRIER SPECIFICATIONS & STANDARDS.




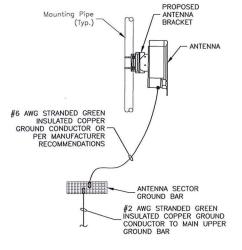

NOTES:

- 1. VERIFY EXISTING GROUNDING SYSTEM IS INSTALLED PER VERIZON WIRELESS STANDARDS.
- 2. BOND NEW EQUIPMENT INTO EXISTING GROUND SYSTEM IN ACCORDANCE WITH VERIZON WIRELESS STANDARDS AND MANUFACTURER'S RECOMMENDATIONS.



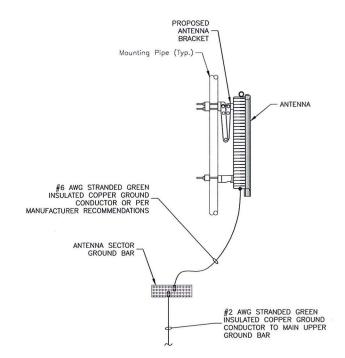

NOTES:

- 1. VERIFY EXISTING GROUNDING SYSTEM IS INSTALLED PER VERIZON WIRELESS STANDARDS.
- BOND NEW EQUIPMENT INTO EXISTING GROUND SYSTEM IN ACCORDANCE WITH VERIZON WIRELESS STANDARDS AND MANUFACTURER'S RECOMMENDATIONS.






VERIZON WIRELESS 118 FLANDERS ROAD WESTBOROUGH, MA 01581-3956

FRESH POND MA HD

| CONSTRUCTION DRAWINGS | | | | |
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| 5 | 02/18/21 | FOR SUBMITTAL | | |
| 4 | 01/22/21 | FOR SUBMITTAL | | |
| 3 | | FOR SUBMITTAL | | |
| 2 | 01/04/21 | FOR SUBMITTAL | | |
| 1 | 12/10/20 | FOR SUBMITTAL | | |
| 0 | 06/02/20 | FOR SUBMITTAL | | |



Dewberry Engineers Inc. 98 SUMMER STREET SUITE 700 BOSTON, MA 02110 PHONE: 617.695.3400 FAX: 617.695.3310

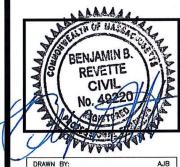

| DICAME DE. | 700 |
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| REVIEWED BY: | JCM |
| CHECKED BY: | BBR |
| PROJECT NUMBER: | 50121487 |
| JOB NUMBER: | 50121678 |
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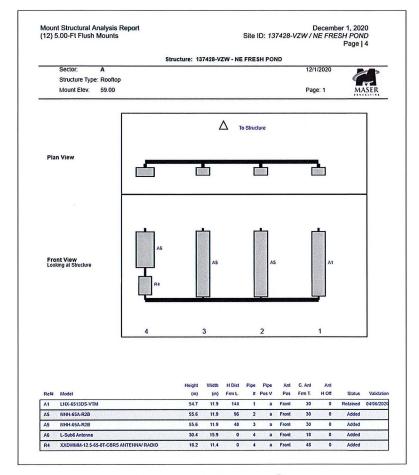
545 CONCORD AVENUE CAMBRIDGE, MA 02138


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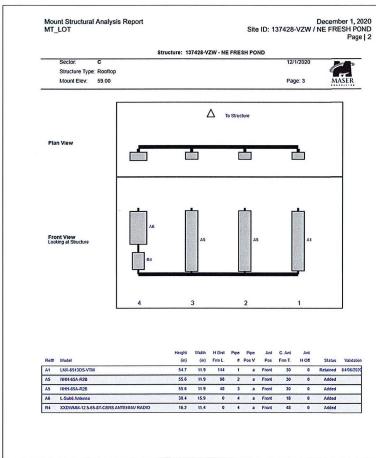
GROUNDING DETAILS

SHEET NUMBER

A-4





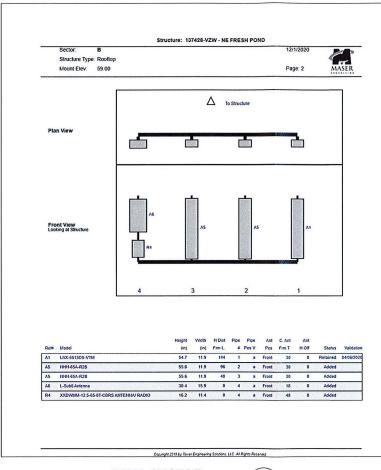

ALPHA SECTOR
SCALE: N.T.S.

BETA SECTOR
SCALE: N.T.S.

2

GAMMA SECTOR
SCALE: N.T.S.

3)

NOTE:

 SECTOR PLANS AND ELEVATIONS TAKEN FROM MOUNT ANALYSIS: SMART TOOL# 10009990, MASER PROJECT # 20777022A, FUZE # 16070588 BY MASER CONSULTING P.A. DATED 10/09/2020.




VERIZON WIRELESS 118 FLANDERS ROAD WESTBOROUGH, MA 01581-3956

FRESH POND MA HD

| С | ONSTRUC [*] | ΓΙΟΝ | DRAWINGS |
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| 5 | 02/18/21 | FOR | SUBMITTAL |
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| 2 | 01/04/21 | FOR | SUBMITTAL |
| 1 | 12/10/20 | FOR | SUBMITTAL |
| 0 | 06/02/20 | FOR | SUBMITTAL |



Dewberry Engineers Inc. 99 SUMMER STREET SUITE 700 BOSTON, MA 02110 PHONE: 617.095.3400 FAX: 617.695.3310

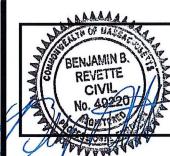

| DRAWN BY: | AJB |
|-----------------|----------|
| REVIEWED BY: | JCM |
| CHECKED BY: | BBR |
| PROJECT NUMBER: | 50121487 |
| JOB NUMBER: | 50121678 |
| SITE ADDRESS: | |

545 CONCORD AVENUE CAMBRIDGE, MA 02138


SHEET TITLE

SMART TOOL SECTOR PLANS & ELEVATIONS

SHEET NUMBER

A - 5

Exhibit 3 "Photo Simulations"

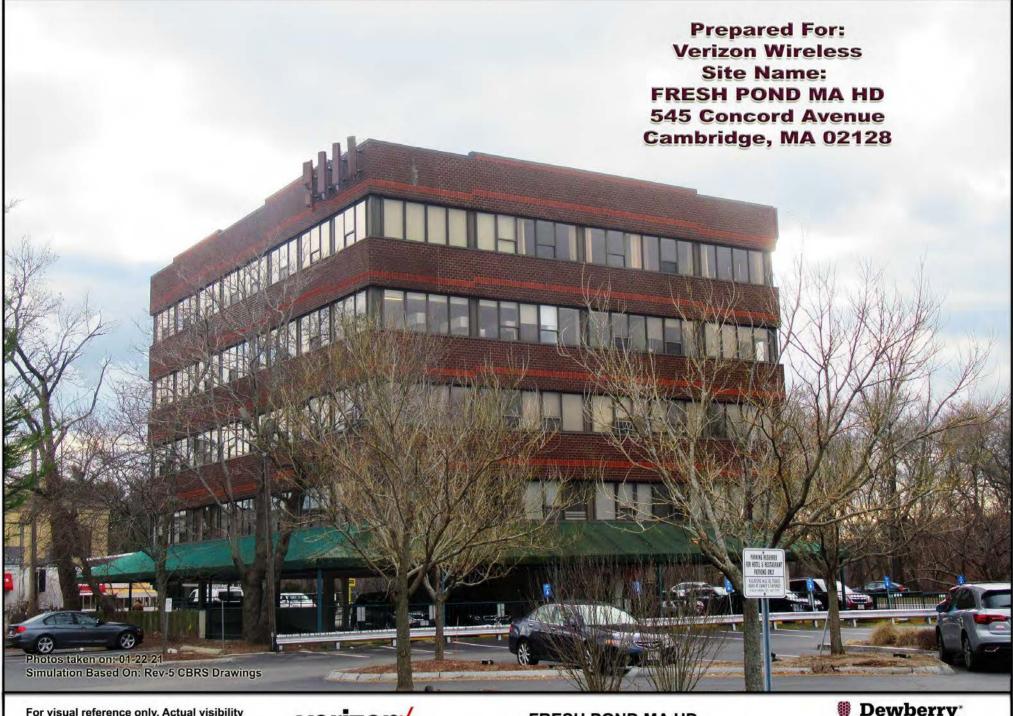

For visual reference only. Actual visibility is dependent upon weather conditions, season, sunlight, and viewer location.




FRESH POND MA HD

DEWBERRY NO. 50121497 (Page 1 of 8)



Dewberry Engineers Inc. 99 Summer St. Suite 700 Boston, MA 02110

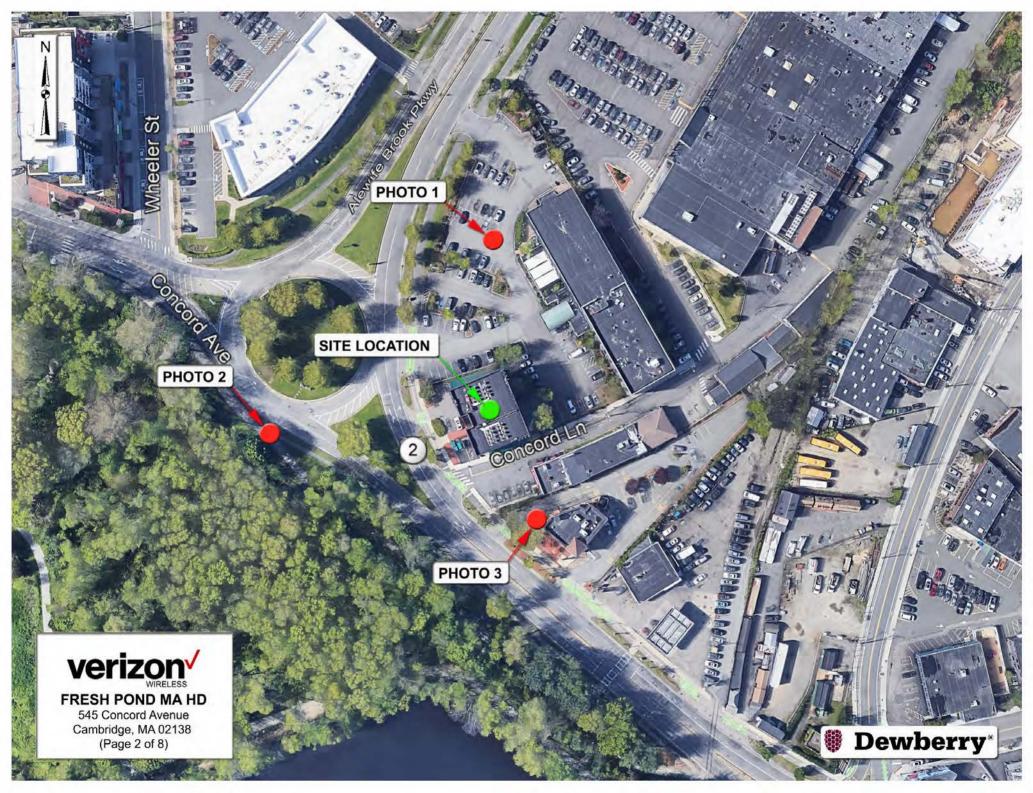





Proposed Alpha Sector Panel Antenna (Typ.-2) (To Replace Existing)

Existing Alpha Sector Antenna (Typ.-1) (To Remain)

Proposed Alpha Sector VZS01 Antenna

Proposed Alpha Sector CBRS RRU With Clip On Antenna



FRESH POND MA HD Photo 1B

View Facing South From Northern Parking Lot (Page 4 of 8)











Exhibit 4 "FCC License to Operate"

REFERENCE COPY

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Federal Communications Commission

Wireless Telecommunications Bureau

RADIO STATION AUTHORIZATION

LICENSEE: CELLCO PARTNERSHIP

ATTN: REGULATORY CELLCO PARTNERSHIP 5055 NORTH POINT PKWY, NP2NE ENGINEERING ALPHARETTA, GA 30022

| Call Sign WRBA936 | File Number | |
|-----------------------------------|-------------|--|
| Radio Service | | |
| UU - Upper Microwave Flexible Use | | |
| Service | | |

FCC Registration Number (FRN): 0003290673

| Grant Date 09-11-2018 | Effective Date 02-27-2019 | Expiration Date 10-06-2028 | Print Date |
|---|---------------------------|-------------------------------|-----------------------|
| Market Number BTA051 | | nel Block L1 | Sub-Market Designator |
| | Market Boston | | |
| 1st Build-out Date 06-01-2024 | 2nd Build-out Date | 3rd Build-out Date | 4th Build-out Date |

Waivers/Conditions:

Grant of the request to update licensee name is conditioned on it not reflecting an assignment or transfer of control (see Rule 1.948); if an assignment or transfer occurred without proper notification or FCC approval, the grant is void and the station is licensed under the prior name.

Conditions:

Pursuant to §309(h) of the Communications Act of 1934, as amended, 47 U.S.C. §309(h), this license is subject to the following conditions: This license shall not vest in the licensee any right to operate the station nor any right in the use of the frequencies designated in the license beyond the term thereof nor in any other manner than authorized herein. Neither the license nor the right granted thereunder shall be assigned or otherwise transferred in violation of the Communications Act of 1934, as amended. See 47 U.S.C. § 310(d). This license is subject in terms to the right of use or control conferred by §706 of the Communications Act of 1934, as amended. See 47 U.S.C. §606.

This license may not authorize operation throughout the entire geographic area or spectrum identified on the hardcopy version. To view the specific geographic area and spectrum authorized by this license, refer to the Spectrum and Market Area information under the Market Tab of the license record in the Universal Licensing System (ULS). To view the license record, go to the ULS homepage at http://wireless.fcc.gov/uls/index.htm?job=home and select "License Search". Follow the instructions on how to search for license information.

Licensee Name: CELLCO PARTNERSHIP

Call Sign: WRBA936 File Number: Print Date:

700 MHz Relicensed Area Information:

Market Name Buildout Deadline Buildout Notification Status

REFERENCE COPY

This is not an official FCC license. It is a record of public information contained in the FCC's licensing database on the date that this reference copy was generated. In cases where FCC rules require the presentation, posting, or display of an FCC license, this document may not be used in place of an official FCC license.



Federal Communications Commission

Wireless Telecommunications Bureau

RADIO STATION AUTHORIZATION

LICENSEE: CELLCO PARTNERSHIP

ATTN: REGULATORY CELLCO PARTNERSHIP 5055 NORTH POINT PKWY, NP2NE ENGINEERING ALPHARETTA, GA 30022

| Call Sign WRBA937 | File Number | |
|-----------------------------------|-------------|--|
| Radio Service | | |
| UU - Upper Microwave Flexible Use | | |
| Service | | |

FCC Registration Number (FRN): 0003290673

| Grant Date 09-11-2018 | Effective Date 02-27-2019 | Expiration Date 10-06-2028 | Print Date |
|---|---------------------------|-------------------------------|-----------------------|
| Market Number BTA051 | | nel Block L2 | Sub-Market Designator |
| | | t Name n, MA | |
| 1st Build-out Date 06-01-2024 | 2nd Build-out Date | 3rd Build-out Date | 4th Build-out Date |

Waivers/Conditions:

Grant of the request to update licensee name is conditioned on it not reflecting an assignment or transfer of control (see Rule 1.948); if an assignment or transfer occurred without proper notification or FCC approval, the grant is void and the station is licensed under the prior name.

Conditions:

Pursuant to §309(h) of the Communications Act of 1934, as amended, 47 U.S.C. §309(h), this license is subject to the following conditions: This license shall not vest in the licensee any right to operate the station nor any right in the use of the frequencies designated in the license beyond the term thereof nor in any other manner than authorized herein. Neither the license nor the right granted thereunder shall be assigned or otherwise transferred in violation of the Communications Act of 1934, as amended. See 47 U.S.C. § 310(d). This license is subject in terms to the right of use or control conferred by §706 of the Communications Act of 1934, as amended. See 47 U.S.C. §606.

This license may not authorize operation throughout the entire geographic area or spectrum identified on the hardcopy version. To view the specific geographic area and spectrum authorized by this license, refer to the Spectrum and Market Area information under the Market Tab of the license record in the Universal Licensing System (ULS). To view the license record, go to the ULS homepage at http://wireless.fcc.gov/uls/index.htm?job=home and select "License Search". Follow the instructions on how to search for license information.

Licensee Name: CELLCO PARTNERSHIP

Call Sign: WRBA937 File Number: Print Date:

700 MHz Relicensed Area Information:

Market Name Buildout Deadline Buildout Notification Status

Exhibit 5 "ZBA Decision"

Southern Middlesex - 20/20 Perfect Vision i2 Document Detail Report

Current datetime: 1/8/2021 7:49:22 PM

| Doc# | Document Type | Town | Book/Page | File Date | Consideration |
|------------|--------------------------|----------------|---------------|------------|---------------|
| 868 | DECISION | | 27811/384 | 10/28/1997 | |
| Property-S | treet Address and/or Des | scription | | | |
| 545 CONC | ORD AV SP PERMIT &am | np;C | | | |
| Grantors | | | | | |
| CAMBRIDO | GE CITY OF, MODERN C | ONTINENTIAL EN | TERPRISES INC | | |
| Grantees | | | | | |
| References | s-Book/Pg Description F | Recorded Year | | | |
| Registered | Land Certificate(s)-Cert | # Book/Pa | | | |



City of Cambridge RECEIVED BY OLEA

MASSACHUSETTS

BOARD OF ZONING APPEAL

97 OCT -3 AM IG

CAMBRIDGE MA.

LOCUS: 545 (Oncord Avenua (2m fr. 1878797 82:48:58

CASE NO:

7530

LOCATION:

545 Concord Avenue

Cambridge, MA

Business C Zone

PETITIONER:

Bell Atlantic Nynex Mobile -Paul J. Moriarty & Associates

Owner modern Continental Enterprises

PETITION:

Special Permit: To establish a telephone exchange

use at 545 Concord Avenue with antennae

equipment installation.

VIOLATIONS:

Art. 4.000, Sec. 4.32.G.1 (Transportation,

Communication & Utility Uses).

DATE OF PUBLIC NOTICE:

August 12 & 19, 1997

DATE OF PUBLIC HEARING: August 28, 1997

MEMBERS OF THE BOARD:

Lauren Curry - Chairperson Michael Wiggins - Vice Chair Charles Pierce John O'Connell

Thomas Sieniewicz

ASSOCIATE MEMBERS:

Susan Spurlock Theodore Hartry Arch Horst

Laura Kershner

James Daniel

David Gray Hanson

Marc Truant

Members of the Board of Zoning Appeal heard testimony and viewed materials submitted regarding the above request for relief from the requirements of the Cambridge Zoning Ordinance.

The Board is familiar with the location of the petitioner's property, the layout and other characteristics as well as the surrounding district.

BK 27811 PG 385

Case No.:

7530

Location:

545 Concord Avenue

Petitioner:

Bell Atlantic Nynex Mobile Paul J. Moriarty & Associates

On August 28, 1997, Tom Befera and Peter Lew, of Bell Atlantic Nynex Mobile, and Paul Moriarty, from Paul J. Moriarty & Associates, appeared before the Board of Zoning Appeal seeking a special permit to establish a telephone exchange use at 545 Concord Avenue with antennae and equipment installation. The applicants submitted plans, drawings and photographs detailing the proposed project.

It was noted that the petitioner agreed to proceed with having the case heard with only four Board members, knowing that all four votes are required to approve the proposed variance.

At the hearing, Mr. Befera stated that the proposed installation is to be a telephone exchange use with antennae and equipment installation at 545 Concord Avenue. He stated that the switching equipment is to be housed within the existing building, the emergency generator system is to be located in the front of the building near the existing vent, and a four panel antennae is to be mounted to the building. He stated that the four panel antennae and the mounted brackets are to be painted with the color of the existing brick background so the equipment will blend in with the surroundings.

Catherine Erat, of 32 Normandy Avenue, indicated her concern as to what the City's policy is for mobile communications facilities and to the equipment standards of the height and location.

The Chair moved that the special permit to establish a telephone exchange use at 545 Concord Avenue with antennae and equipment installation be granted on the following conditions: 1) that the work proceed in approximate conformance with the plans by Dagle Engineers, Incorporated, for Bell Atlantic Nynex Mobile, Project No. 97493 and dated May 6, 1997; 2) that the antennae project no further from the building than as described by the petitioner; 3) that the antennae be painted to match the color of the facade to which the antennae are going to be attached; and 4) that if the petitioner ever chooses to replace or upgrade its equipment in any way that would change the dimensions or the physical appearance of the antennae, then the petitioner would have to return to the Board and seek a new special permit. Four members of the Board voted to grant the special permit.

BK 27811 8 386


The Board based the decision upon the above findings and upon the following:

- 1) The meeting of the requirements of the Ordinance;
- 2) Traffic generated or patterns of access or egress would not cause congestion, hazard, or substantial change in the established neighborhood character;
- 3) The continued operation of or the development of adjacent uses as permitted in the Ordinance would not be adversely affected by the nature of the proposed use;
- 4) Nuisance or hazard would not be created to the detriment of the health, safety and/or welfare of the occupants of the proposed use, and;
- 5) The proposed use would not impair the integrity of the district or adjoining district or otherwise derogate from the Ordinance, and in fact be a significant improvement to the structure and benefit the neighborhood.

The Board of Zoning Appeal is empowered to waive local zoning regulations only. This decision therefore does not relieve the petitioner in any way from the duty to comply with local ordinances and regulation of other local agencies, including, but not limited to the Historical Commission, License Commission and/or compliance with requirements pursuant to the Building Code and other applicable codes.

Michael Wiggins, Vice-Chair

| Attest: A true and correct copy of decision filed with the offices |
|--|
| of the City Clerk and Planning Board on 10-3-97 by |
| Maria (Alleco, Clerk. |
| • |
| Twenty days have elapsed since the filing of this decision |
| No appeal has been filed |
| Appeal has been filed and dismissed or denied |
| Date OCT. 28 1897 D. Margaret Drum |
| Date OCT. 28 1997 D. Plangaret Crum gier Clerk. |
| |
| |
| |

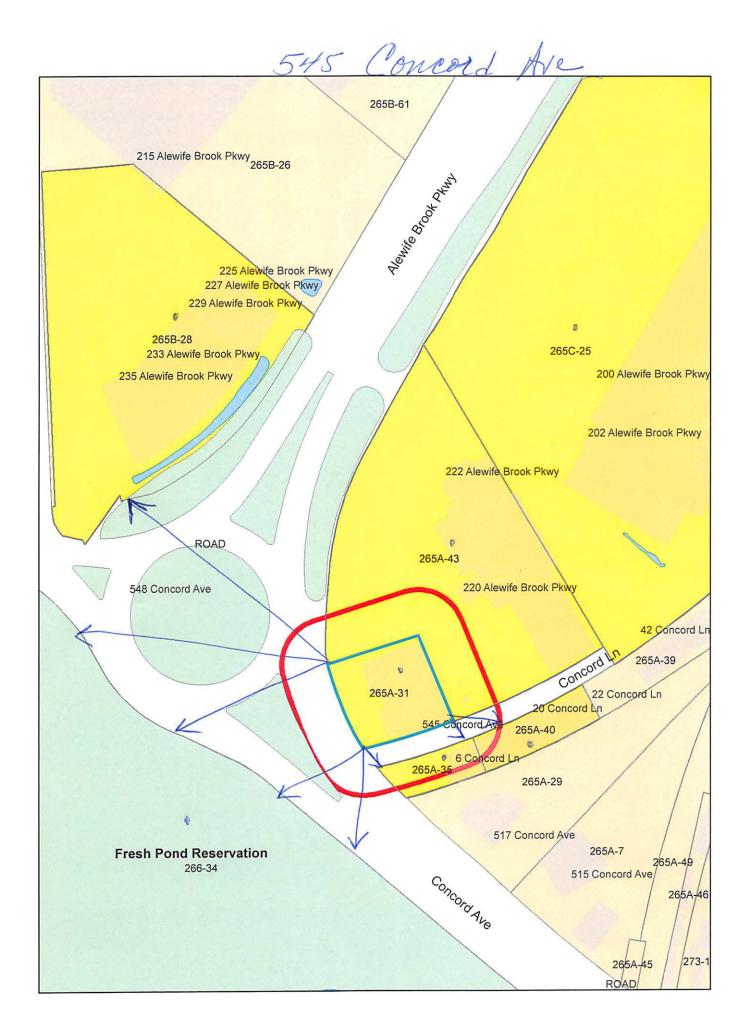

265A-35 MAGOOFAM LLC, 259 CHANNING RD. BELMONT, MA 02478-3108

265C-25 THE FRESH POND MALL LIMITED PARTNERSHIP 545 CONCORD AVE. SUITE 400 CAMBRIDGE, MA 02138

265B-28 LINEAR RETAIL CAMBRIDGE #1 LLC C/O KEYPOINT PARTNERS 1 BURLINGTON WOODS DR. BURLINGTON, MA 01803

266-34 CITY OF CAMBRIDGE C/O NANCY GLOWA CITY SOLICITOR 545 Concord Are

265A-40
ATINIZIAN, NIGOGHOS & CAROLYN ATINIZIAN
TRS THE FRESH POND SHOPPING CENTER TRUST
545 CONCORD AVE., SUITE #400
CAMBRIDGE, MA 02138

265A-43 220 ALEWIFE BROOK PARKWAY LLC C/O HERSHA HOSPITALITY MGMT LP 510 WALNUT ST., 9TH FLOOR PHILADELPHIA, PA 19106

265A-31 ALEWIFE PROPERTIES, LLC 545 CONCORD AVENUE CAMBRIDGE, MA 02138 DUVAL & KLASNICK, LLC C/O DANIEL D. KASNICK, ESQ. P.O. BOX 254 BOXFORD, MA 01921

266-34 CAMBRIDGE CITY OF WATER DEPT 250 FRESH POND PKWY CAMBRIDGE, MA 02138

266-34 CITY OF CAMBRIDGE C/O LOUIE DEPASQUALE CITY MANAGER