

# **CITY OF CAMBRIDGE**

BOARD OF ZONING APPEAL

831 Massachusetts Avenue, Cambridge MA 02139

617-349-6100

2023 MAR -3 AM 10: 18

### **BZA Application Form**

BZA Number: 212734

General	Information

		General II	<u>normation</u>
The undersigned	hereby petitions the	Board of Zoning Ap	peal for the following:
Special Permit: _	X	Variance: X	Appeal:
PETITIONER: SI	usan Kale C/O Jam	<u>es J. Rafferty</u>	
PETITIONER'S A	DDRESS: 907 Mas	sachusetts Avenue,	Cambridge, MA 02139
LOCATION OF P	ROPERTY: <u>5 Foch</u>	St , Cambridge, MA	<u>A</u>
TYPE OF OCCU	PANCY: single fami	<u>ly</u>	ZONING DISTRICT: Residence B Zone
REASON FOR P	ETITION:		
/Additions/			
DESCRIPTION	OF PETITIONER	'S PROPOSAL:	
			by constructing second and third floor additions that will ss to third floor living space.
Add windows with	in the setback.		
SECTIONS OF Z	ONING ORDINANC	E CITED:	
Article: 5.000 Article: 8.000 Article: 8.000 Article: 10.000	Section: 8.22.3 (N Section: 8.22.2.c (	e of Dimensional Re on-Conforming Struc (Non-Conforming Str ariance). & Sec. 10.4	cture). ucture).
		Original Signature(s):	(Petitioner (s) / Owner)
		a	James J. Rafferty, Attorney for Petitioner (Print Name)

Address: Tel. No.

E-Mail Address:

Cambridge, MA 02139

jrafferty@adamsrafferty.com

617.492.4100

### OWNERSHIP INFORMATION FOR BOARD OF ZONING APPEAL RECORD

To be completed by OWNER, signed and returned to Secretary of Board of Appeal
Susan Kale
(Owner or Petitioner)
Address: c/o James J. Rafferty 907 Massachusetts Avenue, Cambridge MA 02139
Location of Premises: 5 Foch Street
the record title standing in the name ofSusan and Carol Kale
T T
whose address is 5 Foch Street, Cambridge MA (Street) (City or Town) (State & Zip Code)
by a deed duly recorded in the Middlesex South County Registry of Deeds in
Book <u>26683 Page 444</u> or Registry
District of Land Court Certificate No Book Page
(Owner)
On this day of December 2022, before me, the undersigned notary public, personally appeared
Alice Mhistore Notary Public
My commission expires: ALICE M. TRIFONE Notary Public Commonwealth of Massachusette My Commission Expires June 1, 2023

#### **BZA Application Form**

#### SUPPORTING STATEMENT FOR A VARIANCE

EACH OF THE FOLLOWING REQUIREMENTS FOR A VARIANCE MUST BE ESTABLISHED AND SET FORTH IN COMPLETE DETAIL BY THE APPLICANT IN ACCORDANCE WITH MGL 40A, SECTION 10.

A) A literal enforcement of the provisions of this Ordinance would involve a substantial hardship, financial or otherwise, to the petitioner or appellant for the following reasons:

A literal enforcement of the Ordinance would prevent the Petitioner from expanding the attic and creating building code compliant access and egress.

The hardship is owing to the following circumstances relating to the soil conditions, shape or topography of such land or structures and especially affecting such land or structures but not affecting generally the zoning district in which it is located for the following reasons:

The hardship is directly related to the shape and size of the lot and the slope of the existing roof.

#### C) DESIRABLE RELIEF MAY BE GRANTED WITHOUT EITHER:

1) Desirable relief may be granted without substantial detriment to the public good for the following reasons:

The home will continue to conform to the height, lot area per dwelling unit and open space requirements of the Residence B zoning district. Furthermore, the provided setbacks will not be altered as a result of this application.

2) Desirable relief may be granted without nullifying or substantially derogating from the intent or purpose of this Ordinance for the following reasons:

The proposed addition will result in a home that is consistent with the size and use of surrounding structures in the neighborhood.

\*If you have any questions as to whether you can establish all of the applicable legal requirements, you should consult with an attorney.

#### **BZA Application Form**

#### SUPPORTING STATEMENT FOR A SPECIAL PERMIT

Please describe in complete detail how you meet each of the following criteria referring to the property and proposed changes or uses which are requested in your application. Attach sheets with additional information for special permits which have additional criteria, e.g.; fast food permits, comprehensive permits, etc., which must be met.

Granting the Special Permit requested for <u>5 Foch St</u>, <u>Cambridge</u>, <u>MA</u> (location) would not be a detriment to the public interest because:

- A) Requirements of the Ordinance can or will be met for the following reasons:
  - Article 8.22.2(c) permits the creation of windows on non-conforming walls when, as in this case, there are no further violations of the dimensional requirements of Article 5.000.
- B) Traffic generated or patterns of access or egress would not cause congestion hazard, or substantial change in established neighborhood character for the following reasons:
  - There will not be any change in traffic patterns as a result of adding windows.
- The continued operation of or the development of adjacent uses as permitted in the Zoning Ordinance would not be adversely affected by the nature of the proposed use for the following reasons:
  - Adjacent uses will not be affected since the use of the property as a single family dwelling will not be changed.
- Nuisance or hazard would not be created to the detriment of the health, safety, and/or welfare of the occupant of the proposed use or the citizens of the City for the following reasons:
  - Adding windows will benefit the health, safety, and welfare of the occupants of this dwelling.
- For other reasons, the proposed use would not impair the integrity of the district or adjoining district or otherwise derogate from the intent or purpose of this ordinance for the following reasons:
  - The proposed windows will not change the use of the property and are consistent with the residential uses in the district.

<sup>\*</sup>If you have any questions as to whether you can establish all of the applicable legal requirements, you should consult with an attorney.

Date: 3/1/23

### **BZA Application Form**

#### **DIMENSIONAL INFORMATION**

Applicant: Susan Kale Location:

5 Foch St, Cambridge, MA

Phone: 617.492.4100 Present Use/Occupancy: single family

Zone: Residence B Zone

Requested Use/Occupancy: single family

		Existing Conditions	Requested Conditions	<u>Ordinance</u> <u>Requirements</u>	
TOTAL GROSS FLOOR AREA:		1,757 sf	2,302 sf	2,040 sf	(max.)
LOT AREA:		4,080 sf	no change	5,000 sf	(min.)
RATIO OF GROSS FLOOR AREA TO LOT AREA: <sup>2</sup>		.43	.564	.50	
LOT AREA OF EACH DWELLING UNIT		4,080	no change	2,500	
SIZE OF LOT:	WIDTH	45'	no change	50'	
<u></u> .	DEPTH	88.87'	no change	N/A	
SETBACKS IN FEET:	FRONT	15'	no change	15'	
	REAR	29'	no change	25'	
	LEFT SIDE	4.1'	no change	7'6" (sum of 20)	
	RIGHT SIDE	16.6'	no change	7'7" (sum of 20)	
SIZE OF BUILDING:	HEIGHT	32'	35'	35'	
	WIDTH	44.8'	no change	N/A	
	LENGTH	24.5'	no change	N/A	
RATIO OF USABLE OPEN SPACE TO LOT AREA:		46%	no change	40%	
NO. OF DWELLING UNITS:		1	no change	1	
NO. OF PARKING SPACES:		2	no change	0	
NO. OF LOADING AREAS:		N/A	no change	N/A	
DISTANCE TO NEAREST BLDG, ON SAME LOT		N/A	N/A	N/A	

Describe where applicable, other occupancies on the same lot, the size of adjacent buildings on same lot, and type of construction proposed, e.g; wood frame, concrete, brick, steel, etc.:

#### N/A

- 1. SEE CAMBRIDGE ZONING ORDINANCE ARTICLE 5.000, SECTION 5.30 (DISTRICT OF DIMENSIONAL REGULATIONS).
- 2. TOTAL GROSS FLOOR AREA (INCLUDING BASEMENT 7'-0" IN HEIGHT AND ATTIC AREAS GREATER THAN 5') DIVIDED BY LOT AREA.
- 3. OPEN SPACE SHALL NOT INCLUDE PARKING AREAS, WALKWAYS OR DRIVEWAYS AND SHALL HAVE A MINIMUM **DIMENSION OF 15'.**

3. ALL WORK SHALL COMPLY WITH THE STANDARDS OF THE NATIONAL BOARD OF FIRE UNDERWRITERS (NBFU), INDUSTRIAL RISK INSURANCE UNDERWRITERS (IRI), FACTORY MUTUAL (FW), OR THE APPLICABLE RATING BUREAU. THE NATIONAL ELECTRIC CODE (NEC), THE AMERICAN GAS ASSOCIATION (AGA), AND THE AMERICAN SOCIETY OF HEATING AND AIR CONDITIONING ENGINEERS (ASHAE), OCCUPATIONAL SAFETY AND HEALTH ADMINISTRATION (OSHA), APPLICABLE STATE AND CITY BUILDING CODES AND THE REQUIREMENTS OF ALL PUBLIC UTILITY COMPANIES

4. CONTRACTOR (AND HIS SUBCONTRACTORS) SHALL BE LICENSED BY THE STATE IN WHICH THE PROJECT IS LOCATED AND APPROVED IN ADVANCE BY THE OWNER.

5. CONTRACTOR SHALL FILE ALL APPLICATIONS, PAY FOR ALL NECESSARY PERMITS AND SECURE

6. ALL WORK IS TO BE COORDINATED WITH THE OWNER. THE CONTRACTOR IS TO MEET WITH THE OWNER PRIOR TO STARTING CONSTRUCTION. THE CONTRACTOR WILL PRESENT THE BUILDING PERMIT AND INSURANCE CERTIFICATES TO THE OWNER PRIOR TO STARTING CONSTRUCTION

7. CONTRACTOR SHALL PROVIDE ANY NECESSARY MEASURES TO PROTECT THE WORKERS AND OTHER PERSONS DURING CONSTRUCTION.

8. CHECK WITH THE OWNER FOR COORDINATION OF THE WORK UNDER THIS CONTRACT WITH WORK OF OTHER TRADES. OWNER'S REGULATIONS GOVERN ALL ASPECTS OF OUTSIDE

CONTRACTORS WORKING ON THE PROPERTY. 9. CONTRACTOR SHALL KEEP THE JOB FREE OF DEBRIS AND MAKE FINAL CLEANUP TO THE SATISFACTION OF THE OWNER. CONTRACTOR SHALL BE RESPONSIBLE FOR REMOVAL OF ALL CONSTRUCTION DEBRIS FROM PROJECT SITE AND SHALL PROVIDE DUMPSTERS ETC. AS  $\,$ 

REQUIRED, REMOVE ALL DEBRIS ON A DAILY BASIS.

10. CONTRACTOR SHALL BE RESPONSIBLE FOR THE PROTECTION OF ALL EXISTING BUILDINGS AND OTHER INSTALLATIONS THAT ARE TO REMAIN INTACT WHILE PERFORMING THE SPECIFIED  $\,$ WORK. PROVIDE AND MAINTAIN FIRE EXTINGUISHERS ON PROJECT SITE DURING CONSTRUCTION.

11. UNLESS INDICATED OTHERWISE, ALL MATERIAL FURNISHED AND INCORPORATED INTO THE WORK SHALL BE NEW, UNUSED AND OF QUALITY STANDARD TO THE INDUSTRY FOR FIRST CLASS WORK OF SIMILAR NATURE AND CHARACTER. INSTALL ALL MATERIALS TO THE MANUFACTURER'S RECOMMENDATIONS AND BEST STANDARD OF THE TRADES INVOLVED.

12. CONTRACTOR SHALL FIELD VERIFY ALL DIMENSIONS IN FIELD PRIOR CONSTRUCTION. NOTIFY ARCHITECT OF ANY DISCREPANCIES ON DRAWINGS.

13. THE CONTRACTOR AND ALL SUBCONTRACTORS MUST VISIT THE SITE TO VERIFY EXISTING CONDITIONS PRIOR TO ANY WORK. EXISTING CONCEALED CONDITIONS AND CONNECTIONS ARE BASED UPON INFORMATION TAKEN FROM LIMITED FIELD INVESTIGATIONS. CONTRACTOR SHALL MAKE REQUIRED ADJUSTMENTS TO SYSTEM COMPONENTS AS NECESSITATED BY ACTUAL FIELD CONDITIONS AT NO ADDITIONAL COST TO OWNER OR ARCHITECT. REPORT ANY DISCREPANCIES BETWEEN THE DRAWINGS AND ACTUAL FIELD CONDITIONS TO THE ARCHITECT BEFORE CONSTRUCTION BEGINS.

14. UNLESS OTHERWISE INDICATED ALL INTERIOR FINISHES SHALL BE AS DIRECTED BY THE

15. CONTRACTOR TO OBTAIN AND PROVIDE OWNER WITH COLOR SAMPLES FOR PROPER COLOR SELECTION AND FINAL APPROVAL OF ALL FINISHES PRIOR TO INSTALLATION

16. INTERIOR FINISHES SHALL BE CLASS C (SURFACE FLAME SPREAD RATING OF 76200) MINIMUM IN CONFORMITY WITH GENERALLY ACCEPTED STANDARDS. CARPETING SHALL BE CLASS 2 WITH A MINIMUM CRITICAL RADIANT FLUX OF .22WATTS PER SQUARE CENTIMETER.

17. ALL GYPSUM BOARD WORK SHALL BE DONE IN ACCORDANCE WITH THE DRYWALL CONSTRUCTION HANDBOOK, LATEST EDITION, PREPARED BY UNITED STATES GYPSUM. ALL JOINTS AND SEAMS SHALL BE TAPED AND FINISHED IN ACCORDANCE WITH MANUFACTURER'S INSTALLATION RECOMMENDATIONS

18. PAINTING FOR GYPSUM BOARD AND WOOD CONSTRUCTION PROVIDE TWO (2) FINISH COATS OF PREMIUM GRADE PAINT OVER SINGLE COAT OF COMPATIBLE PRIMER, PROMAR 200 SERIES BY SHERWIN WILLIAMS, CLEVELAND, OHIO OR APPROVED EQUAL. ALL PAINT BY SINGLE

19. GC TO VERIFY ALL WINDOW LOCATIONS AND SIZES FOR REPLACEMENT SCOPE. ANY LOCATIONS/SIZES IN CONFLICT WITH NEW CONSTRUCTION ASSEMBLIES SHALL BE BROUGHT TO THE ARCHITECTS ATTENTION, IN WRITING, IMMEDIATELY.

20. THE OWNER AND CONTRACTOR SHALL INDEMNIFY AND HOLD HARMLESS THEARCHITECT/ DESIGNER FROM AND AGAINST CLAIMS, DAMAGES, LOSSES AND EXPENSES ARISING OUT OF OR RESULTING FROM THE PERFORMANCE OF THE WORK, PROVIDED THAT SUCH CLAIM, DAMAGE, LOSS OR EXPENSE IS ATTRIBUTABLE TO BODILY INJURY, SICKNESS, DISEASE OR DEATH, OR TO INJURY TO OR DESTRUCTION OF TANGIBLE PROPERTY, BUT ONLY TO THE EXTENT CAUSED BY THE NEGLIGENT ACTS OR OMISSIONS OF THE CONTRACTOR, A SUBCONTRACTOR, OR ANYONE DIRECTLY OR INDIRECTLY EMPLOYED BY OR ANYONE FOR WHOSE ACTS THEY MAY BE LIABLE.

WALL TO BE DEMOLISHED

EXISTING WALL TO REMAIN

# **ENERGY CODE INFO**

THE FOLLOWING ARE ENERGY CODE REQUIREMENTS BASED ON THE 2015 IECC. REFER DIRECTLY TO THI LOCAL GOVERNING AGENCY TO ENSURE THE R-VALUES BELOW ARE SUFFICIENT PRIOR TO INITIATING AN


U-FACTORS: FENESTRATION: 0.32

R-VALUES: CEILING/ROOF - R49 WALLS - R20

SKYLIGHTS: 0.32 WINDOW GLAZING: 0.27 FLOORS - R30 DOORS: 0.30

BASEMENT WALLS - R15 (CONT.) OR R19 (IN STUD CAVITIES) CRAWLSPACE WALLS - R15 (CONT.) OR R19 (IN STUD CAVITIES)

SLAB: R10 TO 24" DEPTH REFER TO 2015 IECC TABLE R402.1.2 FOR FURTHER INFORMATION IF NECESSARY.

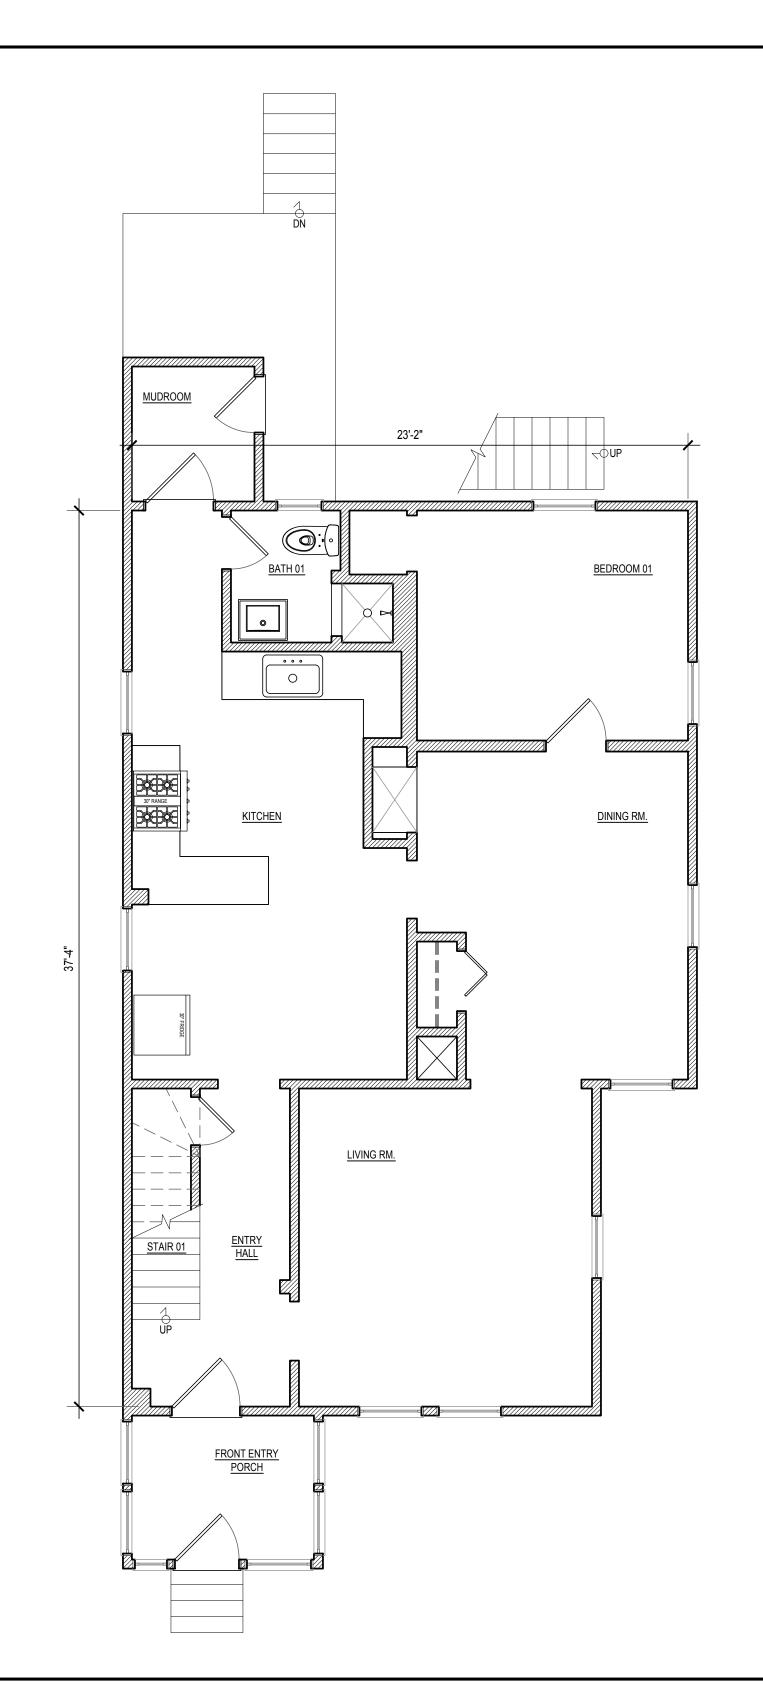

7

0

BRIDGE,

N

Drawing Information: PROJECT NUMBER: 2 0 2 0 - 0 1 JRK CHECKED BY: JRK 02/15/2023 SHEET REFERENCE:

> FIRST FLOOR: **EXISTING**

3. ALL WORK SHALL COMPLY WITH THE STANDARDS OF THE NATIONAL BOARD OF FIRE UNDERWRITERS (NBFU), INDUSTRIAL RISK INSURANCE UNDERWRITERS (IRI), FACTORY MUTUAL (FW), OR THE APPLICABLE RATING BUREAU. THE NATIONAL ELECTRIC CODE (NEC), THE AMERICAN GAS ASSOCIATION (AGA), AND THE AMERICAN SOCIETY OF HEATING AND AIR CONDITIONING ENGINEERS (ASHAE), OCCUPATIONAL SAFETY AND HEALTH ADMINISTRATION (OSHA), APPLICABLE STATE AND CITY BUILDING CODES AND THE REQUIREMENTS OF ALL PUBLIC UTILITY COMPANIES

4. CONTRACTOR (AND HIS SUBCONTRACTORS) SHALL BE LICENSED BY THE STATE IN WHICH THE PROJECT IS LOCATED AND APPROVED IN ADVANCE BY THE OWNER.

5. CONTRACTOR SHALL FILE ALL APPLICATIONS, PAY FOR ALL NECESSARY PERMITS AND SECURE

6. ALL WORK IS TO BE COORDINATED WITH THE OWNER. THE CONTRACTOR IS TO MEET WITH THE OWNER PRIOR TO STARTING CONSTRUCTION. THE CONTRACTOR WILL PRESENT THE BUILDING PERMIT AND INSURANCE CERTIFICATES TO THE OWNER PRIOR TO STARTING CONSTRUCTION

7. CONTRACTOR SHALL PROVIDE ANY NECESSARY MEASURES TO PROTECT THE WORKERS AND OTHER PERSONS DURING CONSTRUCTION.

8. CHECK WITH THE OWNER FOR COORDINATION OF THE WORK UNDER THIS CONTRACT WITH WORK OF OTHER TRADES. OWNER'S REGULATIONS GOVERN ALL ASPECTS OF OUTSIDE CONTRACTORS WORKING ON THE PROPERTY.

9. CONTRACTOR SHALL KEEP THE JOB FREE OF DEBRIS AND MAKE FINAL CLEANUP TO THE SATISFACTION OF THE OWNER. CONTRACTOR SHALL BE RESPONSIBLE FOR REMOVAL OF ALL CONSTRUCTION DEBRIS FROM PROJECT SITE AND SHALL PROVIDE DUMPSTERS ETC. AS  $\,$ REQUIRED. REMOVE ALL DEBRIS ON A DAILY BASIS.

10. CONTRACTOR SHALL BE RESPONSIBLE FOR THE PROTECTION OF ALL EXISTING BUILDINGS AND OTHER INSTALLATIONS THAT ARE TO REMAIN INTACT WHILE PERFORMING THE SPECIFIED WORK, PROVIDE AND MAINTAIN FIRE EXTINGUISHERS ON PROJECT SITE DURING CONSTRUCTION.

11. UNLESS INDICATED OTHERWISE, ALL MATERIAL FURNISHED AND INCORPORATED INTO THE WORK SHALL BE NEW, UNUSED AND OF QUALITY STANDARD TO THE INDUSTRY FOR FIRST CLASS WORK OF SIMILAR NATURE AND CHARACTER. INSTALL ALL MATERIALS TO THE MANUFACTURER'S RECOMMENDATIONS AND BEST STANDARD OF THE TRADES INVOLVED.

12. CONTRACTOR SHALL FIELD VERIFY ALL DIMENSIONS IN FIELD PRIOR CONSTRUCTION. NOTIFY ARCHITECT OF ANY DISCREPANCIES ON DRAWINGS.

13. THE CONTRACTOR AND ALL SUBCONTRACTORS MUST VISIT THE SITE TO VERIFY EXISTING CONDITIONS PRIOR TO ANY WORK. EXISTING CONCEALED CONDITIONS AND CONNECTIONS ARE BASED UPON INFORMATION TAKEN FROM LIMITED FIELD INVESTIGATIONS. CONTRACTOR SHALL MAKE REQUIRED ADJUSTMENTS TO SYSTEM COMPONENTS AS NECESSITATED BY ACTUAL FIELD CONDITIONS AT NO ADDITIONAL COST TO OWNER OR ARCHITECT REPORT ANY DISCREPANCIES BETWEEN THE DRAWINGS AND ACTUAL FIELD CONDITIONS TO THE ARCHITECT BEFORE CONSTRUCTION BEGINS.

14. UNLESS OTHERWISE INDICATED ALL INTERIOR FINISHES SHALL BE AS DIRECTED BY THE

15. CONTRACTOR TO OBTAIN AND PROVIDE OWNER WITH COLOR SAMPLES FOR PROPER COLOR SELECTION AND FINAL APPROVAL OF ALL FINISHES PRIOR TO INSTALLATION

16. INTERIOR FINISHES SHALL BE CLASS C (SURFACE FLAME SPREAD RATING OF 76200) MINIMI IM IN CONFORMITY WITH GENERALLY ACCEPTED STANDARDS. CARPETING SHALL BE CLASS 2 WITH A MINIMUM CRITICAL RADIANT FLUX OF .22WATTS PER SQUARE CENTIMETER.

17. ALL GYPSUM BOARD WORK SHALL BE DONE IN ACCORDANCE WITH THE DRYWALL CONSTRUCTION HANDBOOK, LATEST EDITION, PREPARED BY UNITED STATES GYPSUM. ALL JOINTS AND SEAMS SHALL BE TAPED AND FINISHED IN ACCORDANCE WITH MANUFACTURER'S INSTALLATION RECOMMENDATIONS

18. PAINTING FOR GYPSUM BOARD AND WOOD CONSTRUCTION PROVIDE TWO (2) FINISH COATS OF PREMIUM GRADE PAINT OVER SINGLE COAT OF COMPATIBLE PRIMER, PROMAR 200 SERIES BY SHERWIN WILLIAMS, CLEVELAND, OHIO OR APPROVED EQUAL. ALL PAINT BY SINGLE

19. GC TO VERIFY ALL WINDOW LOCATIONS AND SIZES FOR REPLACEMENT SCOPE. ANY LOCATIONS/SIZES IN CONFLICT WITH NEW CONSTRUCTION ASSEMBLIES SHALL BE BROUGHT TO THE ARCHITECTS ATTENTION, IN WRITING, IMMEDIATELY.

20. THE OWNER AND CONTRACTOR SHALL INDEMNIFY AND HOLD HARMLESS THEARCHITECT/ DESIGNER FROM AND AGAINST CLAIMS, DAMAGES, LOSSES AND EXPENSES ARISING OUT OF OR RESULTING FROM THE PERFORMANCE OF THE WORK, PROVIDED THAT SUCH CLAIM, DAMAGE, LOSS OR EXPENSE IS ATTRIBUTABLE TO BODILY INJURY. SICKNESS, DISEASE OR DEATH, OR TO INJURY TO OR DESTRUCTION OF TANGIBLE PROPERTY, BUT ONLY TO THE EXTENT CAUSED BY THE NEGLIGENT ACTS OR OMISSIONS OF THE CONTRACTOR, A SUBCONTRACTOR, OR ANYONE DIRECTLY OR INDIRECTLY EMPLOYED BY OR ANYONE FOR WHOSE ACTS THEY MAY BE LIABLE.

WALL LEGEND

WALL TO BE DEMOLISHED

EXISTING WALL TO REMAIN

# **ENERGY CODE INFO**


THE FOLLOWING ARE ENERGY CODE REQUIREMENTS BASED ON THE 2015 IECC. REFER DIRECTLY TO THI LOCAL GOVERNING AGENCY TO ENSURE THE R-VALUES BELOW ARE SUFFICIENT PRIOR TO INITIATING AN

<u>U-FACTORS:</u> FENESTRATION: 0.32

R-VALUES: CEILING/ROOF - R49 WALLS - R20

SKYLIGHTS: 0.32 WINDOW GLAZING: 0.27 FLOORS - R30 DOORS: 0.30 BASEMENT WALLS - R15 (CONT.) OR R19 (IN STUD CAVITIES) CRAWLSPACE WALLS - R15 (CONT.) OR R19 (IN STUD CAVITIES)

SLAB: R10 TO 24" DEPTH REFER TO 2015 IECC TABLE R402.1.2 FOR FURTHER INFORMATION IF NECESSARY.

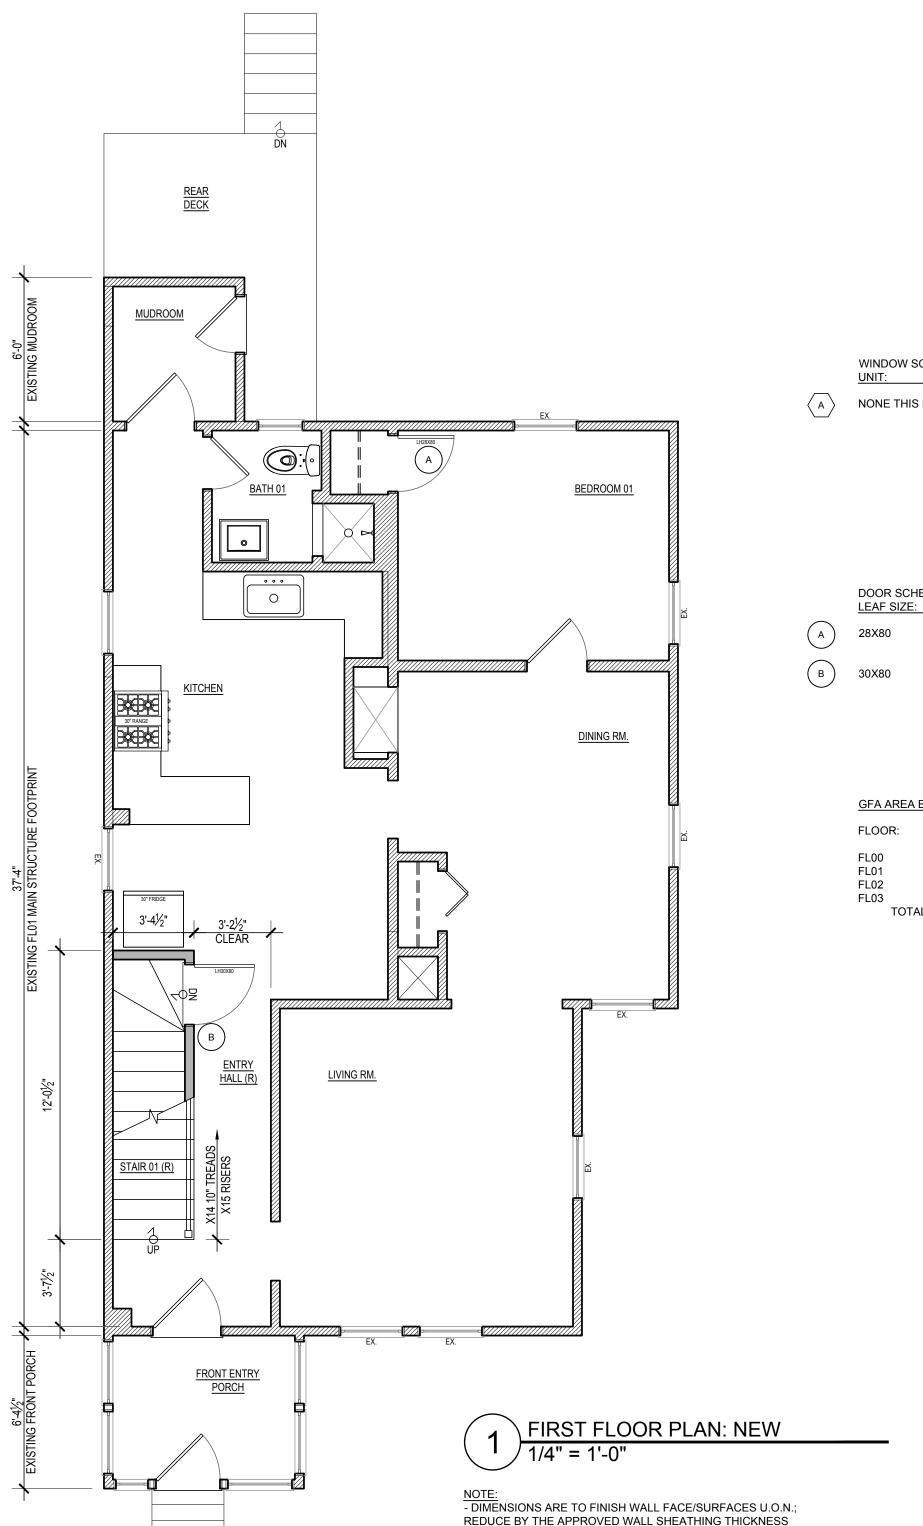

TO ATTAIN ROUGH FRAME DIMENSION/LOCATION.

WINDOW SCHED. (ANDERSEN 400 SERIES OR EQ.)

NONE THIS FLOOR

DOOR SCHED. (REFER TO PLAN FOR HANDING) QTY: MANU.: HW TYPE: BROSCO PR44 OVOLO PASSAGE

BROSCO PR44 OVOLO PASSAGE

GFA AREA BREAKDOWN

**EXISTING** PROPOSED ADD TOTAL BY FLOOR **EXCLUDED** EXCLUDED 0 SF 945 SF 0 SF 945 SF 616 SF 200 SF 816 SF TOTALS 1757 SF

> 0 N

Z

Ш

S

Ш

 $\triangleleft$ 

<u>N</u>

Д

7

0

≥

ВE

RD

S

 $\circ$ 

0

5

Drawing Information: PROJECT NUMBER: 2 0 2 0 - 0 1 JRK JRK 02/15/2023 SCALE: SHEET REFERENCE:

> FIRST FLOOR: NEW

3. ALL WORK SHALL COMPLY WITH THE STANDARDS OF THE NATIONAL BOARD OF FIRE UNDERWRITERS (NBFU), INDUSTRIAL RISK INSURANCE UNDERWRITERS (IRI), FACTORY MUTUAL (FW), OR THE APPLICABLE RATING BUREAU. THE NATIONAL ELECTRIC CODE (NEC), THE AMERICAN GAS ASSOCIATION (AGA), AND THE AMERICAN SOCIETY OF HEATING AND AIR CONDITIONING ENGINEERS (ASHAE), OCCUPATIONAL SAFETY AND HEALTH ADMINISTRATION (OSHA), APPLICABLE STATE AND CITY BUILDING CODES AND THE REQUIREMENTS OF ALL PUBLIC UTILITY COMPANIES

4. CONTRACTOR (AND HIS SUBCONTRACTORS) SHALL BE LICENSED BY THE STATE IN WHICH THE PROJECT IS LOCATED AND APPROVED IN ADVANCE BY THE OWNER.

5. CONTRACTOR SHALL FILE ALL APPLICATIONS, PAY FOR ALL NECESSARY PERMITS AND SECURE

6. ALL WORK IS TO BE COORDINATED WITH THE OWNER. THE CONTRACTOR IS TO MEET WITH THE OWNER PRIOR TO STARTING CONSTRUCTION. THE CONTRACTOR WILL PRESENT THE BUILDING PERMIT AND INSURANCE CERTIFICATES TO THE OWNER PRIOR TO STARTING CONSTRUCTION

7. CONTRACTOR SHALL PROVIDE ANY NECESSARY MEASURES TO PROTECT THE WORKERS AND OTHER PERSONS DURING CONSTRUCTION.

8. CHECK WITH THE OWNER FOR COORDINATION OF THE WORK UNDER THIS CONTRACT WITH WORK OF OTHER TRADES. OWNER'S REGULATIONS GOVERN ALL ASPECTS OF OUTSIDE CONTRACTORS WORKING ON THE PROPERTY.

9. CONTRACTOR SHALL KEEP THE JOB FREE OF DEBRIS AND MAKE FINAL CLEANUP TO THE SATISFACTION OF THE OWNER. CONTRACTOR SHALL BE RESPONSIBLE FOR REMOVAL OF ALL CONSTRUCTION DEBRIS FROM PROJECT SITE AND SHALL PROVIDE DUMPSTERS ETC. AS  $\,$ REQUIRED, REMOVE ALL DEBRIS ON A DAILY BASIS.

10. CONTRACTOR SHALL BE RESPONSIBLE FOR THE PROTECTION OF ALL EXISTING BUILDINGS AND OTHER INSTALLATIONS THAT ARE TO REMAIN INTACT WHILE PERFORMING THE SPECIFIED  $\,$ WORK. PROVIDE AND MAINTAIN FIRE EXTINGUISHERS ON PROJECT SITE DURING CONSTRUCTION.

11. UNLESS INDICATED OTHERWISE, ALL MATERIAL FURNISHED AND INCORPORATED INTO THE WORK SHALL BE NEW, UNUSED AND OF QUALITY STANDARD TO THE INDUSTRY FOR FIRST CLASS WORK OF SIMILAR NATURE AND CHARACTER. INSTALL ALL MATERIALS TO THE MANUFACTURER'S RECOMMENDATIONS AND BEST STANDARD OF THE TRADES INVOLVED.

12. CONTRACTOR SHALL FIELD VERIFY ALL DIMENSIONS IN FIELD PRIOR CONSTRUCTION. NOTIFY ARCHITECT OF ANY DISCREPANCIES ON DRAWINGS.

13. THE CONTRACTOR AND ALL SUBCONTRACTORS MUST VISIT THE SITE TO VERIFY EXISTING CONDITIONS PRIOR TO ANY WORK. EXISTING CONCEALED CONDITIONS AND CONNECTIONS ARE BASED UPON INFORMATION TAKEN FROM LIMITED FIELD INVESTIGATIONS. CONTRACTOR SHALL MAKE REQUIRED ADJUSTMENTS TO SYSTEM COMPONENTS AS NECESSITATED BY ACTUAL FIELD CONDITIONS AT NO ADDITIONAL COST TO OWNER OR ARCHITECT REPORT ANY DISCREPANCIES BETWEEN THE DRAWINGS AND ACTUAL FIELD CONDITIONS TO THE ARCHITECT BEFORE CONSTRUCTION BEGINS.

14. UNLESS OTHERWISE INDICATED ALL INTERIOR FINISHES SHALL BE AS DIRECTED BY THE

15. CONTRACTOR TO OBTAIN AND PROVIDE OWNER WITH COLOR SAMPLES FOR PROPER COLOR SELECTION AND FINAL APPROVAL OF ALL FINISHES PRIOR TO INSTALLATION

16. INTERIOR FINISHES SHALL BE CLASS C (SURFACE FLAME SPREAD RATING OF 76200) MINIMUM IN CONFORMITY WITH GENERALLY ACCEPTED STANDARDS. CARPETING SHALL BE CLASS 2 WITH A MINIMUM CRITICAL RADIANT FLUX OF .22WATTS PER SQUARE CENTIMETER.

17. ALL GYPSUM BOARD WORK SHALL BE DONE IN ACCORDANCE WITH THE DRYWALL CONSTRUCTION HANDBOOK, LATEST EDITION, PREPARED BY UNITED STATES GYPSUM. ALL JOINTS AND SEAMS SHALL BE TAPED AND FINISHED IN ACCORDANCE WITH MANUFACTURER'S INSTALLATION RECOMMENDATIONS.

18. PAINTING FOR GYPSUM BOARD AND WOOD CONSTRUCTION PROVIDE TWO (2) FINISH COATS OF PREMIUM GRADE PAINT OVER SINGLE COAT OF COMPATIBLE PRIMER, PROMAR 200 SERIES BY SHERWIN WILLIAMS, CLEVELAND, OHIO OR APPROVED EQUAL. ALL PAINT BY SINGLE

19. GC TO VERIFY ALL WINDOW LOCATIONS AND SIZES FOR REPLACEMENT SCOPE. ANY LOCATIONS/SIZES IN CONFLICT WITH NEW CONSTRUCTION ASSEMBLIES SHALL BE BROUGHT TO THE ARCHITECTS ATTENTION, IN WRITING, IMMEDIATELY.

20. THE OWNER AND CONTRACTOR SHALL INDEMNIFY AND HOLD HARMLESS THEARCHITECT/ DESIGNER FROM AND AGAINST CLAIMS, DAMAGES, LOSSES AND EXPENSES ARISING OUT OF OR RESULTING FROM THE PERFORMANCE OF THE WORK, PROVIDED THAT SUCH CLAIM, DAMAGE, LOSS OR EXPENSE IS ATTRIBUTABLE TO BODILY INJURY. SICKNESS, DISEASE OR DEATH, OR TO INJURY TO OR DESTRUCTION OF TANGIBLE PROPERTY, BUT ONLY TO THE EXTENT CAUSED BY THE NEGLIGENT ACTS OR OMISSIONS OF THE CONTRACTOR, A SUBCONTRACTOR, OR ANYONE DIRECTLY OR INDIRECTLY EMPLOYED BY OR ANYONE FOR WHOSE ACTS THEY MAY BE LIABLE.

WALL TO BE DEMOLISHED EXISTING WALL TO REMAIN

# **ENERGY CODE INFO.**


THE FOLLOWING ARE ENERGY CODE REQUIREMENTS BASED ON THE 2015 IECC. REFER DIRECTLY TO THI LOCAL GOVERNING AGENCY TO ENSURE THE R-VALUES BELOW ARE SUFFICIENT PRIOR TO INITIATING AN

U-FACTORS: FENESTRATION: 0.32 R-VALUES: CEILING/ROOF - R49 SKYLIGHTS: 0.32 WALLS - R20

WINDOW GLAZING: 0.27 FLOORS - R30 DOORS: 0.30

BASEMENT WALLS - R15 (CONT.) OR R19 (IN STUD CAVITIES) CRAWLSPACE WALLS - R15 (CONT.) OR R19 (IN STUD CAVITIES)

SLAB: R10 TO 24" DEPTH REFER TO 2015 IECC TABLE R402.1.2 FOR FURTHER INFORMATION IF NECESSARY.

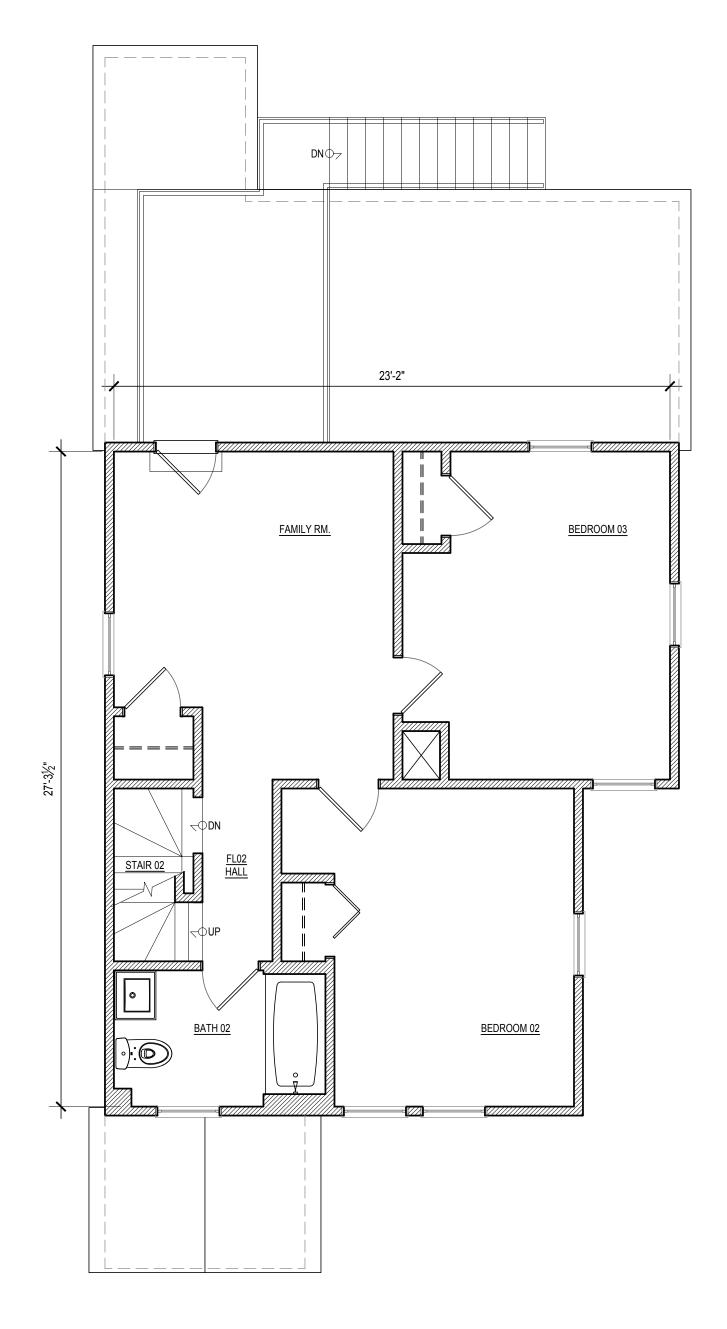

7

0

BRIDGE,

Drawing Information: PROJECT NUMBER: 2 0 2 0 - 0 1 JRK CHECKED BY: JRK 02/15/2023 SCALE: SHEET REFERENCE:

> SECOND FLOOR: **EXISTING**

3. ALL WORK SHALL COMPLY WITH THE STANDARDS OF THE NATIONAL BOARD OF FIRE UNDERWRITERS (NBFU), INDUSTRIAL RISK INSURANCE UNDERWRITERS (IRI), FACTORY MUTUAL (FW), OR THE APPLICABLE RATING BUREAU. THE NATIONAL ELECTRIC CODE (NEC),THE AMERICAN GAS ASSOCIATION (AGA), AND THE AMERICAN SOCIETY OF HEATING AND AIR CONDITIONING ENGINEERS (ASHAE), OCCUPATIONAL SAFETY AND HEALTH ADMINISTRATION (OSHA), APPLICABLE STATE AND CITY BUILDING CODES AND THE REQUIREMENTS OF ALL PUBLIC UTILITY COMPANIES

4. CONTRACTOR (AND HIS SUBCONTRACTORS) SHALL BE LICENSED BY THE STATE IN WHICH THE PROJECT IS LOCATED AND APPROVED IN ADVANCE BY THE OWNER.

5. CONTRACTOR SHALL FILE ALL APPLICATIONS, PAY FOR ALL NECESSARY PERMITS AND SECURE CERTIFICATES OF OCCUPANCY FOR THE PROJECT

6. ALL WORK IS TO BE COORDINATED WITH THE OWNER. THE CONTRACTOR IS TO MEET WITH THE OWNER PRIOR TO STARTING CONSTRUCTION. THE CONTRACTOR WILL PRESENT THE BUILDING PERMIT AND INSURANCE CERTIFICATES TO THE OWNER PRIOR TO STARTING CONSTRUCTION

7. CONTRACTOR SHALL PROVIDE ANY NECESSARY MEASURES TO PROTECT THE WORKERS AND OTHER PERSONS DURING CONSTRUCTION.

8. CHECK WITH THE OWNER FOR COORDINATION OF THE WORK UNDER THIS CONTRACT WITH WORK OF OTHER TRADES. OWNER'S REGULATIONS GOVERN ALL ASPECTS OF OUTSIDE CONTRACTORS WORKING ON THE PROPERTY.

9. CONTRACTOR SHALL KEEP THE JOB FREE OF DEBRIS AND MAKE FINAL CLEANUP TO THE SATISFACTION OF THE OWNER. CONTRACTOR SHALL BE RESPONSIBLE FOR REMOVAL OF ALL CONSTRUCTION DEBRIS FROM PROJECT SITE AND SHALL PROVIDE DUMPSTERS ETC. AS REQUIRED, REMOVE ALL DEBRIS ON A DAILY BASIS.

10. CONTRACTOR SHALL BE RESPONSIBLE FOR THE PROTECTION OF ALL EXISTING BUILDINGS AND OTHER INSTALLATIONS THAT ARE TO REMAIN INTACT WHILE PERFORMING THE SPECIFIED WORK, PROVIDE AND MAINTAIN FIRE EXTINGUISHERS ON PROJECT SITE DURING CONSTRUCTION.

11. UNLESS INDICATED OTHERWISE, ALL MATERIAL FURNISHED AND INCORPORATED INTO THE WORK SHALL BE NEW, UNUSED AND OF QUALITY STANDARD TO THE INDUSTRY FOR FIRST CLASS WORK OF SIMILAR NATURE AND CHARACTER. INSTALL ALL MATERIALS TO THE MANUFACTURER'S RECOMMENDATIONS AND BEST STANDARD OF THE TRADES INVOLVED.

12. CONTRACTOR SHALL FIELD VERIFY ALL DIMENSIONS IN FIELD PRIOR CONSTRUCTION. NOTIFY ARCHITECT OF ANY DISCREPANCIES ON DRAWINGS.

13. THE CONTRACTOR AND ALL SUBCONTRACTORS MUST VISIT THE SITE TO VERIFY EXISTING CONDITIONS PRIOR TO ANY WORK. EXISTING CONCEALED CONDITIONS AND CONNECTIONS ARE BASED UPON INFORMATION TAKEN FROM LIMITED FIELD INVESTIGATIONS. CONTRACTOR SHALL MAKE REQUIRED ADJUSTMENTS TO SYSTEM COMPONENTS AS NECESSITATED BY ACTUAL FIELD CONDITIONS AT NO ADDITIONAL COST TO OWNER OR ARCHITECT. REPORT ANY DISCREPANCIES BETWEEN THE DRAWINGS AND ACTUAL FIELD CONDITIONS TO THE ARCHITECT BEFORE CONSTRUCTION BEGINS.

14. UNLESS OTHERWISE INDICATED ALL INTERIOR FINISHES SHALL BE AS DIRECTED BY THE ARCHITECTS FINISH DRAWINGS (900 SERIES)

15. CONTRACTOR TO OBTAIN AND PROVIDE OWNER WITH COLOR SAMPLES FOR PROPER COLOR SELECTION AND FINAL APPROVAL OF ALL FINISHES PRIOR TO INSTALLATION.


16. INTERIOR FINISHES SHALL BE CLASS C (SURFACE FLAME SPREAD RATING OF 76200) MINIMUM IN CONFORMITY WITH GENERALLY ACCEPTED STANDARDS. CARPETING SHALL BE CLASS 2 WITH A MINIMUM CRITICAL RADIANT FLUX OF .22WATTS PER SQUARE CENTIMETER.

17. ALL GYPSUM BOARD WORK SHALL BE DONE IN ACCORDANCE WITH THE DRYWALL CONSTRUCTION HANDBOOK, LATEST EDITION, PREPARED BY UNITED STATES GYPSUM. ALL JOINTS AND SEAMS SHALL BE TAPED AND FINISHED IN ACCORDANCE WITH MANUFACTURER'S INSTALLATION RECOMMENDATIONS

18. PAINTING FOR GYPSUM BOARD AND WOOD CONSTRUCTION PROVIDE TWO (2) FINISH COATS OF PREMIUM GRADE PAINT OVER SINGLE COAT OF COMPATIBLE PRIMER, PROMAR 200 SERIES BY SHERWIN WILLIAMS, CLEVELAND, OHIO OR APPROVED EQUAL. ALL PAINT BY SINGLE

19. GC TO VERIFY ALL WINDOW LOCATIONS AND SIZES FOR REPLACEMENT SCOPE. ANY LOCATIONS/SIZES IN CONFLICT WITH NEW CONSTRUCTION ASSEMBLIES SHALL BE BROUGHT TO THE ARCHITECTS ATTENTION, IN WRITING, IMMEDIATELY.

20. THE OWNER AND CONTRACTOR SHALL INDEMNIFY AND HOLD HARMLESS THEARCHITECT/ DESIGNER FROM AND AGAINST CLAIMS, DAMAGES, LOSSES AND EXPENSES ARISING OUT OF OR RESULTING FROM THE PERFORMANCE OF THE WORK, PROVIDED THAT SUCH CLAIM, DAMAGE, LOSS OR EXPENSE IS ATTRIBUTABLE TO BODILY INJURY. SICKNESS, DISEASE OR DEATH, OR TO INJURY TO OR DESTRUCTION OF TANGIBLE PROPERTY, BUT ONLY TO THE EXTENT CAUSED BY THE NEGLIGENT ACTS OR OMISSIONS OF THE CONTRACTOR, A SUBCONTRACTOR, OR ANYONE DIRECTLY OR INDIRECTLY EMPLOYED BY OR ANYONE FOR WHOSE ACTS THEY MAY BE LIABLE.

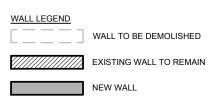

# **ENERGY CODE INFO**


THE FOLLOWING ARE ENERGY CODE REQUIREMENTS BASED ON THE 2015 IECC. REFER DIRECTLY TO THI LOCAL GOVERNING AGENCY TO ENSURE THE R-VALUES BELOW ARE SUFFICIENT PRIOR TO INITIATING AN

<u>U-FACTORS:</u> FENESTRATION: 0.32 R-VALUES: CEILING/ROOF - R49

SKYLIGHTS: 0.32 WALLS - R20 WINDOW GLAZING: 0.27 FLOORS - R30

DOORS: 0.30 BASEMENT WALLS - R15 (CONT.) OR R19 (IN STUD CAVITIES) CRAWLSPACE WALLS - R15 (CONT.) OR R19 (IN STUD CAVITIES)

SLAB: R10 TO 24" DEPTH REFER TO 2015 IECC TABLE R402.1.2 FOR FURTHER INFORMATION IF NECESSARY.

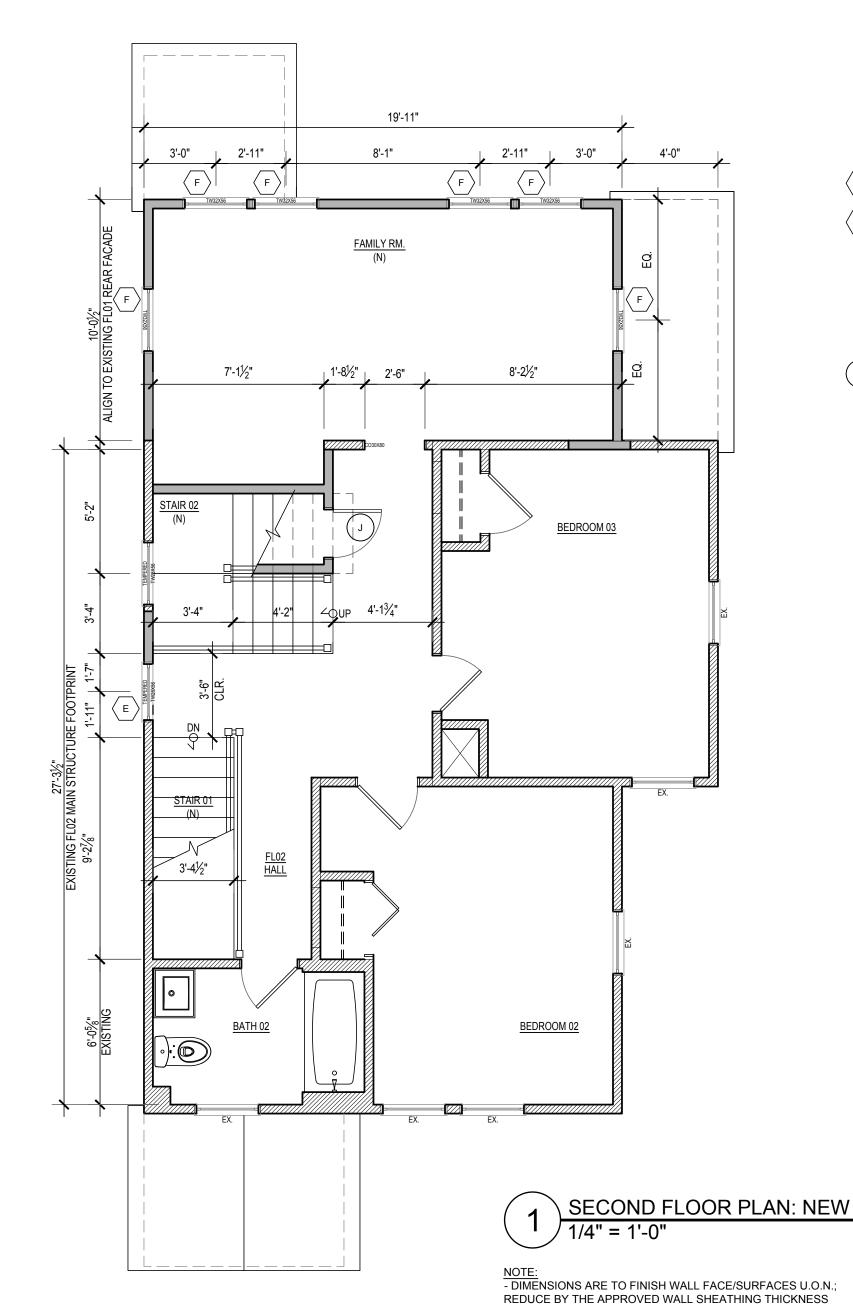

TO ATTAIN ROUGH FRAME DIMENSION/LOCATION.

WINDOW SCHED. (ANDERSEN 400 SERIES OR EQ.)

UNIT: QTY:

TW2442

TW2642

DOOR SCHED. (REFER TO PLAN FOR HANDING) QTY: MANU.: MODEL:

LH24X80 BROSCO PR44 OVOLO PASSAGE

GFA AREA BREAKDOWN

FLOOR: **EXISTING** PROPOSED ADD TOTAL BY FLOOR **EXCLUDED** FL00 EXCLUDED 0 SF FL01 945 SF 0 SF 945 SF FL02 616 SF 200 SF 816 SF FL03 TOTALS 1757 SF 2302 SF

Z Ш 7 0 ഗ ≥ S Ш ВE  $\circ$ 0 RD 5  $\mathbf{\Omega}$  $\triangleleft$ <u>N</u> Д

0 N

Drawing Information: PROJECT NUMBER: 2 0 2 0 - 0 1 JRK JRK 02/15/2023 SCALE: SHEET REFERENCE:

> SECOND FLOOR: NEW

3. ALL WORK SHALL COMPLY WITH THE STANDARDS OF THE NATIONAL BOARD OF FIRE UNDERWRITERS (NBFU), INDUSTRIAL RISK INSURANCE UNDERWRITERS (IRI), FACTORY MUTUAL (FW), OR THE APPLICABLE RATING BUREAU. THE NATIONAL ELECTRIC CODE (NEC), THE AMERICAN GAS ASSOCIATION (AGA), AND THE AMERICAN SOCIETY OF HEATING AND AIR CONDITIONING ENGINEERS (ASHAE), OCCUPATIONAL SAFETY AND HEALTH ADMINISTRATION (OSHA), APPLICABLE STATE AND CITY BUILDING CODES AND THE REQUIREMENTS OF ALL PUBLIC UTILITY COMPANIES

4. CONTRACTOR (AND HIS SUBCONTRACTORS) SHALL BE LICENSED BY THE STATE IN WHICH THE PROJECT IS LOCATED AND APPROVED IN ADVANCE BY THE OWNER.

5. CONTRACTOR SHALL FILE ALL APPLICATIONS, PAY FOR ALL NECESSARY PERMITS AND SECURE

6. ALL WORK IS TO BE COORDINATED WITH THE OWNER. THE CONTRACTOR IS TO MEET WITH THE OWNER PRIOR TO STARTING CONSTRUCTION. THE CONTRACTOR WILL PRESENT THE BUILDING PERMIT AND INSURANCE CERTIFICATES TO THE OWNER PRIOR TO STARTING CONSTRUCTION

7. CONTRACTOR SHALL PROVIDE ANY NECESSARY MEASURES TO PROTECT THE WORKERS AND OTHER PERSONS DURING CONSTRUCTION.

8. CHECK WITH THE OWNER FOR COORDINATION OF THE WORK UNDER THIS CONTRACT WITH WORK OF OTHER TRADES. OWNER'S REGULATIONS GOVERN ALL ASPECTS OF OUTSIDE CONTRACTORS WORKING ON THE PROPERTY.

9. CONTRACTOR SHALL KEEP THE JOB FREE OF DEBRIS AND MAKE FINAL CLEANUP TO THE SATISFACTION OF THE OWNER. CONTRACTOR SHALL BE RESPONSIBLE FOR REMOVAL OF ALL CONSTRUCTION DEBRIS FROM PROJECT SITE AND SHALL PROVIDE DUMPSTERS ETC. AS REQUIRED, REMOVE ALL DEBRIS ON A DAILY BASIS.

10. CONTRACTOR SHALL BE RESPONSIBLE FOR THE PROTECTION OF ALL EXISTING BUILDINGS AND OTHER INSTALLATIONS THAT ARE TO REMAIN INTACT WHILE PERFORMING THE SPECIFIED  $\,$ WORK. PROVIDE AND MAINTAIN FIRE EXTINGUISHERS ON PROJECT SITE DURING CONSTRUCTION.

11. UNLESS INDICATED OTHERWISE, ALL MATERIAL FURNISHED AND INCORPORATED INTO THE WORK SHALL BE NEW, UNUSED AND OF QUALITY STANDARD TO THE INDUSTRY FOR FIRST CLASS WORK OF SIMILAR NATURE AND CHARACTER. INSTALL ALL MATERIALS TO THE MANUFACTURER'S RECOMMENDATIONS AND BEST STANDARD OF THE TRADES INVOLVED.

12. CONTRACTOR SHALL FIELD VERIFY ALL DIMENSIONS IN FIELD PRIOR CONSTRUCTION. NOTIFY ARCHITECT OF ANY DISCREPANCIES ON DRAWINGS.

13. THE CONTRACTOR AND ALL SUBCONTRACTORS MUST VISIT THE SITE TO VERIFY EXISTING CONDITIONS PRIOR TO ANY WORK. EXISTING CONCEALED CONDITIONS AND CONNECTIONS ARE BASED UPON INFORMATION TAKEN FROM LIMITED FIELD INVESTIGATIONS. CONTRACTOR SHALL MAKE REQUIRED ADJUSTMENTS TO SYSTEM COMPONENTS AS NECESSITATED BY ACTUAL FIELD CONDITIONS AT NO ADDITIONAL COST TO OWNER OR ARCHITECT REPORT ANY DISCREPANCIES BETWEEN THE DRAWINGS AND ACTUAL FIELD CONDITIONS TO THE ARCHITECT BEFORE CONSTRUCTION BEGINS.

14. UNLESS OTHERWISE INDICATED ALL INTERIOR FINISHES SHALL BE AS DIRECTED BY THE

15. CONTRACTOR TO OBTAIN AND PROVIDE OWNER WITH COLOR SAMPLES FOR PROPER COLOR SELECTION AND FINAL APPROVAL OF ALL FINISHES PRIOR TO INSTALLATION.

16. INTERIOR FINISHES SHALL BE CLASS C (SURFACE FLAME SPREAD RATING OF 76200) MINIMUM IN CONFORMITY WITH GENERALLY ACCEPTED STANDARDS. CARPETING SHALL BE CLASS 2 WITH A MINIMUM CRITICAL RADIANT FLUX OF .22WATTS PER SQUARE CENTIMETER.

17. ALL GYPSUM BOARD WORK SHALL BE DONE IN ACCORDANCE WITH THE DRYWALL CONSTRUCTION HANDBOOK, LATEST EDITION, PREPARED BY UNITED STATES GYPSUM. ALL JOINTS AND SEAMS SHALL BE TAPED AND FINISHED IN ACCORDANCE WITH MANUFACTURER'S INSTALLATION RECOMMENDATIONS

18. PAINTING FOR GYPSUM BOARD AND WOOD CONSTRUCTION PROVIDE TWO (2) FINISH COATS OF PREMIUM GRADE PAINT OVER SINGLE COAT OF COMPATIBLE PRIMER, PROMAR 200 SERIES BY SHERWIN WILLIAMS, CLEVELAND, OHIO OR APPROVED EQUAL. ALL PAINT BY SINGLE

19. GC TO VERIFY ALL WINDOW LOCATIONS AND SIZES FOR REPLACEMENT SCOPE. ANY LOCATIONS/SIZES IN CONFLICT WITH NEW CONSTRUCTION ASSEMBLIES SHALL BE BROUGHT TO THE ARCHITECTS ATTENTION, IN WRITING, IMMEDIATELY.

20. THE OWNER AND CONTRACTOR SHALL INDEMNIFY AND HOLD HARMLESS THEARCHITECT/DESIGNER FROM AND AGAINST CLAIMS, DAMAGES, LOSSES AND EXPENSES ARISING OUT OF OR RESULTING FROM THE PERFORMANCE OF THE WORK, PROVIDED THAT SUCH CLAIM, DAMAGE, LOSS OR EXPENSE IS ATTRIBUTABLE TO BODILY INJURY. SICKNESS, DISEASE OR DEATH, OR TO INJURY TO OR DESTRUCTION OF TANGIBLE PROPERTY, BUT ONLY TO THE EXTENT CAUSED BY THE NEGLIGENT ACTS OR OMISSIONS OF THE CONTRACTOR, A SUBCONTRACTOR, OR ANYONE DIRECTLY OR INDIRECTLY EMPLOYED BY OR ANYONE FOR WHOSE ACTS THEY MAY BE LIABLE.

WALL TO BE DEMOLISHED EXISTING WALL TO REMAIN

# **ENERGY CODE INFO.**


THE FOLLOWING ARE ENERGY CODE REQUIREMENTS BASED ON THE 2015 IECC. REFER DIRECTLY TO THI LOCAL GOVERNING AGENCY TO ENSURE THE R-VALUES BELOW ARE SUFFICIENT PRIOR TO INITIATING AN

U-FACTORS: FENESTRATION: 0.32 R-VALUES: CEILING/ROOF - R49

SKYLIGHTS: 0.32 WALLS - R20 WINDOW GLAZING: 0.27 FLOORS - R30 DOORS: 0.30

BASEMENT WALLS - R15 (CONT.) OR R19 (IN STUD CAVITIES) CRAWLSPACE WALLS - R15 (CONT.) OR R19 (IN STUD CAVITIES)

SLAB: R10 TO 24" DEPTH REFER TO 2015 IECC TABLE R402.1.2 FOR FURTHER INFORMATION IF NECESSARY.

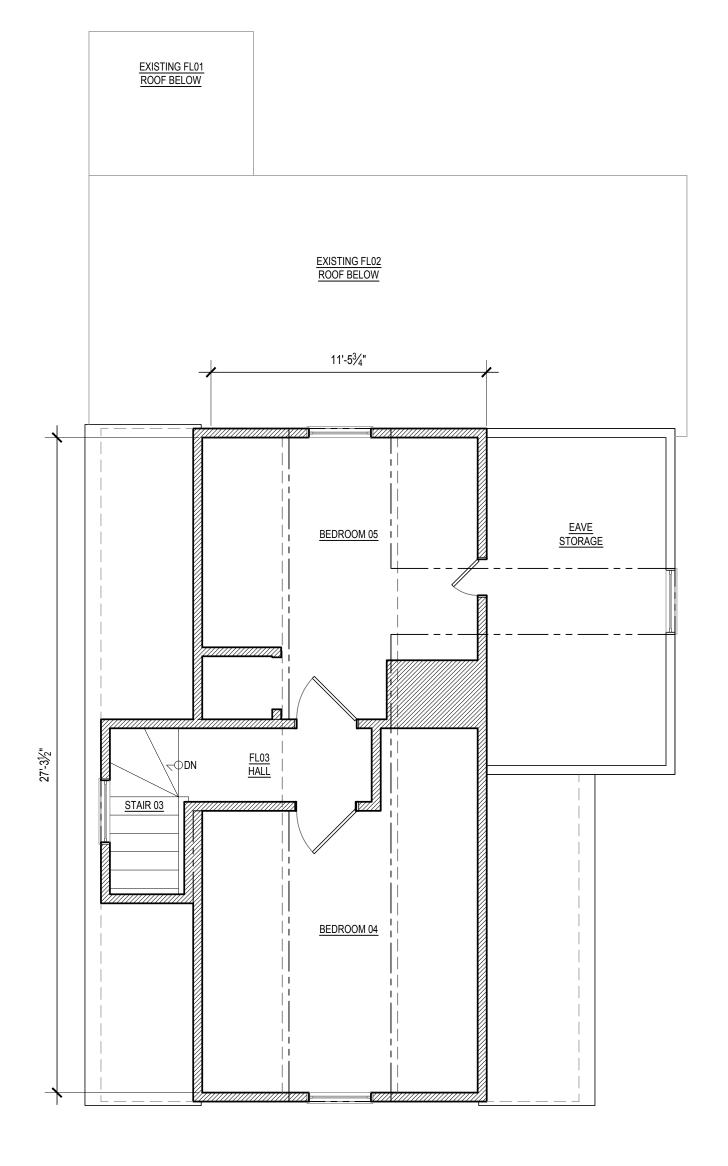

7

0

MBRIDGE,

N

Drawing Information: PROJECT NUMBER: 2 0 2 0 - 0 1 JRK CHECKED BY: JRK 02/15/2023 SCALE:

> THIRD FLOOR: **EXISTING**

SHEET REFERENCE:

3. ALL WORK SHALL COMPLY WITH THE STANDARDS OF THE NATIONAL BOARD OF FIRE UNDERWRITERS (NBFU), INDUSTRIAL RISK INSURANCE UNDERWRITERS (IRI), FACTORY MUTUAL (FW), OR THE APPLICABLE RATING BUREAU. THE NATIONAL ELECTRIC CODE (NEC),THE AMERICAN GAS ASSOCIATION (AGA), AND THE AMERICAN SOCIETY OF HEATING AND AIR CONDITIONING ENGINEERS (ASHAE), OCCUPATIONAL SAFETY AND HEALTH ADMINISTRATION (OSHA), APPLICABLE STATE AND CITY BUILDING CODES AND THE REQUIREMENTS OF ALL PUBLIC UTILITY COMPANIES

4. CONTRACTOR (AND HIS SUBCONTRACTORS) SHALL BE LICENSED BY THE STATE IN WHICH THE PROJECT IS LOCATED AND APPROVED IN ADVANCE BY THE OWNER.

5. CONTRACTOR SHALL FILE ALL APPLICATIONS, PAY FOR ALL NECESSARY PERMITS AND SECURE

6. ALL WORK IS TO BE COORDINATED WITH THE OWNER. THE CONTRACTOR IS TO MEET WITH THE OWNER PRIOR TO STARTING CONSTRUCTION. THE CONTRACTOR WILL PRESENT THE BUILDING PERMIT AND INSURANCE CERTIFICATES TO THE OWNER PRIOR TO STARTING CONSTRUCTION

7. CONTRACTOR SHALL PROVIDE ANY NECESSARY MEASURES TO PROTECT THE WORKERS AND OTHER PERSONS DURING CONSTRUCTION.

8. CHECK WITH THE OWNER FOR COORDINATION OF THE WORK UNDER THIS CONTRACT WITH WORK OF OTHER TRADES. OWNER'S REGULATIONS GOVERN ALL ASPECTS OF OUTSIDE CONTRACTORS WORKING ON THE PROPERTY

9. CONTRACTOR SHALL KEEP THE JOB FREE OF DEBRIS AND MAKE FINAL CLEANUP TO THE SATISFACTION OF THE OWNER. CONTRACTOR SHALL BE RESPONSIBLE FOR REMOVAL OF ALL CONSTRUCTION DEBRIS FROM PROJECT SITE AND SHALL PROVIDE DUMPSTERS ETC. AS  $\,$ REQUIRED, REMOVE ALL DEBRIS ON A DAILY BASIS.

10. CONTRACTOR SHALL BE RESPONSIBLE FOR THE PROTECTION OF ALL EXISTING BUILDINGS AND OTHER INSTALLATIONS THAT ARE TO REMAIN INTACT WHILE PERFORMING THE SPECIFIED WORK, PROVIDE AND MAINTAIN FIRE EXTINGUISHERS ON PROJECT SITE DURING CONSTRUCTION.

11. UNLESS INDICATED OTHERWISE, ALL MATERIAL FURNISHED AND INCORPORATED INTO THE WORK SHALL BE NEW, UNUSED AND OF QUALITY STANDARD TO THE INDUSTRY FOR FIRST CLASS WORK OF SIMILAR NATURE AND CHARACTER. INSTALL ALL MATERIALS TO THE MANUFACTURER'S RECOMMENDATIONS AND BEST STANDARD OF THE TRADES INVOLVED.

12. CONTRACTOR SHALL FIELD VERIFY ALL DIMENSIONS IN FIELD PRIOR CONSTRUCTION. NOTIFY ARCHITECT OF ANY DISCREPANCIES ON DRAWINGS.

13. THE CONTRACTOR AND ALL SUBCONTRACTORS MUST VISIT THE SITE TO VERIFY EXISTING CONDITIONS PRIOR TO ANY WORK. EXISTING CONCEALED CONDITIONS AND CONNECTIONS ARE BASED UPON INFORMATION TAKEN FROM LIMITED FIELD INVESTIGATIONS. CONTRACTOR SHALL MAKE REQUIRED ADJUSTMENTS TO SYSTEM COMPONENTS AS NECESSITATED BY ACTUAL FIELD CONDITIONS AT NO ADDITIONAL COST TO OWNER OR ARCHITECT. REPORT ANY DISCREPANCIES BETWEEN THE DRAWINGS AND ACTUAL FIELD CONDITIONS TO THE ARCHITECT BEFORE CONSTRUCTION BEGINS.

14. UNLESS OTHERWISE INDICATED ALL INTERIOR FINISHES SHALL BE AS DIRECTED BY THE ARCHITECTS FINISH DRAWINGS (900 SERIES)

15. CONTRACTOR TO OBTAIN AND PROVIDE OWNER WITH COLOR SAMPLES FOR PROPER COLOR SELECTION AND FINAL APPROVAL OF ALL FINISHES PRIOR TO INSTALLATION

16. INTERIOR FINISHES SHALL BE CLASS C (SURFACE FLAME SPREAD RATING OF 76200) MINIMUM IN CONFORMITY WITH GENERALLY ACCEPTED STANDARDS. CARPETING SHALL BE CLASS 2 WITH A MINIMUM CRITICAL RADIANT FLUX OF .22WATTS PER SQUARE CENTIMETER.

17. ALL GYPSUM BOARD WORK SHALL BE DONE IN ACCORDANCE WITH THE DRYWALL CONSTRUCTION HANDBOOK, LATEST EDITION, PREPARED BY UNITED STATES GYPSUM. ALL JOINTS AND SEAMS SHALL BE TAPED AND FINISHED IN ACCORDANCE WITH MANUFACTURER'S INSTALLATION RECOMMENDATIONS

18. PAINTING FOR GYPSUM BOARD AND WOOD CONSTRUCTION PROVIDE TWO (2) FINISH COATS OF PREMIUM GRADE PAINT OVER SINGLE COAT OF COMPATIBLE PRIMER, PROMAR 200 SERIES BY SHERWIN WILLIAMS, CLEVELAND, OHIO OR APPROVED EQUAL. ALL PAINT BY SINGLE

19. GC TO VERIFY ALL WINDOW LOCATIONS AND SIZES FOR REPLACEMENT SCOPE. ANY LOCATIONS/SIZES IN CONFLICT WITH NEW CONSTRUCTION ASSEMBLIES SHALL BE BROUGHT TO THE ARCHITECTS ATTENTION, IN WRITING, IMMEDIATELY.

20. THE OWNER AND CONTRACTOR SHALL INDEMNIFY AND HOLD HARMLESS THEARCHITECT/ DESIGNER FROM AND AGAINST CLAIMS, DAMAGES, LOSSES AND EXPENSES ARISING OUT OF OR RESULTING FROM THE PERFORMANCE OF THE WORK, PROVIDED THAT SUCH CLAIM, DAMAGE, LOSS OR EXPENSE IS ATTRIBUTABLE TO BODILY INJURY. SICKNESS, DISEASE OR DEATH, OR TO INJURY TO OR DESTRUCTION OF TANGIBLE PROPERTY, BUT ONLY TO THE EXTENT CAUSED BY THE NEGLIGENT ACTS OR OMISSIONS OF THE CONTRACTOR, A SUBCONTRACTOR, OR ANYONE DIRECTLY OR INDIRECTLY EMPLOYED BY OR ANYONE FOR WHOSE ACTS THEY MAY BE LIABLE.

WALL LEGEND

WALL TO BE DEMOLISHED

EXISTING WALL TO REMAIN

# **ENERGY CODE INFO.**


THE FOLLOWING ARE ENERGY CODE REQUIREMENTS BASED ON THE 2015 IECC. REFER DIRECTLY TO TH LOCAL GOVERNING AGENCY TO ENSURE THE R-VALUES BELOW ARE SUFFICIENT PRIOR TO INITIATING AN

<u>U-FACTORS:</u> FENESTRATION: 0.32 R-VALUES: CEILING/ROOF - R49

SKYLIGHTS: 0.32 WALLS - R20 WINDOW GLAZING: 0.27 FLOORS - R30

DOORS: 0.30 BASEMENT WALLS - R15 (CONT.) OR R19 (IN STUD CAVITIES) CRAWLSPACE WALLS - R15 (CONT.) OR R19 (IN STUD CAVITIES)

SLAB: R10 TO 24" DEPTH REFER TO 2015 IECC TABLE R402.1.2 FOR FURTHER INFORMATION IF NECESSARY.

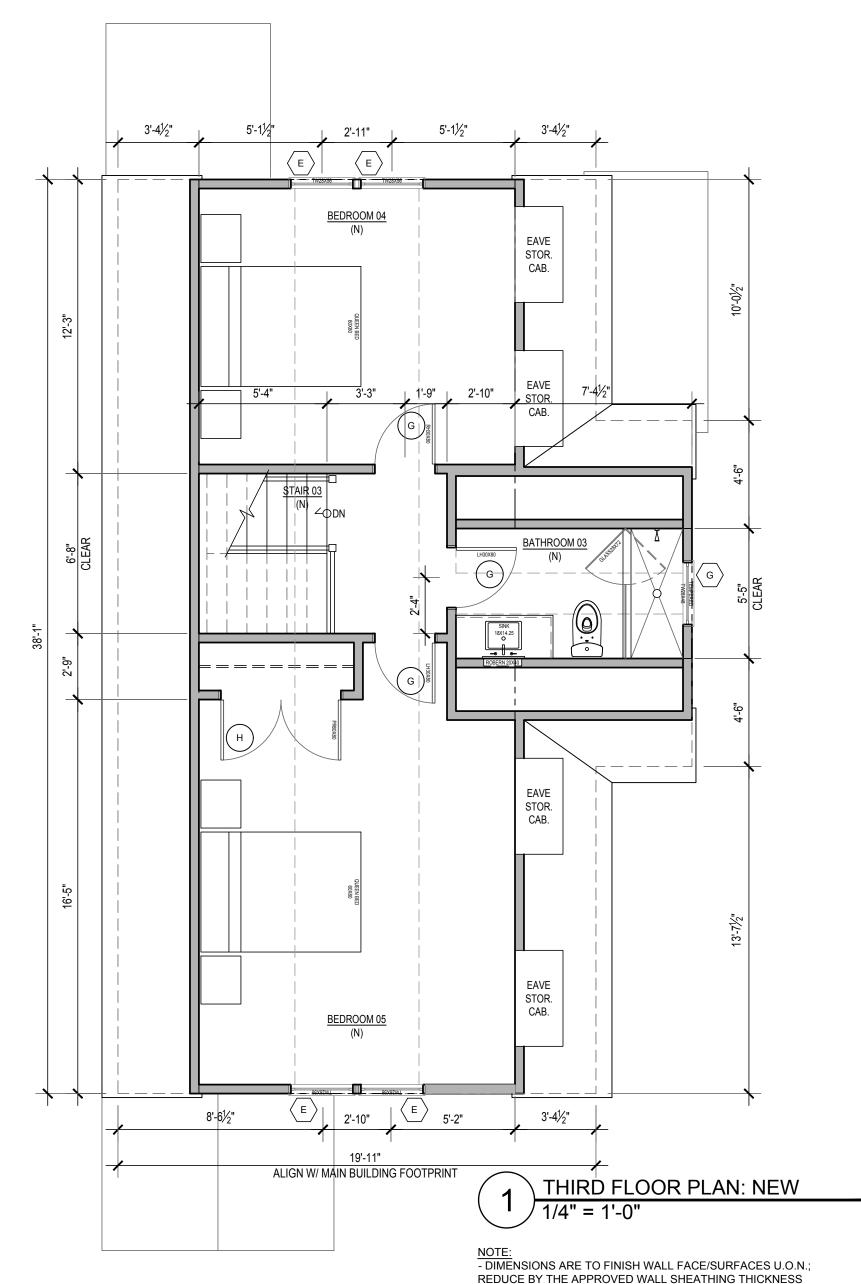

TO ATTAIN ROUGH FRAME DIMENSION/LOCATION.

WINDOW SCHED. (ANDERSEN 400 SERIES OR EQ.) QTY:

UNIT:

TW2442

TW24310

DOOR SCHED. (REFER TO PLAN FOR HANDING)

QTY: MANU.: MODEL: HW TYPE: 30X80 3 BROSCO PR44 OVOLO PRIVACY

PR48X80 BROSCO PR44 OVOLO PASSAGE/DUMMY

GFA AREA BREAKDOWN

FLOOR: **EXISTING** PROPOSED ADD TOTAL BY FLOOR FL00 **EXCLUDED** EXCLUDED 0 SF FL01 945 SF 0 SF 945 SF FL02 616 SF 200 SF 816 SF FL03 TOTALS 1757 SF 2302 SF

0 Z Ш ഗ S Ш  $\circ$ 0 Ш 5  $\triangleleft$ 

4

7

0

≥ ВE RD  $\mathbf{\Omega}$ 

Д

0 N

Drawing Information: PROJECT NUMBER: 2 0 2 0 - 0 1 JRK JRK 02/15/2023 SCALE:

> THIRD FLOOR: NEW

A132

SHEET REFERENCE:

1 EXISTING EXTERIOR ELEVATION: FRONT
1/4" = 1'-0" SOUTH FACING

PRIVATE RESIDENCE 5 FOCH ST., CAMBRIDGE, MA 02140

ZONING REVIEW SET

Drawing Information:

PROJECT NUMBER: 2 0 2 0 - 0 1

DRAWN BY: J R K

CHECKED BY: J R K

DATE: 0 2 / 1 5 / 2 0 2 3

SCALE:

SHEET REFERENCE:

EXTERIOR ELEVATIONS

SHEET NUMBI

ENSURE MIN. HEADLAP PER MANU. REQ. COLOR: TBD PER CLIENT SELECTION

GRACE ICE & WATERSHIELD : FULL ROOF AREA

AND OTHER NECESSARY CONNECTION DETAILS

PTD. FIN. COLOR: TBD PER CLIENT SELECTION

FIN. COLOR: REFER TO FINISH SCHEDULE

TIE DOWNS AND OTHER NECESSARY CONNECTION

MATCH EXISTING EXPOSURE

INSULATION TO R-21 MIN.

**DETAILS** 

W/ 1/8" PLASTER COAT PTD.,

CLAD FULL CHEEK WALL AREAS IN ICE & WATERSHIELD

APPLY INTUMESCENT COATING TO EXPOSED FOAM FACES

Drawing Information: PROJECT NUMBER: 2 0 2 0 - 0 1

DRAWN BY: JRK CHECKED BY: JRK


02/15/2023

SCALE:

SHEET REFERENCE:

EXTERIOR ELEVATIONS

A202

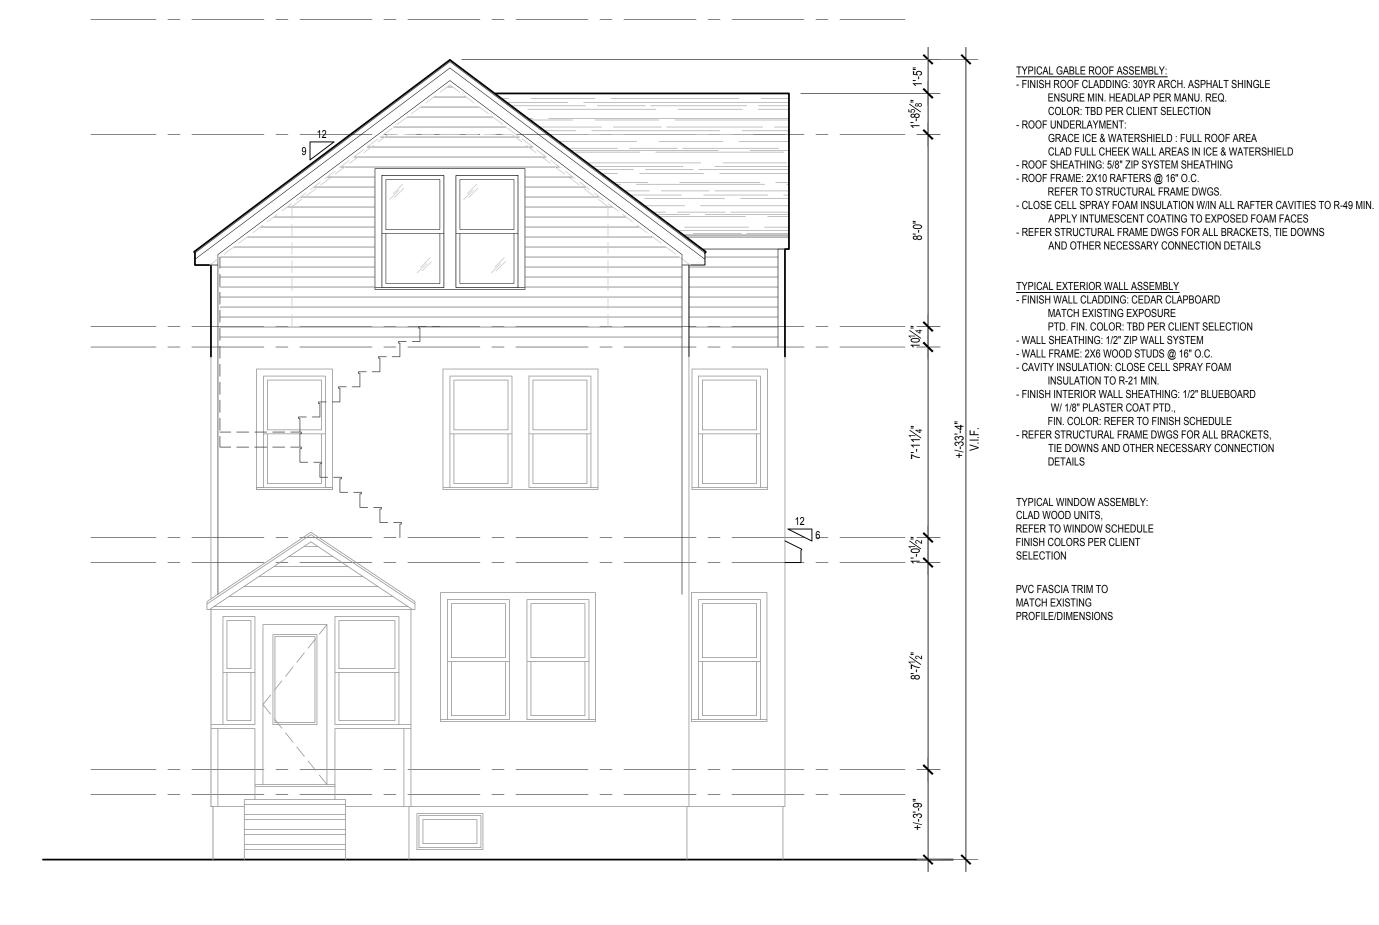

NEW EXTERIOR ELEVATION: FRONT SOUTH FACING

- ALL FRAMING MEMBER SIZING PROVIDED HEREIN IS FOR DESIGN INTENT PURPOSES ONLY. SIZE SHALL NOT BE ASSUMED SUFFICIENT FOR CONSTRUCTION. ALL FRAMING AND ASSOCIATED CONNECTIONS AND/OR DETAILS ARE TO BE PROVIDED SEPARATELY BY A LICENSED PROFESSIONAL STRUCTURAL ENGINEER VIA A STAMPED DRAWING SET ISSUED BY SAID ENGINEER

- DUE TO INTRICACIES OF CONSTRUCTION DETAILS, FIELD REQUIRED MODIFICATIONS AND COMPATIBILITY OF BUILDING COMPONENTRY; IT IS THE GC'S SOLE RESPONSIBILITY TO CONSTRUCT AND MAINTAIN A WATER-TIGHT BUILDING ENVELOP UTILIZING INDUSTRY APPROVED MATERIALS, MEANS AND METHODS. - CURRENT IECC PRESCRIBED INSULATION LEVELS MAY BE ATTAINED UTILIZING VARIED MATERIALS AND METHODS. CLOSED CELL SPRAY FOAM INSULATION HAS BEEN SPECIFIED W/IN FOR THE SAKE OF SIMPLICITY. IN THE EVENT THAT ALTERNATE METHODS ARE ENACTED FOR ANY REASON IT IS THE GC'S RESPONSIBILITY TO MODIFY ASSEMBLIES ACCORDINGLY (I.E. INSTALLING VAPOR BARRIERS/RETARDERS IN APPROPRIATE WALL ASSEMBLY PLANES) FAILURE TO DO SO MAY CAUSE MOISTURE INDUCED DAMAGES TO BUILDING COMPONENTS AND/OR OCCUPANT RELATED HEALTH ISSUES (I.E. ALLERGEN PROPAGATING CONDITIONS)

EXISTING EXTERIOR ELEVATION: RIGHT 1/4" = 1'-0" EAST FACING

N

Drawing Information: PROJECT NUMBER: 2 0 2 0 - 0 1 DRAWN BY: JRK CHECKED BY: JRK 02/15/2023 SHEET REFERENCE:

EXTERIOR ELEVATIONS

NEW EXTERIOR ELEVATION: RIGHT

1/4" = 1'-0"

EAST FACING

OTE:

NOTE:
- ALL FRAMING MEMBER SIZING PROVIDED HEREIN IS FOR DESIGN INTENT PURPOSES ONLY. SIZE SHALL NOT BE ASSUMED SUFFICIENT FOR CONSTRUCTION. ALL FRAMING AND ASSOCIATED CONNECTIONS AND/OR DETAILS ARE TO BE PROVIDED SEPARATELY BY A LICENSED PROFESSIONAL STRUCTURAL ENGINEER VIA A STAMPED DRAWING SET ISSUED BY SAID ENGINEER

- DUE TO INTRICACIES OF CONSTRUCTION DETAILS, FIELD REQUIRED MODIFICATIONS AND COMPATIBILITY OF BUILDING COMPONENTRY; IT IS THE GC'S SOLE RESPONSIBILITY TO CONSTRUCT AND MAINTAIN A WATER-TIGHT BUILDING ENVELOP UTILIZING INDUSTRY APPROVED MATERIALS, MEANS AND METHODS.
- CURRENT IECC PRESCRIBED INSULATION LEVELS MAY BE ATTAINED UTILIZING VARIED MATERIALS AND METHODS. CLOSED CELL SPRAY FOAM INSULATION HAS BEEN SPECIFIED W/IN FOR THE SAKE OF SIMPLICITY. IN THE EVENT THAT ALTERNATE METHODS ARE ENACTED FOR ANY REASON IT IS THE GC'S RESPONSIBILITY TO MODIFY ASSEMBLIES ACCORDINGLY (I.E. INSTALLING VAPOR BARRIERS/RETARDERS IN APPROPRIATE WALL ASSEMBLY PLANES) FAILURE TO DO SO MAY CAUSE MOISTURE INDUCED DAMAGES TO BUILDING COMPONENTS AND/OR OCCUPANT RELATED HEALTH ISSUES (I.E. ALLERGEN PROPAGATING CONDITIONS)

Drawing Information:

PROJECT NUMBER: 2 0 2 0 - 0 1

DRAWN BY: J R K

CHECKED BY: J R K

DATE: 0 2 / 1 5 / 2 0 2 3

SCALE:

SHEET REFERENCE:

EXTERIOR ELEVATIONS

CHEET MINNER.

1 EXISTING EXTERIOR ELEVATION: REAR

1/4" = 1'-0"

NORTH FACING

PRIVATE RESIDENCE 5 FOCH ST., CAMBRIDGE, MA 02140

ZONING REVIEW SET

Drawing Information:

PROJECT NUMBER: 2 0 2 0 - 0 1

DRAWN BY: J R K

CHECKED BY: J R K

DATE: 0 2 / 1 5 / 2 0 2 3

SCALE:

SHEET REFERENCE:

EXTERIOR ELEVATIONS

SHEET NUMBI

Drawing Information:

PROJECT NUMBER: 2 0 2 0 - 0 1 DRAWN BY: JRK CHECKED BY: JRK

02/15/2023

SCALE: SHEET REFERENCE:

EXTERIOR

ELEVATIONS

A206



NORTH FACING

NOTE:
- ALL FRAMING MEMBER SIZING PROVIDED HEREIN IS FOR DESIGN INTENT PURPOSES ONLY. SIZE SHALL NOT BE ASSUMED SUFFICIENT FOR CONSTRUCTION. ALL FRAMING AND ASSOCIATED CONNECTIONS AND/OR DETAILS ARE TO BE PROVIDED SEPARATELY BY A LICENSED PROFESSIONAL STRUCTURAL ENGINEER VIA A STAMPED DRAWING SET ISSUED BY SAID ENGINEER

- DUE TO INTRICACIES OF CONSTRUCTION DETAILS, FIELD REQUIRED MODIFICATIONS AND COMPATIBILITY OF BUILDING COMPONENTRY; IT IS THE GC'S SOLE RESPONSIBILITY TO CONSTRUCT AND MAINTAIN A WATER-TIGHT BUILDING ENVELOP UTILIZING INDUSTRY APPROVED MATERIALS, MEANS AND METHODS.
- CURRENT IECC PRESCRIBED INSULATION LEVELS MAY BE ATTAINED UTILIZING VARIED MATERIALS AND METHODS. CLOSED CELL SPRAY FOAM INSULATION HAS BEEN SPECIFIED W/IN FOR THE SAKE OF SIMPLICITY. IN THE EVENT THAT ALTERNATE METHODS ARE ENACTED FOR ANY REASON IT IS THE GC'S RESPONSIBILITY TO MODIFY ASSEMBLIES ACCORDINGLY (I.E. INSTALLING VAPOR BARRIERS/RETARDERS IN APPROPRIATE WALL ASSEMBLY PLANES) FAILURE TO DO SO MAY CAUSE MOISTURE INDUCED DAMAGES TO BUILDING COMPONENTS AND/OR OCCUPANT RELATED HEALTH ISSUES (I.E. ALLERGEN PROPAGATING CONDITIONS)

PRIVATE RESIDENCE

ZONING REVIEW SET

Drawing Information:

PROJECT NUMBER: 2 0 2 0 - 0 1

DRAWN BY: J R K

CHECKED BY: J R K

DATE: 0 2 / 1 5 / 2 0 2 3

SCALE:

SHEET REFERENCE:

EXTERIOR ELEVATIONS

SHEET NUMBE


NOTE:
- ALL FRAMING MEMBER SIZING PROVIDED HEREIN IS FOR DESIGN INTENT PURPOSES ONLY. SIZE SHALL NOT BE ASSUMED SUFFICIENT FOR CONSTRUCTION. ALL FRAMING AND ASSOCIATED CONNECTIONS AND/OR DETAILS ARE TO BE PROVIDED SEPARATELY BY A LICENSED PROFESSIONAL STRUCTURAL ENGINEER VIA A STAMPED DRAWING SET ISSUED BY SAID ENGINEER

- DUE TO INTRICACIES OF CONSTRUCTION DETAILS, FIELD REQUIRED MODIFICATIONS AND COMPATIBILITY OF BUILDING COMPONENTRY; IT IS THE GC'S SOLE RESPONSIBILITY TO CONSTRUCT AND MAINTAIN A WATER-TIGHT BUILDING ENVELOP UTILIZING INDUSTRY APPROVED MATERIALS, MEANS AND METHODS.
- CURRENT IECC PRESCRIBED INSULATION LEVELS MAY BE ATTAINED UTILIZING VARIED MATERIALS AND METHODS. CLOSED CELL SPRAY FOAM INSULATION HAS BEEN SPECIFIED W/IN FOR THE SAKE OF SIMPLICITY. IN THE EVENT THAT ALTERNATE METHODS ARE ENACTED FOR ANY REASON IT IS THE GC'S RESPONSIBILITY TO MODIFY ASSEMBLIES ACCORDINGLY (I.E. INSTALLING VAPOR BARRIERS/RETARDERS IN APPROPRIATE WALL ASSEMBLY PLANES) FAILURE TO DO SO MAY CAUSE MOISTURE INDUCED DAMAGES TO BUILDING COMPONENTS AND/OR OCCUPANT RELATED HEALTH ISSUES (I.E. ALLERGEN PROPAGATING CONDITIONS)

SEVIEW SET N

Drawing Information: PROJECT NUMBER: 2 0 2 0 - 0 1 DRAWN BY: JRK CHECKED BY: JRK 02/15/2023 SCALE: SHEET REFERENCE:

EXTERIOR ELEVATIONS

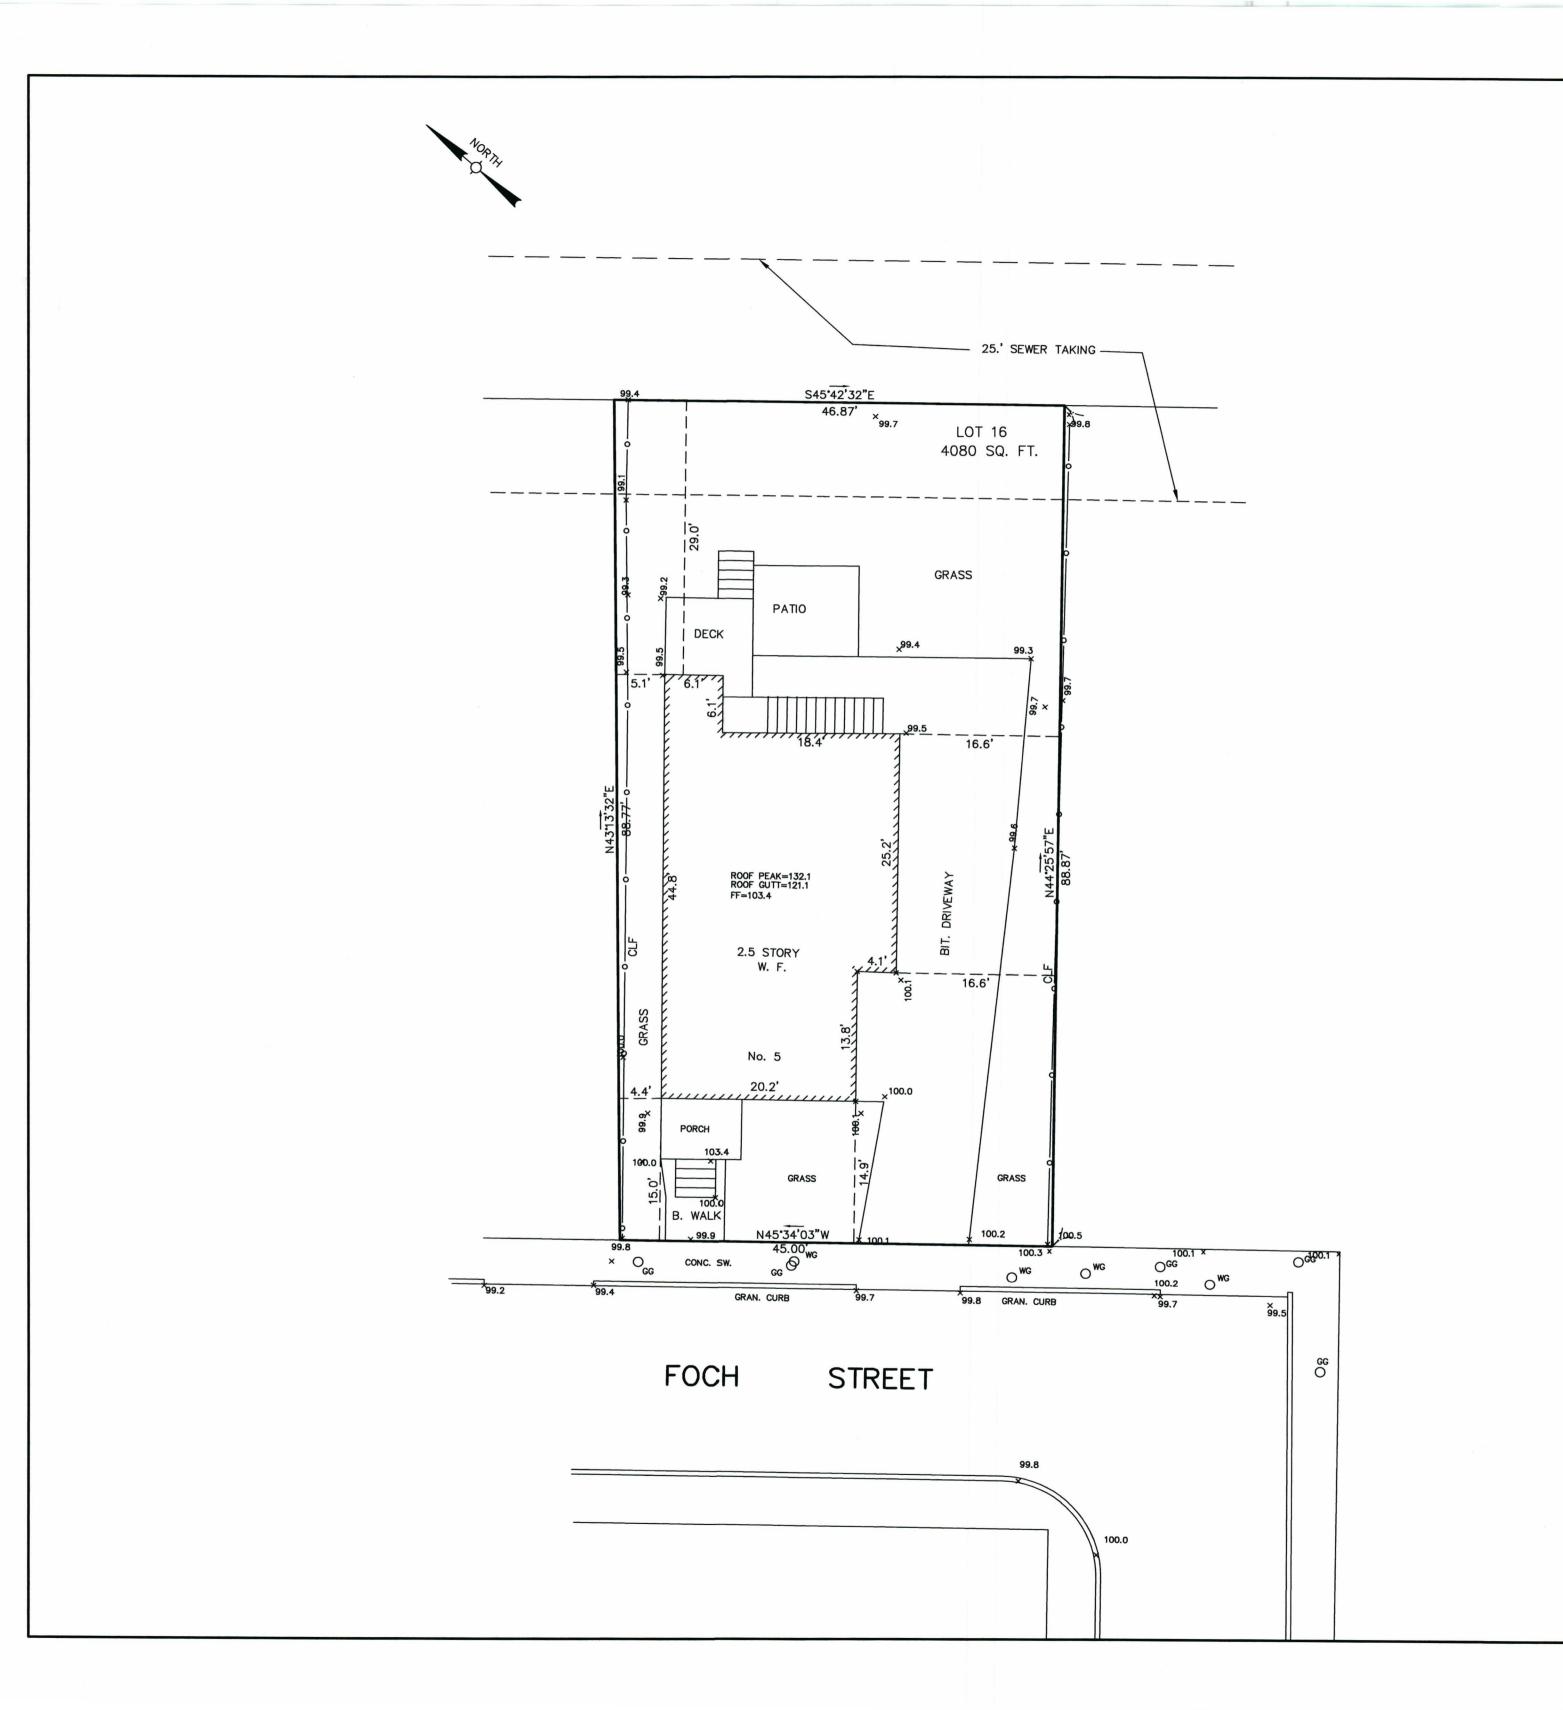

Jahon; Granusur



# PLOT PLAN

5 FOCH STREET

# CAMBRIDGE, MASS.

SCALE : 1"= 10'

JANUARY 4, 2023

AGH ENGINEERING

166 WATER STREET STOUGHTON, MA 02072

PHONE: (781)344-2386

GRAPHIC SCALE

0 0 5 10 20 40









52 Murray Hill Rd 185-51 185-15 185-23 54 Murray Hill Rd 48 Murray Hill Rd Murray Hill Rd Murray Hill Rd Rd Rd 43 Murray Hill Rd185-16 185-10 185-17 185-24 37 Murray Hill/Rd 39 Murray Hill Rd 185-18 185-1 185-26 185-25 46 Murray Hill Rd 35 Murray Hill Rd33 Murray Hill Rd 185-19 185-27 40 Murray Hill Rd38 Murray Hill Rd 29 Murray Hill Rd ROAD 185-20 31 Murray Hill Rd 185-28 27 Murray Hill Rd25 Murray Hill Rd 186-4 36 Murray Hill Rd34 Murray Hill Rd 185-21 185-29 32 Murray Hill Rd30 Murray Hill Rd 19 Murray Hill Rd 186-5 185-30 26 Murray Hill Rd28 Murray Hill Rd 186-6 185-31 20 Murray Hill Rd 22 Murray Hill Ro 185-32 186-7 17 Foch St 15 Foch St 186-8 186-75 B 11 Foch St 186-9 186-76 7 Gladstone St och St<sub>7</sub> Foch St 186-10 5 Foch St ROAD 186-101 5 Gladstone St 186-20 ROAD och St 3 Foch St 1 Foch St 186-100 186-31 186-98 186-21 24 Newman St 23 Newman St 0 186-19 0 186-22 19 Newman St 186-60 186-30 20 Newman St 15 Newman St 18 Use Minor 186-23 186-61 23 Richard Ave 186-18 186-29 16 Newman St 186-24 11 Newman St 186-27 186-62 186-17 21 Richard Ave ROAD 12 Newman St 186-26 19 Richard Ave 186-63 186-16 186-25 186-64 186-70

5 Foch Id.

186-9 KALE, SUSAN & CAROL KALE 7 FOCH ST CAMBRIDGE, MA 02138

186-19 CONNELLY, SUSAN TYLER & PAUL FRANCIS TONER 24 NEWMAN STREET CAMBRIDGE, MA 02140-1013

186-8 CARSON, W. JAMES & JEANIE COOPER CARSON 11 FOCH ST CAMBRIDGE, MA 02140

186-100 EDWARDS, WILLIAM S. & DOROTHEA E. REES 1 FOCH ST CAMBRIDGE, MA 02140 186-75 BREDIN, MARGARET ELIZABETH & SIOBHAN P. BREDIN 20 MURRAY HILL RD CAMBRIDGE, MA 02140-1011

185-30 WOODS, ERIC C. & BONNIE T. LE 36 MURRAY HILL RD CAMBRIDGE, MA 02140

186-21 CAMPBELL, CATARINA D. & JASON D. ARROYO 23 NEWMAN ST CAMBRIDGE, MA 02140

186-101 DUNBAR, ANNIE B. & THOMAS R. DUNBAR 3 FOCH ST CAMBRIDGE, MA 02140 JAMES J. RAFFERTY, ESQ. 907 MASS AVENUE – SUITE 300 CAMBRIDGE, MA 02139

186-10 KALE, CAROL A. & SUSAN M. KALE 5 FOCH ST CAMBRIDGE, MA 02140-1002

185-32 BARKER, IAIN W. & KATHLEEN FITZGERALD 26-28 MURRAY HILL RD CAMBRIDGE, MA 02139

185-31 COLUCI ALBERT W. SANDRA A. COLUCI 32 MURRAY HILL RD CAMBRIDGE, MA 02140

52 Murray Hill Rd 185-51 185-15 185-23 54 Murray Hill Rd 48 Murray Hill Rd Murray Hill Rd Murray Hill Rd Rd Rd 43 Murray Hill Rd185-16 185-10 185-17 185-24 37 Murray Hill/Rd 39 Murray Hill Rd 185-18 185-1 185-26 185-25 46 Murray Hill Rd 35 Murray Hill Rd33 Murray Hill Rd 185-19 185-27 40 Murray Hill Rd38 Murray Hill Rd 29 Murray Hill Rd ROAD 185-20 31 Murray Hill Rd 185-28 27 Murray Hill Rd25 Murray Hill Rd 186-4 36 Murray Hill Rd34 Murray Hill Rd 185-21 185-29 32 Murray Hill Rd30 Murray Hill Rd 19 Murray Hill Rd 186-5 185-30 26 Murray Hill Rd28 Murray Hill Rd 186-6 185-31 20 Murray Hill Rd 22 Murray Hill Ro 185-32 186-7 17 Foch St 15 Foch St 186-8 186-75 B 11 Foch St 186-9 186-76 7 Gladstone St och St<sub>7</sub> Foch St 186-10 5 Foch St ROAD 186-101 5 Gladstone St 186-20 ROAD och St 3 Foch St 1 Foch St 186-100 186-31 186-98 186-21 24 Newman St 23 Newman St 0 186-19 0 186-22 19 Newman St 186-60 186-30 20 Newman St 15 Newman St 18 Use Minor 186-23 186-61 23 Richard Ave 186-18 186-29 16 Newman St 186-24 11 Newman St 186-27 186-62 186-17 21 Richard Ave ROAD 12 Newman St 186-26 19 Richard Ave 186-63 186-16 186-25 186-64 186-70

5 Foch Id.

186-9 KALE, SUSAN & CAROL KALE 7 FOCH ST CAMBRIDGE, MA 02138

186-19 CONNELLY, SUSAN TYLER & PAUL FRANCIS TONER 24 NEWMAN STREET CAMBRIDGE, MA 02140-1013

186-8 CARSON, W. JAMES & JEANIE COOPER CARSON 11 FOCH ST CAMBRIDGE, MA 02140

186-100 EDWARDS, WILLIAM S. & DOROTHEA E. REES 1 FOCH ST CAMBRIDGE, MA 02140 186-75 BREDIN, MARGARET ELIZABETH & SIOBHAN P. BREDIN 20 MURRAY HILL RD CAMBRIDGE, MA 02140-1011

185-30 WOODS, ERIC C. & BONNIE T. LE 36 MURRAY HILL RD CAMBRIDGE, MA 02140

186-21 CAMPBELL, CATARINA D. & JASON D. ARROYO 23 NEWMAN ST CAMBRIDGE, MA 02140

186-101 DUNBAR, ANNIE B. & THOMAS R. DUNBAR 3 FOCH ST CAMBRIDGE, MA 02140 JAMES J. RAFFERTY, ESQ. 907 MASS AVENUE – SUITE 300 CAMBRIDGE, MA 02139

186-10 KALE, CAROL A. & SUSAN M. KALE 5 FOCH ST CAMBRIDGE, MA 02140-1002

185-32 BARKER, IAIN W. & KATHLEEN FITZGERALD 26-28 MURRAY HILL RD CAMBRIDGE, MA 02139

185-31 COLUCI ALBERT W. SANDRA A. COLUCI 32 MURRAY HILL RD CAMBRIDGE, MA 02140 To: Board of Zoning Appeal

831 Mass Ave Cambridge, MA

Case No: BZA-212734

Location: 5 Foch St, Cambridge, MA

Petitioner: Susan Kale

We are in support of the petition submitted by our neighbor, Susan Kale, to the Board of Zoning Appeal

Name	Address	Signature
Annie Dunbar	3 Foch Street	o celeuser
Thomas Dunbar	3 Fach Street	lh
Dow thea Rees	1 Foch St.	Dorothea =. Rees
Sandy & Warens	30 Murray Hill ROAD	Sandy Calker
July Carrily Power	24 Newman St	Jun Ginely
Esic Coffey Woods	36 Muray Hill Rd	Mus
CArol Kale	7.9 FOCHST	Teo DD



# City of Cambridge

MASSACHUSETTS

### BOARD OF ZONING APPEAL

831 Mass Avenue, Cambridge, MA. (617) 349-6100

### BZA

### POSTING NOTICE - PICK UP SHEET

The undersigned picked up the notice board for the Board of Zoning Appeals Hearing.

Name:	David Kale (Print)	Date:3 23-2033 =
Address:	5 Foch St.	· · · · · · · · · · · · · · · · · · ·
Case No	BZA-212734	×-
Hearing Da	ate: 4/13/23	•

Thank you, Bza Members