

CITY OF CAMBRIDGE MASSACHUSETTS BOARD OF ZONING APPEAL 831 MASSACHUSETTS AVENUE CAMBRIDGE, MA 02139 617 349-6100

BZA	APPL	_ICA	TION	FORM

Plan No:

BZA-017153-2019

GENERAL INFORMATION

		ons the Boa	rd of Zoning Appeal for the following:
Special Pe	4		Variance : Appeal :
PETITION	ER: Jenna Ta	ube Sirki	n & Rene Rampal Chopra
PETITION	ER'S ADDRESS :	62 Cla	y St. Cambridge, MA 02140
LOCATION	OF PROPERTY:	62 Clay	St Cambridge, MA
TYPE OF (OCCUPANCY: _		ZONING DISTRICT: Residence B Zone
REASON F	OR PETITION :		
	Dorme	r	
DESCRIPT	TON OF PETITIONER	'S PROPOS	SAL:
Petition	ner requests var	iance re	lief to construct a dormer partially within the side yard
			area ratio. Petitioner requests a special permit to add
	within the setb		
SECTIONS	OF ZONING ORDIN	ANCE CITE	D:
Article	5.000	Section	5.31 (Table of Dimensional Requirements).
Article	8.000	Section	8.22.2.C (Non-Conforming Structure).
Article	10.000	Section	10.30 (Variance).
Article	10.000	Section	10.40 (Special Permit).
			Original Signature(s):
			(Petitioner(s) / Owner)
			Jenna Taube Sirkin & Rene Rampal Chopra
			(Print Name)
			Address: 62 Clay St. #2
			Cambridge, MA 02140
			Tel. No.: 617-895-8580
			E-Mail Address : jenna.sirkin@gmail.com
Date: 7	7-16-19		

BZA APPLICATION FORM - OWNERSHIP INFORMATION

To be completed by OWNER, signed before a notary and returned to The Secretary of the Board of Zoning Appeals.

I/We Jenna Sirkin and Rene Chopra (OWNER)
Address: 62 Clay Street Cambridge, MA
State that I/We own the property located at <u>62 Clay Street</u> , which is the subject of this zoning application.
The record title of this property is in the name ofJenna Sirkin and Rene Chopre
*Pursuant to a deed of duly recorded in the date <u>12/4/2015</u> , Middlesex South
County Registry of Deeds at Book 66479 , Page 454 ; or
Middlesex Registry District of Land Court, Certificate No.
Book Page SIGNATURE BY LAND OWNER OR
*Written evidence of Agent's standing to represent petitioner may be requested.
Commonwealth of Massachusetts, County of
The above-name Jenna SixKin & Reve Chopro personally appeared before me,
this 9^k of 30 , 2019, and made oath that the above statement is true.
Notary JAYDEN DDHIR Notary Public Notary Public

• If ownership is not shown in recorded deed, e.g. if by court order, recent deed, or inheritance, please include documentation.

BZA APPLICATION FORM

SUPPORTING STATEMENT FOR A VARIANCE

EACH OF THE FOLLOWING REQUIREMENTS FOR A VARIANCE MUST BE ESTABLISHED AND SET FORTH IN COMPLETE DETAIL BY THE APPLICANT IN ACCORDANCE WITH MGL 40A, SECTION 10:

A) A Literal enforcement of the provisions of this Ordinance would involve a substantial hardship, financial or otherwise, to the petitioner or appellant for the following reasons:

A literal enforcement of the provisions of the Ordinance would involve a substantial hardship to Petitioner because the house is dated and requires significant upgrades to its systems and floor plan. Additionally, this lot suffers from subsurface flooding conditions that restrict the use of the basement area for an additional bedroom to accommodate Petitioner's growing family. The Petitioner has tenants on the first floor of the multi-family home, so the Petitioner needs to create space on the second and third floor to have a children's bedroom on the same floor as the master bedroom. One of the Petitioners also works from home full time in Cambridge and has an office on the second floor.

Granting the requested relief will provide for functional head height on the third floor allowing for a second bedroom and code compliant stairs.

B) The hardship is owing to the following circumstances relating to the soil conditions, shape or topography of such land or structures and especially affecting such land or structures but not affecting generally the zoning district in which it is located for the following reasons:

The hardship is owing to the non-conforming size of the dwelling that exceeds the allowable FAR and the soil condition such that even a modest increase in FAR for dormers would require relief. Further the dormer on the left side of the house will provide building code compliant access to the existing third floor bedrooms thereby making the house safer and more suitable for families.

C) DESIRABLE RELIEF MAY BE GRANTED WITHOUT EITHER:

1) Substantial detriment to the public good for the following reasons:

The requested additions will not negatively impact the adjacent residential uses because the changes are modest in nature and are consistent with the other residential structures on the street that also utilize dormers.

Relief may be granted without nullifying or substantially derogating from the intent or purpose of this Ordinance for the following reasons:

The requested relief will not substantially derogate from the intent or purpose of the ordinance because the relief is modest in nature and if approved will increase Cambridge's housing stock of renovated family friendly properties.

* If You have any questions as to whether you can establish all of the applicable legal requirements, you should consult with your own attorney.

BZA APPLICATION FORM

SUPPORTING STATEMENT FOR A SPECIAL PERMIT

Please describe in complete detail how you meet each of the following criteria referring to the property and proposed changes or uses which are requested in your application. Attach sheets with additional information for special permits which have additional criteria, e.g.; fast food permits, comprehensive permits, etc., which must be met.

Granting the Special Permit requested for $\underline{62}$ Clay St Cambridge, MA (location) would not be a detriment to the public interest because:

A) Requirements of the Ordinance can or will be met for the following reasons:

With the requested relief the requirements of the ordinance will be satisfied.

B) Traffic generated or patterns of access or egress would not cause congestion hazard, or substantial change in established neighborhood character for the following reasons:

No congestion, hazard, or substantial change in the established neighborhood character will result from approval of the windows within the setback because the location of the windows will not negatively impact privacy for the direct abutters and will allow for the appropriate amount of light in air into the reconfigured dwelling.

C) The continued operation of or the development of adjacent uses as permitted in the Zoning Ordinance would not be adversely affected by the nature of the proposed use for the following reasons:

The continued operation of or the development of adjacent uses will not be adversely affected because there is no change to the two family use.

Nuisance or hazard would not be created to the detriment of the health, safety and/or welfare of the occupant of the proposed use or the citizens of the City for the following reasons:

No nuisance or hazard will be created nor will any detriment to the health, safety and/or welfare of the occupants of the proposed use or the citizens of the City because the additional windows will allow the appropriate light and air into the reconfigured dwelling.

E) For other reasons, the proposed use would not impair the integrity of the district or adjoining district or otherwise derogate from the intent or purpose of this ordinance for the following reasons:

The proposed addition will not impair the integrity of the district and is consistent with the intent of the ordinance by allowing for the renovation and modernization of Cambridge's older housing stock.

BZA APPLICATION FORM

DIMENSIONAL INFORMATION

APPLICANT: Jenna Sirkin PRESENT USE/OCCUPANCY: multi-family

LOCATION: 62 Clay St Cambridge, MA ZONE: Residence B Zone

PHONE: 617-895-8580 REQUESTED USE/OCCUPANCY: multi-family


			-		
		EXISTING CONDITIONS	REQUESTED CONDITIONS	ORDINANCE REQUIREMENTS	
TOTAL GROSS FLOOR AR	EA:	2305 sf	2509 sf	1487 sf	(max.)
LOT AREA:		2974 sf	2974 sf	5000 sf	(min.)
RATIO OF GROSS FLOOR TO LOT AREA: 2	AREA	.78	.85	.5	(max.)
LOT AREA FOR EACH DW	ELLING UNIT:	1487 sf	1487 sf	2500 sf	(min.)
SIZE OF LOT:	WIDTH	39'8"	39'8"	50'	(min.)
	DEPTH	75'	75'	n/a	
SETBACKS IN FEET:	FRONT	13'	13'	15'	(min.)
	REAR	19'9"	19'9"	25'	(min.)
	LEFT SIDE	13'8"	13'8"	7'6"	(min.)
	RIGHT SIDE	3'11"	3'11"	7'6"	(min.)
SIZE OF BLDG.:	HEIGHT	32'8"	34'11"	35'	(max.)
	LENGTH	42'2"	42'2"	n/a	
	WIDTH	22'1"	22'1"	n/a	
RATIO OF USABLE OPEN SPACE TO LOT AREA:		.3	.3	. 4	(min.)
NO. OF DWELLING UNITS:		2	2	2	(max.)
NO. OF PARKING SPACES:		0	0	n/a (mi	n./max)
NO. OF LOADING AREAS:		0	0	n/a	(min.)
DISTANCE TO NEAREST BLDG. ON SAME LOT:		n/a	n/a	n/a	(min.)

Describe where applicable, other occupancies on same lot, the size of adjacent buildings on same lot, and type of construction proposed, e.g.; wood frame, concrete, brick, steel, etc.

^{1.} SEE CAMBRIDGE ZONING ORDINANCE ARTICLE 5.000, SECTION 5.30 (DISTRICT OF DIMENSIONAL REGULATIONS).

^{2.} TOTAL GROSS FLOOR AREA (INCLUDING BASEMENT 7'-0" IN HEIGHT AND ATTIC AREAS GREATER THAN 5') DIVIDED BY LOT AREA.

^{3.} OPEN SPACE SHALL NOT INCLUDE PARKING AREAS, WALKWAYS OR DRIVEWAYS AND SHALL HAVE A MINIMUM DIMENSION OF 15'.

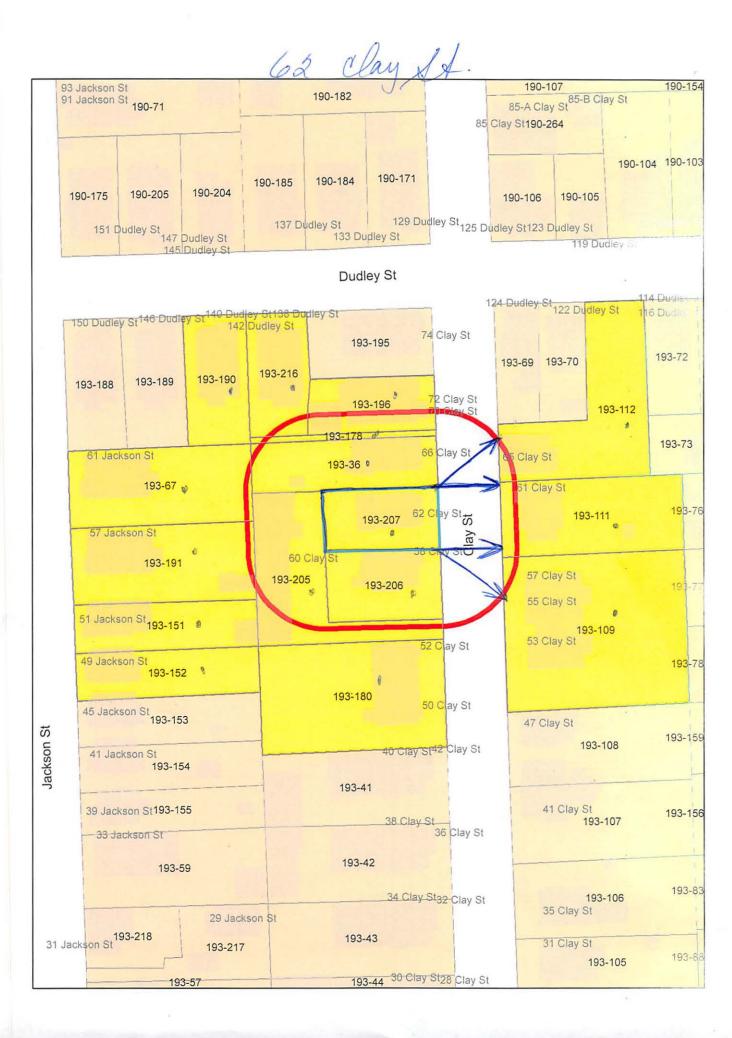

62 clay XX

193-36 DELVECCHIO, BERNARD M. & RACHEL H. DELVECCHIO, TRUSTEE 66 CLAY ST CAMBRIDGE, MA 02140

193-109 ROTHFEDER, JAMIE L. & MITHRA T. ROTHFEDE 55 CLAY ST., #55 CAMBRIDGE, MA 02140

193-112 TREMBLAY, PAUL L. & IRENE T. REEDER-TREMBLAY TRUST OF PAUL L. TREMBLAY TRUST 65 CLAY ST CAMBRIDGE, MA 02140

193-178 CAMBRIDGE CITY OF PWD 147 HAMPSHIRE ST CAMBRIDGE, MA 02139

193-190 DESROSIERS, BETTY J. 142 DUDLEY ST CAMBRIDGE, MA 02140

193-206 WINE, PAMELA R. 58 CLAY ST CAMBRIDGE, MA 02140

193-191 E2 PROPERTY, LLC 95 AUCKLAND ST., #2 BOSTON, MA 02125

193-109 GREIF, MATTHEW P. 53 CLAY ST CAMBRIDGE, MA 02140 193-67 COMERFORD, EDWARD M. & MICHELLE COMERFORD-MORA C/O ELLIS COLLEN 18 CLIFF AVE SCITUATE, MA 02066

193-109 PEPIN, FLORENTINE & PEDRAM JAVEDAN 57 CLAY ST., #57 CAMBRIDGE, MA 02138

193-151 SIROIS, RAYMOND & PIERRETTE SIROIS 51 JACKSON ST CAMBRIDGE, MA 02140

193-178 CITY OF CAMBRIDGE C/O NANCY GLOWA CITY SOLICITOR

193-196 GIRARD, THERESE, TR. OF THE THERESE GIRARD FAM TRUST 72 CLAY ST CAMBRIDGE, MA 02140

193-180 LORY, STEPHEN & CLARISSA B. FOY 52 CLAY ST., UNIT #52 CAMBRIDGE, MA 02138

193-191 FREI, WALTER 57 JACKSON ST., #3 CAMBRIDGE, MA 02140

193-180 BROPHY, BENJAMIN W. & LISA M. DOWNING 50 CLAY ST. CAMBRIDGE, MA 02140 193-207 SIRKIN, JENNA TAUBE & RENE RAMPAL CHOPRA 62 CLAY ST CAMBRIDGE, MA 02140

193-111 RAYCROFT, JOSY T. & KATHERINE A. TOOKE 61 CLAY ST CAMBRIDGE, MA 02140

193-152 ARCIDIACONO, JOSEPH E. & EMMA MENDEZ-ARCIDIACONO 49 JACKSON ST CAMBRIDGE, MA 02140

193-178 CITY OF CAMBRIDGE C/O LOUIS DEPASQUALE CITY MANAGER

193-205 BAEHR, JOEL D. & ANN W. BAEHR 60 CLAY STREET CAMBRIDGE, MA 02140

193-216 iDOC PROPERTIES, LLC 9 BEDFORD LANE LINCOLN, MA 01773

193-191 O'BERG, MELISSA A. & JAMES P. BYRNES 57 JACKSON ST., #2 CAMBRIDGE, MA 02140

SIRKIN/ CHOPRA RESIDENCE

BZA SUBMISSION SET 07/10/2019

JENNA SIRKIN RAMPAL CHOPRA

62 CLAY ST. CAMBRIDGE MA 02140





ARCHITECT:

SAM KACHMAR **ARCHITECTS**



SAM KACHMAR

ARCHITECTS (p)978-270-8441 kachmardesign.com 357 HURON AVE. CAMBRIDGE MA, 02138 CLIENT:

INTERIOR DESIGNER:

JENNA SIRKIN RAMPAL CHOPRA NONE

PROJECT NARRATIVE

THE SCOPE OF THE SIRKIN/CHOPRA PROJECT IS TO RAISE THE ROOF BY 2' 3" TO A PROPOSED RIDGE HEIGHT OF 34' 11" AND WIDEN THE EXISTING THE DORMERS IN ORDER TO INCREASE LIVING SPACE ON LEVEL 3 FOR THE FAMILY. THE FIRST FLOOR COVERED PORCH WILL BE PARTIALLY ENCLOSED TO CREATE A MUDROOM. THE SECOND FLOOR SCOPE OF WORK IS ONLY THE ADDITION OF A WINDOW ON THE NORTH ELEVATION FOR DAYLIGHTING IN THE OFFICE THAT THE CLIENT WORKS FROM HOME IN AND THE REDESIGNED STAIRWELL TO THE THIRD FLOOR. THE THIRD FLOOR WILL BE REDESIGNED TO ACCOMIDATE A MASTER SUITE, CHILDRENS BEDROOM & BATHROOM, AND LAUNDRY & STORAGE. THE EXTERIOR SCOPE OF WORK INCLUDES ADDING A DECK ON THE THIRD FLOOR ON THE FRONT AND RECONFIGURING THE BACK PORCHES WITH A NEW SPIRAL STAIRCASE AND STORAGE SHED.


GENERAL CONTRACTOR:

STRUCTURAL ENGINEER:

J CONTRACTORS


NONE

Sheet List					
Sheet Number	Sheet Name	Drawn By	Designed By		
A-001	COVER	MNW	SKA		
A-002	PLOT PLAN	MNW	SKA		
A-003	SITE AXON - NORTH	MNW	SKA		
A-100	LOWER LEVEL	MNW	SKA		
A-101	1ST FLOOR PLAN	MNW	SKA		
A-102	2ND FLOOR PLAN	MNW	SKA		
A-103	3RD FLOOR PLAN	MNW	SKA		
A-104	ROOF PLAN	MNW	SKA		
A-200	EAST ELEVATION	MNW	SKA		
A-201	NORTH ELEVATION	MNW	SKA		
A-202	WEST ELEVATION	MNW	SKA		
A-203	SOUTH ELEVATION	MNW	SKA		
A-204	CLAY STREET ELEVATION	MNW	SKA		
A-205	EXISTING & PROPOSED FRONT PERSPECTIVE	MNW	SKA		
A-206	EXISTING & PROPOSED REAR PERSPECTIVE	MNW	SKA		
A-207	EXISTING PHOTOS	MNW	SKA		
Grand total: 16	•	,			

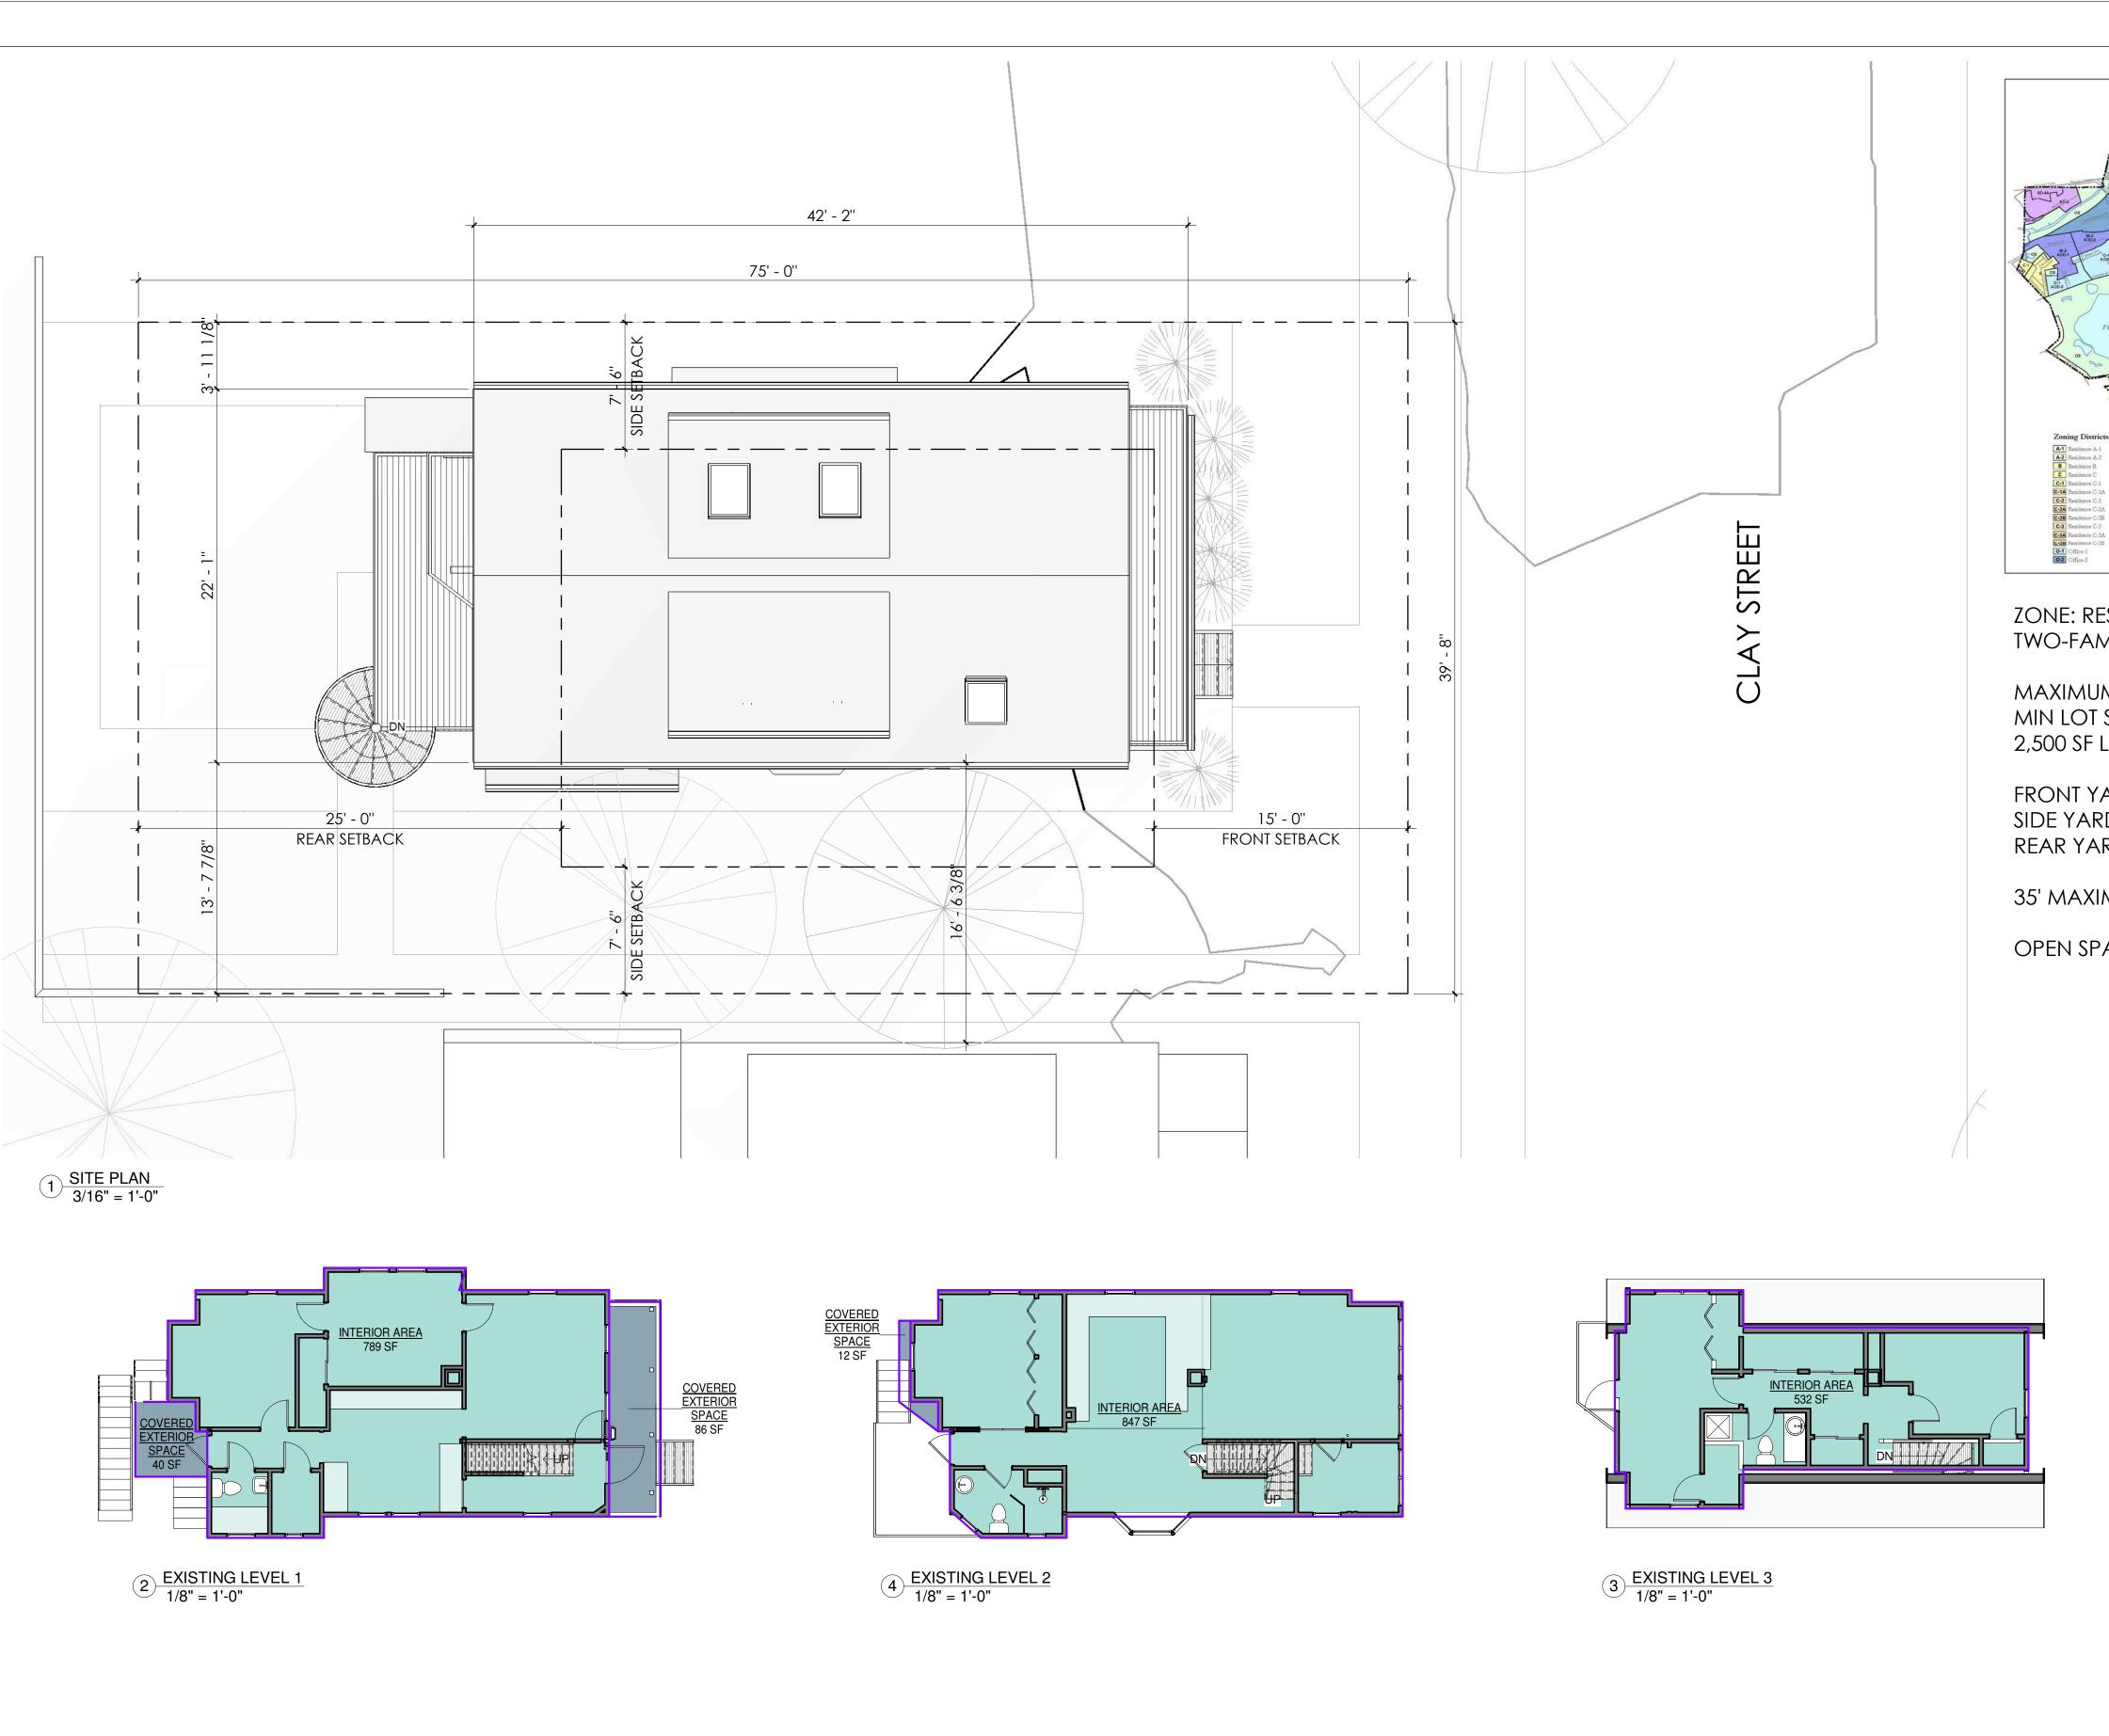

6 PROPOSED LEVEL 2
1/8" = 1'-0"

5 PROPOSED LEVEL 1
1/8" = 1'-0"

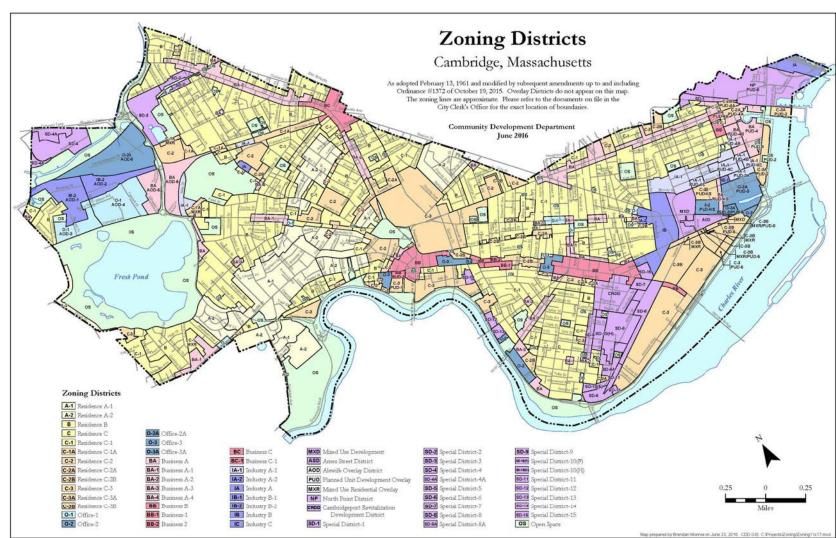

ZONE: RESIDENCE B TWO-FAMILY OR SEMI- DETACHED DWELLINGS

MAXIMUM FAR: 0.50 MIN LOT SIZE = 5,000 SF 2,500 SF LOT PER DWELLING UNIT

FRONT YARD SETBACK: 15' SIDE YARD SETBACK: 7.5' REAR YARD SETBACK: 25'

35' MAXIMUM BUILDING HEIGHT

OPEN SPACE REQUIREMENT: 40%

EXISTING LOT SIZE: 2,974 SQ. FT.

EXISTING AREA SO	CHEDULE
Name	Area
LEVEL 1	
COVERED EXTERIOR SPACE	126 SF
NTERIOR AREA	789 SF
LEVEL 2	1
COVERED EXTERIOR SPACE	12 SF
nterior area	847 SF
_EVEL 3	
nterior area	532 SF
Grand total: 6	2305 SF

EXISTING HOUSE HEIGHT: 32' 8" EXISTING FAR: 0.78

INTERIOR AREA 739 SF	
DN	

	PROPOSED HOUSE HEIGHT: 34' 1
7 PROPOSED LEVEL 3 1/8" = 1'-0"	PROPOSED FAR: 0.85

PROPOSED AREA SCHEDULE					
Level	Name	Area			
Not Placed					
Not Placed	COVERED EXTERIOR SPACE	0 SF			
Not Placed	INTERIOR AREA	0 SF			
LEVEL 1					
LEVEL 1	COVERED EXTERIOR SPACE	65 SF			
LEVEL 1	INTERIOR AREA	846 SF			
LEVEL 2		•			
LEVEL 2	COVERED EXTERIOR SPACE	12 SF			
LEVEL 2	INTERIOR AREA	847 SF			
LEVEL 3					
LEVEL 3	INTERIOR AREA	739 SF			
Grand total: 10		2509 SF			





SIRKIN RAMPAL CHOPRA

JENNA

RESIDENCE AMBRIDGE MA ST. 62 CLAY 02140

Project Status BZA SUBMISSION SET Project number 07/10/2019 MNW Checker Checked by A-002

As indicated

ABBREVIATIONS

INTERIOR

LENGTH

POUND

LIGHT

LIGHT WEIGHT

MECHANICAL

MANUFACTURER

MISCELLANEOUS

NOT APPLICABLE

NOT TO SCALE
ON CENTER

NOT IN CONTRACT

OUTSIDE DIAMETER

ORIENTED STRANDBOARD

OPPOSITE HAND

MAXIMUM

MEDIUM

MINIMUM

MOUNTED

METAL

NORTH

NOMINAL

OPPOSITE

OVERHEAD

OUNCE (S)

PATTERN (ED)

PERFORATED PERPENDICULAR

PLASTIC LAMINATE

PREFAB PREFABRICATE, PREFABRICATED

REFRIGERATE, REFRIGERATOR

REINFORCE, REINFORCED

REVISION, REVISE, REVISED

SOUND TRANSMISSION CLASS

UNLESS OTHERWISE NOTED

INDICATES TIMES OR BY

ROUGH OPENING

PAINT, PAINTED

LAMINATE, LAMINATED

MEDIUM DENSITY FIBER

LIGHT GAGE METAL FRAMING

JOINT

LAM

LB

LT WT

MAX

MDF

MECH

MFR

MISC

MTD

MTL

N/A

NIC

NOM

OD

 OH

OPP

OVHD

ΟZ

PATT

PERF

PLAM

PR

QTY

RBR

REF

REQ

REV

RM

SQ

STC

STOR

STR

UON

WD

PLYWD PLYWOOD

PAIR

QUANTITY

RADIUS

RUBBER

ROOF DRAIN

REFERENCE

REQUIRE

ROOM

SOUTH

SQUARE FEET

SIMILAR

SQUARE

STORAGE

TOP OF

WOOD

WEIGHT

UNDERSIDE OF

STAIR

SS, SST STAINLESS STEEL

SQUARE INCHES

SPECIFICATION

SCHED SCHEDULE

#	T	ı
	NUMBER OR POUND	
&,+	AND	
@	AT	
ADJ	ADJUSTABLE	
AFF	ABOVE FINISH FLOOR	
ALUM	ALUMINUM	
APPROX	APPROXIMATELY	
ARCH	ARCHITECTURAL	
AVB	AIR AND VAPOR BARRIER	
BD	BOARD	
BIT	BITUMINOUS	
BLDG	BUILDING	
BSMT	BASEMENT	
BTWN	BETWEEN	
CF	CUBIC FEET	
Cl	CUBIC INCHES	
CJ	CONTROL JOINT	
CL	CENTERLINE	
CLG	CEILING	
CLR	CLEAR OR CLEARANCE	
CMU	CONCRETE MASONRY UNIT	
COL	COLUMN	
CONC	CONCRETE	
CONT	CONTINUOUS	
CORR	CORRIDOR, CORRUGATED	
CTR	CENTER DEPTH DEED	
D	DEPTH, DEEP	
DBL	DOUBLE	
DEMO	DEMOLISH, DEMOLITION	
DIA	DIAMETER	
DIM	DIMENSION	
DN	DOWN	
DTL	DETAIL	
DW	DISHWASHER	
Е	EAST	
EA	EACH	
EJ	EXPANSION JOINT	
EL	ELEVATION (GRADE)	
ELEC	ELECTRICAL	
ELEV	ELEVATION (FACADE)	
EOS	EDGE OF SLAB	
EQ	EQUAL, EQUIPMENT, EQUIP	
ETR	EXISTING TO REMAIN	
EXG	EXISTING	
EXP	EXPOSED	
	EXTERIOR	
FXT		
EXT FAR		ı
FAB	FABRICATE, FABRICATION	
FAB FD	FABRICATE, FABRICATION FLOOR DRAIN	
FAB FD FF	FABRICATE, FABRICATION FLOOR DRAIN FINISHED FLOOR	
FAB FD FF FL	FABRICATE, FABRICATION FLOOR DRAIN FINISHED FLOOR FLOOR	
FAB FD FF FL FOW	FABRICATE, FABRICATION FLOOR DRAIN FINISHED FLOOR FLOOR FACE OF WALL	
FAB FD FF FL FOW FT	FABRICATE, FABRICATION FLOOR DRAIN FINISHED FLOOR FLOOR FACE OF WALL FEET, FOOT	
FAB FD FF FL FOW FT GA	FABRICATE, FABRICATION FLOOR DRAIN FINISHED FLOOR FLOOR FACE OF WALL FEET, FOOT GAUGE	
FAB FD FF FL FOW FT GA GALV	FABRICATE, FABRICATION FLOOR DRAIN FINISHED FLOOR FLOOR FACE OF WALL FEET, FOOT GAUGE GALVANIZED	
FAB FD FF FL FOW FT GA GALV GL	FABRICATE, FABRICATION FLOOR DRAIN FINISHED FLOOR FLOOR FACE OF WALL FEET, FOOT GAUGE GALVANIZED GLASS, GLAZING, GLAZED	
FAB FD FF FL FOW FT GA GALV	FABRICATE, FABRICATION FLOOR DRAIN FINISHED FLOOR FLOOR FACE OF WALL FEET, FOOT GAUGE GALVANIZED	
FAB FD FF FL FOW FT GA GALV GL	FABRICATE, FABRICATION FLOOR DRAIN FINISHED FLOOR FLOOR FACE OF WALL FEET, FOOT GAUGE GALVANIZED GLASS, GLAZING, GLAZED	
FAB FD FF FL FOW FT GA GALV GL GWB	FABRICATE, FABRICATION FLOOR DRAIN FINISHED FLOOR FLOOR FACE OF WALL FEET, FOOT GAUGE GALVANIZED GLASS, GLAZING, GLAZED GYPSUM WALLBOARD, BACKING BOARD	
FAB FD FF FL FOW FT GA GALV GL GWB GYP	FABRICATE, FABRICATION FLOOR DRAIN FINISHED FLOOR FLOOR FACE OF WALL FEET, FOOT GAUGE GALVANIZED GLASS, GLAZING, GLAZED GYPSUM WALLBOARD, BACKING BOARD GYPSUM	
FAB FD FF FL FOW FT GA GALV GL GWB GYP H	FABRICATE, FABRICATION FLOOR DRAIN FINISHED FLOOR FLOOR FACE OF WALL FEET, FOOT GAUGE GALVANIZED GLASS, GLAZING, GLAZED GYPSUM WALLBOARD, BACKING BOARD GYPSUM HIGH	
FAB FD FF FL FOW FT GA GALV GL GWB GYP H HDWD	FABRICATE, FABRICATION FLOOR DRAIN FINISHED FLOOR FLOOR FACE OF WALL FEET, FOOT GAUGE GALVANIZED GLASS, GLAZING, GLAZED GYPSUM WALLBOARD, BACKING BOARD GYPSUM HIGH HARDWOOD HOLLOW METAL	
FAB FD FF FL FOW FT GA GALV GL GWB GYP H HDWD HM HORIZ	FABRICATE, FABRICATION FLOOR DRAIN FINISHED FLOOR FLOOR FACE OF WALL FEET, FOOT GAUGE GALVANIZED GLASS, GLAZING, GLAZED GYPSUM WALLBOARD, BACKING BOARD GYPSUM HIGH HARDWOOD HOLLOW METAL HORIZONTAL	
FAB FD FF FL FOW FT GA GALV GL GWB GYP H HDWD	FABRICATE, FABRICATION FLOOR DRAIN FINISHED FLOOR FLOOR FACE OF WALL FEET, FOOT GAUGE GALVANIZED GLASS, GLAZING, GLAZED GYPSUM WALLBOARD, BACKING BOARD GYPSUM HIGH HARDWOOD HOLLOW METAL	

MATERIALS

7717 (TEICH (LO	
	EARTH
	CONCRETE
2000 2000 2000 2000 2000 2000 2000 200	GRAVEL
	SAND
	GYPSUM BOARD OR SHEATHING
	MASONRY - BRICK
	MASONRY - CONCRETE BLOCK
	WOOD - FINISH - END GRAIN
	WOOD - FINISH - FACE
	WOOD - ROUGH - BLOCKING (CONTINUOUS MEMBERS)
	WOOD - ROUGH - BLOCKING (INTERMEDIATE MEMBERS)
	INSULATION - RIGID
	INSULATION - BATT OR MINERAL WOOL
	ACOUSTIC TILE, PANEL, OR PLANK
	PLYWOOD
	CUT STONE
	PARTICLE BOARD OR FIBERBOARD

193-196 (30.0)Map-Lot: (120.0)(45.0)Map-Lot: 5250 Map-Lot: 193-205 Map-Lot: 🗀 (75.0)Map-Lot: 193-109 (120.0)8400 Map-Lot:

SYMBOLS

VIEW SCALE:1/X	VIEW NAME SCALE:1/X" = 1'-0"			DRAWING TITLE	
SHEET	O.H. / SIM			EXTERIOR ELEVATION KEY	
SHEET				INTERIOR ELEVATION KEY	
O.H. / SIM VIEW # SHEET			BUILDING SECTION MARKER		
VIEW # O.H. / SIM			WALL SECT	TON MARKER	
VIEW # O.H. / SIM			DETAIL ARE	EA MARKER	
VIEW # O.H. / SIM		-	DETAIL SEC	CTION MARKER	
COLUMN	COLUMN			GRID LINE	
Name				VERTICAL ELEVATION KEY (ELEV)	
- O' - O"	0' - 0"			SPOT ELEVATION W/ TARGET (PLAN)	
0' - 0"	0 0.,			SPOT ELEVATION NO TARGET (PLAN)	
	REV#		REVISION (REVISION 1	CLOUD AND AG	
ROOM NAME ROOM #	ROOM TAG		Ę	CENTERLINE	
? AREA NAME AREA	AREA TAG	SHEET SHEET		MATCH LINE	
DOÖR#	DOOR TAG			HINGE SIDE OF DOOR	
# TYPE	WINDOW TAG	·		ALIGN SURFACES	
		R F	ROOM NAME OOM # LOOR BASE WALL EILING	FINISH TAG	

GENERAL NOTES

THE WORK.

- 1. ALL WORK SHALL BE CONSIDERED NEW, UNLESS OTHERWISE INDICATED.
- DO NOT SCALE DRAWINGS
 VERIFY DIMENSIONS, GRADES, BOUNDARIES, AND CONSTRUCTION AND IMMEDIATELY REPORT ANY DISCREPANCIES BEFORE PROCEEDING WITH
- 4. TO THE EXTENT PRACTICABLE, VERIFY DIMENSIONS AND FIELD CONDITIONS AT THE SITE PRIOR TO THE BID SUBMISSION. CONFLICTS, OMISSIONS AND DISCREPANCIES WITHIN THE CONTRACT DOCUMENTS SHALL BE REPORTED IN WRITING TO THE ARCHITECT, IN ACCORDANCE WITH THE CONTRACT DOCUMENTS, PRIOR TO THE BID SUBMISSION. THE CONTRACTOR WARRANTS, BY TENDERING HIS BID, THAT THE WORK IS BUILDABLE AS SHOWN.
- 5. LAYOUT ALL WORK WITHIN THE CONFINES OF EXISTING CONSTRUCTION AND RESOLVE DISCREPANCIES PRIOR TO INITIATION OF NEW WORK.
- 6. ARCHITECT IS NOT RESPONSIBLE FOR CONSTRUCTION THAT IS STARTED PRIOR TO PERMIT BEING ISSUED.
- 7. DIMENSIONS, NOTES, FINISHES AND FIXTURES SHOWN ON TYPICAL FLOOR PLANS, SECTION OR DETAILS SHALL APPLY TO SIMILAR, SYMMETRICAL OR OPPOSITE HAND PLANS SECTIONS OR DETAILS, UNLESS NOTED OTHERWISE.
- 8. TYPICAL OR "TYP" SHALL MEAN THAT THE CONDITION IS REPRESENTATIVE FOR SIMILAR CONDITIONS THROUGHOUT, UNLESS NOTED OTHERWISE. DETAILS ARE USUALLY KEYED AND NOTED "TYP" ONLY ONE TIME, WHEN THEY FIRST OCCUR.
- IMMEDIATELY NOTIFY THE ARCHITECT IN WRITING OF ANY DISCREPANCIES BETWEEN PROJECT MANUAL, LARGE SCALE DRAWINGS, SMALL SCALE DRAWINGS AND DETAILS. THE CONTRACTOR SHALL NOT PROCEED WITH AFFECTED WORK UNTIL ARCHITECT PROVIDES CLARIFICATION.
- 10. PARTITIONS ARE DIMENSIONED FROM FINISHED FACE TO FINISHED FACE UNLESS OTHERWISE NOTED. DIMENSIONS TO MASONRY ARE TO ACTUAL FINISHED FACE, UNLESS OTHERWISE NOTED.
- 11. VERIFY THAT DRAWINGS ARE THE LATEST ISSUE PRIOR TO COMMENCING CONSTRUCTION. THE GENERAL CONTRACTOR SHALL BE RESPONSIBLE FOR COMMUNICATING AND DISTRIBUTING ALL CONSTRUCTION DOCUMENT UPDATES TO ALL TRADES.
- 12. WORK SHALL CONFORM TO THE REQUIREMENTS OF APPLICABLE STATE, FEDERAL AND CITY/COUNTY CODES. STATE AND FEDERAL CODES ARE TO TAKE PRECEDENCE OVER THE DRAWINGS AND SPECIFICATIONS. IF ANY DISCREPANCY IS NOTED, IMMEDIATELY INFORM THE ARCHITECT, PRIOR TO PROCEEDING WITH THE WORK.
- 13. FILE, OBTAIN AND PAY FEES FOR BUILDING DEPARTMENT PERMITS, CONTROLLED INSPECTIONS, OTHER AGENCY APPROVALS AND PERMITS WHERE REQUIRED, AND FINAL WRITE-OFFS FOR PROJECT COMPLETION. COPIES OF TRANSACTIONS SHALL BE FORWARDED TO THE OWNER OR OWNER'S REPRESENTATIVE.
- 14. EXECUTE INSPECTIONS NECESSARY TO OBTAIN A CERTIFICATE OF OCCUPANCY.
- 15. WORK AREA SHALL BE MAINTAINED, CLEAN AND FREE OF DEBRIS AT ALL TIMES.16. PATCH ALL SURFACES TO MATCH ADJACENT IN A MANNER SUITABLE TO
- RECEIVE FINISHES.

 17. PATCH, REPAIR AND FINISH ALL SURFACES IN AREAS OUTSIDE OF THE EXISTING SCOPE THAT ARE DISTURBED AS A RESULT OF THE WORK
- EXISTING SCOPE THAT ARE DISTURBED AS A RESULT OF THE WORK.

 18. COORDINATE AND PROVIDE BLOCKING AND STRAPPING WITHIN PARTITIONS FOR MILLWORK AND OTHER WALL ATTACHED ITEMS.
- 19. APPLY, INSTALL, CONNECT, CLEAN AND/OR CONDITION MANUFACTURED ARTICLES, MATERIALS AND/OR EQUIPMENT PER MANUFACTURER'S INSTRUCTIONS. IN CASE OF CONFLICT BETWEEN MANUFACTURER'S INSTRUCTIONS AND THE CONTRACT DOCUMENTS, THE CONTRACTOR SHALL OBTAIN WRITTEN CLARIFICATION FROM THE ARCHITECT BEFORE PROCEEDING.
- 20. GLASS 18" OR LESS FROM FLOOR LINE OR ADJACENT TO A DOOR SWING SHALL BE SAFETY GLASS AS REQUIRED BY APPLICABLE CODE(S). THE CONTRACTOR SHALL BE RESPONSIBLE FOR PROVIDING ." SAFETY GLASS, UNLESS OTHERWISE NOTED, TO COMPLY WITH BUILDING AND LIFE SAFETY CODES, INDUSTRY STANDARDS AND OTHER APPLICABLE FEDERAL AND STATE CODES.
- 21. FLASHING AT EXTERIOR WALLS SHALL BE INSTALLED WITH SEALED JOINTS, SEALED PENETRATIONS AND ENDS TURNED UP. IT SHALL BE FABRICATED AND INSTALLED TO ENSURE THAT MOISTURE IN WALLS WILL BE DIRECTED TO WICKS AND WEEP HOLES.
- 22. COORDINATE ALL DIMENSIONS CONCERNING DOORS/PANELS/WINDOWS, STAIRS AND THEIR OPENINGS WITH PRODUCT MANUFACTURERS PRIOR TO FABRICATION AND CONSTRUCTION.
- 23. PROVIDE WEATHERSTRIP AT EXTERIOR DOORS.
- 24. PROVIDE FLASHING AND/OR SEALANT AT OPENINGS IN ROOF OR WALLS TO ENSURE A WEATHERTIGHT BUILDING.
- 25. LOCATE THERMOSTATS ADJACENT TO SWITCH PLATES WHERE POSSIBLE. VERIFY LOCATION WITH THE ARCHITECT PRIOR TO INSTALLATION TO AVOID CONFLICTS WITH BUILT-INS OR SYSTEMS FURNITURE OR DESIGN ELEMENTS.
- 26. ALIGN OUTLETS, WALL SWITCHES, TEL-DATA JACKS, ETC., INDICATED TO BE MOUNTED AT NEAR EQUIVALENT ELEVATIONS.
- 27. ALL DOORS SHALL BE LOCATED 6" OFF THE ADJACENT PARTITION, OR ONE MASONRY COURSE AT CMU PARTITIONS, UNLESS NOTED OTHERWISE.
- 28. DURING DEMOLITION AND CONSTRUCTION PROTECT ALL EXISTING FINISHES TO REMAIN.
- 29. ALL WOOD SHALL BE FSC CERTIFIED.
- 30. ALL WOOD FRAMING SIZES ARE BASED ON SPF-SS
- 31. ALL WOOD FRAMING SIZES ARE BASED ON SPF-SS

 31. ALL WOOD IN CONTACT WITH CONCRETE OR MASONRY SHALL BE
 PRESSURE TREATED (P.T.).
- 32. CORRECT ALL DEFECTS FOUND IN EXISTING BUILDING WHICH INTERFERE WITH NEW CONSTRUCTION. THIS INCLUDES BUT IS NOT LIMITED TO UNEVEN SURFACES AND FINISHES AT GWB.




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ARCHITECTS

(2) 0.70, 0.70, 0.441

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KIN/ CHOPRA RESIDENCE CLAY ST. CAMBRIDGE MA 40

SIRKIN

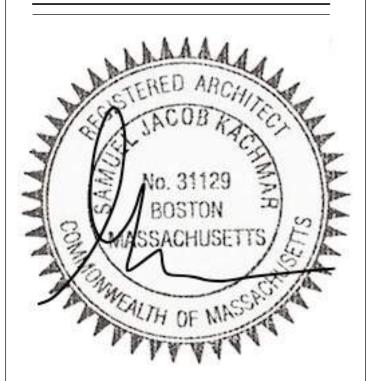Project Status BZA SUBMISSION SET
Project number 16.32
Date 07/10/2019
Drawn by MNW


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A-002A

Scale 1 1/2" = 1'-0"





JENNA SIRKIN RAMPAL

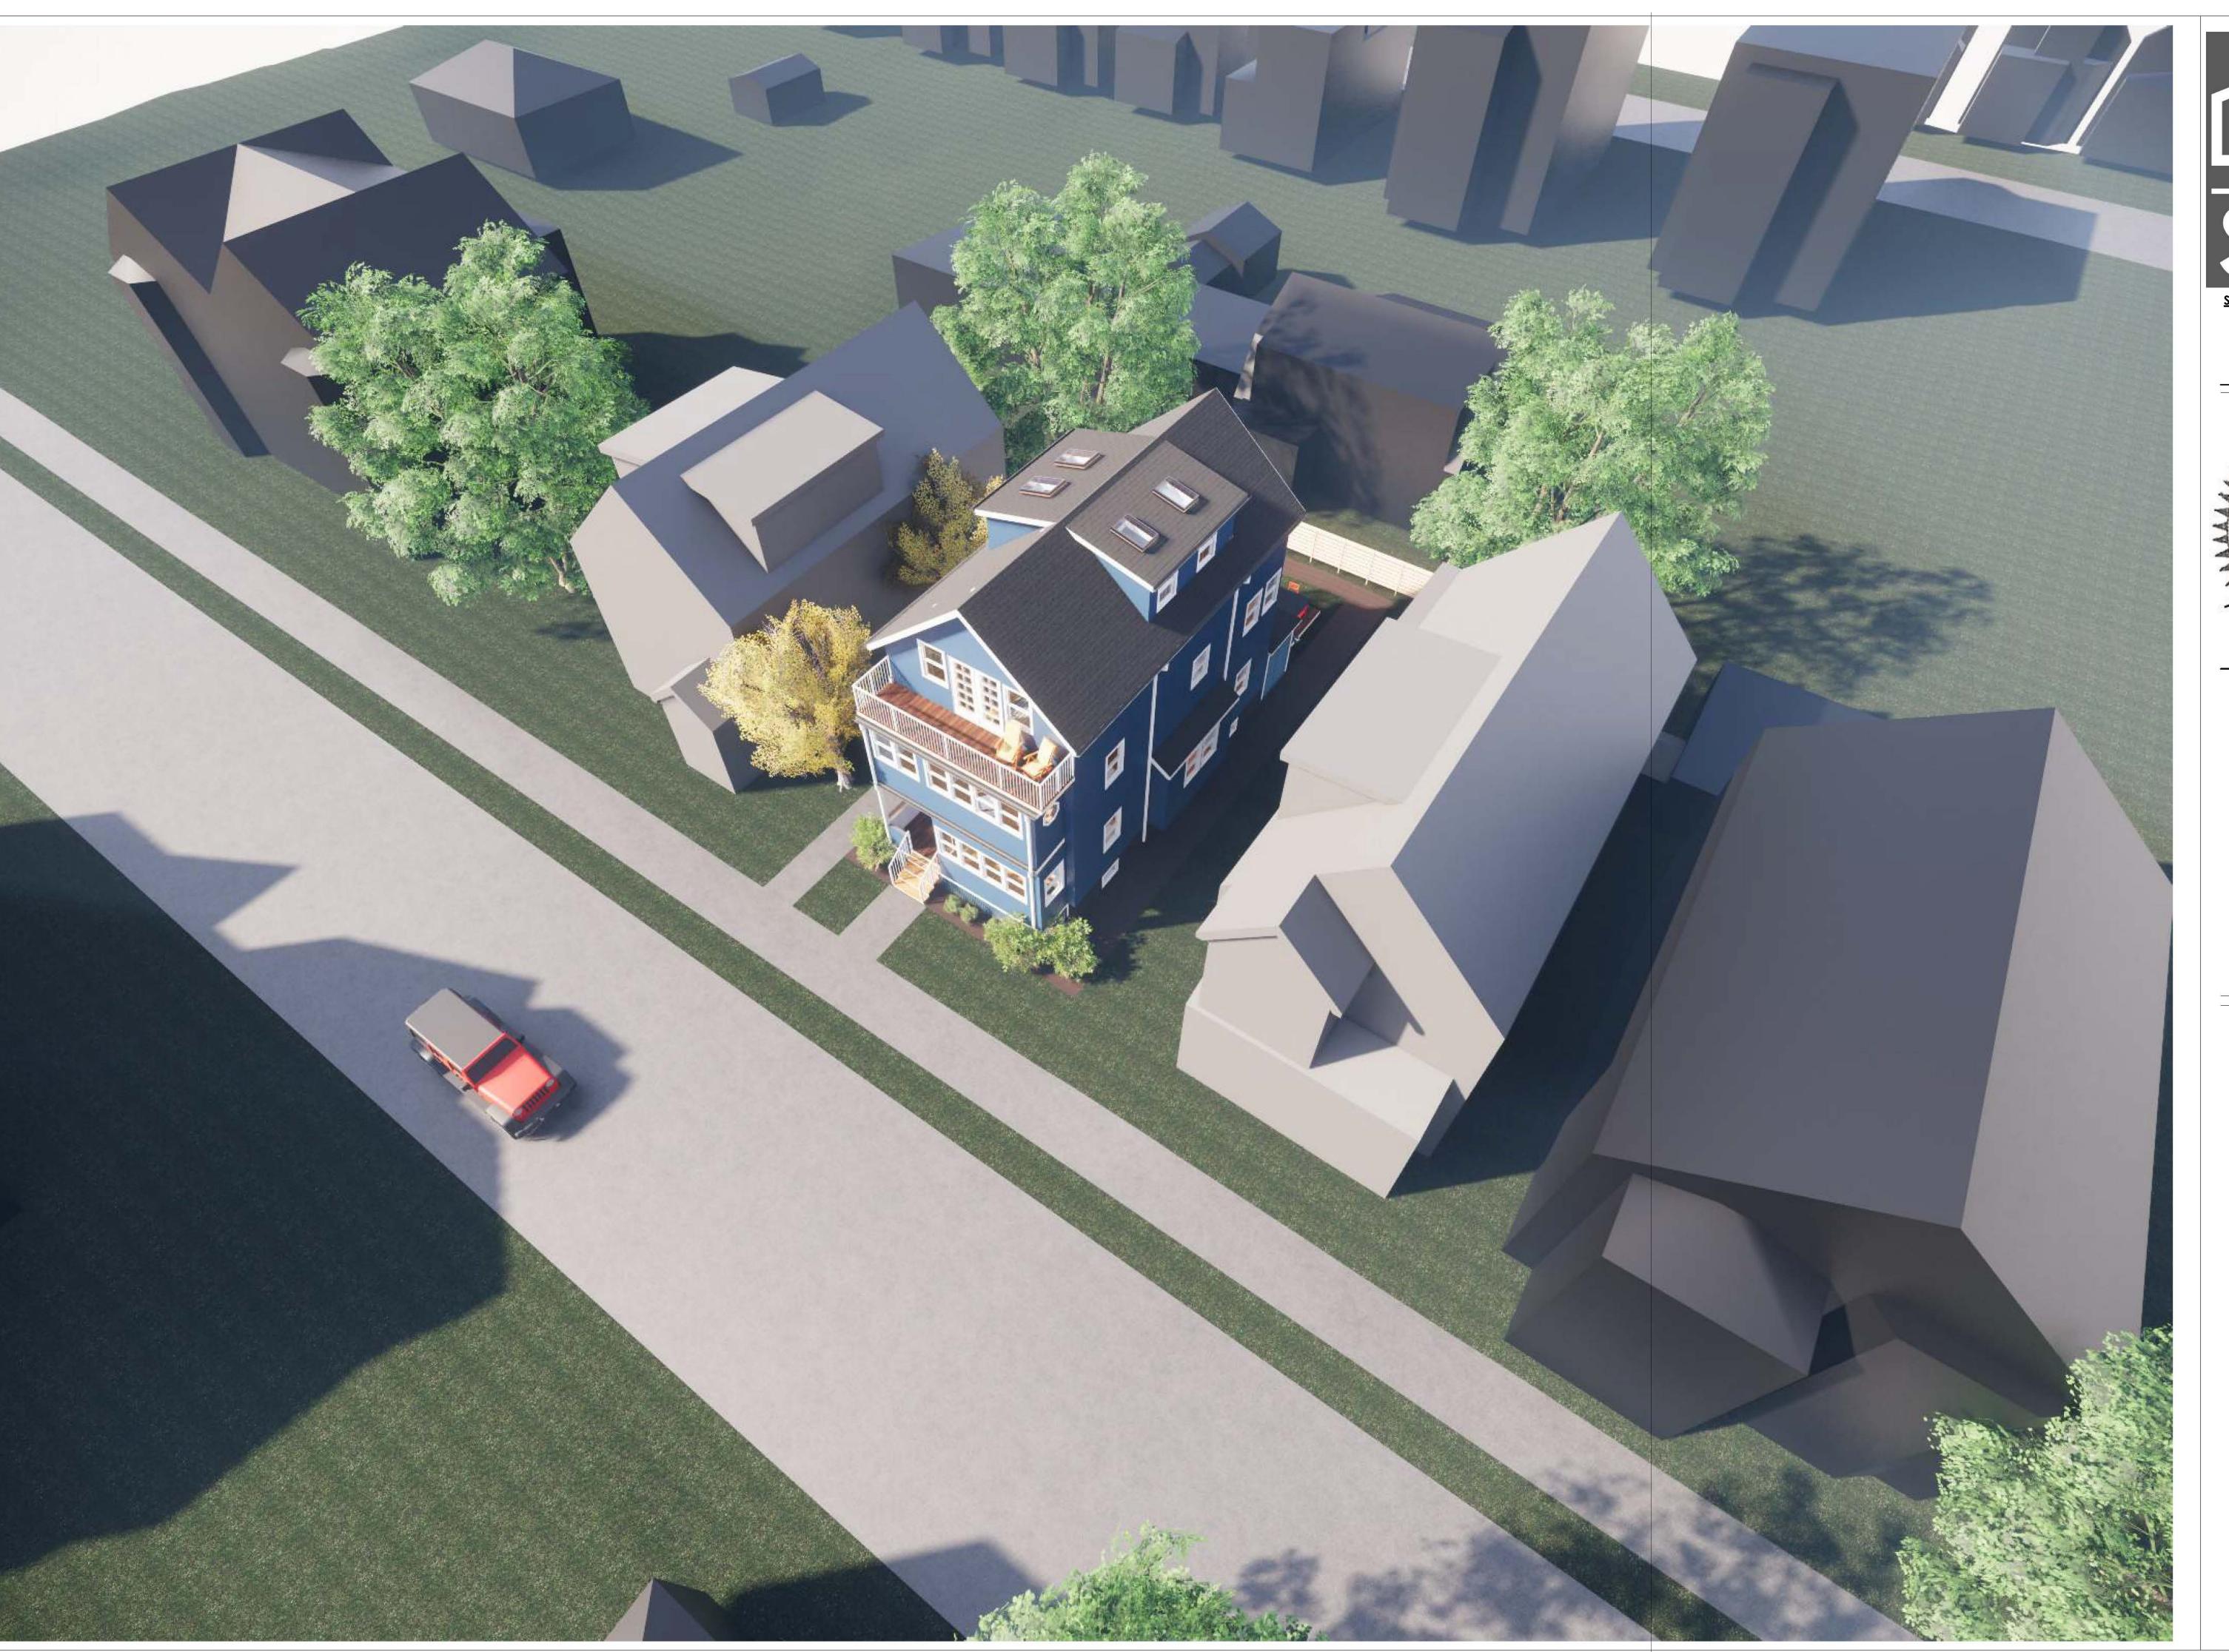62 CLAY ST. CAMBRIDGE MA 02140

Project Status BZA SUBMISSION SET Project number

Date

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Scale

1/4" = 1'-0"


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62 CL/ 02140

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SIRKIN RAMPAL JENNA

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Project Status BZA SUBMISSION SET 16.32 Project number Date 07/10/2019 Drawn by MNW Checker Checked by


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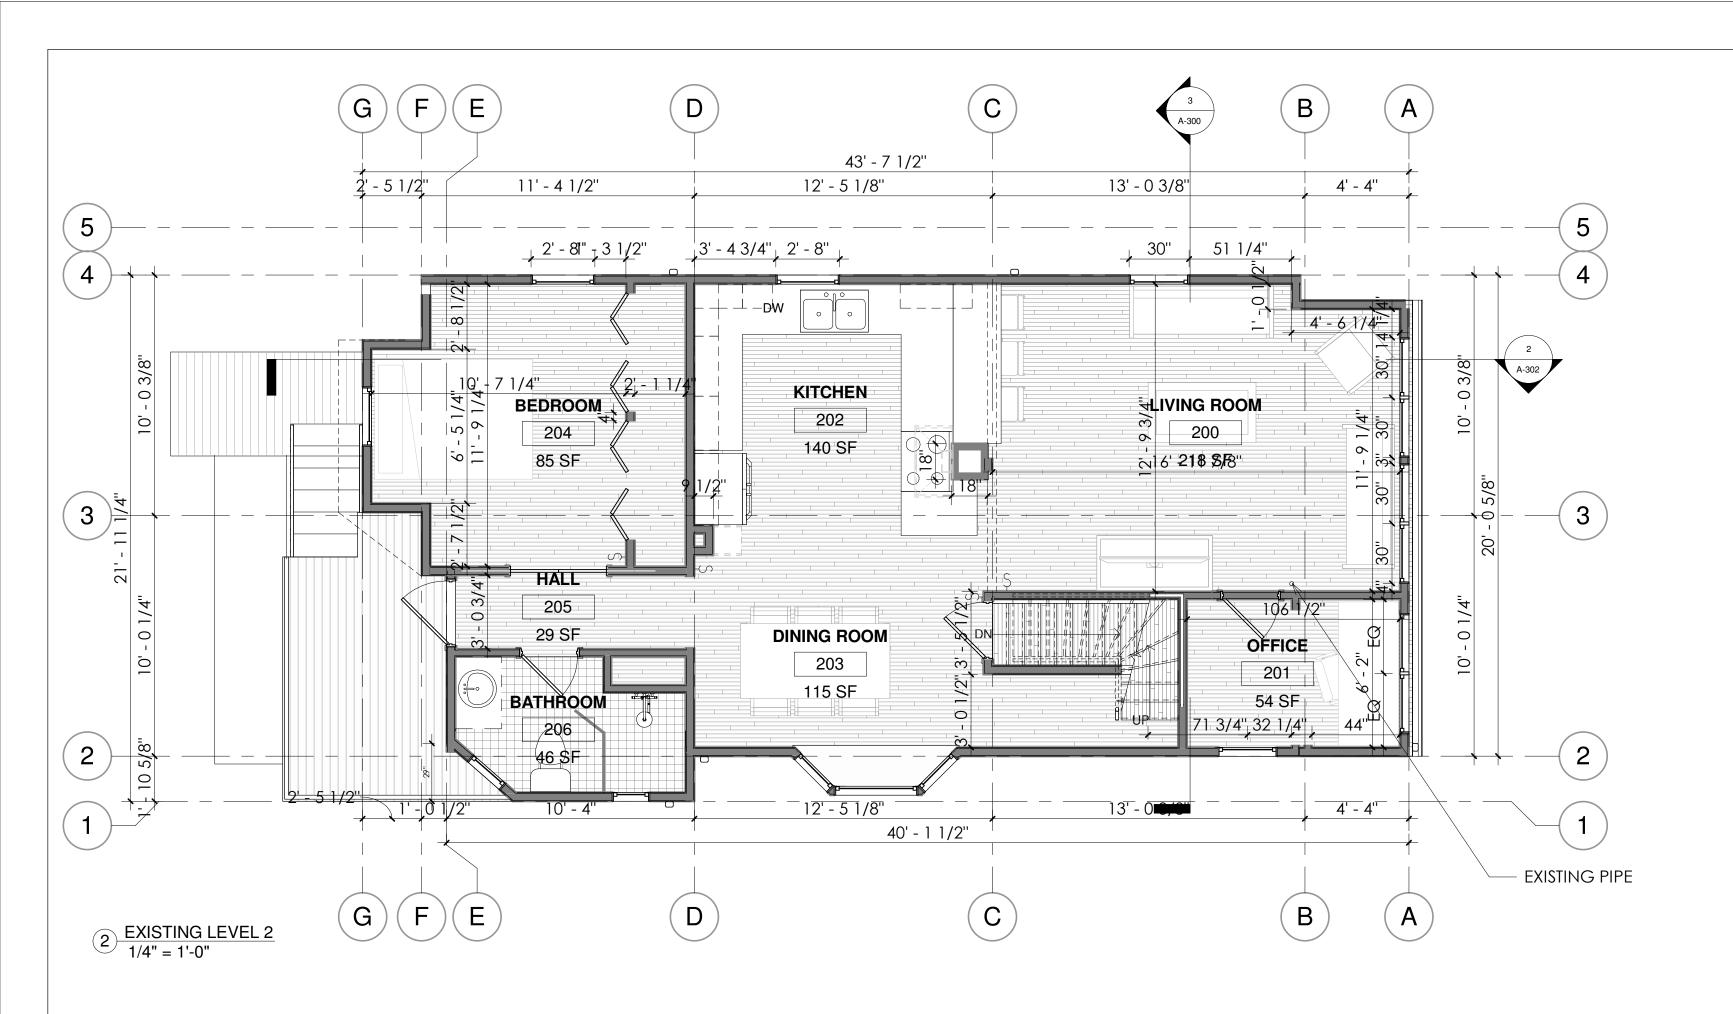
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62 CLAY 02140


Scale 1/4" = 1'-0"

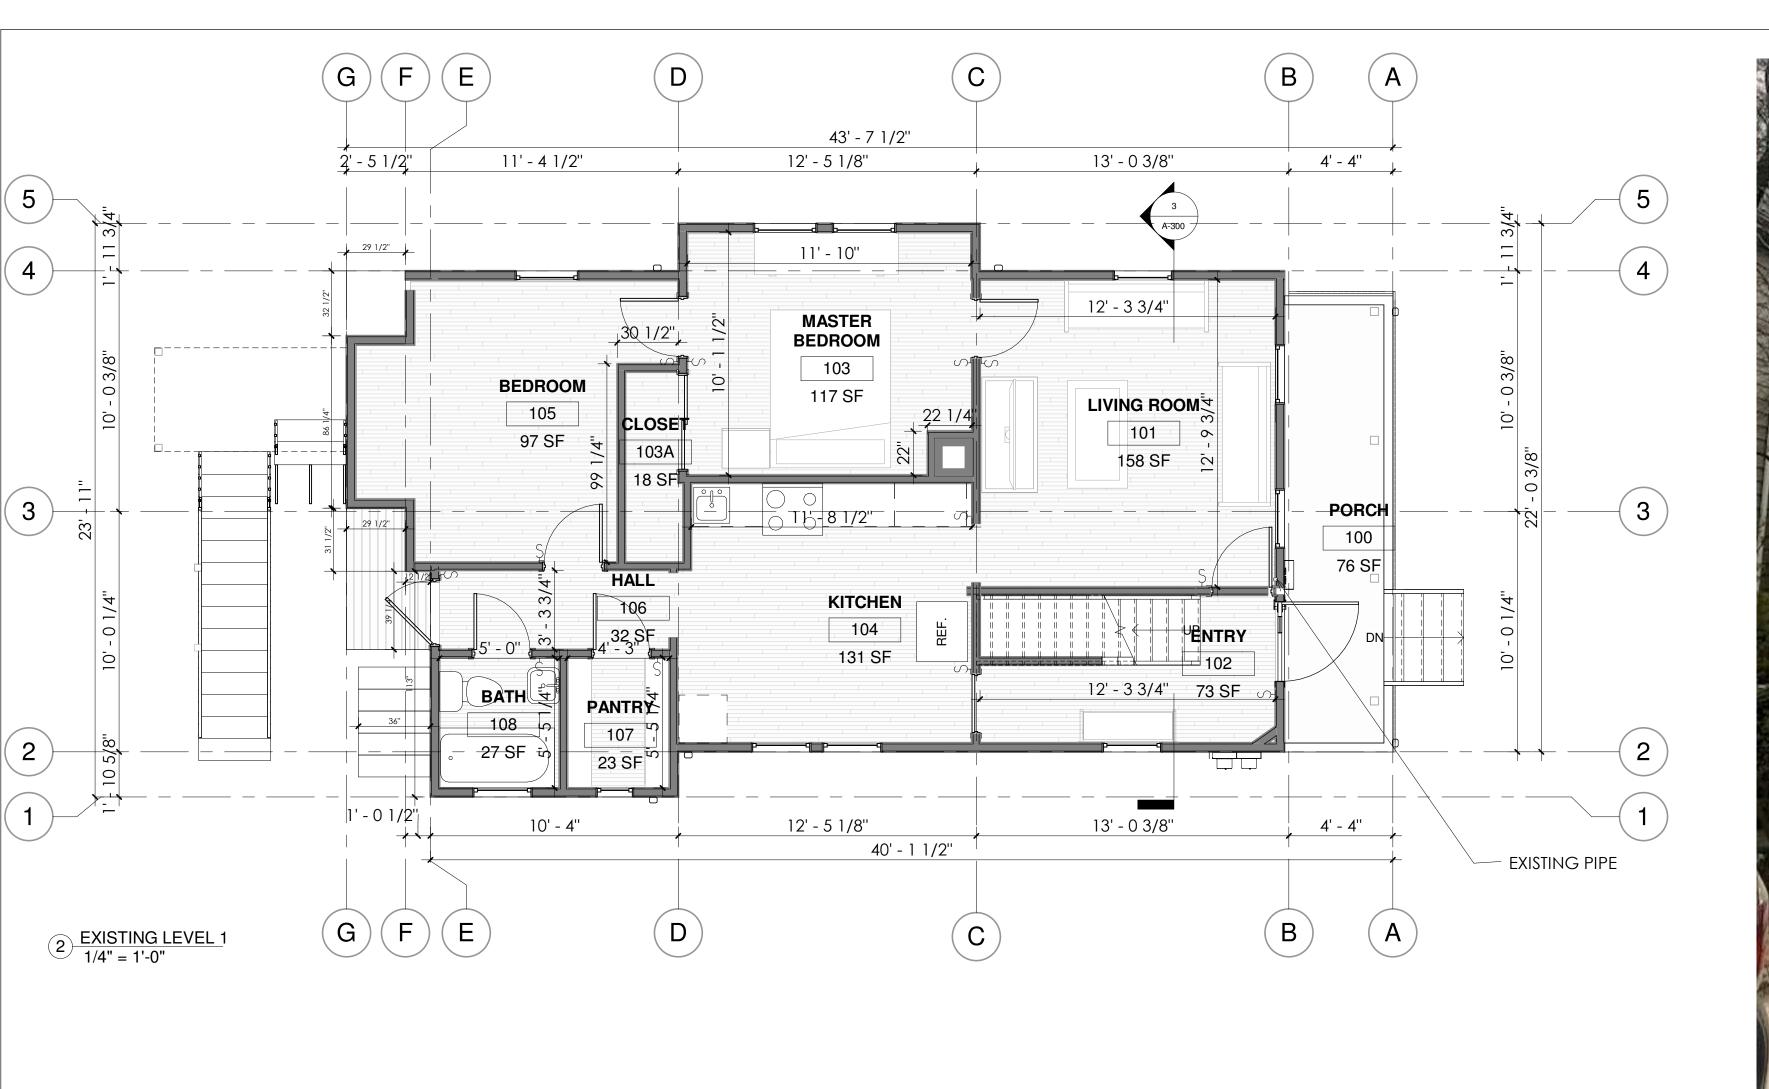





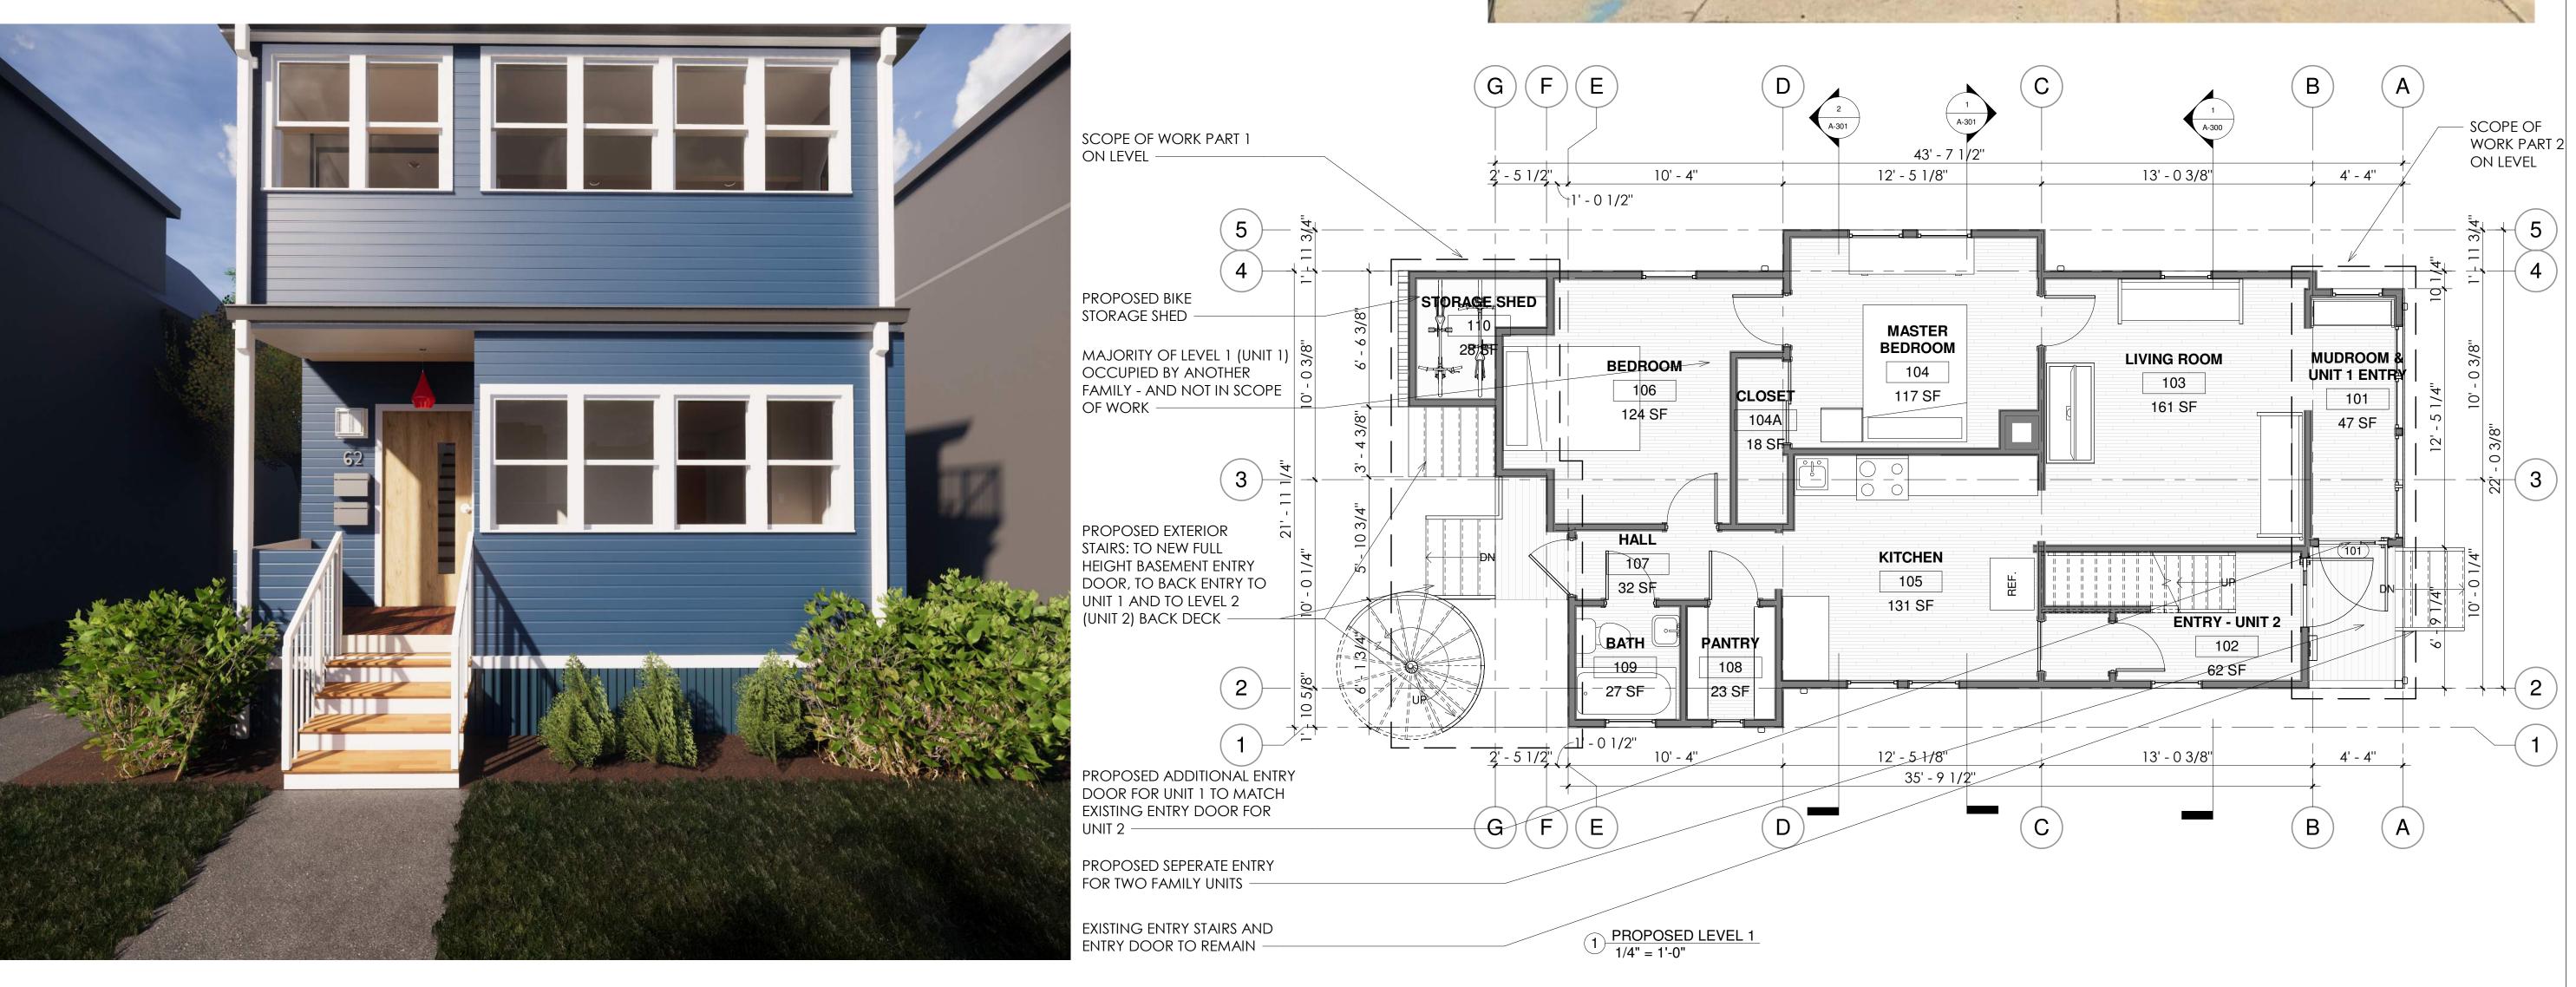

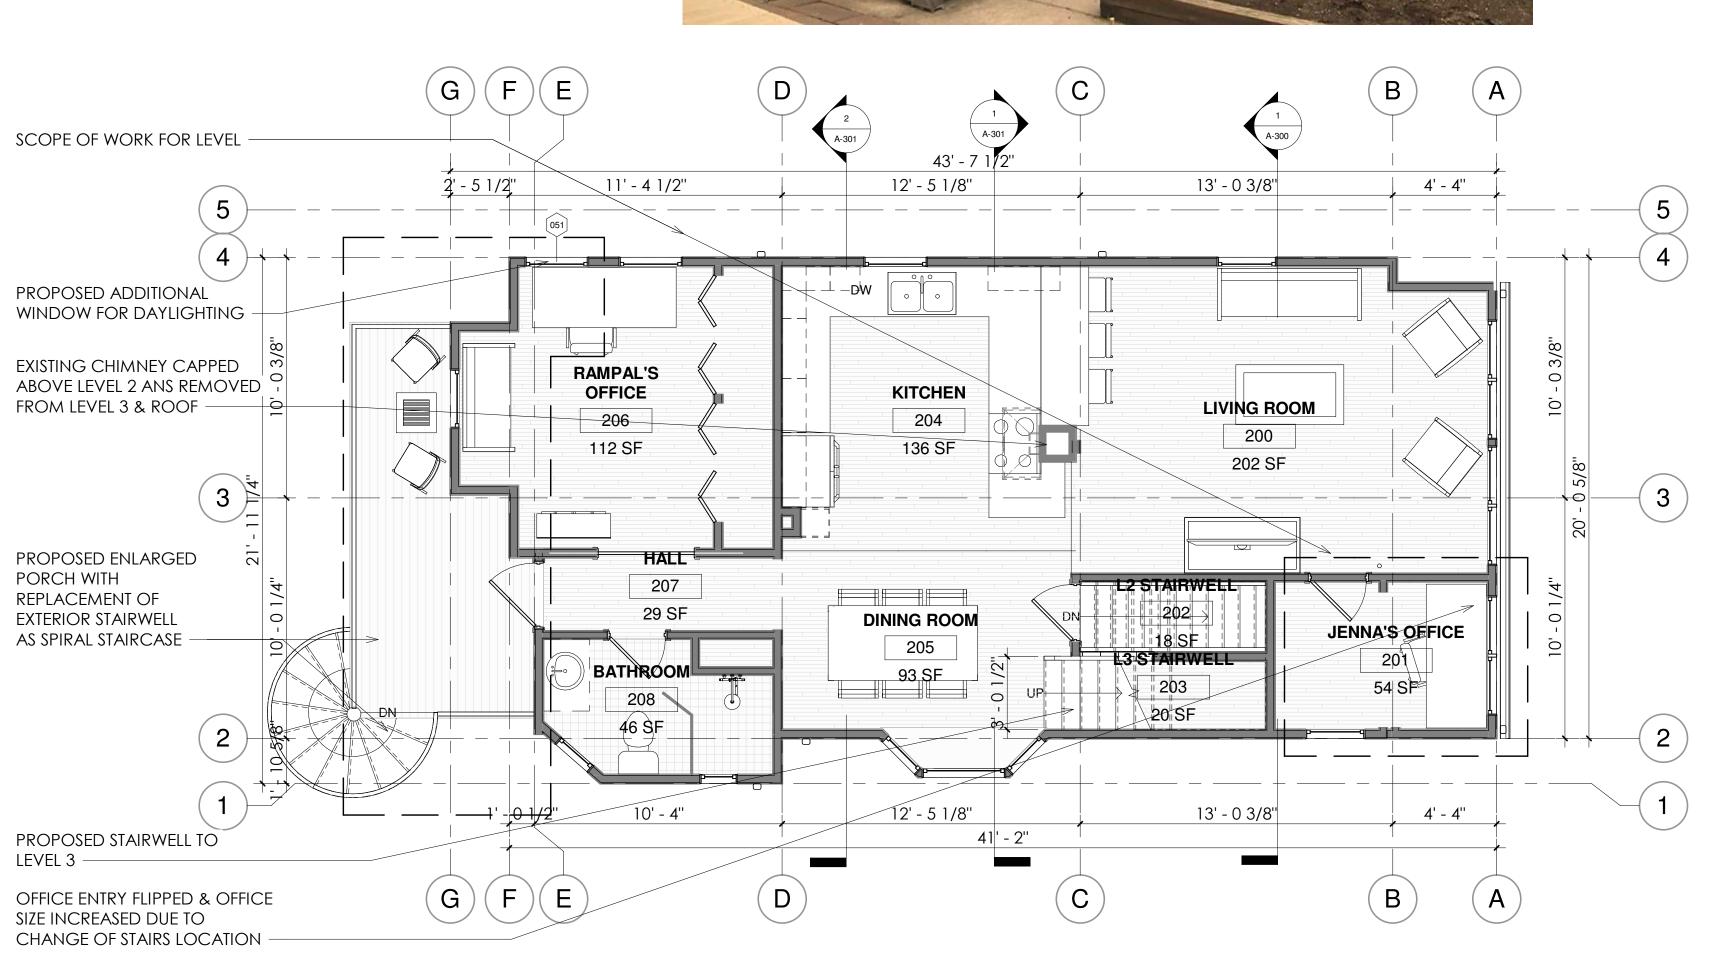

1) PROPOSED LEVEL 2 1/4" = 1'-0"

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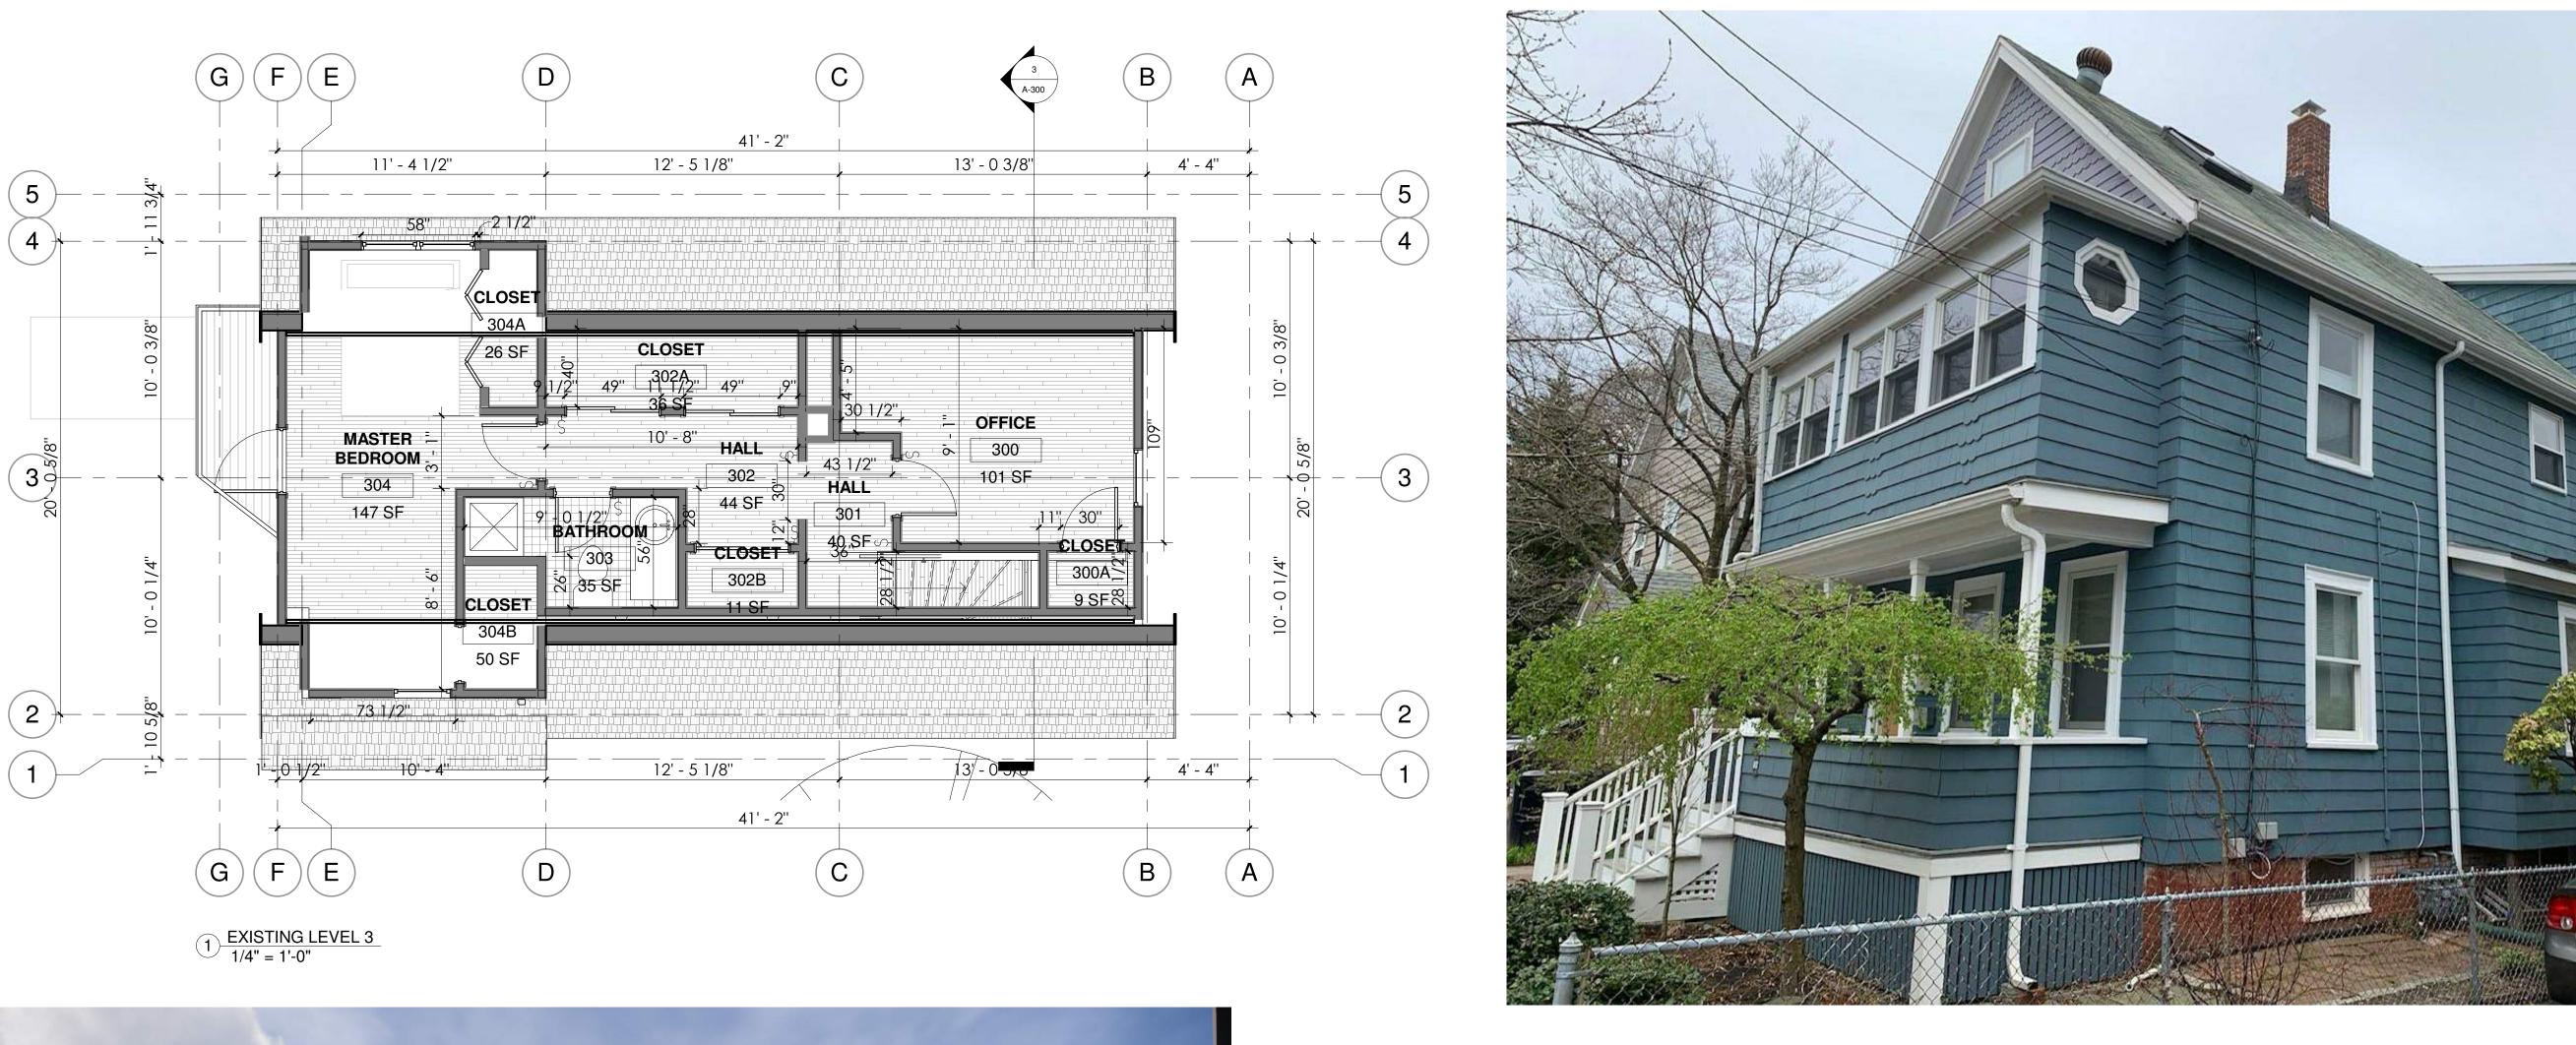
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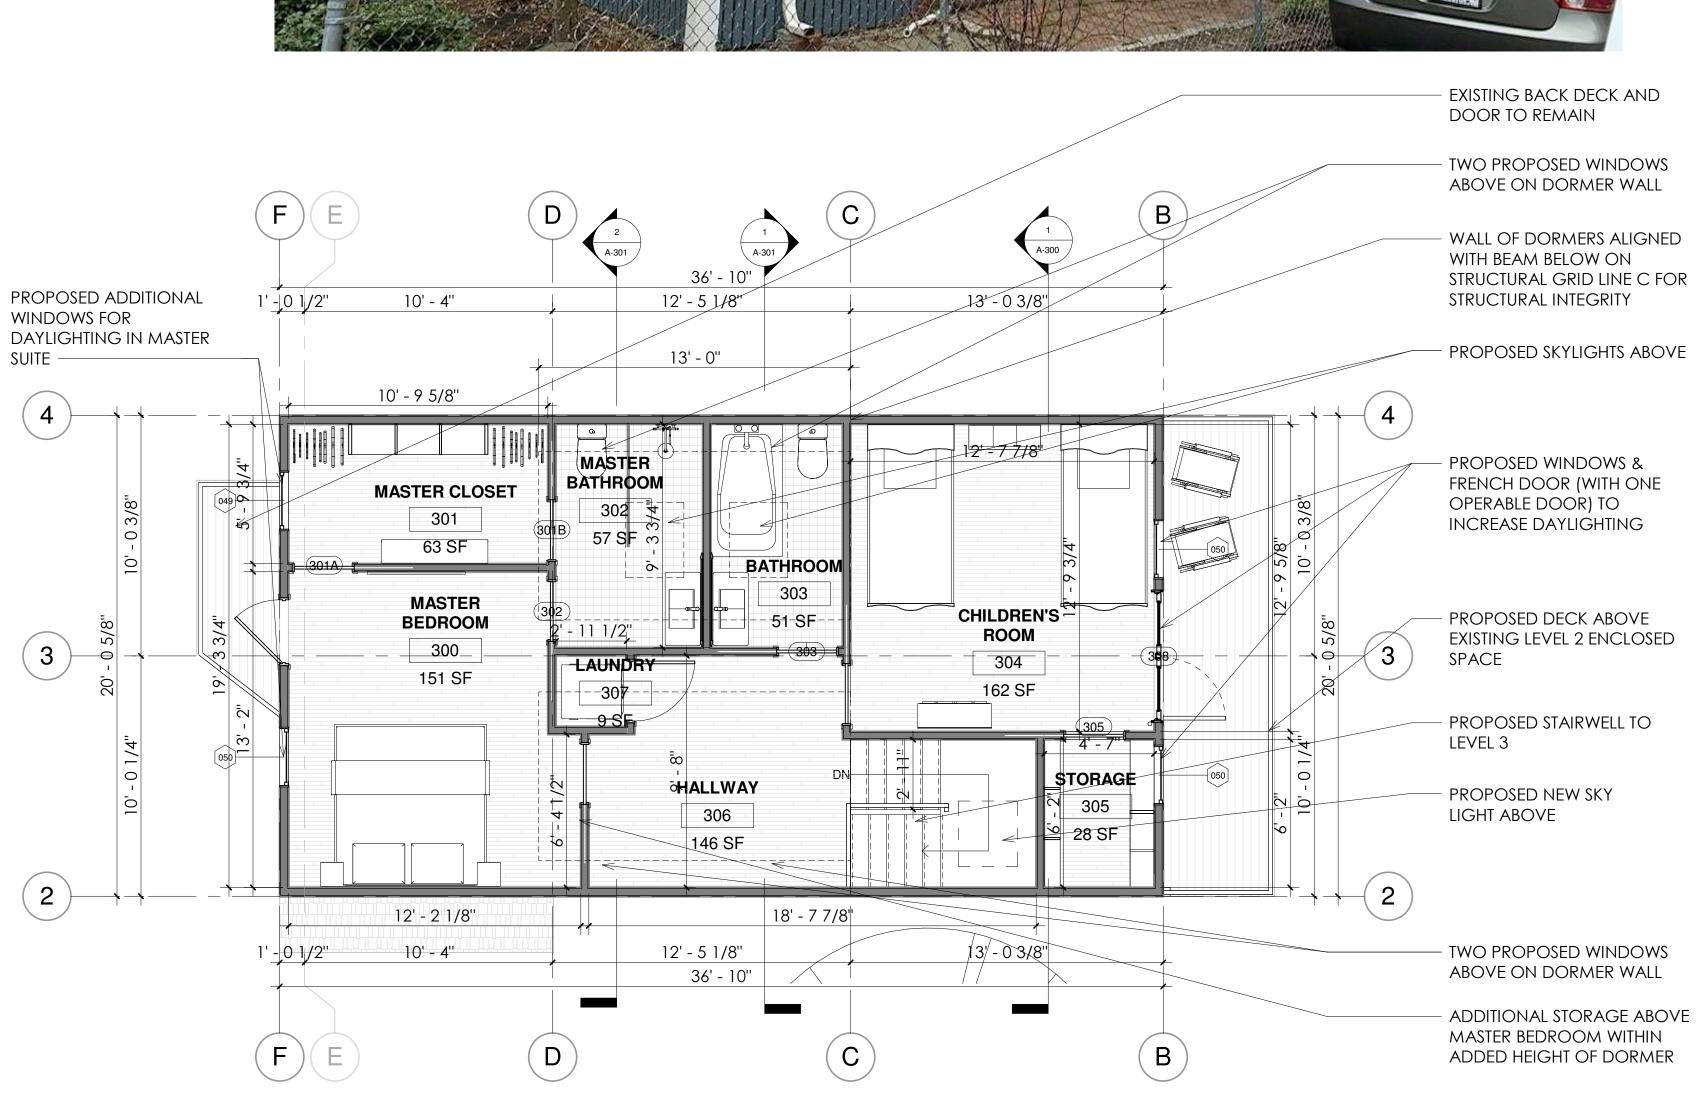
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A-102 1/4" = 1'-0"



2 PROPOSED LEVEL 3
1/4" = 1'-0"





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CAMBRIDGE MA, 02138

No. 31129
BOSTON
BOSTON
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ALTH OF MASSACH

3RD FLOOR PLAN

JENNA SIRKIN RAMPAL CHOPRA

SIRKIN/ CHOPRA RESIDENCE

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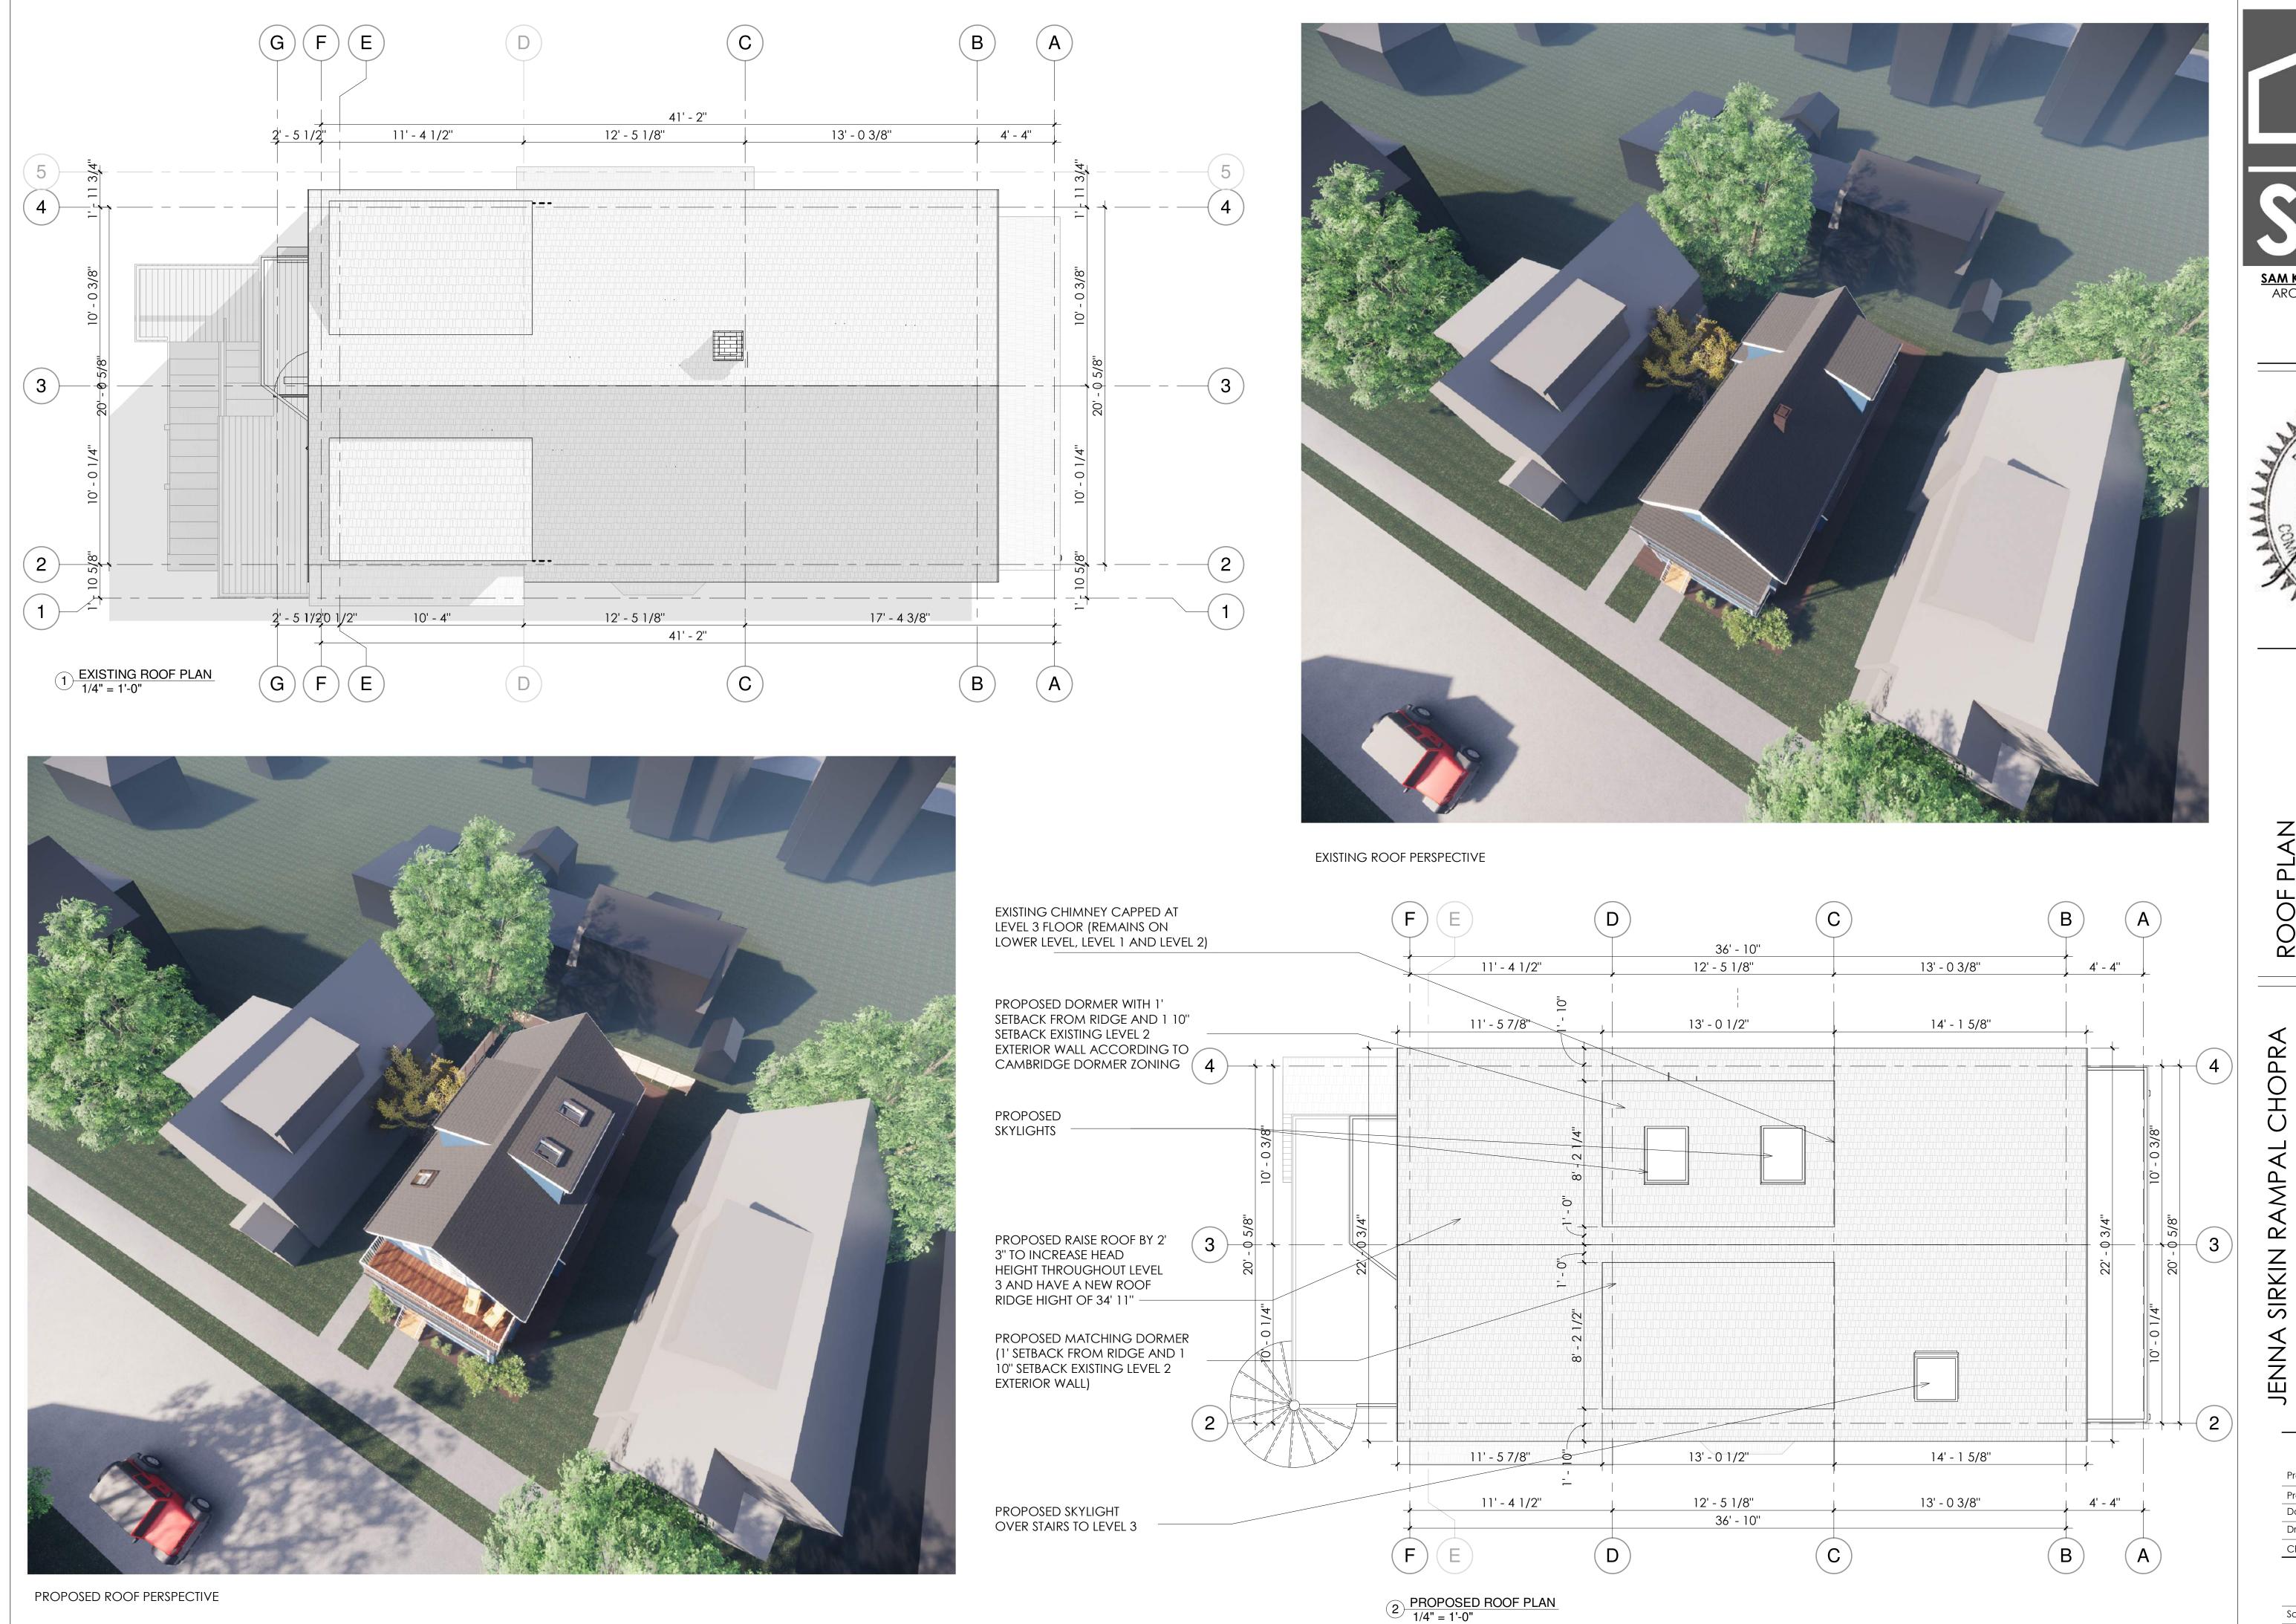
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Scale 1/4" = 1'-0"

16.32 07/10/2019 MNW Checker

1/4" = 1'-0"



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Scale

1/4" = 1'-0"

1 EAST ELEVATION - EXISTING 1/4" = 1'-0"







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SIRKIN RAMPAL

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Checked by A-200

Scale 1/4" = 1'-0"

2 EAST ELEVATION - PROPOSED 1/4" = 1'-0"

PROPOSED SKYLIGHTS FOR MAXIMUM DAYLIGHTING ON LEVEL 3

ROOF RAISED BY 2' 3" AND SLOPE

PROPOSED MATCHING DORMERS
ALIGNED WITH STRUCTURAL BEAM
EXISTING ON LEVEL TWO AND
ADHERING TO CAMBRIDGE
DORMER SETBACKS

PROPOSED FRENCH DOORS AND TWO WINDOWS TO

INCREASE DAYLIGHTING ON

PROPOSED DECK ON EXISTING LEVEL 2 ENCLOSED SPACE -

LEVEL 2 REMAINS AS EXISTING (ASIDE FROM NEW STAIRWELL TO

EXISTING ENTRY STAIRWELL AND

PROPOSED ADDITIONAL ENTRY Door for unit 1 - Seperates

REST OF FRONT PORCH PROPOSED

NEW ENCLOSURE FOR MUDROOM

FOR UNIT 1 WITH NEW WINDOWS

DOOR TO REMAIN

UNIT ENTRY -


DECREASED FROM 12"/12" TO 10"/12" TO MAXIMIZE LIVABLE SPACE ON LEVEL 3 FOR OWNER'S

FAMILY —

LEVEL 3 -

LEVEL 3) -

Checker

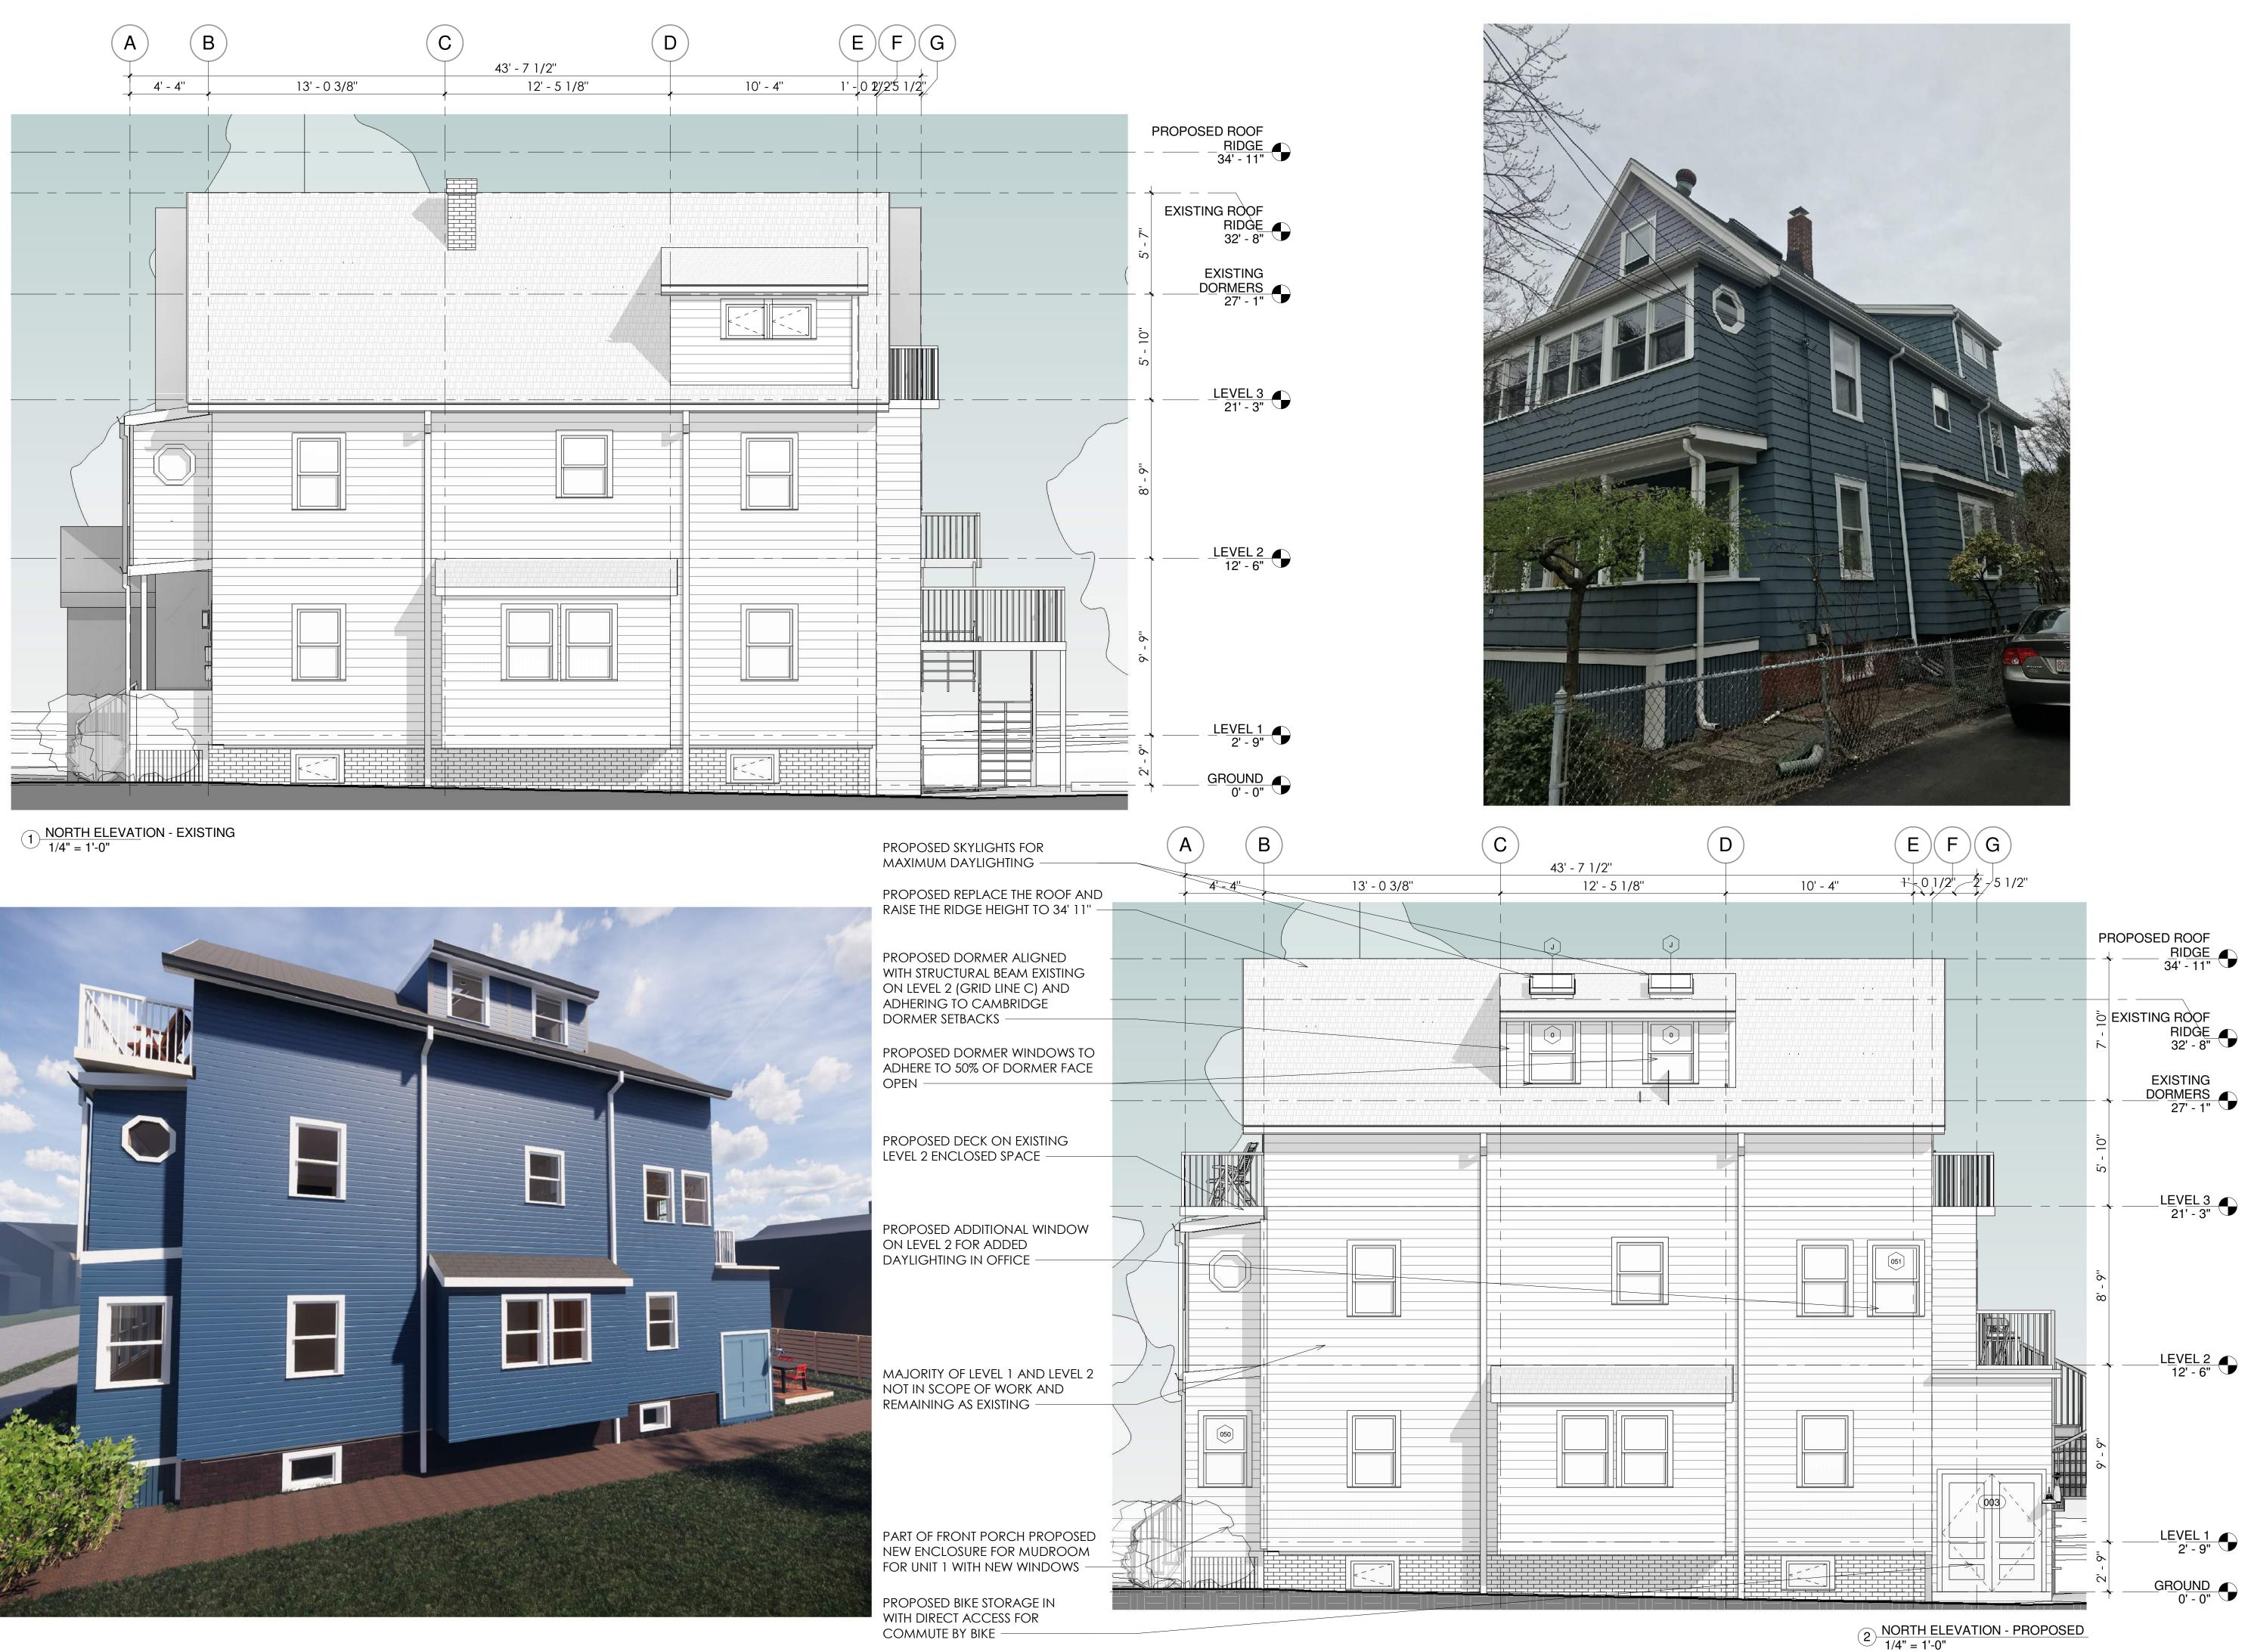



SIRKIN RAMPAL JENNA

RESIDENCE

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AMBRIDGE

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62 CLAY 02140

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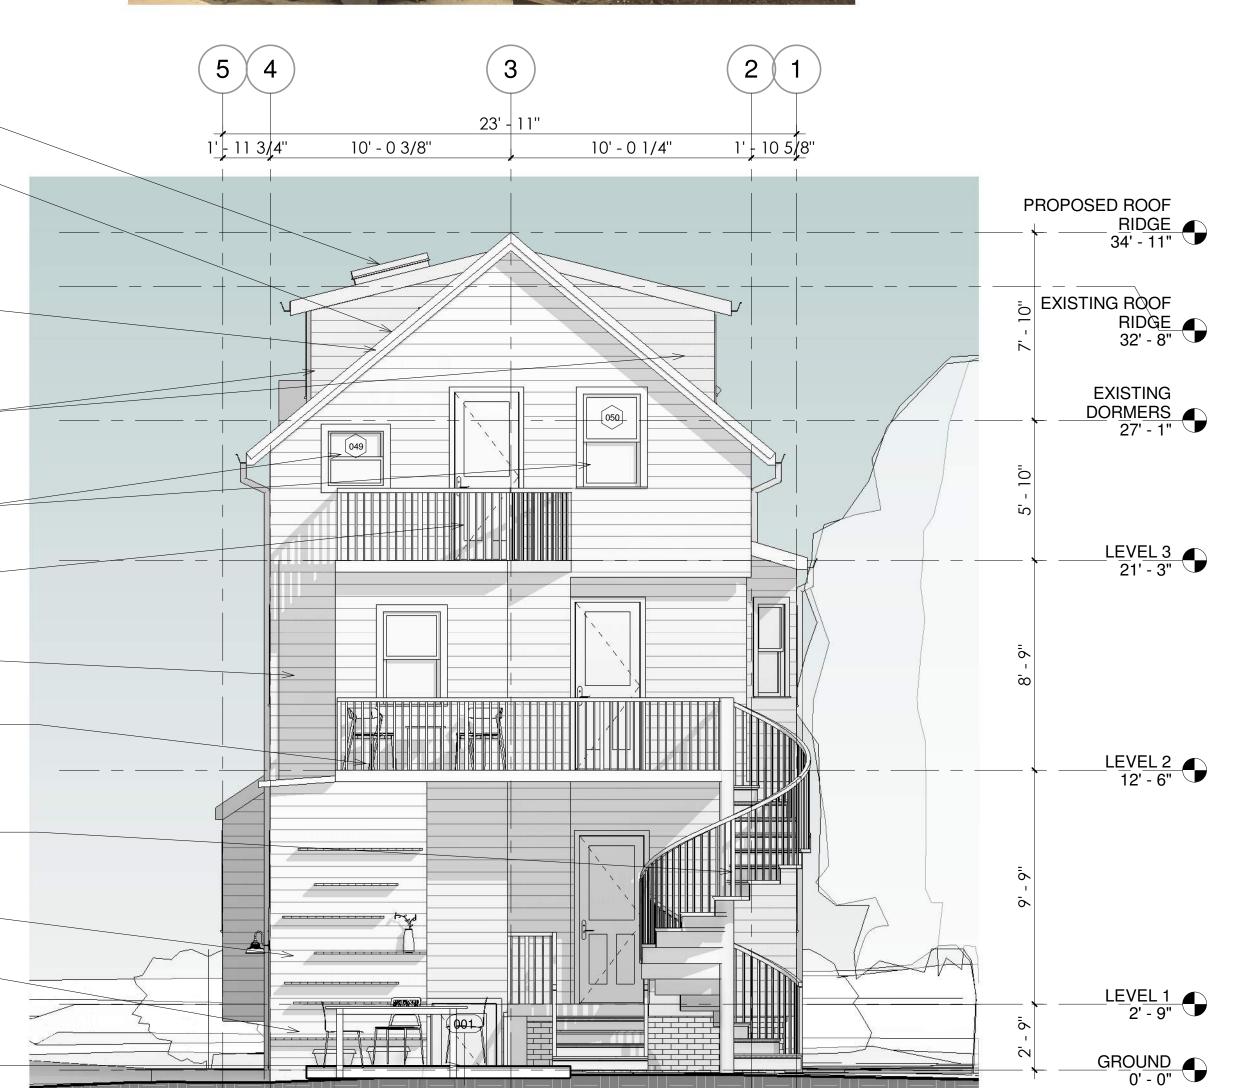
Scale 1/4" = 1'-0"

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SIRKIN JENNA

AMBRIDGE

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Checked by A-202

Scale 1/4" = 1'-0"

2 WEST ELEVATION - PROPOSED 1/4" = 1'-0"

PROPOSED SKYLIGHTS FOR MAXIMUM

PROPOSED REPLACE THE ROOF AND RAISE THE RIDGE HEIGHT TO 34' 11"

ROOF RAISED BY 2' 3" AND SLOPE

PROPOSED MATCHING DORMERS ALIGNED WITH STRUCTURAL BEAM

TO CAMBRIDGE DORMER SETBACKS

PROPOSED ADDITIONAL WINDOWS

MAJORITY OF LEVEL 1 AND LEVEL 2

LEVEL 2 DECK PROPOSED ENLARGE SIZE WITH

PROPOSED NEW SPIRAL STAIRCASE TO MINIMIZE STAIRS FOOTPRINT AND MAXIMIZE DECK SPACE

WITHIN EXISTING AND PROPOSED FAR

GARDEN STORAGE INCORPORATED

PROPOSED FULL HEIGHT ENTRY DOOR TO

LOWER LEVEL AND NEW EXTERIOR STAIRS -

INTO PROPOSED BIKE STORAGE -

EXTERIOR EXCAVATION NEEDED

NOT IN SCOPE OF WORK AND

REMOVAL OF EXISTING STAIRS -

PROPOSED BIKE STORAGE IN WITH DIRECT ACCESS FOR

COMMUTE BY BIKE -

REMAINING AS EXISTING

EXISTING LEVEL 3 DECK AND DOOR TO DECK TO REMAIN

ON LEVEL 3 FOR ADDED DAYLIGHTING

EXISTING ON LEVEL TWO AND ADHERING


DECREASED FROM 12"/12" TO 10"/12" TO MAXIMIZE LIVABLE SPACE ON LEVEL 3 FOR OWNER'S

FAMILY —

IN MASTER SUITE -

DAYLIGHTING ON LEVEL 3 -

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10' - 4''

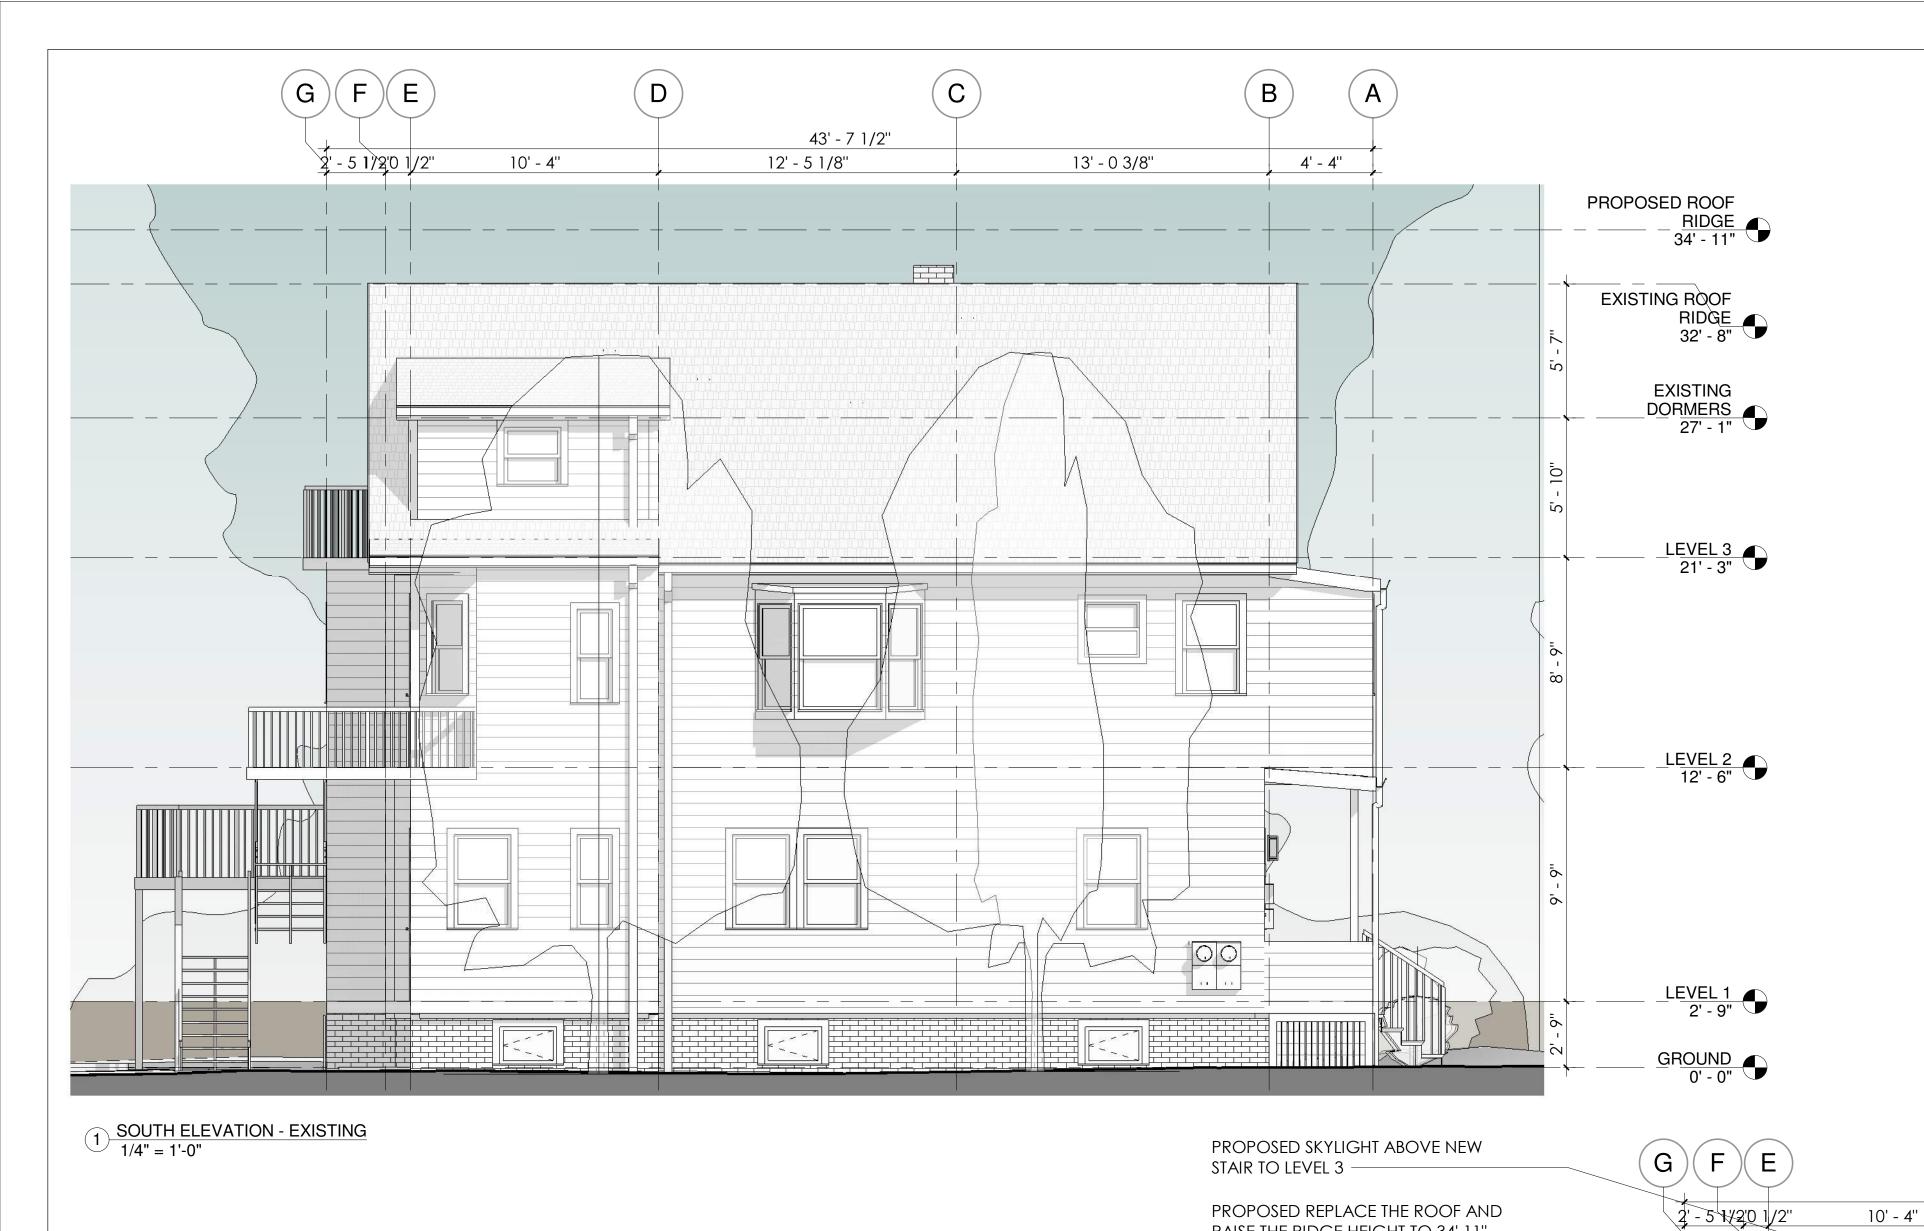PROPOSED DORMER WINDOWS TO ADHERE TO 50% OF DORMER FACE OPEN —

RAISE THE RIDGE HEIGHT TO 34' 11" -

PROPOSED DORMER ALIGNED

ON LEVEL 2 (GRID LINE C) AND ADHERING TO CAMBRIDGE

DORMER SETBACKS -

WITH STRUCTURAL BEAM EXISTING

LEVEL 3 DECK TO REMAIN AS EXISTING —

MAJORITY OF LEVEL 1 AND LEVEL 2 NOT IN SCOPE OF WORK AND REMAINING AS EXISTING

LEVEL 2 DECK PROPOSED ENLARGE SIZE WITH REMOVAL OF EXISTING STAIRS -

PROPOSED NEW SPIRAL STAIRCASE to minimize stairs footprint and MAXIMIZE DECK SPACE WITHIN EXISTING AND PROPOSED FAR

PROPOSED BIKE STORAGE IN BACK -

NEW ENCLOSURE FOR MUDROOM FOR UNIT 1 WITH NEW WINDOWS

EXISTING ENTRY STAIRWELL AND DOOR TO REMAIN

REST OF FRONT PORCH PROPOSED

PROPOSED ADDITIONAL ENTRY DOOR FOR UNIT 1 - SEPERATES UNIT ENTRY —

2 SOUTH ELEVATION - PROPOSED 1/4" = 1'-0"

SIRKIN RAMPAL JENNA

62 CL/ 02140

M

AMBRIDGE

ST.

Project Status BZA SUBMISSION SET Project number Date 07/10/2019 Drawn by MNW Checker Checked by

A-203 Scale 1/4" = 1'-0"







CLAY STREET EAST ELEVATION - EXISTING



CLAY STREET EAST ELEVATION - PROPOSED





Y STREET EI EVATION

IENNA SIRKIN RAMPAL CHOPRA

SIRKIN/ CHOPRA RESIDENCE

	Project Status	BZA SUBMISSION S
	Project number	16.
	Date	07/10/20
	Drawn by	MN
	Checked by	Check

A-204

ale







EXISTING 8 FRONT PER

JENNA SIRKIN RAMPAL CHOPRA

SIRKIN/ CHOPRA RESIDENCE

Project Status BZA SUBMISSION SET Project number

Date 16.32 07/10/2019 MNW Checker Drawn by

Checked by A-205

Scale

62 CLAY ST. CAMBRIDGE MA 02140







JENNA SIRKIN RAMPAL CHOPRA

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AMBRIDGE MA

62 CLAY ST. (02140

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Scale



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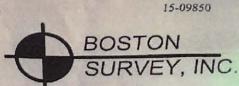
Scale

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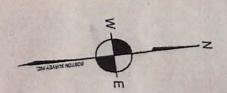
MORTGAGE INSPECTION PLAN


LOCATION: 62 CLAY STREET CITY, STATE: CAMBRIDGE, MA APPLICANT: RENE RAMPAL CHOPRA & JENNA RAUBE SIRKIN

CERTIFIED TO: GUARANTED RATE INC. SCALE: 1" = 20' PREPARED: NOV. 6,2015



P.O. BOX 290220 CHARLESTOWN, MA 02129 T (617) 242-1313; F (617) 242-1616 WWW.BOSTONSURVEYINC.COM



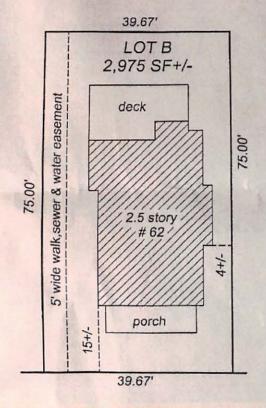

CLAY STREET

REFERENCES

DEED / REF: 63493 - 576 PLAN REF: 7753 - 160





CITY OF CAMBRIDGE **MASSACHUSETTS** BOARD OF ZONING APPLIES 831 MASSACHUSETTS AVENUE CAMBRIDGE, MA 02139 JUL 16 617 349-6100 CAMBRIDGE OF THE AM 11: 32

BZA APPLICATION FORM

Plan No:

GENERAL INFORMATION

The under	signed hereby pe	titions the Boa	rd of Zoning Appea	I for the	followi	ing:
Special Pe	rmit:√	_	Variance :	√		Appeal:
PETITIONE	ER: Jenna	Taube Sirki	n & Rene Rampa	1 Chop	ra	
PETITIONE	ER'S ADDRESS :	62 Cla	y St. Cambridge	e, MA ()2140	
I OCATION	OF PROPERTY:	62 Clay	St Cambridge,	MA		
				DATES!		Desidence D Zene
TYPE OF C	OCCUPANCY:	-		20	NING L	DISTRICT: Residence B Zone
REASON F	OR PETITION:					
	Dor	mer				
DESCRIPT	ION OF PETITION	IER'S PROPOS	SAL:			
Petition	er requests	ariance re	lief to constru	uct a c	dormen	r partially within the side yard
setback	and increase	the floor	area ratio. Pet	titione	r rec	quests a special permit to add
windows	within the se	etback				
SECTIONS	OF ZONING ORD	DINANCE CITE	D:			
Article	5.000	Section	5.31 (Table of Dimensional Requirements).			
Article	8.000	Section	8.22.2.C (Non-Conforming Structure).			
Article	10.000	Section	10.30 (Variance	ce).		
Article	10.000	Section	10.40 (Special	L Permi	t).	
					1	$(I \cup I)$
					1/4	
					1	
			Original Signature	(s):		
			ong	/		(Petitioner(s) / Owner)
					Jenna -	Taube Sirkin & Rene Rampal Chopra
						(Print Name)
			Addre	ess:	62 Cla	ry St. #2
					200 200 2	idge, MA 02140
			Tel. N	lo. :	617-89	95-8580
				I Addres	s:	jenna.sirkin@gmail.com
Date: 7	-16-19		≟-wai			