

# **CITY OF CAMBRIDGE**

**BOARD OF ZONING APPEAL** 

2021 APR -9 AM 10:57
CATTERIOR THE CITY OF THE CHUSENTS 831 Massachusetts Avenue, Cambridge MA 02139

617-349-6100

# **BZA Application Form**

**BZA Number: 113723** 

Date: 4.8-21

### **General Information**

The undersigned	hereby petitions the Board of Zoning	Appeal for the following:
Special Permit: _	Variance:X	Appeal:
	auren Stewart C/O James Sullivan (r ADDRESS: 63 Orchard st, cambridge	· · · · · · · · · · · · · · · · · · ·
LOCATION OF P	ROPERTY: 63 Orchard St , Cambri	idge, MA
TYPE OF OCCUI	PANCY: Residential single family	ZONING DISTRICT: Residence B Zone
REASON FOR P	ETITION:	
/Additions/		
DESCRIPTION O	F PETITIONER'S PROPOSAL:	
Construct a 5' X 1	19' 7" 1 story addition which will push	us over FAR
SECTIONS OF Z	ONING ORDINANCE CITED:	
Article: 5.000 Article: 10.000	Section: 5.31 (Table of Dimensional Section: 10.30 (Variance).	l Requirements).
	Original Signature(s):	(Petitioner (s) / Owner)
		<u>TAMES SUCIVAV</u> (Print Name)
	Address:	(=)

617 480 1312

jim@rjamesrenovations.com

Tel. No.

E-Mail Address:

## BZA APPLICATION FORM - OWNERSHIP INFORMATION

To be completed by OWNER, signed before a notary and returned to The Secretary of the Board of Zoning Appeals.

I/We Lauren Stewart
(OWNER)
I/We Lauren Stewart  (OWNER)  Address: 63 Orchard St, Cambridge MPS 02140
State that I/We own the property located at 63 Orchard St.,
which is the subject of this zoning application.
The record title of this property is in the name of Lawer
stewart + Ben vigoda
*Pursuant to a deed of duly recorded in the date 10 31 19, Middlesex South
County Registry of Deeds at Book 73576, Page 244; or
Middlesex Registry District of Land Court, Certificate No
BookPage
SIGNATURE BY LAND OWNER OR AUTHORIZED TRUSTEE, OFFICER OR AGENT*  *Written evidence of Agent's standing to represent petitioner may be requested.
Commonwealth of Massachusetts, County of Middlesex
The above-name large Specially appeared before me,
this <u>Hard</u> , 20 <u>21</u> , and made oath that the above statement is true.
Notary
My commission expires Ag_ 1 2825 (Notary Seal) JASON V CIMONS Notary Public Commission of Massachusetts of Commission August 05, 2027

• If ownership is not shown in recorded deed, e.g. if by court order, recent deed, or inheritance, please include documentation.

Frances Stomans.

63 or hard st. combridge ma oztro -- 68 onchard St.

stewart t Ben vigoda

10 31 19 24+

fearing of

#### SUPPORTING STATEMENT FOR A VARIANCE

# EACH OF THE FOLLOWING REQUIREMENTS FOR A VARIANCE MUST BE ESTABLISHED AND SET FORTH IN COMPLETE DETAIL BY THE APPLICANT IN ACCORDANCE WITH MGL 40A, SECTION 10.

A) A literal enforcement of the provisions of this Ordinance would involve a substantial hardship, financial or otherwise, to the petitioner or appellant for the following reasons:

First floor addition needed for 1/2 bathroom and entry closet. No room for it in design/layouts of existing footprint. This is owners primary residence and goal is to create a functional first floor plan which includes 1/2 bath and entry closet.

The hardship is owing to the following circumstances relating to the soil conditions, shape or topography of such land or structures and especially affecting such land or structures by not affecting generally the zoning district in which it is located for the following reasons:

We are asking for .01 more FAR which we believe is minimal and not affecting any setbacks which would affect direct neighbors or take away in a negative way from the neighborhood.

## C) DESIRABLE RELIEF MAY BE GRANTED WITHOUT EITHER:

1) Desirable relief may be granted without substantial detriment to the public good for the following reasons:

Architecturally addition will blend in with house and neighborhood creating a seamless design. We care about house and neighborhoods history.

2) Desirable relief may be granted without nullifying or substantially derogating from the intent or purpose of this Ordinance for the following reasons:

All details from original house will be replicated, scale is appropriate to original house and neighborhood, Goal is to have a seamless design that looks like has been there for 100+ years.

\*If you have any questions as to whether you can establish all of the applicable legal requirements, you should consult with an attorney.

#### **BZA Application Form**

#### **DIMENSIONAL INFORMATION**

Applicant: Lauren Stewart Present Use/Occupancy: Residential single family

**Location:** 63 Orchard st **Zone:** Residence B Zone

Phone: 617 480 1312 Reguested Use/Occupancy: Residential single family

		Existing Conditions	Requested Conditions	<u>Ordinance</u> <u>Requirements</u>	
TOTAL GROSS FLOOR AREA:		2860	2956	68.5	(max.)
LOT AREA: RATIO OF GROSS		5775	0	0	(min.)
FLOOR AREA TO LOT AREA: 2		0.495	0.51	.01	
LOT AREA OF EACH	<b>i</b>	N/A	N/A	N/A	
SIZE OF LOT:	WIDTH	58	N/A	N/A	
	DEPTH	99.88	N/A	N/A	
SETBACKS IN FEET	FRONT	N/A	N/A	N/A	
	REAR	N/A	N/A	N/A	
	LEFT SIDE	N/A	N/A	N/A	
	RIGHT SIDE	N/A	N/A	N/A	
SIZE OF BUILDING:	HEIGHT	N/A	N/A	N/A	
	WIDTH	N/A	N/A	N/A	
RATIO OF USABLE OPEN SPACE TO LOT AREA:		N/A	N/A	N/A	
NO. OF DWELLING UNITS:		N/A	N/A	N/A	
NO. OF PARKING SPACES:		N/A	N/A	N/A	
NO. OF LOADING AREAS:		N/A	N/A	N/A	
DISTANCE TO NEAREST BLDG. ON SAME LOT		N/A	N/A	N/A	

Describe where applicable, other occupancies on the same lot, the size of adjacent buildings on same lot, and type of construction proposed, e.g; wood frame, concrete, brick, steel, etc.

- 1. SEE CAMBRIDGE ZONING ORDINANCE ARTICLE 5.000, SECTION 5.30 (DISTRICT OF DIMENSIONAL REGULATIONS).
- 2. TOTAL GROSS FLOOR AREA (INCLUDING BASEMENT 7'-0" IN HEIGHT AND ATTIC AREAS GREATER THAN 5') DIVIDED BY LOT AREA.
- 3. OPEN SPACE SHALL NOT INCLUDE PARKING AREAS, WALKWAYS OR DRIVEWAYS AND SHALL HAVE A MINIMUM DIMENSION OF 15'.

## Pacheco, Maria

From:

Levy, Sharon <Sharon.Levy@childrens.harvard.edu>

Sent:

Thursday, May 20, 2021 4:19 PM

To: Subject: Pacheco, Maria Zoning variance

Dear Maria,

This note is in SUPPORT of the zoning variance requested by Lauren Stewart at 63 Orchard Street in Cambridge, MA. I own the house next door, at 65 Orchard Street. I have no questions or concerns about the request and I believe it will be a wonderful addition to the house.

Please don't hesitate to contact me at this email address if I can be of further assistance.

Sincerely,

Sharon Levy

Sharon Levy, MD, MPH Director, Adolescent Substance Use and Addiction Program Boston Children's Hospital

Associate Professor of Pediatrics Harvard Medical School



# City of Cambridge

MASSACHUSETTS

BOARD OF ZONING APPEAL

831 Mass Avenue, Cambridge, MA. (617) 349-6100

# BZA

# POSTING NOTICE - PICK UP SHEET

The undersigned picked up the notice board for the Board of Zoning Appeals Hearing.

Name: Tored Batchelder Date	te: 5-10 21
Address: 63 Mchard St.	•
Case No. BZA - 1/3723	
Hearing Date: $\frac{5}{\sqrt{27/2}}$	

Thank you, Bza Members

### **BZA Application Form**

#### DIMENSIONAL INFORMATION

Applicant: Lauren Stewart

Present Use/Occupancy:

Residential single family

Location: 63 Orchard st

Zone:

Residence B Zone

Phone: 617 480 1312

Requested Use/Occupancy:


Residential single family

	Existing Conditions	Requested Conditions	Ordinance Requirements
TOTAL GROSS FLOOR AREA:	2860	2956	68.5 2887.5 (max.) NB
LOT AREA:	5775	0 5775	0 5000 (min.)
RATIO OF GROSS FLOOR AREA TO LOT AREA: 2	0.495	0.51	D+15
LOT AREA OF EACH DWELLING UNIT	N/A 2606	N/A 2702	NIA 2500 min.
SIZE OF LOT: WIDTH DEPTH	58 <b>'</b> 99.88	N/A 58' N/A 99,88	NIA 50'
SETBACKS IN FEET; FRONT REAR	N/A 18'	N/A 22,5'	N/A 15' N/A 25'
LEFT	N/A 14.7'	N/A /3.6 '	NIA 7.5 SOM OF 20'
RIGHT	N/A 10,14	N/A 10.14	NIA 7.5 SUM OF 20"
SIZE OF BUILDING: HEIGHT WIDTH	N/A 34,9 N/A 32,61	N/A 34,9 N/A 33,61	N/A 35"
RATIO OF USABLE OPEN SPACE TO LOT AREA:	N/A 73.35%		N/A 40%
NO. OF DWELLING UNITS:	N/A /	N/A /	N/A 2.
NO. OF PARKING SPACES:	N/A 2	N/A Z	N/A
NO. OF LOADING AREAS:	NIA	(N/A)	N/A)
DISTANCE TO NEAREST BLDG. ON SAME LOT	N/A	N/A)	(N/A)

Describe where applicable, other occupancies on the same lot, the size of adjacent buildings on same lot, and type of construction proposed, e.g; wood frame, concrete, brick, steel, etc.

- 1. SEE CAMBRIDGE ZONING ORDINANCE ARTICLE 5.000, SECTION 5.30 (DISTRICT OF DIMENSIONAL REGULATIONS).
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  DIVIDED BY LOT AREA.
- OPEN SPACE SHALL NOT INCLUDE PARKING AREAS, WALKWAYS OR DRIVEWAYS AND SHALL HAVE A MINIMUM DIMENSION OF 15'.

**BZA Application Form** 

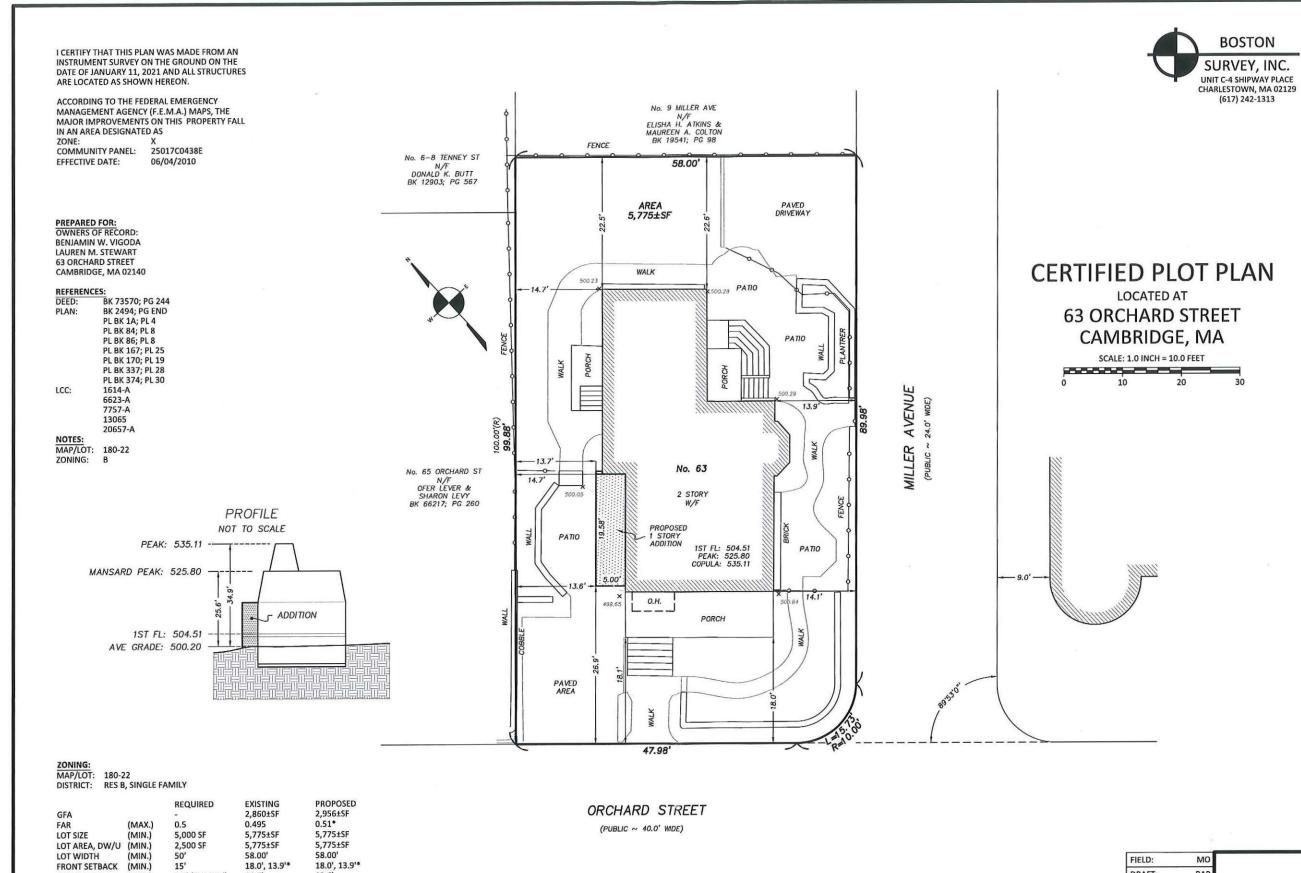

**BOSTON** 

DRAFT:

CHECK:

DATE: JOB#

RAP

GCC

03/30/21

20-00653

PVT. OP. SPACE (MIN) \* = NON-CONFORMING

(MIN.)

(MIN.)

(MAX.)

SIDE SETBACK REAR SETBACK

HEIGHT

18.0', 13.9'\*

14.7

22.51\*

34.9'

56.9%

7.5' (SUM 20')

25'

35'


40%

18.0', 13.9'\*

13.6'

22.5'\*

34.91

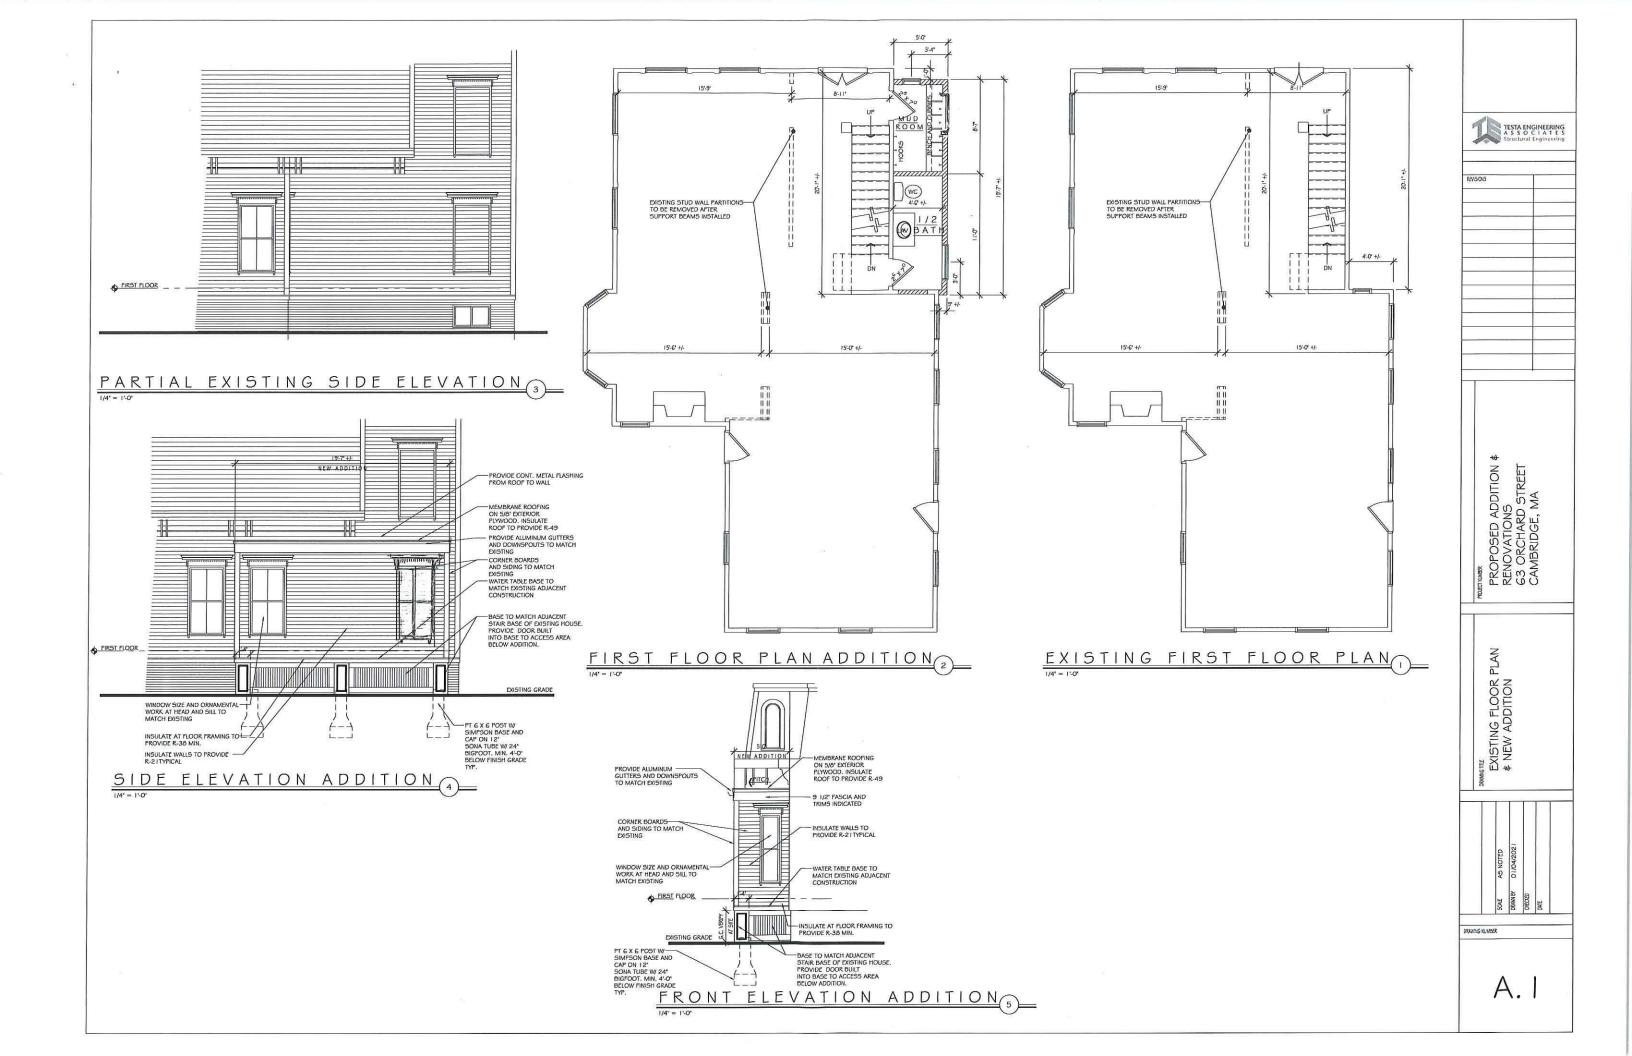

GENERAL NOTES: GENERAL

ALL MATERIALS, WORKMANSHIP AND DETAILS SHALL CONFORM TO THE 9TH EDITION OF THE MASSACHUSETTS RESIDENTIAL BUILDING

CODE AND THE REFERENCE STANDARDS INCLUDED THEREIN THA ARE APPLICABLE TO THIS PROJECT.

THE CONTRACTOR SHALL FAMILIARIZE HIMSELF WITH THE CONTRACT DRAWINGS ANY DISCREPANCIES SHALL BE BROUGHT TO THE ATTENTION OF THE PROJECT ARCHITECT PRIOR TO PROCEEDING WITH

THE AFFECTED WORK ANY VARIATIONS OR UTIONS OF MATERIALS OR DETAILS FROM THOSE INDICATED ON THE DRAWINGS MAY BE MADE ONLY WITH PRIOR APPROVAL OF THE PROJECT ARCHITECT.

SHOP DRAWINGS FOR STRUCTURAL STEEL SHALL BE SUBMITTED TO THE ARCHITECT AND A STAMPED APPROVAL RECEIVED BEFORE FABRICATION CAN PROCEED.

NO MAIN FRAMING OR STRUCTURAL MEMBERS ARE TO BE MODIFIED. ALTERED OR CUT WITHOUT THE APPROVAL OF THE PROJECT ARCHITECT

FOR EXACT LOCATION OF FLOOR & ROOF OPENINGS, SEE ARCHITECTURAL DRAWINGS. THE CONTRACTOR SHALL BE RESPONSIBLE FOR ALL JOB SAFETY DURING CONSTRUCTION INCLUDING BUT NOT LIMITED TO SHEETING, SHORING AND GUYING STRUCTURES, BARRIERS AND SIGNAGE.

ALL STRUCTURAL DRAWINGS SHALL BE USED IN CONJUNCTION WITH THE ARCHITECTURAL AND SHOP DRAWINGS

UNLESS OTHERWISE INDICATED, DETAILS SHOWN ON ANY DRAWING ARE TO BE CONSIDERED TYPICAL FOR ALL SIMILAR CONDITIONS.

ARE TO BE CONSIDERED THPICAL FOR ALL SMILLAR COMMINENS.

THE GENERAL CONTRACTOR SHALL BE RESPONDEDE FOR ALL CONSTRUCTION MEANS,
METHODS, CO-ORDINATION OF OTHER TRADES AND TECHNOLUSE TO
PRODUCE A SOUTH AND QUALITY BUILDING, ALL DIMENSIONS, ELEVATIONS
AND CONDITIONS MUST BE VERIFIED BY THE ORIENTAL CONTRACTOR OR RESPONSIBLE
TRADES PRIOR TO PRODUCTION OF SHOP DRAWNISS AND/OR COMMENSMENT OF
THE WORK.

#### DESIGN LOADS

THE BUILDING STRUCTURE HAS BEEN DESIGNED FOR THE FOLLOWING LOADS ACCORDANCE WITH THE 9TH EDITION OF THE MASSACHUSETTS STATE BUILDING

SNOW LOAD; ZONE 2 FLAT ROOF SNOW PI = 40 PSF DRIFTING AND SLIDING SNOW INCLUDED WHERE APPLICABLE

FLOOR LIVE LOAD:
RESIDENTIAL LIVING AREAS - 40 PSF
RESIDENTIAL SLEEPING AREAS - 30 PSF

WIND: MAIN WIND FORCE RESISTANCE SYSTEM ZONE 3 EXPOSURE BASIC WIND SPEED 100 MPH HEIGHT 0 - 50 FEET

#### STRUCTURAL LUMBER

A. CODE CONFORMANCE

NATIONAL FOREST PRODUCTS ASSOCIATION "NATIONAL DESIGN SPECIFICATION FOR WOOD CONSTRUCTION" INCLUDING SUPPLEMENT.

AMERICAN INSTITUTE OF TIMBER CONSTRUCTION TIMBER CONSTRUCTION STANDARDS" - ATC 100

US DEPARTMENT OF COMMERCE - PS 20 FOR LUMBER US DEPARTMENT OF COMMERCE - PS 166 FOR SOFTWOOD PLYWOOD AMERICAN WOOD PRESERVERS INSTITUTE - ST-1 STANDARDS

SOLID LUMBER (19% MAXIMUM MOISTURE CONTENT) STUDS - 234, 236, SPRUCE PINE FIR, STUD GRADE.
MEMBERS - 236, 236, 2310, 2312 - HEM FIR NO. 2, 15 KD
BASE DESIGN VALUES - Fb = 980 PSI, Fv = 70 PSI, E = 1200 KSI

LAMINATED VENEER LUMBER BEAMS (LVL) - GLUE LAMINATED VENEER LUMBER OF SOUTHERN PINE WITH MINIMUM DESIGN VALUES: FV = 285 PSI, Fb = 2600 PSI,

PARALLEL STRAND LUMBER BEAMS (PSL) - GLUE LAMINATED VENEER LUMBER OF SOUTHERN PINE WITH MINIMUM DESIGN VALUES: FY = 290 PSI, Fb = 2900 PSI, E=1,800,000 PSI.

BOLTS, NUTS & WASHERS - ASTM - A307

NAILS - COMMON WIRE, EXCEPT BARBED NAILS AT PLYWOOD SHEATHING. GALVANIZED NAILS AT EXPOSED FRAMING.

METAL CONNECTORS - APPROVED ITEMS OF PROPER TYPE & GAUGE AS SHOWN ON DRAWINGS - GALVANIZED.

ALL CONNECTORS AND FASTENERS AT PRESSURE TREATED WOOD SHALL BE STANNLESS STEEL.

PLYWOOD - APA RATED SHEATHING WITH EXTERIOR GLUE.

ROOF - 5/8" THICK

WALLS - 1/2" THICK SUBFLOORS - 3/4" THICK TONGUE & GROOVE

PRESSURE TREATED WOOD AT ALL EXPOSED FRAMING WITH APPROVED CLEAR WATER BORNE PRESERVATIVE. ALL MEMBERS TO BE STAMPED BY APPROPRIATE

ALL WOOD MEMBERS TO BE NAILED IN ACCORDANCE WITH MASS STATE CODE APPENDIX  ${\bf C}$ .

PLYWOOD SHALL BE NAILED AT 8" O.C. AT ALL JOINTS AND EDGES & 10" O.C. AT OTHER SUPPORTS, PLYWOOD SUB-FLOOR SHALL BE GLUED TO JOIST, BEFORE NAILING, WITH APPROVED ADJESSIVE. PROVIDE NAILING AT ALL CONNECTORS IN ACCORDANCE WITH MANUFACTURERS RECOMMENDATIONS. CONCRETE WORK A. CODE CONFORMANCE

COMPLY WITH THE LATEST RECOMMENDATIONS OF THE FOLLOWING STANDARDS: ACI 301 - SPECIFICATIONS FOR STRUCTURAL CONCRETE FOR BUILDING ACI 315 - DETAILING REINFORCING STEEL

ACI 347 - FORMWORK ACI 318 - BUILDING CODE REQUIREMENTS FOR STRUCTURAL CONCRETE ACI 318 CHAPTER 22 - BUILDING CODE REQUIREMENTS FOR STRUCTURAL PLAIN CONCRETE R MATERIALS

CONCRETE: APPROVED READY MIXED CONCRETE HAVING AN ULTIMATE COMPRESSIVE STRENGTH OF 3000 PSI AT 28 DAYS, SLUMP 3 - 5 INCHES.

REINFORCING: DEFORMED BARS ASTM A615 GRADE 60 EXCEPT TIES AND STIRRUPS MAY BE GRADE 40.

FORWYORK: SMOOTH PLYWOOD FORMS FOR EXPOSED SLABS OR VERTICAL SUFACES. BOARD FORMS FOR FOOTINGS OR UNEXPOSED CONCRETE SURFACES. NO EARTH FORMS PERMITTED.

SHRINKAGE CONTROL FIBERS (FIBERMESH) - INSTALL IN CONCRETE MIX PER MANUFACTURERS SPECIFICATIONS.

GROUT: NON-METALLIC NON - SHRINK TYPE UNDER BASE PLATES OR BEARING PLATES.

C. EXECUTION

CONCRETE: PLACE CONCRETE BY APPROVED METHODS OF ACI 304

EXCAVATE TO LINES AND GRADES REQUIRED TO PROPERLY INSTALL THE FOURBATIONS ON UNDISTURBED SOIL OR CONTROLLED STRUCTURAL BACKFLL APPROVED BY THE PROJECT AGAITHET. REMOVE ALL SLITY TOPSON OR DISECTIONAL MATERIAL FROM UNIDER SLABS ON GRADE. ALL EXCAVATIONS

EXTERIOR WALL FOOTINGS ARE TO BE PLACED ON APPROVED SOIL, AT A MINIMUM DEPTH OF 4 FT. BELOW THE LOWEST ADJACENT GROWN SURFACE EXPOSED TO FREEZING. ANY ADJUSTMENT OF ELEVATIONS OF FOOTINGS DUE TO

SOIL BEARING CAPACITY - NATURAL UNDISTURBED SOIL OR CONTROLLED STRUCTURAL BACKFILL HAVING AN ALLOWABLE BEARING PRESSURE OF 4000

BACKFILL THE EXCAVATION WITH APPROVED GRANULAR MATERILA PLACED IN 6 IN. LAYERS AND COMPACTED TO 95% DENSITY AT OPTIMUM MOISTURE CONTENT, AS DEFINED BY ASTM D1557, METHOD D AFTER BOTTOM OF EXCAVATION HAS BEEN APPROVED BY THE PROJECT ARCHITECT.

BACKFILLING AGAINST FOUNDATION WALLS TO BE DONE ONLY AFTER WALLS ARE BRACED TO PREVENT MOVEMENT.

WHERE NEW FOUNDATIONS ARE BUILT IN THE SAME LOCATION AS REMOVED EXISTING FOUNDATIONS, THEY SHALL BEAR ON UNDISTURBED SOIL AT OR BELOW THE ELEVATION OF THE EXISTING FOUNDATIONS.

REINFORCING: PLACE REINFORCING USING STANDARD BAR SUPPORTS TO PROVIDE PROPER CLEARANCE AND PREVENT DISPLACEMENT DURING CONCRETE OPERATIONS, LAP CONTINUOUS BARS 40 DIAVETERS.

MINIMUM CONCRETE COVER:


CONCRETE PLACED AGAINST EARTH - 3 IN.
FORMED CONCRETE EXPOSED TO EARTH, WEATHER OR WATER - 1 1/2 IN., 2 INCHES FOR #5 BAR OR LARGER. SLABS ON GRADE - 1 IN. FROM TOP

FORMWORK - PROPERLY BRACE AND SHORE FORMWORK TO MAINTAIN ALIGNMENT AND TOLERANCES IN ACCORDANCE WITH ACI 347.

REINFORCING BARS SHALL BE PLACED IN ACCORDANCE WITH THE LATEST EDITION OF THE CRSI "RECOMMENDED PRACTICE FOR PLACING REINFORCING

PROVIDE TWO #5 BARS EACH SIDE OF ALL OPENINGS IN WALLS AND SLABS.
BARS TO EXTEND 24" BEYOND EDGE OF OPENINGS. (FOR SIZE AND LOCATION OF OPENINGS, SEE ARCHITECTURAL DRAWINGS).

DETAILS NOT SHOWN ON DRAWINGS SHALL BE IN ACCORDANCE WITH THE ACI DETAILING MANUAL (ACI 315).

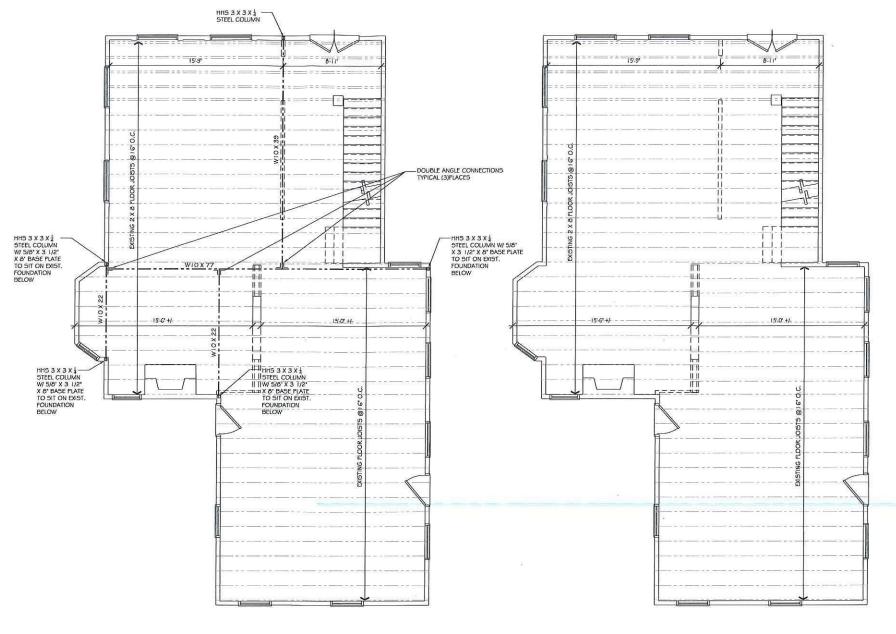

NEW SUPPORT BEAMS


EXISTING SECOND FLOOR

FRAMING PLAN



REN	75085					
	PROJECT MJAGER	PROPOSED ADDITION &	NENOVALIONO PAREET		CAMIDNIDGE, IMA	
	DRAWANG TITLE	XISTING FLO	4 - RAMING FLAN			
		SCUE AS NOTED	DRAWN BY 01/04/2021	CHECKED	DATE	


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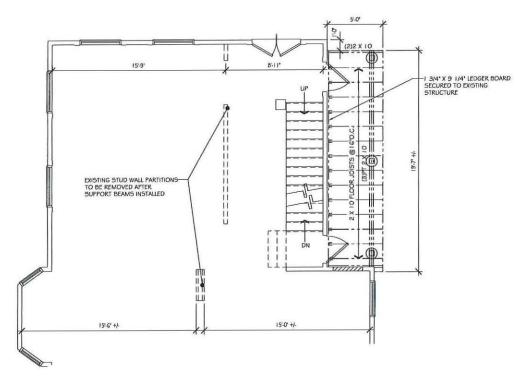
ROOF FRAMING PLAN

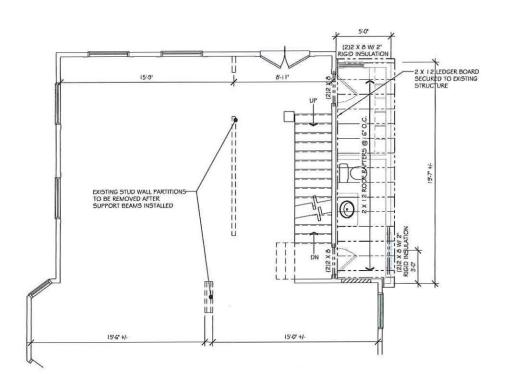1/4' = 1'-0'

3



FOUNDATION PLAN

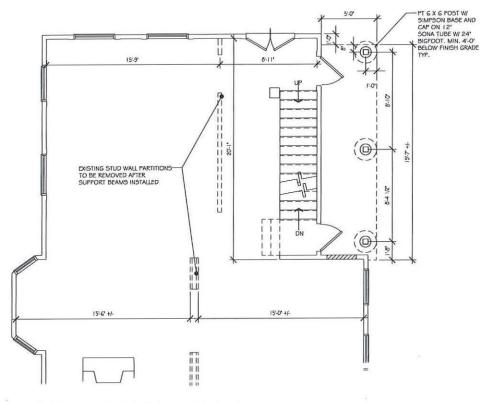


FIRST FLOOR FRAMING PLAN 2





RAVIS	TESTA ENGINEERING A \$ 5 0 C   A T E   Structural Engineering
	PROPOSED ADDITION ¢ RENOVATIONS 63 ORCHARD STREET CAMBRIDGE, MA
	MONDATION FOUNDATION ♦ FRAMING PLANS ADDITION

5.2

DRAWING NUMBER

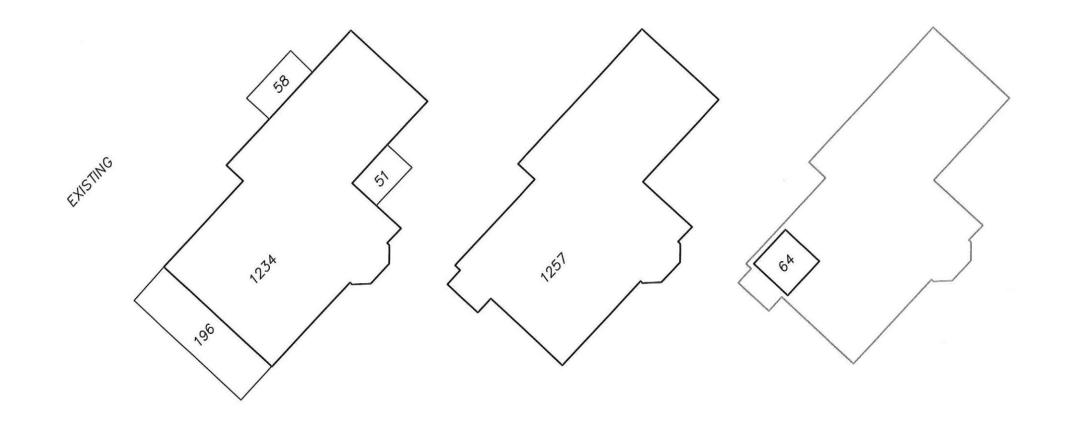

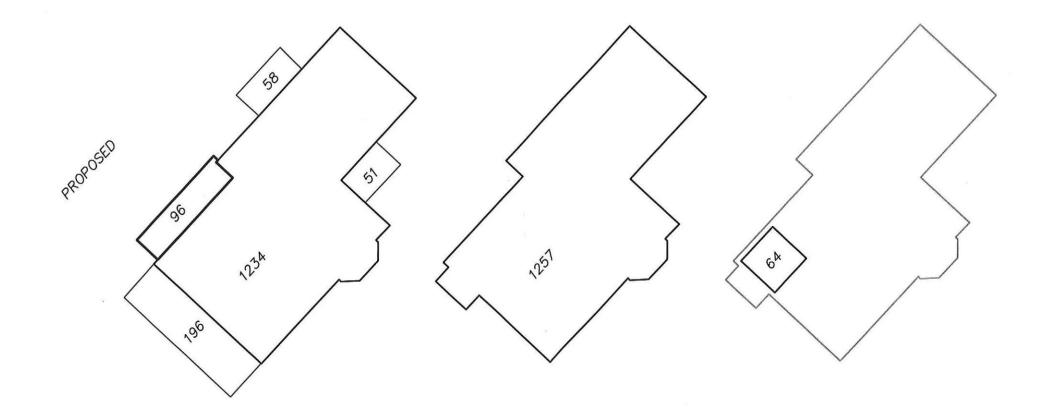

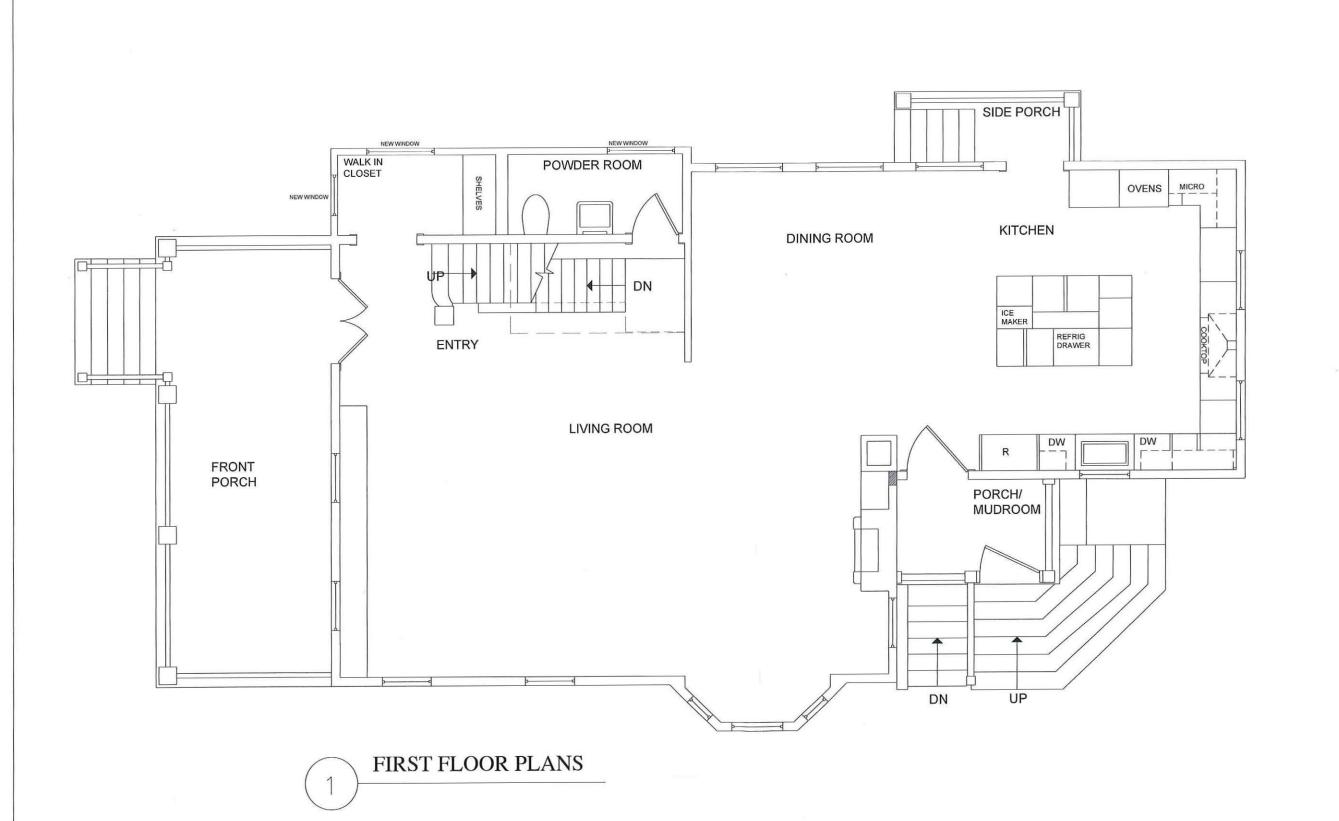

ARCHITECTURAL DESIGNER-LEANNE SZWARC

LEANNE SZWARC 24 RAMSDELL AVENUE #2 ROSLINDALE, MA 02131

PROPOSED PLANS

LAUREN STEWART & BEN VIGODA
63 ORCHARD STREET
CAMBRIDGE, MA 02138

Scale


 $\frac{3}{16}$ " = 1'-0"

Date

3/4/21

Drawing No.

A1.1

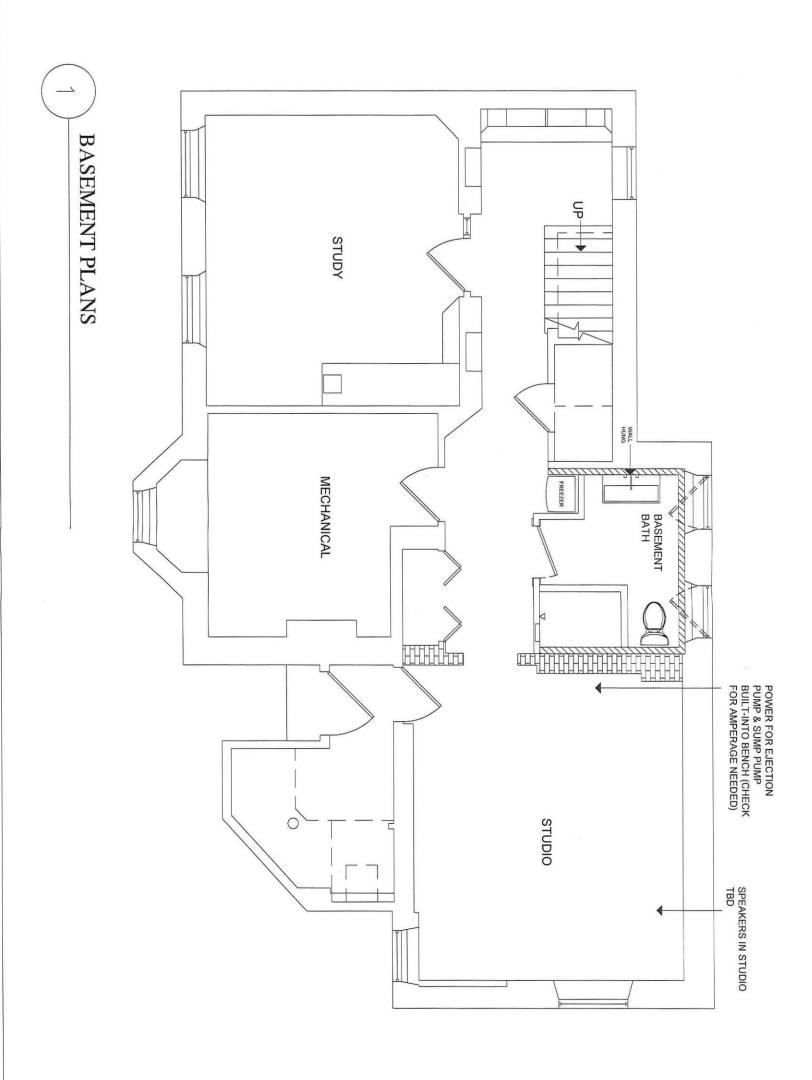

A1.0


Scale  $\frac{3}{16}$ " = 1'-0"


Date  $\frac{3}{4/21}$ 

PROPOSED PLANS

LAUREN STEWART & BEN VIGODA 63 ORCHARD STREET CAMBRIDGE, MA 02138 ARCHITECTURAL DESIGNER-

LEANNE SZWARC 24 RAMSDELL AVENUE #2 ROSLINDALE, MA 02131

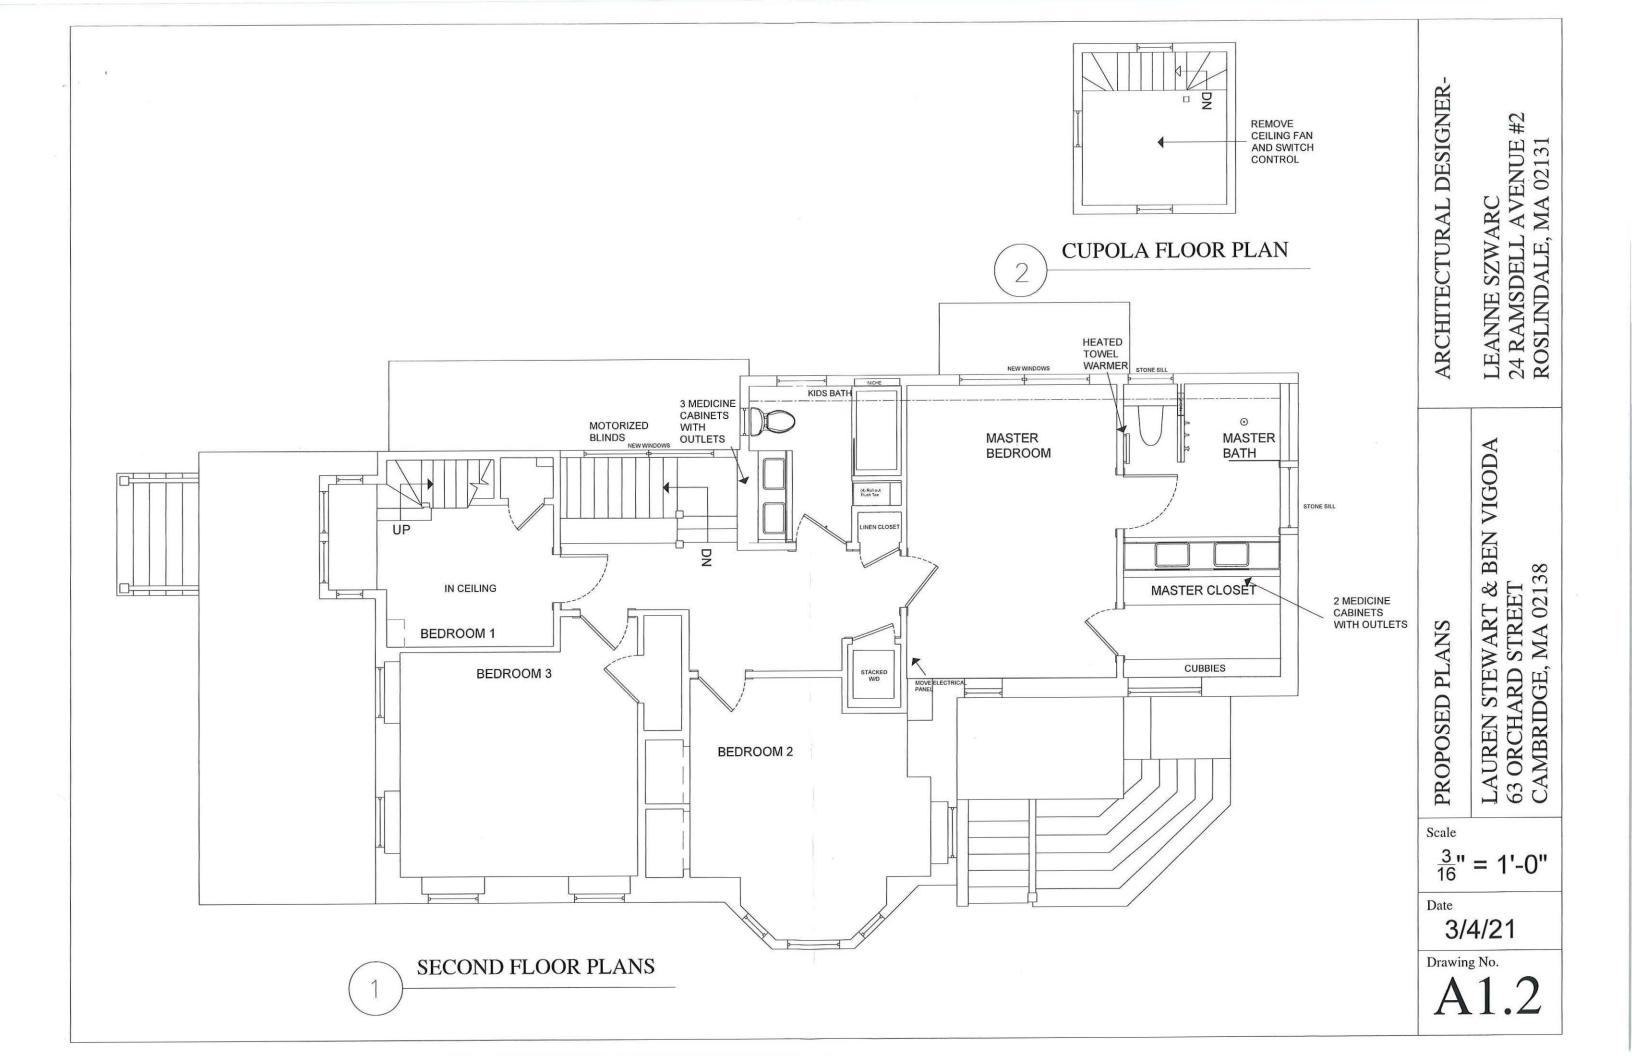

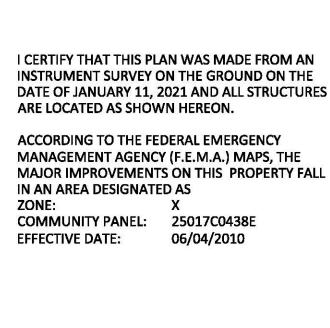

## **PREPARED FOR: OWNERS OF RECORD:** BENJAMIN W. VIGODA **LAUREN M. STEWART 63 ORCHARD STREET** CAMBRIDGE, MA 02140

**REFERENCES:** BK 73570; PG 244 BK 2494; PG END PL BK 1A; PL 4 PLAN: PL BK 84; PL 8 PL BK 86; PL 8 PL BK 167; PL 25

PL BK 170; PL 19 PL BK 337; PL 28 PL BK 374; PL 30 1614-A 6623-A

7757-A 13065 20657-A **NOTES:** MAP/LOT: 180-22

ZONING: B

PROFILE NOT TO SCALE PEAK: 535.11 --

MANSARD PEAK: 525.80 - ADDITION 1ST FL: 504.51 AVE GRADE: 500.20

N/F ELISHA H. ATKINS & MAUREEN A. COLTON BK 19541; PG 98 **FENCE** No. 6-8 TENNEY ST 58.00 N/F DONALD K. BUTT BK 12903; PG 567 **AREA** PAVED DRIVEWAY 5,775±SF WALK 500.23 500.29 PATIO No. 63 No. 65 ORCHARD ST N/F OFER LEVER & SHARON LEVY BK 66217; PG 260 14.7 2 STORY PROPOSED 1 STORY ADDITION PATIO 1ST FL: 504.51 PEAK: 525.80 COPULA: 535.11 O.H. 499.65 **PORCH** PAVED


No. 9 MILLER AVE

**BOSTON** SURVEY, INC. UNIT C-4 SHIPWAY PLACE CHARLESTOWN, MA 02129 (617) 242-1313

# **CERTIFIED PLOT PLAN LOCATED AT**

**63 ORCHARD STREET** CAMBRIDGE, MA

SCALE: 1.0 INCH = 10.0 FEET 10

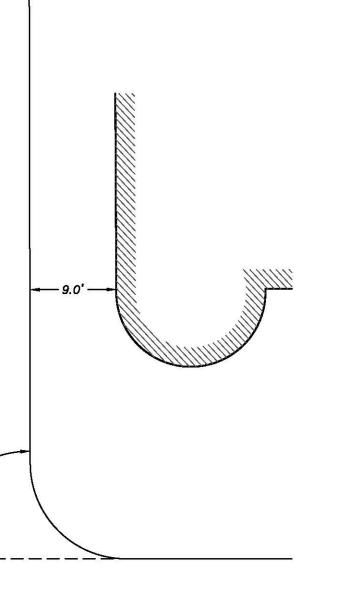

**ZONING:** 

MAP/LOT: 180-22

DISTRICT: RES B, SINGLE FAMILY

		REQUIRED	EXISTING	PROPOSED
GFA		=	2,860±SF	2,956±SF
FAR	(MAX.)	0.5	0.495	0.51*
LOT SIZE	(MIN.)	5,000 SF	5,775±SF	5,775±SF
LOT AREA, DW/U	(MIN.)	2,500 SF	5,775±SF	5,775±SF
LOT WIDTH	(MIN.)	50'	58.00'	58.001
FRONT SETBACK	(MIN.)	<b>15</b> '	18.0', 13.9'*	18.0', 13.9'*
SIDE SETBACK	(MIN.)	7.5' (SUM 20')	14.7'	13.6'
REAR SETBACK	(MIN.)	25'	22.5'*	22.5'*
HEIGHT	(MAX.)	35'	34.9'	34.9'
PVT. OP. SPACE	(MIN)	40%	56.9%	50.7%


\* = NON-CONFORMING

ORCHARD STREET

PATIO

(PUBLIC ~ 40.0' WIDE)

FIELD:	МО
DRAFT:	RAP
CHECK:	GCC
DATE:	03/30/21
JOB#	20-00653

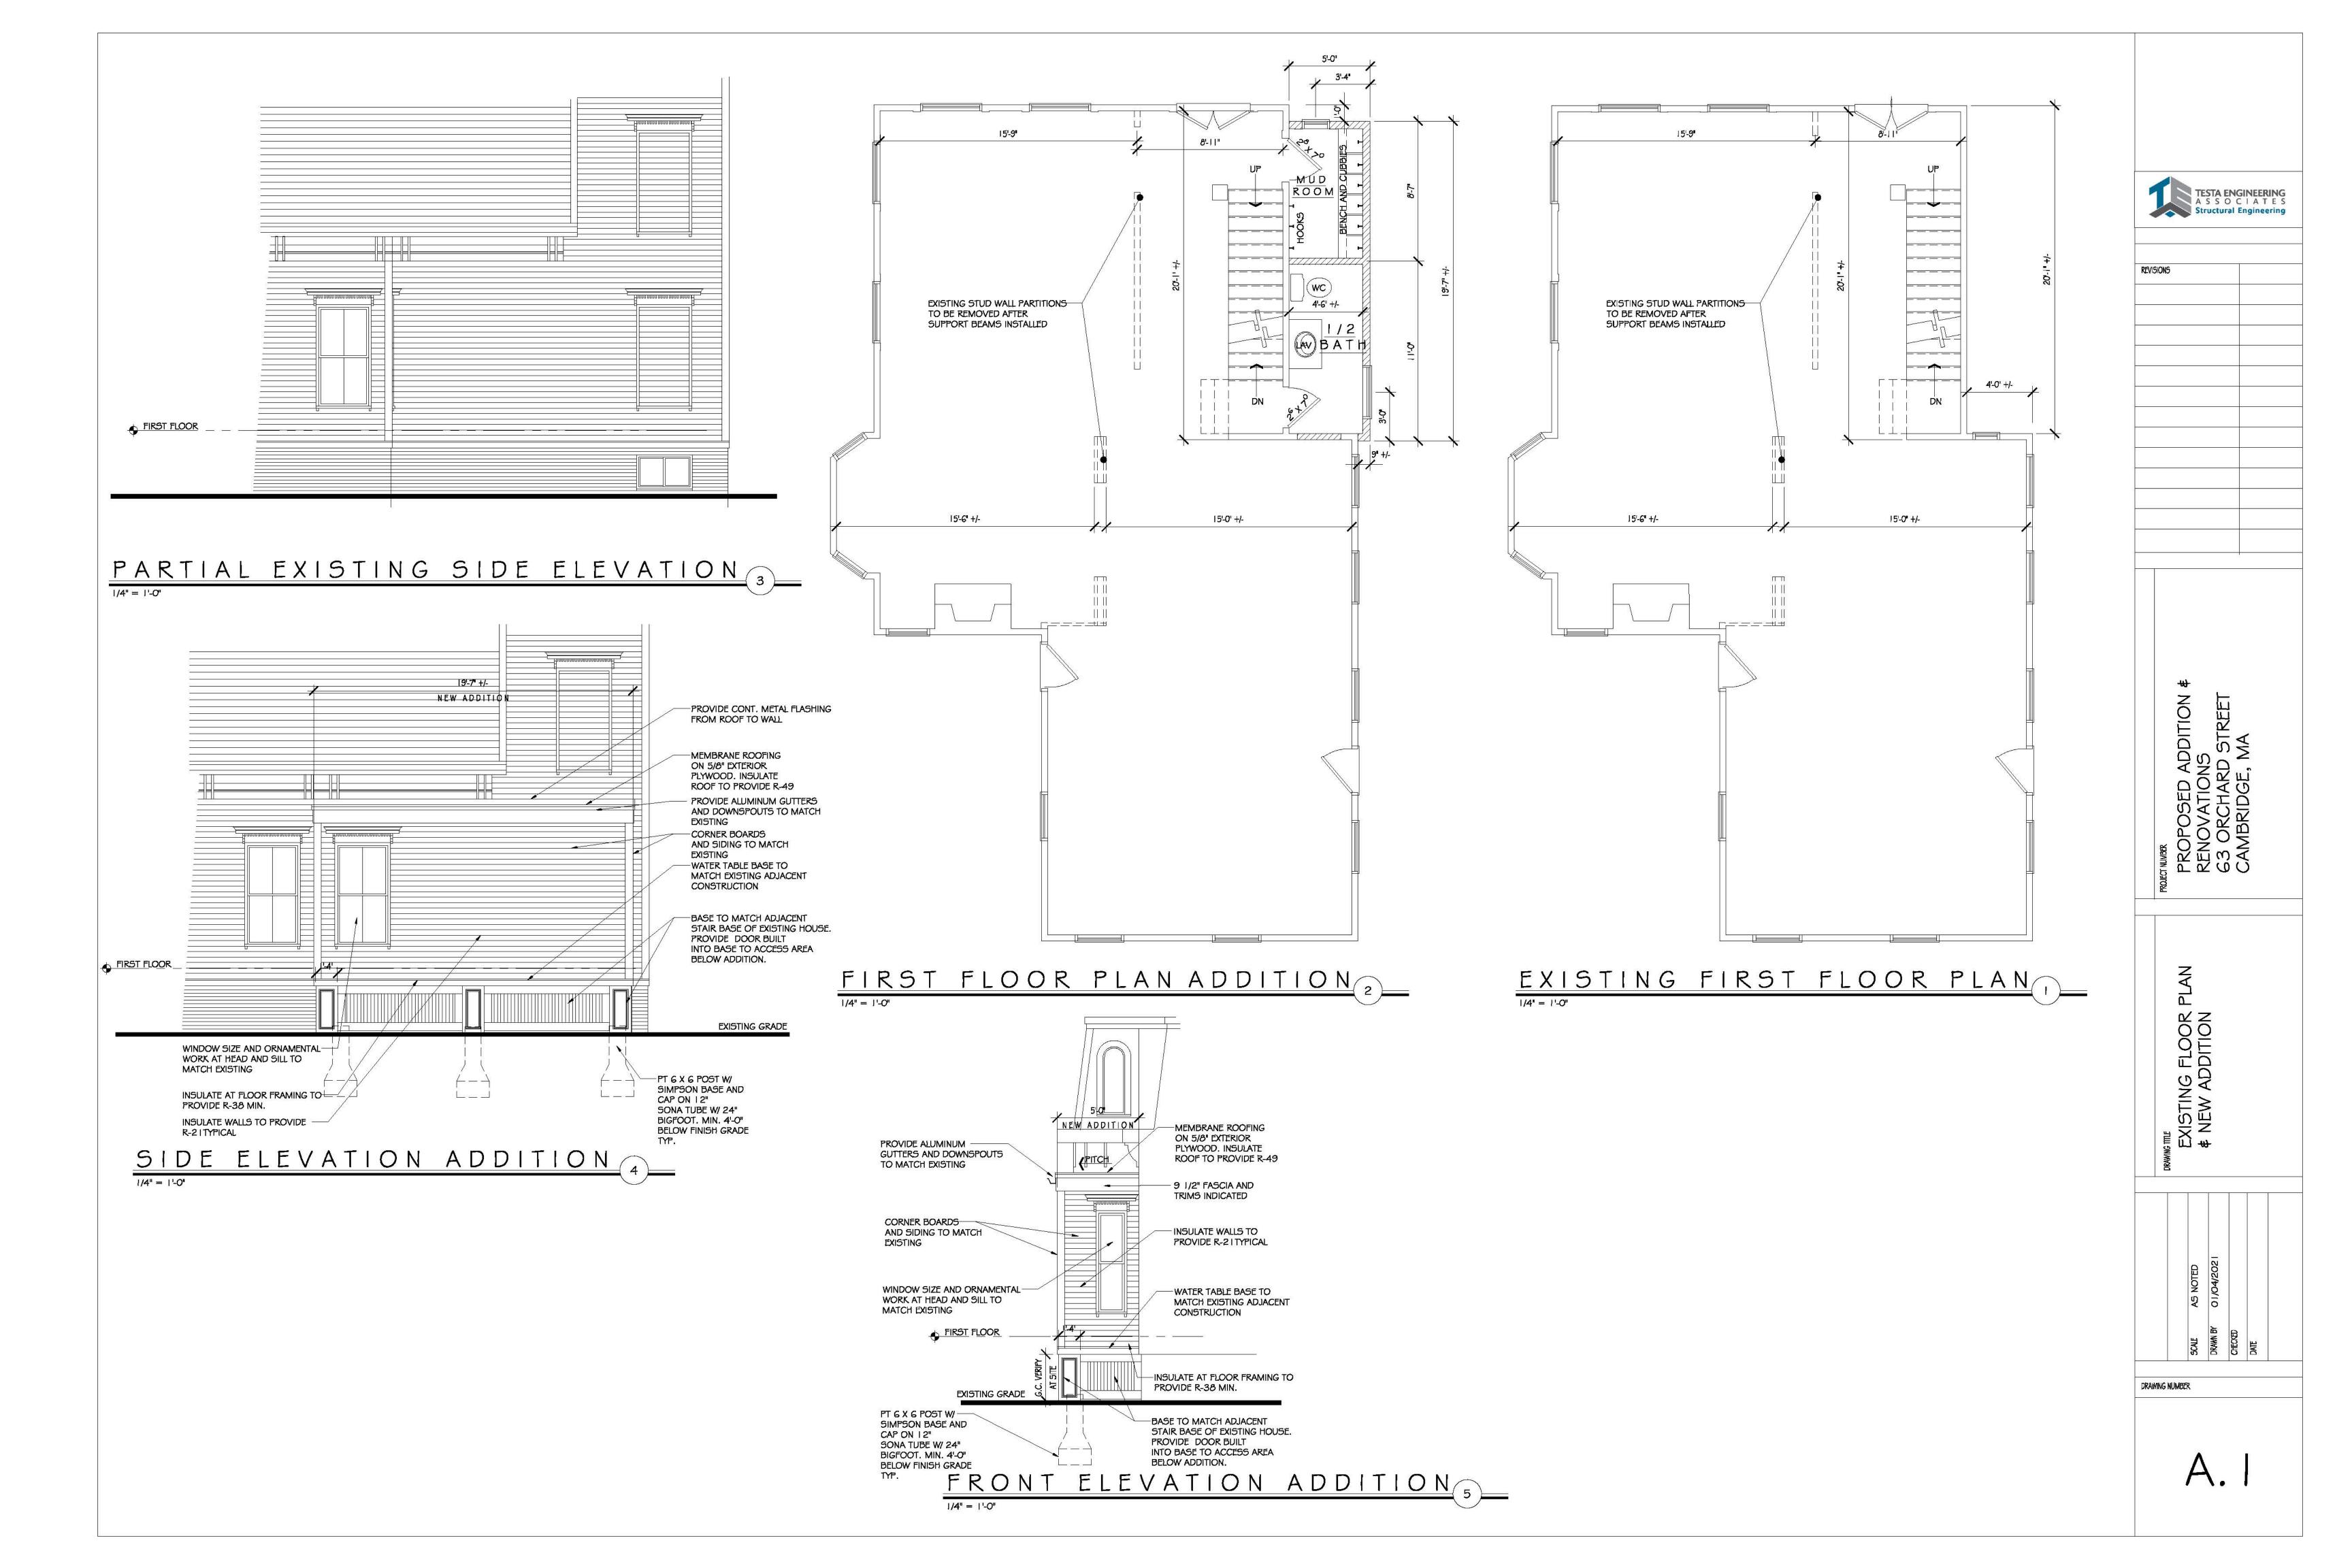

GENERAL NOTES: GENERAL

ALL MATERIALS, WORKMANSHIP AND DETAILS SHALL CONFORM TO THE 9TH EDITION OF THE MASSACHUSETTS RESIDENTIAL BUILDING CODE AND THE REFERENCE STANDARDS INCLUDED THEREIN THAT ARE APPLICABLE TO THIS PROJECT.

THE CONTRACTOR SHALL FAMILIARIZE HIMSELF WITH THE CONTRACT

THE CONTRACTOR SHALL FAMILIARIZE HIMSELF WITH THE CONTRACT DRAWINGS
ANY DISCREPANCIES SHALL BE BROUGHT TO THE ATTENTION OF
THE PROJECT ARCHITECT PRIOR TO PROCEEDING WITH

THE AFFECTED WORK. ANY VARIATIONS OR SUBSTITUTIONS OF MATERIALS OR DETAILS FROM THOSE INDICATED ON THE DRAWINGS MAY BE MADE ONLY WITH PRIOR APPROVAL OF THE PROJECT ARCHITECT.

SHOP DRAWINGS FOR STRUCTURAL STEEL SHALL BE SUBMITTED TO THE ARCHITECT

AND A STAMPED APPROVAL RECEIVED BEFORE FABRICATION CAN PROCEED.

NO MAIN FRAMING OR STRUCTURAL MEMBERS ARE TO BE MODIFIED,

ALTERED OR CUT WITHOUT THE APPROVAL OF THE PROJECT ARCHITECT.

FOR EXACT LOCATION OF FLOOR & ROOF OPENINGS, SEE ARCHITECTURAL DRAWINGS.

THE CONTRACTOR SHALL BE RESPONSIBLE FOR ALL JOB SAFETY DURING CONSTRUCTION INCLUDING BUT NOT LIMITED TO SHEETING, SHORING AND GUYING

STRUCTURES, BARRIERS AND SIGNAGE.

ALL STRUCTURAL DRAWINGS SHALL BE USED IN CONJUNCTION WITH
THE ARCHITECTURAL AND SHOP DRAWINGS

UNLESS OTHERWISE INDICATED, DETAILS SHOWN ON ANY DRAWING ARE TO BE CONSIDERED TYPICAL FOR ALL SIMILAR CONDITIONS.

THE GENERAL CONTRACTOR SHALL BE RESPONSIBLE FOR ALL CONSTRUCTION MEANS, METHODS, CO-ORDINATION OF OTHER TRADES AND TECHNIQUES TO PRODUCE A SOUND AND QUALITY BUILDING. ALL DIMENSIONS, ELEVATIONS AND CONDITIONS MUST BE VERIFIED BY THE GENERAL CONTRACTOR OR RESPONSIBLE TRADES PRIOR TO PRODUCTION OF SHOP DRAWINGS AND/OR COMMENSMENT OF THE WORK

DESIGN LOADS

THE BUILDING STRUCTURE HAS BEEN DESIGNED FOR THE FOLLOWING LOADS ACCORDANCE WITH THE 9TH EDITION OF THE MASSACHUSETTS STATE BUILDING CODE.

SNOW LOAD: ZONE 2 FLAT ROOF SNOW Pt = 40 PSF
DRIFTING AND SLIDING SNOW INCLUDED WHERE APPLICABLE

FLOOR LIVE LOAD:
RESIDENTIAL LIVING AREAS - 40 PSF

RESIDENTIAL SLEEPING AREAS - 30 PSF

WIND: MAIN WIND FORCE RESISTANCE SYSTEM ZONE 3 EXPOSURE
BASIC WIND SPEED 100 MPH HEIGHT 0 - 50 FEET

STRUCTURAL LUMBER

A. CODE CONFORMANCE

NATIONAL FOREST PRODUCTS ASSOCIATION "NATIONAL DESIGN SPECIFICATION FOR WOOD CONSTRUCTION" INCLUDING SUPPLEMENT.

AMERICAN INSTITUTE OF TIMBER CONSTRUCTION "TIMBER CONSTRUCTION STANDARDS" - ATC 100

US DEPARTMENT OF COMMERCE - PS 20 FOR LUMBER
US DEPARTMENT OF COMMERCE - PS 166 FOR SOFTWOOD PLYWOOD
AMERICAN WOOD PRESERVERS INSTITUTE - ST-1 STANDARDS

B. MATERIALS

SOLID LUMBER (19% MAXIMUM MOISTURE CONTENT) STUDS - 2X4, 2X6, SPRUCE PINE FIR, STUD GRADE.

MEMBERS - 2X6, 2X8, 2X10, 2X12 - HEM FIR NO. 2, 15 KD BASE DESIGN VALUES - Fb = 980 PSI, Fv = 70 PSI, E = 1200 KSI

LAMINATED VENEER LUMBER BEAMS (LVL) - GLUE LAMINATED VENEER LUMBER OF SOUTHERN PINE WITH MINIMUM DESIGN VALUES:  $F_V = 285$  PSI,  $F_D = 2600$  PSI, E = 2,000,000 PSI.

PARALLEL STRAND LUMBER BEAMS (PSL) - GLUE LAMINATED VENEER LUMBER OF SOUTHERN PINE WITH MINIMUM DESIGN VALUES: FV = 290 PSI, Fb = 2900 PSI, E = 1,800,000 PSI.

BOLTS, NUTS & WASHERS - ASTM - A307

NAILS - COMMON WIRE, EXCEPT BARBED NAILS AT PLYWOOD SHEATHING. GALVANIZED NAILS AT EXPOSED FRAMING.

METAL CONNECTORS - APPROVED ITEMS OF PROPER TYPE & GAUGE AS SHOWN OF DRAWINGS - GALVANIZED.

ALL CONNECTORS AND FASTENERS AT PRESSURE TREATED WOOD SHALL BE

STAINLESS STEEL PLYWOOD - APA RATED SHEATHING WITH EXTERIOR GLUE.

ROOF - 5/8" THICK WALLS - 1/2" THICK

SUBFLOORS - 3/4" THICK TONGUE & GROOVE

PRESSURE TREATED WOOD AT ALL EXPOSED FRAMING WITH APPROVED CLEAR WATER BORNE PRESERVATIVE. ALL MEMBERS TO BE STAMPED BY APPROPRIATE

AGENCY. C. EXECUTION

ALL WOOD MEMBERS TO BE NAILED IN ACCORDANCE WITH MASS STATE CODE APPENDIX C.

PLYWOOD SHALL BE NAILED AT 8" O.C. AT ALL JOINTS AND EDGES & 10" O.C. AT OTHER SUPPORTS, PLYWOOD SUB-FLOOR SHALL BE GLUED TO JOIST,

BEFORE NAILING, WITH APPROVED ADHESIVE.
PROVIDE NAILING AT ALL CONNECTORS IN ACCORDANCE WITH MANUFACTURERS RECOMMENDATIONS.

CONCRETE WORK
A CODE CONFORMANCE

COMPLY WITH THE LATEST RECOMMENDATIONS OF THE FOLLOWING STANDARDS:
ACI 301 - SPECIFICATIONS FOR STRUCTURAL CONCRETE FOR BUILDING

ACI 301 - SPECIFICATIONS FOR STRUCTURAL CONCRETE FOR BUILDING
ACI 315 - DETAILING REINFORCING STEEL
ACI 347 - FORMWORK

ACI 318 - BUILDING CODE REQUIREMENTS FOR STRUCTURAL CONCRETE ACI 318 CHAPTER 22 - BUILDING CODE REQUIREMENTS FOR STRUCTURAL PLAIN CONCRETE

B. MATERIALS

CONCRETE: APPROVED READY MIXED CONCRETE HAVING AN ULTIMATE COMPRESSIVE STRENGTH OF 3000 PSI AT 28 DAYS. SLUMP 3 - 5 INCHES.

REINFORCING: DEFORMED BARS ASTM A615 GRADE 60 EXCEPT TIES AND STIRRUPS MAY BE GRADE 40.

FORMWORK: SMOOTH PLYWOOD FORMS FOR EXPOSED SLABS OR VERTICAL SUFACES. BOARD FORMS FOR FOOTINGS OR UNEXPOSED CONCRETE SURFACES. NO EARTH FORMS PERMITTED.

SHRINKAGE CONTROL FIBERS (FIBERMESH) - INSTALL IN CONCRETE

MIX PER MANUFACTURERS SPECIFICATIONS.

GROUT: NON-METALLIC NON - SHRINK TYPE UNDER BASE PLATES OR BEARING

C EVECUTION

CONCRETE: PLACE CONCRETE BY APPROVED METHODS OF ACI 304

OUNDATIONS

EXCAVATE TO LINES AND GRADES REQUIRED TO PROPERLY INSTALL THE FOUNDATIONS ON UNDISTURBED SOIL OR CONTROLLED STRUCTURAL BACKFILL APPROVED BY THE PROJECT ARCHITECT. REMOVE ALL SILTY TOPSOIL OR OBJECTIONAL MATERIAL FROM UNDER SLABS ON GRADE. ALL EXCAVATIONS SHALL BE DRY BEFORE PLACING ANY CONCRETE.

EXTERIOR WALL FOOTINGS ARE TO BE PLACED ON APPROVED SOIL, AT A MINIMUM DEPTH OF 4 FT. BELOW THE LOWEST ADJACENT GROUND SURFACE EXPOSED TO FREEZING. ANY ADJUSTMENT OF ELEVATIONS OF FOOTINGS DUE TO FIELD CONDITIONS MUST HAVE THE EXPRESSED APPROVAL OF THE PROJECT

SOIL BEARING CAPACITY - NATURAL UNDISTURBED SOIL OR CONTROLLED STRUCTURAL BACKFILL HAVING AN ALLOWABLE BEARING PRESSURE OF 4000

BACKFILL THE EXCAVATION WITH APPROVED GRANULAR MATERILA PLACED IN 6 IN. LAYERS AND COMPACTED TO 95% DENSITY AT OPTIMUM MOISTURE CONTENT, AS DEFINED BY ASTM D1557, METHOD D AFTER BOTTOM OF EXCAVATION HAS BEEN APPROVED BY THE PROJECT ARCHITECT.

BACKFILLING AGAINST FOUNDATION WALLS TO BE DONE ONLY AFTER WALLS ARE BRACED TO PREVENT MOVEMENT.

WHERE NEW FOUNDATIONS ARE BUILT IN THE SAME LOCATION AS REMOVED EXISTING FOUNDATIONS, THEY SHALL BEAR ON UNDISTURBED SOIL AT OR BELOW THE ELEVATION OF THE EXISTING FOUNDATIONS.

REINFORCING: PLACE REINFORCING USING STANDARD BAR SUPPORTS TO PROVIDE PROPER CLEARANCE AND PREVENT DISPLACEMENT DURING CONCRETE OPERATIONS. LAP CONTINUOUS BARS 40 DIAMETERS.

OPERATIONS. LAP CONTINUOUS BARS 40 DIAMETERS.

MINIMUM CONCRETE COVER:

CONCRETE PLACED AGAINST EARTH - 3 IN.

FORMED CONCRETE EXPOSED TO EARTH, WEATHER OR WATER - 1 1/2 IN.,

2 INCHES FOR #6 BAR OR LARGER.

DETALING MANUAL (ACI 315).


SLABS ON GRADE - 1 IN. FROM TOP

FORMWORK - PROPERLY BRACE AND SHORE FORMWORK TO MAINTAIN ALIGNMENT
AND TOLERANCES IN ACCORDANCE WITH ACI 347.

REINFORCING BARS SHALL BE PLACED IN ACCORDANCE WITH THE LATEST EDITION OF THE CRSI "RECOMMENDED PRACTICE FOR PLACING REINFORCING BARS".

PROVIDE TWO #5 BARS EACH SIDE OF ALL OPENINGS IN WALLS AND SLABS.
BARS TO EXTEND 24" BEYOND EDGE OF OPENINGS. (FOR SIZE AND LOCATION OF OPENINGS, SEE ARCHITECTURAL DRAWINGS).

DETAILS NOT SHOWN ON DRAWINGS SHALL BE IN ACCORDANCE WITH THE ACI

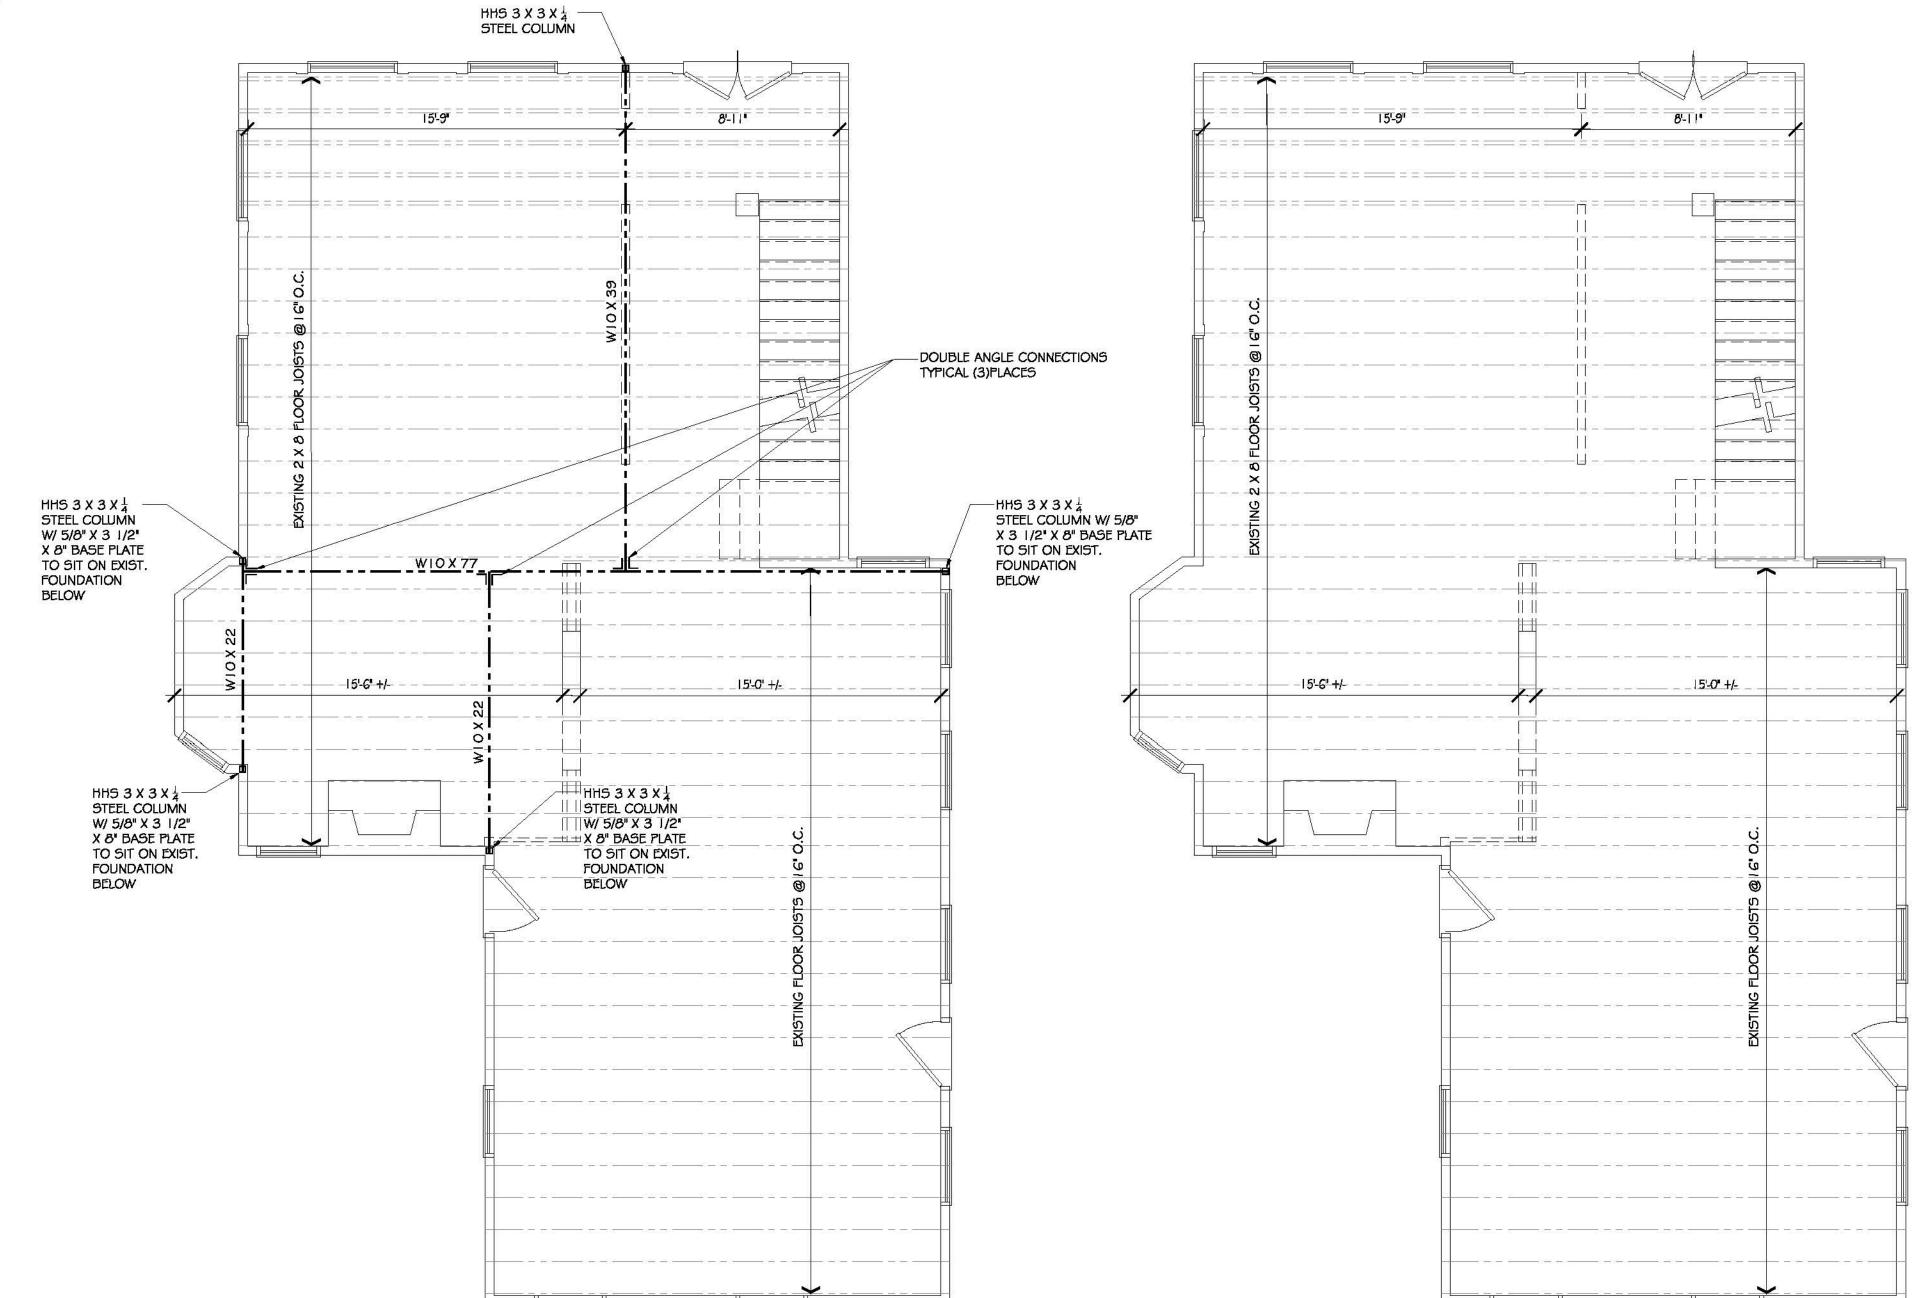

NEW SUPPORT BEAMS

EXISTING SECOND FLOOR

FRAMING PLAN

TESTA ENGINEERING
A S S O C | A T E S
Structural Engineering

REVISIONS

PROPOSED ADDITION & RENOVATIONS
63 ORCHARD STREET CAMBRIDGE, MA


EXISTING FLOOR PLAN


FRAMING PLAN

SCALE AS NOTED
DRAWN BY 01/04/2021
CHECKED
DATE


DRAWING NUMBER

5.1

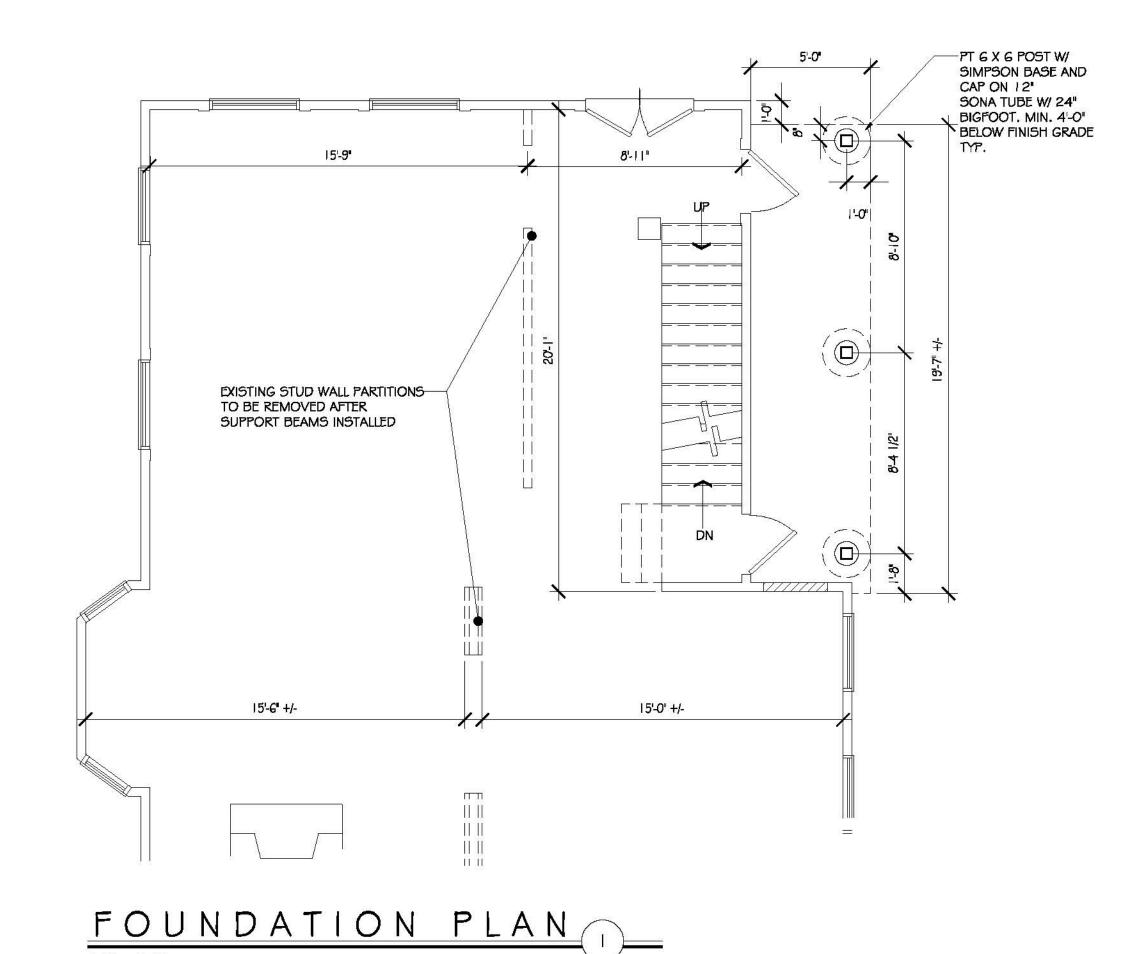


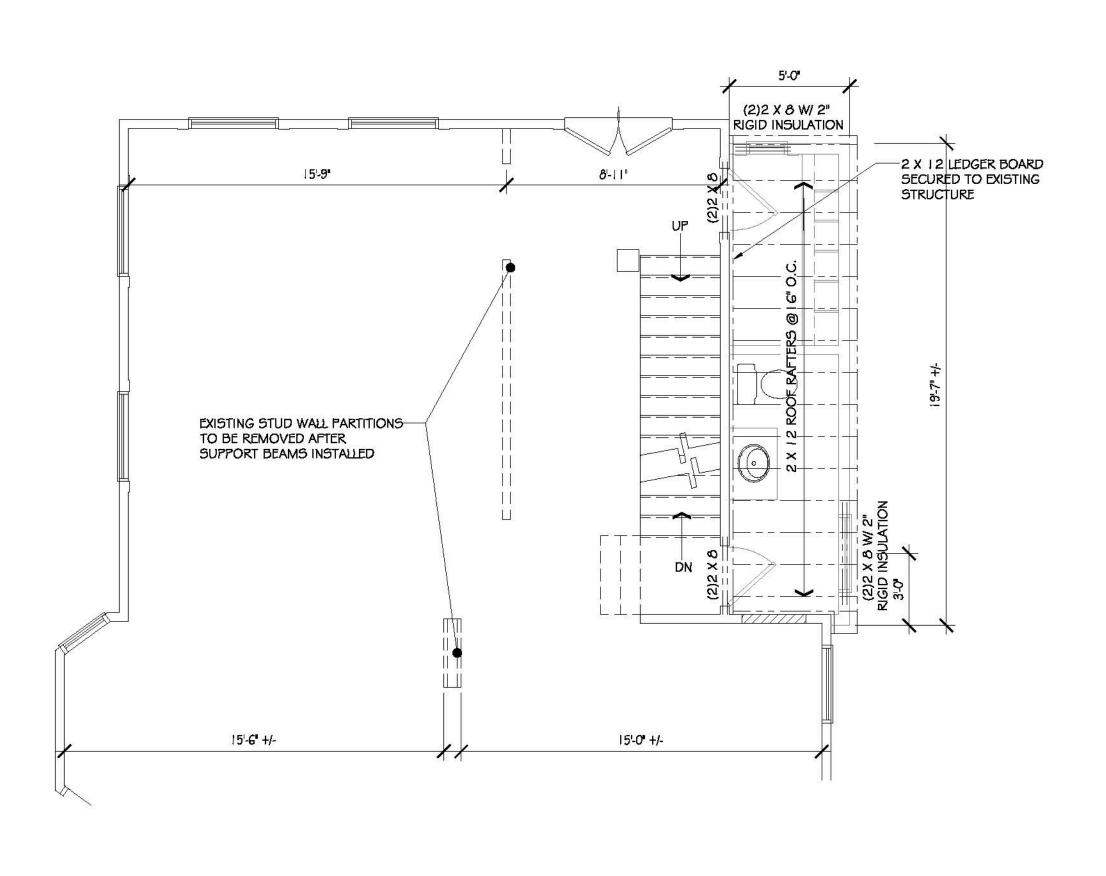



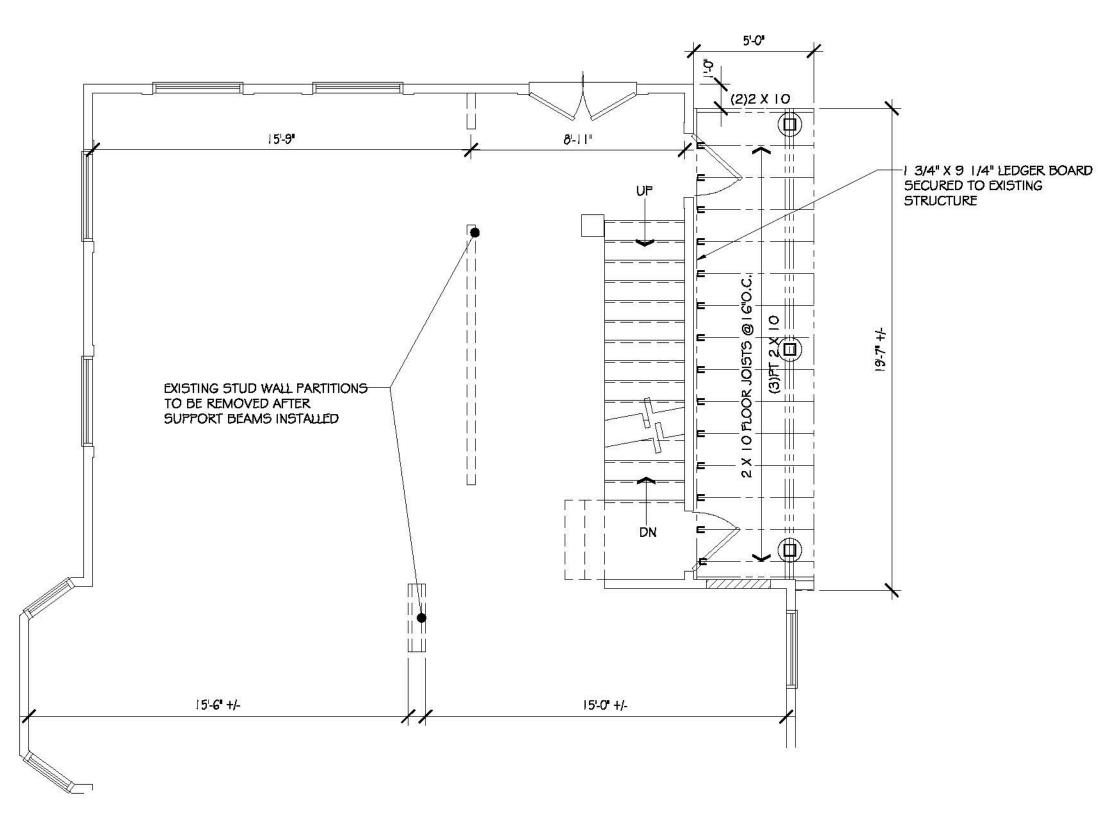

FIRST FLOOR FRAMING PLAN 2

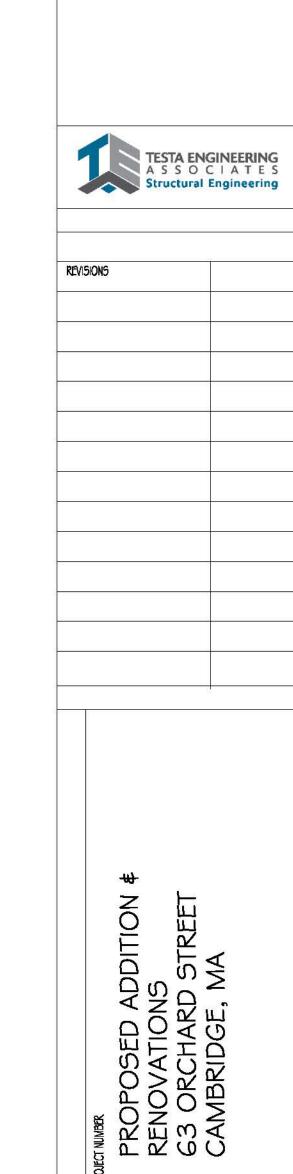


PRAWING TILE
FOUNDATION
FOUNDATION
FOUNDATION
ADDITION
F

5.2

DRAWING NUMBER



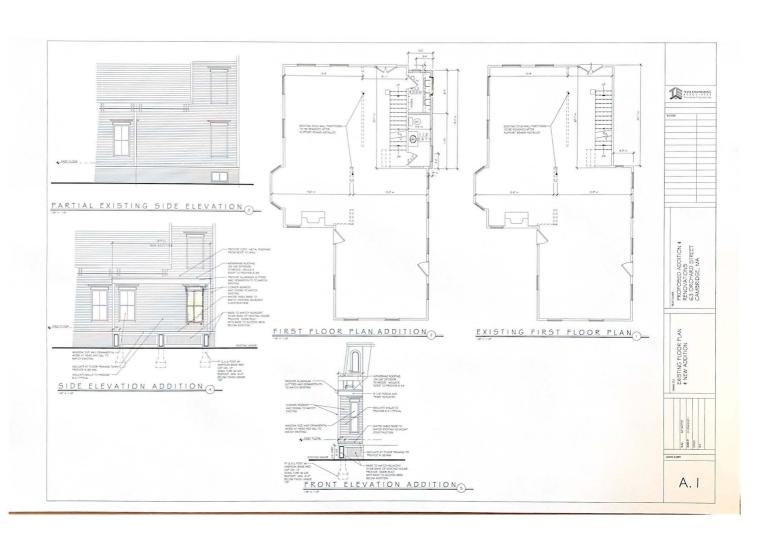

Ochard St 180-14 22 Tenney St 180-11 180-13 180-17 180-5 15 Tenney St 18 Tenney St 180-27 180-12 180-59 180-10 14 Tenney St 180-26 9 Tenney St 5 Tenney St 180-18 180-60 Tenney St 12 Tenney St 180-25 180-9 77 Orchard St 180-19 6 Tenney St 180-51 17 Miller Ave 180-55 10 75 Orchard St 180-20 180-56 180-52 11 Miller Ave 73 Orchard St 180-69 180-65 180-21 9 Miller Ave 181-63 69 Orchard St 180-64 180-68 76 Orchard St hiller Ave 10 Miller Ave 12 Miller Ave 181-64 65 Orchard 5t 8 Miller Ave 180-50 74 Orchard St 180-22 72 Orchard St 63 Orchard St 181-70 180-70 Ord and St 180-49 10 0 181-71 64 Orchard St 68 Orchard St 181-72 180-48 57 Orchard St 180-47 181-68 60 Or hard St 55 Orchard St 181-69 36 Hadley St 34 Hadley St 180-46 53-A Orchard St53 Orchard St 181-67 181-19 35 Blake St 49 Orchard St180-45 Blakest 181-29 181-20 29 Blake St 181-45<sub>50</sub> Orchard St 181-21 180-44 181-46 181-22

180-20 DELAURE, CHRISTOPHE T. & ISABELLE H. DELAURE 11 MILLER AVE CAMBRIDGE, MA 02140

181-71 WHEELER, GORDON & NANCY LUNNEY WHEELER 302 MOORE ST SANTA CRUZ, CA 95060

181-69 NOVOTNY, LIA C. & CHAD H. NOVOTNY 60 ORCHARD ST CAMBRIDGE, MA 02139

180-64 OFER, LEVY & SHARON LEVY 65 ORCHARD ST CAMBRIDGE, MA 02140

180-49 WHITE, HUGH R. AND SUSAN P. TIERSCH 8 MILLER AVE CAMBRIDGE, MA 02140

180-65 DORAN, MARGUERITE A. & EDWARD M. DORAN JR. 69 ORCHARD ST. CAMBRIDGE, MA 02140 63 orchard St.

180-48
FENN, GEORGE W. & PAIGE M. ARNOF-FENN
57 ORCHARD ST
CAMBRIDGE, MA 02140-1326

JAMES SULLIVAN 27 SYLVIA ROAD MEDFORD, MA 02155

180-25 SHEEHAN, MARY E., A LIFE ESTATE 14-16 TENNEY ST CAMBRIDGE, MA 02140-1312

180-50 BOYCE, DAVID S. & MARY LOU DYMSKI TRUSTEE, THE BOYSKI REV TRUST 10 MILLER AVE CAMBRIDGE, MA 02140

181-68
PACHECO, ALBERT M.
LEONTINA O. PACHECO, TRS
54 LARCHWOOD DR
CAMBRIDGE, MA 02138

180-21 COLTON MAUREEN A TRS MAUREEN A COLTON REVOCABLE TR 9 MILER AVE CAMBRIDGE, MA 02140 180-22 VIGODA, BENJAMIN LAUREN M. STEWART 63 ORCHARD ST CAMBRIDGE, MA 02140

180-52 BUTT, DONALD K. 6 TENNEY ST CAMBRIDGE, MA 02140-1312

181-19 FOX DEBRA E TRS DEBRA E FOX 2002 TRUST 35 BLAKE ST CAMBRIDGE, MA 02140

180-51 MILLER, CARSTEN B. & MOLLY C READY TRS. OF THE MILLER-READY REVOC LIVING TRT 12 TENNEY ST CAMBRIDGE, MA 02140

# Pacheco, Maria

63 orchard St.

From: Sent: Debra Fox <dfox228@gmail.com> Sunday, May 16, 2021 7:54 PM

To:

Pacheco, Maria

Subject:

BZA-113723

I am a homeowner at 35 Blake Street. I have no objection to the zoning relief requested. Debra Fox

# Pacheco, Maria

From:

Hugh White <hugwhite@us.ibm.com>

Sent:

Thursday, May 20, 2021 9:43 AM

To:

Pacheco, Maria

Subject:

We fully support the addition project at 63 Orchard.

Hi Maria:

This is in relation to the zoning board meeting 5/27 @ 7:15...thanks

Hugh White 8 Miller Avenue Cambridge 617.605.9163