

# ITY OF CAMBRIDGE

**BOARD OF ZONING APPEAL** 

831 Massachusetts Avenue, Cambridge MA 02139 2021 APR 28 PM 3: 50

617-349-6100

## **BZA Application Form**

BZA Number: 117709

<u>General Information</u>
The undersigned hereby petitions the Board of Zoning Appeal for the following:
Special Permit: X Variance: X Appeal:
PETITIONER: Anderson Porter Design C/O Dan Anderson
PETITIONER'S ADDRESS: 875 Main Street, Cambridge, MA 02139
LOCATION OF PROPERTY: <u>8 Poplar Rd , Cambridge, MA</u>
TYPE OF OCCUPANCY: Residential 3 Units  ZONING DISTRICT: Residence B Zone
REASON FOR PETITION:
/Additions/
DESCRIPTION OF PETITIONER'S PROPOSAL:
Areaway lowers average grade increasing non-conforming height, window well railings in non-conforming setbacks
Changes of openings in non-conforming setbacks
SECTIONS OF ZONING ORDINANCE CITED:
Article: 5.000 Section: 5:31 (Table of Dimensional Requirements).  Article: 8.000 Section: 8.22.3 (Non-Conforming Structure).  Article: 8.000 Section: Section 8.22.2.C (Non-Conforming Structure).  Article: 10.000 Section: 10.30 (Variance).
Article: 10.000 Section: 10.40 (Special Permit).

Original Signature(s):

(Petitioner (s) / Owner)

Address:

Tel. No.

617-794-2371

E-Mail Address:

dan@andersonporter.com

Date: 9/24/2021

### BZA APPLICATION FORM -OWNERSHIP INFORMATION

(To be completed by <b>OWNER</b> , signed before a notary, and returned to Secretary of Board of Appeal).
I/We & POPLAR ROAD LLC
I/We & POPLAR ROAD LLC (OWNER).
Address: C/O DND HOMES, I GARFIELD CIRCLE, UNIT 6, BURLINGTON, MA
State that I/We own the property located at & POPLAR ROAD which is the
subject of this zoning application.
The record title of this property is in the name of 8 POPLAR ROAD LLC
*Pursuant to a deed of duly recorded in the date 9/22/20, Middlesex South
County Registry of Deeds at Book, Page; or
Middlesex Registry District of Land Court, Certificate No. 274211
Book 01513 Page 2
SIGNATURE BY LAND OWNER OR AUTHORIZED TRUSTEE, OFFICER OR AGENT*
*Written evidence of Agent's standing to represent petitioner may be requested.
Commonwealth of Massachusetts, County of MiddleSex
The above-name 62an Doknecis9 personally appeared before me, this March of, 2004, and made oath that the above statement is true.
My commission expires October 25, 2024 (Notary Seal).

 If ownership is not shown in recorded deed, e.g. if by court order, recent deed, or inheritance, please include documentation.

# EACH OF THE FOLLOWING REQUIREMENTS FOR A VARIANCE MUST BE ESTABLISHED AND SET FORTH IN COMPLETE DETAIL BY THE APPLICANT IN ACCORDANCE WITH MGL 40A, SECTION 10.

A) A literal enforcement of the provisions of this Ordinance would involve a substantial hardship, financial or otherwise, to the petitioner or appellant for the following reasons:

The literal enforcement of the provisions of this Ordinance would involve a substantial hardship by precluding direct exterior access to the commonly accessible sprinkler mechanical room and window wells at the basement emergency egress windows required by state building code.

The hardship is owing to the following circumstances relating to the soil conditions, shape or topography of such land or structures and especially affecting such land or structures by not affecting generally the zoning district in which it is located for the following reasons:

The hardship is owing to the following circumstances related to the shape of the lot and placement of the existing structure on a small lot. The placement of the areaway access stair is in the only location not violating yard setbacks. The placement of proposed window wells allowing for bedroom emergency egress windows are in the only locations feasible. These conditions do not affect generally the zoning district in which it is located.

### C) DESIRABLE RELIEF MAY BE GRANTED WITHOUT EITHER:

1) Desirable relief may be granted without substantial detriment to the public good for the following reasons:

Desirable relief may be granted without substantial detriment to the public good as the location of the areaway access stair is at the rear of the property not readily visible to the public. The code required guardrails at the window wells are provided for safety and are visually unobtrusive.

Desirable relief may be granted without nullifying or substantially derogating from the intent or purpose of this Ordinance for the following reasons:

Desirable relief may be granted with out nullifying or substantially derogating from the intent or purpose of this Ordinance as the proposed increase in height is due to the minimal change in average

grade, no additional stories or change to the existing roof structure is proposed. Therefore not disturbing open views to the sky, increasing shadow impact or otherwise impacting abutters. The code required guardrails at the window wells are provided for safety and are visually unobtrusive.

\*If you have any questions as to whether you can establish all of the applicable legal requirements, you should consult with an attorney.

### **BZA Application Form**

### SUPPORTING STATEMENT FOR A SPECIAL PERMIT

Please describe in complete detail how you meet each of the following criteria referring to the property and proposed changes or uses which are requested in your application. Attach sheets with additional information for special permits which have additional criteria, e.g.; fast food permits, comprehensive permits, etc., which must be met.

Granting the Special Permit requested for <u>8 Poplar Rd</u>, <u>Cambridge</u>, <u>MA</u> (location) would not be a detriment to the public interest because:

A) Requirements of the Ordinance can or will be met for the following reasons:

The proposed project at 8 Poplar Road improves an existing non-conforming three family structure within its existing footprint and proposes no increase in gross building area. The project includes the installation of a full building sprinkler system. The proposed basement window wells serve the code required bedroom emergency egress windows and are located in the only locations feasible. The left side yard is too narrow and the right side yard is occupied by parking, unit access, and access to the common sprinkler mechanical room.

Traffic generated or patterns of access or egress would not cause congestion hazard, or substantial change in established neighborhood character for the following reasons:

The traffic generated or patterns of egress will not cause congestion hazard, or substantial change in established neighborhood character as no change in the existing occupancy or parking is proposed.

The continued operation of or the development of adjacent uses as permitted in the Zoning

Ordinance would not be adversely affected by the nature of the proposed use for the following reasons:

The continued operation of adjacent uses as permitted in the Ordinance would not be adversely affected as there is minimal change from existing. Basement window wells and areaway access stairs create no limitations on existing uses.

Nuisance or hazard would not be created to the detriment of the health, safety, and/or welfare of the occupant of the proposed use or the citizens of the City for the following reasons:

No nuisance or hazard will be created to the detriment of the health, safety, and/or welfare of the occupants of the structure or the citizens of the City since the addition of a full building fire protection system will improve the safety of the occupants and citizens.

For other reasons, the proposed use would not impair the integrity of the district or adjoining district or otherwise derogate from the intent or purpose of this ordinance for the following reasons:

The proposed use would not impair the integrity of the district or adjoining district or otherwise derogate from the intent or purpose of this ordinance as basement window wells and access areaways are typical additions that allow the full use and occupancy of otherwise underutilized

building areas. No changes in use, intensity, or area are proposed and the district will remain unaffected by the proposed improvements.

\*If you have any questions as to whether you can establish all of the applicable legal requirements, you should consult with an attorney.

### **BZA Application Form**

### **DIMENSIONAL INFORMATION**

Applicant: Anderson Porter Design Present Use/Occupancy: Residential 3 Units

**Location:** 875 Main Street **Zone:** Residence B Zone

Phone: 617-794-2371 Reguested Use/Occupancy: Residential 3 Units

		Existing Conditions	Requested Conditions	<u>Ordinance</u> <u>Requirements</u>	
TOTAL GROSS FLOOR AREA:		5774	5774	1546.5	(max.)
LOT AREA:		3093	3093	5000	(min.)
RATIO OF GROSS FLOOR AREA TO LO AREA: <sup>2</sup>	Ι	1.86	1.86	.5	
LOT AREA OF EACH DWELLING UNIT		1031	1031	2500	
SIZE OF LOT:	WIDTH	40.2	40.2	50	
	DEPTH	75	75	NA	
SETBACKS IN FEET:	FRONT	5	5	15	
	REAR	7.8	7.8	25	
	LEFT SIDE	4.4	4.4	12.5	
	RIGHT SIDE	10.2	10.2	7.5	
SIZE OF BUILDING:	HEIGHT	35.3	38.1	35	
	WIDTH	55.6	55.6	NA	
RATIO OF USABLE OPEN SPACE TO LO AREA:	Ľ	.28	.28	.40	
NO. OF DWELLING UNITS:		3	3	1	
NO. OF PARKING SPACES:		1	1	3	
NO. OF LOADING AREAS:		NA	NA	NA	
DISTANCE TO NEAREST BLDG. ON SAME LOT		NA	NA	10	

Describe where applicable, other occupancies on the same lot, the size of adjacent buildings on same lot, and type of construction proposed, e.g; wood frame, concrete, brick, steel, etc.

- 1. SEE CAMBRIDGE ZONING ORDINANCE ARTICLE 5.000, SECTION 5.30 (DISTRICT OF DIMENSIONAL REGULATIONS).
- 2. TOTAL GROSS FLOOR AREA (INCLUDING BASEMENT 7'-0" IN HEIGHT AND ATTIC AREAS GREATER THAN 5') DIVIDED BY LOT AREA.
- 3. OPEN SPACE SHALL NOT INCLUDE PARKING AREAS, WALKWAYS OR DRIVEWAYS AND SHALL HAVE A MINIMUM DIMENSION OF 15'.


### **BZA Application Form**

# CAMBRIDGE, MA 02138

- THE DRAWINGS SHALL BE WORKED IN CONJUNCTION WITH THE SPECIFICATIONS AND/OR PROJECT MANUAL.
- THE CONTRACTOR SHALL VERIFY ALL DIMENSIONS AND EXISTING CONDITIONS PRIOR TO THE START OF WORK. NOTIFY THE ARCHITECT OF CHANGES IN DIMENSIONS OR CONDITIONS. THE CONTRACTOR SHALL PROVIDE ALL MATERIALS, TOOLS, EQUIPMENT AND NECESSARY FACILITIES, AND PERFORM ALL LABOR AND SERVICES OF EVERY DESCRIPTION AS MAY BE NECESSARY TO
- AUTHORITIES HAVING JURISDICTION OVER WORK PERFORMED UNDER THIS CONTRACT. PROVIDE COPIES OF ALL REQUIRED PERMITS, CERTIFICATES, INSPECTIONS, AND AGENCY APPROVALS TO THE
- ALL WORK SHALL BE FABRICATED AND INSTALLED IN STRICT ACCORDANCE WITH THE INTERNATIONAL BUILDING/RESIDENTIAL CODE, ALL APPLICABLE STATE AND LOCAL CODES, AND THE GENERAL AND
- DEFICIENCIES IN THE DRAWINGS RECOGNIZED BY THE CONTRACTOR SHOULD BE BROUGHT TO THE ATTENTION OF THE ARCHITECT FOR CLARIFICATION.
- ALL CONTRACTORS AND SUBCONTRACTORS SHALL BE RESPONSIBLE FOR: THE PROPER PERFORMANCE OF THEIR WORK, COORDINATION WITH OTHER TRADES, MEANS AND METHODS OF CONSTRUCTION, AND SAFETY AND SECURITY ON SITE.
- CUTTING AND PATCHING SHALL BE PERFORMED BY EACH TRADE AS NECESSARY FOR THE PERFORMANCE AND INSTALLATION OF THEIR WORK. CUTTING AND PATCHING SHALL BE PERFORMED IN A WORKMANLIKE MANNER CONSISTENT WITH INDUSTRY STANDARDS FOR FINISHES AND SUBSTRATES AFFECTED.
- THE CONTRACTOR SHALL PROTECT THE FACILITY FROM WEATHER AND MAINTAIN SECURITY DURING ALL CONSTRUCTION WORK. THE EXISTING PROPERTY SHALL BE PROTECTED DURING CONSTRUCTION. REPAIR OR REPLACE, WITHOUT ADDITIONAL CHARGE TO THE OWNER, ANY EXISTING WORK DAMAGED DURING THE COURSE OF
- THE CONTRACTOR SHALL BE RESPONSIBLE FOR THE ACCURATE PLACEMENT OF THE BUILDING ON THE SITE AND VERIFY ALL DIMENSIONS AND EXISTING CONDITIONS. DISCREPANCIES BETWEEN THE DRAWINGS AND ACTUAL SITE CONDITION SHALL BE BROUGHT TO THE ATTENTION OF THE ARCHITECT BEFORE BIDDING THE PROJECT OR THE COMMENCEMENT OF WORK. THE OWNER SHALL NOT BE
- RESPONSIBLE FOR CHANGES TO THE WORK DUE TO THE FAILURE OF THE CONTRACTOR TO FAMILIARIZE HIMSELF/HERSELF WITH EXISTING CONDITIONS. DO NOT SCALE DRAWINGS: ALL DIMENSIONS SHALL HAVE PREFERENCE OVER SCALE AND BE FIELD-VERIFIED AND COORDINATED WITH WORK OF ALL TRADES. IF NO DIMENSIONS ARE GIVEN OR
- DISCREPANCIES ARE FOUND. THE CONTRACTOR SHALL NOTIFY THE ARCHITECT FOR CLARIFICATION BEFORE BIDDING OR COMMENCING THE WORK.
- THE CONTRACTOR SHALL VERIFY THE SIZES AND LOCATIONS OF ALL MECHANICAL AND ELECTRICAL EQUIPMENT PADS AND BASES, AS WELL AS POWER, WATER, AND DRAIN REQUIREMENTS FOR SUCH EQUIPMENT WITH THE EQUIPMENT MANUFACTURER. DEVIATION OF THE AFOREMENTIONED REQUIREMENTS SHOULD BE BROUGHT TO THE ATTENTION OF THE ARCHITECT FOR CLARIFICATION. UNLESS ITEMS, MATERIALS, EQUIPMENT, OR WORK ARE SPECIFICALLY NOTED TO BE PROVIDED OR FURNISHED BY OTHERS, THEY SHALL BE PROVIDED BY THE CONTRACTOR UNDER THIS CONTRACT.
- ALL WORK SHALL BE PERFORMED BY SKILLED WORKERS IN A WORKMANLIKE AND PROFESSIONAL MANNER CONSISTENT WITH INDUSTRY STANDARDS. MATERIALS AND COMPONENTS AS SPECIFIED CONSTITUTE A STANDARD OF QUALITY, UNLESS OTHERWISE NOTED. EQUAL SUBSTITUTES WILL BE ACCEPTABLE ONLY WITH WRITTEN PRIOR APPROVAL BY
- THE CONTRACTOR SHALL PERFORM TESTS AT HIS/HER OWN EXPENSE, AS NECESSARY OR AS REQUIRED BY ANY INSPECTION AGENCY. TESTS SHALL BE MADE TO VERIFY WHETHER THE SYSTEM OR
- COMPONENTS INSTALLED COMPLY WITH THE SPECIFICATIONS AND ARE IN WORKING ORDER. THE CONTRACTOR SHALL LEAVE THE WORK IN PROPER WORKING ORDER AND SHALL, WITHOUT ADDITIONAL CHARGE, REPLACE ANY WORK, MATERIALS, OR EQUIPMENT FURNISHED AND INSTALLED UNDER THIS CONTRACT WHICH DEVELOPS DEFECTS, EXCEPT FROM ORDINARY WEAR AND TEAR, WITHIN ONE (1) YEAR FROM THE DATE OF FINAL ACCEPTANCE BY THE OWNER.


# **DEMOLITION NOTES**


- CONTRACTOR SHALL VERIFY EXISTING CONDITIONS.
- THE DEMOLITION PLANS ARE DERIVED FROM EXISTING PLANS AND ARE INTENDED TO REASONABLY REPRESENT EXISTING CONDITIONS.
- DEMOLITION NOTES ON THE DRAWINGS IDENTIFY SPECIFIC AREAS OF WORK BUT MAY NOT BE COMPLETE IN THE IDENTIFICATION OF ALL REMOVALS. THE CONTRACTOR SHALL VERIFY ACTUAL CONDITIONS AND COORDINATE THE DEMOLITION WITH NEW WORK SO THAT DEMOLITION IS COMPLETE.
- IT IS THE CONTRACTOR'S RESPONSIBILITY TO VERIFY THE DIMENSION OF ALL COMPONENTS TO BE DEMOLISHED. CONTRACTOR SHALL NOTIFY "DIG-SAFE" PRIOR TO COMMENCEMENT OF ANY DEMOLITION ACTIVITY.
- REMOVE ALL EXISTING CONSTRUCTIONS AND FINISHES NECESSARY FOR THE COMPLETION OF THE WORK AS DEPICTED ON THE DRAWINGS, INCLUDING BUT NOT LIMITED TO, ITEMS SHOWN ON THE PLANS WITH DASHED LINES. NECESSARY DISCONNECTS AND ALTERATIONS TO EXISTING MECHANICAL AND ELECTRICAL SYSTEMS SHALL BE INCLUDED. PATCH AS REQUIRED ALL CONSTRUCTIONS TO REMAIN IN ACCORDANCE WITH THE
- THE CONTRACTOR SHALL BE RESPONSIBLE FOR THE REMOVAL AND DISPOSAL OF MATERIALS TO BE DEMOLISHED. VERIFY WITH OWNER, THE DISPOSAL AND REMOVAL OF ANY COMPONENTS OF SALVAGEABLE VALUE. REMOVE FROM THE JOBSITE, AS SOON AS PRACTICAL, DEMOLISHED MATERIALS, DEBRIS, AND RUBBISH, DO NOT ACCUMULATE DEBRIS ON THE FLOOR OR AT THE SITE.
- ALL REMOVALS AND SALVAGE, UNLESS SPECIFICALLY NOTED OR REQUESTED BY THE OWNER, SHALL BECOME THE PROPERTY OF THE CONTRACTOR. REMOVE ONLY NON-LOAD-BEARING CONSTRUCTION AND PARTITIONS. CONTRACTOR TO VERIFY, PRIOR TO REMOVAL, THAT NO STRUCTURAL COMPONENTS (I.E. BEARING WALLS, BEAMS, HEADERS, ETC.) SUPPORTING FLOOR, ROOF, OR CEILING JOISTS ARE DESIGNATED FOR REMOVAL. THE CONTRACTOR SHALL NOTIFY THE ARCHITECT PRIOR TO REMOVAL OF ANY CONSTRUCTION IN QUESTION OR DEVIATING FROM THE DESIGN INTENT.
- CONTRACTOR'S NON-CONTACT OF ARCHITECT PRIOR TO REMOVAL OF ANY WORK INDICATES HIS COMPLETE UNDERSTANDING THAT NO LOAD-BEARING OR STRUCTURAL WORK IS BEING ALTERED UNDER THIS CONTRACT. ALL STRUCTURAL SYSTEMS SHALL BE MAINTAINED AND SHALL BE OF SUFFICIENT STRENGTH TO SUPPORT THE DESIGN LOADS AND TO RESIST THE DEFORMATION CAUSED BY SUCH LOADS. CONTRACTOR SHALL BE RESPONSIBLE FOR PROVIDING ANY TEMPORARY SHORING ASSOCIATED WITH ANY DEMOLITION WORK.
- PATCH ALL FINISHES TO MATCH EXISTING, INCLUDING BUT NOT LIMITED TO: GYPSUM BOARD, PLASTER, ACOUSTIC SYSTEMS, WOOD TRIM, COVERS, BASE, PANELS, AND RAILS. VERIFY MATCH OF NEW FINISH MATERIALS TO EXISTING IN: COLOR, TEXTURE, THICKNESS, AND CUT TO SATISFACTION OF OWNER PRIOR TO INSTALLATIONS, PROVIDE OTHER MATERIALS TO MATCH EXISTING WHEN REQUIRED - TO BE APPROVED BY ARCHITECT AND

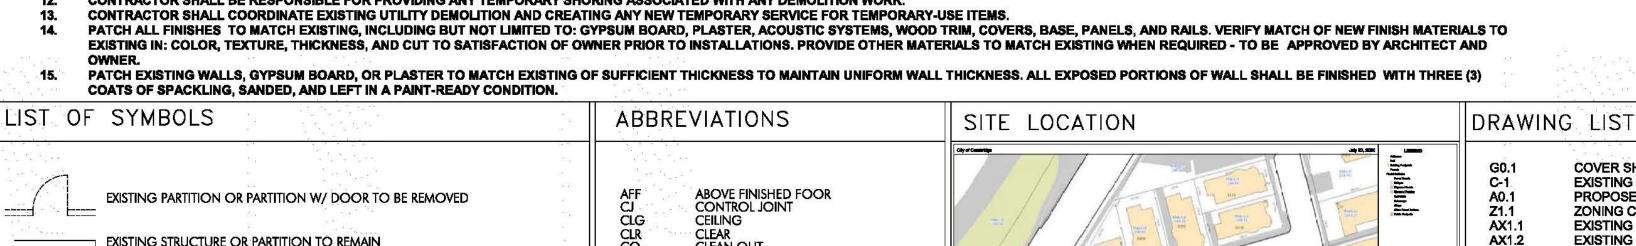

WNDW

WINDOW

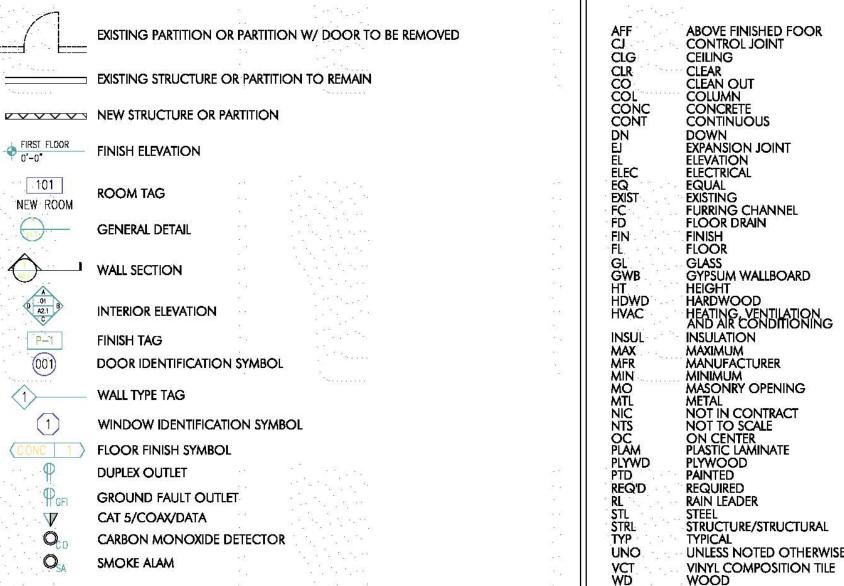

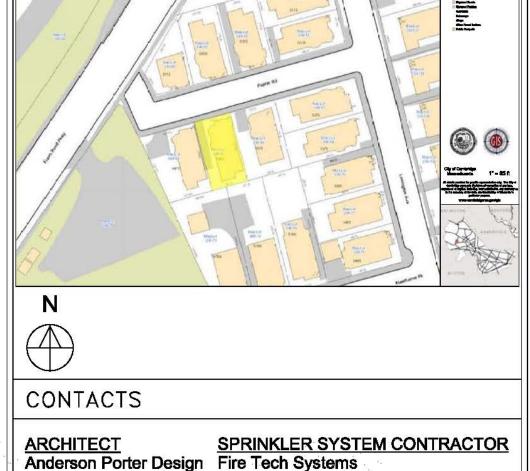

136 Golden Road 875 Main Street Stoughton MA 02072 Cambridge MA 02139 617-892-2803 Dan Anderson 617.354.2501

271 Lincoln Street, STE 10

Lexington MA 02421

781-460-8437

**DND Homes LLC** 

**COVER SHEET** 

AX2.1

AX2.2

AD1.1

A1.1

A2.3

A3.1

A5.1

A8.2

EXISTING CIVIL PLAN

ZONING CODE REVIEW

**EXISTING FLOOR PLANS** 

**EXISTING FLOOR PLANS** 

EXISTING ELEVATIONS

**EXISTING ELEVATIONS** 

**DEMOLITION FLOOR PLANS** 

**DEMOLITION FLOOR PLANS** 

PROPOSED FLOOR PLANS

PROPOSED FLOOR PLANS

PROPOSED ELEVATIONS

PROPOSED ELEVATIONS

PROPOSED ELEVATIONS

SCHEDULES AND DETAILS

REFLECTED CEILING PLANS

REFLECTED CEILING PLANS

FIRE SPRINKLER BASEMENT PLAN


1ST-3RD FLR SIRE SPRINKLER FLOOR PLANS

PROPOSED SECTIONS

PROPOSED SECTIONS

NOTES AND DETAILS

PROPOSED LANDSCAPE PLAN

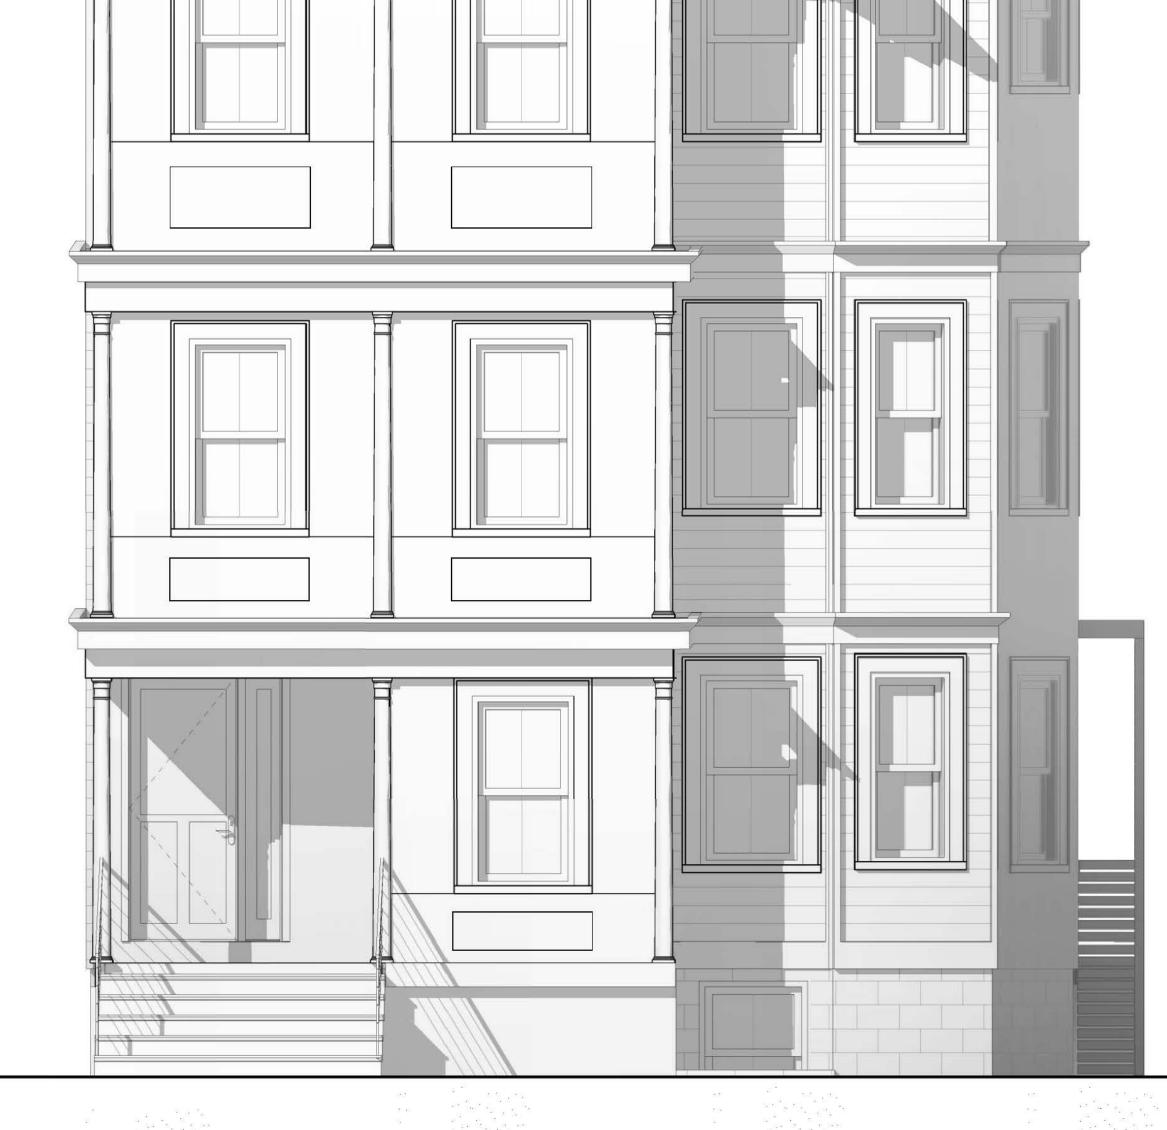

USE AND OCCUPANCY - RESIDENTIAL (DETACHED THREE-FAMILY DWELLING) Smoke alarms shall be provided and located as required. **BUILDING CONSTRUCTION - TYPE V-B** SECTION 315 CARBON MONOXIDE ALARMS

CODE SUMMARY CODE REFERENCE: MASSACHUSETTS STATE BUILDING CODE 780 CMR 9TH EDITION, COMMERCIAL CODE AMENDMENTS; IBC 2015; IEBC 2015

ALTERATIONS - LEVEL 3

**CHAPTER 3 - BUILDING PLANNING** 

SECTION R302 FIRE-RESISTANT CONSTRUCTION Dwelling units shall be separated by a 1-hour fire-resistance rated wall. R302.7 Enclosed space under stairs that is accessed by door or access panel shall be covered with 1/2" gypsum board.

Fireblocking shall be provided per code. SECTION R303 LIGHT, VENTILATION AND HEATING Mechanical ventilation shall be provided R303.10 Dwelling units shall be provided with required heating.

SECTION R304 MINIMUM ROOM AREAS All habitable room areas shall comply with code. **SECTION 305 CEILING HEIGHT** 

Ceiling heights shall be equal to, or greater than, minimum requirements. SECTION 306 SANITATION Toilet fixtures, kitchens, sewage disposal, and water supply to fixtures shall

SECTION 307 TOILET, BATH AND SHOWER SPACES Tollet, baths, and showers spaces shall comply with code. SECTION 308 GLAZING

All glazing shall comply with code.

comply with code.

SECTION 309 GARAGES AND CARPORTS This section of the code is not applicable to the proposed design SECTION 310 EMERGENCY ESCAPE AND RESCUE OPENINGS Emergency and escape rescue openings shall have net clear openings that

SECTION 311 MEANS OF EGRESS Each dwelling unit shall be provided with a means of egress with clear widths that comply with code. Code Reference 1006.2.1 In Group R-2 and CHAPTER 7 - WALL COVERING R-3 occupancies, one means of egress is permitted within and from individual dwelling units with a maximum occupant load of 20 where the dwelling unit is equipped throughout with an automatic sprinkler system in

accordance with Section 903.3.1.1 or 903.3.1.2 and the common path of egress travel does not exceed 125 feet. All interior doors shall have nominal widths and heights that comply with Riser heights shall not be more than 81/4". Tread depths shall not be less

than 9". Winder treads shall have a minimum tread depth of 3" at any point. SECTION 312 GUARDS AND WINDOW FALL PROTECTION Guard locations and heights, and window openings and fall protections shall comply with code SECTION 313 AUTOMATIC FIRE SPRINKLER SYSTEMS

The proposed design does not have an aggregate area greater than 14,400 The proposed design includes a fire sprinkler system.

Carbon monoxide alarms shall be provided and located as

SECTION 316 FOAM PLASTIC GC shall verify that any form plastics used shall comply with code. SECTION 317 PROTECTION OF WOOD AND WOOD-BASED PRODUCTS AGAINST

GC shall verify that construction complies with code. SECTION 318 PROTECTION AGAINST SUBTERRANEAN TERMITES

GC shall verify that construction complies with code. **SECTION 319 SITE ADDRESS** Both units shall be provided with address identification that complies with code.

SECTION 320 ACCESSIBILITY This section is not applicable to the proposed design. SECTION 321 ELEVATORS AND PLATFORM LIFTS

CHAPTER 6 - WALL CONSTRUCTION

This section is not applicable to the proposed design. SECTION 322 FLOOD-RESISTANT CONSTRUCTION The basement shall be constructed to anticipate the estimated

seasonal high ground water level. **SECTION 323 STORM SHELTERS** This section is not applicable to the proposed design. **SECTION 324 SOLAR ENERGY SYSTEMS** This section is not applicable to the proposed design.

**CHAPTER 4 - FOUNDATIONS** GC shall verify that construction complies with code. GC shall verify that construction complies with code.

GC shall verify that construction complies with code GC shall verify that construction complies with code CHAPTER 8 - ROOF-CEILING CONSTRUCTION


GC shall verify that construction complies with code CHAPTER 9 - ROOF ASSEMBLIES GC shall verify that construction complies with code

IMNEY AND FIREPLACES GC shall verify that construction complies with code **CHAPTER 11 - ENERGY EFFICIENCY** 

GC shall use the energy efficiency requirements of 780 CMR 11 Appendix AA. The proposed design is the alteration, renovation, addition, and repair of an existing building.

PERMIT SET

REVISIONS Description

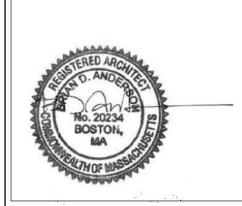

**AndersonPorterDesign** 875 Main Street, Cambridge, MA 02139 Tel. 617.354.2501 Fax. 617.354.2509

8 POPLAR ROAD


8 POPLAR ROAD CAMBRIDGE, MA 02138


**COVER SHEET** 

Drawing Issued By: ANDERSON PORTER DESIGN Project # 2017 Drawn No. Date 10/22/2020 G0.1 Scale 3/8" = 1'-0" Drawn by DA/ER/KA





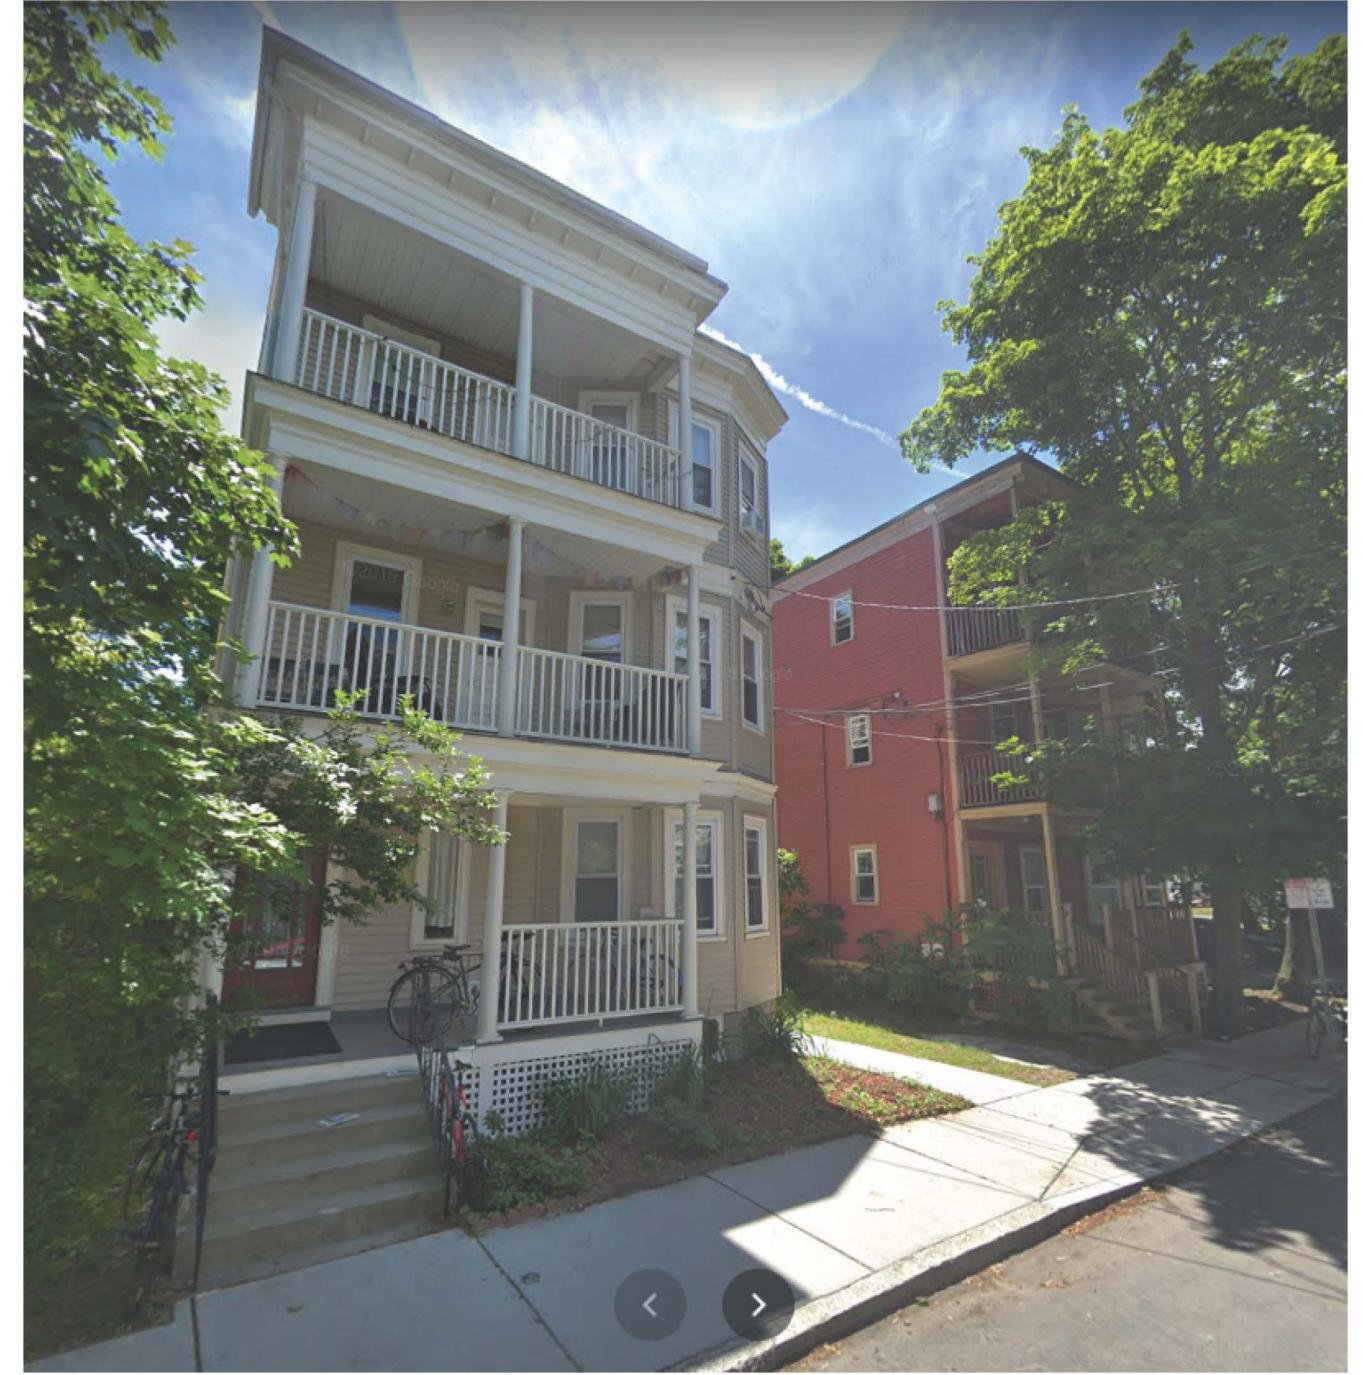

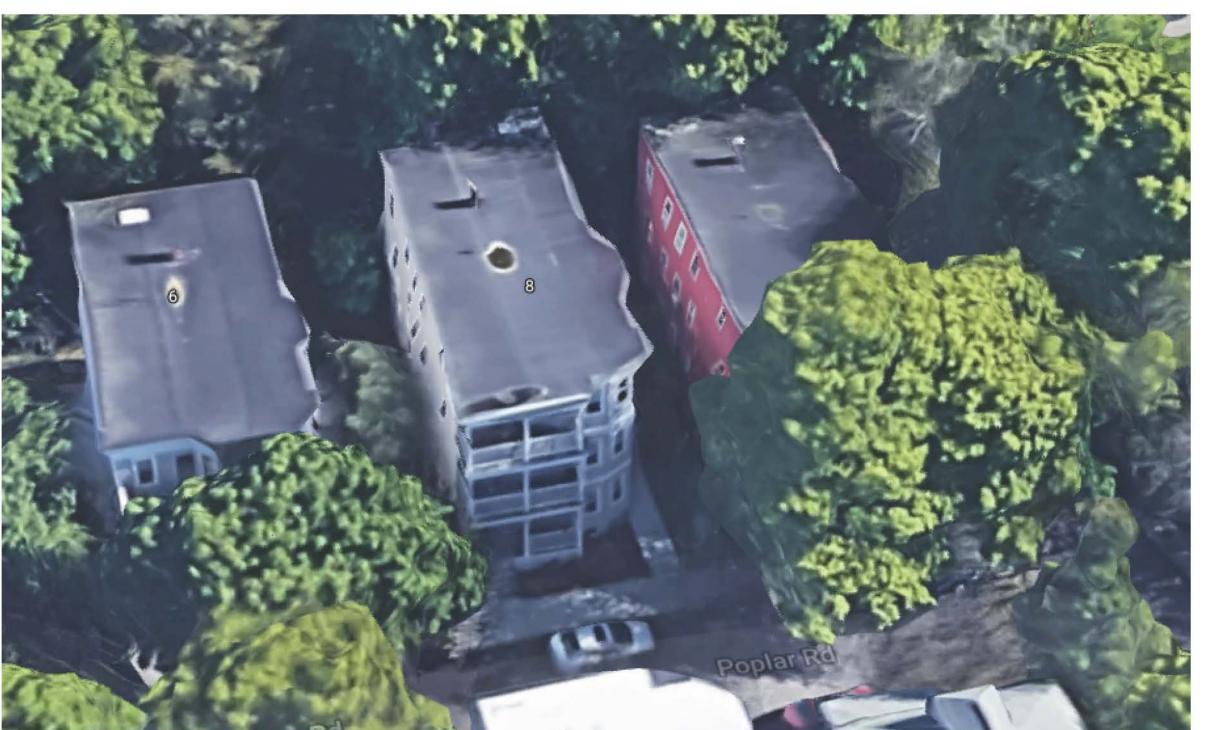

No.	Description	Date
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74		-473



AndersonPorterDesign 875 Main Street, Cambridge, MA 02139 Tel. 617.354.2501 Fax. 617.354.2509

8 POPLAR ROAD

8 POPLAR ROAD CAMBRIDGE, MA 02138

SITE PHOTOS

Project # 2017 Drawn No.

Dete 10/22/2020

Scale 1/4" = 1'-0"

Drawn by ER/DS/KA


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# LEGEND: BULKHEAD BITUMINOUS CB CONC CLF DMH GW SWH VGC **CATCH BASIN** CONCRETE CHAIN LINK FENCE DRAIN MANHOLE **GAS METER GAS VALVE** SEWER MANHOLE VERTICAL GRANITE CURB WDFE W/F WV WOOD FENCE **WOOD FRAME WATER VALVE** × 22.04 CB × 21.32 R=21.32 21.75 DMH R=21.72 ① GATE BOLT ELEV = 22.26' SMH (S) R=21.74 × 21.74 × 21.90 **POPLAR** (PUBLIC - 40' WIDE) \_21.73 VGC 22.25 22.16 kg (3 STORY) 10.4' THRESHOLD \_\_\_ ELEV=26.0' 22.05 No. 6 POPLAR RD No. 10 POPLAR RD CATHERINE E. SULLIVAN 10 POPLAR RD CONDOMINIUM 3 STORY W/F 23.04 6,000 SF± 22.62 <u>BENCHMARK</u> TOP OF CONC FOOTING AT DECK CORNER ELEV = 22.67' S 77°04'16" W RECORD OWNERS: SERIES E OF LEGACIES PROPERTY, LLC 1837 TRAPELO ROAD No. 9-11 HAWTHORNE PARK No. 13-15 HAWTHORNE PARK WALTHAM, MA 02451 9-11 HAWTHORNE PARK EDWARD B. DENNEY & CONDOMINIUM JENNIFER MILES REFERENCES: CERTIFICATE NO. 239559 LCC NO. 5436 C LCC NO. 5436 D LCC NO. 5436 G NOTES:

SCALE: 1" = 10 FT.

- 1.) THIS PLAN WAS PREPARED FROM AN INSTRUMENT SURVEY PERFORMED IN SEPTEMBER 15, 2020.
- 2.) THE LOCATION OF SUBSURFACE UTILITIES WERE NOT INCLUDED AS PART OF THIS SURVEY. UTILITY STRUCTURES SHOWN HEREON ARE FROM THE LOCATION OF VISIBLE SURFACE EVIDENCE. THE LOCATION OF SUBSURFACE UTILITIES ARE NOT WARRANTED TO BE CORRECT, NOR DOES THE SURVEYOR GUARANTEE THAT ALL UTILITIES ARE SHOWN. THE CONTRACTOR SHALL VERIFY ALL UTILITIES AND CONTACT "DIG SAFE" (1-800-DIG-SAFE) PRIOR TO THE COMMENCEMENT OF WORK.
- 3.) A TITLE EXAMINATION WAS NOT PROVIDED FOR THIS SURVEY. AS SUCH OTHER MATTERS OF RECORD MAY EXIST AND NOT BE SHOWN HEREON.

4.) VERTICAL DATUM IS NAVD 88.

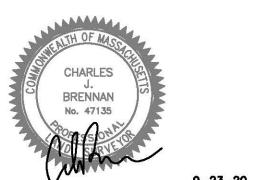

TOPOGRAPHIC SITE PLAN

CAMBRIDGE, MA


AT 8 POPLAR ROAD PREPARED FOR

DND HOMES LLC

SUMMIT SURVEYING INC.

4 SOUTH POND STREET, NEWBURYPORT, MA 01950 TEL. 978-692-7109 WWW.SUMMITSURVEYINGINC.COM 20-0151


**SEPTEMBER 23, 2020** 

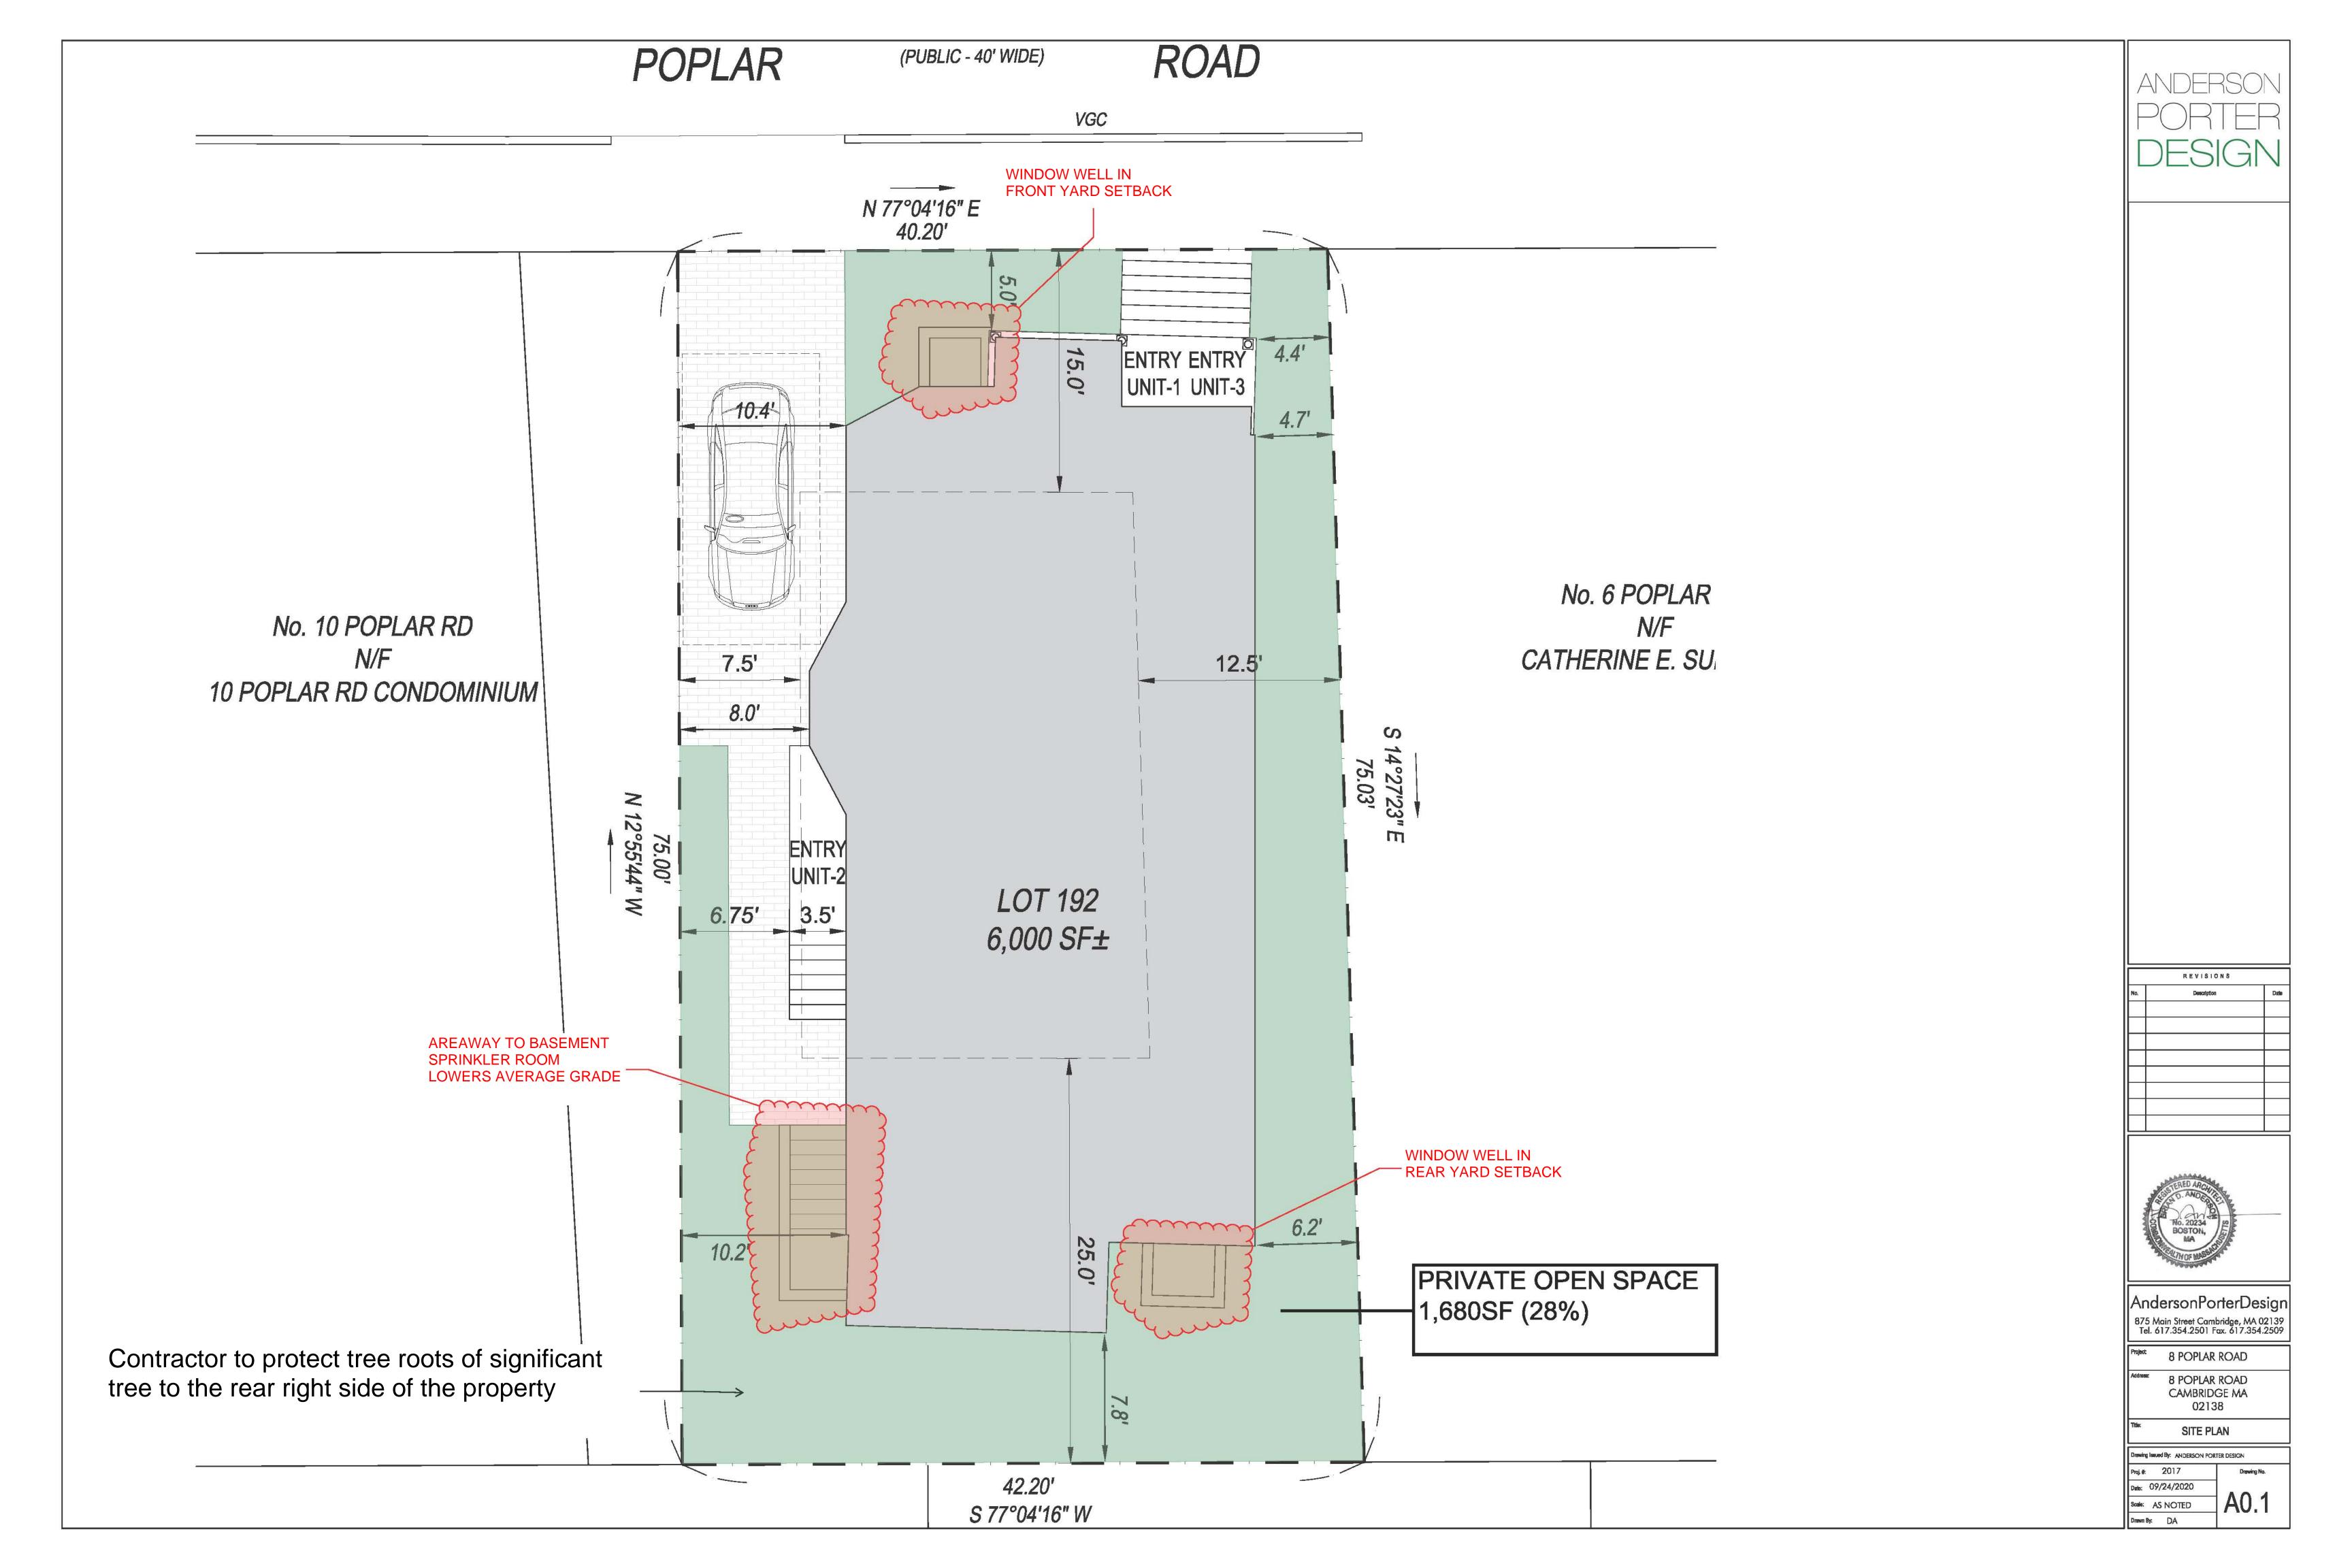

## DIMENSIONAL INFORMATION

APPLICANT: DND Homes/Anderson Porter Design PRESENT USE/OCCUPANCY: Residential 3 family


LOCATION: 8 Poplar R	oad		ZONE: I	Res. B	
<b>PHONE:</b> 617-794/23	71	REQUESTED US	SE/OCCUPANCY:	Residential 3	family
		EXITING CONDITIONS	REQUESTED CONDITIONS	ORDINANCE REQUIREMENT	<u>s1</u>
TOTAL GROSS FLOOR ARE	<u>A:</u>	5662	5662	1546.5	(max.)
LOT AREA:		3093		5000	(min.)
RATIO OF GROSS FLOOR AREA TO LOT AREA: 2		1.83	1.83	5	(max.)
LOT AREA FOR EACH DWE	LLING UNIT:	1031	1031	2500	(min.)
SIZE OF LOT:	WIDTH	40.20		50	(min.)
Setbacks in Feet:	DEPTH FRONT	75.00	5	15	(min.)
SIZE OF BUILDING:	REAR LEFT SIDE RIGHT SIDE HEIGHT LENGTH WIDTH	7.8 4.4 10.2 35.3 52.5 25.3	7.8 4.4 10.2 38.1 52.5 25.3	25 12.5(sum 20 7.5 35	(min.) (min.) (min.) (max.)
RATIO OF USABLE OPEN SPACE TO LOT AREA:		28%	28%	40%	(min.)
NO. OF DWELLING UNITS	<u>:</u> _	3	3	1	(max.)
NO. OF PARKING SPACES	<u>:</u>	1	1	3	(min/max.)
NO. OF LOADING AREAS:		N/A	N/A	N/A	(min.)
DISTANCE TO NEAREST		N/A	N/A	N/A	(min.)

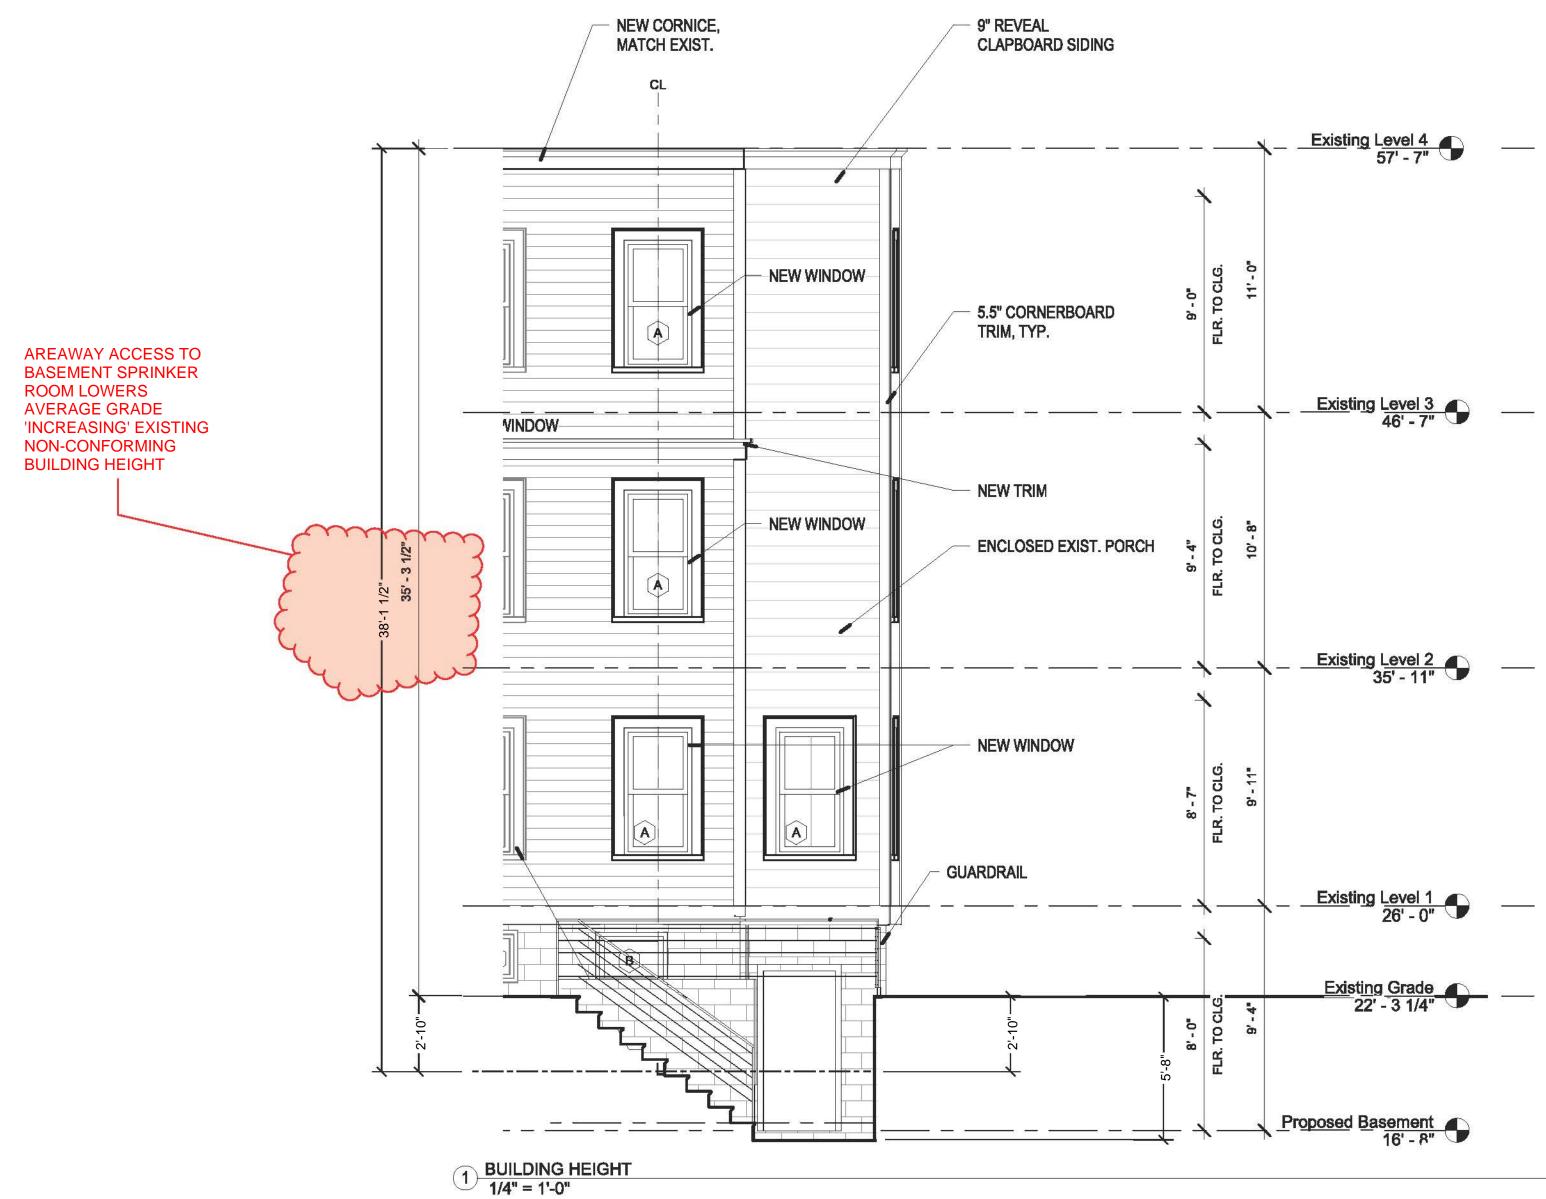


NET AREA CALCULATIONS


BASEMENT: 1ST FLOOR: 2ND FLOOR: 3RD FLOOR: TOTAL SF: 1183 SF 1493 SF 1493 SF 1493 SF 5662 SF

BLDG. ON SAME LOT

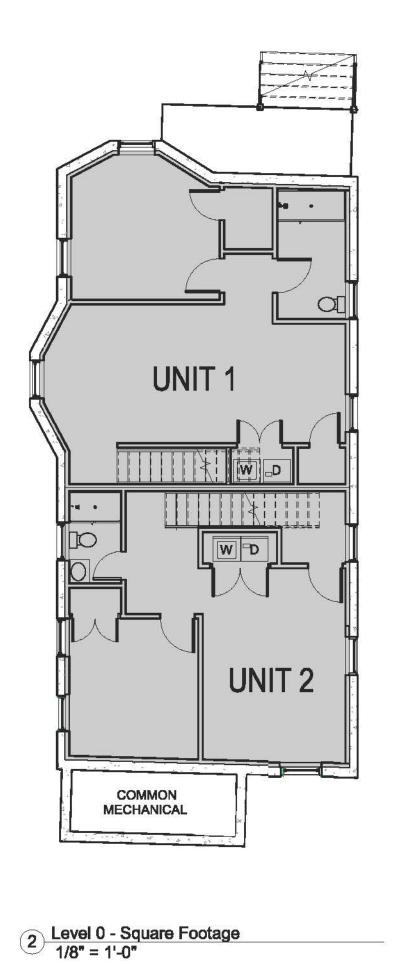


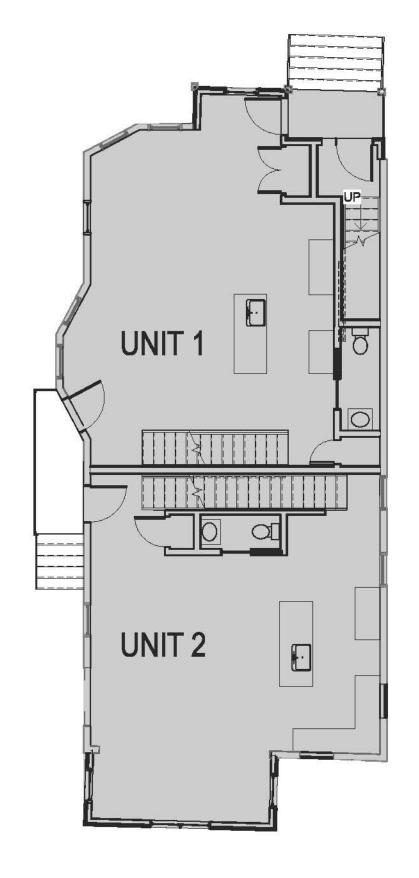

3 Level 1 - Square Footage 1/8" = 1'-0"

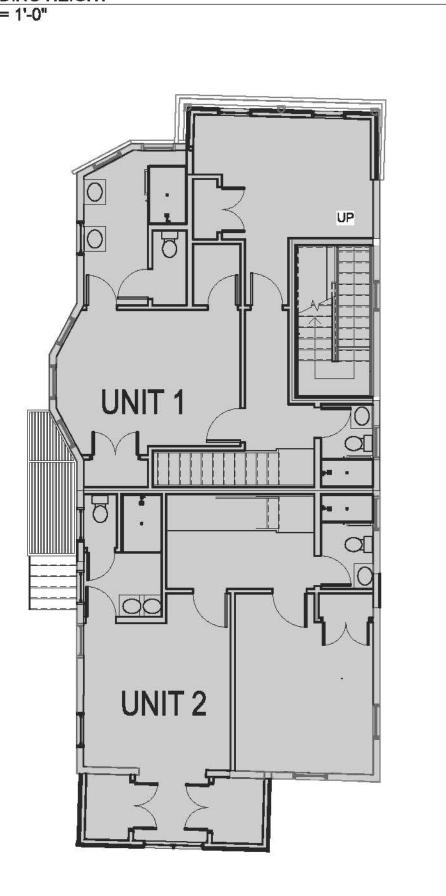

4 Level 2 - Square Footage 1/8" = 1'-0"

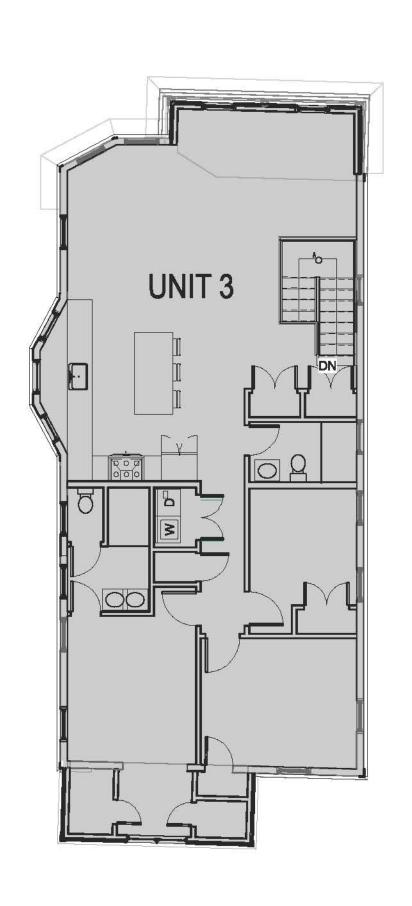

5 Level 3 - Square Footage 1/8" = 1'-0"



PERMIT SET

REVISIONS								
No.	Description	Date						
		3						
		72						



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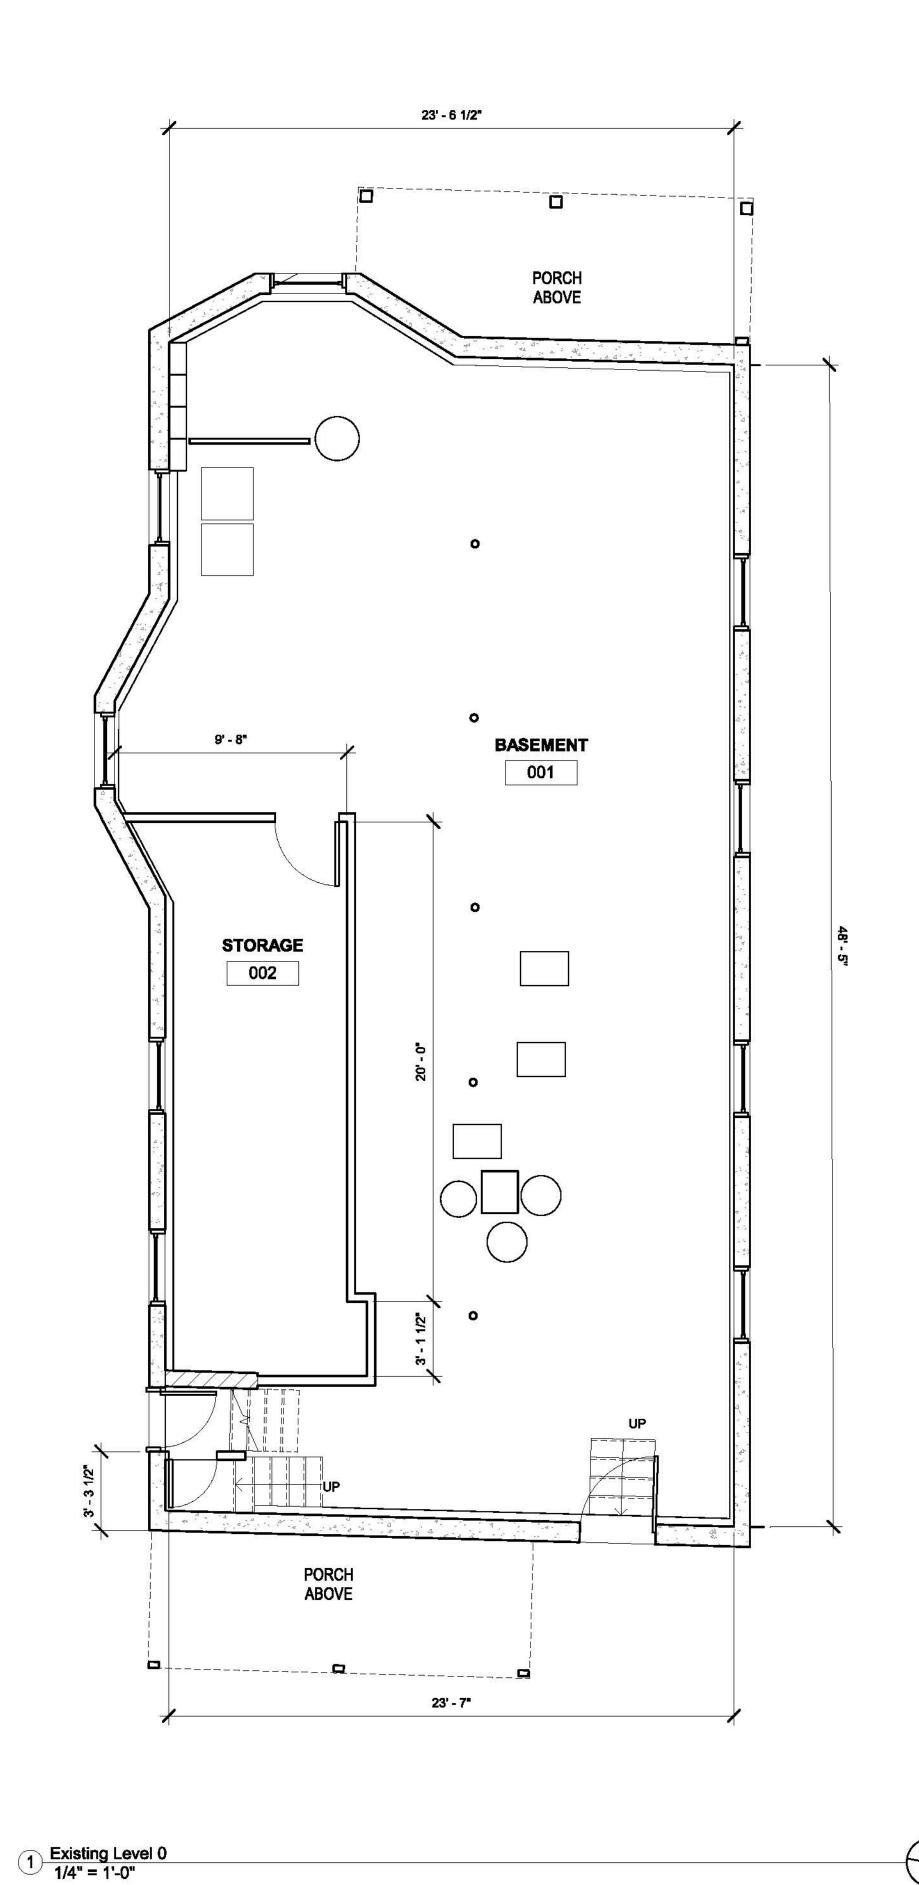
8 POPLAR ROAD


8 POPLAR ROAD CAMBRIDGE, MA 02138

ZONING SUMMARY PAGE

Project # 2017 Date 10/22/2020 Scale As indicated

Drawn by ER




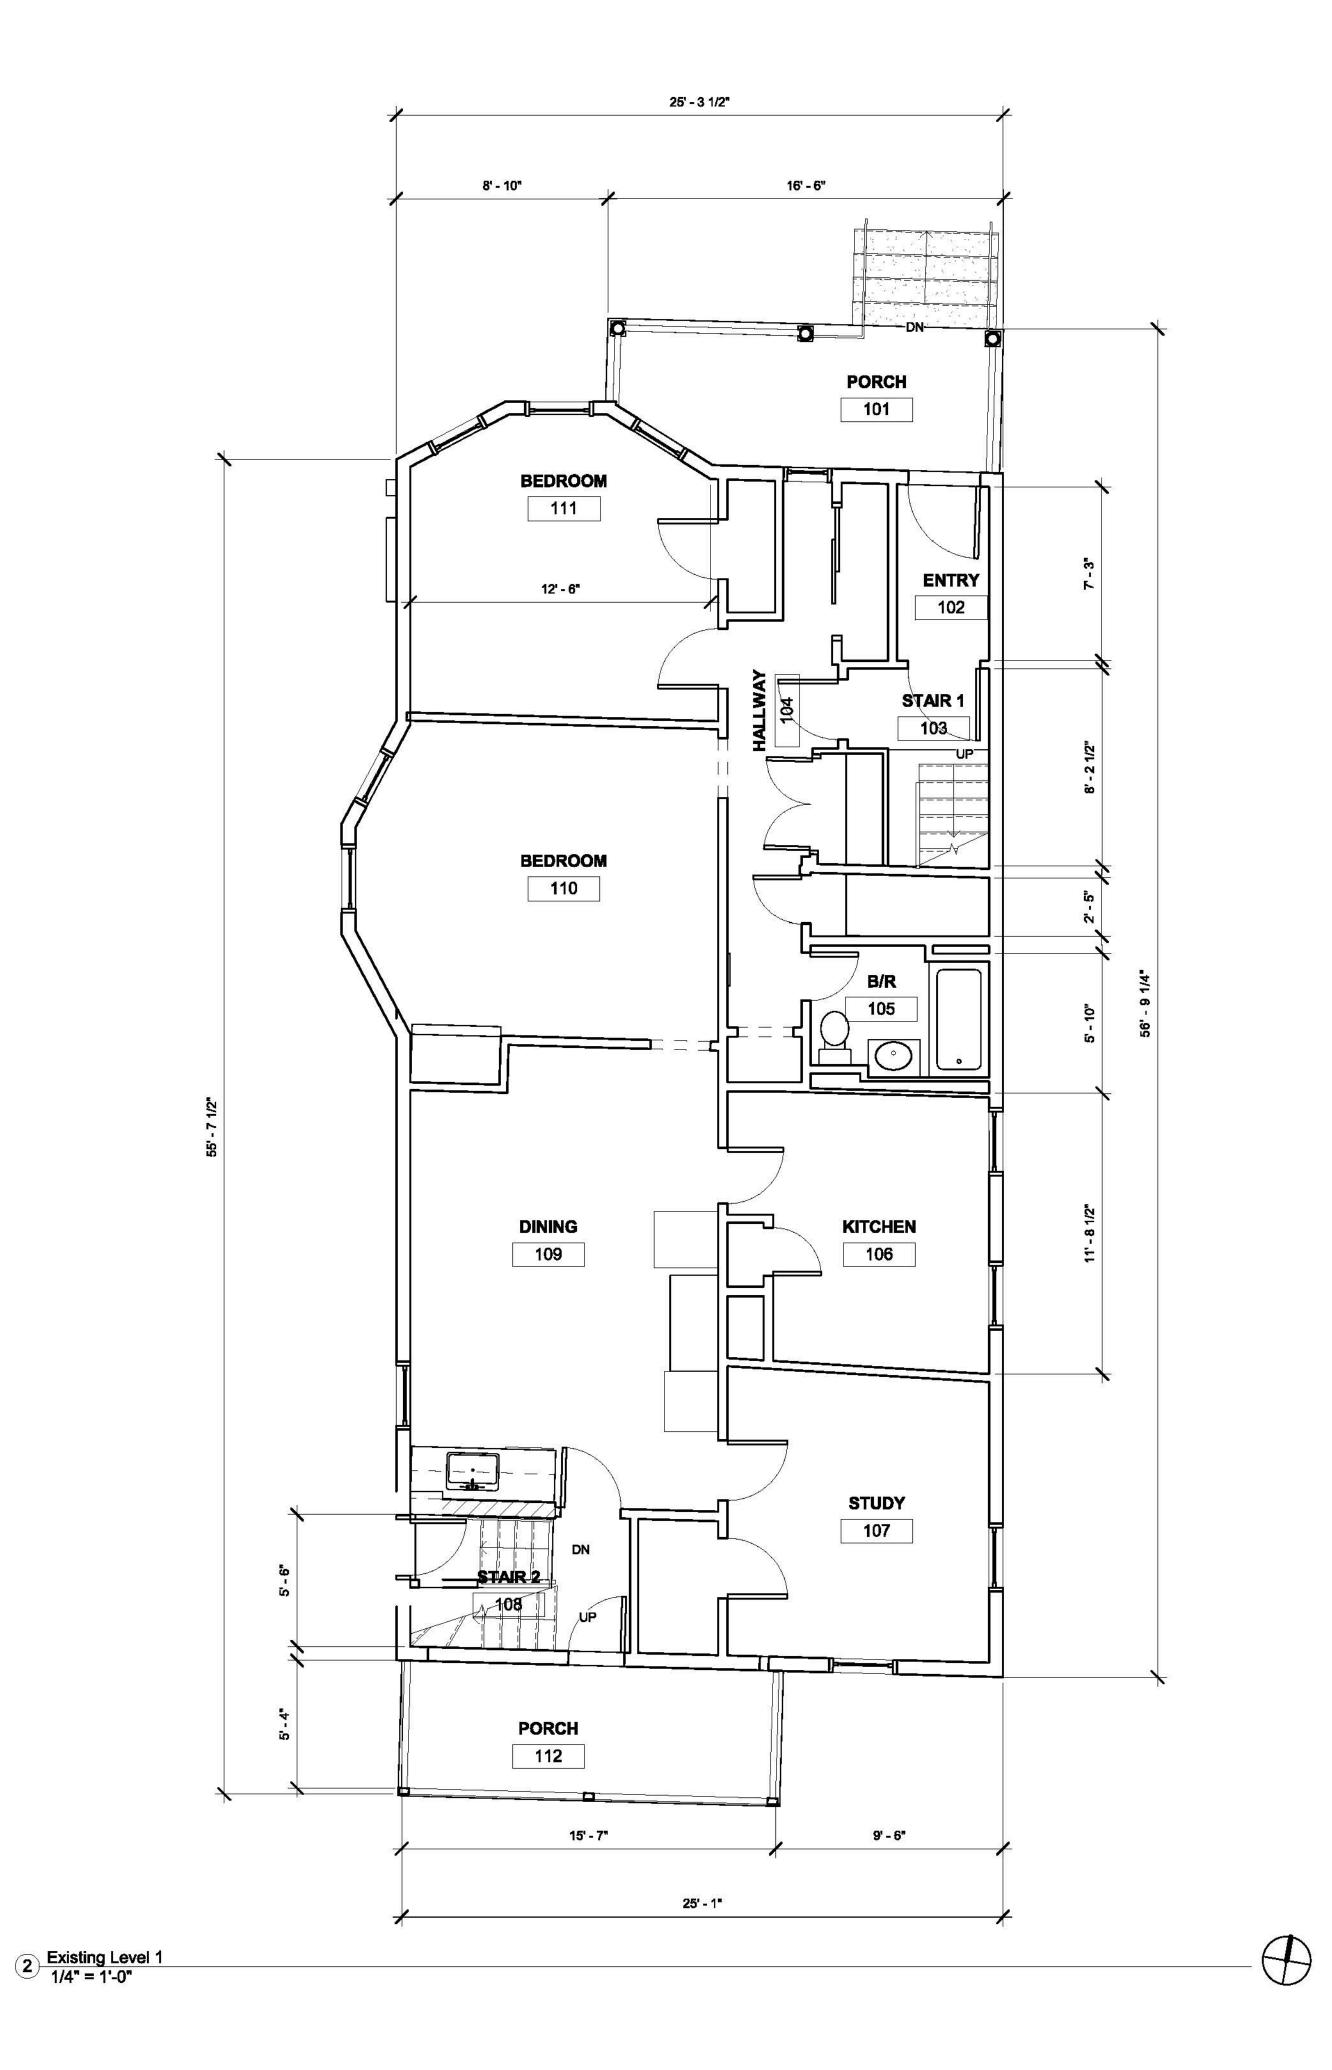



REVISIONS

No. Description Date

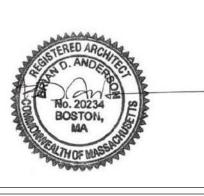


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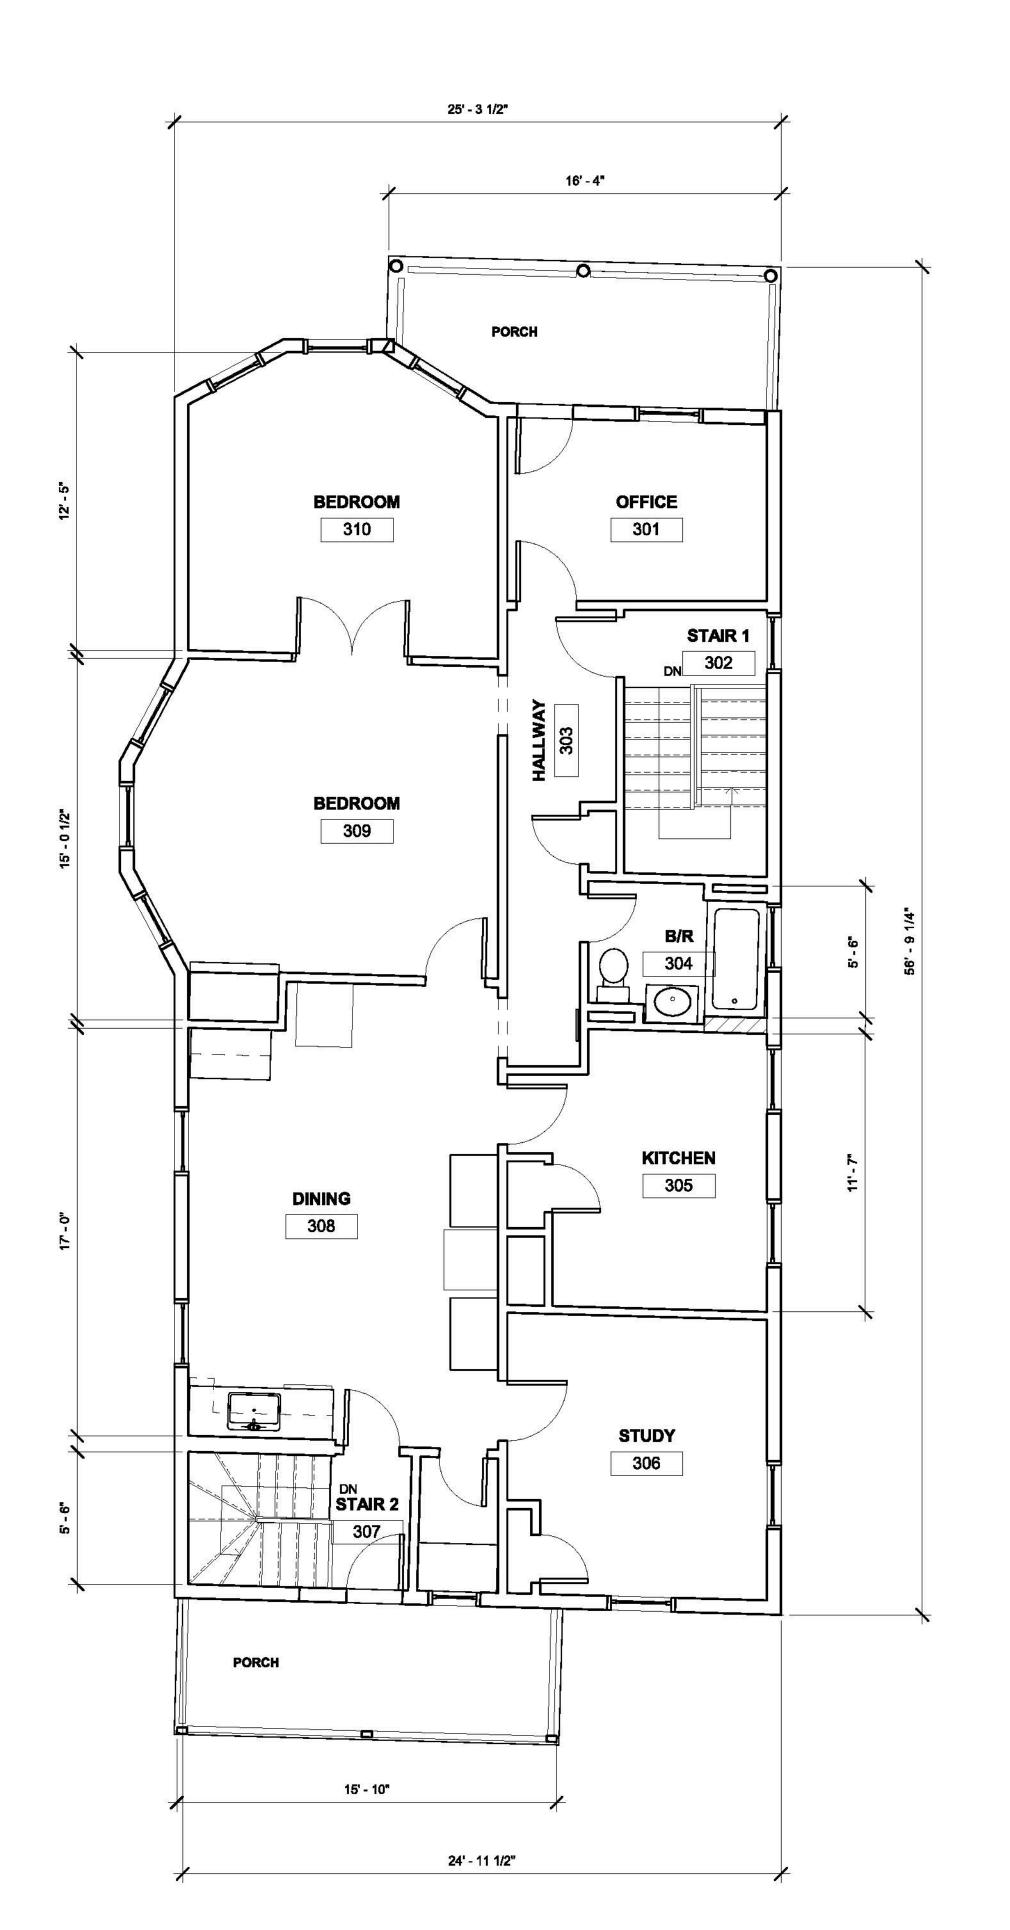
Project:
8 POPLAR ROAD

8 POPLAR ROAD CAMBRIDGE, MA 02138

EXISTING FLOOR PLANS

Drewn by ER/DS/KA



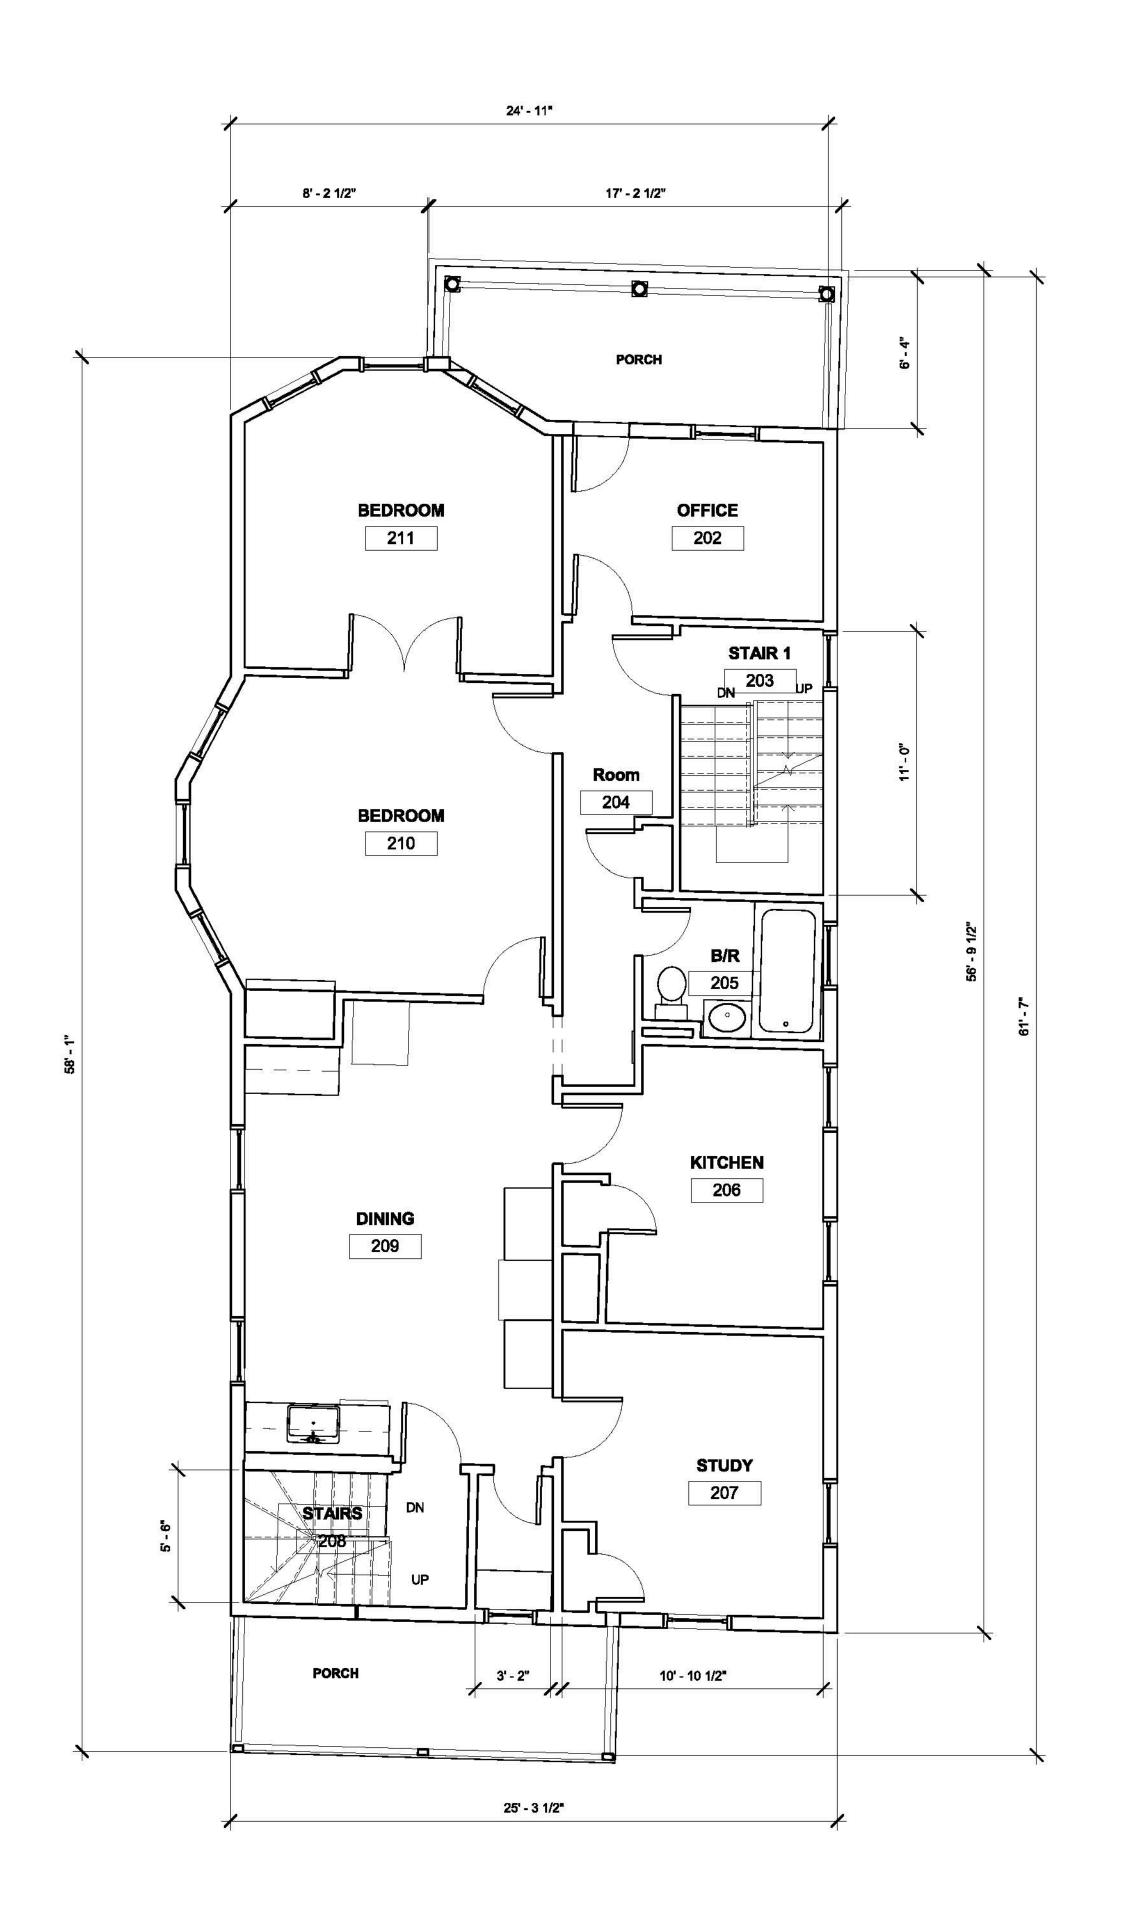



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Project: 8 POPLAR ROAD

8 POPLAR ROAD CAMBRIDGE, MA 02138

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EXISTING FLOOR PLANS

1/4" = 1'-0"





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8 POPLAR ROAD


8 POPLAR ROAD CAMBRIDGE, MA 02138

EXISTING ELEVATIONS


Project# 2017

Deta 10/22/2020 Scale 1/4" = 1'-0"

Drawn by ER/DS/KA

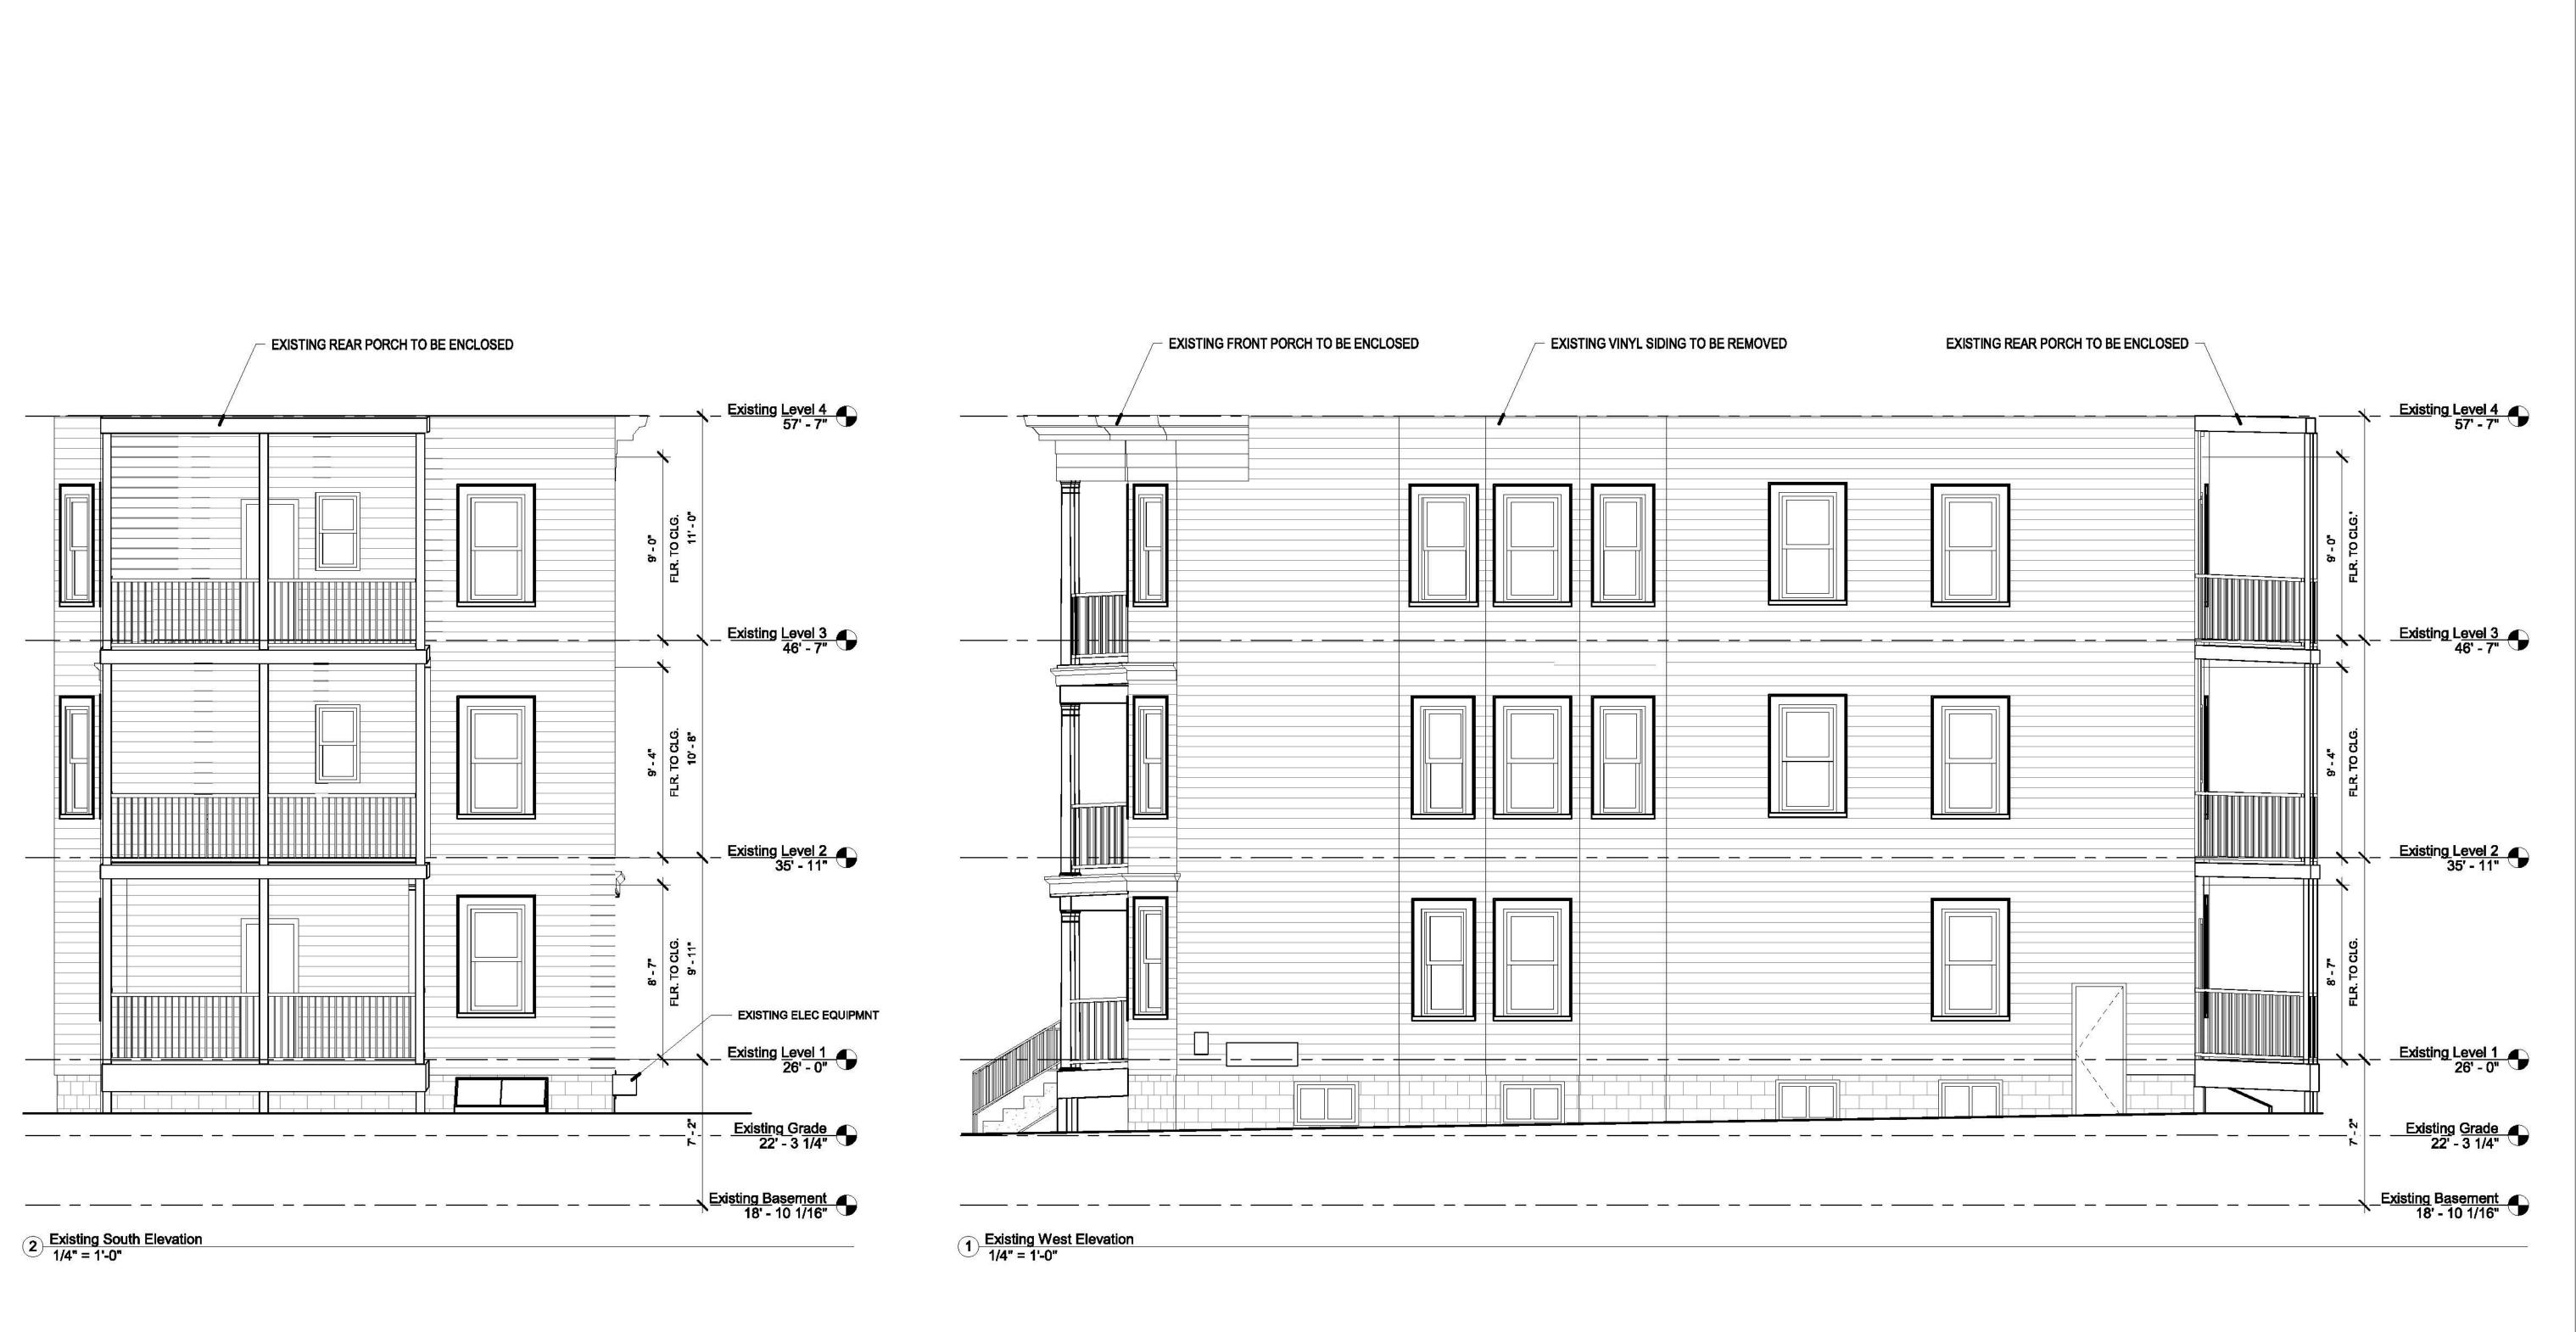

REVISIONS

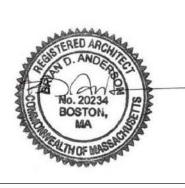


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8 POPLAR ROAD

8 POPLAR ROAD CAMBRIDGE, MA 02138


**EXISTING ELEVATIONS** 

Deta 10/22/2020 Scale 1/4" = 1'-0" Drawn by ER/DS/KA

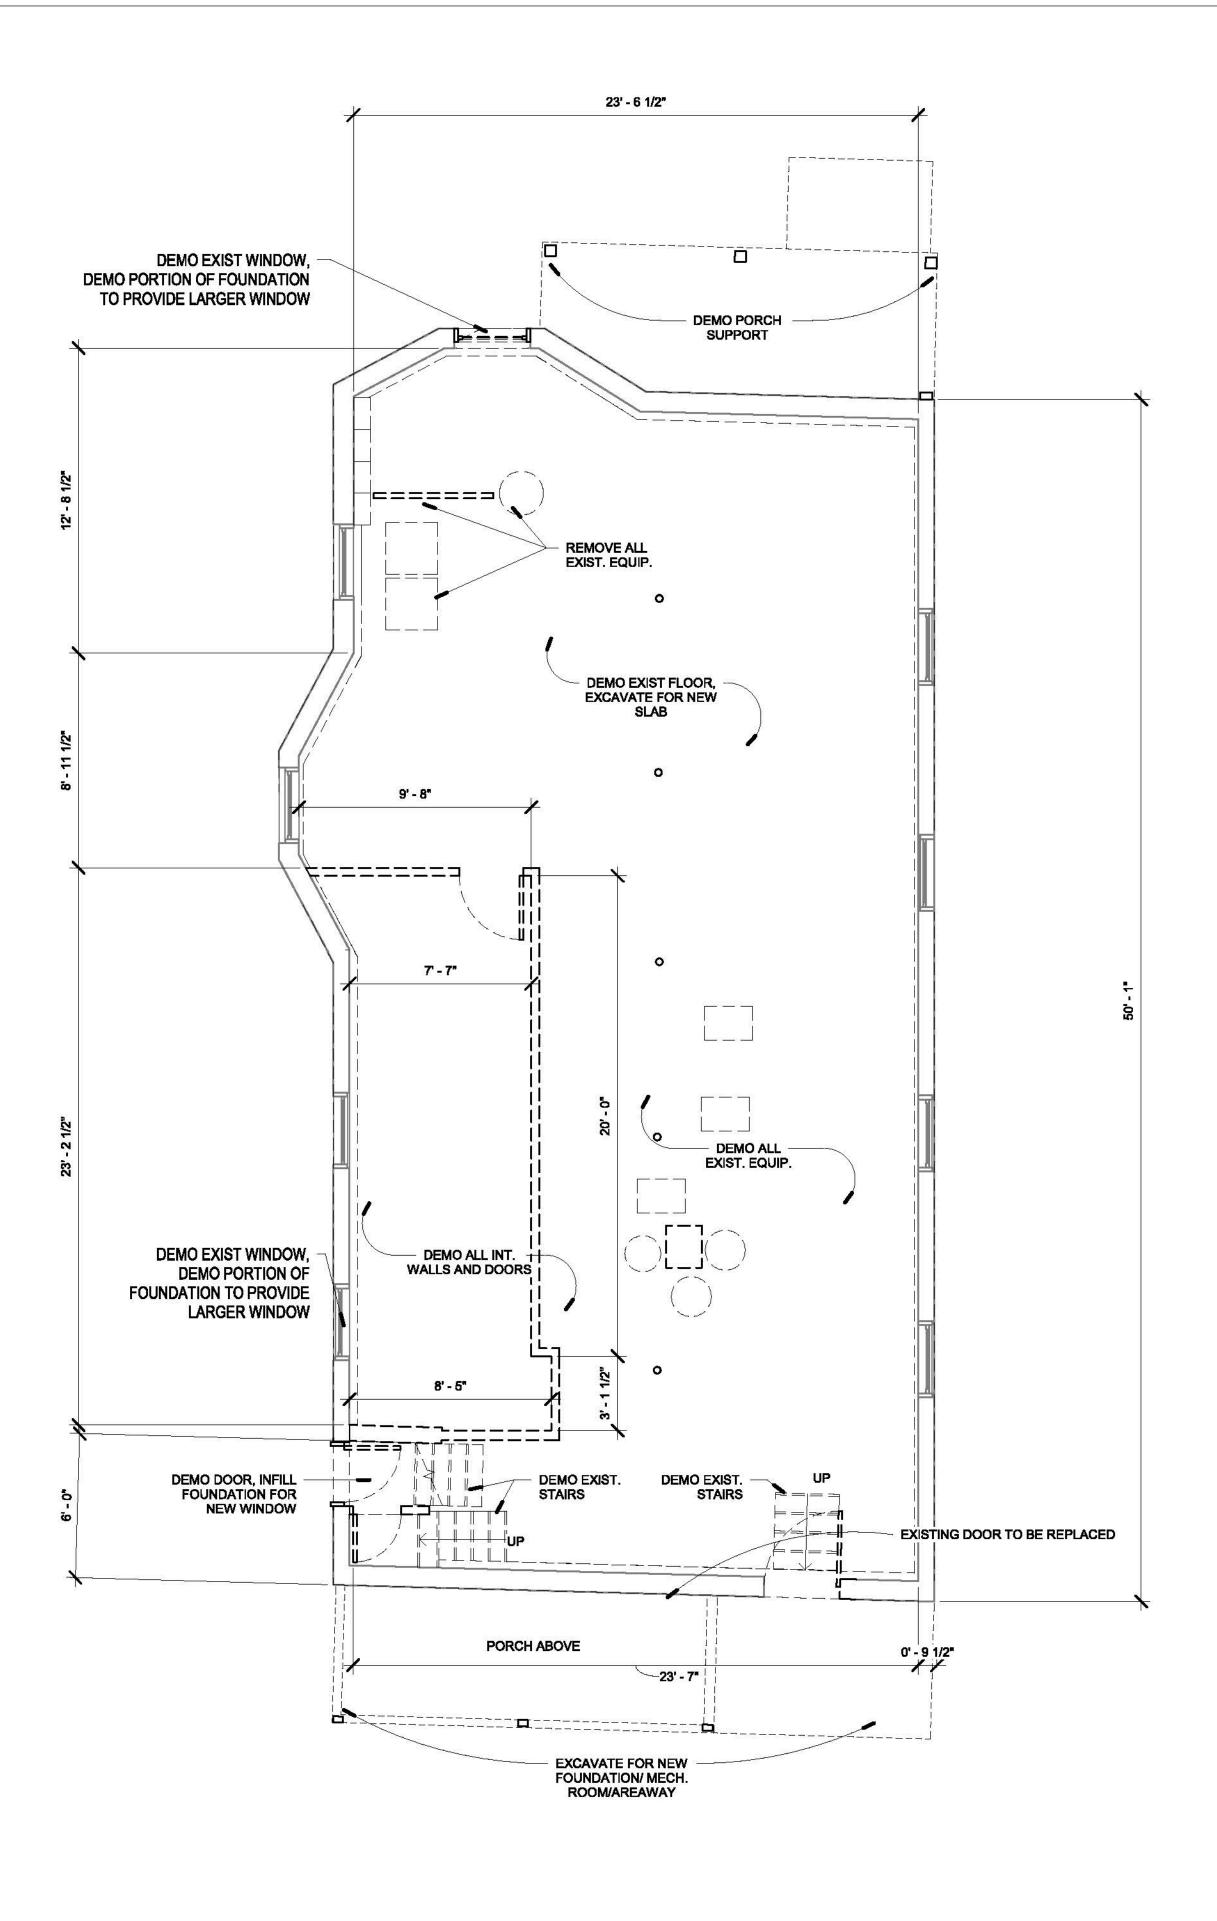

\*ALL EXISTING WINDOWS TO BE REPLACED IN EXIST.
OPENINGS UNLESS OTHERWISE NOTED\*

1 Demolition Level 0
1/4" = 1'-0"

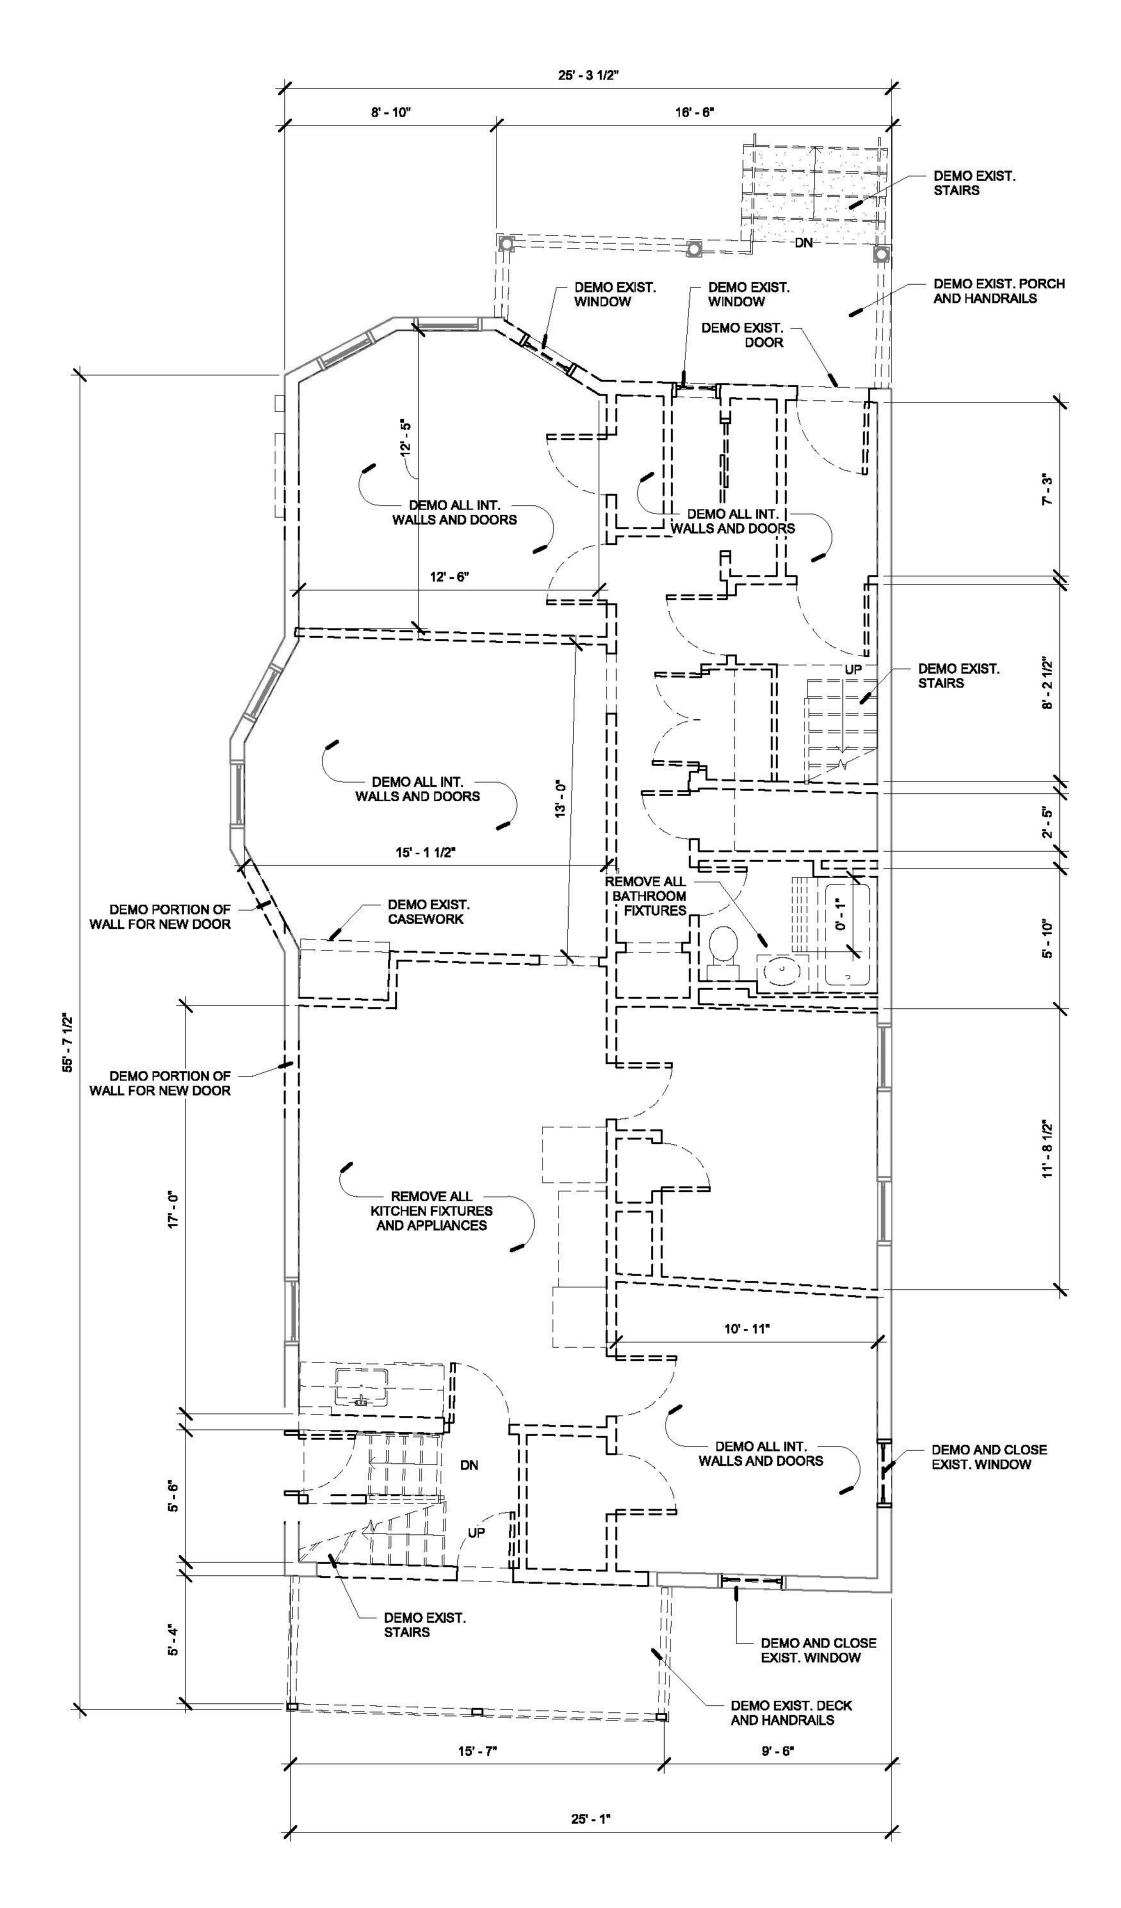

\*ALL EXISTING WINDOWS TO BE REPLACED IN EXIST.
OPENINGS UNLESS OTHERWISE NOTED\*

2 Demolition Level 1
1/4" = 1'-0"



PERMIT SET

REVISIONS
No. Description Date




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8 POPLAR ROAD


Address: 8 POPLAR ROAD CAMBRIDGE, MA 02138

DEMOLITION PLANS

Drewn by ER/DS/KA

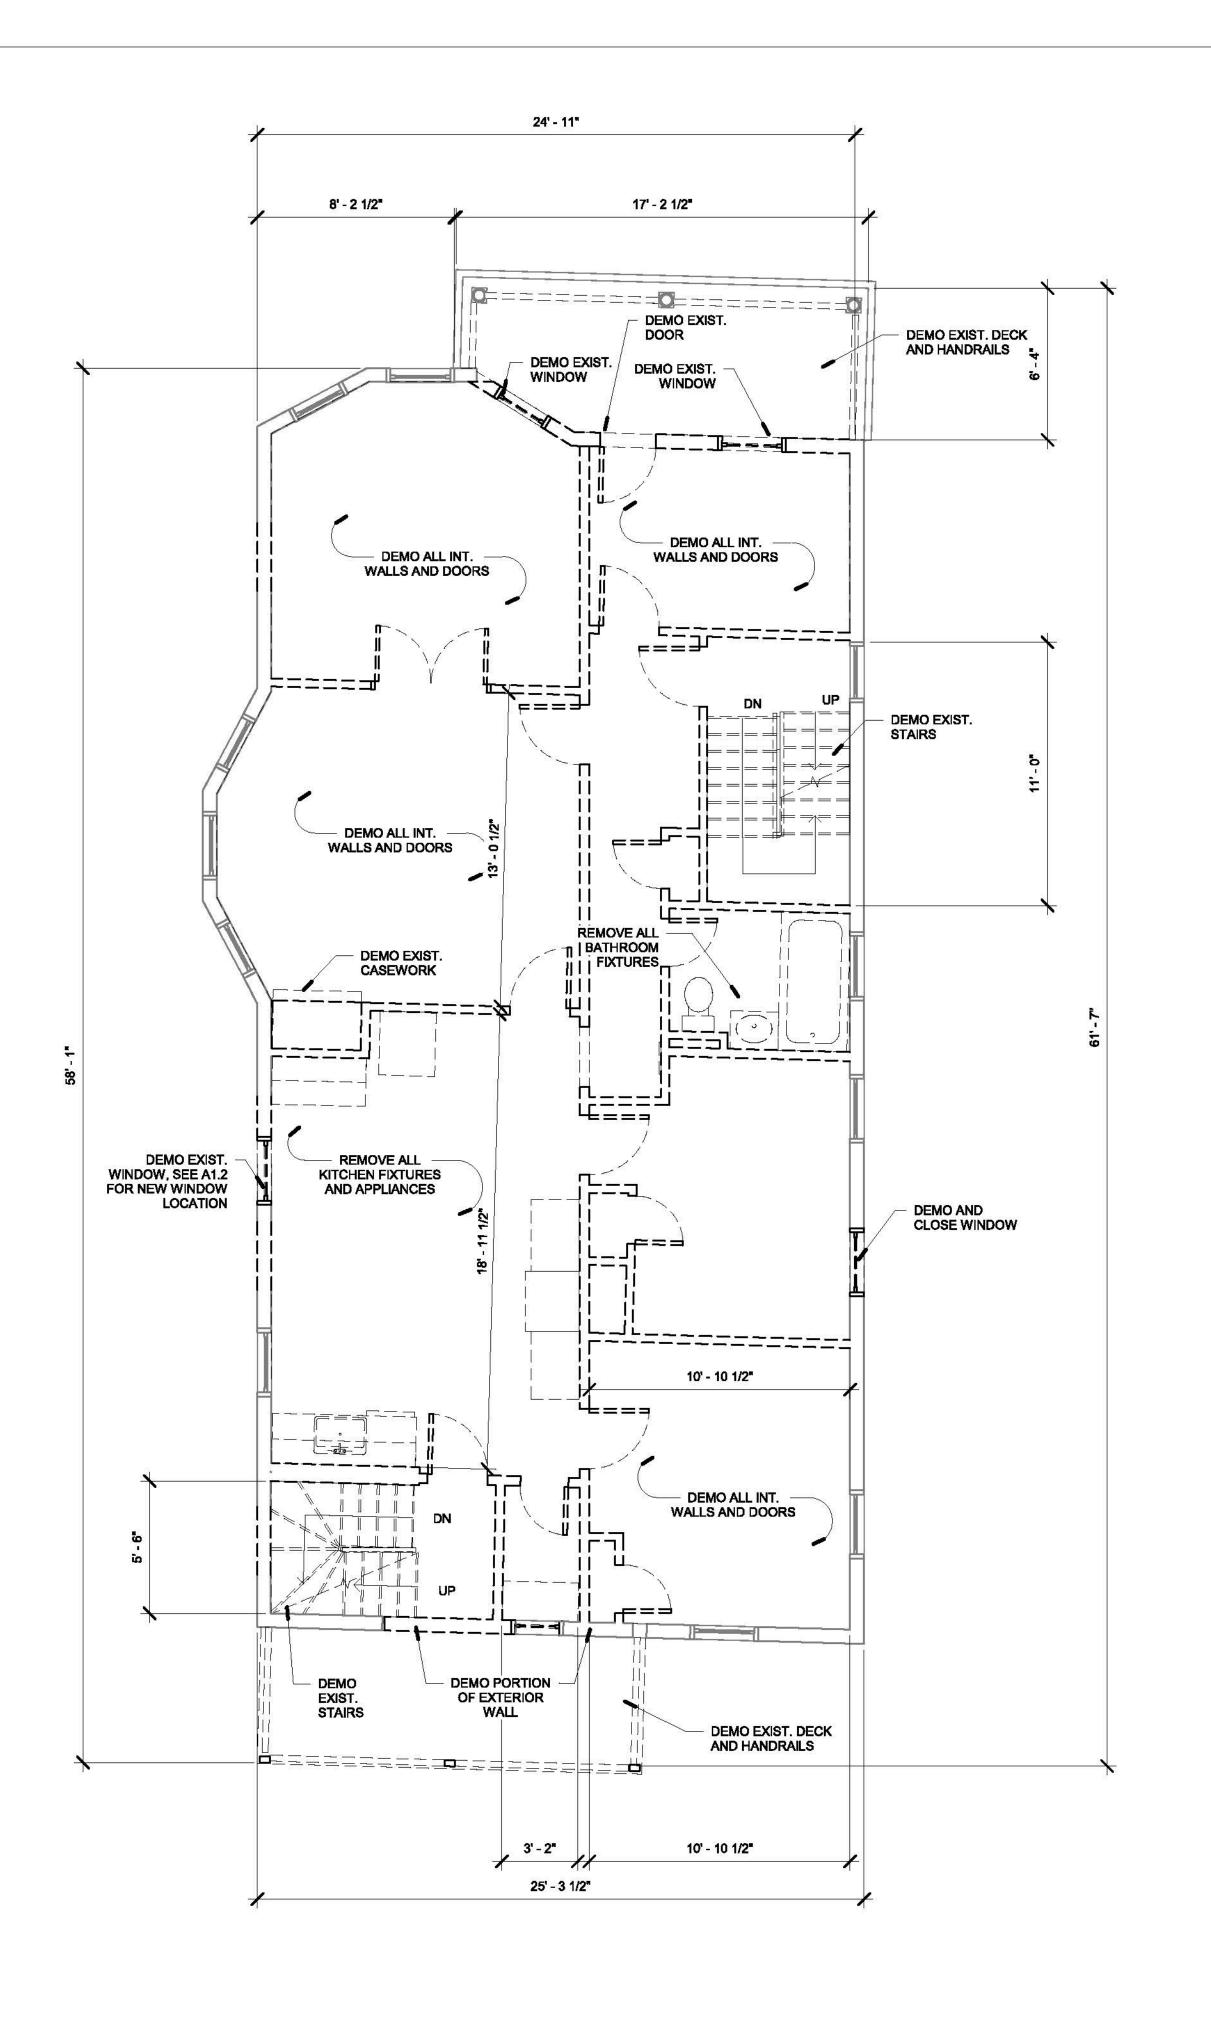

1 Demolition Level 2 1/4" = 1'-0"

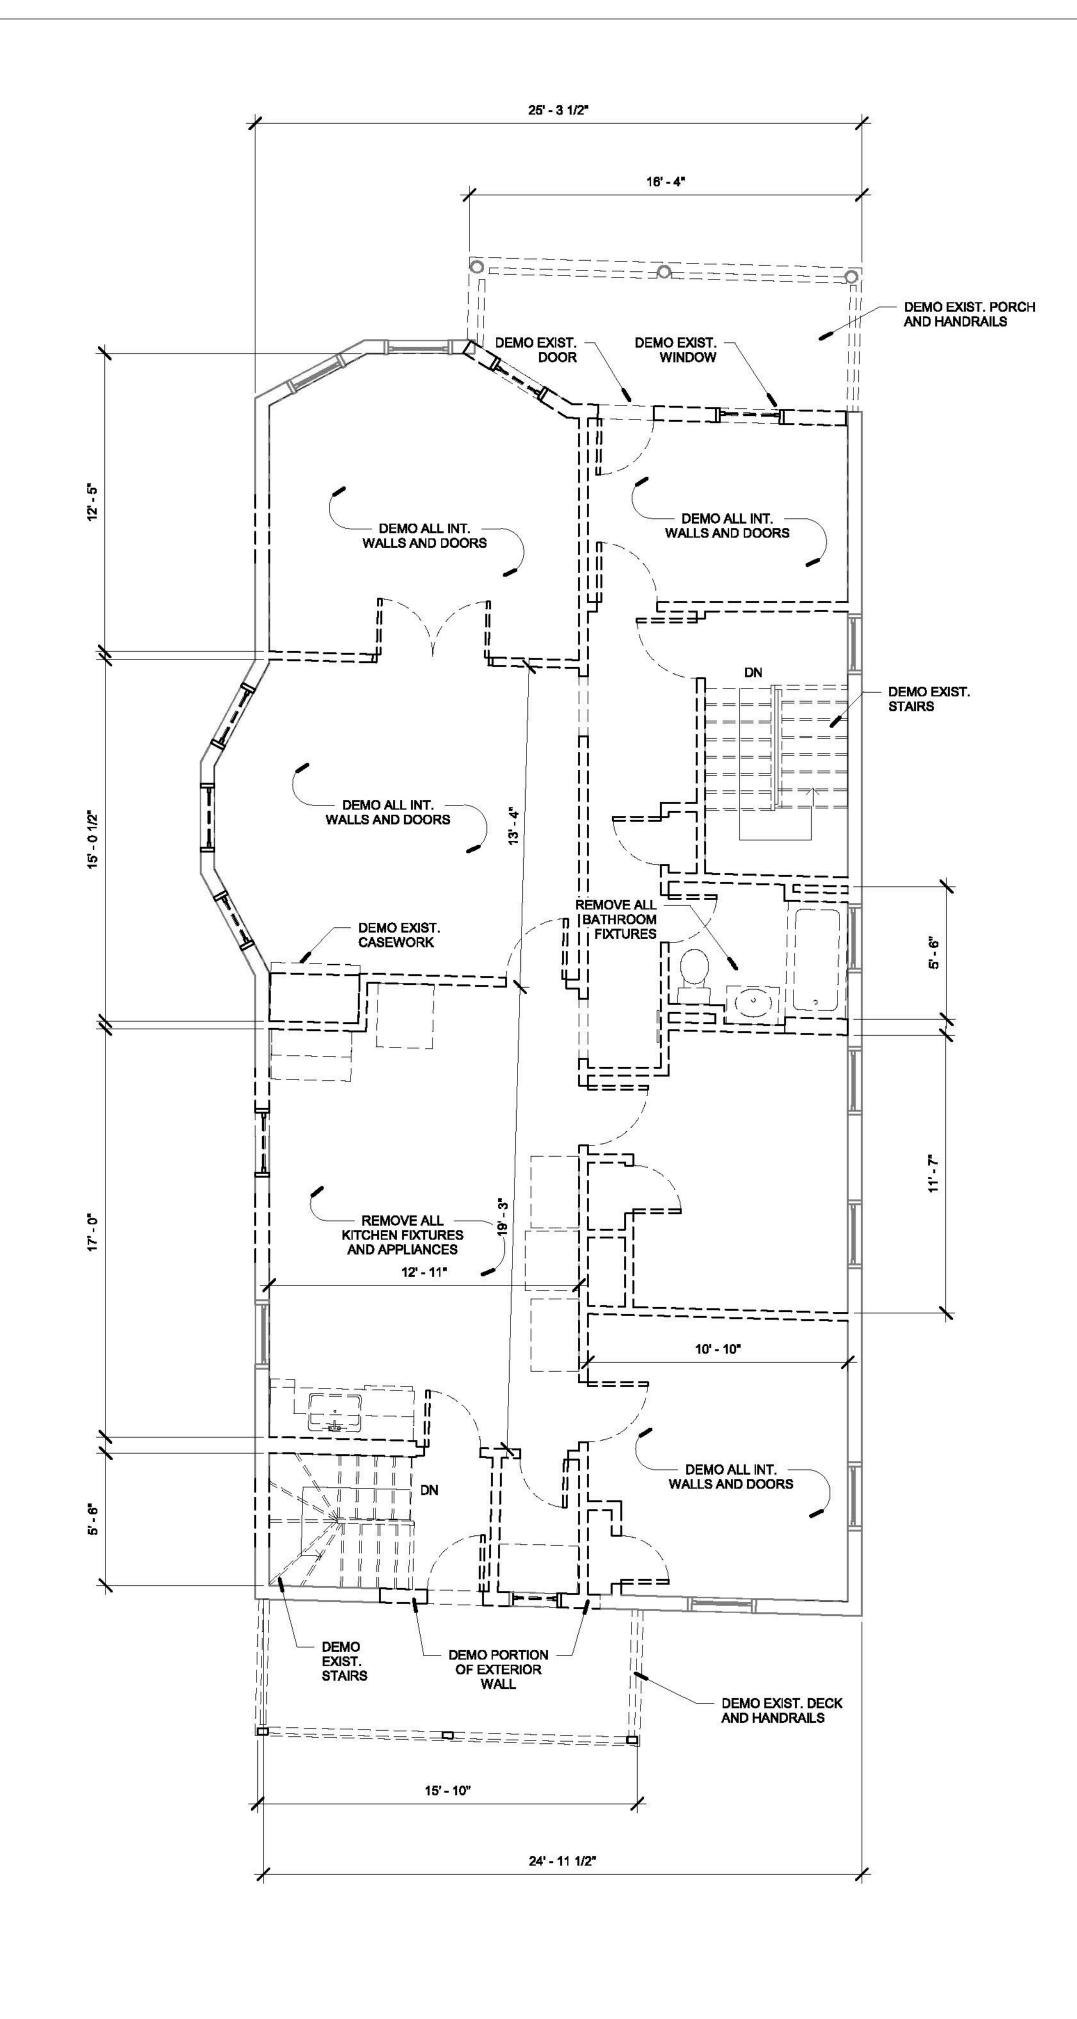


ANDERSON PORTER DESIGN

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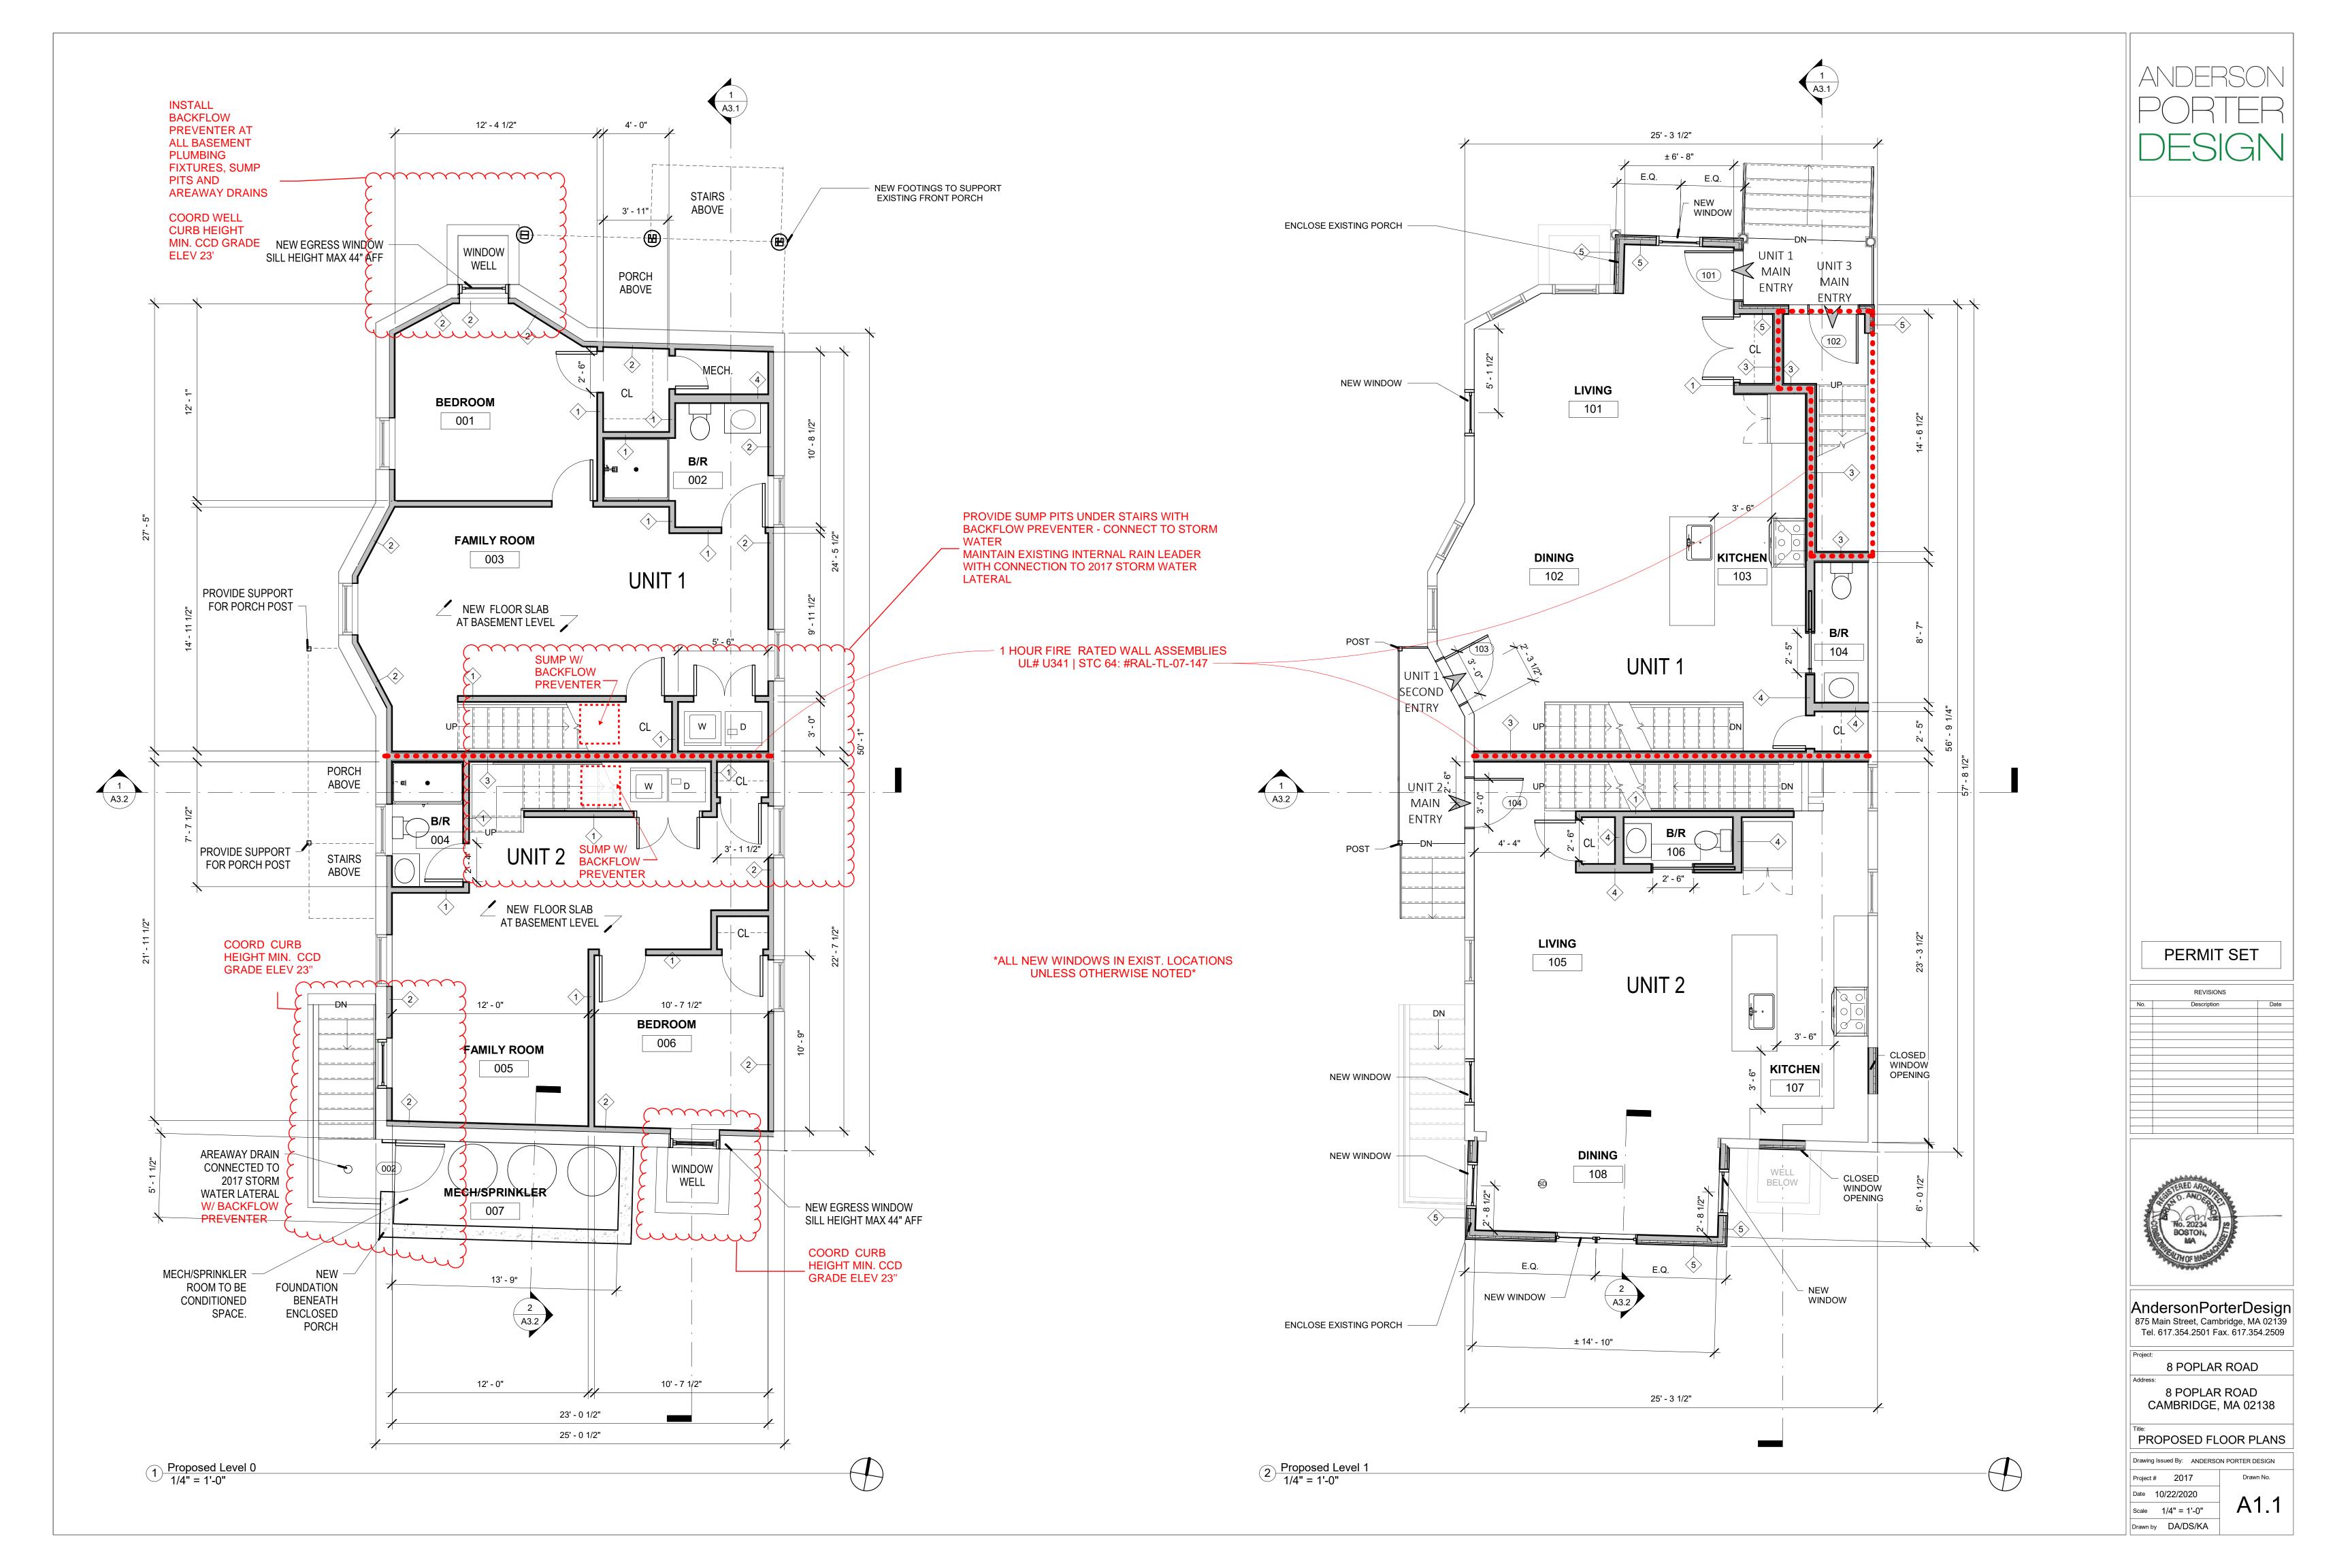
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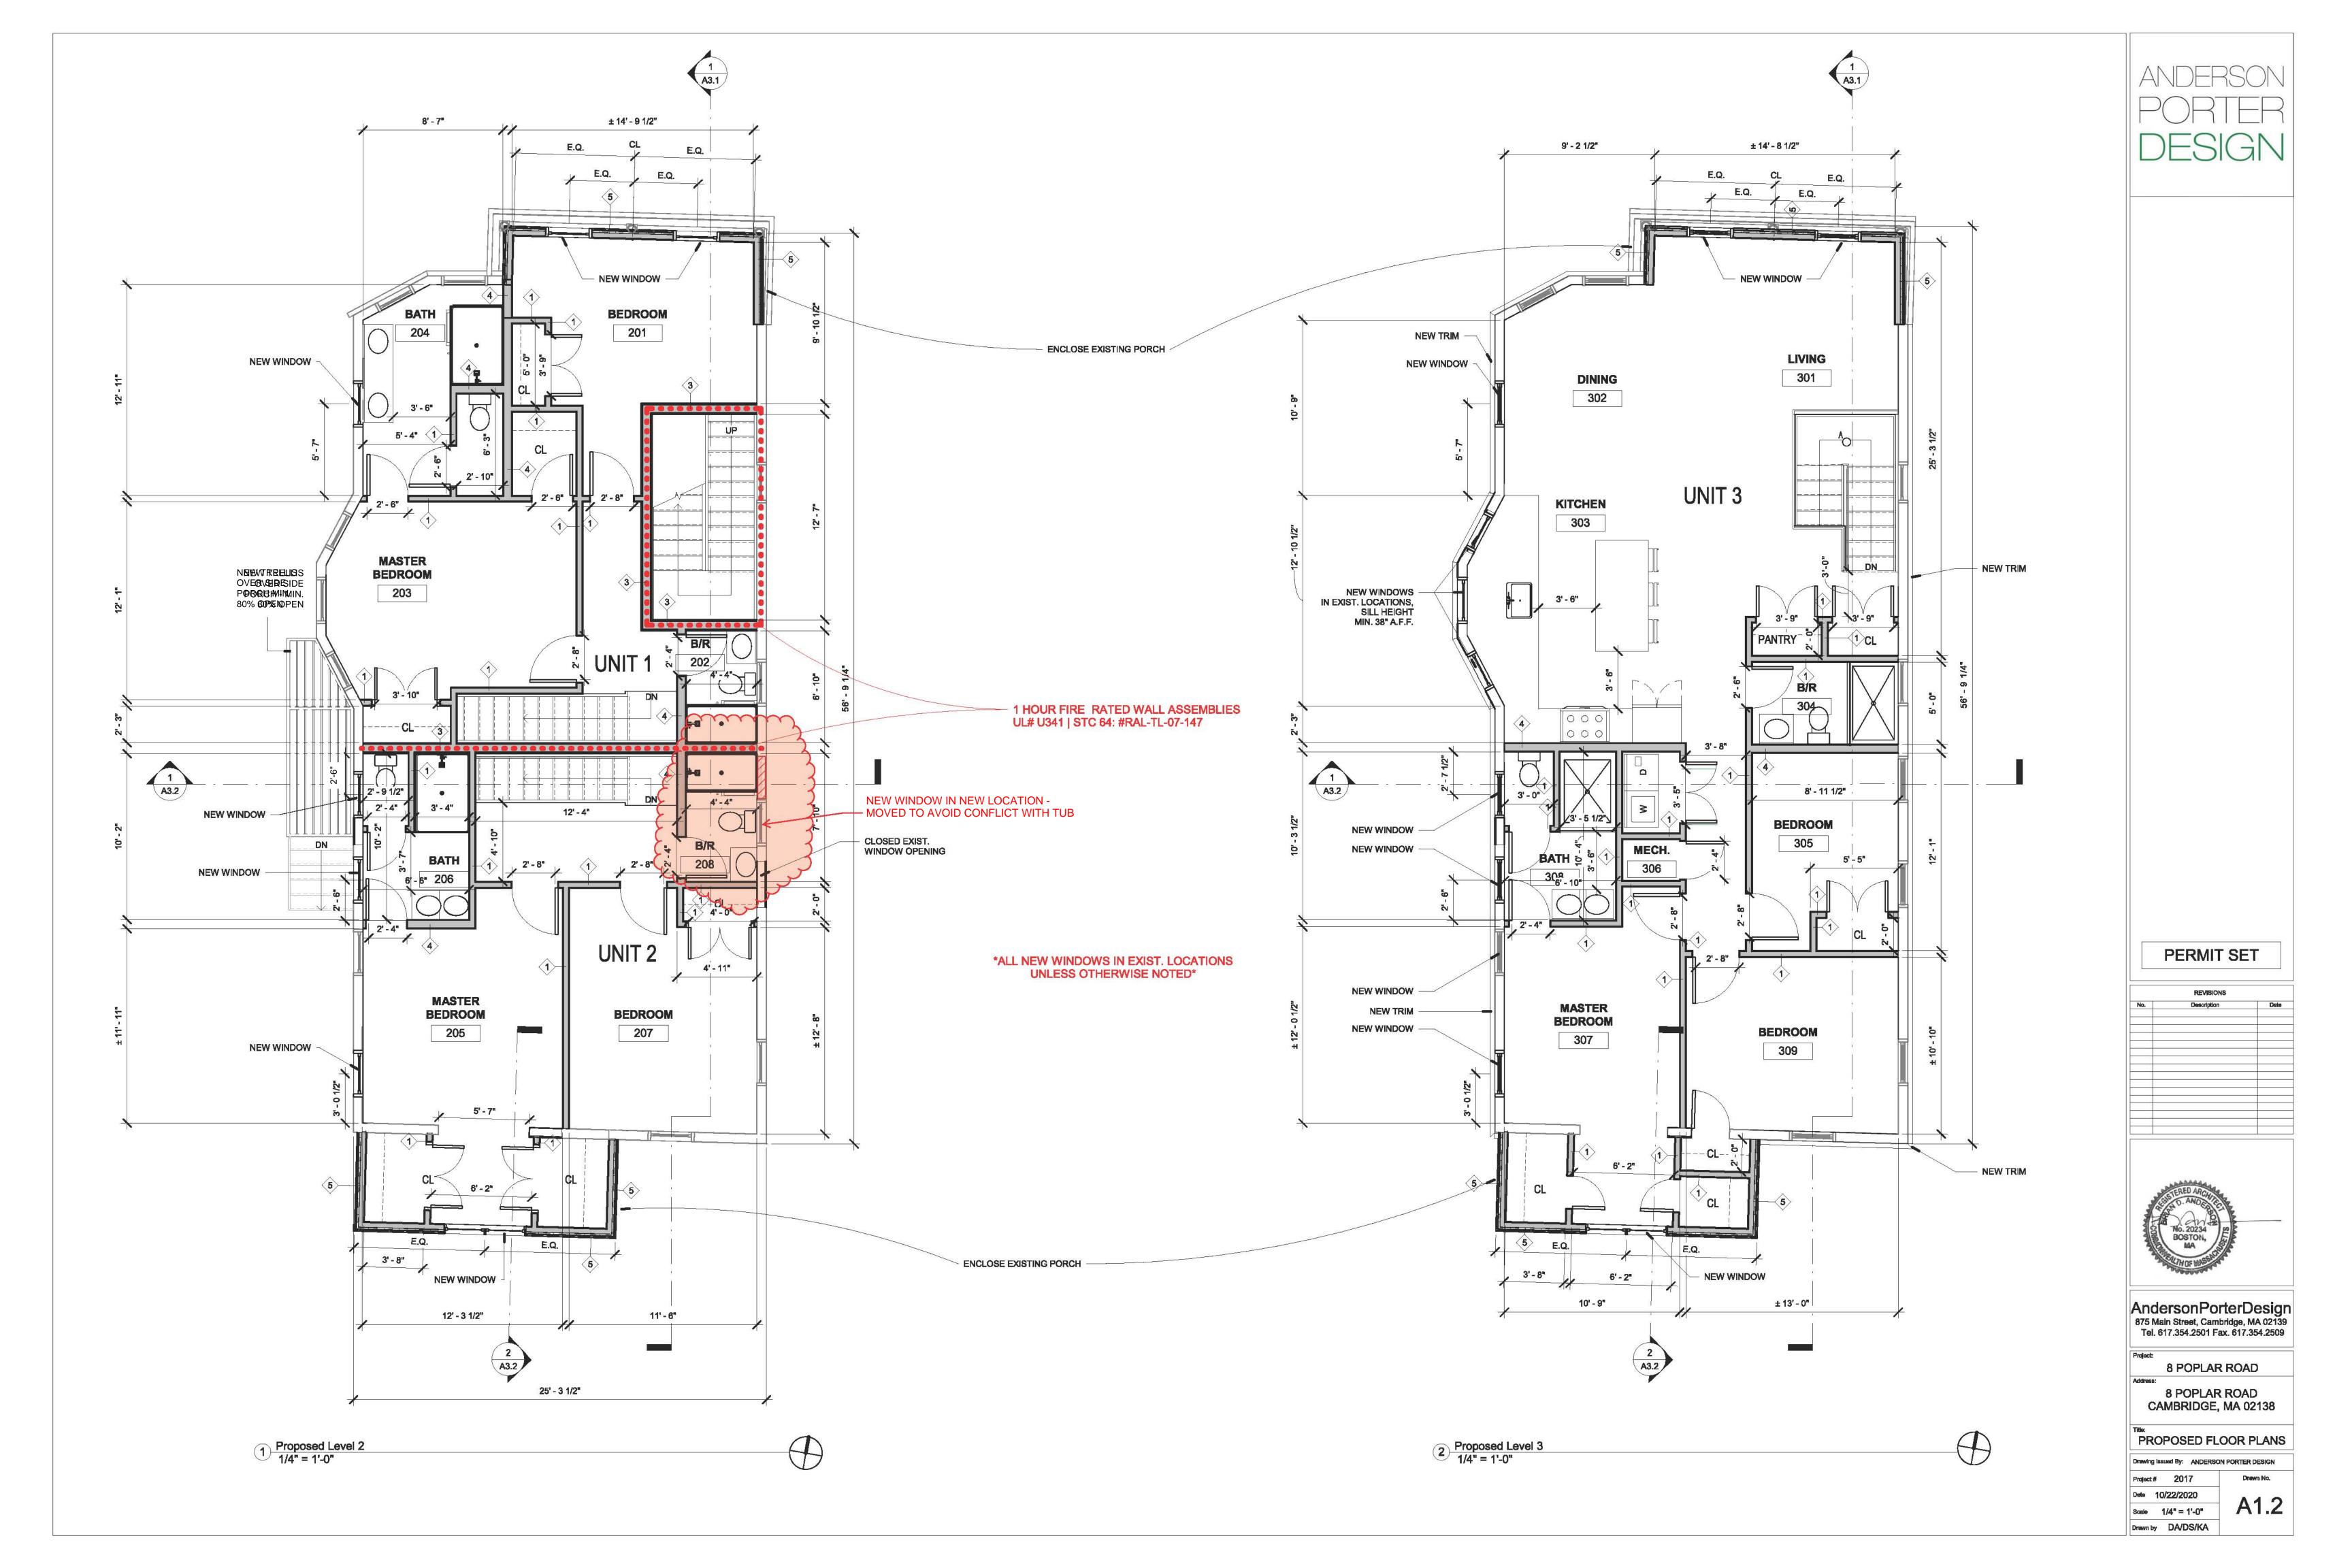
8 POPLAR ROAD CAMBRIDGE, MA 02138

DEMOLITION PLANS


Drawn by ER/DS/KA

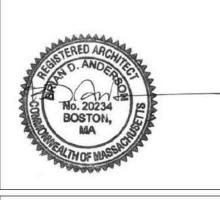2 <u>Demolition Level 3</u> 1/4" = 1'-0"








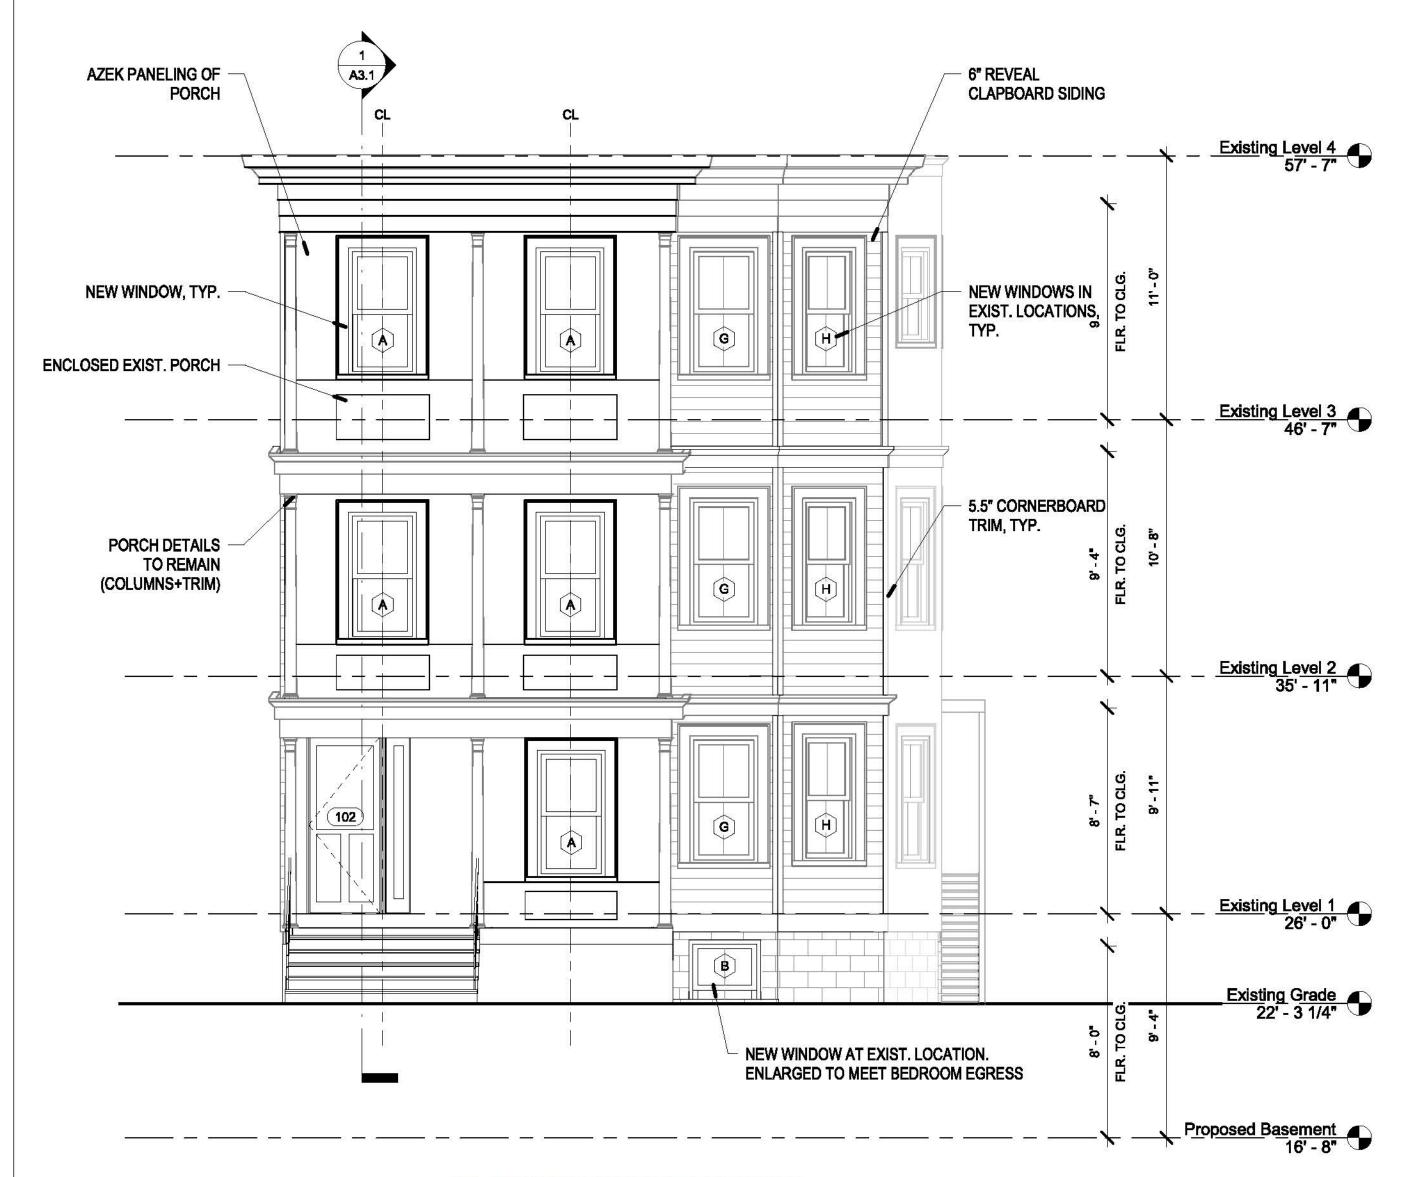

\*ALL NEW WINDOWS IN EXIST. LOCATIONS UNLESS OTHERWISE NOTED, GC TO VERIFY HEIGHT AND WIDTH IN FIELD\*

2 Proposed North Elevation 1/4" = 1'-0"

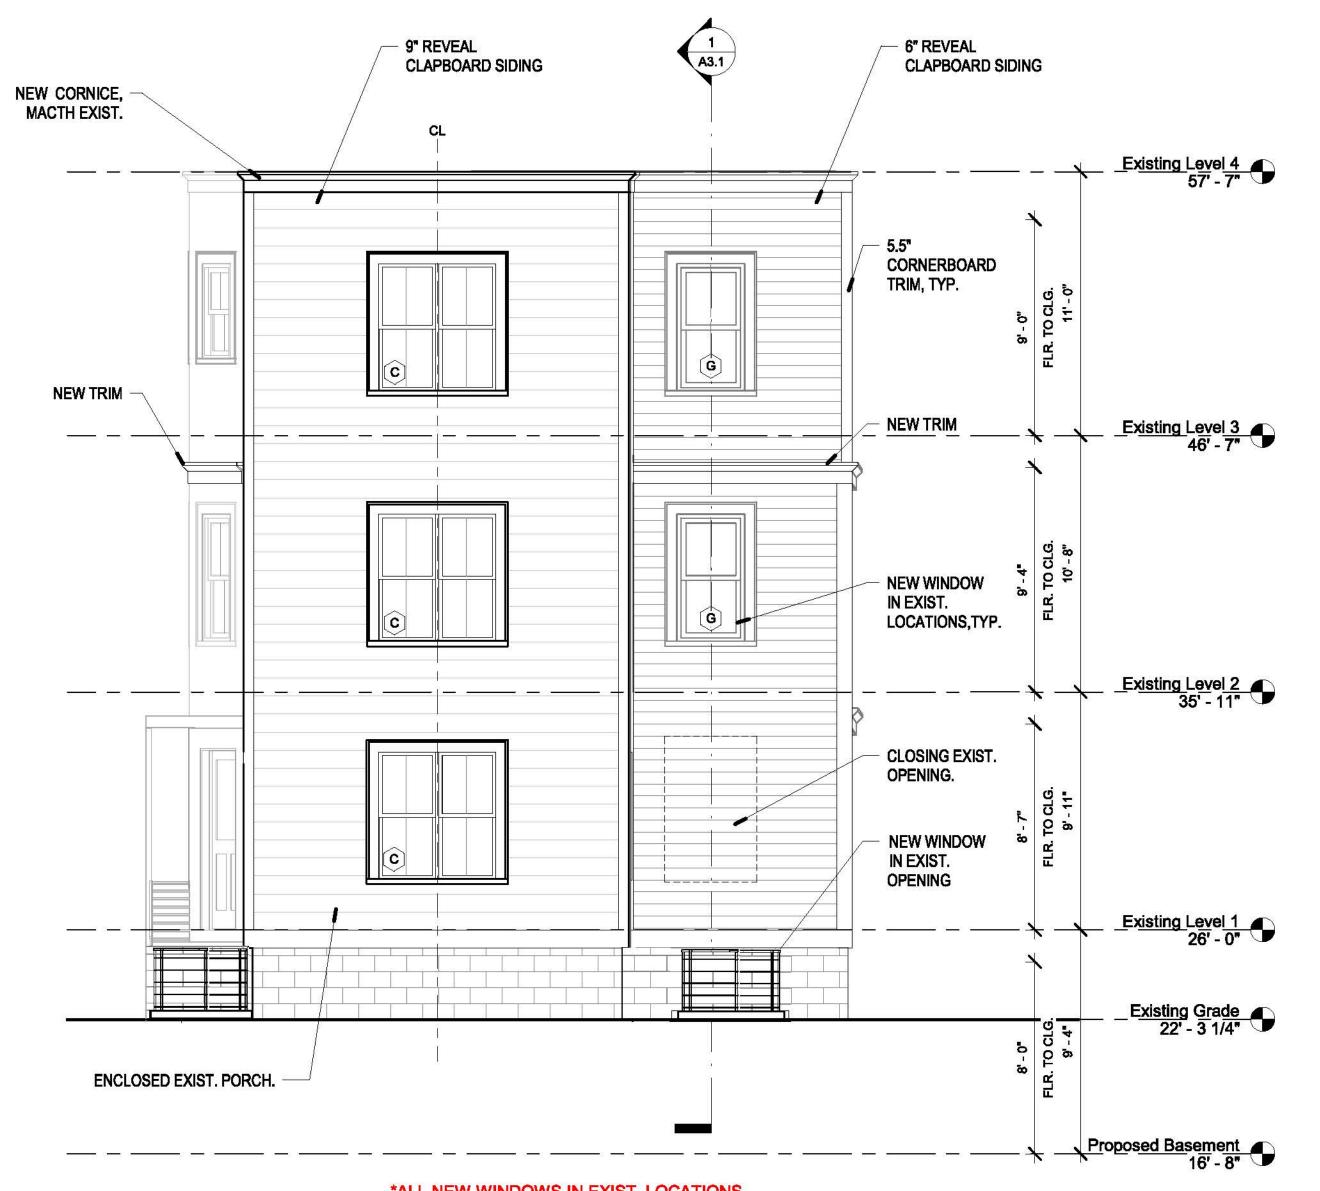


\*ALL NEW WINDOWS IN EXIST. LOCATIONS UNLESS OTHERWISE NOTED, GC TO VERIFY HEIGHT AND WIDTH IN FIELD\*

1 Proposed South Elevation 1/4" = 1'-0"

**PERMIT SET** 

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**8 POPLAR ROAD** 

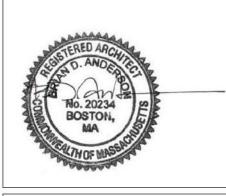
8 POPLAR ROAD CAMBRIDGE, MA 02138

PROPOSED ELEVATIONS

Project# 2017

Deta 10/22/2020 Scale 1/4" = 1'-0" Drewn by ER/DS/KA



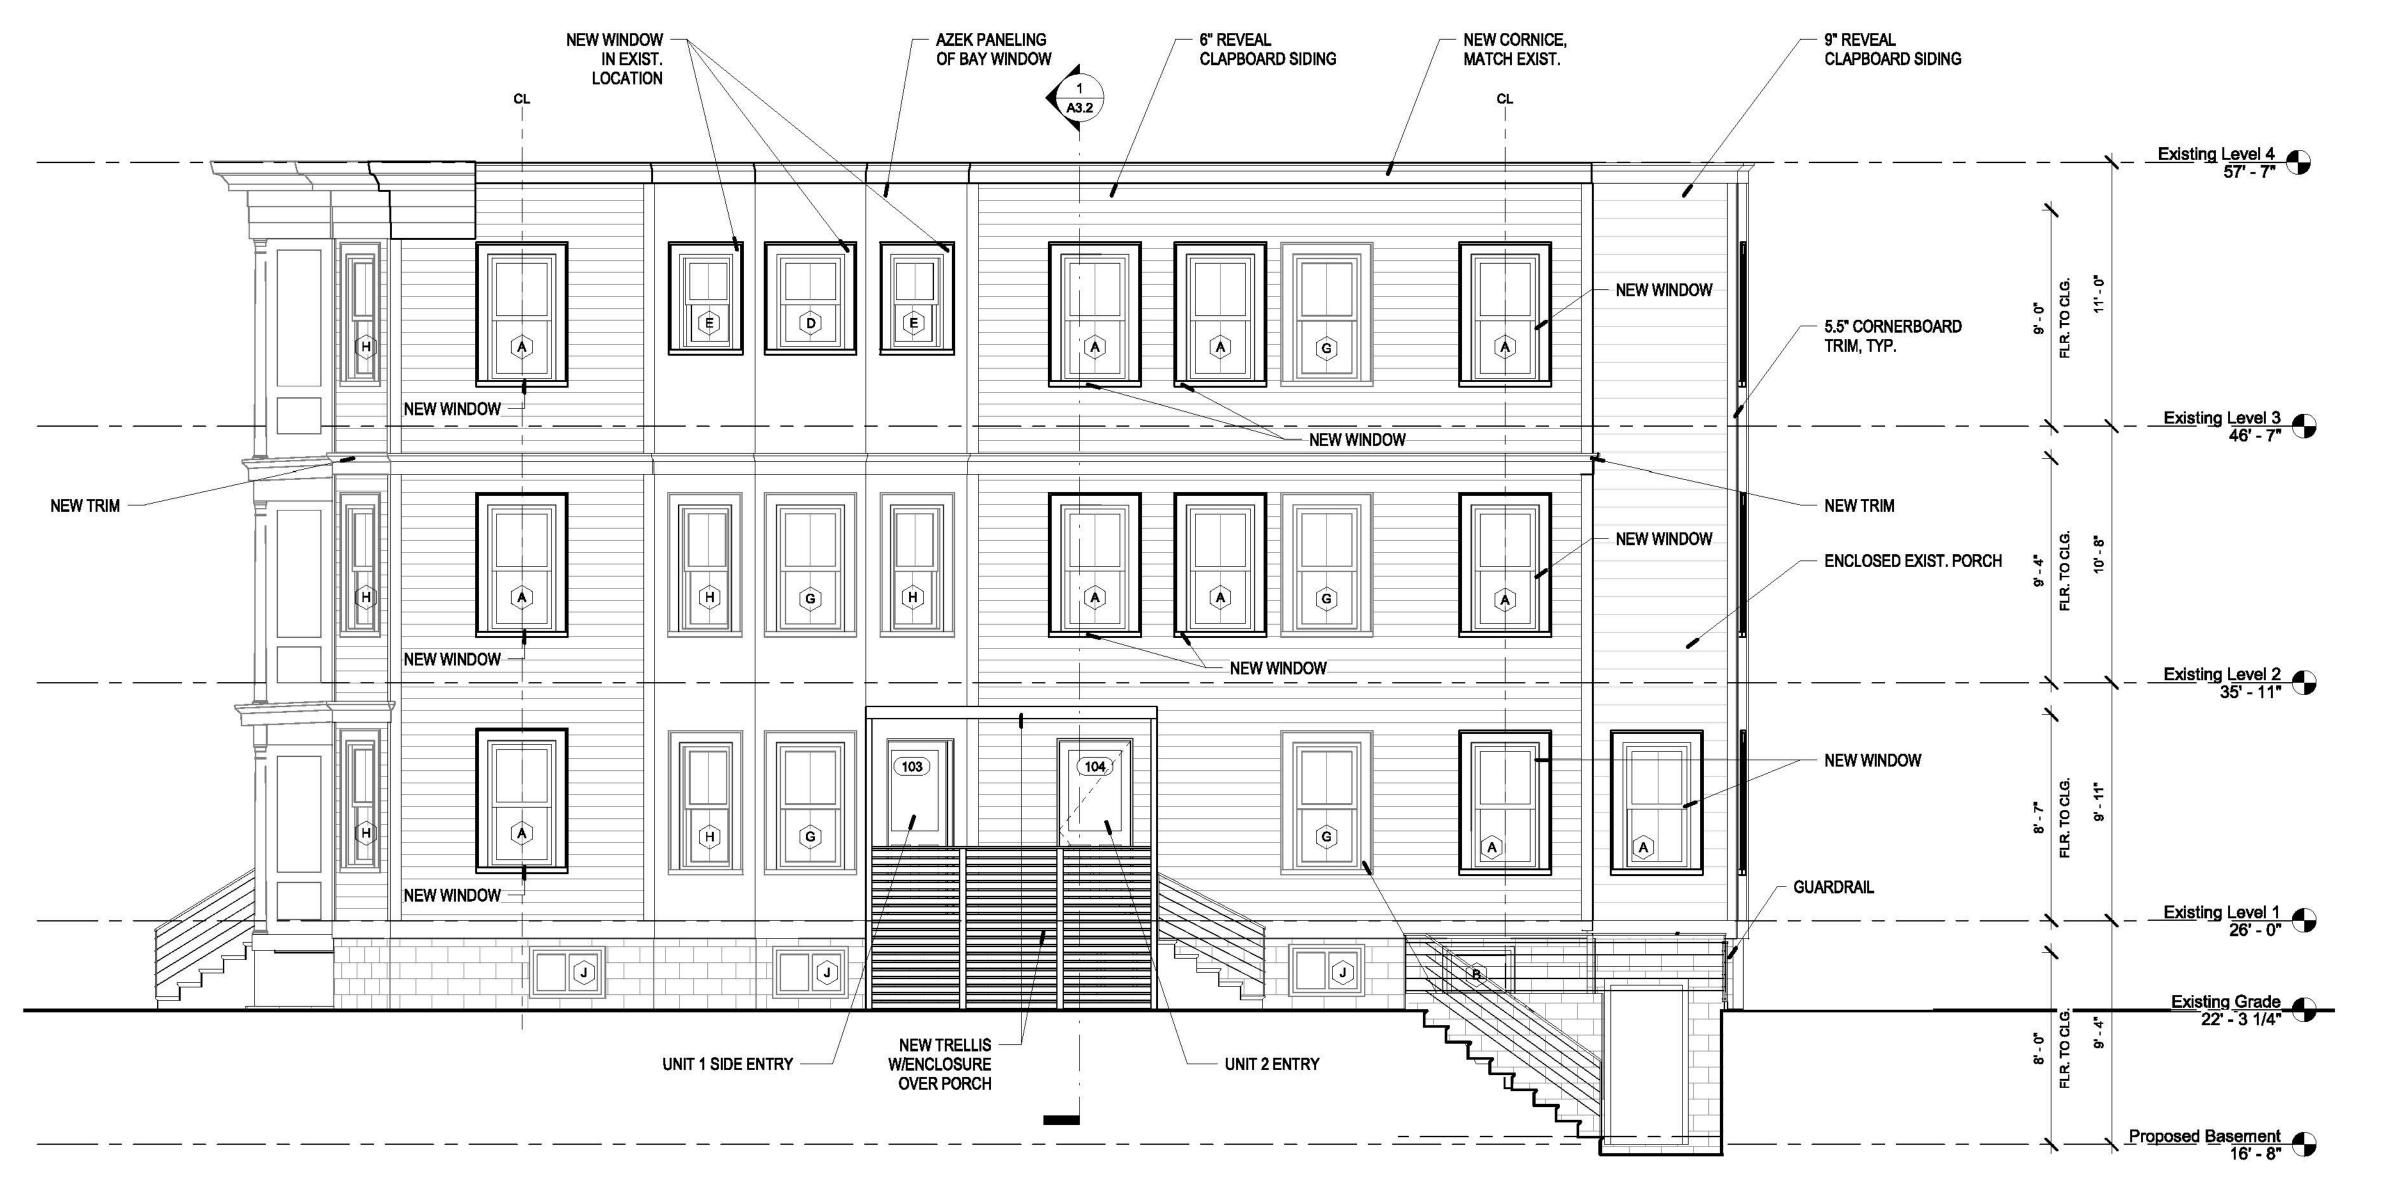


\*ALL NEW WINDOWS IN EXIST. LOCATIONS
UNLESS OTHERWISE NOTED, GC TO VERIFY
HEIGHT AND WIDTH IN FIELD\*

Proposed West Elevation
1/4" = 1'-0"

# PERMIT SET

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8 POPLAR ROAD

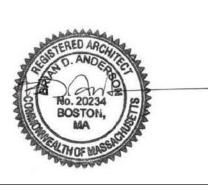8 POPLAR ROAD CAMBRIDGE, MA 02138

PROPOSED ELEVATIONS

Drawing Issued By: ANDERSON PORTER DESIGN
Project # 2017 Drawn No.


Deta 10/22/2020

Scale 1/4" = 1'-0"

Drawn by ER/DS/KA

A2.2



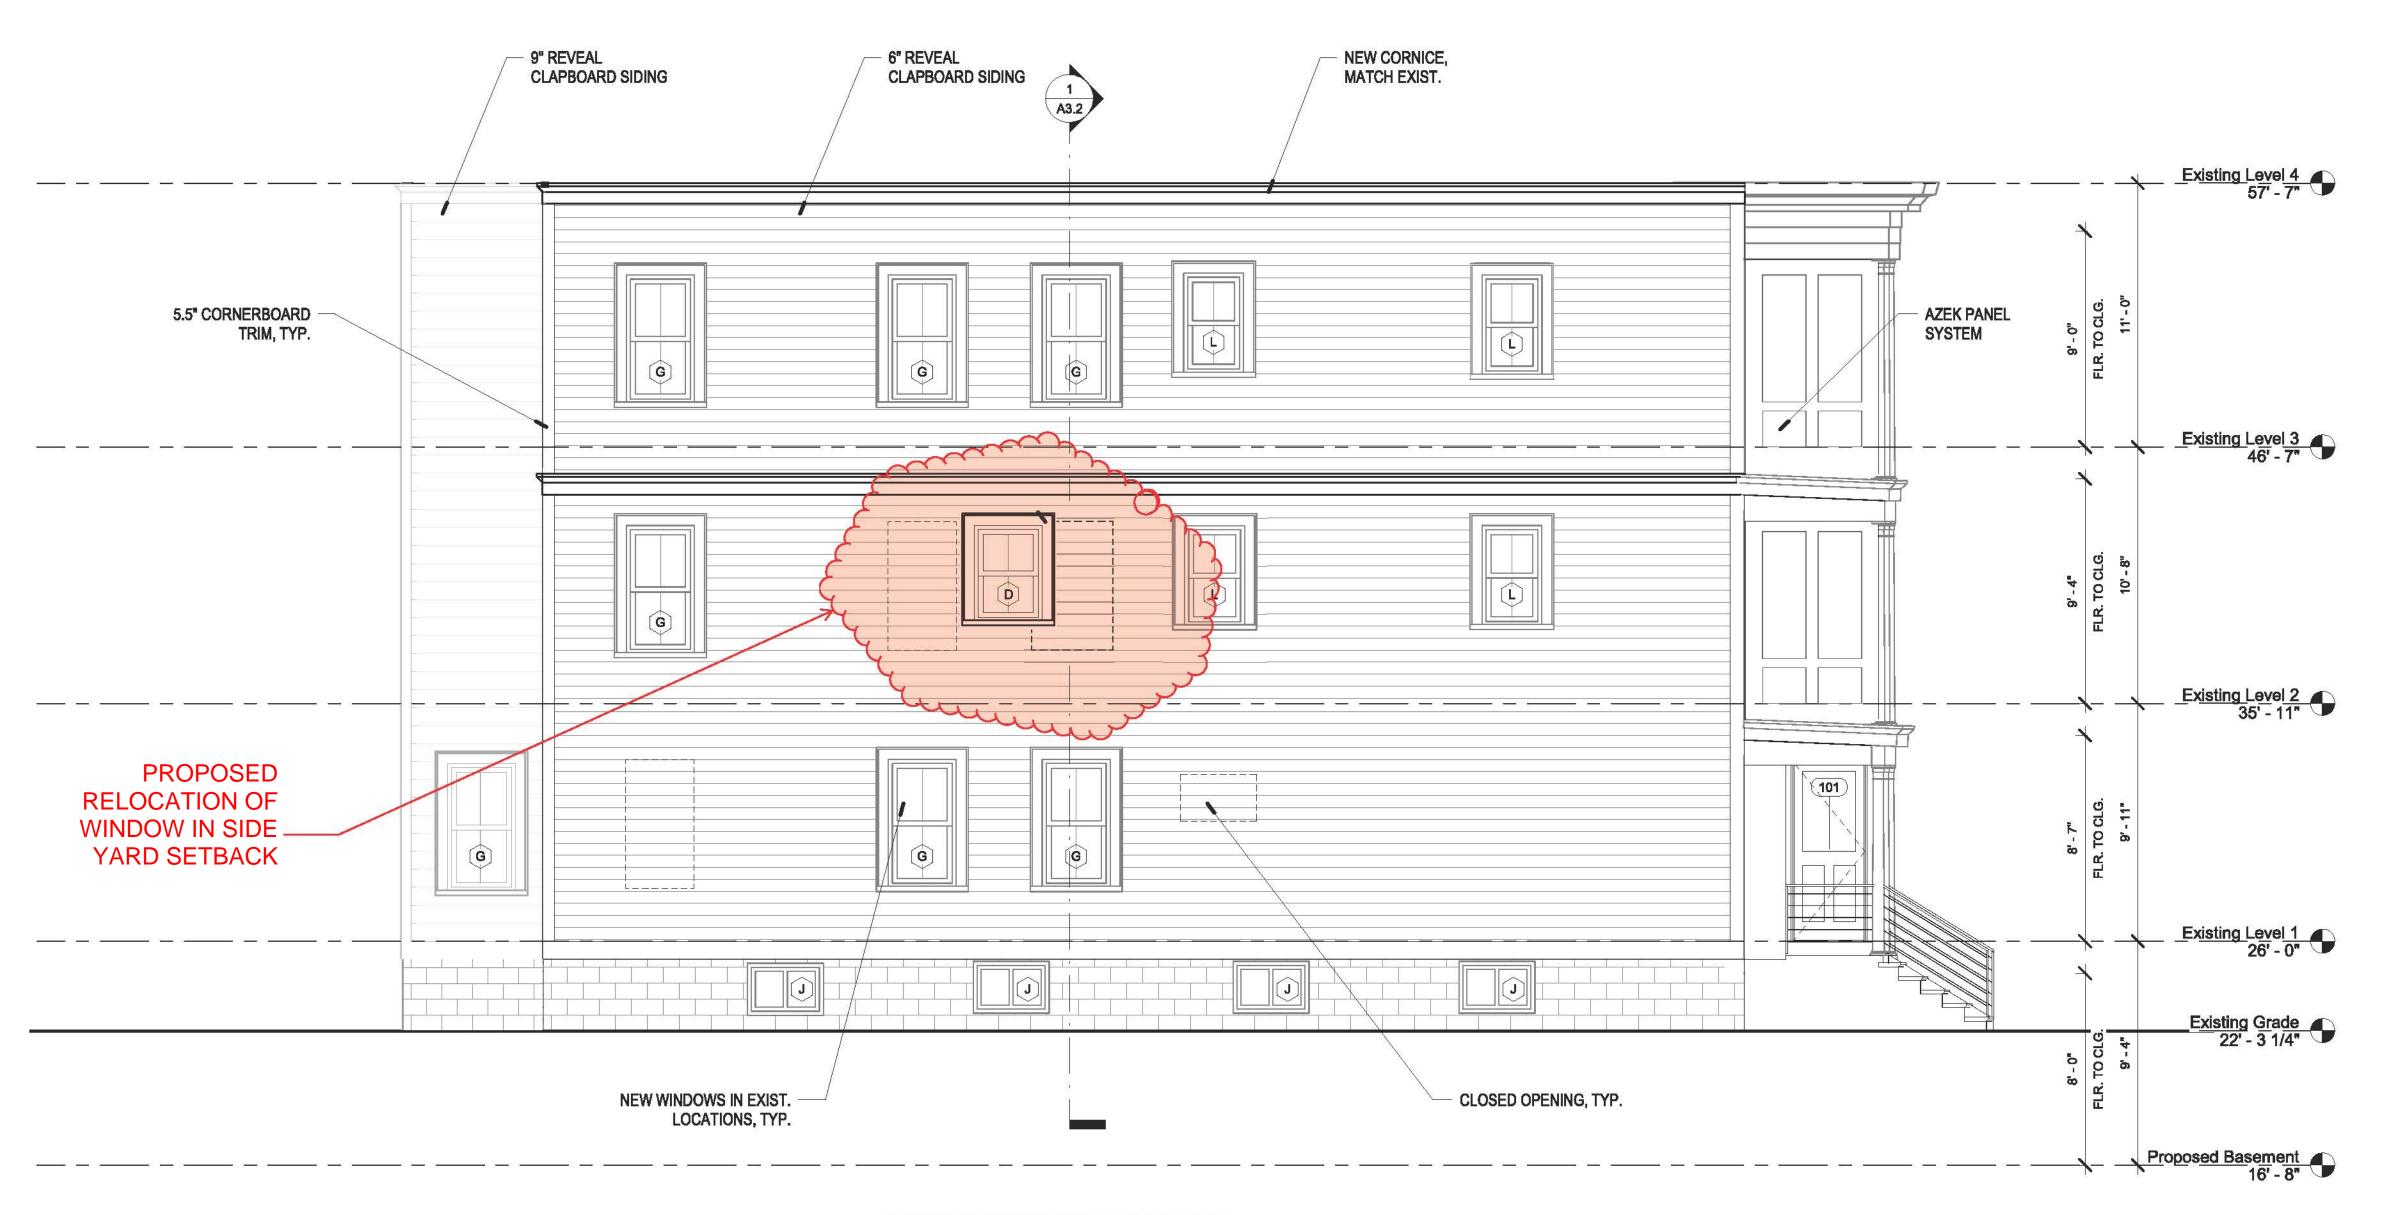


\*ALL NEW WINDOWS IN EXIST. LOCATIONS UNLESS OTHERWISE NOTED, GC TO VERIFY HEIGHT AND WIDTH IN FIELD\*

Proposed East Elevation
1/4" = 1'-0"

PERMIT SET

REVISIONS								
No.	Description	Date						
1	REVISION	1/27/20						
	2.	23						

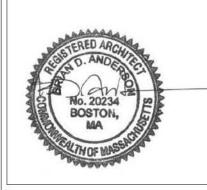

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8 POPLAR ROAD


8 POPLAR ROAD CAMBRIDGE, MA 02138

PROPOSED ELEVATIONS


Project# 2017 Date 10/22/2020

Scale 1/4" = 1'-0" Drawn by ER/DS/KA



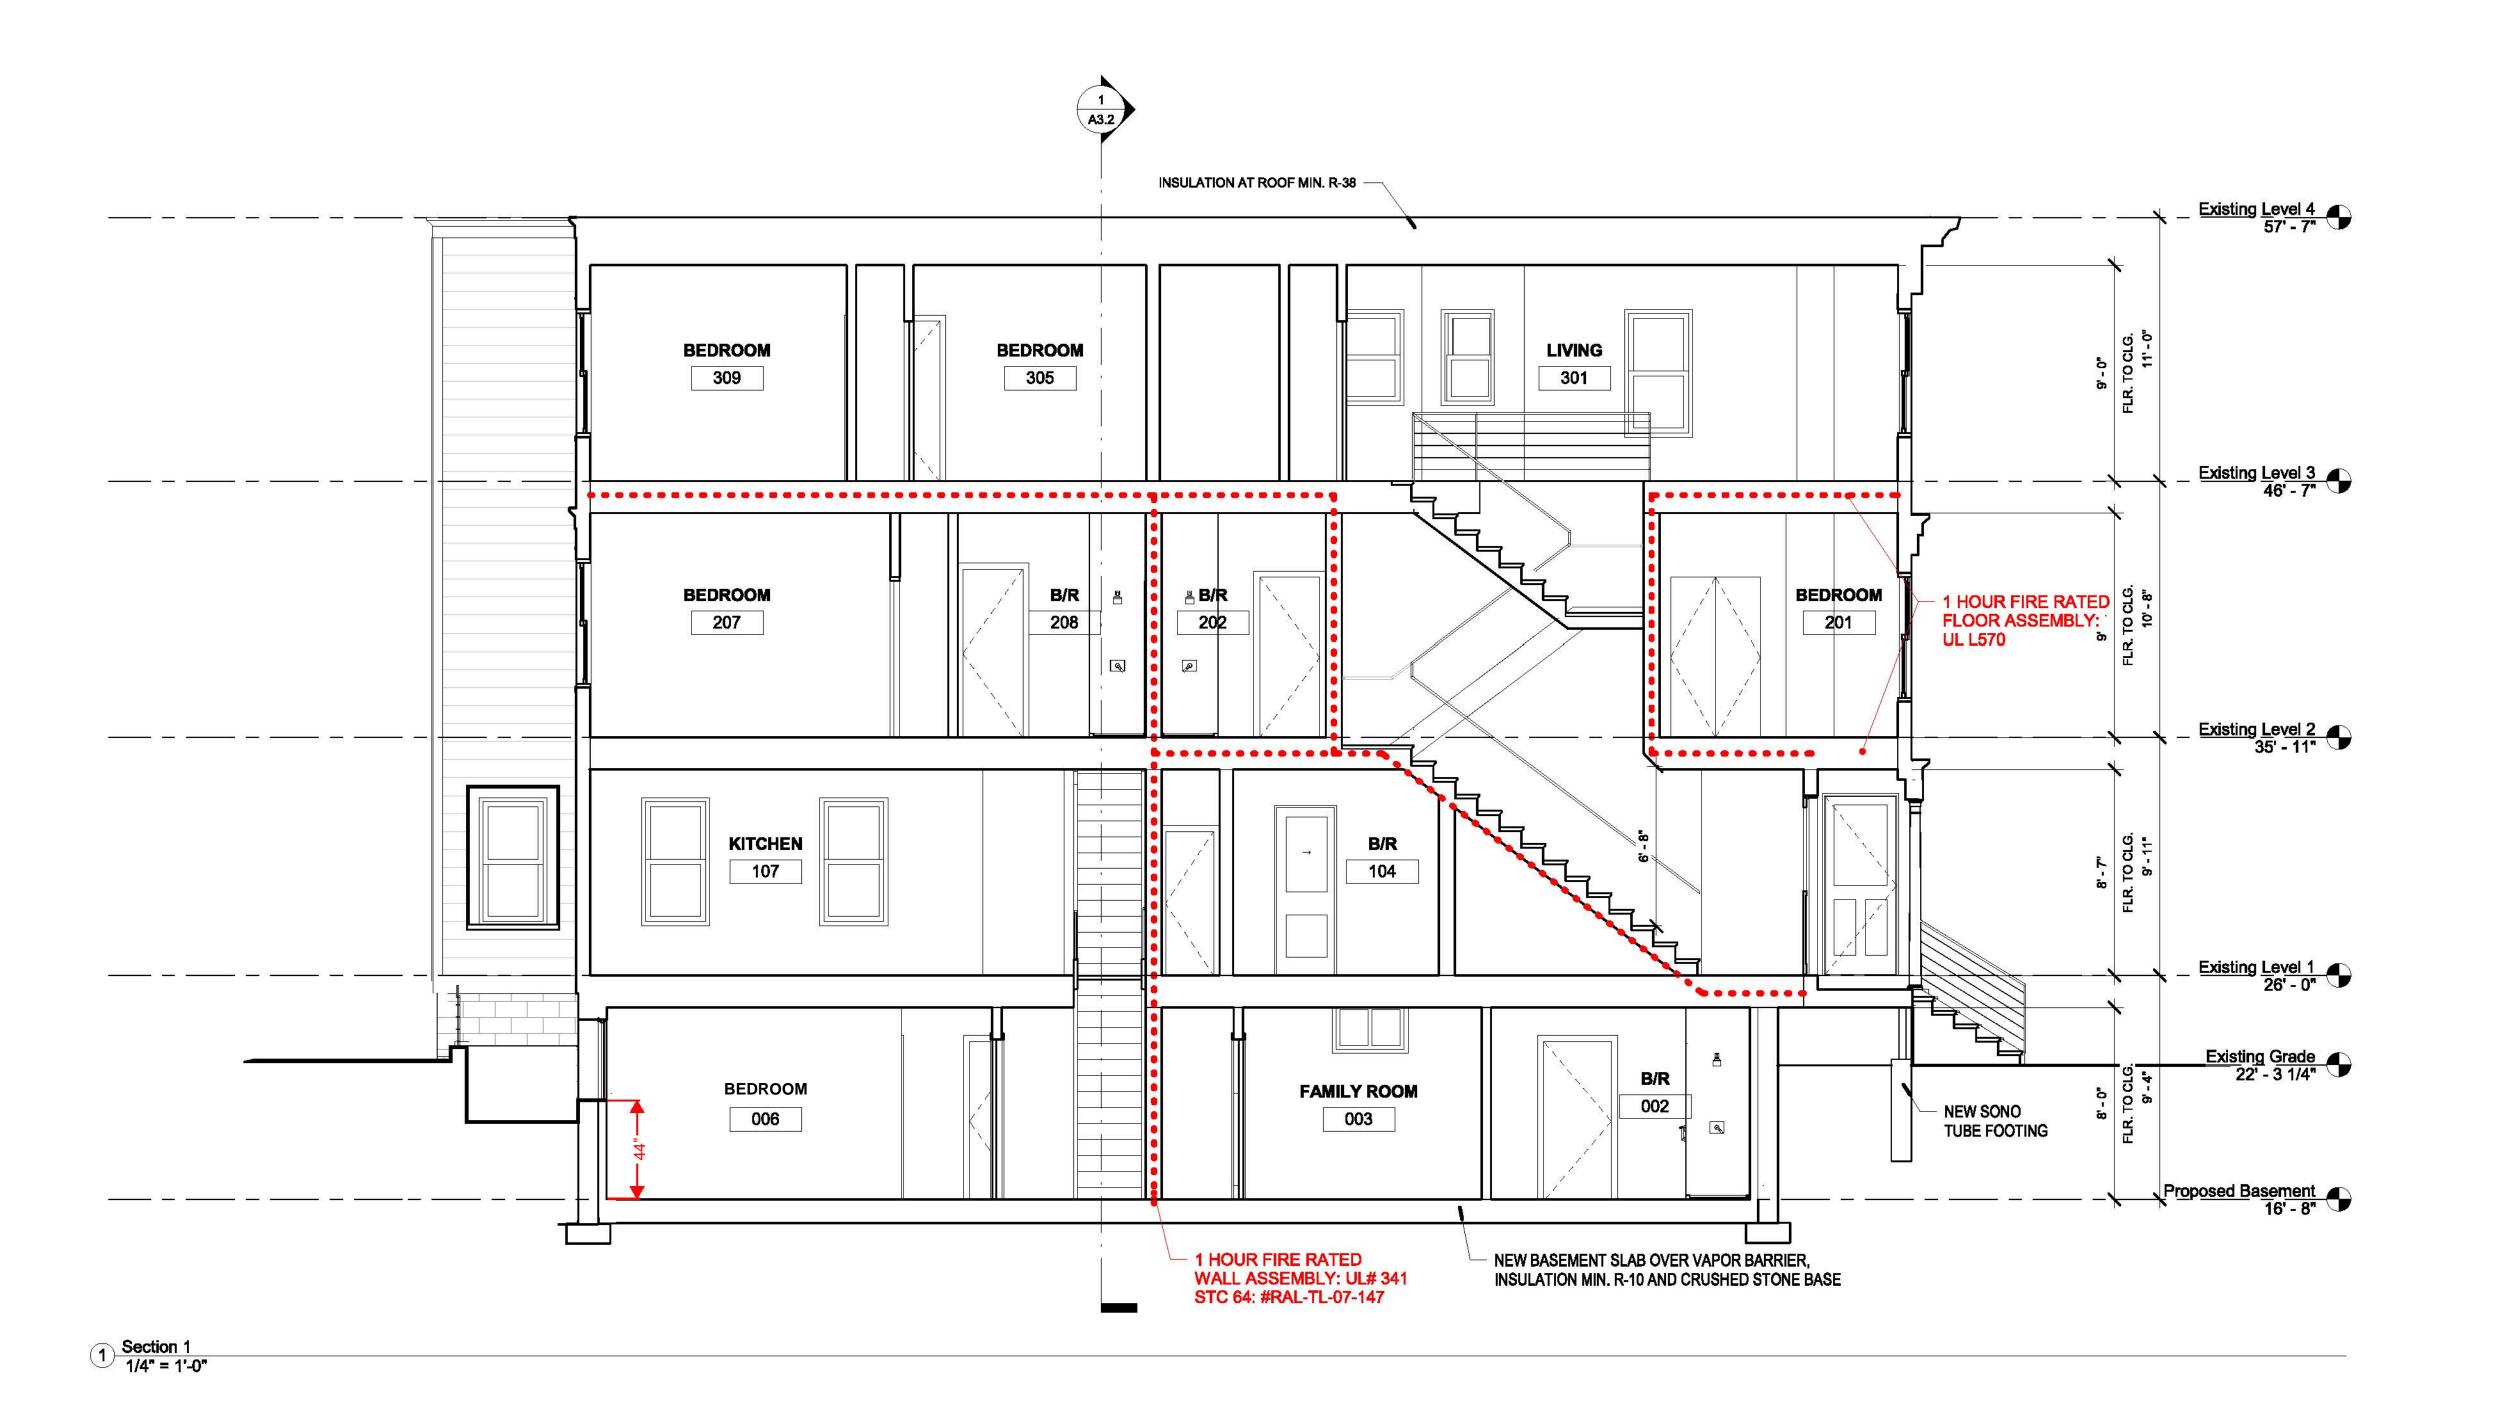

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No.	Description	Date					
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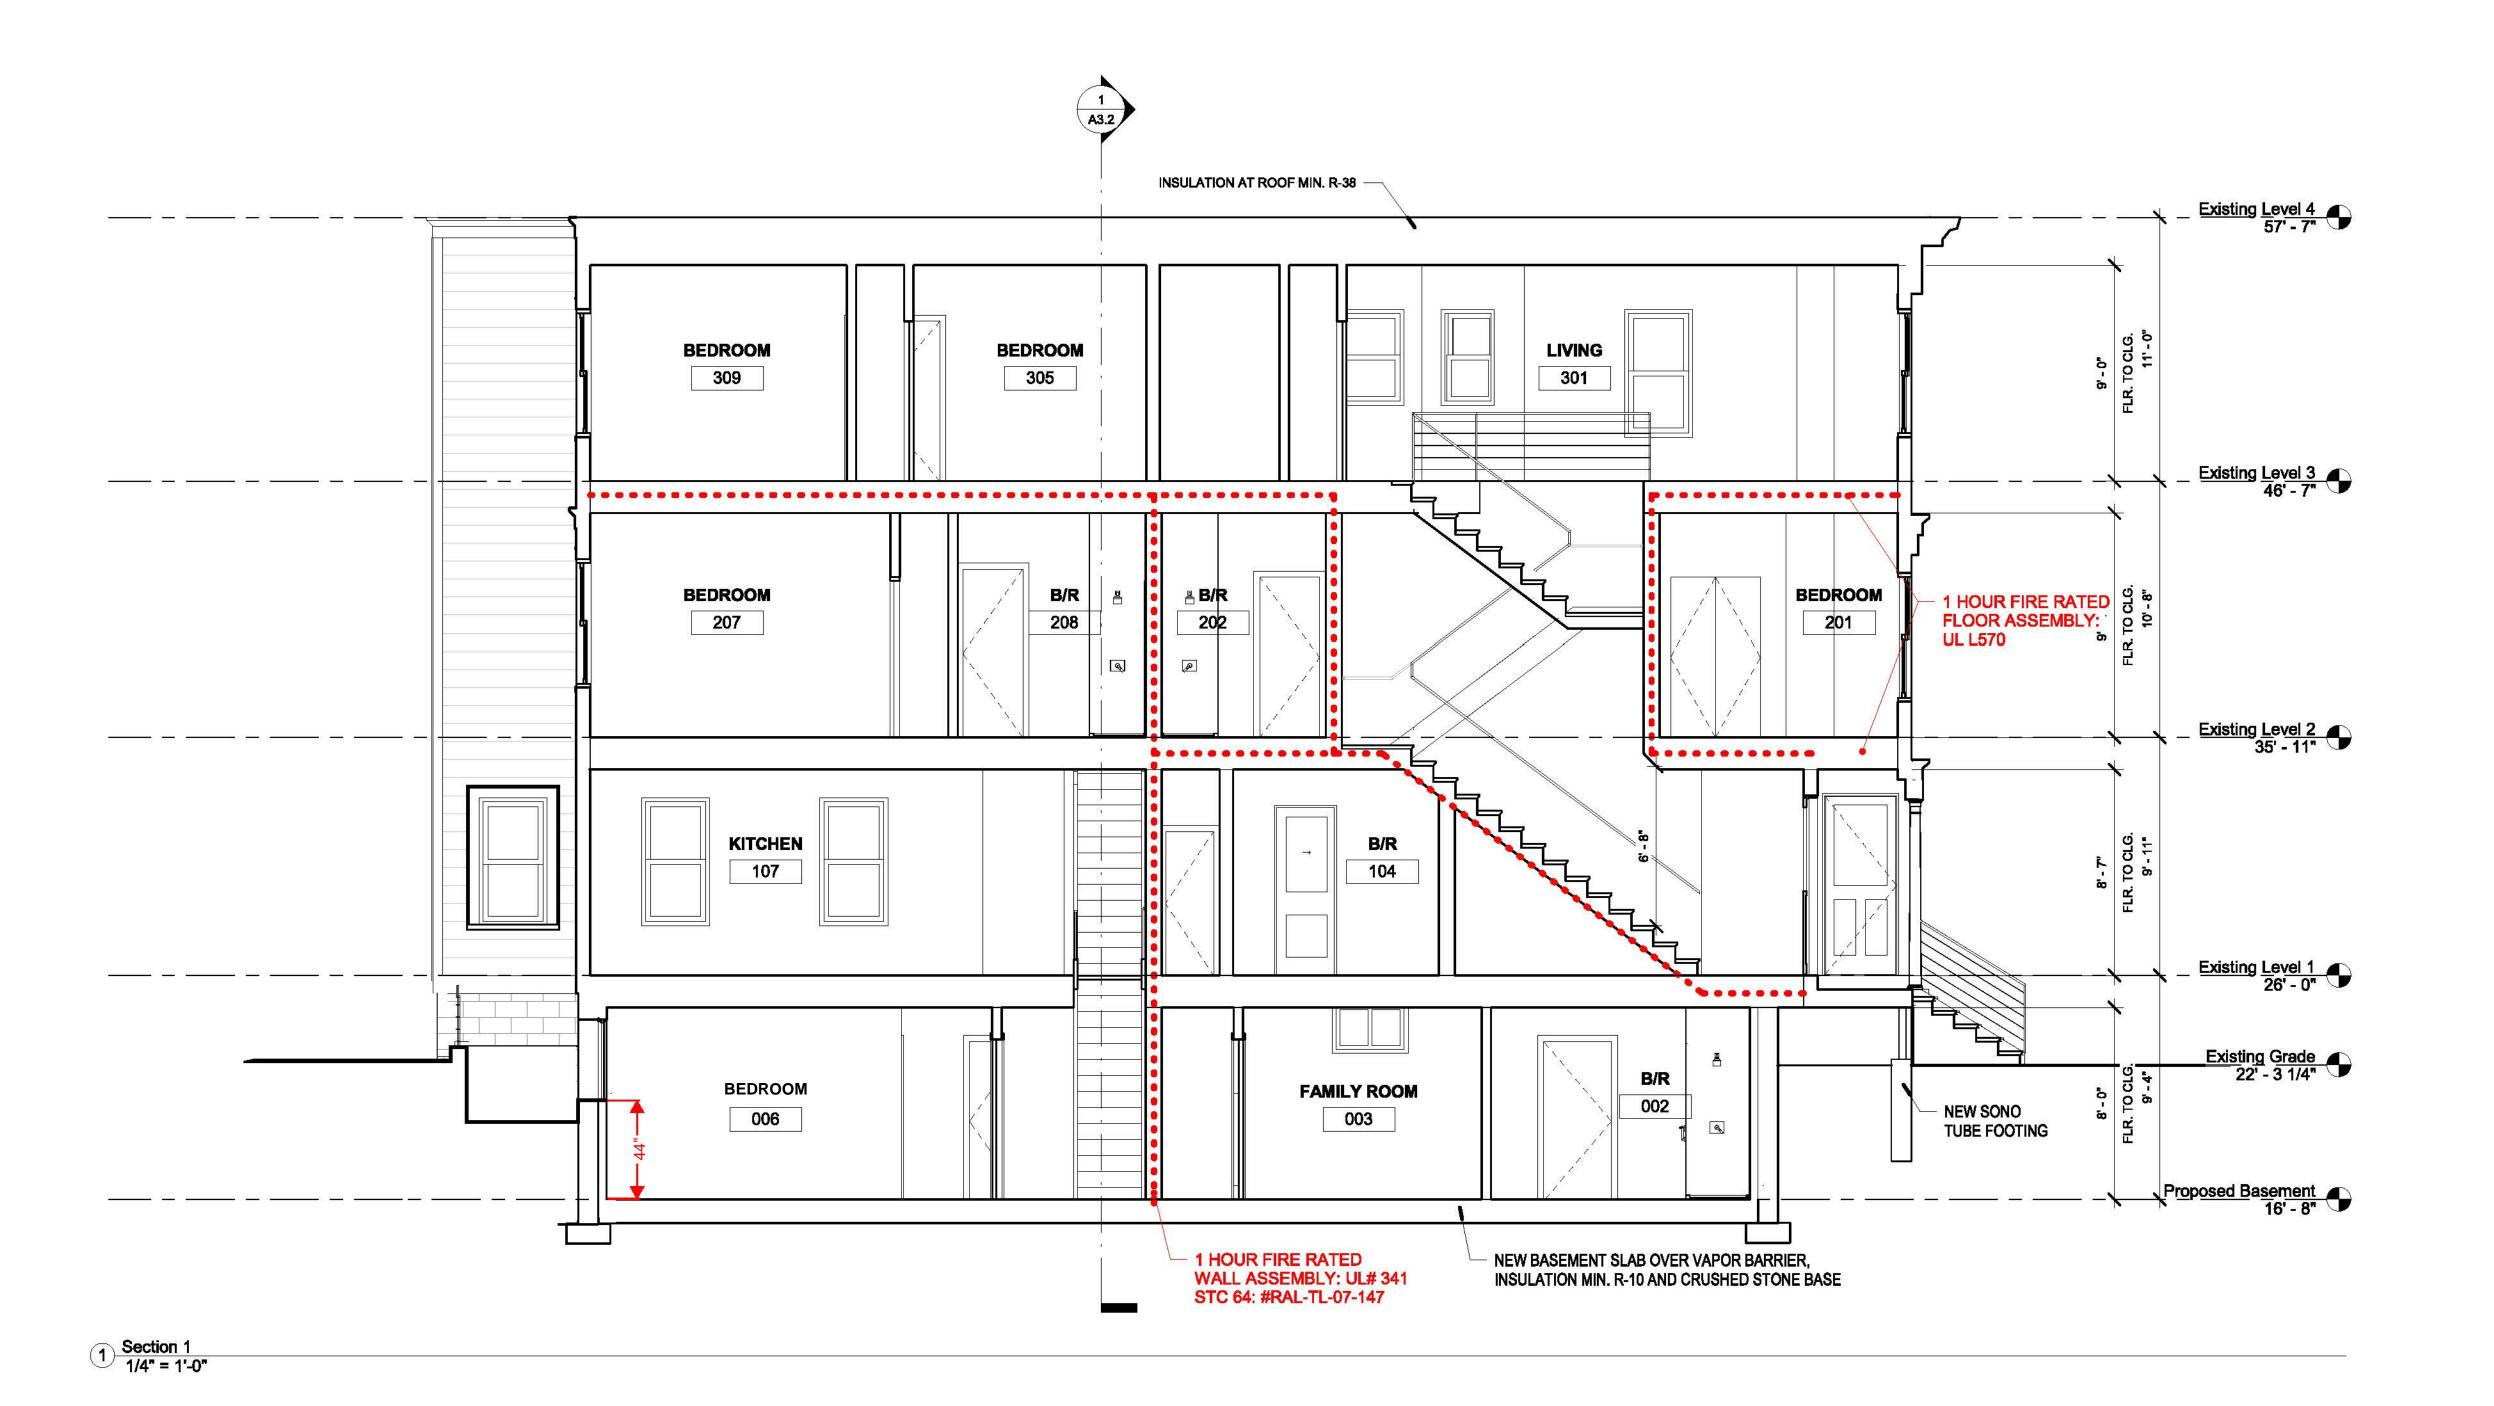
PROPOSED SECTIONS

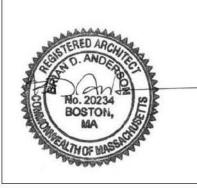Project# 2017


Deta 10/22/2020 Scale 1/4" = 1'-0"

Drawn by ER/DS/KA





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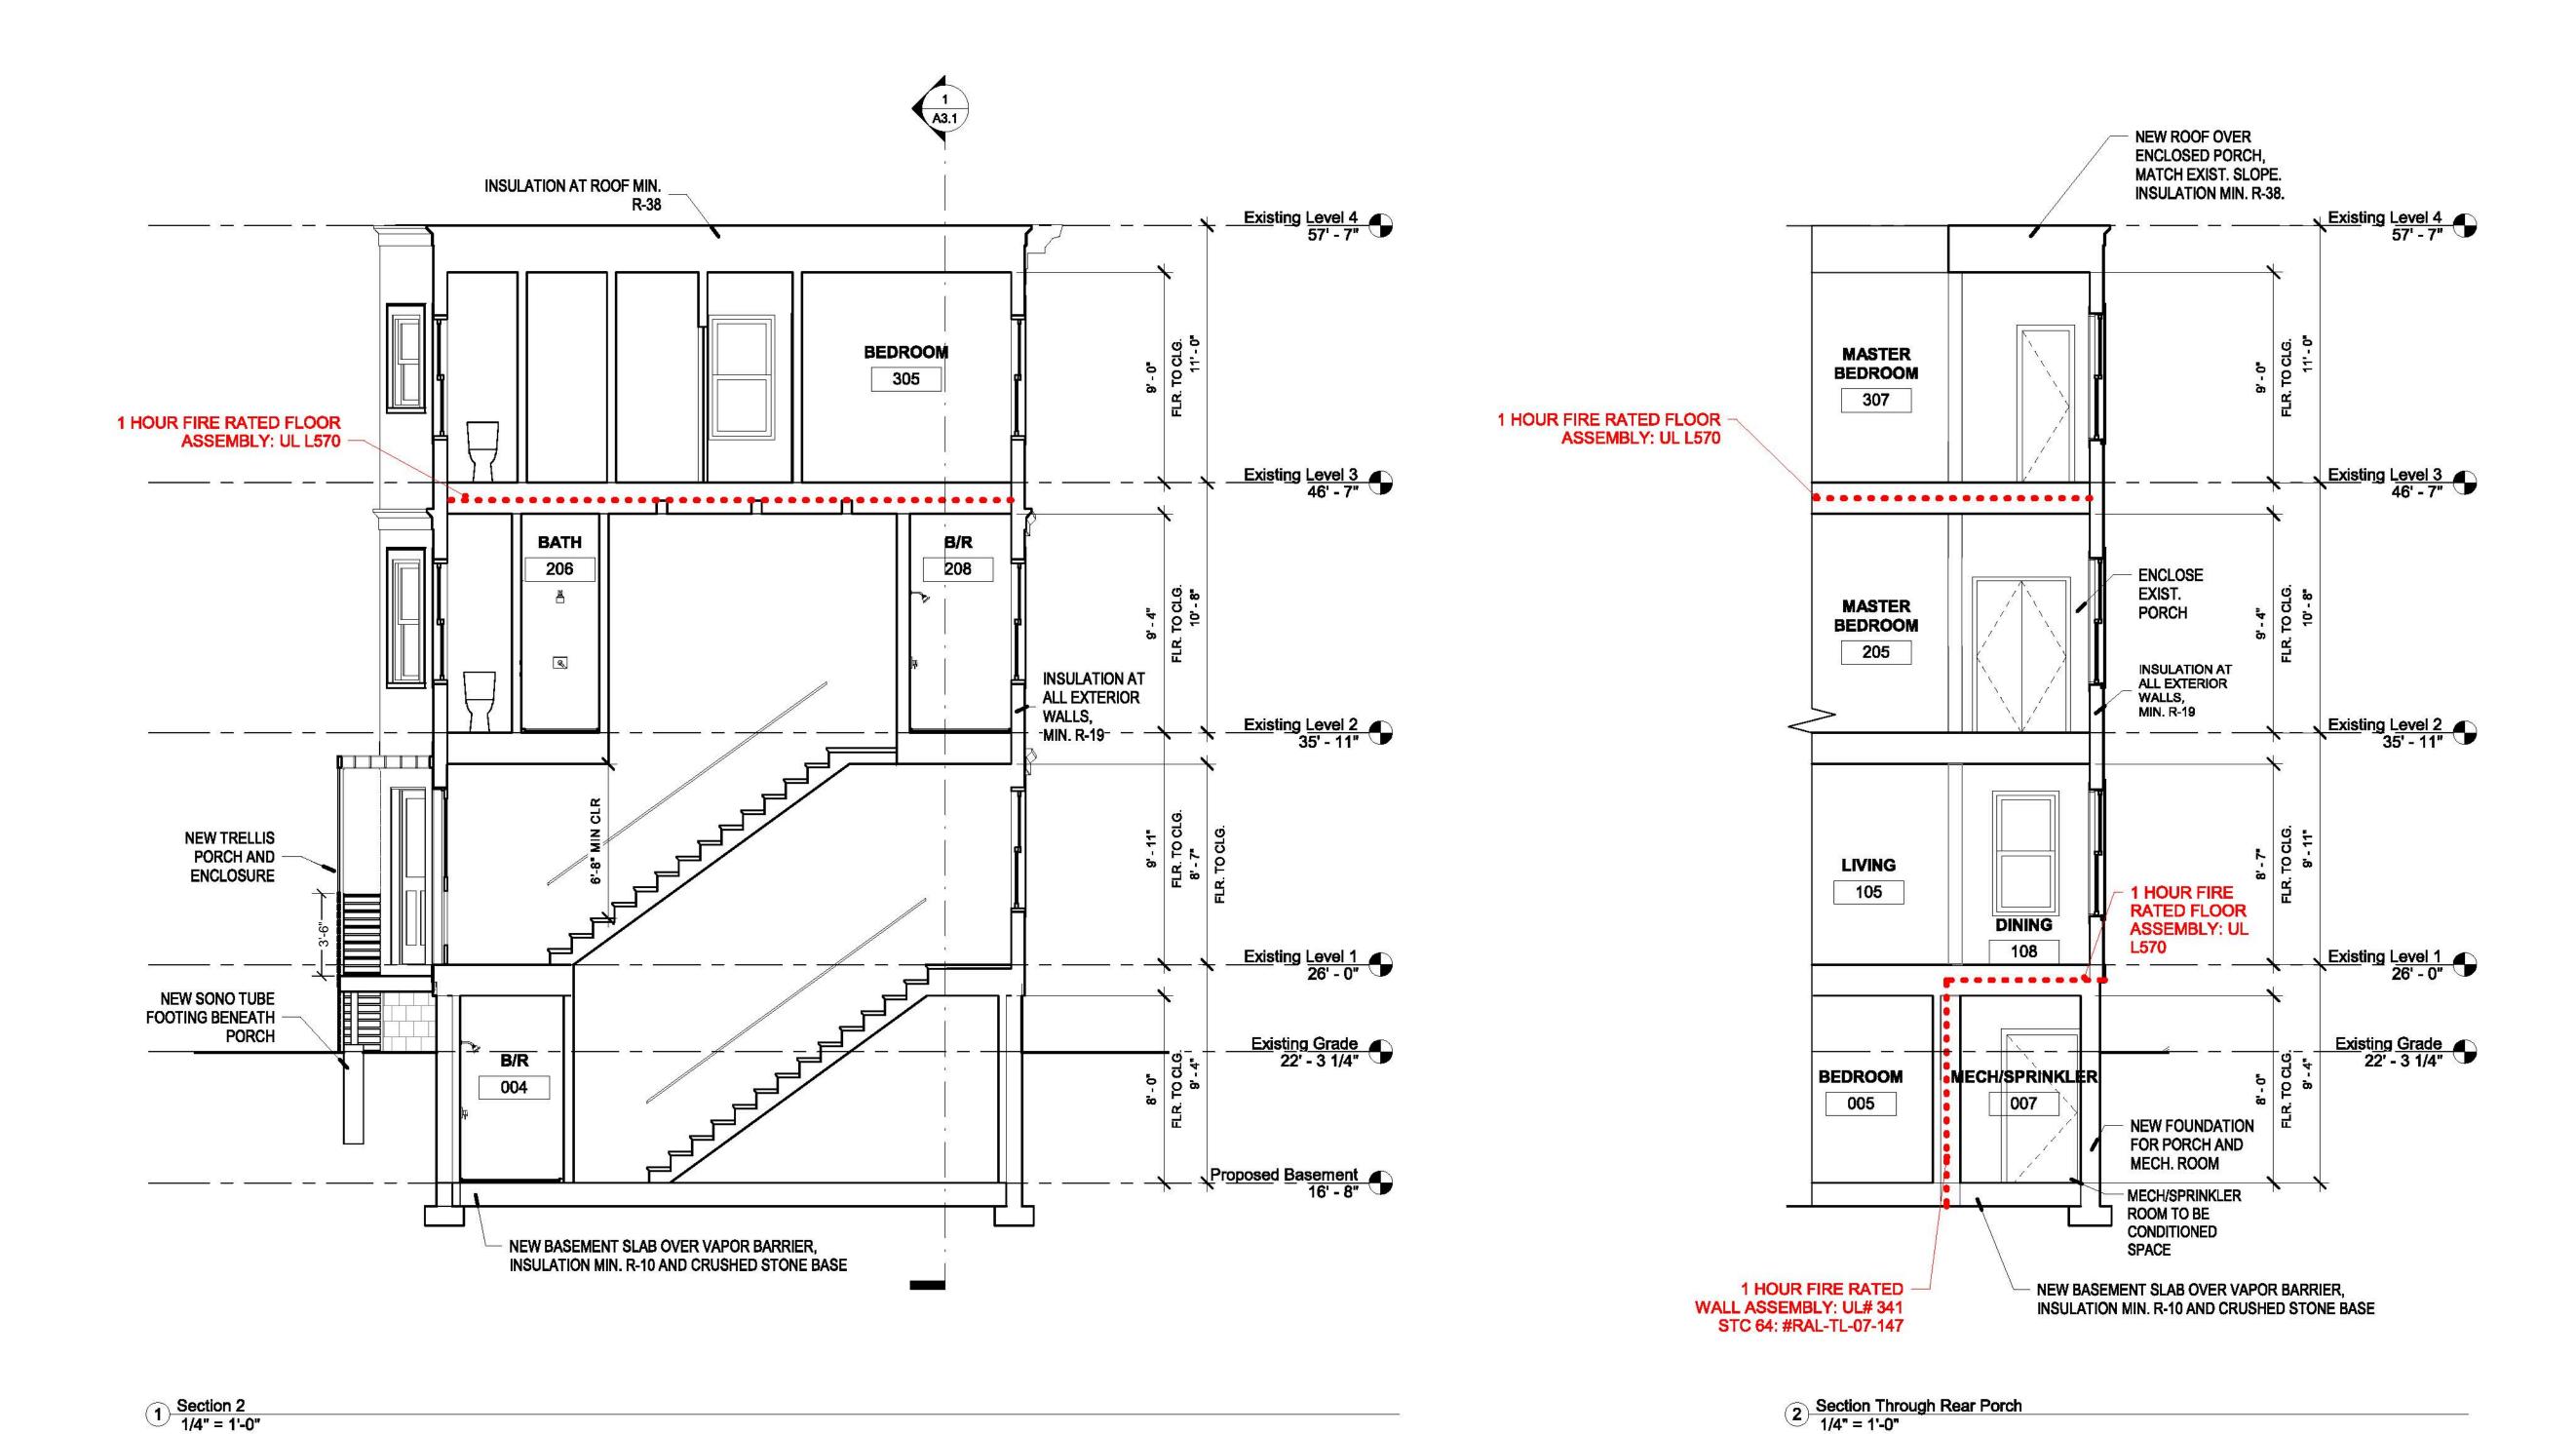
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Project# 2017

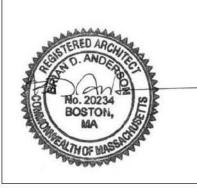
Deta 10/22/2020 Scale 1/4" = 1'-0"

Drawn by ER/DS/KA





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8 POPLAR ROAD
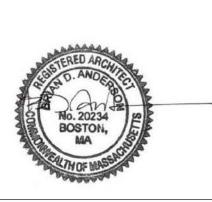
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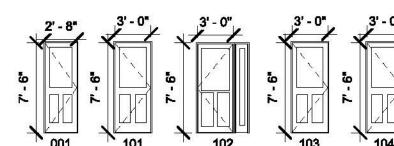
PROPOSED SECTIONS

Project# 2017


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A3.2


				DOOR SO	HEDUL	E					
	DOOR & FRAME								HINGE TYPE		
NUMBER	LEVEL	DESCRIPTION	MATERIAL	TYPE	FINISH	WIDTH	HEIGHT	THICKNESS	LATCH/LOCK TYPE	HINGE TYPE	
001	LOWER LEVEL	UNIT 2 SECOND ENTRY	WOOD	EXTERIOR SWINGING DOOR W/ PANELING	STAINED	2'-8"	7'-6"	0'-1-3/8"	ENTRY	STANDARD WEIGHT ANTIFRICTION BEARING	
101	LEVEL 1	UNIT 1 MAIN ENTRY	WOOD	EXTERIOR SWINGING DOOR W/ PANELING	SIMINED		7'-6"	0"-1-3/8"	ENTRY	STANDARD WEIGHT ANTIFRICTION BEARING	
102	LEVEL 1	UNIT 3 MAIN ENTRY		EXTERIOR SWINGING DOOR W/ PANELING			7'-6"	0'-1-3/8"	ENTRY	STANDARD WEIGHT ANTIFRICTION BEARING	
103	LEVEL 1	UNIT 1 SECOND ENTRY	GLASS /WOOD	EXTERIOR SWINGING DOOR W/ PANELING	STAINED	3'-0"	7'-6"	0'-1-3/8"	ENTRY	STANDARD WEIGHT ANTIFRICTION BEARING	
104	LEVEL 1	UNIT 2 MAIN ENTRY	GLASS /WOOD	EXTERIOR SWINGING DOOR W/ PANELING	STAINED	3'-0"	7'-6"	0'-1-3/8"	ENTRY	STANDARD WEIGHT ANTIFRICTION BEARING	




WINDOW SCHEDULE								
TYPE	NEW/	LOCATION	HEAD	FR	AME	REMARKS		
1301 E	EXISTING		HEIGHT	INTERIOR	EXTERIOR	REMARAS		
Α	NEW	NEW	VIF	WOOD	CLAD	Provide egress windows as code requires.     Provide tempered glass as code requires.		
В	NEW	NEW	VIF	WOOD	CLAD	3. Assume all window to be Jeld-Wen double hung 2-over-2 light.  4. All simulated divided lite muntin bars to be fixed, 7/8" with low conductance spacer bar typical exterior casings to match existing trim style.		
С	NEW	NEW	VIF	WOOD	CLAD	6. GC to verify height, width, and jamb depths in field prior to ordering windows. 7. Price screens (wood framed) as alternate. 8. Manufactuer to provide shop drawings for approcal prior to ordering windows.		
D	NEW	NEW	VIF	WOOD		9. Do not order without architects's written approve		
E	NEW	NEW	VIF	WOOD				
F	NEW	NEW	VIF	WOOD		CLAD		
G	NEW	EXISTING	VIF	WOOD	CLAD			
H	NEW	EXISTING	VIF	WOOD	CLAD			
J	NEW	EXISTING	VIF	WOOD	CLAD			
κ	NEW	EXISTING	VIF	WOOD	CLAD			
L	NEW	EXISTING	VIF	WOOD	CLAD			

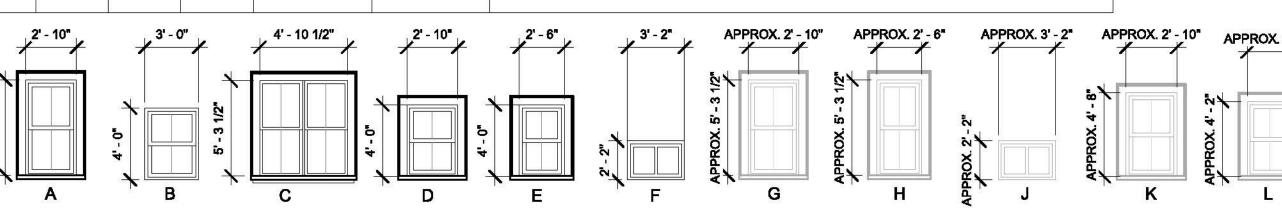

WINDOWS 3/16" = 1'-0"

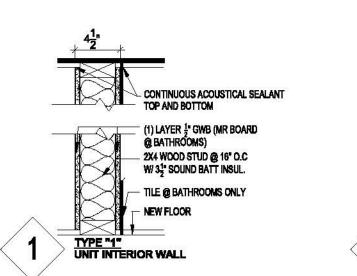

MATCH EXISTING EXTERIOR WALL, INSULATION MIN. R-19.

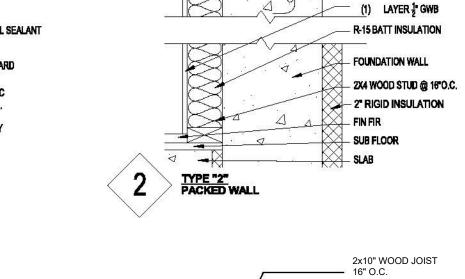

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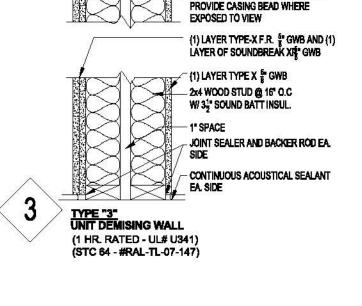
UL# 1-HR RATED CELING ASSEMBLY, STC 55 PLUS UL Des L569 RAL-INO4-007/TLO4-034


1" LEVELROCK


NOM 19/32" T&G PLY SUBFLOOR

INSULATION CLIPPED
TO SUBFLOOR
RC-1 CHANNEL
AT 16" 0.C.

\_\_\_\_\_ 5/8" TYP X GYP.



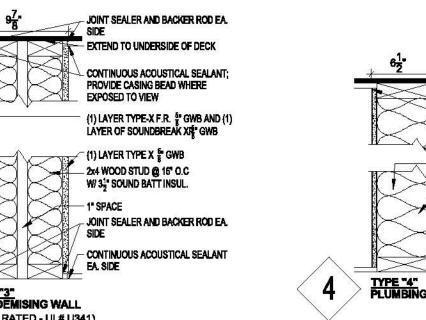

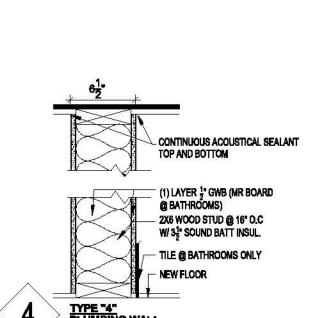



PERMIT SET

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875 Main Street, Cambridge, MA 02139
Tel. 617.354.2501 Fax. 617.354.2509

Project:	
	8 POPLAR ROAD
Address:	


8 POPLAR ROAD CAMBRIDGE, MA 02138


# SCHEDULES AND DETAILS

Drawing Issue	d By:	ANDERSON PORTER DESIGN
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Deta 10/22/2020 A5.1 Scale As indicated Drawn by KA

	FINISH CEILING
	HEADROOM
HANDRAILS SHALL NOT PROJECT MORE THAN 4-1/2 INCHES ON EITHER SIDE OF THE STAIRWAY. HANDRAILS ADJACENT TO A WALL SHALL HAVE A SPACE OF NOT LESS THAN 1-1/2 INCHES BETWEEN THE WALL AND THE HANDRAILS.  HANDRAILS SHALL BE CONTINUOUS FOR THE FULL LENGTH OF THE FLIGHT, FROM A POINT DIRECTLY ABOVE THE TOP RISER OF THE FLIGHT TO A POINT DIRECTLY ABOVE THE LOWEST RISER OF THE FLIGHT. HANDRAIL ENDS SHALL BE RETURNED OR SHALL TERMINATE IN NEWEL POSTS OR SAFETY TERMINALS.	2-10° MIN. 3-2° MAX. HANDRAIL HEIGHT
STAIRWAYS SHALL BE NOT LESS THAN 36 INCHES IN CLEAR WIDTH AT ALL POINTS ABOVE THE PERMITTED HANDRAIL HEIGHT AND BELOW THE REQUIRED HEADROOM HEIGHT. THE CLEAR WIDTH OF STAIRWAYS AT AND BELOW THE HANDRAIL HEIGHT, INCLUDING TREADS AND LANDINGS, SHALL NOT BE LESS THAN 31-1/2 INCHES WHERE A HANDRAIL IS INSTALLED ON ONE SIDE, AND 27 INCHES WHERE HANDRAILS ARE INSTALLED ON BOTH SIDES.	9" MIN. TREAD STARS
NOSINGS AT TREADS, LANDINGS, AND FLOORS OF STAIRWAYS SHALL HAVE A RADIUS OF CURVATURE AT THE NOSING NOT GREATER THAN 9/16 INCH OR A BEVEL NOT GREATER THAN 1/2 INCH. A NOSING PROJECTION NOT LESS THAN 3/4 INCH AND NOT MORE THAN 1-1/4 INCHES SHALL BE PROVIDED ON STAIRWAYS. THE GREATEST NOSING PROJECTION SHALL NOT EXCEED THE SMALLEST NOSING PROJECTION BY MORE THAN 3/8 INCH WITHIN A STAIRWAY.	FINISH FLOOR  1-HR RATED WHERE NOTED



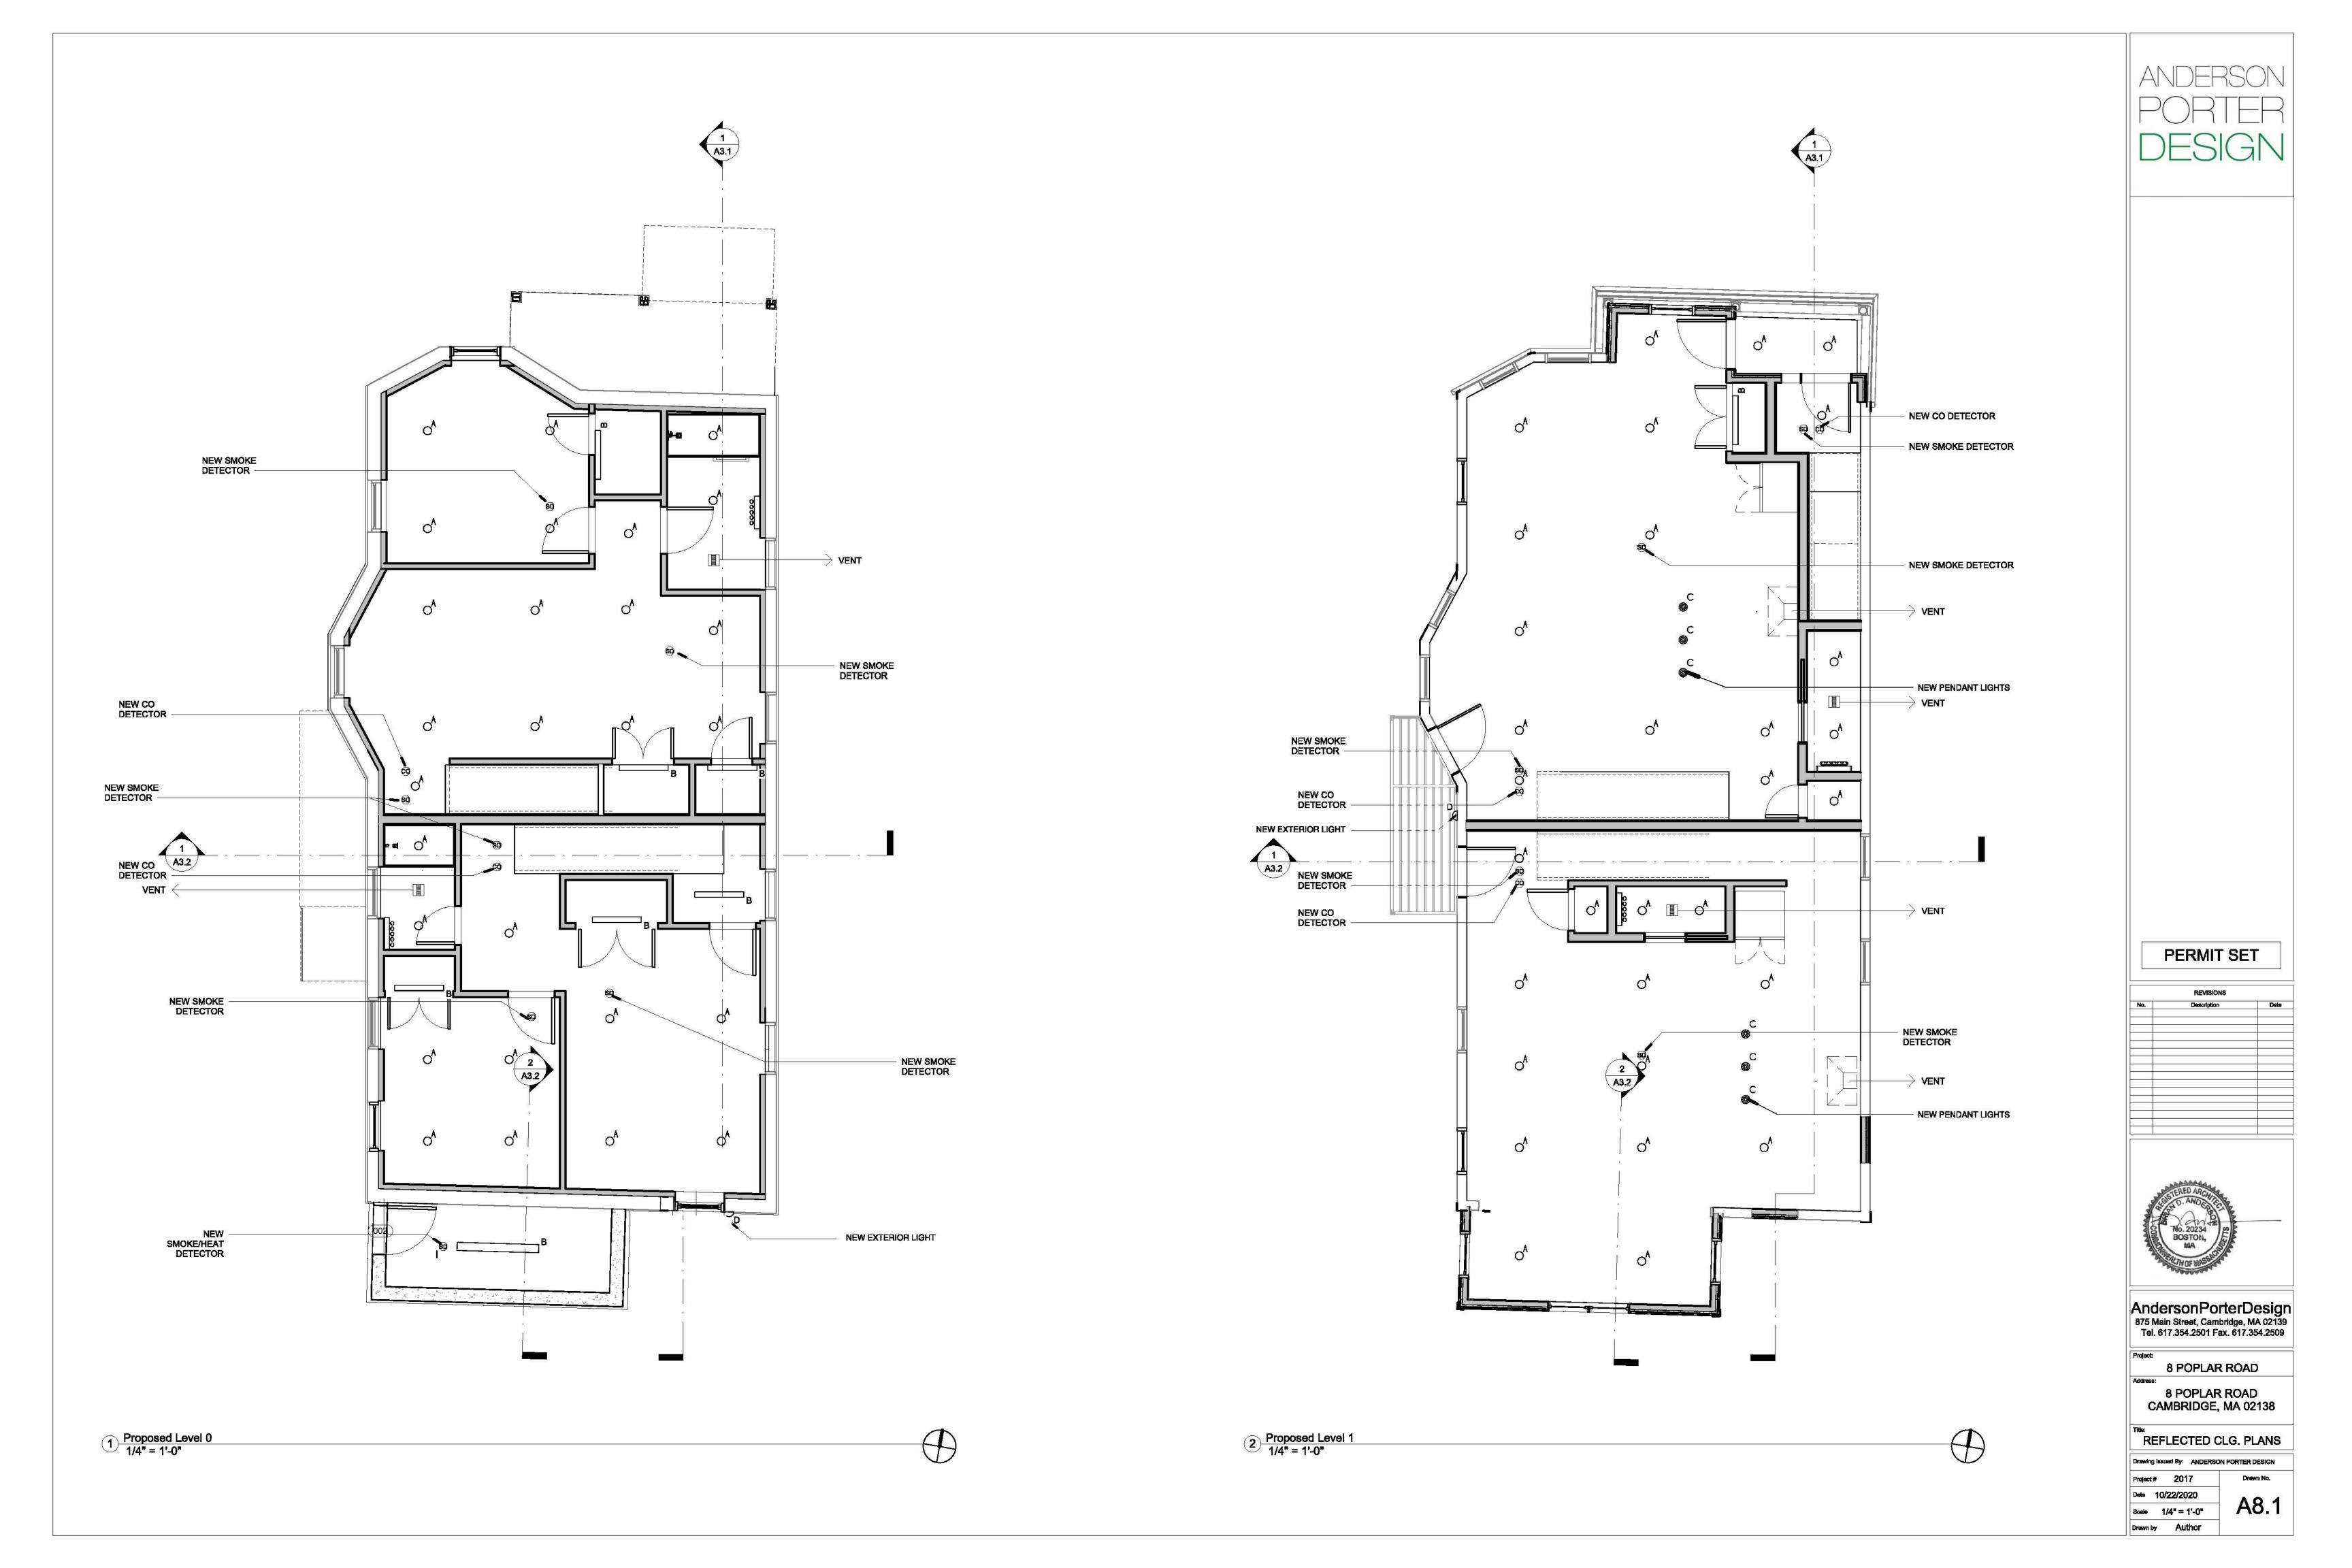

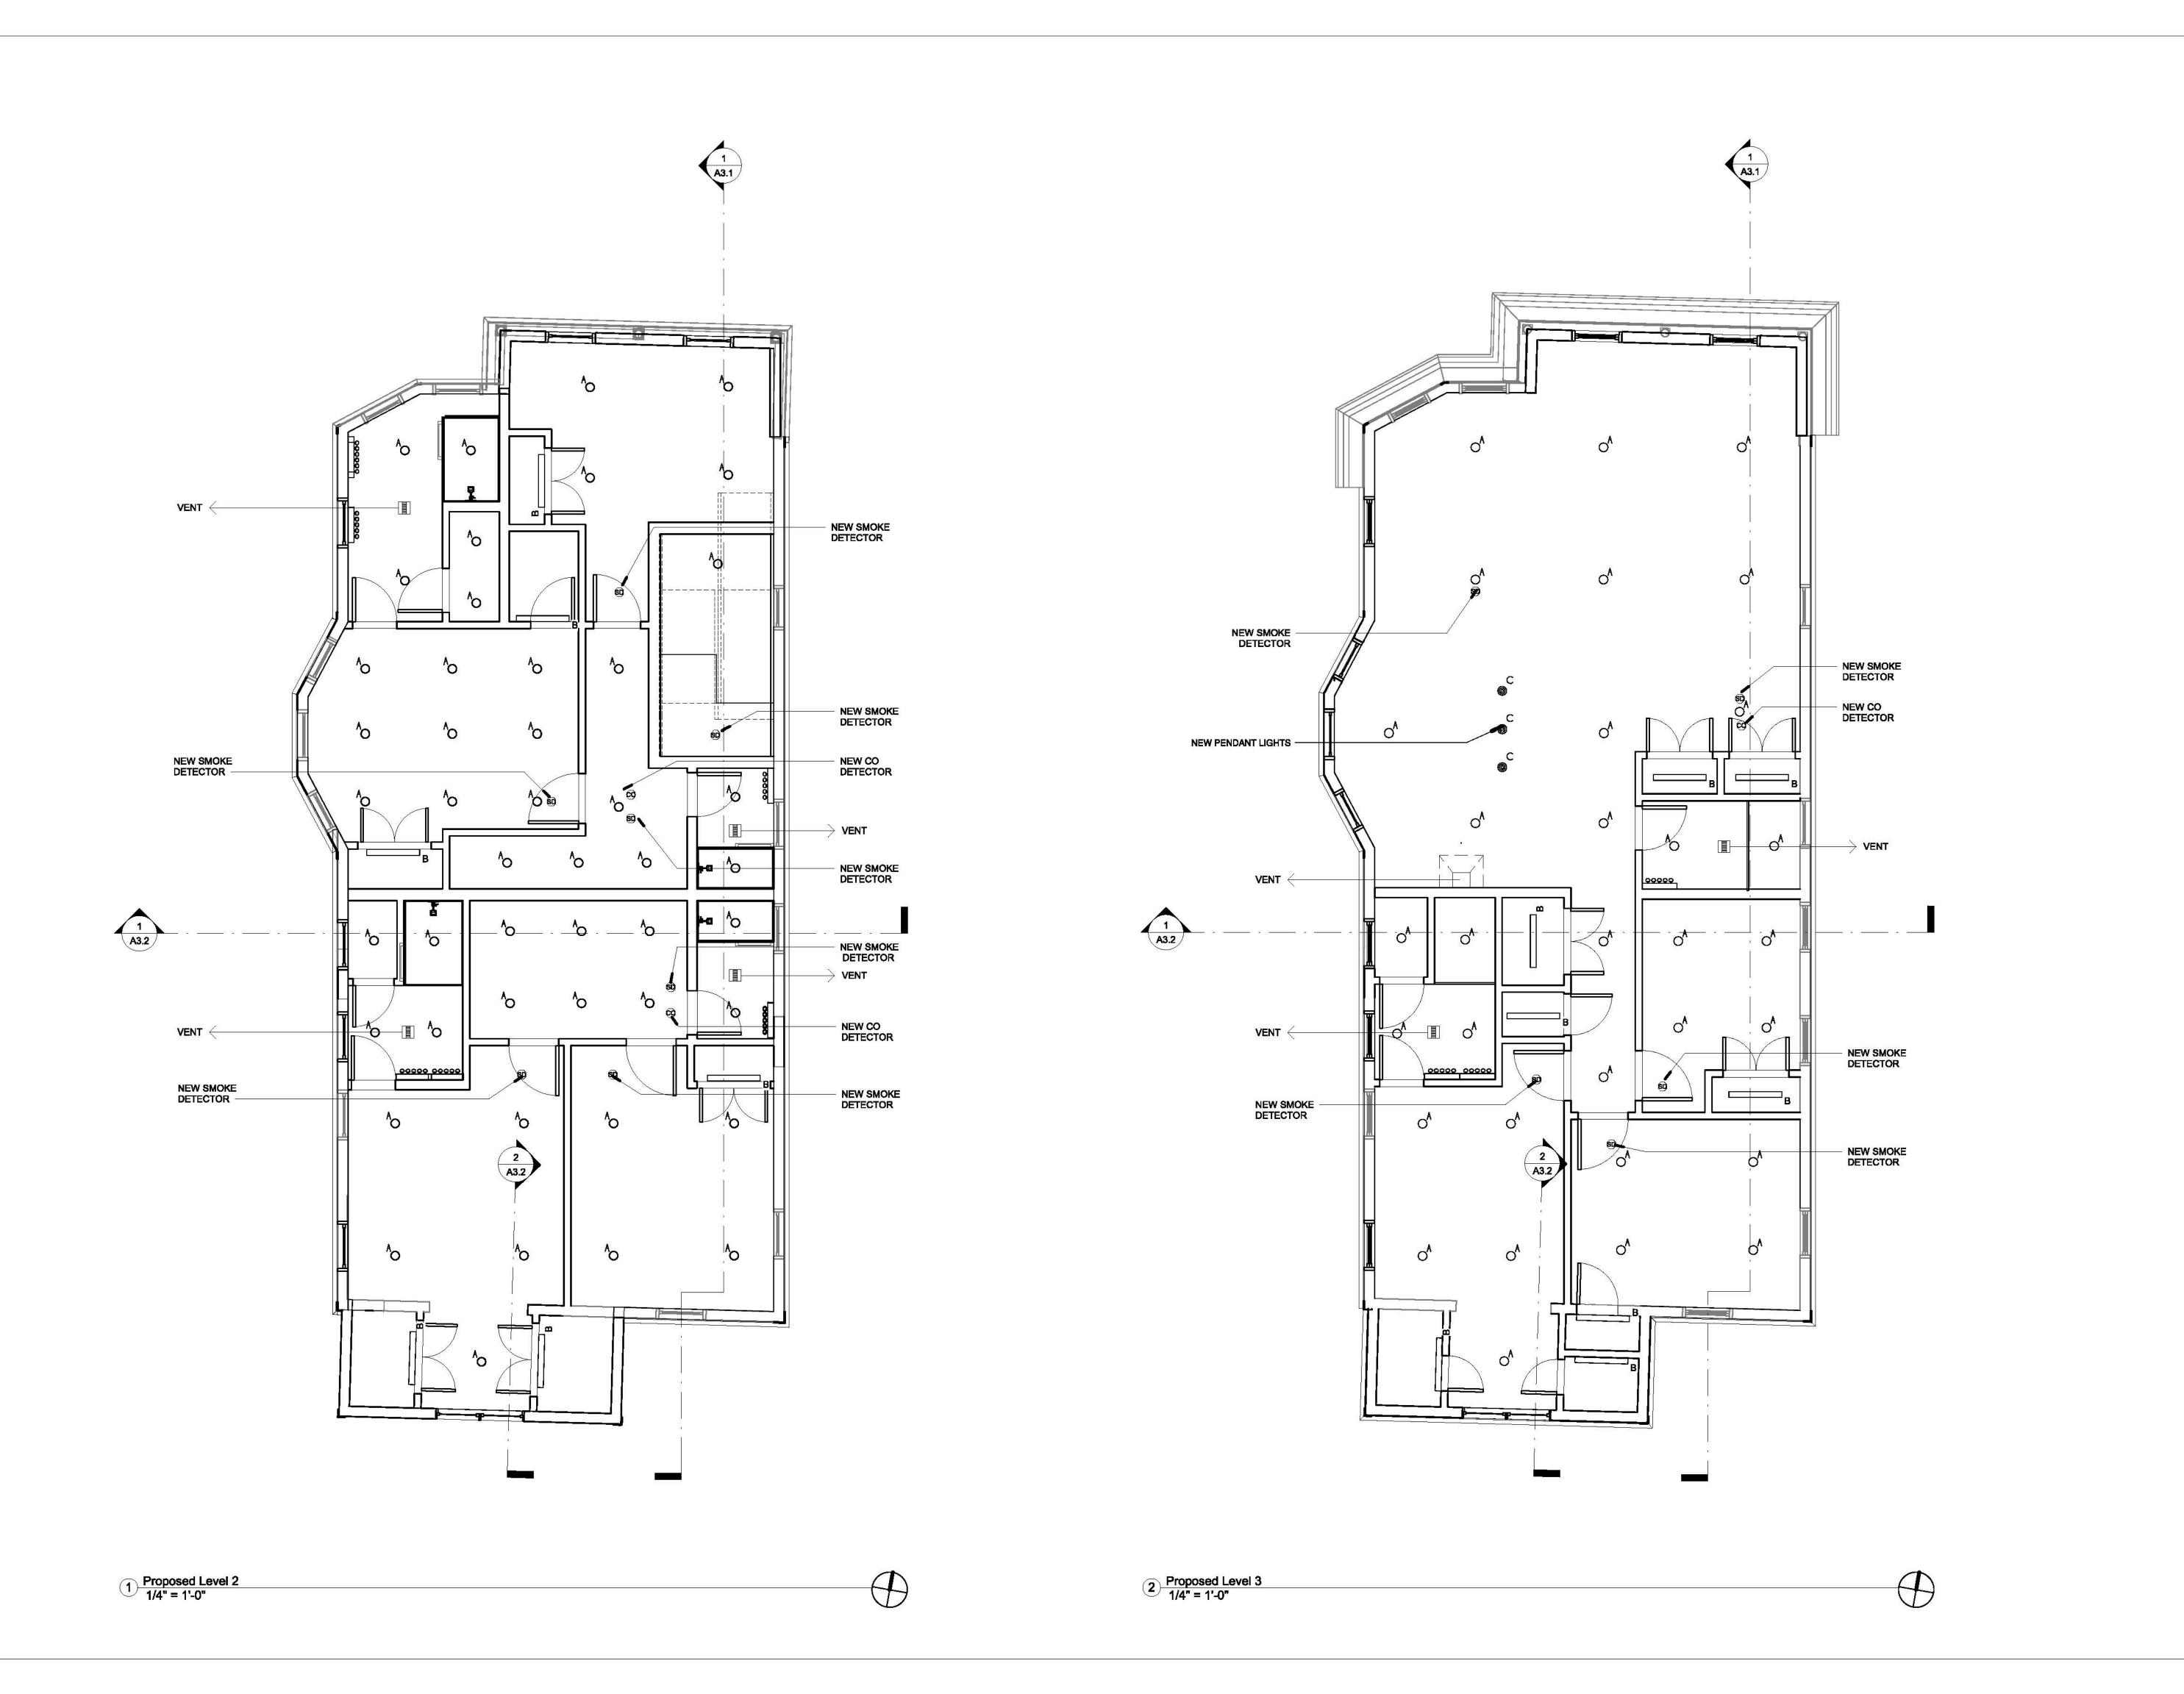

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Description	Date					
	12					
	REVISIONS  Description					




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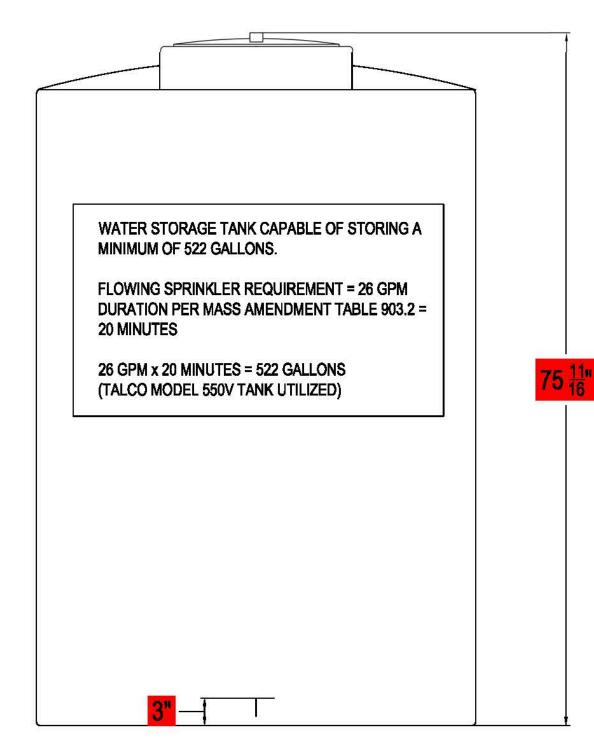
8 POPLAR ROAD

8 POPLAR ROAD CAMBRIDGE, MA 02138

REFELCTED CLG. PLANS

Deta 10/22/2020 A8.2 Scale 1/4" = 1'-0" Drawn by Author



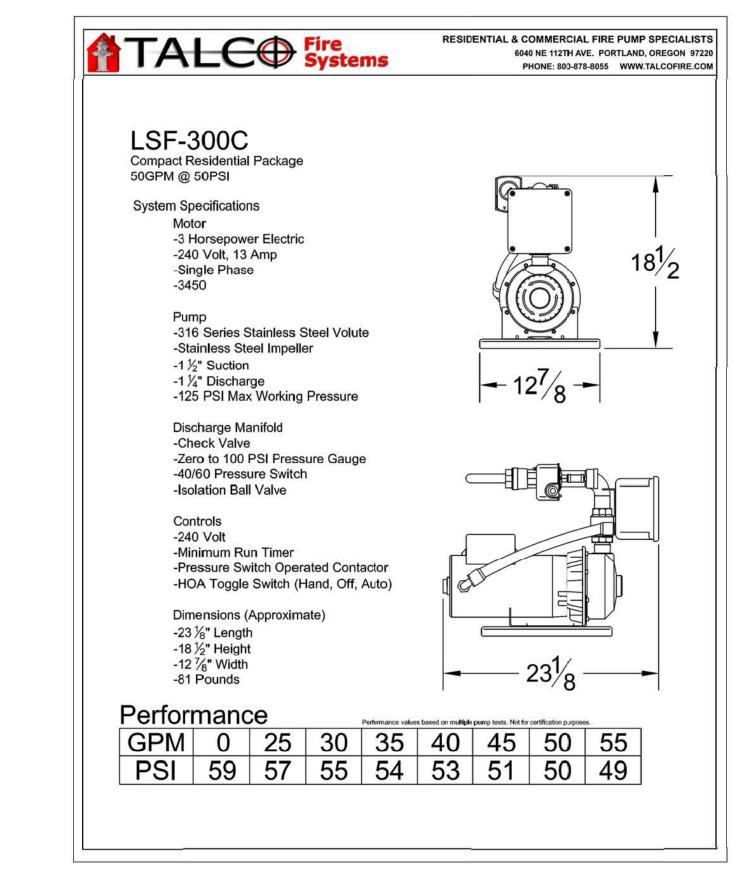

## **WATER STORAGE TANK DETAIL** NOT TO SCALE

Calculation results for Desig	n Area <u>1</u>	- 3rd Flr - Unit 3	
This system as shown on		company print no	dated
for 8 Poplar Road	at 8	Poplar Road	
contract no a maximum area of <u>266 ft²</u> Hose stream allowance of _	and the state of t	rater at a rate of 26.1 gpm at 33.8 ps	nin/m²) of floor area over <u>i</u> at the base of the riser.
Occupancy classification: Recommodity classification: Maximum storage height: Storage arrangement:	esidential	Number o System Ty Maximum	

Pressure Required at Source: 33.8 psi
Pressure Available at Source: 56.3 psi
Surplus Pressure at Source: 22.5 psi Flow from In-Rack sprinklers: Flow from Overhead sprinklers: 26.1 gpm Flow from Inside Hoses: 0 gpm Flow from Outside Hoses: 0 gpm Other fixed flows: 0 gpm Total flow in system piping: 26.1 gpm 0 gpm 26.1 gpm Additional flow at/beyond source:

Total of all flows:

**GENERAL NOTES:** 

8 POPLAR ROAD IS AN EXISTING WOOD STRUCTURE MULTI-FAMILY HOME CONTAINING 3 SEPARATE LIVING AREAS. IT IS CLASSIFIED AS AN R-3 DWELLING / TYPE V CONSTRUCTION AND IS APPROXIMATLY 40'-0" (3 STORIES ) IN HEIGHT FROM GRADE PLUS 1 LEVEL BELOW GRADE. TOTAL AREA OF LIVABLE SPACE EQUALS 5,343 SQ.FT.

THE DRAWING BACKGROUND, INCLUDING WALL AND DOOR LOCATIONS HAVE BEEN PROVIDED BY OTHERS. ACCURACY OF WALL LOCATIONS AND DIMENSIONS SHALL BE FIELD VERIFIED BY THE CONTRACTOR WITH REGARDS TO PIPE ROUTING AND PROXIMITY TO OBSTRUCTIONS.

ALL MATERIALS USED ARE TO BE ULLISTED AND COMPLY WITH NFPA 13D (2013 EDITION) AND THE MASSACHUSETTS STATE BUILDING CODE (9TH EDITION).

SPRINKLER SYSTEM INSTALLATION IS TO CONFORM TO NFPA 13D (2013 EDITION). DESIGN AREA 1 IS HYDRAULICALLY CALCULATED AT A .05 DENSITY FLOWING 2 RESIDENTIAL SPRINKLERS. THE SYSTEM IS SUPPLIED BY A TALCO MODEL 550V VERTICAL WATER TANK AND A 50 PSI @ 50 GPM TALCO LSF-300C FIRE PUMP.

OWNER IS REQUIRED TO PROVIDE HEAT THROUGHOUT THE ENTIRE BUILDING TO MAINTAIN MINIMUM TEMPERATURE OF 40°F FOR ALL AREAS PROTECTED WITH A WET PIPE SPRINKLER SYSTEM. ALL THIRD FLOOR SPRINKLER PIPING IS TO BE INSTALLED BENEATH ROOF / ATTIC INSULATION. THE SYSTEM IS TO BE MAINTAINED BY THE OWNER AS REQUIRED BY NFPA-25.

ALL PIPING IS BLAZEMASTER CPVC WITH CPVC FITTINGS. CPVC PIPING IS TO BE SUPPORTED PER BLAZEMASTER AND NFPA GUIDELINES FOR PLASTIC PIPING, PIPING CONNECTING TO FIRE PUMP SHALL BE BLACK STEEL SCHEDULE 40.

ALL PENDENT SPRINKLER HEADS WILL BE LOCATED AS REQUIRED BY NFPA13D STANDARDS TO ASSURE PROPER CLEARANCES FROM SURFACE-MOUNTED OBSTRUCTIONS.

LOCATION OF ANY HIGH TEMPERATURE SPRINKLERS TO BE DETERMINED IN THE FIELD. PIPING IS TO BE SUPPORTED AS REQUIRED BY NFPA-13D. HANGERS ARE TO BE FIELD LOCATED TO BEST SUPPORT THE PIPE.

ALL PIPING WILL BE HYDROSTATICALLY TESTED AT 200 PSI FOR 2 HOURS.

PIPING ELEVATIONS SHOWN ARE MEASURED FROM THE BASEMENT FLOOR FOR HYDRAULIC CALCULATION PURPOSES.

STRUCTURAL LOAD BEARING ANALYSIS IS NOT INCLUDED WITHIN THE SCOPE OF THE SPRINKLER INSTALLATION.

ELECTRICAL OR ALARM WIRING OF DEVICES PROVIDED UNDER THE SPRINKLER SCOPE IS TO BE DONE BY OTHERS IN ACCORDANCE WITH NFPA72 - LATEST EDITION.

SPRINKLERS ARE NOT REQUIRED IN THE FOLLOWING AREAS AS OUTLINED IN NFPA13D, 2013 EDITION AS LONG AS THE WALLS AND CEILINGS ARE SURFACED WITH NONCOMBUSTIBLE OR LIMITED COMBUSTIBLE MATERIALS AS DEFINED BY NFPA 222 -STANDARD ON TYPES OF BUILDING CONSTRUCTION:

BATHROOMS NOT EXCEEDING 55 SQUARE FEET (PER SECTION 8.3.2)

**SPRINKLER HEAD LEGEND:** 

- CLOTHES CLOSETS, LINEN CLOSETS AND PANTRIES NOT EXCEEDING 24 SQUARE FEET OR THE LEAST DIMENSION NOT EXCEEDING 3'-0" (PER SECTION 8.3.3)
- SPRINKLERS SHALL BE INSTALLED IN ANY CLOSET USED FOR HEATING AND AIR-CONDITIONING EQUIPMENT. (PER SECTION
- SPRINKLERS SHALL NOT BE REQUIRED IN ANY PORCHES, BALCONIES, CORRIDORS, AND STAIRS THAT ARE OPEN AND ATTACHED. (PER SECTION 8.3.4)
- SPRINKLERS SHALL NOT BE REQUIRED IN ATTICS, PENTHOUSE, EQUIPMENT ROOMS, CRAWL SPACES, FLOOR/CEILING SPACES, ELEVATOR SHAFTS AND OTHER AREAS NOT INTENDED FOR LIVING PURPOSES OR STORAGE (PER SECTION 8.3.5)
- SPRINKLERS SHALL NOT BE REQUIRED IN CLOSETS ON EXTERIOR BALCONIES, REGARDLESS OF SIZE, AS LONG AS THERE ARE NO DOORS OR UNPROTECTED PENETRATIONS FROM THE CLOSET DIRECTLY INTO THE DWELLING UNIT. (PER SECTION

RESIDENTIAL NOTES:

UNINSULATED HEAT DUCTS

UNINSULATED HOT WATER PIPES

AS PER NFPA 13D TABLE 7.5.6.3 MINIMUM DISTANCES FOR ORDINARY AND INTERMEDIATE TEMPERATURE RESIDENTIAL SPRINKLERS:

HEAT SOURCE MINIMUM DISTANCE FROM EDGE OF SOURCE TO ORDINARY-TEMP SPRINKLER


SIDE OF OPEN OR RECESSED FIREPLACE FRONT OF RECESSED **FIREPLACE** COAL OR WOOD BURNING STOVE SIDE OF CEILING OR WALL MOUNTED HOT AIR DIFFUSERS HOT WATER HEATER OR FURNACE LIGHT FIXTURE 0 W - 250 W 250 W - 499 W KITCHEN RANGE / WALL OVEN **HOT AIR FLUES** 


> Digitally signed b Scott Henderson



SYM	CNT	NAME	RESPONSE	METAL	TEMP	K	NPT	SIN#	MFG.	MODEL#	ESCUT
•	49	RES. PENDENT	Q.R.	WHITE	160	4.90	1/2"	TY3596	TYCO	LFII	CONCEALED
Ø	4	PENDENT	Q.R.	CHROME	200	5.60	1/2"	TY3231	TYCO	LFII	RECESSED

TYCO RESIDENTIAL PENDENTS: 16' x 16' COVERAGE (NO MORE THAN 8'-0" FROM A WALL) WATER REQUIREMENTS: 13 GPM @ 7.0 PSI PER SPRINKLER

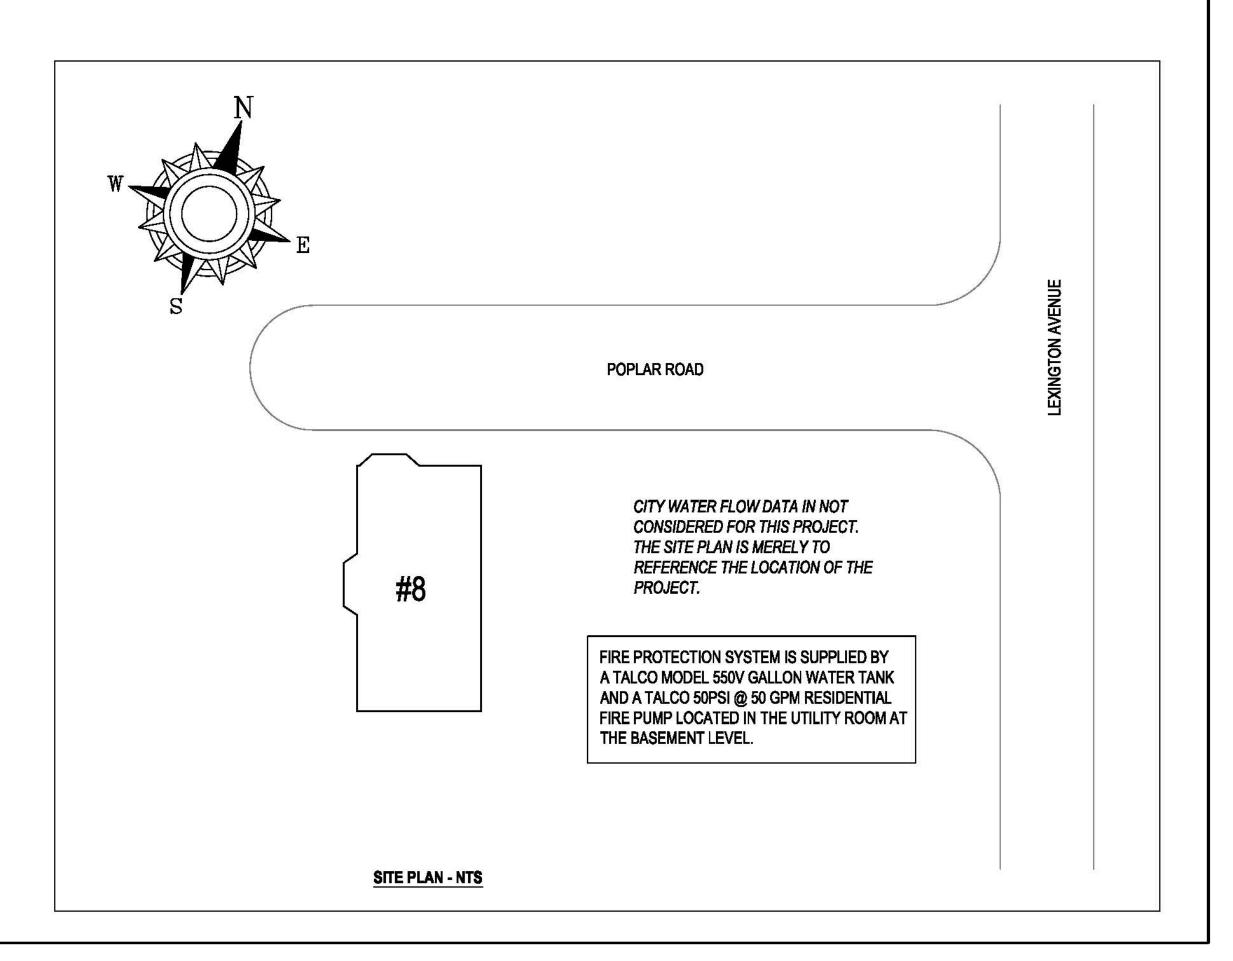

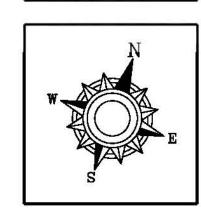



Drawing Date: 10-13-20 Drawn By: JC Scale: AS NOTED

02138 ROAD POPLAR  $\infty$ 

Sheet Title FIRE SPRINKLER BASEMENT PLAN NOTES & DETAILS

FP-1

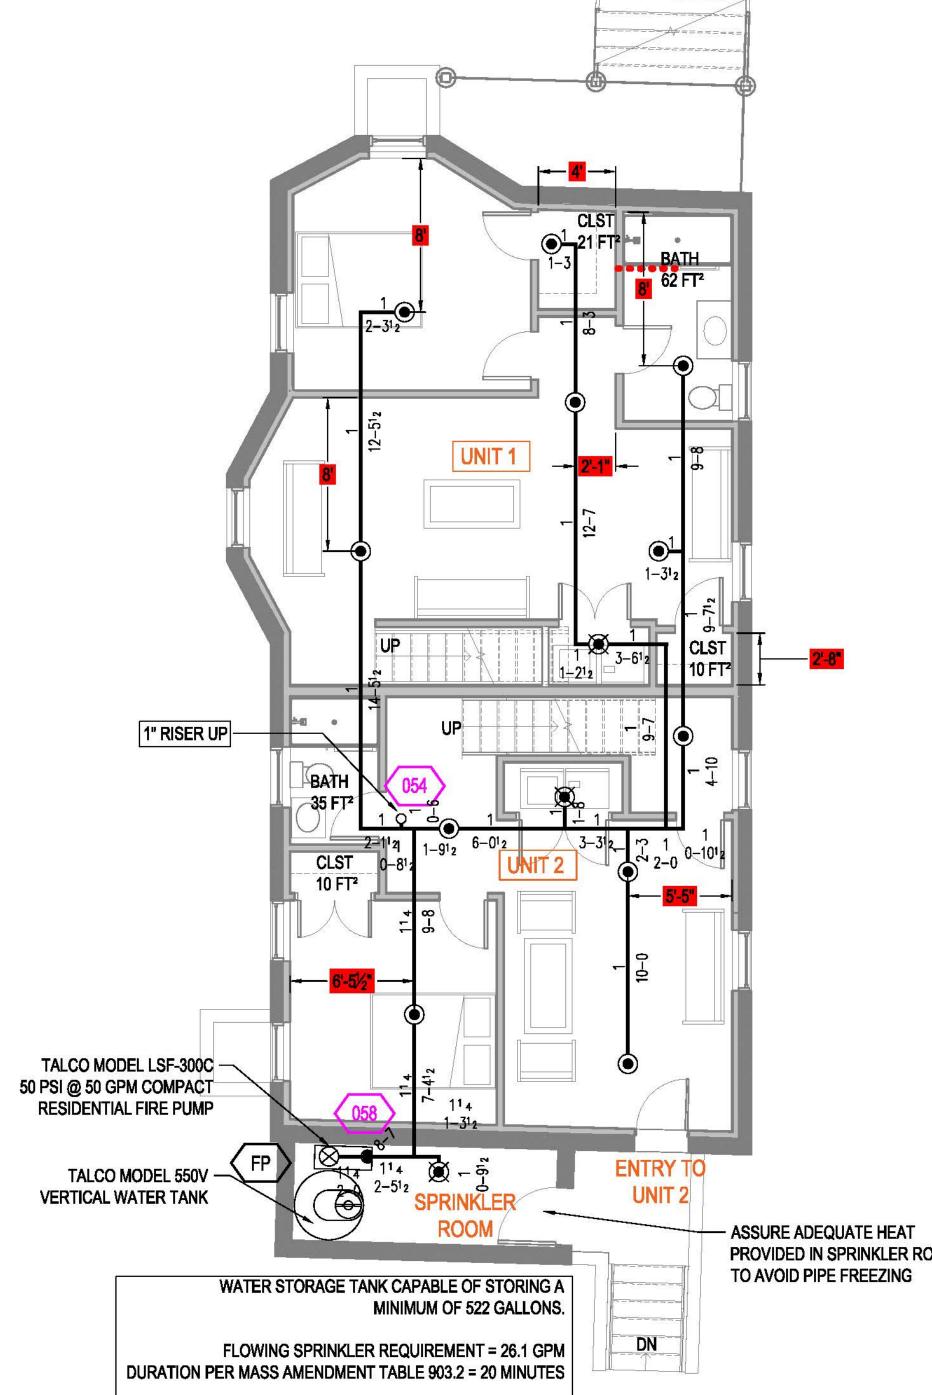


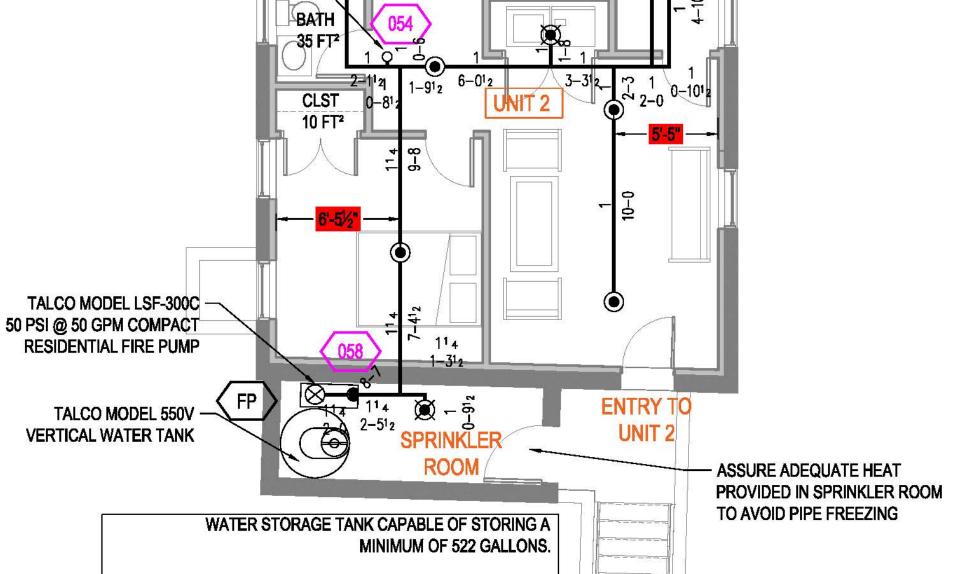



BASEMENT FLOOR PLAN - 1/4 " = 1'-0"


AREA = 1,218 S.F.+/-


26.1 GPM x 20 MINUTES = 522 GALLONS

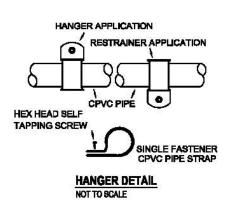

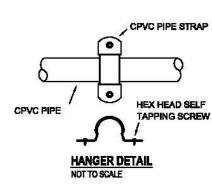

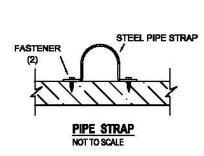

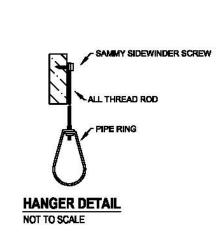

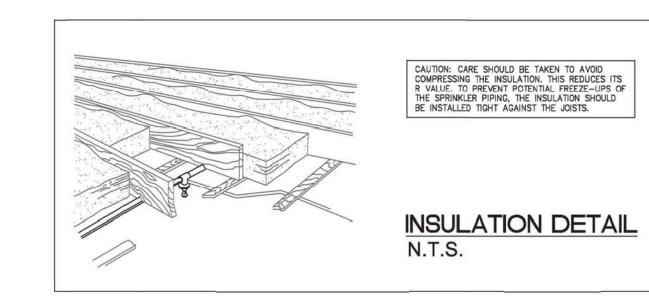





SYM	CNT	NAME	RESPONSE	METAL	TEMP	K	NPT	SIN#	MFG.	MODEL#	ESCUT
•	49	RES. PENDENT	Q.R.	WHITE	160	4.90	1/2"	TY3596	TYCO	LFII	CONCEALED
<b>®</b>	4	PENDENT	Q.R.	CHROME	200	5.60	1/2"	TY3231	TYCO	LFII	RECESSED

TYCO RESIDENTIAL PENDENTS: 16" x 16" COVERAGE (NO MORE THAN 8"-0" FROM A WALL) WATER REQUIREMENTS: 13 GPM @ 7.0 PSI PER SPRINKLER

This system as shown on			print no		dated
for 8 Poplar Road	at <u>8 Pop</u>	kar Road	. Million Primer Louis	17	on XII III SALAA
contract no	is designed to dischar	gpm/ft² (L/min/m²) of fi		loor area over	
a maximum area of 266 ft <sup>a</sup>	when supplied with water	rat a rate of 26.1 gpm	_at 33.8 psi	at the base	of the riser
Hose stream allowance of	is included in the	above.			
Occupancy classification: Resi	Idential		Number of	heads flow	ing: 2
Commodity classification:			System Type: Maximum velocity:		Wet 8.79 ft/s
Meximum storage height:					
Storage arrangement:				27	95
Flow from In-Rack sprinklers:	0 gpm	Pressure Required	at Source: 3	13.8 psl	
Flow from Overhead sprinkler	s: 26.1 gpm	Pressure Available	at Source: 5	6.3 psi	
Flow from Inside Hoses:	0 gpm	Surplus Pressure at	Source: 2	2.5 psi	
Flow from Outside Hoses:	0 gpm				
Other fixed flows:	0 gpm				
Total flow in system piping:	26.1 gpm				
Additional flow at/beyond sour	rce: <u>0 gpm</u>				
Total of all flows:	26.1 gpm				

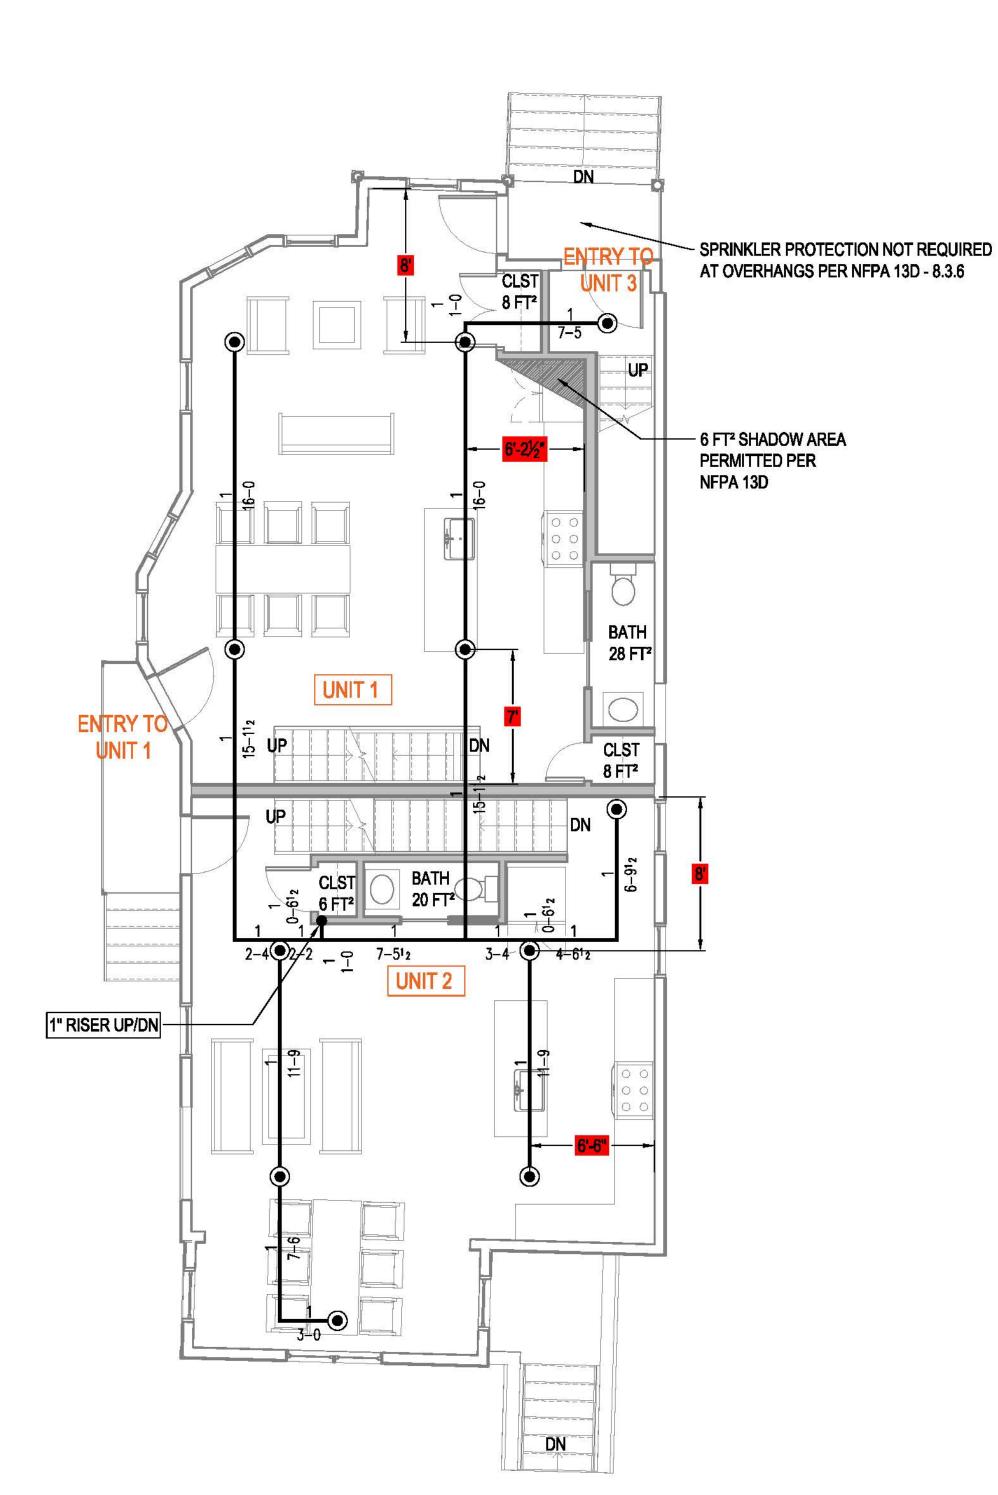

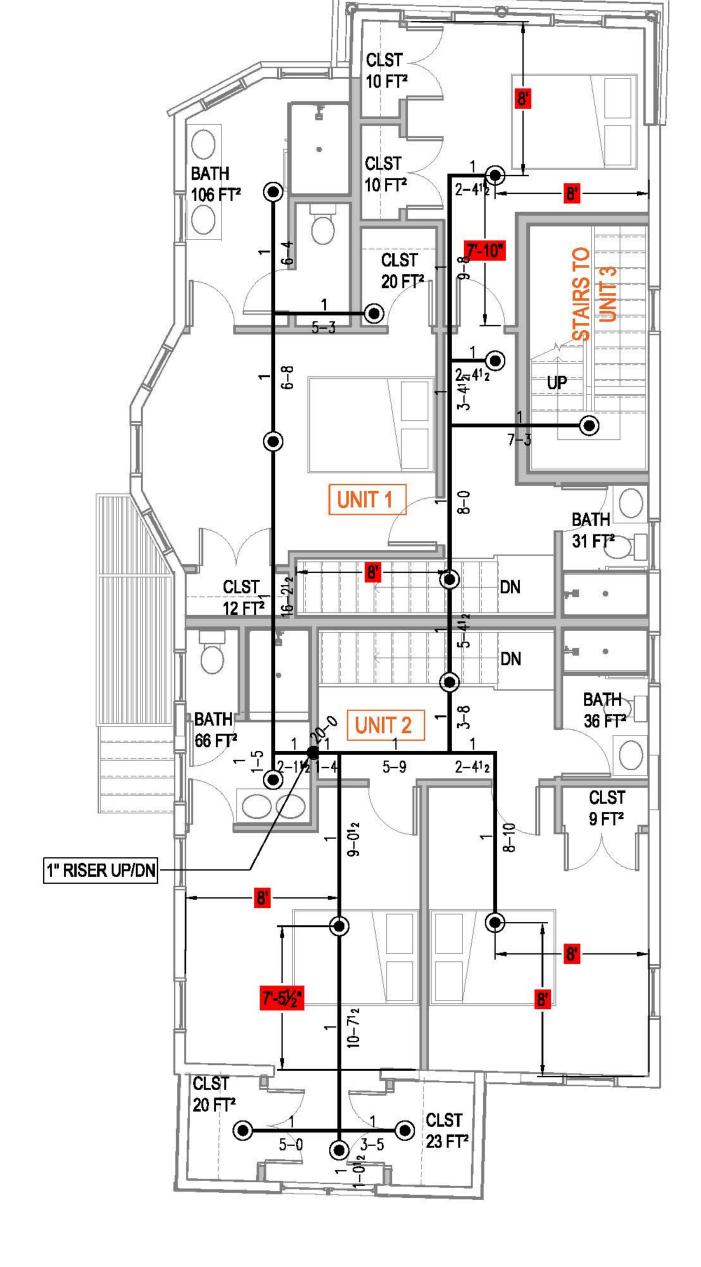

SECOND FLOOR PLAN - 1/4 " = 1'-0" SECOND FLOOR AREA = 1,386 S.F. +/-

THIS AREA HAS BEEN CALCULATED TO PROVIDE A DENSITY OF .05 GPM OVER THE REMOTE 2 SPRINKLERS IN A COMPARTMENT. THE TOTAL DEMAND WILL BE 26.1 GPM AT 33.8 PSI AT THE Demand Calculations using Hazen-Williams Method SOURCE. WITH 2 SPRINKLERS FLOWING, THERE IS A CUSHION OF 22.5 PSI. Design Area Density: Additional Outside Hose: Design Area Size: Notes: 2 Residential Sprinklers Flowing RAILING -DA Name: 1 DA Area: 266.71 CLST CLST 9 FT<sup>2</sup> 9 FT<sup>2</sup> SPRINKLER PIPING TO BE PLACED BENEATH INSUL TO PREVENT PIPE FREEZ - SEE INSULATION DETAI 1" RISER DN CLST 10 FT<sup>2</sup>

THIRD FLOOR PLAN - 1/4 " = 1'-0"

THIRD FLOOR AREA = 1,384 S.F. +/-


Drawing Date: 10-13-20 Drawn By: JC Scale: 1/4" = 1'-0"

02138 ROAD POPLAR 8 POPLAF CAMBRIDGE,

Sheet Title 1ST - 3RD FLR FIRE SPRINKLER FLOOR PLANS

FP-2

FIRST FLOOR PLAN - 1/4 " = 1'-0" FIRST FLOOR AREA = 1,355 S.F. +/-

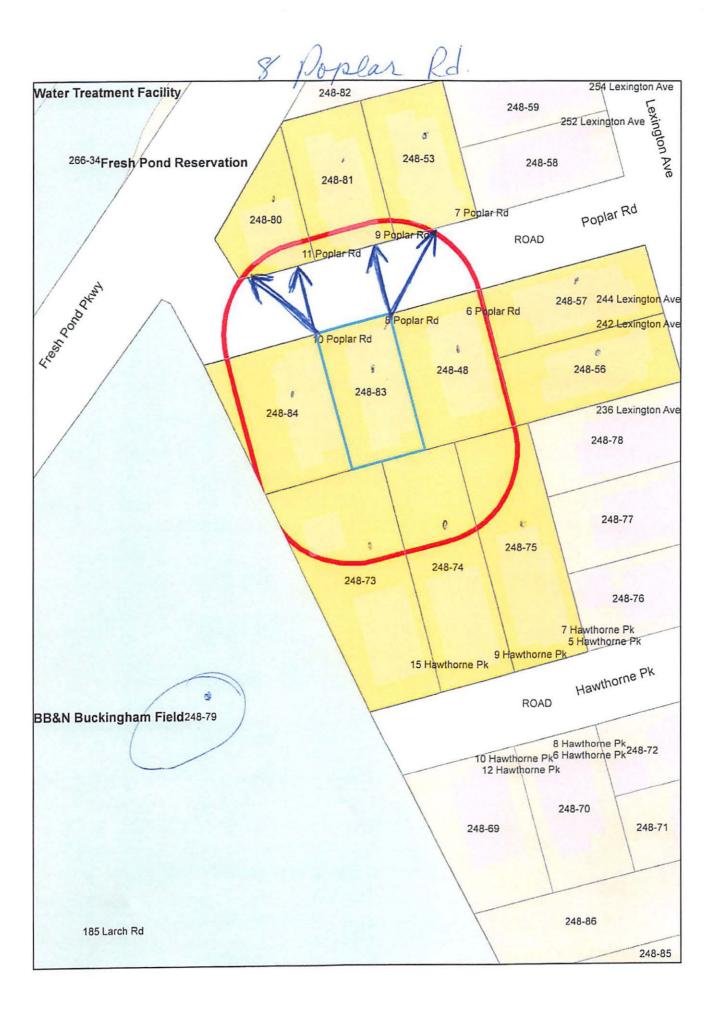

8 Roplas Rd.

248-53 SANDS, GEORGE WALKER JR. & DARLENE P. SANDS 7 POPLAR RD CAMBRIDGE, MA 02138

248-73
DENNEY, EDWARD B. & JENNIFER MILES
15 HAWTHORNE PK
CAMBRIDGE, MA 02138

248-81 PAQUETTE, MARY ELLEN 9 POPLAR RD. UNIT#3 CAMBRIDGE, MA 02138

248-81 BUGBEE, PATRICK J. & ELIZABETH E. UTZ 9 POPLAR RD., UNIT #1 CAMBRIDGE, MA 02138

248-48
SULLIVAN, CATHERINE E.
28 PARTRIDGE ROAD
LEXINGTON, MA 02420-1310

248-81 ARTHUR, JOSEPH F. & MANJUSHA GOKHALE 9 POPLAR ROAD, #2 CAMBRIDGE, MA 02138

248-74 LUDEN, ERIC & JEANNE SYBYLLA SMITH 9-11 HAWTHORNE PK., #2 CAMBRIDGE, MA 02138

248-83 8 POPLAR RD. LLC C/O DND HOMES 1 GARFIELD CIRCLE – UNIT 6 BURLINGTON, MA 01803 248-56 BADIE, NICOLE 242 LEXINGTON AVE., #3 CAMBRIDGE, MA 02138

248-75 RUSSELL, SHEILA T. & EILEEN M. STRUZZIERY, TRUSTEES 5 HAWTHORNE PK CAMBRIDGE, MA 02138

248-57 SMOLENSKI, THOMAS & NISHA SMOLENSKI 218 LEXINGTON AVE CAMBRIDGE, MA 02138

248-84 BACHMAN, RONALD CLAYTON 10 POPLAR RD., #1 CAMBRIDGE, MA 02138

248-57 SMOLENSKI, THOMAS M. & NISHA G. SMOLENSKI 218 LEXINGTON AVE CAMBRIDGE, MA 02138

248-84
BAER, STEPHEN C. & CHRISTINE BAER
10 POPLAR RD., #3
CAMBRIDGE, MA 02138

248-56 MCHUGH, GERARD P. & ANNETTE KLEIN 242 LEXINGTON AVE UNIT 2 CAMBRIDGE, MA 02138 248-80 ROCHOW, JENNIFER J. 13 POPLAR ROAD

CAMBRIDGE, MA 02138-2142

ANDERSON PORTER DESIGN

C/O DANIEL P. ANDERSON

CAMBRIDGE, MA 02139

**875 MAIN STREET** 

248-56 ST. JOHN, KATHLEEN M. 242 LEXINGTON AVE, UNIT#1 CAMBRIDGE, MA 02138

248-84 PERROTTI, JEFFREY 10 POPLAR RD. UNIT#2 CAMBRIDGE, MA 02139

248-79 BUCKINGHAM BROWNE AND NICHOLS SCHOOL 80 GERRYS LANDING ROAD CAMBRIDGE, MA 02138

248-74
JOSLIN, RICHARD S.,
TR. THE RICHARD S. JOSLIN REV LIV TRUST
9-11 HAWTHORNE PK., #1
CAMBRIDGE, MA 02138

248-83 8 POPLAR ROAD LLC 271 LINCOLN ST - STE 10 LEXINGTON, MA 02421