9/30/2020



CITY OF CAMBRIDGE

BOARD OF ZONING APPEAL

831 Massachusetts Avenue, Cambridge MA 02139

2020 OCT -5 PM 3: 22

617-349-6100

OFFICE OF THE CITY CLERK CAMBRIDGE, MASSACHUSETTS

BZA Application Form

BZA Number: 93791	BZA	Num	ber:	93791
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General Information

The undersigned	hereby petitions th	ne Board of Zoning A	appeal for the following:
Special Permit:_	X	Variance: X	Appeal:
PETITIONER: St	even Ng, Patricia	D. Ng and Audrey N	g C/O Christopher J. Alphen, Esq.
PETITIONER'S A	ADDRESS: Blatm	an, Bobrowski & Ha	verty, LLC - 9 Damonmill Sq, Suite 4A4, Concord, MA
LOCATION OF F	PROPERTY: <u>96 AI</u>	<u>pine St , Cambridg</u>	ıe, MA
TYPE OF OCCU	PANCY: Two-Fam	nily Dwelling	ZONING DISTRICT: Residence B Zone
REASON FOR P	ETITION:		
/Additions/			
DESCRIPTION (OF PETITIONER'S	S PROPOSAL:	4
	the state of the s	or apartment and th ming FAR and gros	e raising of the roof by six (6) feet to include a main suite s floor area.
To add/relocate	new windows.		
SECTIONS OF Z	ONING ORDINA	NCE CITED:	
Article: 5.000 Article: 8.000 Article: 8.000 Article: 10.000 Article: 10.000	Section: 8.22.3 (and the second s	ructure).
		Original Signature(s):	(Petitioner (s) / Owner) Christopher J. Alphen, Esq. Attorney for Applicants

Address:

Blatman, Bobrowski & Haverty, LLC 9 Damonmill Square, Ste. 4A4

(Print Name)

Concord, MA 01742



Tel. No.

9783712226

E-Mail Address: chris@bbhlaw.net

Date: 09/30/2020

BZA APPLICATION FORM - OWNERSHIP INFORMATION

To be completed by OWNER, signed before a notary and returned to The Secretary of the Board of Zoning Appeals.

I/We Steven Ng, Patricia D. Ng and Audrey Ng
(OWNER)
Address: 94-96 Alpine Street, Cambridge, MA
State that I/We own the property located at $\underline{}$ 94-96 Alpine Street, Cambridge, MA which is the subject of this zoning application.
The record title of this property is in the name of
Steven Ng, Patricia D. Ng and Audrey Ng
*Pursuant to a deed of duly recorded in the date $12/18/2019$, Middlesex South County Registry of Deeds at Book 73875 , Page 99 ; or
Middlesex Registry District of Land Court, Certificate No
Book Page
SIGNATURE BY LAND OWNER OR AUTHORIZED TRUSTEE, OFFICER OR AGENT* Christopher J. Alphen, Esq. on behalf of the petitioners *Written evidence of Agent's standing to represent petitioner may be requested.
Commonwealth of Massachusetts, County ofMiddlesex
The above-name Christopher J. Alphen personally appeared before me,
this 25th of September, 20 30, and made oath that the above statement is true. All Clafflus Notary
My commission expires 12-12-2025 (Notary S all REBECCA L. FLINKSTROM Notary Public COMMONWEALTH OF MASSACHUSETTS My Commission Expires December 12, 2025 If ownership is not shown in recorded deed, e.g. if by court order, recent
deed, or inheritance, please include documentation.

My Commission Expires
My Commission Expires
December 12, 2025

SUPPORTING STATEMENT FOR A VARIANCE

EACH OF THE FOLLOWING REQUIREMENTS FOR A VARIANCE MUST BE ESTABLISHED AND SET FOR IN COMPLETE DETAIL BY THE APPLICANT IN ACCORDANCE WITH MGL 40A, SECTION 10.

A) A literal enforcement of the provisions of this Ordinance would involve a substantial hardship, financial or otherwise, to the petitioner or appellant for the following reasons:

The Petitioners recently moved to Cambridge from Concord to accommodate their son Thomas who has special needs. The dwelling contains two units. One unit will be independently occupied by Thomas and other by his parents Steven and Patricia Ng. Thomas works in Boston; residing in Cambridge affords him an easier commute. The Petitioners wish to provide a fitting independent livin area for their son. Additionally, their daughter Audrey, who has an ownership interest in the home, plans to reside at the home. With a literal enforcement of the Ordinance, the home's living space cannot be altered to become suitable for the entire family.

The hardship is owing to the following circumstances relating to the soil conditions, shape or topography of such land or structures and especially affecting such land or structures by not affecting generally the zoning district in which it is located for the following reasons:

The hardship is related to the size and shape of the lot and the age and condition of the existing two family structure.

C) DESIRABLE RELIEF MAY BE GRANTED WITHOUT EITHER:

1) Desirable relief may be granted without substantial detriment to the public good for the following reasons:

The excess FAR will not be detrimental to the public good. The proposed alterations and additions to the residential home will meet the characteristics of the neighborhood. The residential home will hav a minimal visual impact on the surrounding neighborhood.

2) Desirable relief may be granted without nullifying or substantially derogating from the intent or purpose of this Ordinance for the following reasons:

The renovations to the dwelling have been aesthetically designed to blend in with the existing neighborhood. The renovations will improve to the neighborhood without substantially derogating from the requirement of the Ordinance.

*If you have any questions as to whether you can establish all of the applicable legal requirements, you should consult with an attorney.

BZA Application Form

SUPPORTING STATEMENT FOR A SPECIAL PERMIT

Please describe in complete detail how you meet each of the following criteria referring to the property as proposed changes or uses which are requested in your application. Attach sheets with additional information for special permits which have additional criteria, e.g.; fast food permits, comprehensive permits, etc., which must be met.

Granting the Special Permit requested for <u>96 Alpine St</u>, <u>Cambridge</u>, <u>MA</u> (location) would not be a detriment to the public interest because:

A) Requirements of the Ordinance can or will be met for the following reasons:

The proposed renovations do not create any additional nonconformities, nor does it increase any existing nonconformities, other than an increase to the FAR (for which the applicant has applied for a variance). The proposed renovations will not be substantially more detrimental to the neighborhood that the existing nonconforming structure or use.

B) Traffic generated or patterns of access or egress would not cause congestion hazard, or substantial change in established neighborhood character for the following reasons:

The proposed alterations will not cause any additional traffic.

The continued operation of or the development of adjacent uses as permitted in the Zoning Ordinance would not be adversely affected by the nature of the proposed use for the following reasons:

The proposed alterations and additions to the residential home will meet the characteristics of the neighborhood. The residential home will have a minimal visual impact on the surrounding neighborhood.

Nuisance or hazard would not be created to the detriment of the health, safety, and/or welfare of the occupant of the proposed use or the citizens of the City for the following reasons:

The proposed alterations will not cause a nuisance or hazards.

For other reasons, the proposed use would not impair the integrity of the district or adjoining district or otherwise derogate from the intent or purpose of this ordinance for the following reasons:

The renovations to the dwelling have been aesthetically designed to blend in with the existing neighborhood. The renovations will improve to the neighborhood without substantially derogating from the requirement of the Ordinance.

^{*}If you have any questions as to whether you can establish all of the applicable legal requirements, you should consult with an attorney.

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BZA Application Form

DIMENSIONAL INFORMATION

Applicant:

Steven Ng, Patricia D. Ng and Audrey Ng

Present Use/Occupancy: Two-Family Dwelling

Blatman, Bobrowski & Haverty, LLC - 9

Residence B Zone Zone:

Location:

Damonmill Sq, Suite 4A4

9783712226 Phone:

Requested Use/Occupancy: Two-Family Dwelling

		Existing Conditions	Requested Conditions	Ordinance Requirements	
TOTAL GROSS FLOOR AREA:		2,265	3,348	1,900	(max.)
LOT AREA: RATIO OF GROSS		3,800	N/A	5,000	(min.)
FLOOR AREA TO LOT AREA: 2 LOT AREA OF		.70	.88	.50	
EACH DWELLING UNIT		3,800	3,800	2,500	
SIZE OF LOT:	WIDTH	40	N/A	50	
	DEPTH	95	N/A	N/A	
SETBACKS IN FEET:	FRONT	16-8	16-8	15	
	REAR	27-2	27-2	25	
	LEFT SIDE	5	5	7-6	
	RIGHT SIDE	10-6	10-6	7-6	
SIZE OF BUILDING:		28-9	34-9	35	
	WIDTH	N/A	N/A	N/A	
RATIO OF USABLE					
OPEN SPACE TO LOT AREA:		.61	.59	.40	
NO. OF DWELLING UNITS:		2	2	2	
NO. OF PARKING SPACES:		1	1	1	
NO. OF LOADING AREAS:		N/A	N/A	N/A	
DISTANCE TO NEAREST BLDG. ON SAME LOT		N/A	N/A	N/A	

Describe where applicable, other occupancies on the same lot, the size of adjacent buildings on same lot, and type of constructio proposed, e.g; wood frame, concrete, brick, steel, etc.

- 1. SEE CAMBRIDGE ZONING ORDINANCE ARTICLE 5.000, SECTION 5.30 (DISTRICT OF DIMENSIONAL REGULATION
- 2. TOTAL GROSS FLOOR AREA (INCLUDING BASEMENT 7'-0" IN HEIGHT AND ATTIC AREAS GREATER THAN 5') **DIVIDED BY LOT AREA.**
- 3. OPEN SPACE SHALL NOT INCLUDE PARKING AREAS, WALKWAYS OR DRIVEWAYS AND SHALL HAVE A MINIMUM **DIMENSION OF 15'.**

BZA Application Form

NG RESIDENCE

STEVE & TRISH NG

94-96 ALPINE ST. CAMBRIDGE, MA 02138





BZA SUBMISSION SET

09/11/2020

ARCHITECT:

SKA

SAM KACHMAR

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ARCHITECTS
(p)978-270-8441
kachmardesign.com
357 HURON AVE.
CAMBRIDGE MA, 02138

CLIENTS:

GENERAL CONTRACTOR:

STRUCTURAL ENGINEER:


STEVE & TRISH NG

THE NG RESIDENCE LOCATED AT 94-96
ALPINE ST WILL INCLUDE THE
RENOVATION OF THE FRONT AND REAR
PORCH, THE RENOVATION OF THE 2ND
FLOOR APARTMENT AND THE RAISING
OF THE ROOF BY 6 FT TO INCLUDE A
MAIN SUITE AND OFFICE.


Permit Sheet List				
Sheet Number	Sheet Name	Designed By		
-				
P-000	COVER	Designer		
P-001	GENERAL NOTES	Designer		
P-002	PLOT PLAN & AREA PLAN	Designer		
P-003	LANDSCAPE PLAN	SKA		
P-100	PROPOSED LEVEL 0	Designer		
P-101	PROPOSED LEVEL 1	Designer		
P-102	PROPOSED LEVEL 2	Designer		
P-103	PROPOSED LEVEL 3	Designer		
P-110	PROPOSED ROOF PLAN	Designer		
P-200	ELEVATION WEST	Designer		
P-201	ELEVATION NORTH	Designer		
P-202	ELEVATION EAST	Designer		
P-203	ELEVATION SOUTH	Designer		

#	NUMBER OR POUND
&,+	AND
@	AT
ADJ	ADJUSTABLE
AFF	ABOVE FINISH FLOOR
ALUM	ALUMINUM
APPROX	APPROXIMATELY
ARCH	ARCHITECTURAL
AVB	AIR AND VAPOR BARRIER
BD	BOARD
BIT	BITUMINOUS
BLDG	BUILDING
BSMT	BASEMENT
BTWN	BETWEEN
CF	CUBIC FEET
CI	CUBIC INCHES
CJ	CONTROL JOINT
CL	CENTERLINE
CLG	CEILING
CLR	CLEAR OR CLEARANCE
CMU	CONCRETE MASONRY UNIT
COL	COLUMN
CONC	CONCRETE
CONT	CONTINUOUS
CORR	CORRIDOR, CORRUGATED
CTR	CENTER
D	DEPTH, DEEP
DBL	DOUBLE
DEMO	DEMOLISH, DEMOLITION
DIA	DIAMETER
DIM	DIMENSION
DN	DOWN
DTL	DETAIL
DW	DISHWASHER
E	EAST
EA	EACH
EJ	EXPANSION JOINT
EL	ELEVATION (GRADE)
ELEC	ELECTRICAL
ELEV	ELEVATION (FACADE)
EOS	EDGE OF SLAB
EQ	EQUAL, EQUIPMENT, EQUIP
ETR	EXISTING TO REMAIN
EXG	EXISTING
EXP	EXPOSED
EXT	EXTERIOR
FAB	FABRICATE, FABRICATION
FD	FLOOR DRAIN
FF	FINISHED FLOOR
FL	
	FLOOR
FOW	FACE OF WALL
FT	FEET, FOOT
GA	GAUGE
GALV	GALVANIZED
GL	GLASS, GLAZING, GLAZED
GWB	GYPSUM WALLBOARD, BACKING BOARD
GYP	GYPSUM
H	HIGH
HDWD	HARDWOOD
HM	HOLLOW METAL
HORIZ	HORIZONTAL
HVAC	HEATING, VENTILATING & AIR CONDITIONING
IN	INCH, INCHES
IIN	
	INCLUDE, INCLUDED
INCL	INCLUDE, INCLUDED
	INCLUDE, INCLUDED INTERIOR JOINT


L	LENCTH	
LAM	LENGTH LAMINATE, LAMINATED	
LAIVI	POUND	I Ľ ,
LGMF	LIGHT GAGE METAL FRAMING	
LT	LIGHT GAGE METAL FRAMING	4
LT WT	LIGHT WEIGHT	
MAX	MAXIMUM	
MDF	MEDIUM DENSITY FIBER	4Δ , .
MECH	MECHANICAL MECHANICAL	
MED	MEDIUM	
MFR	MANUFACTURER	
MIN	MINIMUM	Xol
MISC	MISCELLANEOUS	
MTD	MOUNTED	
MTL	METAL	-2-2-2
N	NORTH	27, 7, 4
N/A	NOT APPLICABLE	
NIC	NOT IN CONTRACT	
NOM	NOMINAL	71.77 27.1 71.71 27.1
NTS	NOT TO SCALE	77.4
OC	ON CENTER	7
OD	OUTSIDE DIAMETER	
OH	OPPOSITE HAND	
OPP	OPPOSITE HAND	
OSB	ORIENTED STRANDBOARD	▎┕
OVHD	OVERHEAD	
OZ	OUNCE (S)	
PATT	PATTERN (ED)	
PERF	PERFORATED	
PERP	PERPENDICULAR BLACTIC LAMBIATE	l
PLAM	PLASTIC LAMINATE	
PLYWD	PLYWOOD	
PNT	PAINT, PAINTED	
PR	PAIR	
PREFAB	PREFABRICATE, PREFABRICATED	
QTY	QUANTITY	
RAD	RADIUS	
RBR	RUBBER	
RD	ROOF DRAIN	
REF	REFERENCE	
REFR	REFRIGERATE, REFRIGERATOR	-
REINF	REINFORCE, REINFORCED	
REQ	REQUIRE	┌─
REV	REVISION, REVISE, REVISED	
RM	ROOM	
RO S	ROUGH OPENING	
	SOUTH	l
SCHED	SCHEDULE	
SF	SQUARE FEET	
SI	SQUARE INCHES	
SIM	SIMILAR	
SPEC	SPECIFICATION	$\mathbf{L} \wedge \mathbf{L}$
SQ	SQUARE	
SS, SST	STAINLESS STEEL	
STC	SOUND TRANSMISSION CLASS	
STL	STEEL	
STOR	STORAGE	
STR	STAIR	
T.O.	TOP OF	
U.O.	UNDERSIDE OF	
UON	UNLESS OTHERWISE NOTED	
WD	WOOD	
WT	WEIGHT	
X	INDICATES TIMES OR BY	777

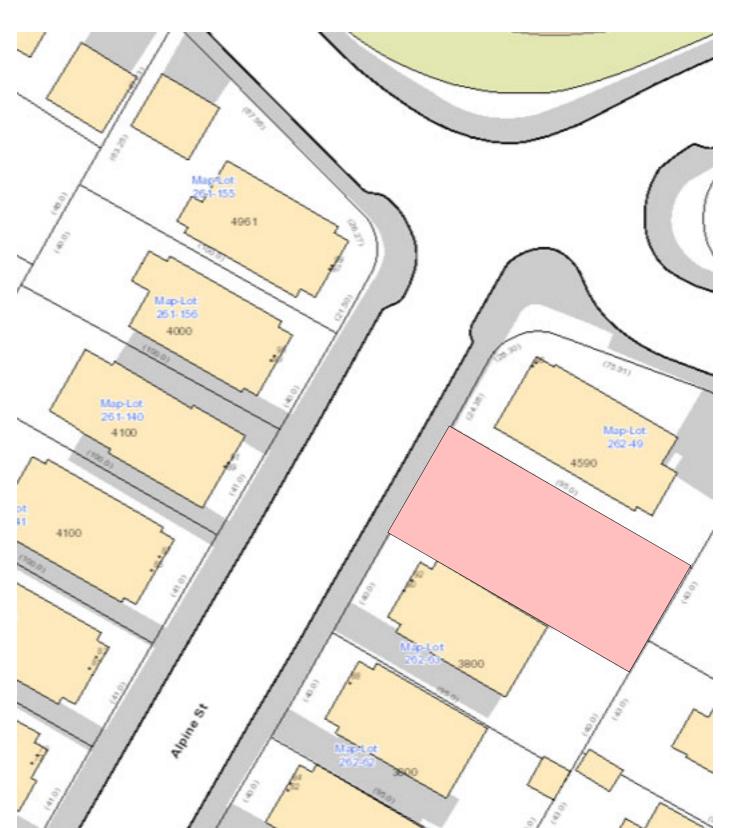


5 P-SITE PLAN 1 1/2" = 1'-0"

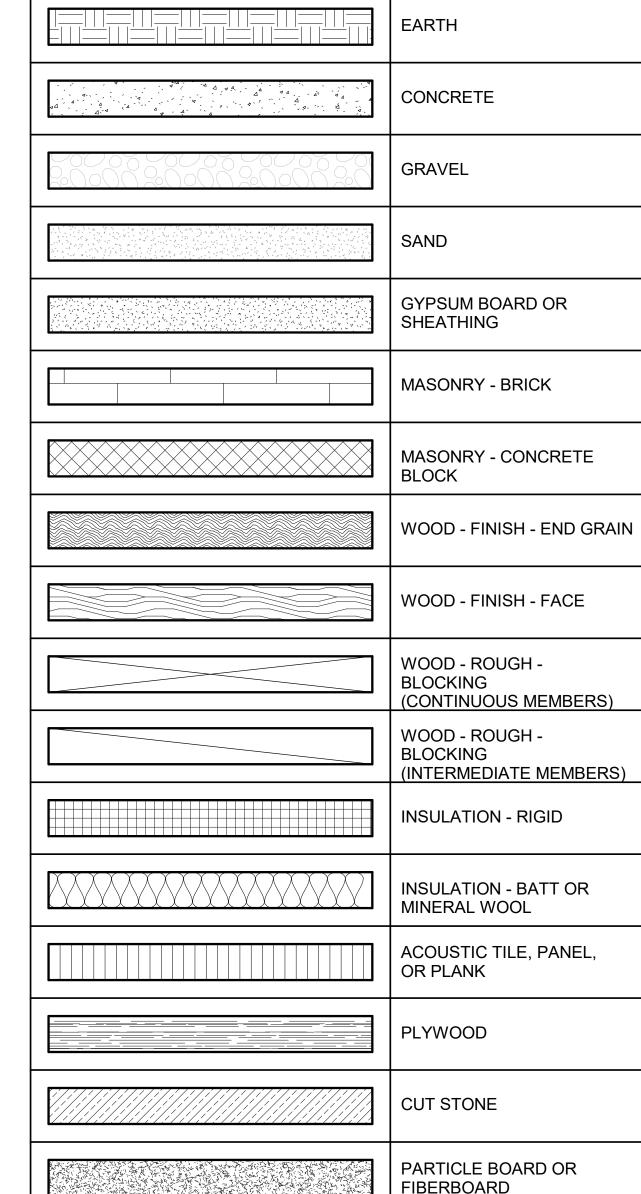

P-MATERIALS ¹ 1 1/2" = 1'-0"

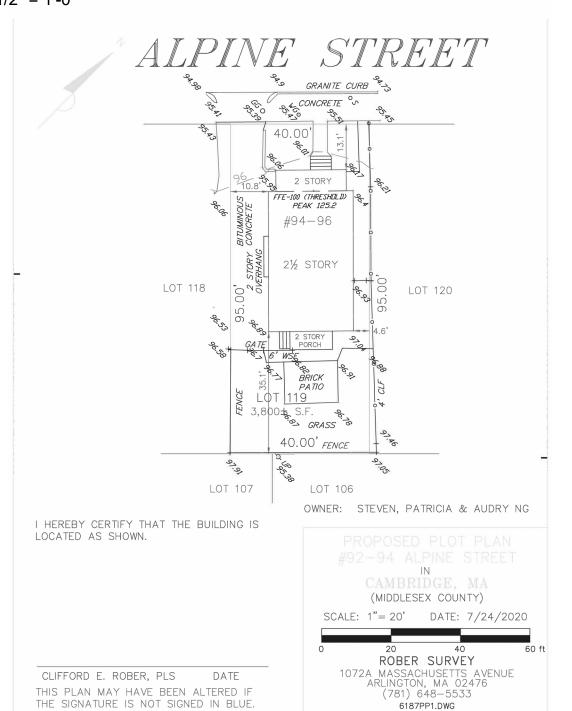

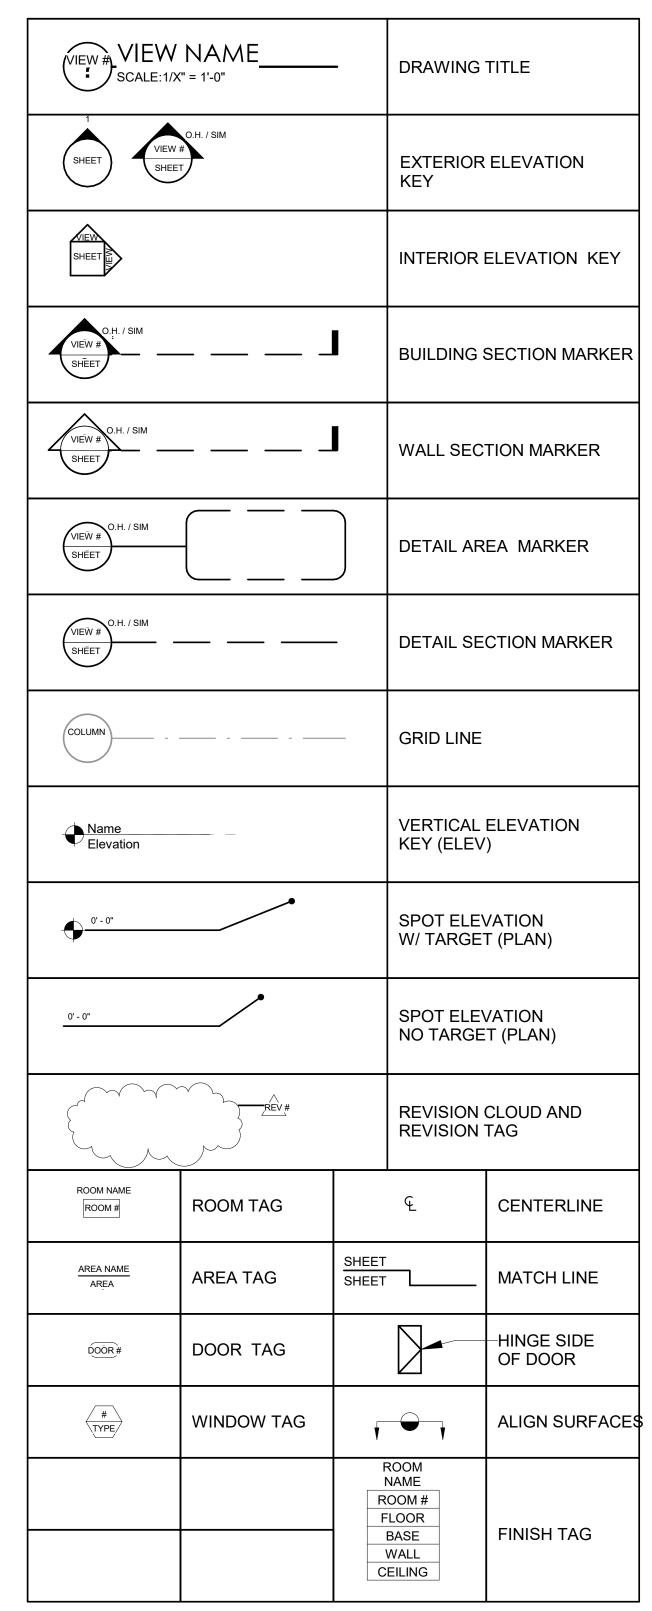

3 P-SYMBOLS 1 1/2" = 1'-0"

ALL WORK SHALL BE CONSIDERED NEW, UNLESS OTHERWISE
INDICATED.
DO NOT SCALE DRAWINGS
VERIFY DIMENSIONS, GRADES, BOUNDARIES, AND CONSTRUCTION
AND IMMEDIATELY REPORT ANY DISCREPANCIES BEFORE
PROCEEDING WITH THE WORK.

4. TO THE EXTENT PRACTICABLE, VERIFY DIMENSIONS AND FIELD CONDITIONS AT THE SITE PRIOR TO THE BID SUBMISSION. CONFLICTS, OMISSIONS AND DISCREPANCIES WITHIN THE CONTRACT DOCUMENTS SHALL BE REPORTED IN WRITING TO THE ARCHITECT, IN ACCORDANCE WITH THE CONTRACT DOCUMENTS, PRIOR TO THE BID SUBMISSION. THE CONTRACTOR WARRANTS, BY TENDERING HIS BID, THAT THE WORK IS BUILDABLE AS SHOWN.

5. LAYOUT ALL WORK WITHIN THE CONFINES OF EXISTING CONSTRUCTION AND RESOLVE DISCREPANCIES PRIOR TO INITIATION OF NEW WORK.

6. ARCHITECT IS NOT RESPONSIBLE FOR CONSTRUCTION THAT IS STARTED PRIOR TO PERMIT BEING ISSUED.

7. DIMENSIONS, NOTES, FINISHES AND FIXTURES SHOWN ON TYPICAL FLOOR PLANS, SECTION OR DETAILS SHALL APPLY TO SIMILAR, SYMMETRICAL OR OPPOSITE HAND PLANS SECTIONS OR DETAILS, UNLESS NOTED OTHERWISE.

8. TYPICAL OR "TYP" SHALL MEAN THAT THE CONDITION IS REPRESENTATIVE FOR SIMILAR CONDITIONS THROUGHOUT, UNLESS NOTED OTHERWISE. DETAILS ARE USUALLY KEYED AND NOTED "TYP" ONLY ONE TIME, WHEN THEY FIRST OCCUR.

9. IMMEDIATELY NOTIFY THE ARCHITECT IN WRITING OF ANY DISCREPANCIES BETWEEN PROJECT MANUAL, LARGE SCALE DRAWINGS, SMALL SCALE DRAWINGS AND DETAILS. THE CONTRACTOR SHALL NOT PROCEED WITH AFFECTED WORK UNTIL ARCHITECT PROVIDES CLARIFICATION.

10. PARTITIONS ARE DIMENSIONED FROM FINISHED FACE TO FINISHED FACE UNLESS OTHERWISE NOTED. DIMENSIONS TO MASONRY ARE TO ACTUAL FINISHED FACE, UNLESS OTHERWISE NOTED.

11. VERIFY THAT DRAWINGS ARE THE LATEST ISSUE PRIOR TO COMMENCING CONSTRUCTION. THE GENERAL CONTRACTOR SHALL BE RESPONSIBLE FOR COMMUNICATING AND DISTRIBUTING ALL CONSTRUCTION DOCUMENT UPDATES TO ALL TRADES.

12. WORK SHALL CONFORM TO THE REQUIREMENTS OF APPLICABLE STATE, FEDERAL AND CITY/COUNTY CODES. STATE AND FEDERAL CODES ARE TO TAKE PRECEDENCE OVER THE DRAWINGS AND SPECIFICATIONS. IF ANY DISCREPANCY IS NOTED, IMMEDIATELY INFORM THE ARCHITECT, PRIOR TO PROCEEDING WITH THE WORK.

13. FILE, OBTAIN AND PAY FEES FOR BUILDING DEPARTMENT PERMITS, CONTROLLED INSPECTIONS, OTHER AGENCY APPROVALS AND PERMITS WHERE REQUIRED, AND FINAL WRITE-OFFS FOR PROJECT COMPLETION. COPIES OF TRANSACTIONS SHALL BE FORWARDED TO THE OWNER OR OWNER'S REPRESENTATIVE.

14. EXECUTE INSPECTIONS NECESSARY TO OBTAIN A CERTIFICATE OF OCCUPANCY.

15. WORK AREA SHALL BE MAINTAINED, CLEAN AND FREE OF DEBRIS AT ALL TIMES.

16. PATCH ALL SURFACES TO MATCH ADJACENT IN A MANNER SUITABLE TO RECEIVE FINISHES.

17. PATCH, REPAIR AND FINISH ALL SURFACES IN AREAS OUTSIDE OF THE EXISTING SCOPE THAT ARE DISTURBED AS A RESULT OF THE WORK.

18. COORDINATE AND PROVIDE BLOCKING AND STRAPPING WITHIN PARTITIONS FOR MILLWORK AND OTHER WALL ATTACHED ITEMS.

19. APPLY, INSTALL, CONNECT, CLEAN AND/OR CONDITION MANUFACTURED ARTICLES, MATERIALS AND/OR EQUIPMENT PER MANUFACTURER'S INSTRUCTIONS. IN CASE OF CONFLICT BETWEEN MANUFACTURER'S INSTRUCTIONS AND THE CONTRACT DOCUMENTS. THE CONTRACTOR SHALL OBTAIN WRITTEN CLARIFICATION FROM THE ARCHITECT BEFORE PROCEEDING.

20. GLASS 18" OR LESS FROM FLOOR LINE OR ADJACENT TO A DOOR SWING SHALL BE SAFETY GLASS AS REQUIRED BY APPLICABLE CODE(S). THE CONTRACTOR SHALL BE RESPONSIBLE FOR PROVIDING ." SAFETY GLASS, UNLESS OTHERWISE NOTED, TO COMPLY WITH BUILDING AND LIFE SAFETY CODES, INDUSTRY STANDARDS AND OTHER APPLICABLE FEDERAL AND STATE CODES

21. FLASHING AT EXTERIOR WALLS SHALL BE INSTALLED WITH SEALED JOINTS, SEALED PENETRATIONS AND ENDS TURNED UP. IT SHALL BE FABRICATED AND INSTALLED TO ENSURE THAT MOISTURE IN WALLS WILL BE DIRECTED TO WICKS AND WEEP HOLES.

22. COORDINATE ALL DIMENSIONS CONCERNING DOORS/PANELS/WINDOWS, STAIRS AND THEIR OPENINGS WITH PRODUCT MANUFACTURERS PRIOR TO FABRICATION AND CONSTRUCTION.

23. PROVIDE WEATHERSTRIP AT EXTERIOR DOORS

24. PROVIDE FLASHING AND/OR SEALANT AT OPENINGS IN ROOF OR WALLS TO ENSURE A WEATHERTIGHT BUILDING.

25. LOCATE THERMOSTATS ADJACENT TO SWITCH PLATES WHERE POSSIBLE. VERIFY LOCATION WITH THE ARCHITECT PRIOR TO INSTALLATION TO AVOID CONFLICTS WITH BUILT-INS OR SYSTEMS FURNITURE OR DESIGN ELEMENTS.

26. ALIGN OUTLETS, WALL SWITCHES, TEL-DATA JACKS, ETC., INDICATED TO BE MOUNTED AT NEAR EQUIVALENT ELEVATIONS.

27. ALL DOORS SHALL BE LOCATED 6" OFF THE ADJACENT PARTITION, OR ONE MASONRY COURSE AT CMU PARTITIONS, UNLESS NOTED OTHERWISE

28. DURING DEMOLITION AND CONSTRUCTION PROTECT ALL EXISTING FINISHES TO REMAIN.

29. ALL WOOD SHALL BE FSC CERTIFIED.

30. ALL WOOD FRAMING SIZES ARE BASED ON SPF-SS

31. ALL WOOD IN CONTACT WITH CONCRETE OR MASONRY SHALL BE PRESSURE TREATED (P.T.).

32. CORRECT ALL DEFECTS FOUND IN EXISTING BUILDING WHICH INTERFERE WITH NEW CONSTRUCTION. THIS INCLUDES BUT IS NOT LIMITED TO UNEVEN SURFACES AND FINISHES AT GWB.

1 P-GENERAL NOTES 1 1/2" = 1'-0"



ARCHITECTS (P) 978-270-8441 kachmardesign.com 357 Huron Ave. CAMBRIDGE MA, 02138

REGISTRATIONS:

STRUCTURAL ENGINEER:

Ш

ST. RESIDENC S ALPINE BRIDGE % | | | | |

TRISH

38


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BZA SUBMISSION SET Project Number Project number

Date 09/11/2020 Drawn by Author Checker Checked by

Scale 1 1/2" = 1'-0"

P-PROPERTY BOUNDARY ^{[/} 1 1/2" = 1'-0"

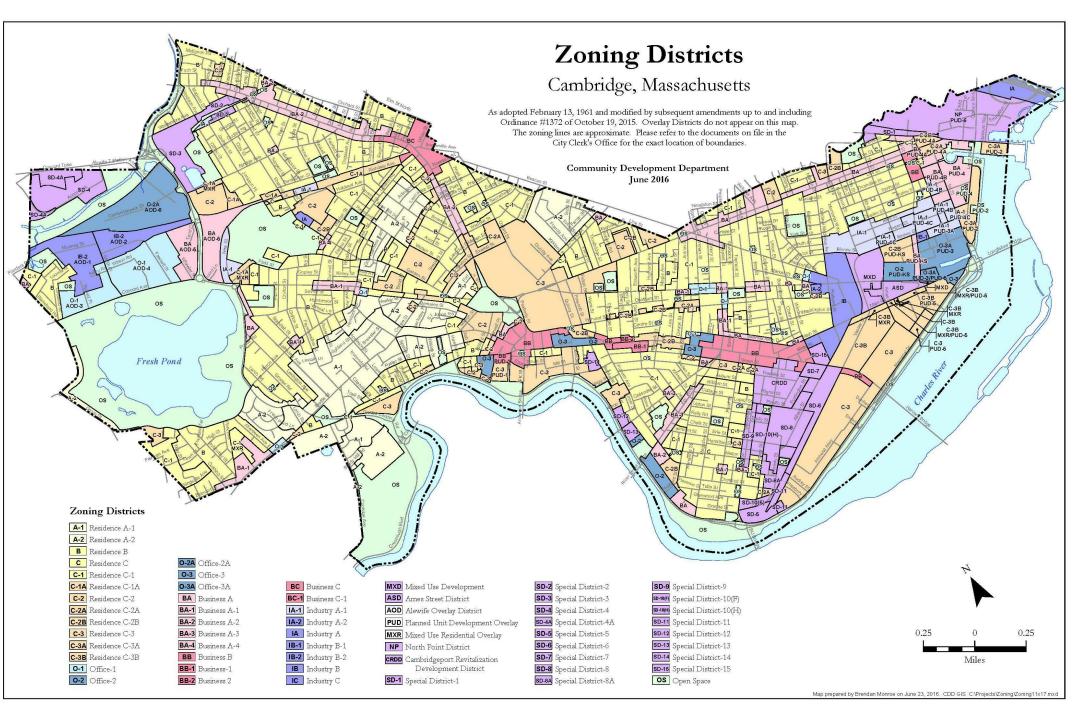

<u>DECK</u> 141 SF

P-PROPOSED LEVEL 3

Proposed FAR

DECK

FINISHED

Existing FAR

ATTIC

9 P-EXISTING LEVEL 3 1/16" = 1'-0"

	EXIS	STING FAR		
Level	Area	Comments	Count	Name
EXISTING LEVEL 1	982 SF		1	FINISHED
EXISTING LEVEL 1	118 SF		1	FRONT PORCH
EXISTING LEVEL 1	64 SF		1	BACK DECK
EXISTING LEVEL 2	958 SF		1	FINISHED
EXISTING LEVEL 2	63 SF		1	DECK
EXISTING LEVEL 2	118 SF		1	PORCH
	'			
PROPOSED LEVEL 3	362 SF		1	ATTIC
	2665 SF		•	•

	Pı	roposed FAR		
Level	Area	Comments	Count	Name
EXISTING LEVEL 1	69 SF		1	PORCH
EXISTING LEVEL 1	1000 SF		1	FINISHED
EXISTING LEVEL 1	84 SF		1	DECK
EXISTING LEVEL 1	55 SF		1	STAIRWELL
	-			
EXISTING LEVEL 2	1073 SF		1	FINISHED
EXISTING LEVEL 2	79 SF		1	DECK
	-			
PROPOSED LEVEL 3	987 SF		1	FINISHED
	3348 SF	'		

ZONE: RESIDENCE B SINGLE- & TWO-FAMILY DETACHED DWELLING TOWNHOUSE DWELLINGS

MAXIMUM FAR: 0.50

FRONT YARD SETBACK: 15' SIDE YARD SETBACK: 7.5' REAR YARD SETBACK: 25'

35' MAXIMUM BUILDING HEIGHT

LOT SIZE: 3,800 SQ. FT.

EXISTING FAR = .70

PROPOSED FAR = .88

PROPOSED FAR INCREASE = .18

EXISTING OPEN SPACE: MINIMUM 40% REQUIREMENT

EXISTING OPEN SPACE: .61

NEW OPEN SPACE: .59

EXISTING RIDGE HEIGHT= 28 - 9"

NEW RIDGE HEIGHT = 34' - 9"

INCREASE ROOF HEIGHT= 6' - 0"

SAM KACHMAR © 2020 SAM KACHMAR ARCHITECTS

(P) 978-270-8441 kachmardesign.com 357 Huron Ave. CAMBRIDGE MA, 02138

REGISTRATIONS:

STRUCTURAL ENGINEER:

02138 94-96 ALPINE ST. CAMBRIDGE, MA NG RESIDENCE


BZA SUBMISSION SET Project Number Project number


09/11/2020 Author Checker


As indicated

TRISH NG Date Drawn by Checked by



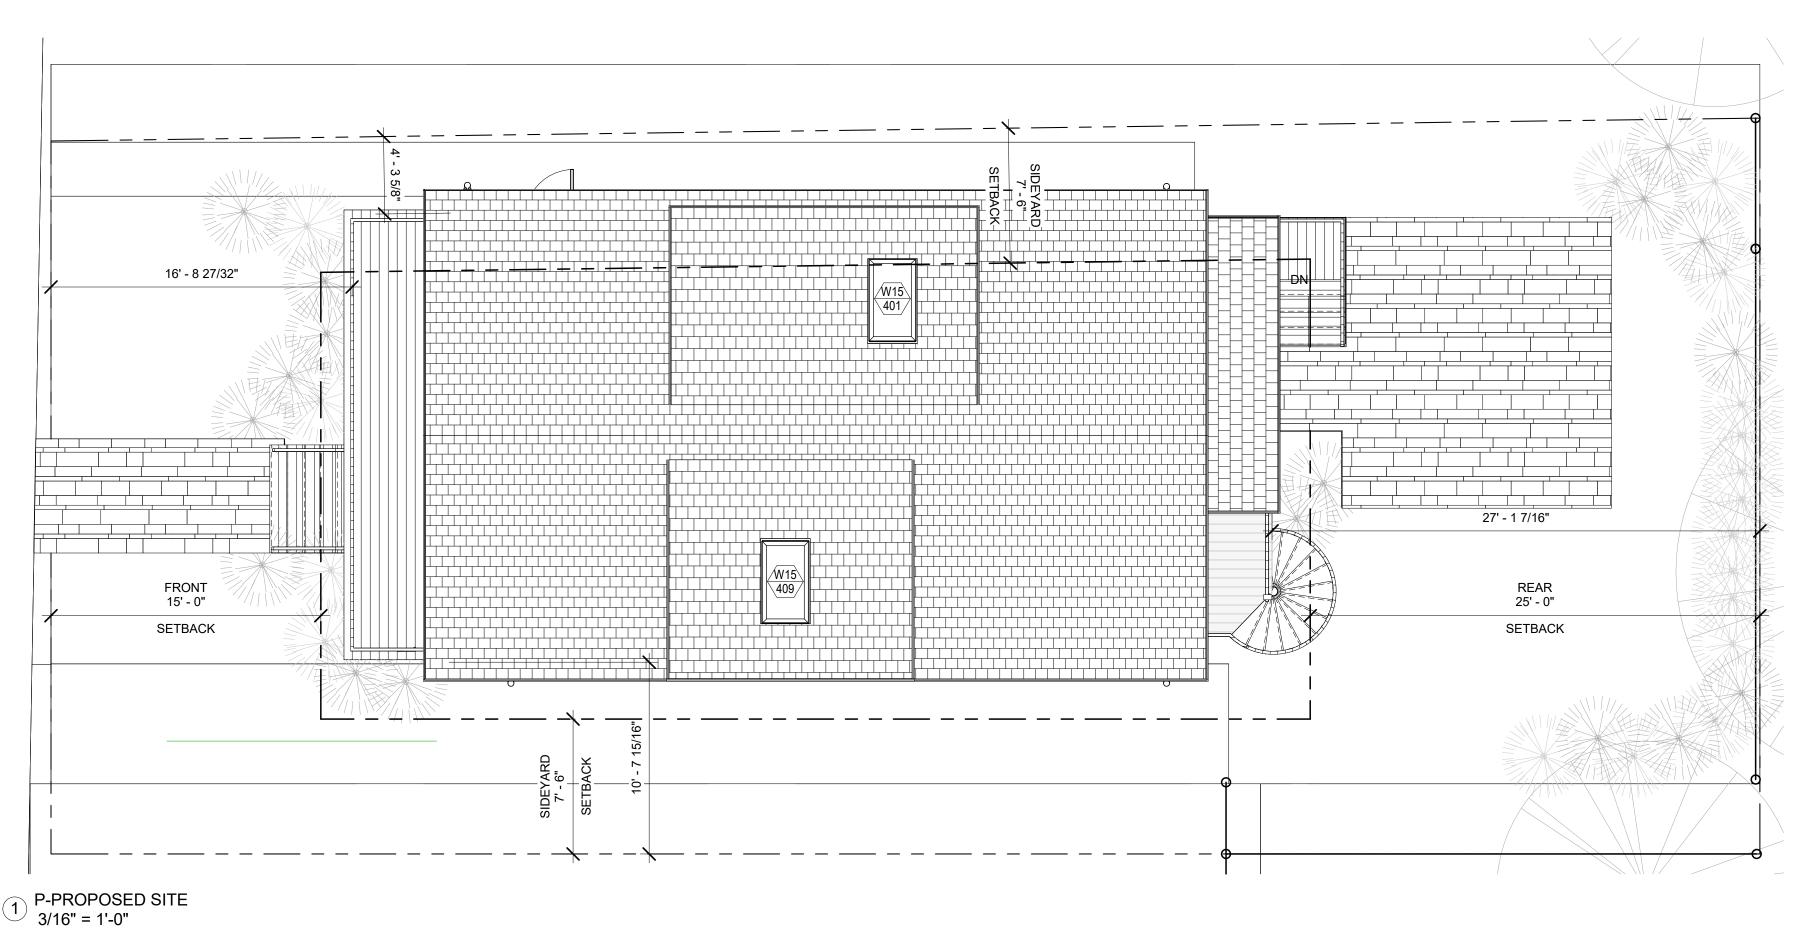

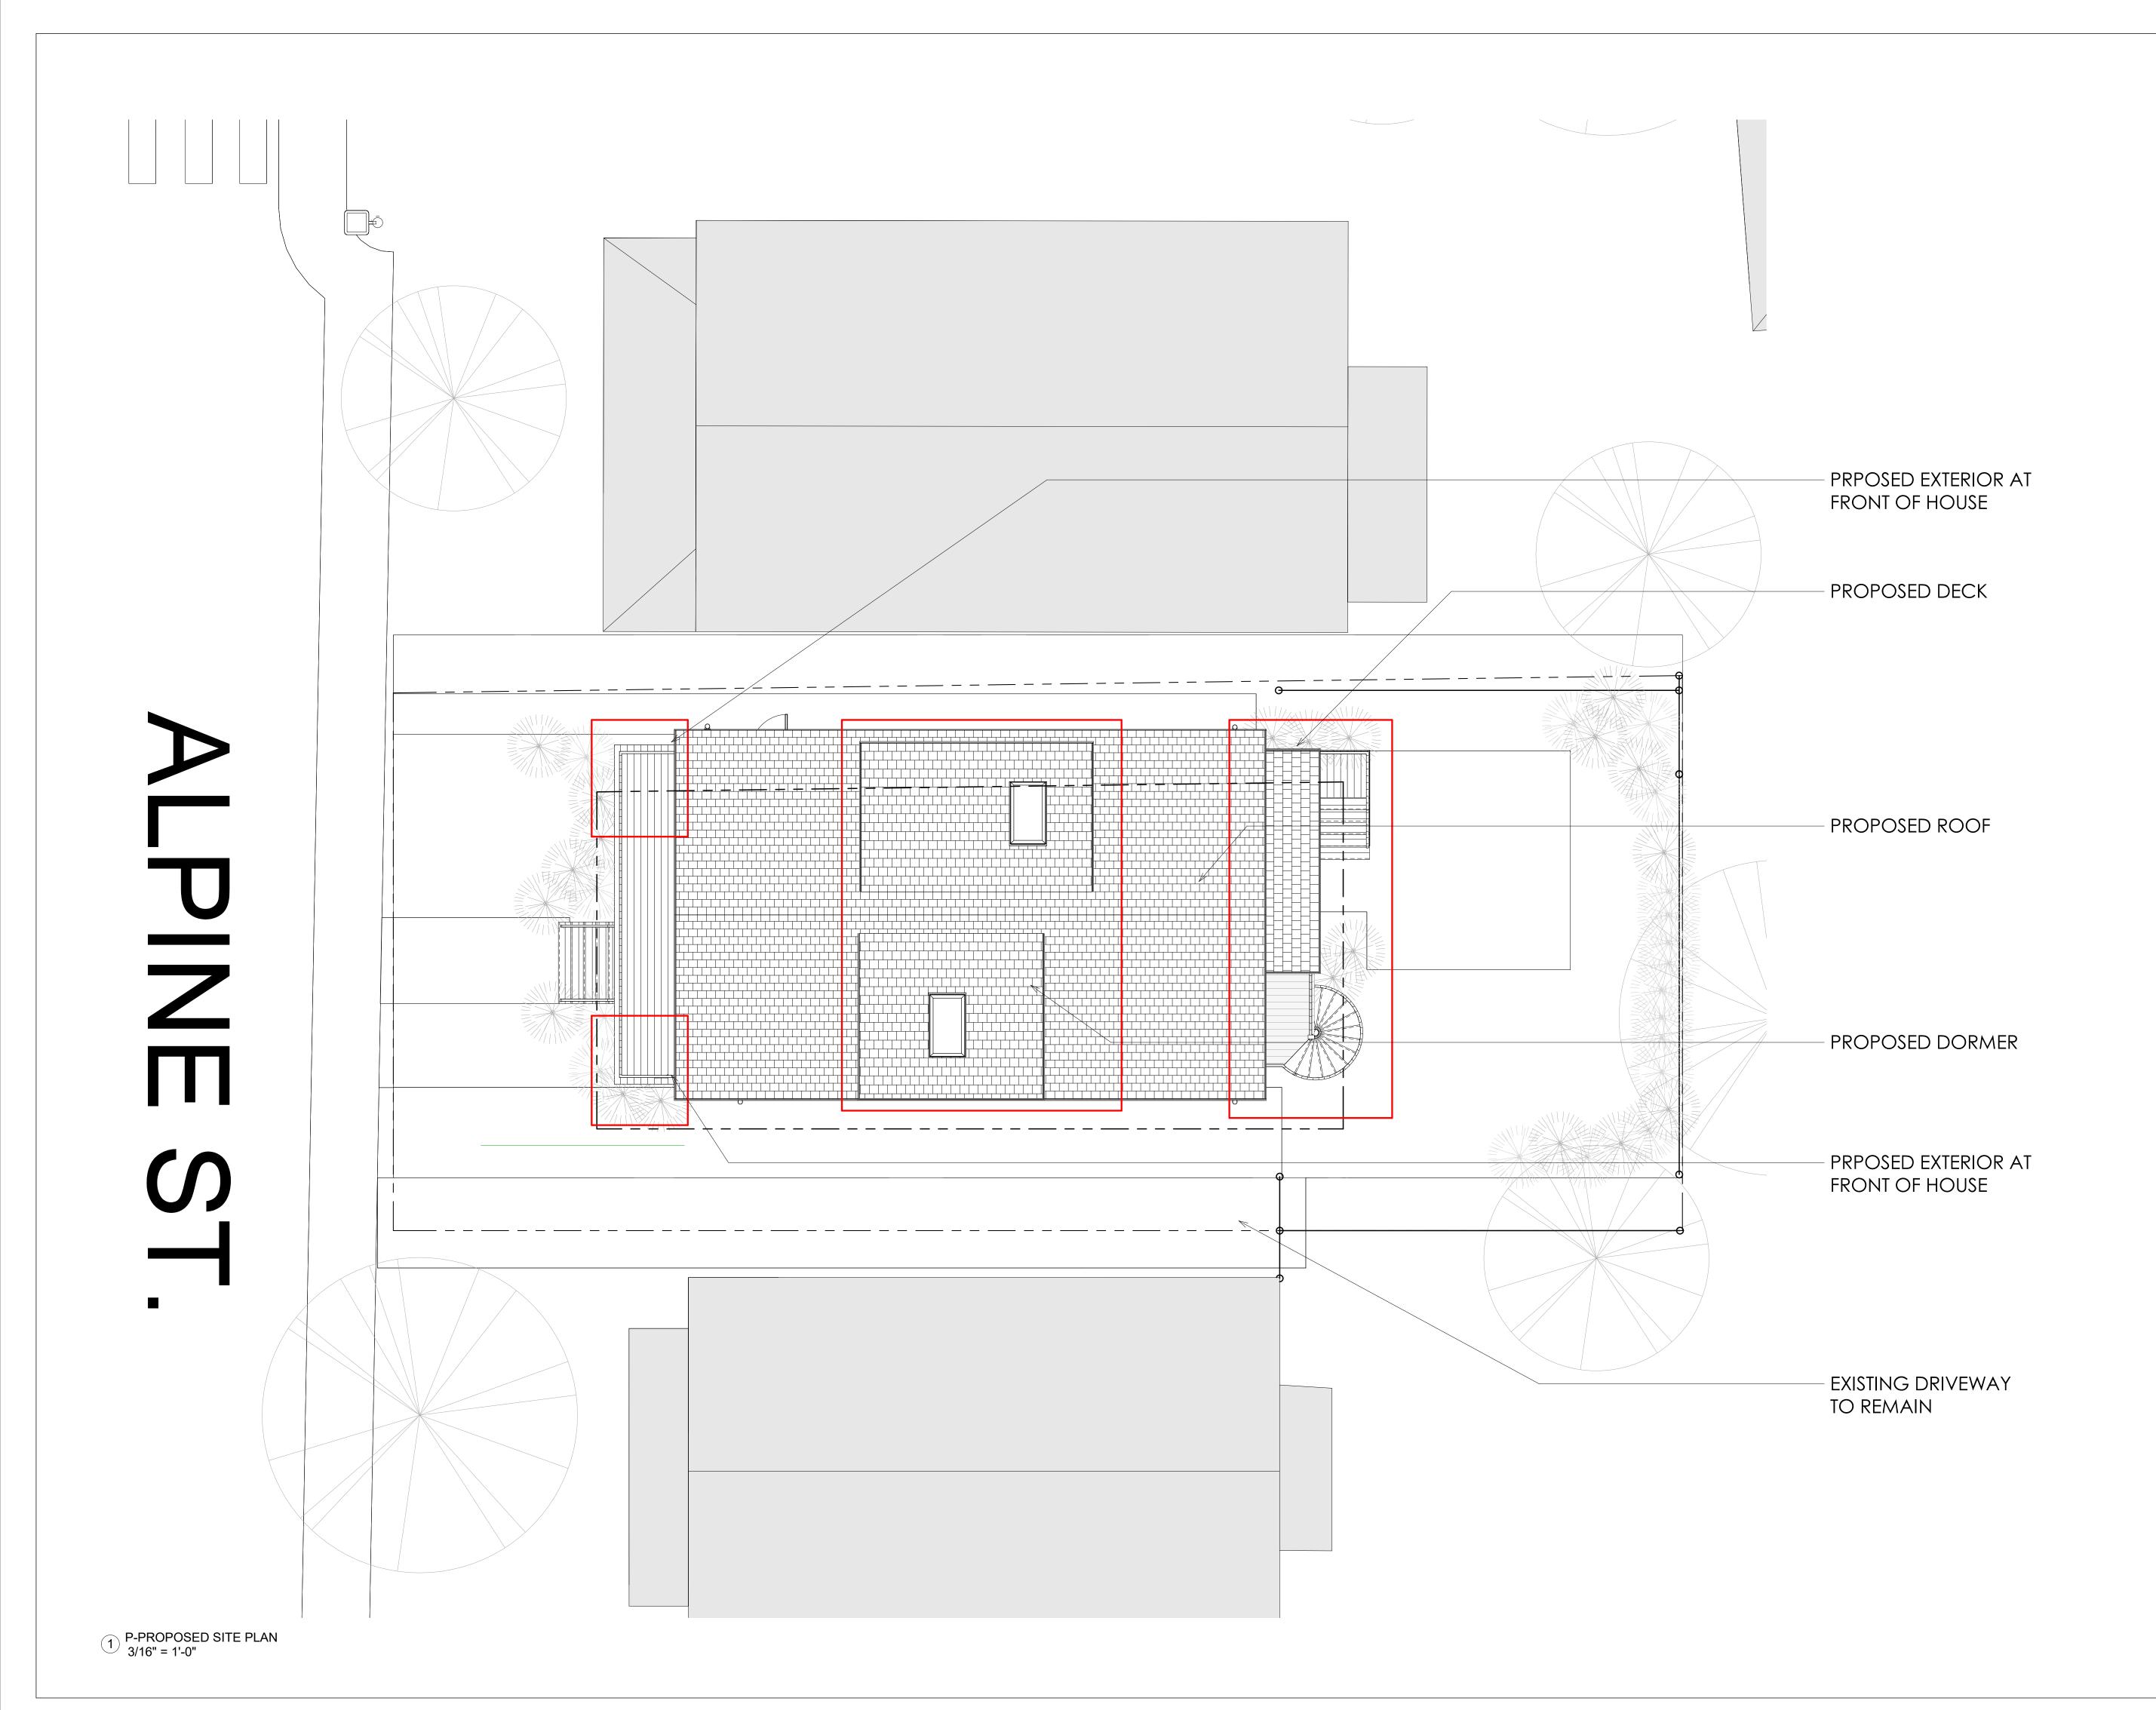

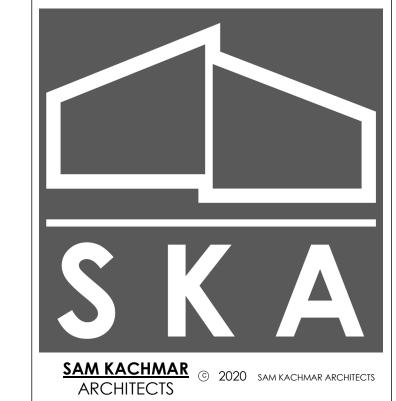

RCHITECTS

(P) 978-270-8441

kachmardesign.com

357 Huron Ave.

CAMBRIDGE MA, 02138

REGISTRATIONS:

STRUCTURAL ENGINEER:

LANDSCAPE PLAN

& TRISH NG

NG RESIDENCE 94-96 ALPINE ST. CAMBRIDGE, MA 02138

Project Status BZA SUBMISSION SET

Project number Project Number


Date 09/11/2020


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Checked by Checker

P-003

Scale 3/16" = 1'-0"



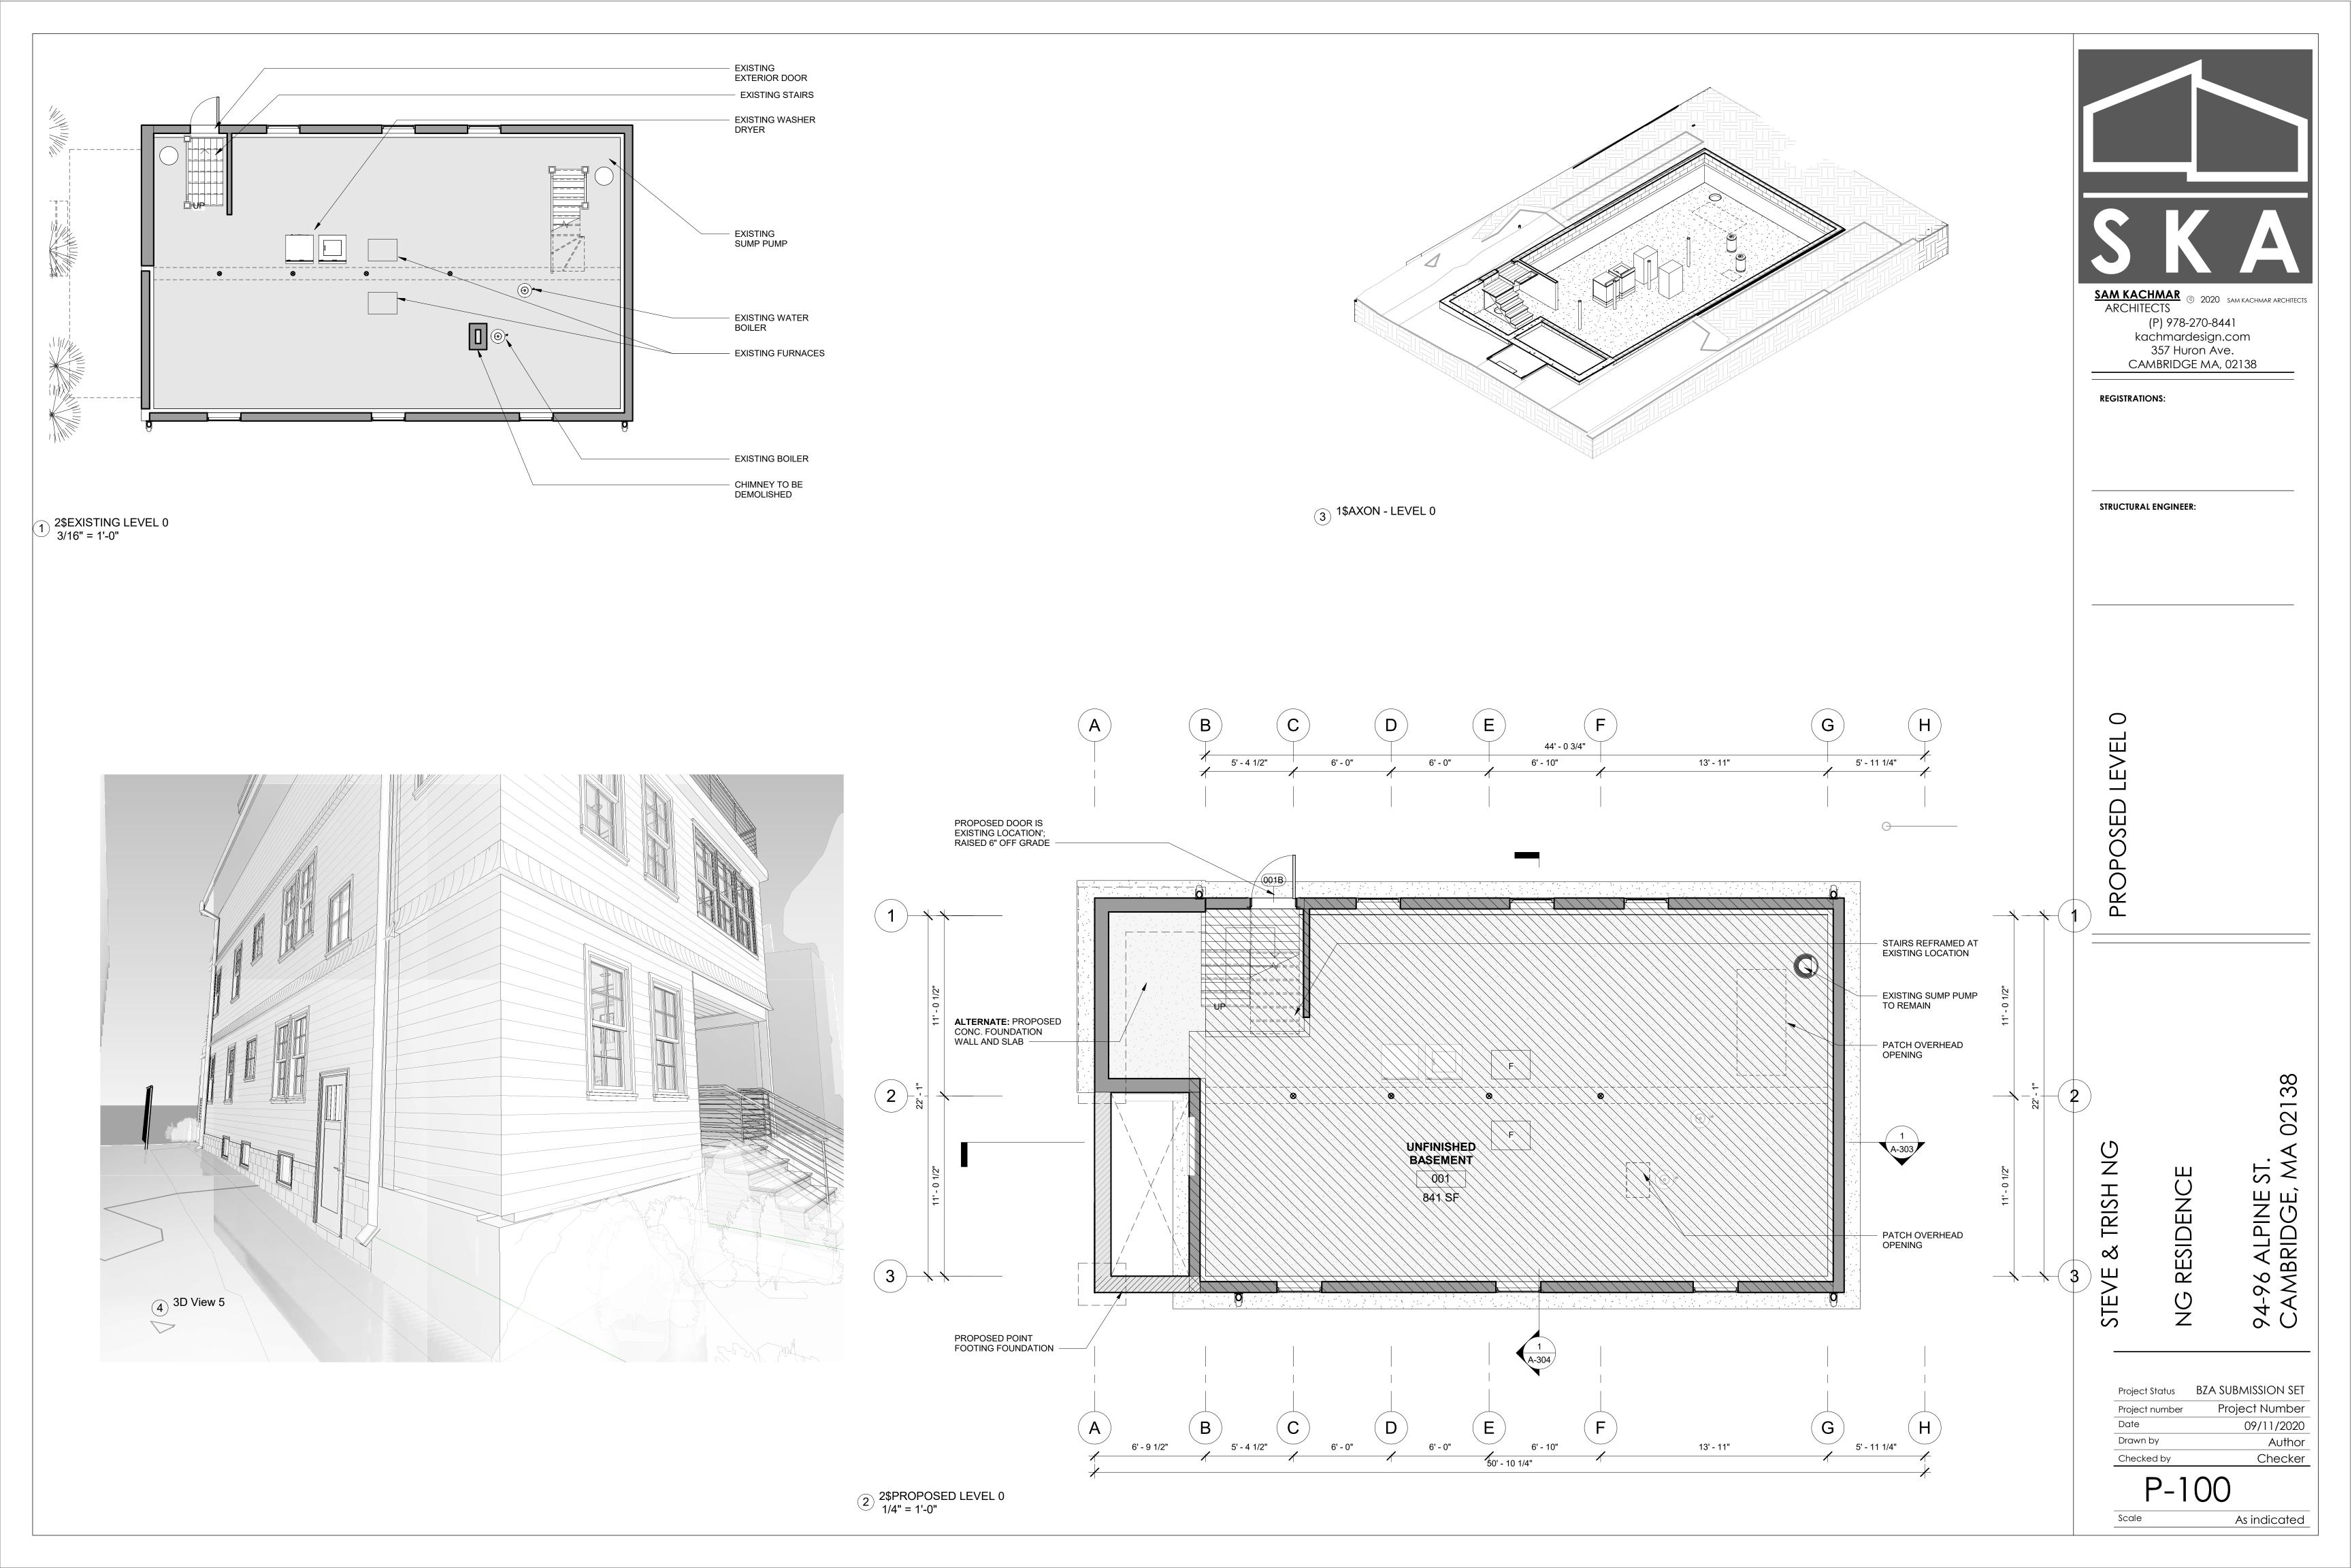

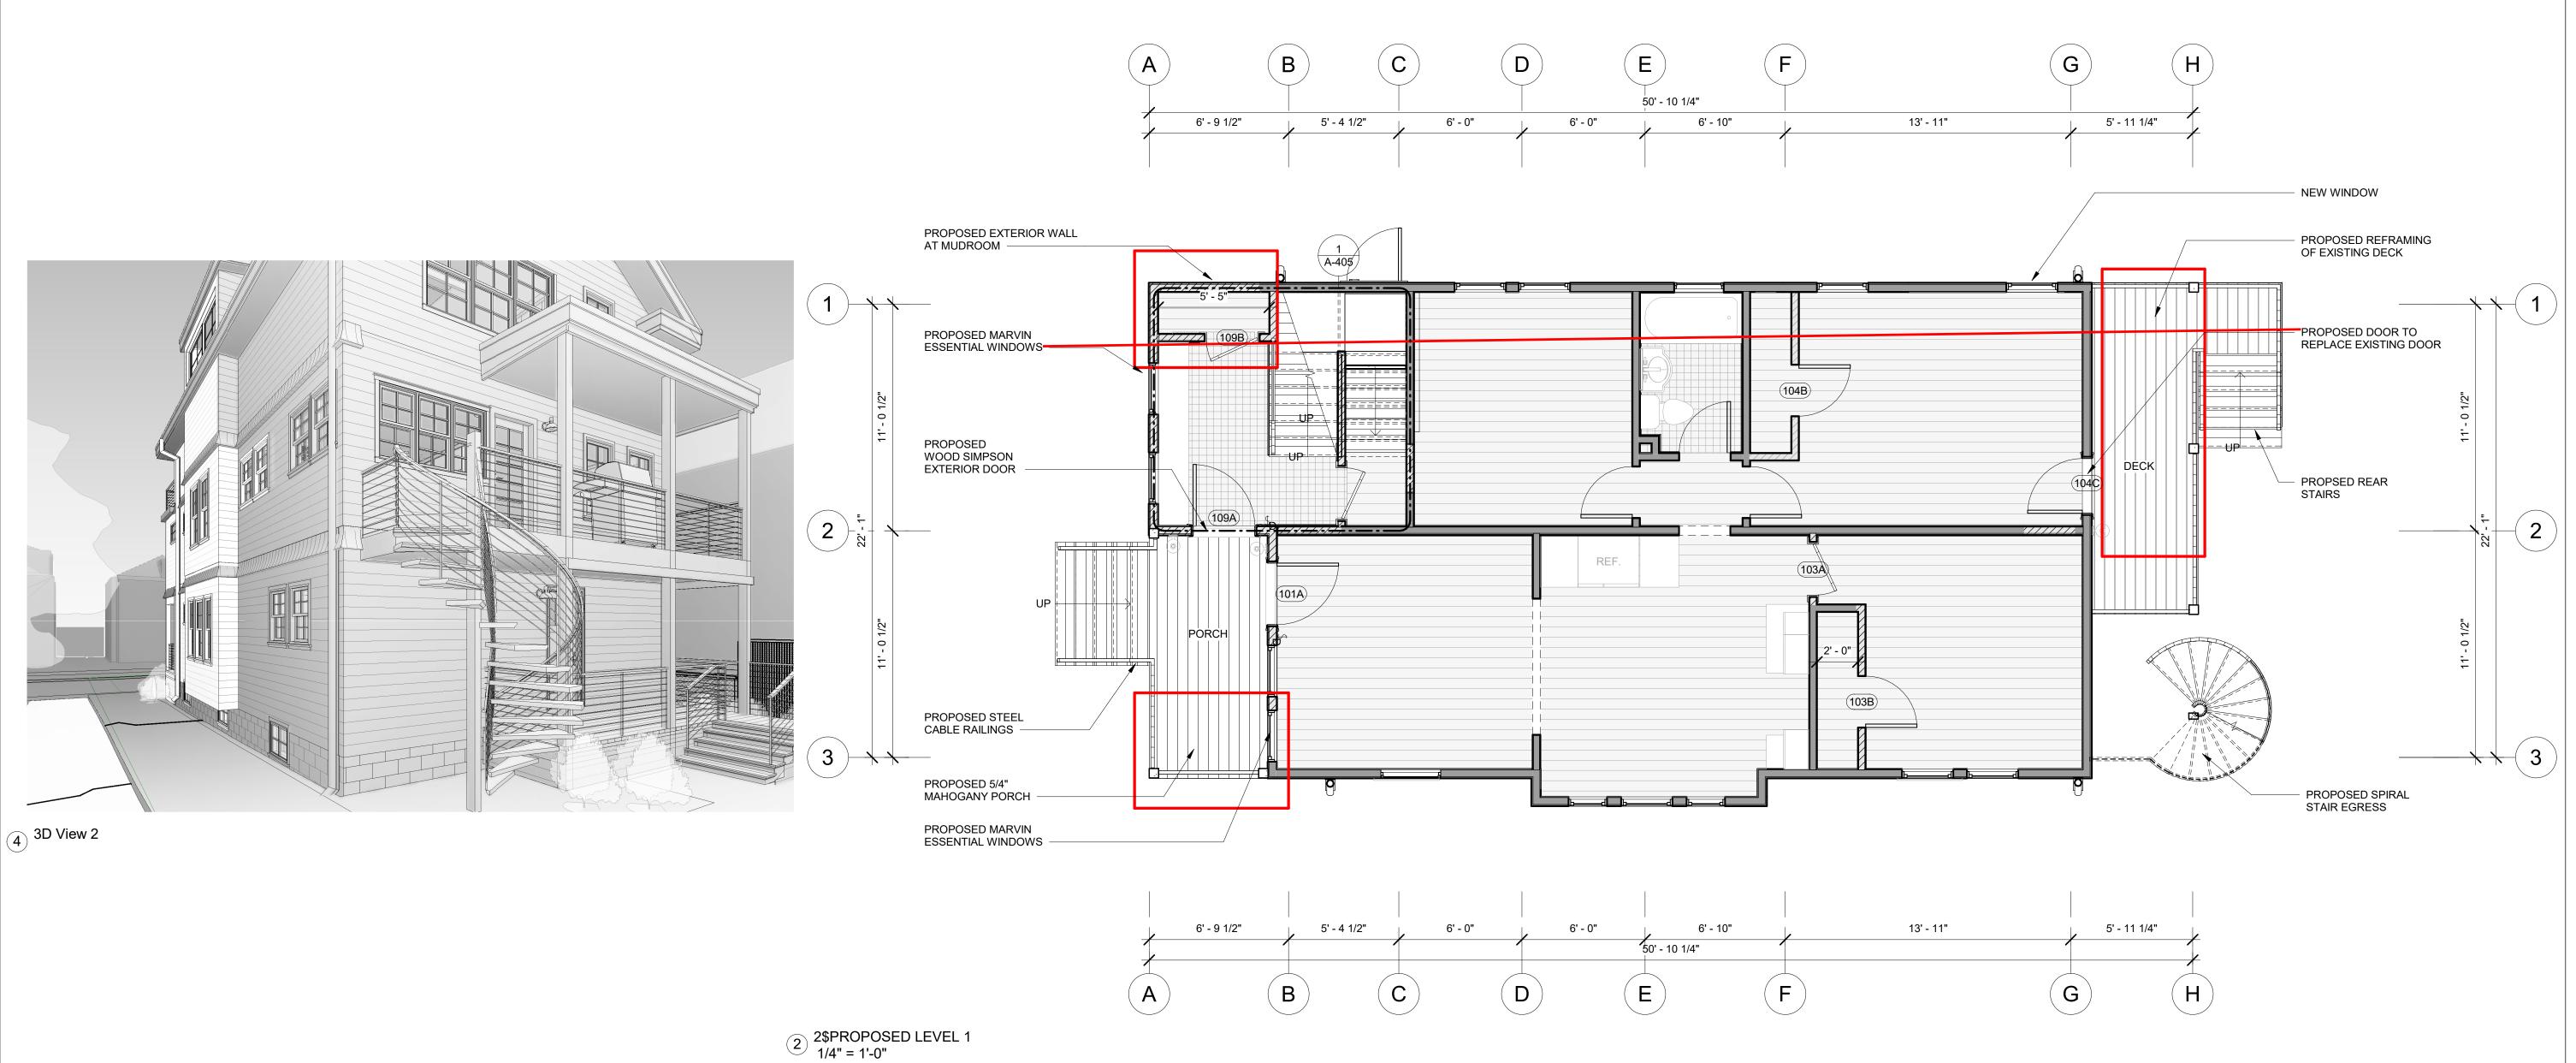
1 2\$EXISTING LEVEL 1 3/16" = 1'-0"

BEDROOM

LIVING ROOM

BEDROOM

4

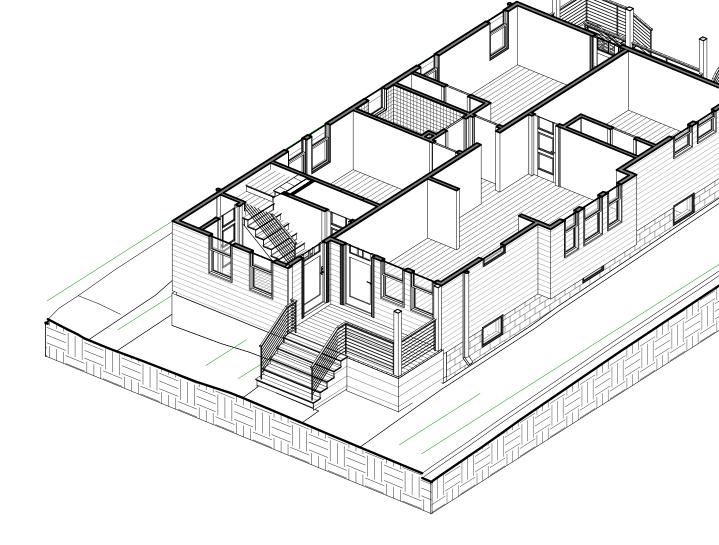

3 1\$AXON - PROPOSED LEVEL 1

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(P) 978-270-8441 kachmardesign.com 357 Huron Ave. CAMBRIDGE MA, 02138

REGISTRATIONS:

STRUCTURAL ENGINEER:

TRISH NG

STEVE

02138


94-96 ALPINE ST. CAMBRIDGE, MA

Project Status BZA SUBMISSION SET Project Number Project number Date 09/11/2020 Drawn by Author Checker Checked by


NG RESIDENCE

Scale As indicated

2\$PROPOSED LEVEL 2 1/4" = 1'-0"

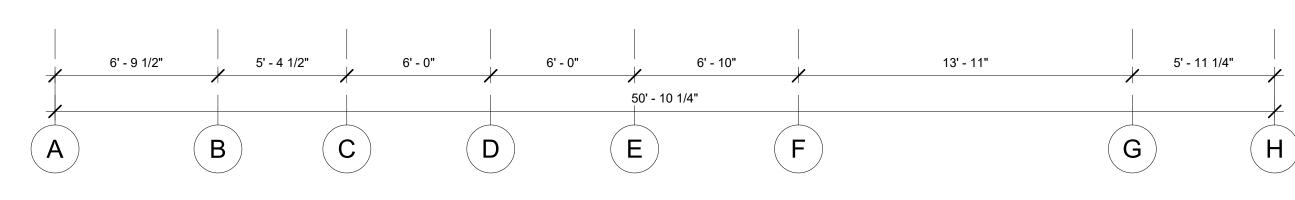




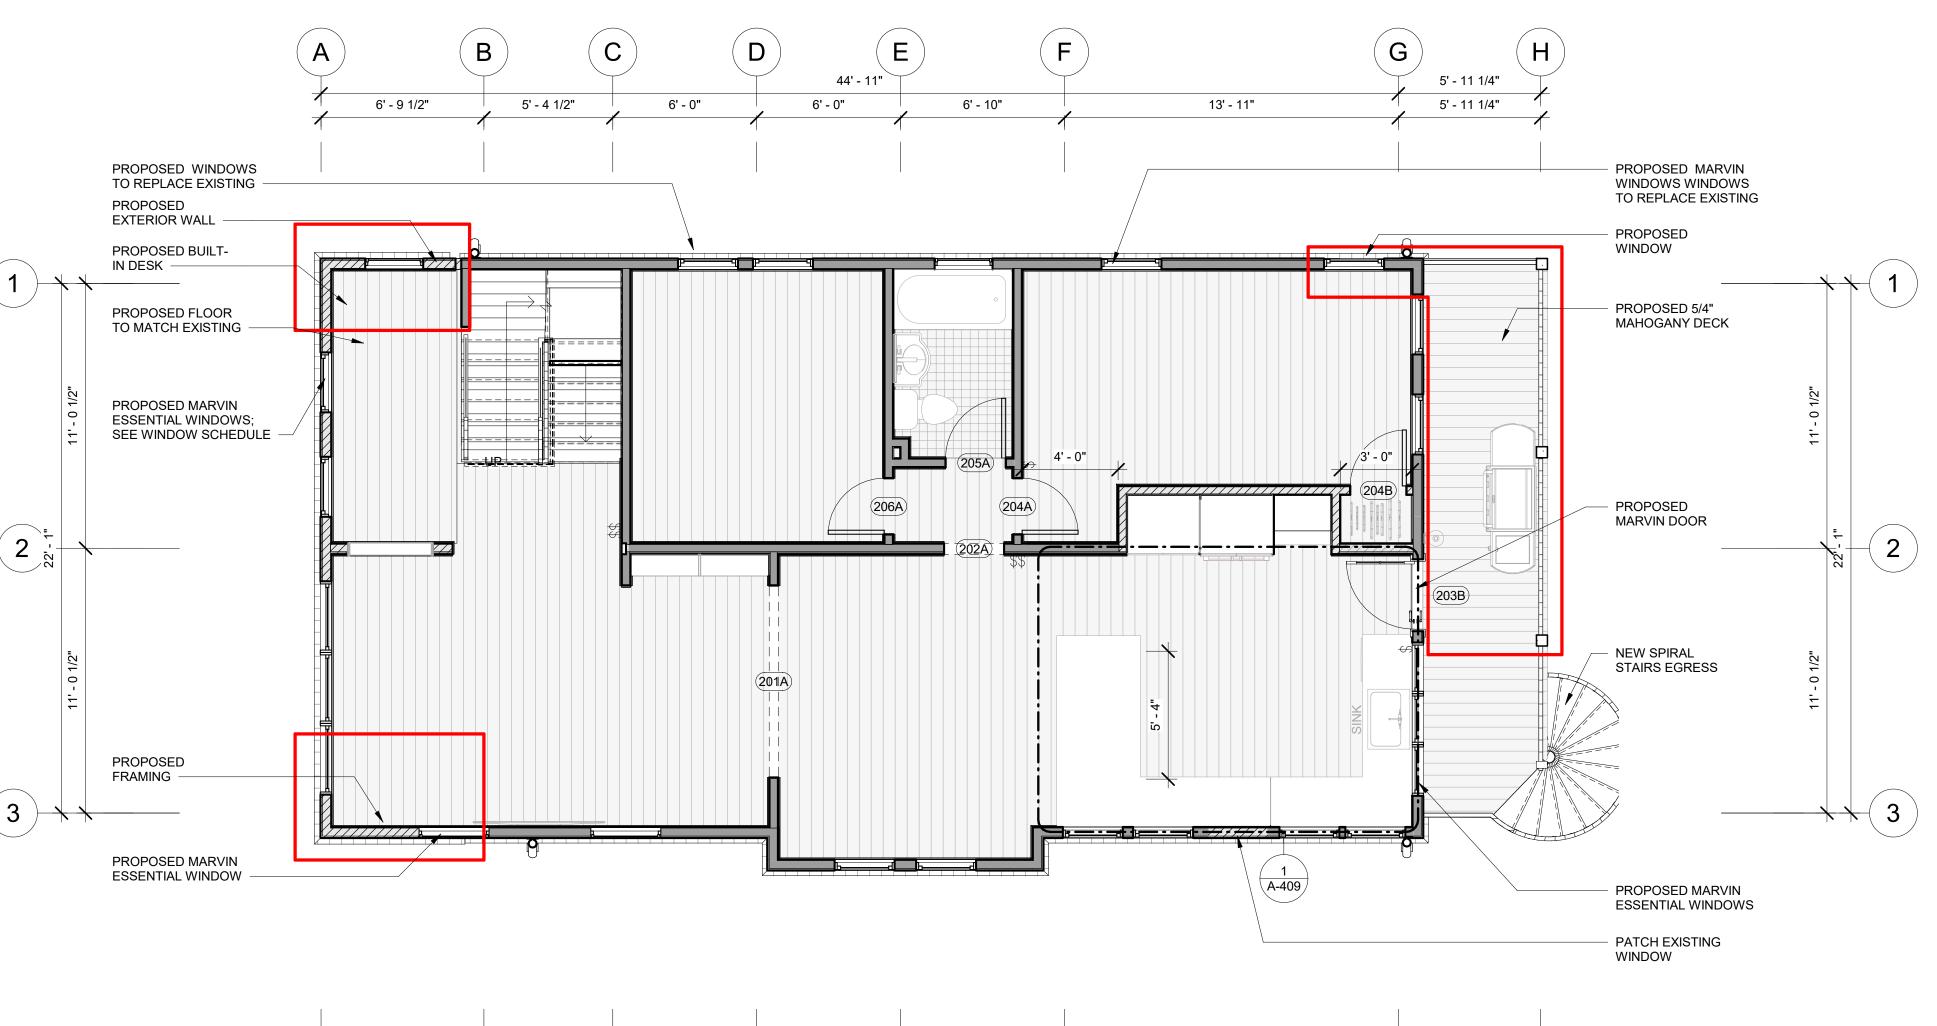

2\$EXISTING LEVEL 2 3/16" = 1'-0"



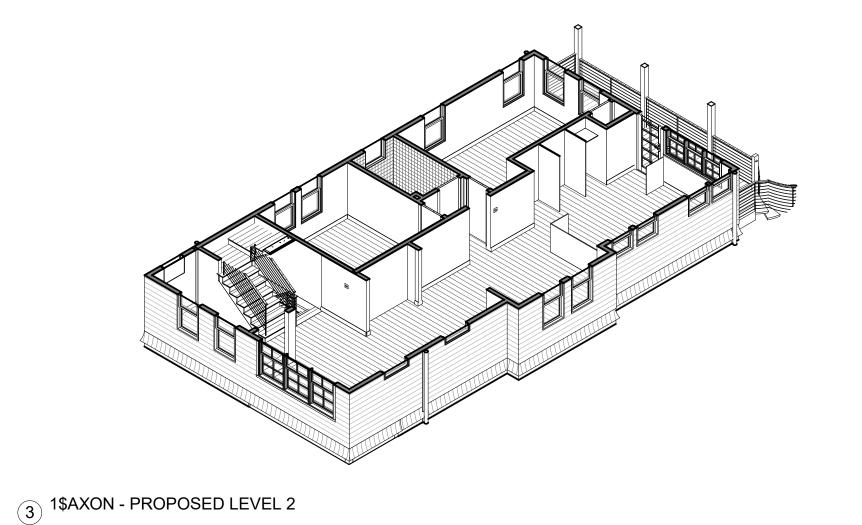

STEVE & TRISH NG

94-96 ALPINE ST. CAMBRIDGE, MA 02138 NG RESIDENCE

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357 Huron Ave.

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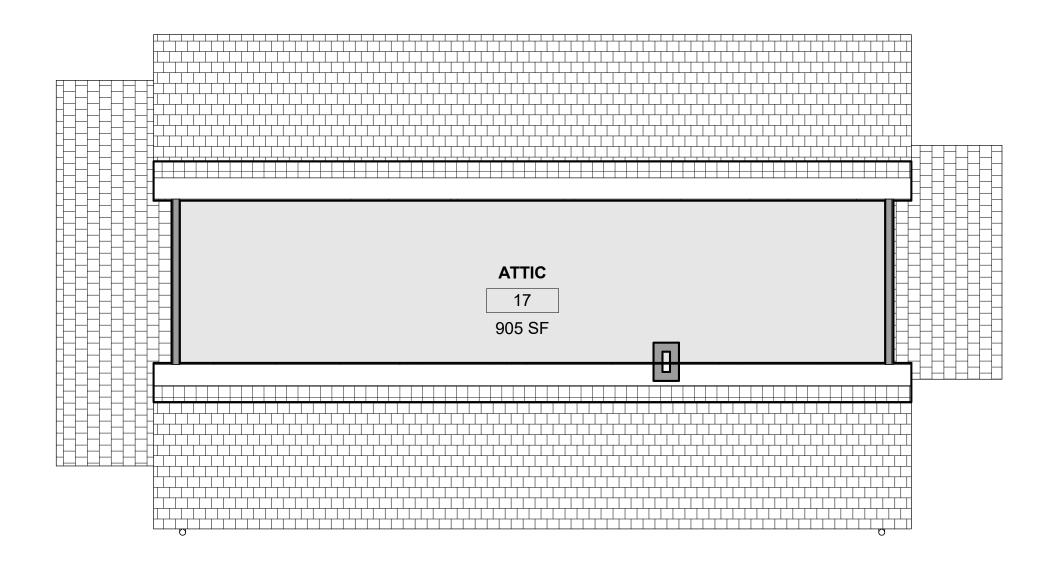
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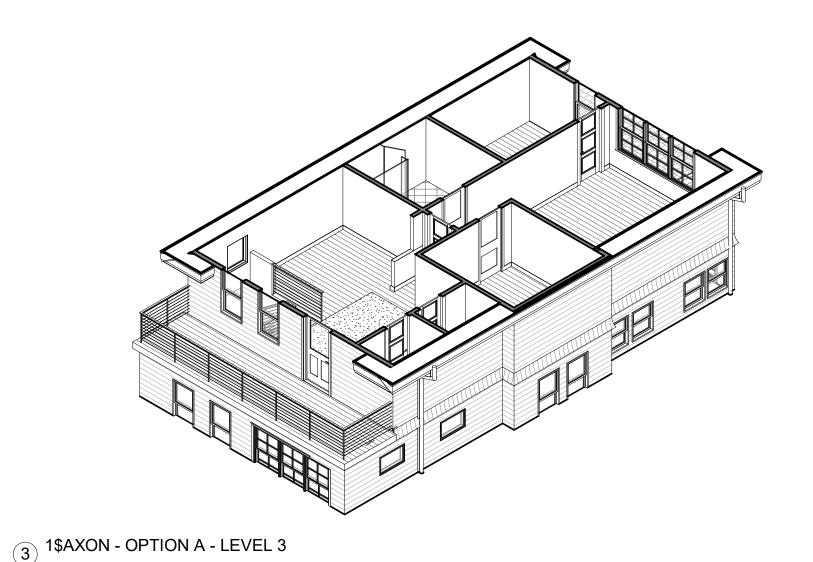
STRUCTURAL ENGINEER:

Project Status BZA SUBMISSION SET Project Number Project number Date 09/11/2020 Drawn by Author Checker

Checked by P-102

Scale As indicated







1\$PROPOSED LEVEL 4 3/16" = 1'-0"





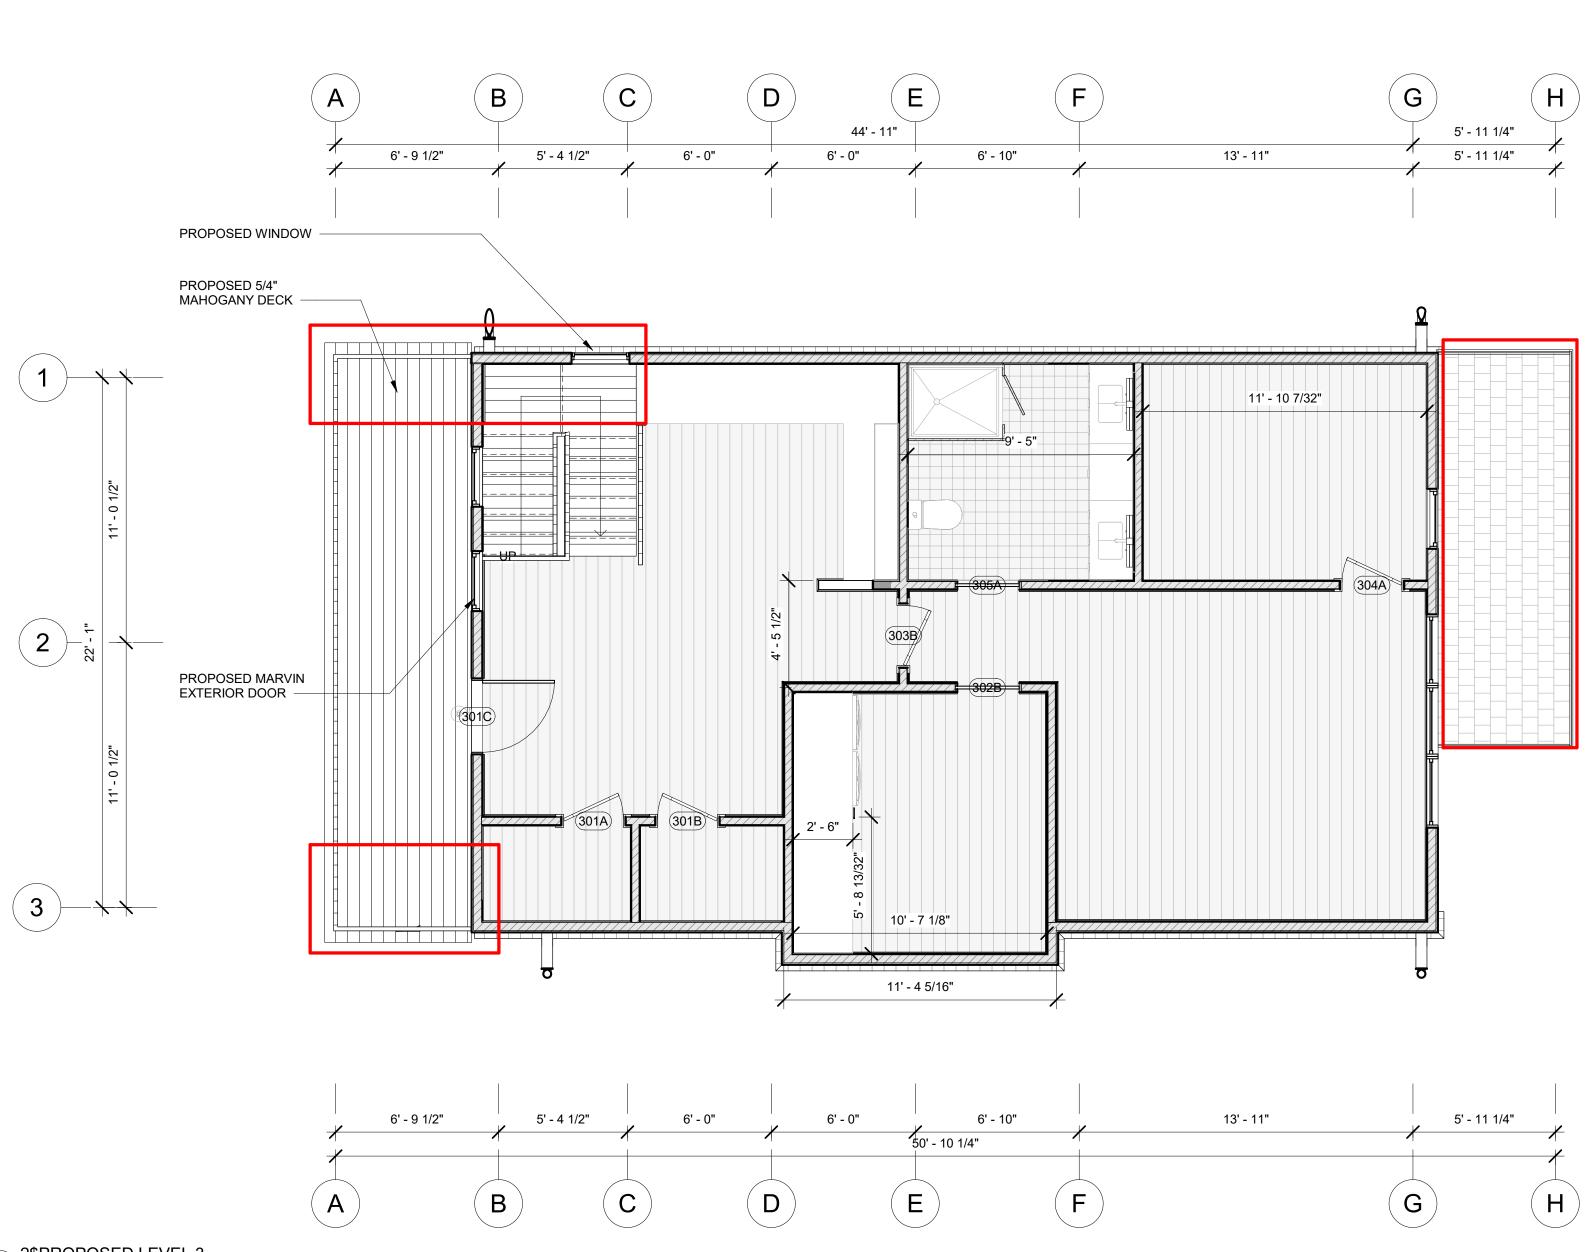

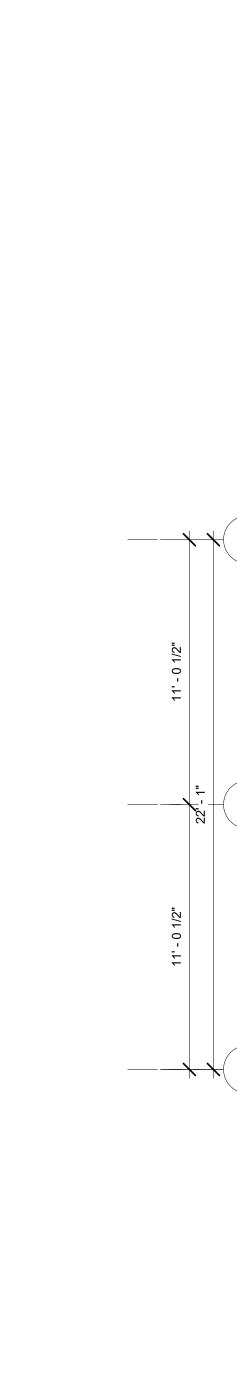

94-96 ALPINE ST. CAMBRIDGE, MA 02138 NG RESIDENCE

STEVE & TRISH NG

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REGISTRATIONS:

STRUCTURAL ENGINEER:

Project Status	BZA SUBMISSION SET
Project number	Project Numbe
Date	09/11/2020
Drawn by	Autho
Checked by	Checke


P-103

Scale As indicated

2\$PROPOSED LEVEL 3 1/4" = 1'-0"

1 1\$EXISTING ROOF RIDGE 3/16" = 1'-0"



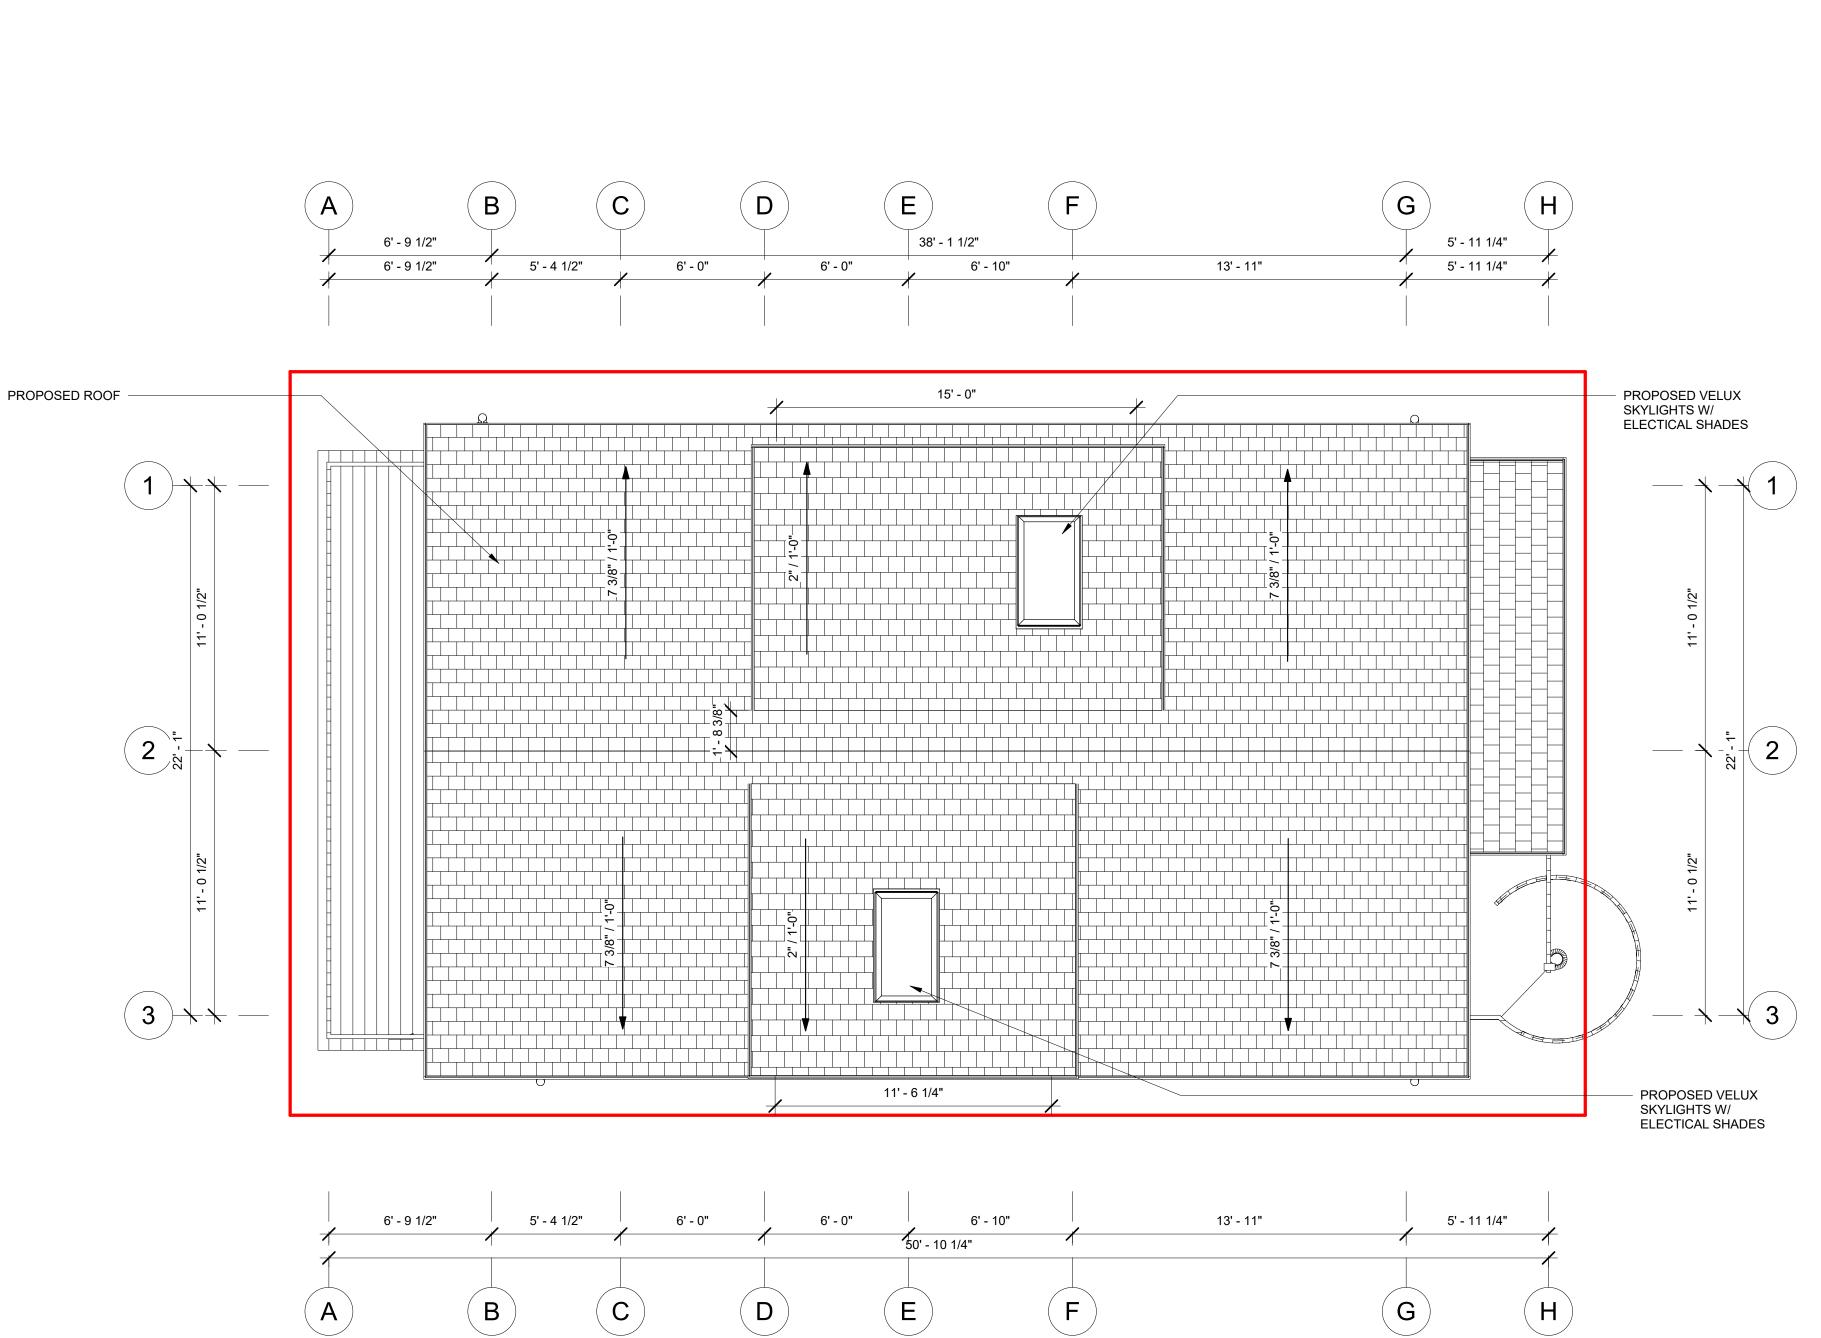

2 1\$PROPOSED ROOF RIDGE 1/4" = 1'-0"



STRUCTURAL ENGINEER:

REGISTRATIONS:

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& TRISH NG

STEVE

94-96 ALPINE ST. CAMBRIDGE, MA 02138 NG RESIDENCE


BZA SUBMISSION SET Project Number Project number Date 09/11/2020 Drawn by Author Checker Checked by

Scale As indicated



3 PERSPECTIVE FRONT ELEVATION



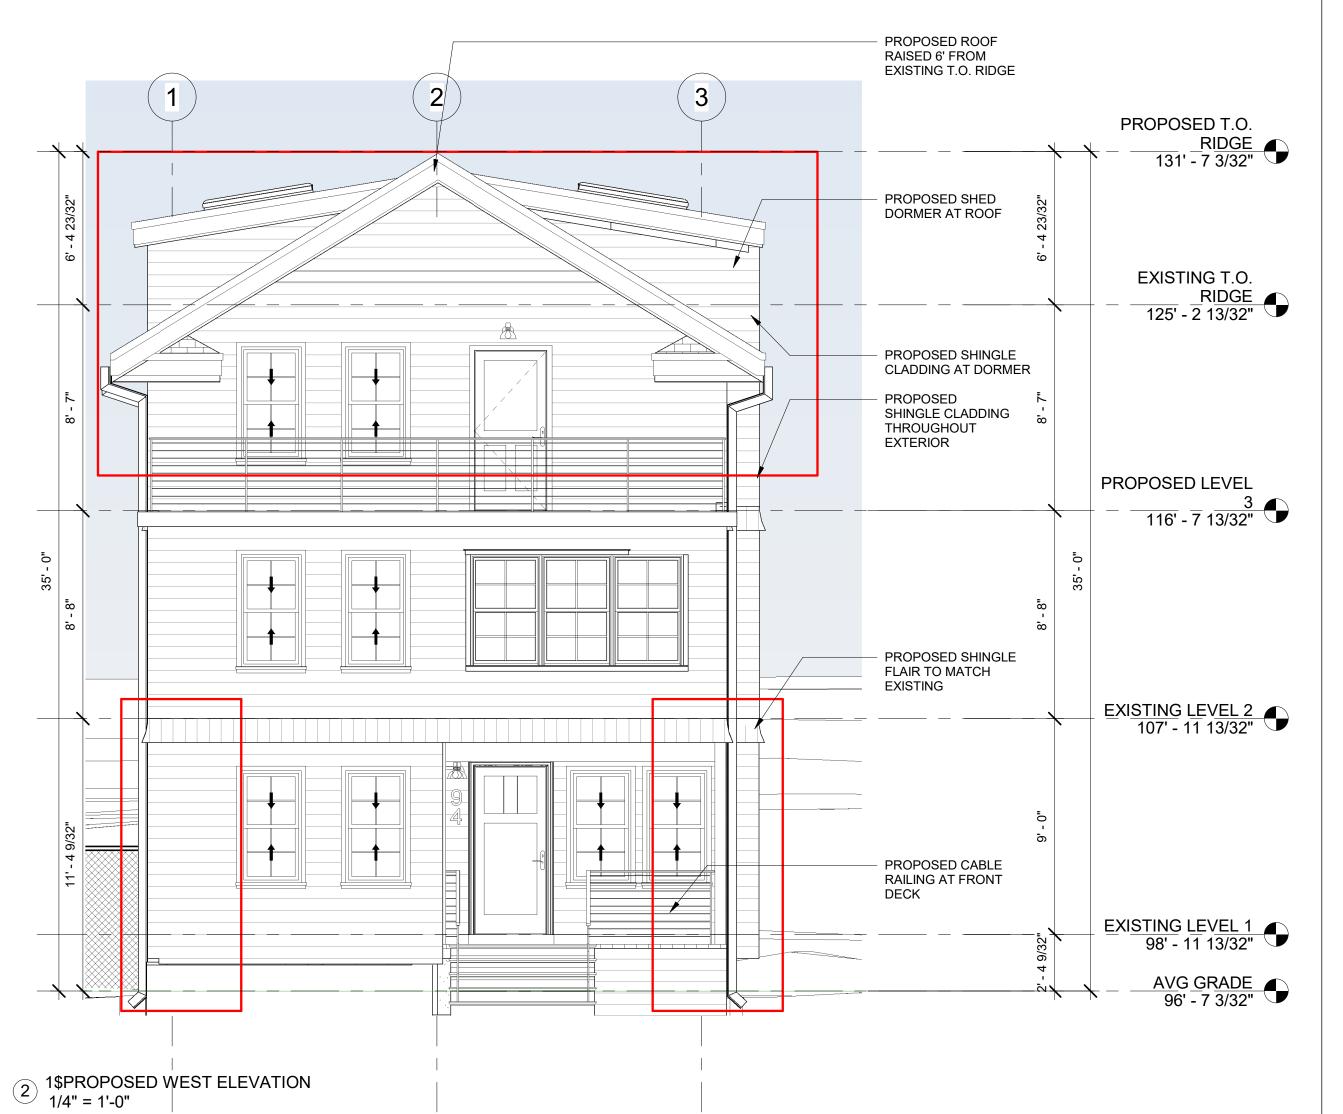



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REGISTRATIONS:

STRUCTURAL ENGINEER:

TRISH NG

94-96 ALPINE ST. CAMBRIDGE, MA 02138

Project Status BZA SUBMISSION SET Project Number Project number Date 09/11/2020 Drawn by Author Checker

Checked by P-200

NG RESIDENCE

1/4'' = 1'-0''



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94-96 ALPINE ST. CAMBRIDGE, MA 02138

Project Status BZA SUBMISSION SET Project Number 09/11/2020 Drawn by Author Checker Checked by

P-201

NG RESIDENCE

1/4" = 1'-0"



EXISTING T.O.

RIDGE
125' - 2 13/32"


PROPOSED LEVEL

116' - 7 13/32" •

EXISTING LEVEL 2 107' - 11 13/32"

EXISTING LEVEL 1 98' - 11 13/32"

AVG GRADE 96' - 7 3/32"

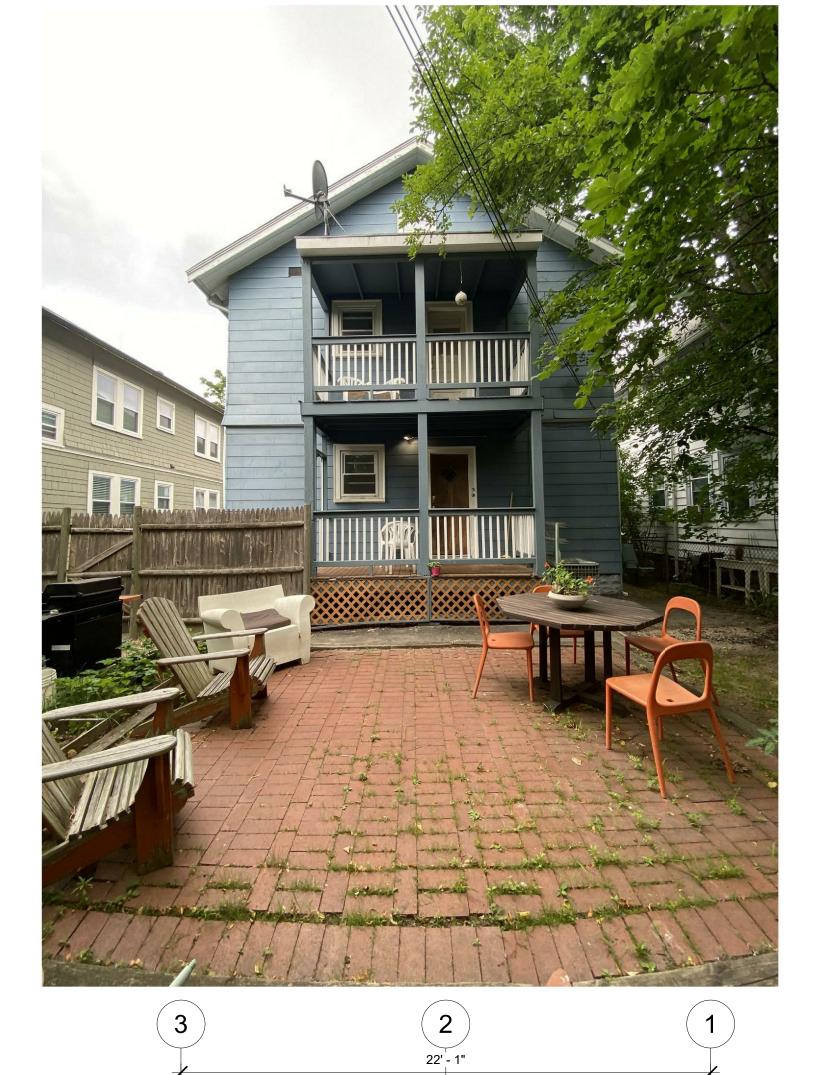



ELEV

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REGISTRATIONS:

STRUCTURAL ENGINEER:

& TRISH NG

STEVE

EXISTING LEVEL 1 98' - 11 13/32"

AVG GRADE 96' - 7 3/32"

94-96 ALPINE ST. CAMBRIDGE, MA 02138

Project Status BZA SUBMISSION SET Project Number Date 09/11/2020 Drawn by

Author

Checker Checked by P-202

NG RESIDENCE

Scale 1/4" = 1'-0"

3 PERSPECTIVE - EVELATION - EAST

1\$EXISTING EAST ELEVATION 1/4" = 1'-0"

PROPOSED T.O.

RIDGE
131' - 7 3/32" EXISTING T.O.

RIDGE
125' - 2 13/32" PROPOSED LEVEL 116' - 7 13/32" EXISTING LEVEL 2 107' - 11 13/32"





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STRUCTURAL ENGINEER:

94-96 ALPINE ST. CAMBRIDGE, MA 02138 NG RESIDENCE

Project Status BZA SUBMISSION SET Project number

Date Project Number 09/11/2020 Drawn by Author Checker Checked by

P-203 Scale 1/4" = 1'-0"

MORTGAGE INSPECTION PLAN

NORTHERN ASSOCIATES, INC. 92 MAPLE AVENUE ANDOVER, MA 01810 TEL:(978) 837-3335 FAX:(978) 837-3336 MASSACHUSETTS

MORTGAGOR: STEVEN NG, PATRICIA NG & AUDREY NG

LOCATION: 94-96 ALPINE ST CITY, STATE: CAMBRIDGE, MA DATE: 11/25/19

DEED REF. 72187 /182 PLAN REF. #481 SCALE: 1"=20' JOB #: 2193744

40.00' LOT 119 $3800 \pm sf$ POR. 00 EXISTING 95. DWELLING 94 - 96**ENCL** POR. 40.00'

ALPINE STREET

CERTIFIED TO: GUARANTEED RATE AFFINITY LLC, ISAOA/ATIMA

Flood hazard zone has been determined by scale and is not necessarily accurate. Until definitive plans are issued by HUD and/or a vertical control survey is performed, precise elevations cannot be determined.

NOTE: This mortgage Inspection was prepared specifically for mortgage purpose only and is not to be relied upon as a land or property line survey, used for recording, preparing deed descriptions, or construction. No corners were set. Building location and offsets are approximately located on ground and are shown specifically for zoning determination only and are not to betweed to establish property lines. The matters shown hereon are based on client-furnished information and may be subject to further out-sales, takings, easements and rights of way, and other matters of record and preserptive or other rights. Northern Associates, Inc. assumes nuresponsibility herein to land owner or occupant, accepts no responsibility for damages resulting from reliance by anyone other than the said mortgage and the connection with its proposed mortgage financing to said mortgagor.



I render this mortgage inspection plan to be issued with the best of my knowledge, information and belief.

I further state that in my professional opinion that the structures shown conform with the local zoning horizontal dimensional setback requirements at the time of construction or are exempt under previsions of M.C.L. CH. 40—A Sec. 7.

■ 1. Property/House is not in Flood Hazard.

□ 2. Property/House is in a Flood Hazard Area.


□ 3. Information is insufficent to determine Flood Hazard.

Flood Hazard determined from latest Federal Flood Insurance Rate Map Panel 25017C0419E

Date 06/04/10

X Zone



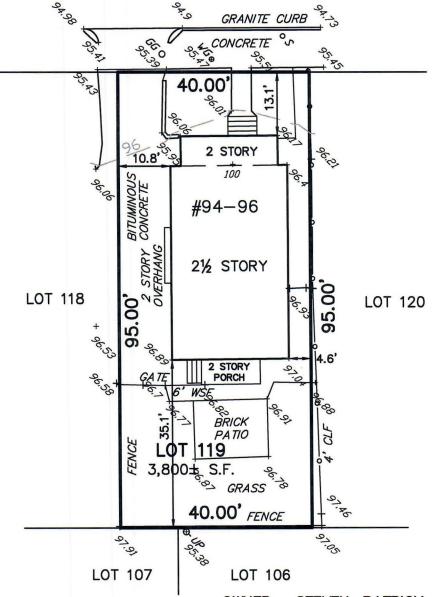

I HEREBY CERTIFY THAT THE BUILDING IS LOCATED AS SHOWN.

OWNER: STEVEN, PATRICIA & AUDRY NG

PROPOSED PLOT PLAN #92-94 ALPINE STREET

CAMBRIDGE, MA
(MIDDLESEX COUNTY)

SCALE: 1"= 20' DATE: 7/24/2020

0 20 40 60 ft

ROBER SURVEY

1072A MASSACHUSETTS AVENUE ARLINGTON, MA 02476 (781) 648-5533 6187PP1.DWG

CLIFFORD E. ROBER, PLS

DATE

THIS PLAN MAY HAVE BEEN ALTERED IF THE SIGNATURE IS NOT SIGNED IN BLUE.

Google Maps 97 Alpine St

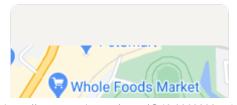


Image capture: Jul 2019 © 2020 Google

Cambridge, Massachusetts



Street View



Google Maps 94 Alpine St

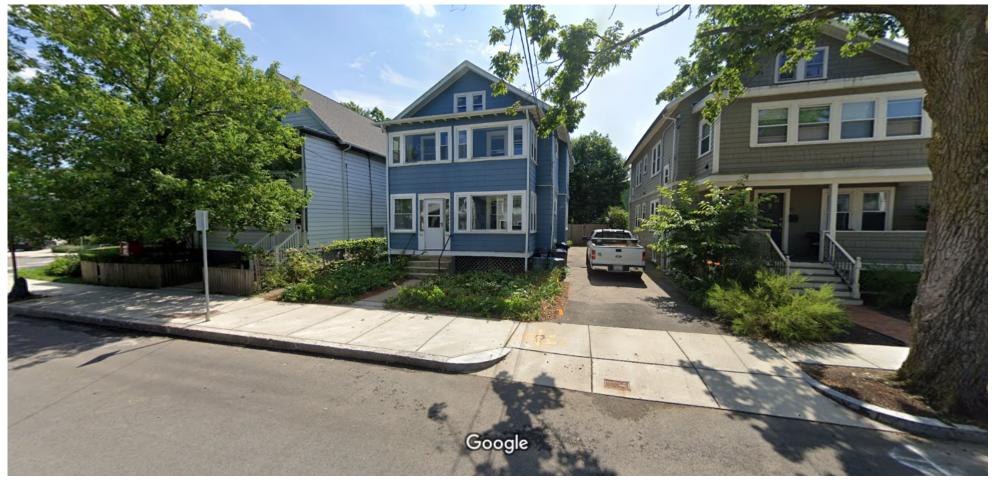



Image capture: Jul 2019 © 2020 Google

Cambridge, Massachusetts



Street View

Google Maps 96 Alpine St

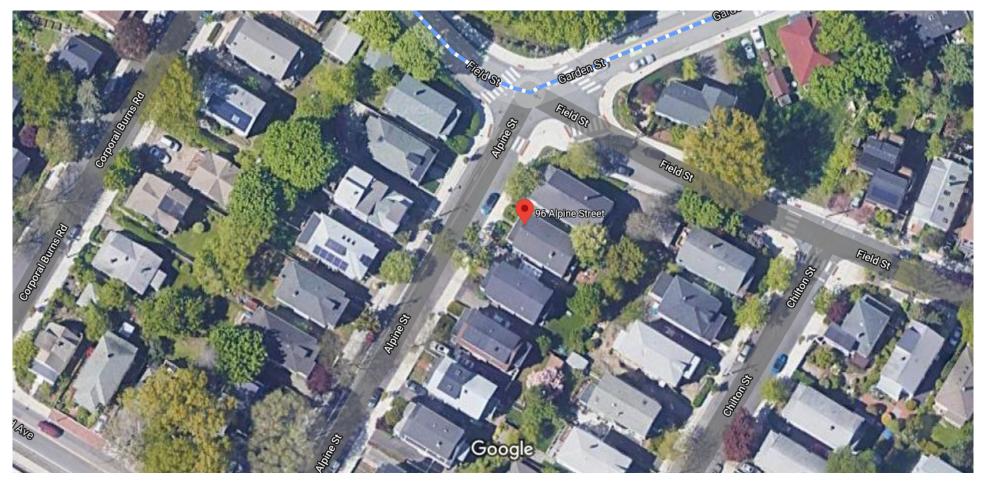

Imagery ©2020 MassGIS, Commonwealth of Massachusetts EOEA, Maxar Technologies, Map data ©2020 50 ft

GENERAL INFORMATION

Special Permit: X Variance: X App	eal:
PETITIONER: Steven Ng, Patricia D. Ng and Audrey Ng b	y: Christopher J. Alphen, Esq.
ETITIONER'S ADDRESS: Blatman, Bobrowski & Haverty, LLC, 9 Dan	nonmill Square, Concord, MA 0
OCATION OF PROPERTY: 94-96 Alpine Street, Cambridge, MA 02138	
YPE OF OCCUPANCY: Two-Family Residence ZONING DISTRICT:	
EASON FOR PETITION:	
X Additions	New Structure
Change in Use/Occupancy	Parking
Conversion to Addi'l Dwelling Unit's	Sign
Dormer	Subdivision
Other:	
nonconforming FAR from 0.70 to 0.88, requiring a Variance. The pro-	oposal is an alteration of
a pre-existing nonconforming structure, requiring a special permit.	
a pre-existing nonconforming structure, requiring a special permit. EECTIONS OF ZONING ORDINANCE CITED: Exticle 5.000 Section 11 / Table 5-1	
a pre-existing nonconforming structure, requiring a special permit. EECTIONS OF ZONING ORDINANCE CITED: Exticle 5.000 Section 11 / Table 5-1 Exticle 10.000 Section 30 / 13(c) / G.L. ch. 40A, s. 11	
a pre-existing nonconforming structure, requiring a special permit. ECCTIONS OF ZONING ORDINANCE CITED: Article 5.000 Section 11/Table 5-1 Article 10.000 Section 30/13(c)/G.L. ch. 40A, s. 11 Article 8.000 Section 8.22.2.C (Non-Confroming Structure) Applicants for a Variance must complete Pages 1-5 Applicants for a Special Permit must complete Pages 1-4 and applicants for an Appeal to the BZA of a Zoning of a special Services Department must attach a statement of the appeal	d 6 determination by the
a pre-existing nonconforming structure, requiring a special permit. ECCTIONS OF ZONING ORDINANCE CITED: Inticle 5.000 Section 11/Table 5-1 Inticle 10.000 Section 30/13(c)/G.L. ch. 40A, s. 11 Inticle 8.000 Section 8.22.2.C (Non-Confroming Structure) Implicants for a Variance must complete Pages 1-5 Implicants for a Special Permit must complete Pages 1-4 and populational Services Department must attach a statement of the appeal or the appeal Inticle 8.000 Section 70 Original Signature(s): Inticle 9.000 Section 70 Original Signature(s):	d 6 determination by the concerning the reasons
a pre-existing nonconforming structure, requiring a special permit. ECTIONS OF ZONING ORDINANCE CITED: Tricle 5.000 Section 11/Table 5-1 Tricle 10.000 Section 30/13(c)/G.L. ch. 40A, s. 11 Tricle 8.000 Section 8.22.2.C (Non-Confroming Structure) Expelicants for a Variance must complete Pages 1-5 Expelicants for a Special Permit must complete Pages 1-4 and Expelicants for an Appeal to the BZA of a Zoning of Experiment special Services Department must attach a statement of the appeal Original Signature(s): Address: Blatman, Bob 9 Damonmill Concord, MA	d 6 determination by the concerning the reasons er(s)/Owner) Ng by: Christopher J. Alphen, Ent Name) prowski & Haverty, LLC Square, Ste. 4A4
a pre-existing nonconforming structure, requiring a special permit. ECTIONS OF ZONING ORDINANCE CITED: Tricle 5.000 Section 11/Table 5-1 Tricle 10.000 Section 30/13(c)/G.L. ch. 40A, s. 11 Tricle 8.000 Section 8.22.2.C (Non-Confroming Structure) Expelicants for a Variance must complete Pages 1-5 Expelicants for a Special Permit must complete Pages 1-4 and Expelicants for an Appeal to the BZA of a Zoning of Experiment special Services Department must attach a statement of the appeal Original Signature(s): Address: Blatman, Bob 9 Damonmill Concord, MA	d 6 determination by the concerning the reasons er(s)/Owner) Ng by: Christopher J. Alphen, Ent Name) prowski & Haverty, LLC Square, Ste. 4A4 101742 Ext. 19 (office)

BZA APPLICATION FORM - OWNERSHIP INFORMATION

To be completed by OWNER, signed before a notary and returned to The Secretary of the Board of Zoning Appeals.

I/We Steven Ng, Patricia D. Ng and Audrey Ng (OWNER)
Address: 94-96 Alpine Street, Cambridge, MA
Address. 7170 Tipine offeet, Camoriage, 1471
State that I/We own the property located at94-96 Alpine Street, Cambridge, MA
which is the subject of this zoning application.
The record title of this property is in the name of
Steven Ng, Patricia D. Ng and Audrey Ng
0'
*Pursuant to a deed of duly recorded in the date $\phantom{aaaaaaaaaaaaaaaaaaaaaaaaaaaaaaaaaaa$
County Registry of Deeds at Book <u>73875</u> , Page <u>99</u> ; or
Middlesex Registry District of Land Court, Certificate No
Book
A a
SIGNATURE BY LAND OWNER OR AUTHORIZED TRUSTEE, OFFICER OR AGENT* Christopher J. Alphen, Esq. on behalf of the the petitioners *Written evidence of Agent's standing to represent petitioner may be requested.
Commonwealth of Massachusetts, County of <u>Middlesex</u>
The above-name Christopher J. Alphen personally appeared before me,
this 25 of September, 20 10, and made oath that the above statement is true.
All Caf Iten Windary
My commission expires 12-12-255 (Notary Sal REBECCA L. FLINKSTROM Notary Public COMMONWEALTH OF MASSACHUSETTS My Commission Expires December 12, 2025
If ownership is not shown in recorded deed, e.g. if by court order, recent deed, or inheritance, please include documentation.

DIMENSIONAL INFORMATION

Christopher 978 371-222	r J. Alphen, Esq. 26	REQUESTED USE/	OCCUPANCY: Resid	dential Two family
		EXISTING CONDITIONS	REQUESTED CONDITIONS	ORDINANCE REQUIREMENTS ¹
OTAL GROSS FLOOR	AREA:	2,265 SF	3,348 SF	1,900 SF (
OT AREA:		3,800 SF		5,000 SF
ATIO OF GROSS FLO	OOR AREA	.70 %	.88 %	(
OT AREA FOR EACH	DWELLING UNIT:	3,800 SF	3,800 SF	2,500 SF (
IZE OF LOT:	WIDTH	40' - 0"		50' - 0"
	DEPTH	95' - 0''		
etbacks in		16 - 8"	16 - 8"	15' - 0''
Feet:	REAR	27' - 2"	27' - 2"	25' - 0"
	LEFT SIDE	5' - 0''	5' - 0"	7' - 6" (
	RIGHT SIDE	10' - 6"	10' - 6''	7' - 6" (
IZE OF BLDG.:	HEIGHT	28' - 9"	34' - 9"	35' - 0''
	LENGTH			
W	WIDTH			
ATIO OF USABLE OF	PEN SPACE			
O LOT AREA: 3)		.61 %	.59 %	.40 %
O. OF DWELLING U	NITS:	2	2	(
O. OF PARKING SPA	ACES:	1	1	1 (min.
O. OF LOADING AR	EAS:	0	0	N/A (
ISTANCE TO NEARES	ST BLDG.	N/A	N/A	N/A (
n same lot, and teel, etc.	type of const	cruction propos	same lot, the sized, e.g.; wood f	ee of adjacent buil Frame, concrete, b

^{1.} SEE CAMBRIDGE ZONING ORDINANCE ARTICLE 5.000, SECTION 5.30 (DISTRICT OF DIMENSIONAL REGULATIONS).

^{2.} TOTAL GROSS FLOOR AREA (INCLUDING BASEMENT 7'-0" IN HEIGHT AND ATTIC AREAS GREATER THAN 5') DIVIDED BY LOT AREA.

THAN 5') DIVIDED BY LOT AREA.

3. OPEN SPACE SHALL NOT INCLUDE PARKING AREAS, WALKWAYS OR DRIVEWAYS AND SHALL HAVE A MINIMUM DIMENSION OF 15'.

SUPPORTING STATEMENT FOR A VARIANCE

EACH OF THE FOLLOWING REQUIREMENTS FOR A VARIANCE MUST BE ESTABLISHED AND SET FORTH IN COMPLETE DETAIL BY THE APPLICANT IN ACCORDANCE WITH MGL 40A, SECTION 10:

A) A Literal enforcement of the provisions of this Ordinance would involve a substantial hardship, financial or otherwise, to the petitioner or appellant for the following reasons:

The Petitioners recently moved to Cambridge from Concord to accommodate their son Thomas who has special needs. The dwelling contains two units. One unit will be independently occupied by Thomas and other by his parents Steven and Patricia Ng. Thomas works in Boston; residing in Cambridge affords him an easier commute. The Petitioners wish to provide a fitting independent living area for their son. Additionally, their daughter Audrey, who has an ownership interest in the home, plans to reside at the home. With a literal enforcement of the Ordinance, the home's living space cannot be altered to become suitable for the entire family.

B) The hardship is owing to the following circumstances relating to the soil conditions, shape or topography of such land or structures and especially affecting such land or structures but not affecting generally the zoning district in which it is located for the following rearsons:

The hardship is related to the size and shape of the lot and the age and condition of the two-family structure.

C) DESIRABLE RELIEF MAY BE GRANTED WITHOUT EITHER:

1) Substantial detriment to the public good for the following reasons:

The excess FAR will not be detrimental to the public good. The proposed alterations and additions to the residential home will meet the characteristics of the neighborhood. The residential home will have a minimal visual impact on the surrounding neighborhood.

2) Relief may be granted without nullifying or substantially derogating from the intent or purpose of this Ordinance for the following reasons:

The renovations to the dwelling have been aesthetically designed to blend in with the existing neighborhood. The renovations will improve to the neighborhood without substantially derogating from the requirement of the Ordinance.

* If You have any questions as to whether you can establish all of the applicable legal requirements, you should consult with your own attorney.

(ATTACHMENT B - PAGE 5)

SUPPORTING STATEMENT FOR A SPECIAL PERMIT

Please describe in complete detail how you meet each of the following criteria referring to the property and proposed changes or uses which are requested in your application. Attach sheets with additional information for special permits which have additional criteria, e.g.; fast food permits, comprehensive permits, etc., which must be met.

Granting the Special Permit requested for <u>94-96 Alpine Street</u> (location) would not be a detriment to the public interest because:

- A) Requirements of the Ordinance can or will be met for the following reasons:
 - The proposed renovations do not create any additional nonconformities, nor does it increase any existing nonconformities, other than an increase to the FAR (for which the applicant has applied for a variance). The proposed renovations will not be substantially more detrimental to the neighborhood than the existing nonconforming structure or use.
- B) Traffic generated or patterns of access or egress would not cause congestion hazard, or substantial change in established neighborhood character for the following reasons:

The proposed alterations will not cause any additional traffic.

- C) The continued operation of or the development of adjacent uses as permitted in the Zoning Ordinance would not be adversely affected by the nature of the proposed use for the following reasons:
 - The proposed alterations and additions to the residential home will meet the characteristics of the neighborhood. The residential home will have a minimal visual impact on the surrounding neighborhood.
- D) Nuisance or hazard would not be created to the detriment of the health, safety and/or welfare of the occupant of the proposed use or the citizens of the City for the following reasons:

The proposed alterations will not cause a nuisance or hazards.

E) For other reasons, the proposed use would not impair the integrity of the district or adjoining district or otherwise derogate from the intent or purpose of this ordinance for the following reasons:

The renovations to the dwelling have been aesthetically designed to blend in with the existing neighborhood. The renovations will improve to the neighborhood without substantially derogating from the requirement of the Ordinance.

(ATTACHMENT B - PAGE 6)

NG RESIDENCE

STEVE & TRISH NG

94-96 ALPINE ST. CAMBRIDGE, MA 02138





BZA SUBMISSION SET

09/11/2020

ARCHITECT:

SKA

SAM KACHMAR

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ARCHITECTS
(p)978-270-8441
kachmardesign.com
357 HURON AVE.
CAMBRIDGE MA, 02138

CLIENTS:

GENERAL CONTRACTOR:

STRUCTURAL ENGINEER:


STEVE & TRISH NG

THE NG RESIDENCE LOCATED AT 94-96
ALPINE ST WILL INCLUDE THE
RENOVATION OF THE FRONT AND REAR
PORCH, THE RENOVATION OF THE 2ND
FLOOR APARTMENT AND THE RAISING
OF THE ROOF BY 6 FT TO INCLUDE A
MAIN SUITE AND OFFICE.


	Permit Sheet List			
Sheet Number	Sheet Name	Designed By		
-				
P-000	COVER	Designer		
P-001	GENERAL NOTES	Designer		
P-002	PLOT PLAN & AREA PLAN	Designer		
P-003	LANDSCAPE PLAN	SKA		
P-100	PROPOSED LEVEL 0	Designer		
P-101	PROPOSED LEVEL 1	Designer		
P-102	PROPOSED LEVEL 2	Designer		
P-103	PROPOSED LEVEL 3	Designer		
P-110	PROPOSED ROOF PLAN	Designer		
P-200	ELEVATION WEST	Designer		
P-201	ELEVATION NORTH	Designer		
P-202	ELEVATION EAST	Designer		
P-203	ELEVATION SOUTH	Designer		

#	NUMBER OR POUND
&,+	AND
@	AT
ADJ	ADJUSTABLE
AFF	ABOVE FINISH FLOOR
ALUM	ALUMINUM
APPROX	APPROXIMATELY
ARCH	ARCHITECTURAL
AVB	AIR AND VAPOR BARRIER
BD	BOARD
BIT	BITUMINOUS
BLDG	BUILDING
BSMT	BASEMENT
BTWN	BETWEEN
CF	CUBIC FEET
CI	CUBIC INCHES
CJ	CONTROL JOINT
CL	CENTERLINE
CLG	CEILING
CLR	CLEAR OR CLEARANCE
CMU	CONCRETE MASONRY UNIT
COL	COLUMN
CONC	CONCRETE
CONT	CONTINUOUS
CORR	CORRIDOR, CORRUGATED
CTR	CENTER
D	DEPTH, DEEP
	
DBL	DOUBLE DEMOLITION
DEMO	DEMOLISH, DEMOLITION
DIA	DIAMETER
DIM	DIMENSION
DN	DOWN
DTL	DETAIL
DW	DISHWASHER
Е	EAST
EA	EACH
EJ	EXPANSION JOINT
EL	ELEVATION (GRADE)
ELEC	ELECTRICAL
ELEV	ELEVATION (FACADE)
EOS	EDGE OF SLAB
EQ	EQUAL, EQUIPMENT, EQUIP
ETR	EXISTING TO REMAIN
EXG	EXISTING
EXP	EXPOSED
EXT	EXTERIOR
FAB	FABRICATE, FABRICATION
FD	FLOOR DRAIN
FF	FINISHED FLOOR
FL	FLOOR
FOW	FACE OF WALL
FT	FEET, FOOT
GA	GAUGE
GALV	GALVANIZED
GL	GLASS, GLAZING, GLAZED
GWB	GYPSUM WALLBOARD, BACKING BOARD
GYP	GYPSUM
H	HIGH
HDWD	HARDWOOD
HM	HOLLOW METAL
HORIZ	HORIZONTAL
HVAC	HEATING, VENTILATING & AIR CONDITIONING
IN	INCH, INCHES
INCL	INCLUDE, INCLUDED
INT	INTERIOR
	JOINT


L	LENGTH
LAM	LAMINATE, LAMINATED
LB	POUND
LGMF	LIGHT GAGE METAL FRAMING
LT	LIGHT
LT WT	LIGHT WEIGHT
MAX	MAXIMUM
MDF	MEDIUM DENSITY FIBER
MECH	MECHANICAL
MED	MEDIUM
MFR	MANUFACTURER
MIN	MINIMUM
MISC	MISCELLANEOUS
MTD	MOUNTED
MTL	METAL
N	NORTH
N/A	NOT APPLICABLE
NIC	NOT IN CONTRACT
NOM	NOMINAL
NTS	NOT TO SCALE
OC	ON CENTER
OD	OUTSIDE DIAMETER
OH	OPPOSITE HAND
OPP	OPPOSITE OF TANDROAD PRODUCTION OF THE PRODUCTIO
OSB	ORIENTED STRANDBOARD
OVHD	OVERHEAD
OZ	OUNCE (S)
PATT	PATTERN (ED)
PERF	PERFORATED
PERP	PERPENDICULAR
PLAM	PLASTIC LAMINATE
PLYWD	PLYWOOD
PNT	PAINT, PAINTED
PR	PAIR
PREFAB	PREFABRICATE, PREFABRICATED
QTY	QUANTITY
RAD	RADIUS
RBR	RUBBER
RD	ROOF DRAIN
REF	REFERENCE
REFR	REFRIGERATE, REFRIGERATOR
REINF	REINFORCE, REINFORCED
REQ	REQUIRE
REV	REVISION, REVISE, REVISED
RM	ROOM
RO	ROUGH OPENING
S	SOUTH
SCHED	SCHEDULE
SF	SQUARE FEET
SI	SQUARE INCHES
SIM	SIMILAR
SPEC	SPECIFICATION
SQ	SQUARE
SS, SST	STAINLESS STEEL
STC	SOUND TRANSMISSION CLASS
STL	STEEL
STOR	STORAGE
	OTAID
STR	STAIR
STR T.O.	TOP OF
T.O. U.O.	TOP OF UNDERSIDE OF
T.O. U.O. UON	TOP OF UNDERSIDE OF UNLESS OTHERWISE NOTED
T.O. U.O. UON WD	TOP OF UNDERSIDE OF UNLESS OTHERWISE NOTED WOOD
T.O. U.O. UON	TOP OF UNDERSIDE OF UNLESS OTHERWISE NOTED

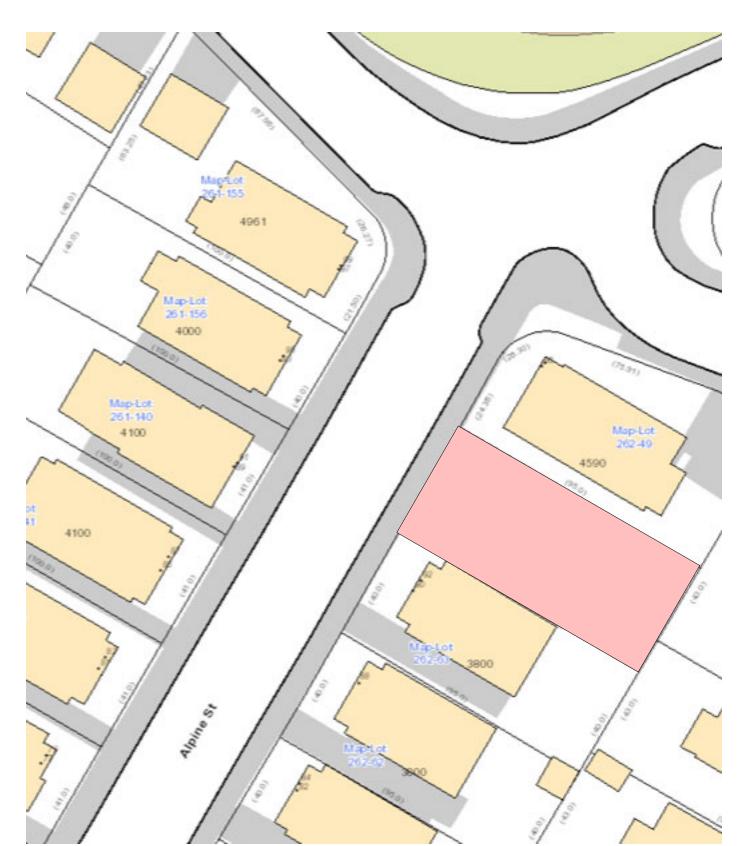


5 P-SITE PLAN 1 1/2" = 1'-0"

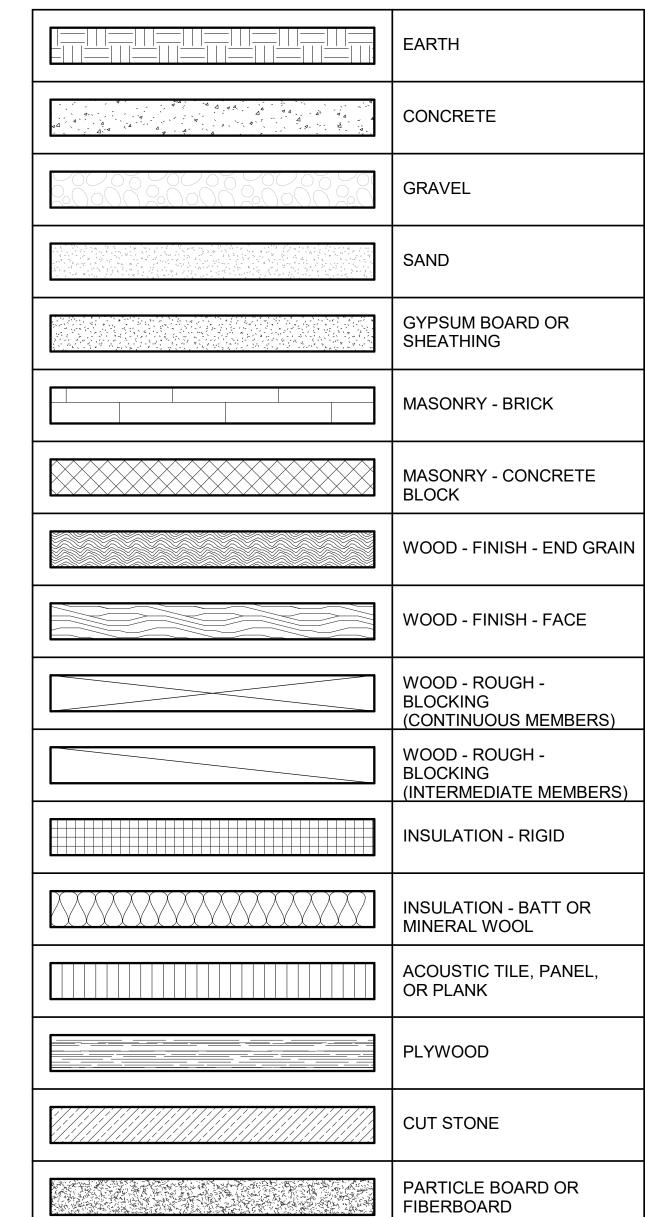

P-MATERIALS [/] 1 1/2" = 1'-0"

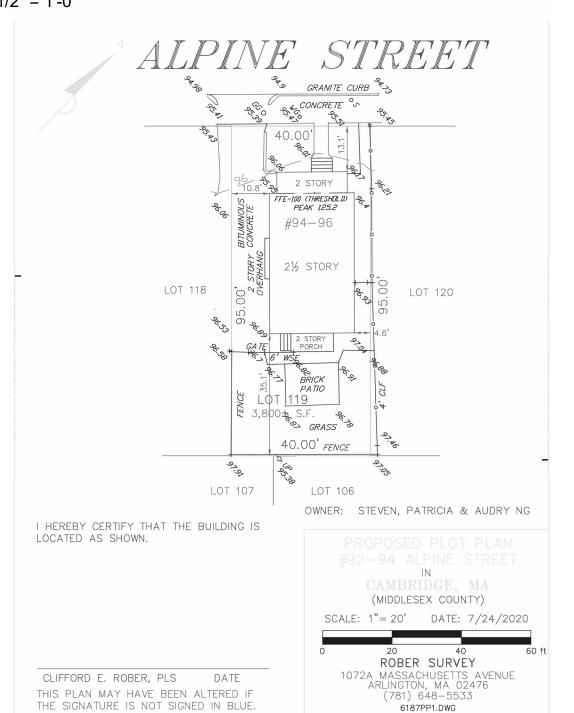

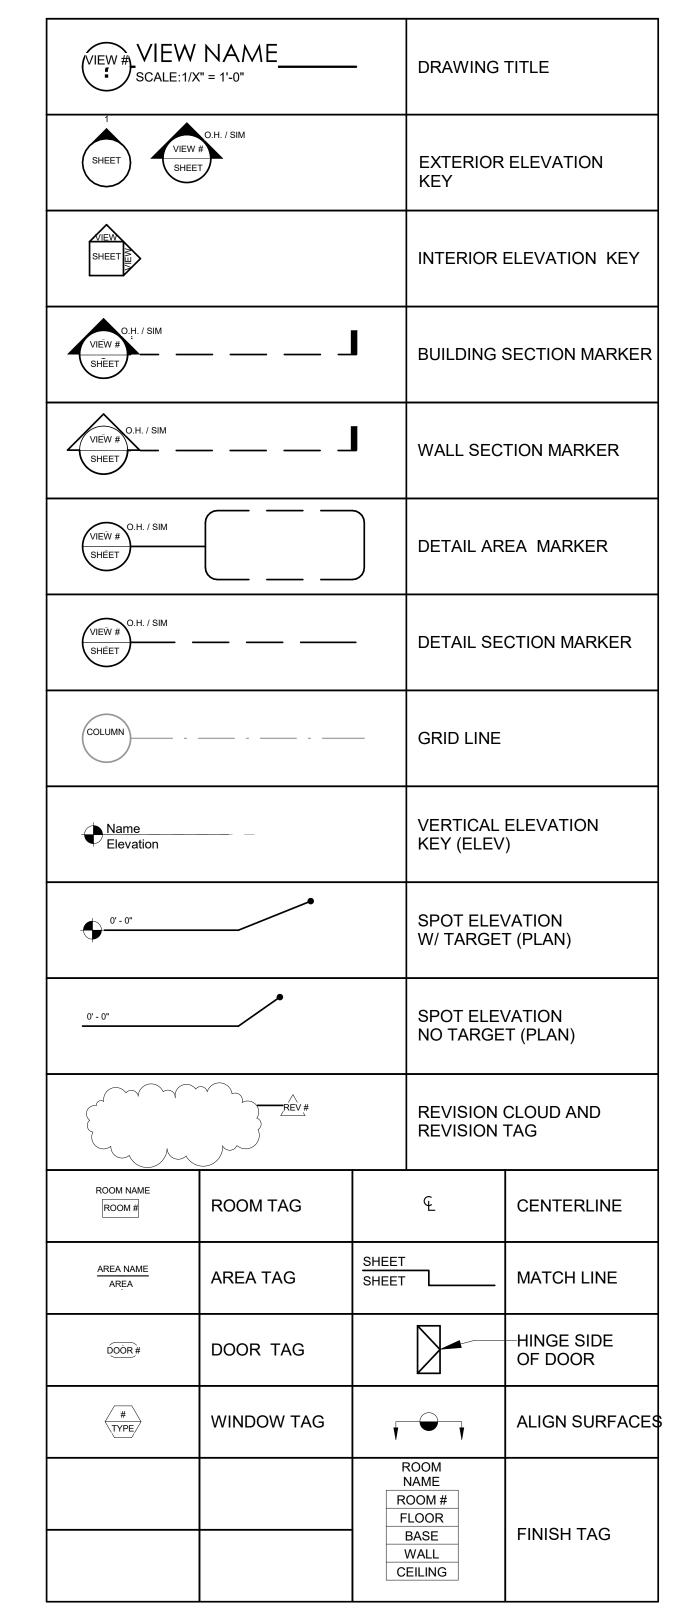

3 P-SYMBOLS 1 1/2" = 1'-0"

1.	ALL WORK SHALL BE CONSIDERED NEW, UNLESS OTHERWISE
	INDICATED.

2. DO NOT SCALE DRAWINGS 3. VERIFY DIMENSIONS, GRADES, BOUNDARIES, AND CONSTRUCTION AND IMMEDIATELY REPORT ANY DISCREPANCIES BEFORE PROCEEDING WITH THE WORK.

4. TO THE EXTENT PRACTICABLE, VERIFY DIMENSIONS AND FIELD CONDITIONS AT THE SITE PRIOR TO THE BID SUBMISSION. CONFLICTS, OMISSIONS AND DISCREPANCIES WITHIN THE CONTRACT DOCUMENTS SHALL BE REPORTED IN WRITING TO THE ARCHITECT, IN ACCORDANCE WITH THE CONTRACT DOCUMENTS, PRIOR TO THE BID SUBMISSION. THE CONTRACTOR WARRANTS, BY TENDERING HIS BID, THAT THE WORK IS BUILDABLE AS SHOWN.

5. LAYOUT ALL WORK WITHIN THE CONFINES OF EXISTING CONSTRUCTION AND RESOLVE DISCREPANCIES PRIOR TO INITIATION OF NEW WORK.

6. ARCHITECT IS NOT RESPONSIBLE FOR CONSTRUCTION THAT IS STARTED PRIOR TO PERMIT BEING ISSUED.

7. DIMENSIONS, NOTES, FINISHES AND FIXTURES SHOWN ON TYPICAL FLOOR PLANS, SECTION OR DETAILS SHALL APPLY TO SIMILAR, SYMMETRICAL OR OPPOSITE HAND PLANS SECTIONS OR DETAILS, UNLESS NOTED OTHERWISE.

8. TYPICAL OR "TYP" SHALL MEAN THAT THE CONDITION IS REPRESENTATIVE FOR SIMILAR CONDITIONS THROUGHOUT, UNLESS NOTED OTHERWISE. DETAILS ARE USUALLY KEYED AND NOTED "TYP" ONLY ONE TIME, WHEN THEY FIRST OCCUR.

9. IMMEDIATELY NOTIFY THE ARCHITECT IN WRITING OF ANY DISCREPANCIES BETWEEN PROJECT MANUAL, LARGE SCALE DRAWINGS, SMALL SCALE DRAWINGS AND DETAILS. THE CONTRACTOR SHALL NOT PROCEED WITH AFFECTED WORK UNTIL ARCHITECT PROVIDES CLARIFICATION.

10. PARTITIONS ARE DIMENSIONED FROM FINISHED FACE TO FINISHED FACE UNLESS OTHERWISE NOTED. DIMENSIONS TO MASONRY ARE TO ACTUAL FINISHED FACE, UNLESS OTHERWISE NOTED.

11. VERIFY THAT DRAWINGS ARE THE LATEST ISSUE PRIOR TO COMMENCING CONSTRUCTION. THE GENERAL CONTRACTOR SHALL BE RESPONSIBLE FOR COMMUNICATING AND DISTRIBUTING ALL CONSTRUCTION DOCUMENT UPDATES TO ALL TRADES.

12. WORK SHALL CONFORM TO THE REQUIREMENTS OF APPLICABLE STATE, FEDERAL AND CITY/COUNTY CODES. STATE AND FEDERAL CODES ARE TO TAKE PRECEDENCE OVER THE DRAWINGS AND SPECIFICATIONS. IF ANY DISCREPANCY IS NOTED, IMMEDIATELY INFORM THE ARCHITECT, PRIOR TO PROCEEDING WITH THE WORK.

13. FILE, OBTAIN AND PAY FEES FOR BUILDING DEPARTMENT PERMITS, CONTROLLED INSPECTIONS, OTHER AGENCY APPROVALS AND PERMITS WHERE REQUIRED, AND FINAL WRITE-OFFS FOR PROJECT COMPLETION. COPIES OF TRANSACTIONS SHALL BE FORWARDED TO THE OWNER OR OWNER'S REPRESENTATIVE.

14. EXECUTE INSPECTIONS NECESSARY TO OBTAIN A CERTIFICATE OF OCCUPANCY.

15. WORK AREA SHALL BE MAINTAINED, CLEAN AND FREE OF DEBRIS AT ALL TIMES.

16. PATCH ALL SURFACES TO MATCH ADJACENT IN A MANNER SUITABLE TO RECEIVE FINISHES.

17. PATCH, REPAIR AND FINISH ALL SURFACES IN AREAS OUTSIDE OF THE EXISTING SCOPE THAT ARE DISTURBED AS A RESULT OF THE WORK.

18. COORDINATE AND PROVIDE BLOCKING AND STRAPPING WITHIN PARTITIONS FOR MILLWORK AND OTHER WALL ATTACHED ITEMS.

19. APPLY, INSTALL, CONNECT, CLEAN AND/OR CONDITION MANUFACTURED ARTICLES, MATERIALS AND/OR EQUIPMENT PER MANUFACTURER'S INSTRUCTIONS. IN CASE OF CONFLICT BETWEEN MANUFACTURER'S INSTRUCTIONS AND THE CONTRACT DOCUMENTS. THE CONTRACTOR SHALL OBTAIN WRITTEN CLARIFICATION FROM THE ARCHITECT BEFORE PROCEEDING.

20. GLASS 18" OR LESS FROM FLOOR LINE OR ADJACENT TO A DOOR SWING SHALL BE SAFETY GLASS AS REQUIRED BY APPLICABLE CODE(S). THE CONTRACTOR SHALL BE RESPONSIBLE FOR PROVIDING." SAFETY GLASS. UNLESS OTHERWISE NOTED. TO COMPLY WITH BUILDING AND LIFE SAFETY CODES, INDUSTRY STANDARDS AND OTHER APPLICABLE FEDERAL AND STATE CODES

21. FLASHING AT EXTERIOR WALLS SHALL BE INSTALLED WITH SEALED JOINTS, SEALED PENETRATIONS AND ENDS TURNED UP. IT SHALL BE FABRICATED AND INSTALLED TO ENSURE THAT MOISTURE IN WALLS WILL BE DIRECTED TO WICKS AND WEEP HOLES.

22. COORDINATE ALL DIMENSIONS CONCERNING DOORS/PANELS/WINDOWS, STAIRS AND THEIR OPENINGS WITH PRODUCT MANUFACTURERS PRIOR TO FABRICATION AND CONSTRUCTION.

23. PROVIDE WEATHERSTRIP AT EXTERIOR DOORS 24. PROVIDE FLASHING AND/OR SEALANT AT OPENINGS IN ROOF OR WALLS TO ENSURE A WEATHERTIGHT BUILDING.

25. LOCATE THERMOSTATS ADJACENT TO SWITCH PLATES WHERE POSSIBLE. VERIFY LOCATION WITH THE ARCHITECT PRIOR TO INSTALLATION TO AVOID CONFLICTS WITH BUILT-INS OR SYSTEMS FURNITURE OR DESIGN ELEMENTS.

26. ALIGN OUTLETS, WALL SWITCHES, TEL-DATA JACKS, ETC.,

INDICATED TO BE MOUNTED AT NEAR EQUIVALENT ELEVATIONS. 27. ALL DOORS SHALL BE LOCATED 6" OFF THE ADJACENT PARTITION, OR ONE MASONRY COURSE AT CMU PARTITIONS, UNLESS NOTED OTHERWISE

28. DURING DEMOLITION AND CONSTRUCTION PROTECT ALL EXISTING FINISHES TO REMAIN.


29. ALL WOOD SHALL BE FSC CERTIFIED.

30. ALL WOOD FRAMING SIZES ARE BASED ON SPF-SS

31. ALL WOOD IN CONTACT WITH CONCRETE OR MASONRY SHALL BE PRESSURE TREATED (P.T.).

32. CORRECT ALL DEFECTS FOUND IN EXISTING BUILDING WHICH INTERFERE WITH NEW CONSTRUCTION. THIS INCLUDES BUT IS NOT LIMITED TO UNEVEN SURFACES AND FINISHES AT GWB.

1 P-GENERAL NOTES 1 1/2" = 1'-0"

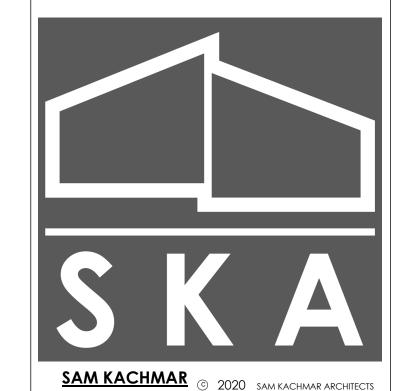

ARCHITECTS (P) 978-270-8441 kachmardesign.com 357 Huron Ave. CAMBRIDGE MA, 02138

REGISTRATIONS:

STRUCTURAL ENGINEER:

Ш

RESIDENC S ALPINE BRIDGE

TRISH

38

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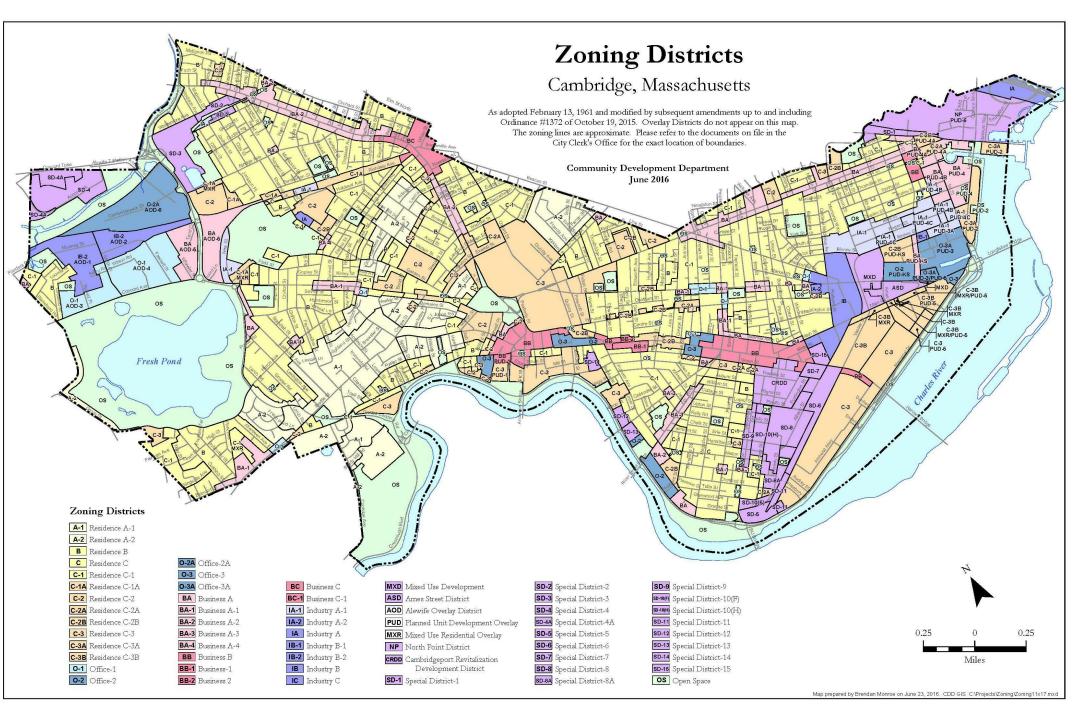
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Author

BZA SUBMISSION SET Project Number Project number

Date 09/11/2020 Drawn by Checker Checked by

Scale 1 1/2" = 1'-0"



<u>DECK</u> 141 SF

P-PROPOSED LEVEL 3

Proposed FAR

DECK

FINISHED

Existing FAR

ATTIC

9 P-EXISTING LEVEL 3 1/16" = 1'-0"

	EXIS	STING FAR		
Level	Area	Comments	Count	Name
EXISTING LEVEL 1	982 SF		1	FINISHED
EXISTING LEVEL 1	118 SF		1	FRONT PORCH
EXISTING LEVEL 1	64 SF		1	BACK DECK
	-			
EXISTING LEVEL 2	958 SF		1	FINISHED
EXISTING LEVEL 2	63 SF		1	DECK
EXISTING LEVEL 2	118 SF		1	PORCH
	'			
PROPOSED LEVEL 3	362 SF		1	ATTIC
	2665 SF		•	'

	Pı	roposed FAR		
Level	Area	Comments	Count	Name
EXISTING LEVEL 1	69 SF		1	PORCH
EXISTING LEVEL 1	1000 SF		1	FINISHED
EXISTING LEVEL 1	84 SF		1	DECK
EXISTING LEVEL 1	55 SF		1	STAIRWELL
	-			
EXISTING LEVEL 2	1073 SF		1	FINISHED
EXISTING LEVEL 2	79 SF		1	DECK
	-			
PROPOSED LEVEL 3	987 SF		1	FINISHED
	3348 SF	'		

ZONE: RESIDENCE B SINGLE- & TWO-FAMILY DETACHED DWELLING TOWNHOUSE DWELLINGS

MAXIMUM FAR: 0.50

FRONT YARD SETBACK: 15' SIDE YARD SETBACK: 7.5' REAR YARD SETBACK: 25'

35' MAXIMUM BUILDING HEIGHT

LOT SIZE: 3,800 SQ. FT.

EXISTING FAR = .70

PROPOSED FAR = .88

PROPOSED FAR INCREASE = .18

EXISTING OPEN SPACE: MINIMUM 40% REQUIREMENT

EXISTING OPEN SPACE: .61

NEW OPEN SPACE: .59

EXISTING RIDGE HEIGHT= 28 - 9"

NEW RIDGE HEIGHT = 34' - 9"

INCREASE ROOF HEIGHT= 6' - 0"

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REGISTRATIONS:

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02138 94-96 ALPINE ST. CAMBRIDGE, MA NG RESIDENCE


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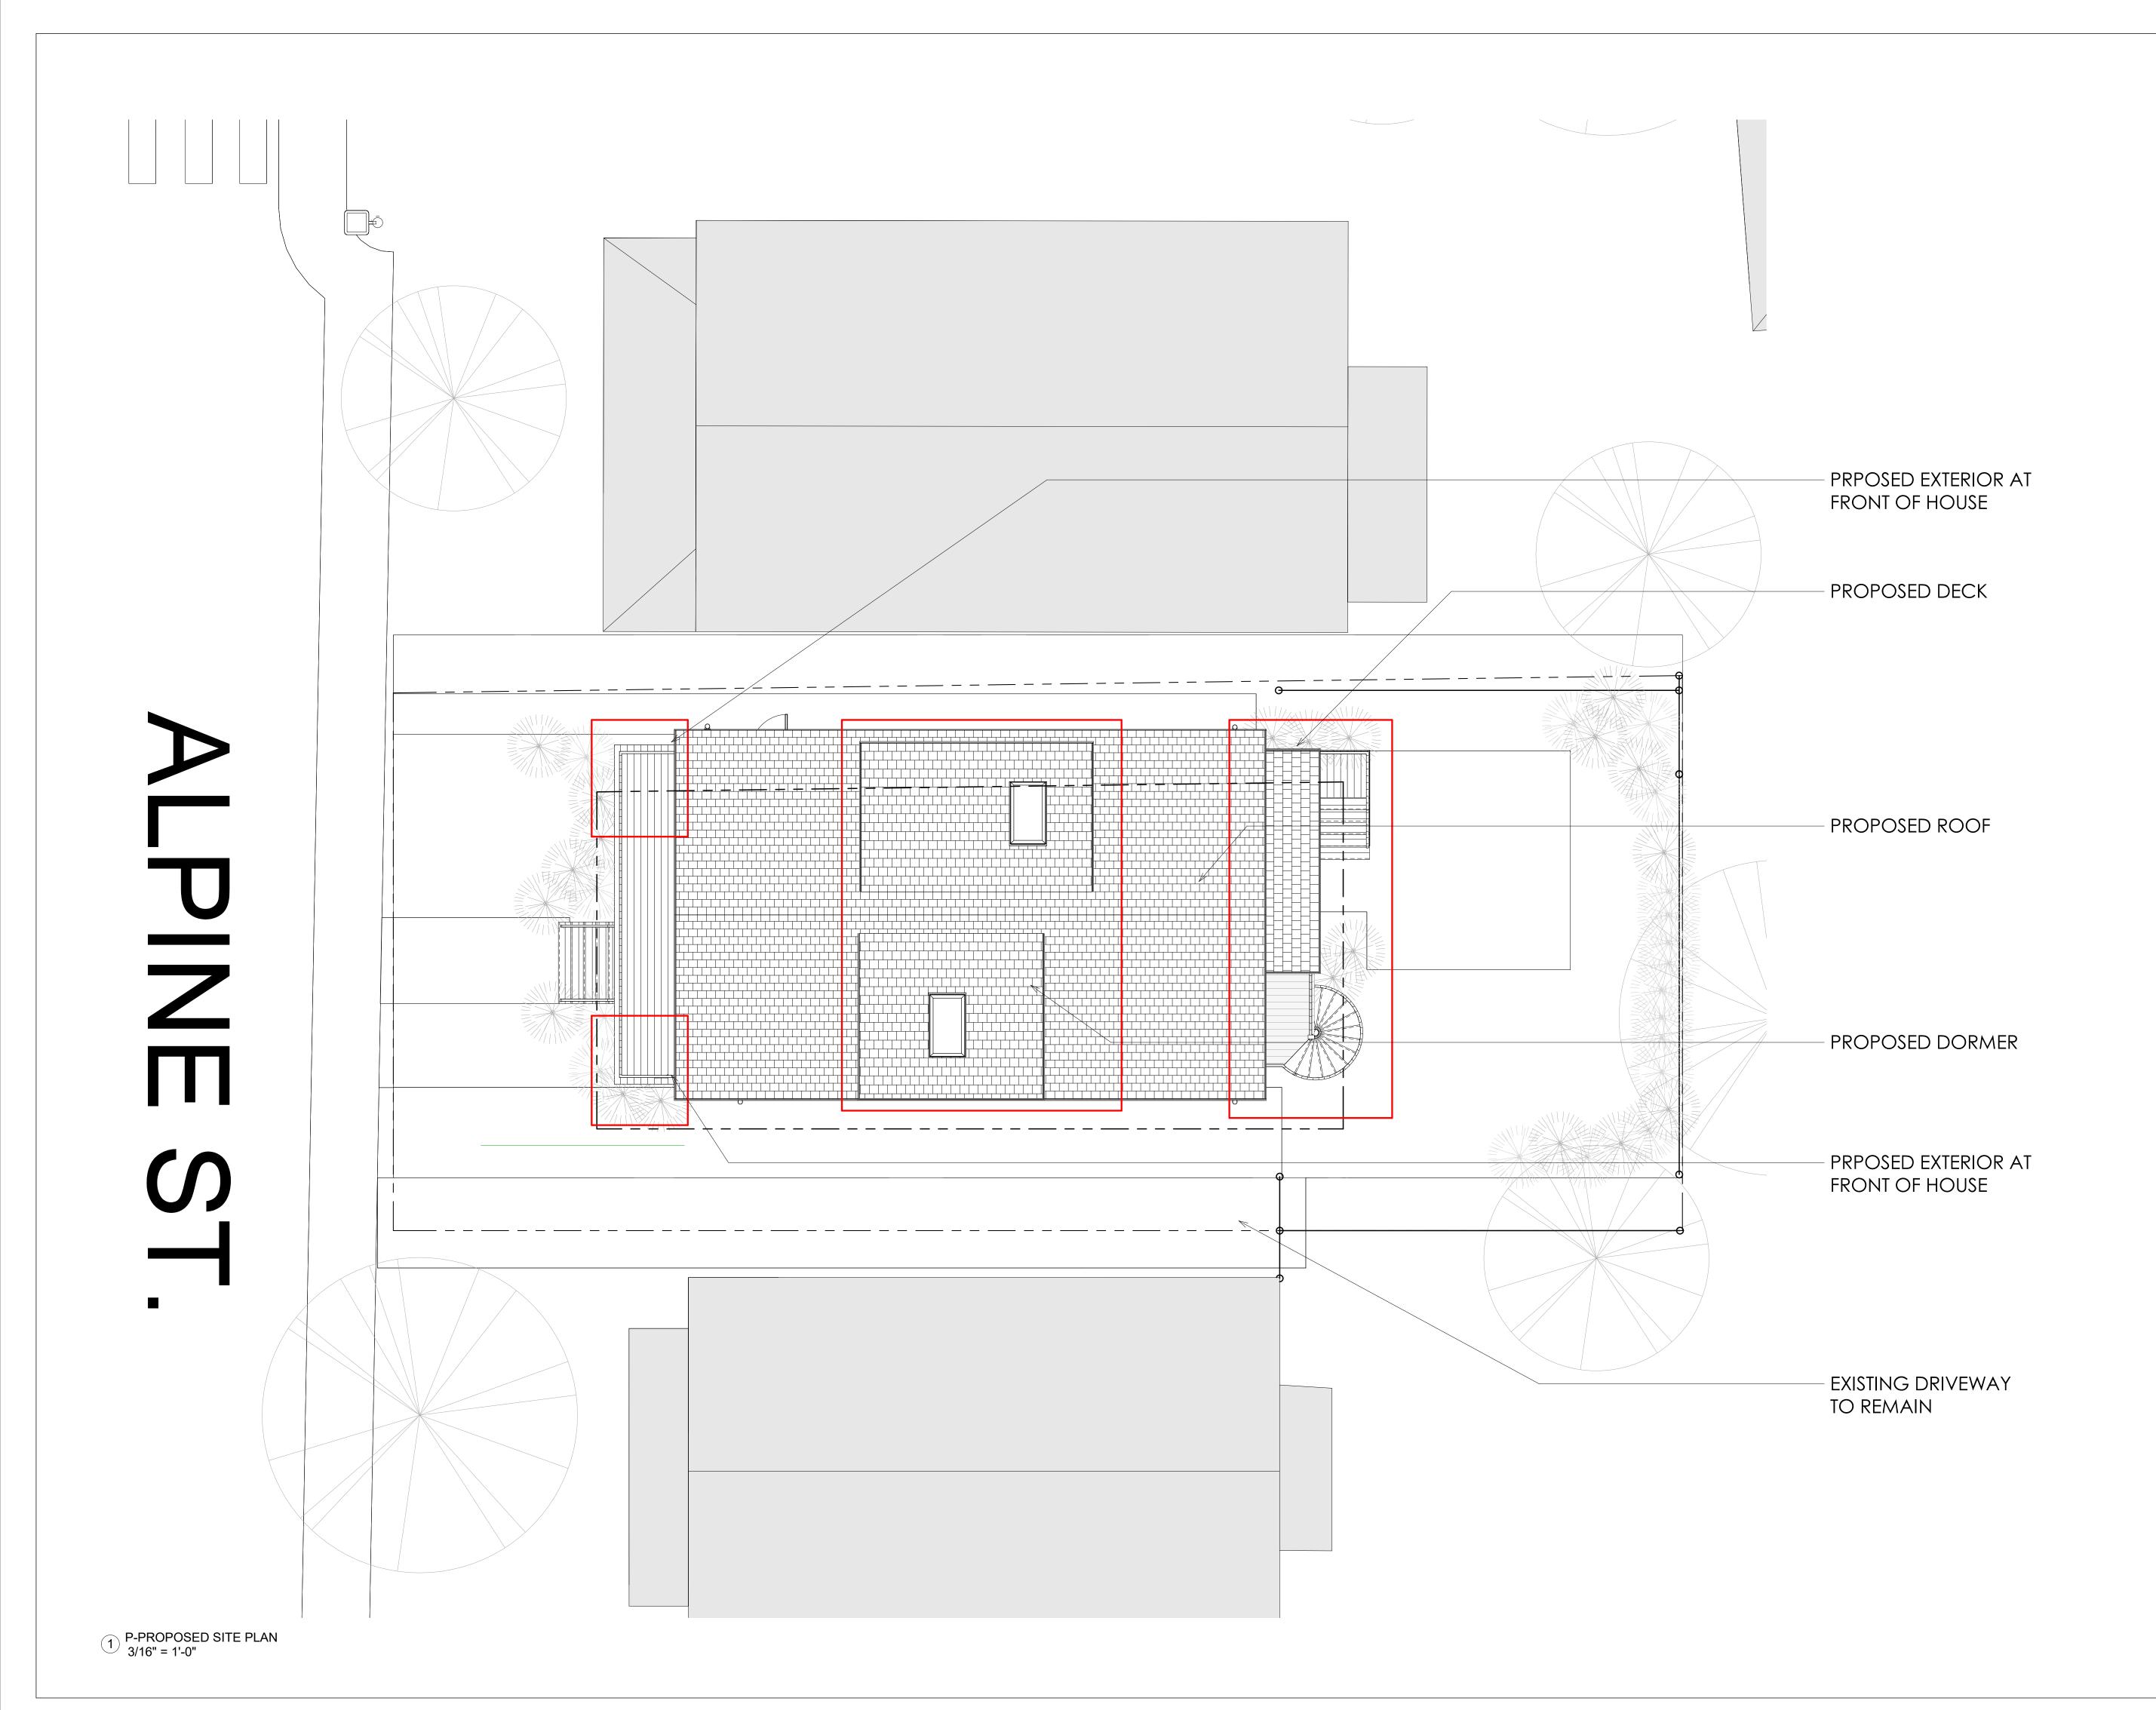
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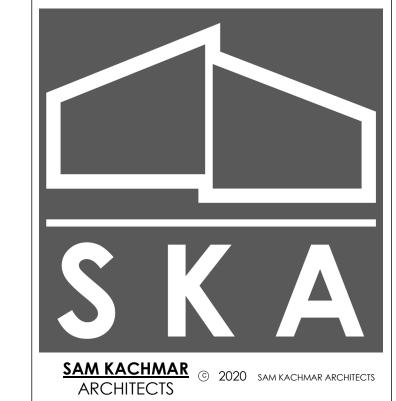
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LANDSCAPE PLAN

& TRISH NG

NG RESIDENCE 94-96 ALPINE ST. CAMBRIDGE, MA 02138

Project Status BZA SUBMISSION SET

Project number Project Number

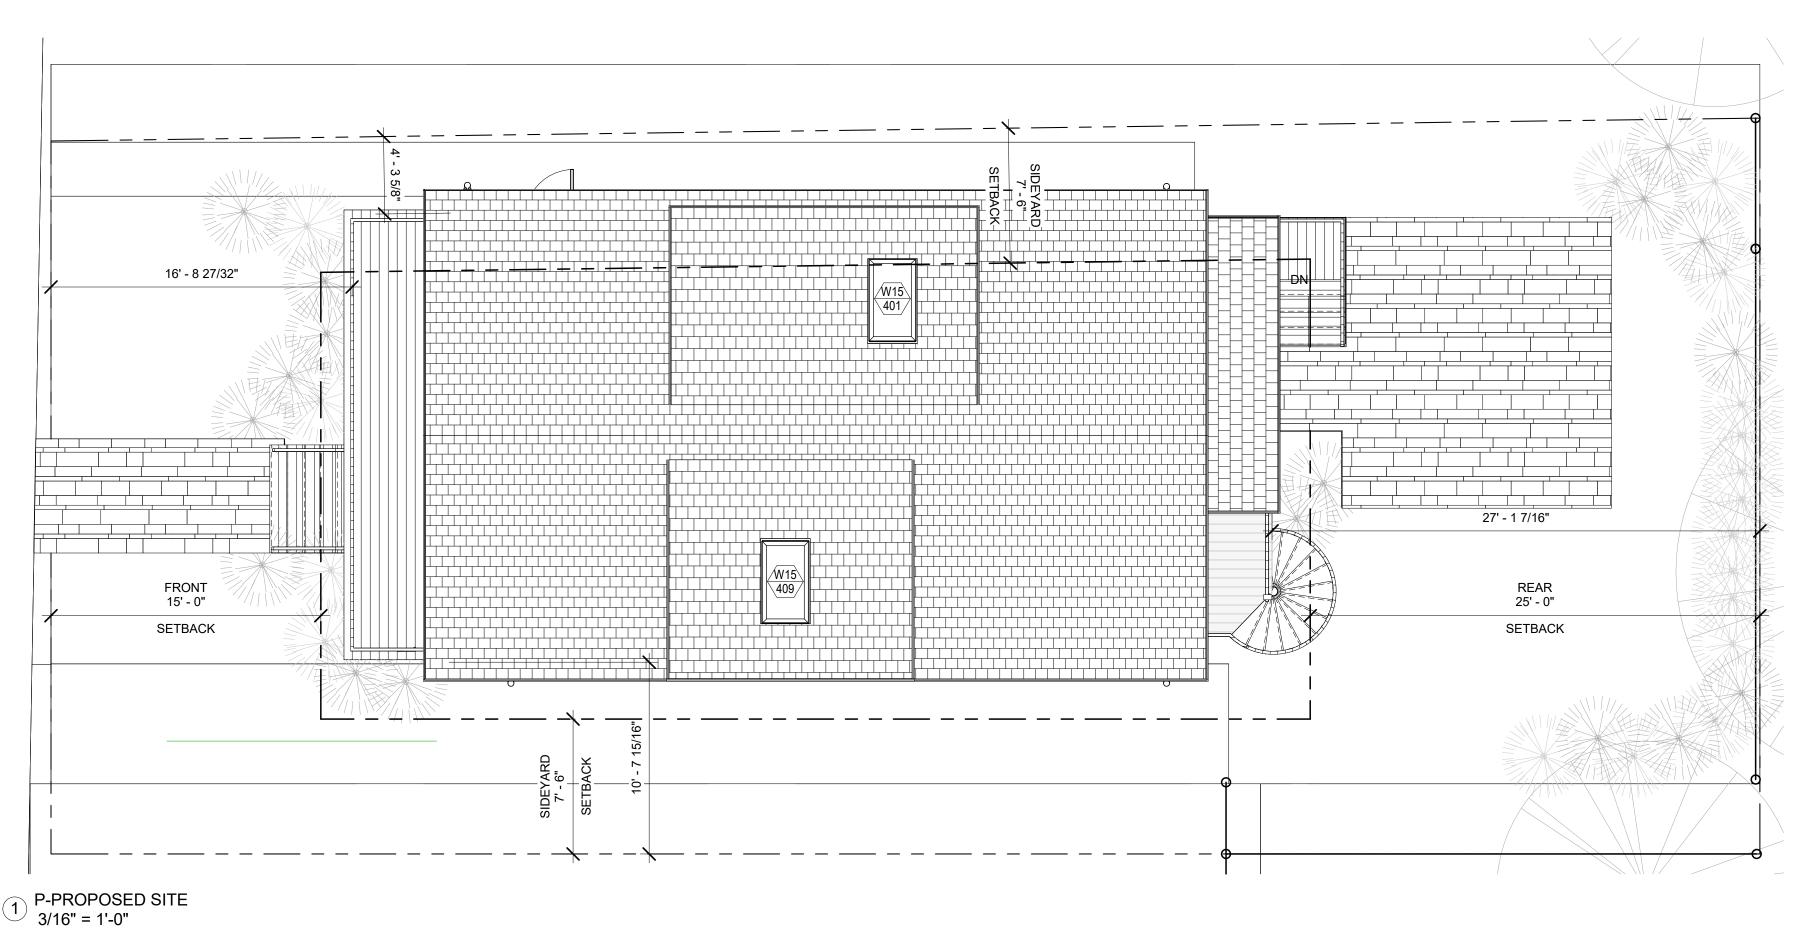
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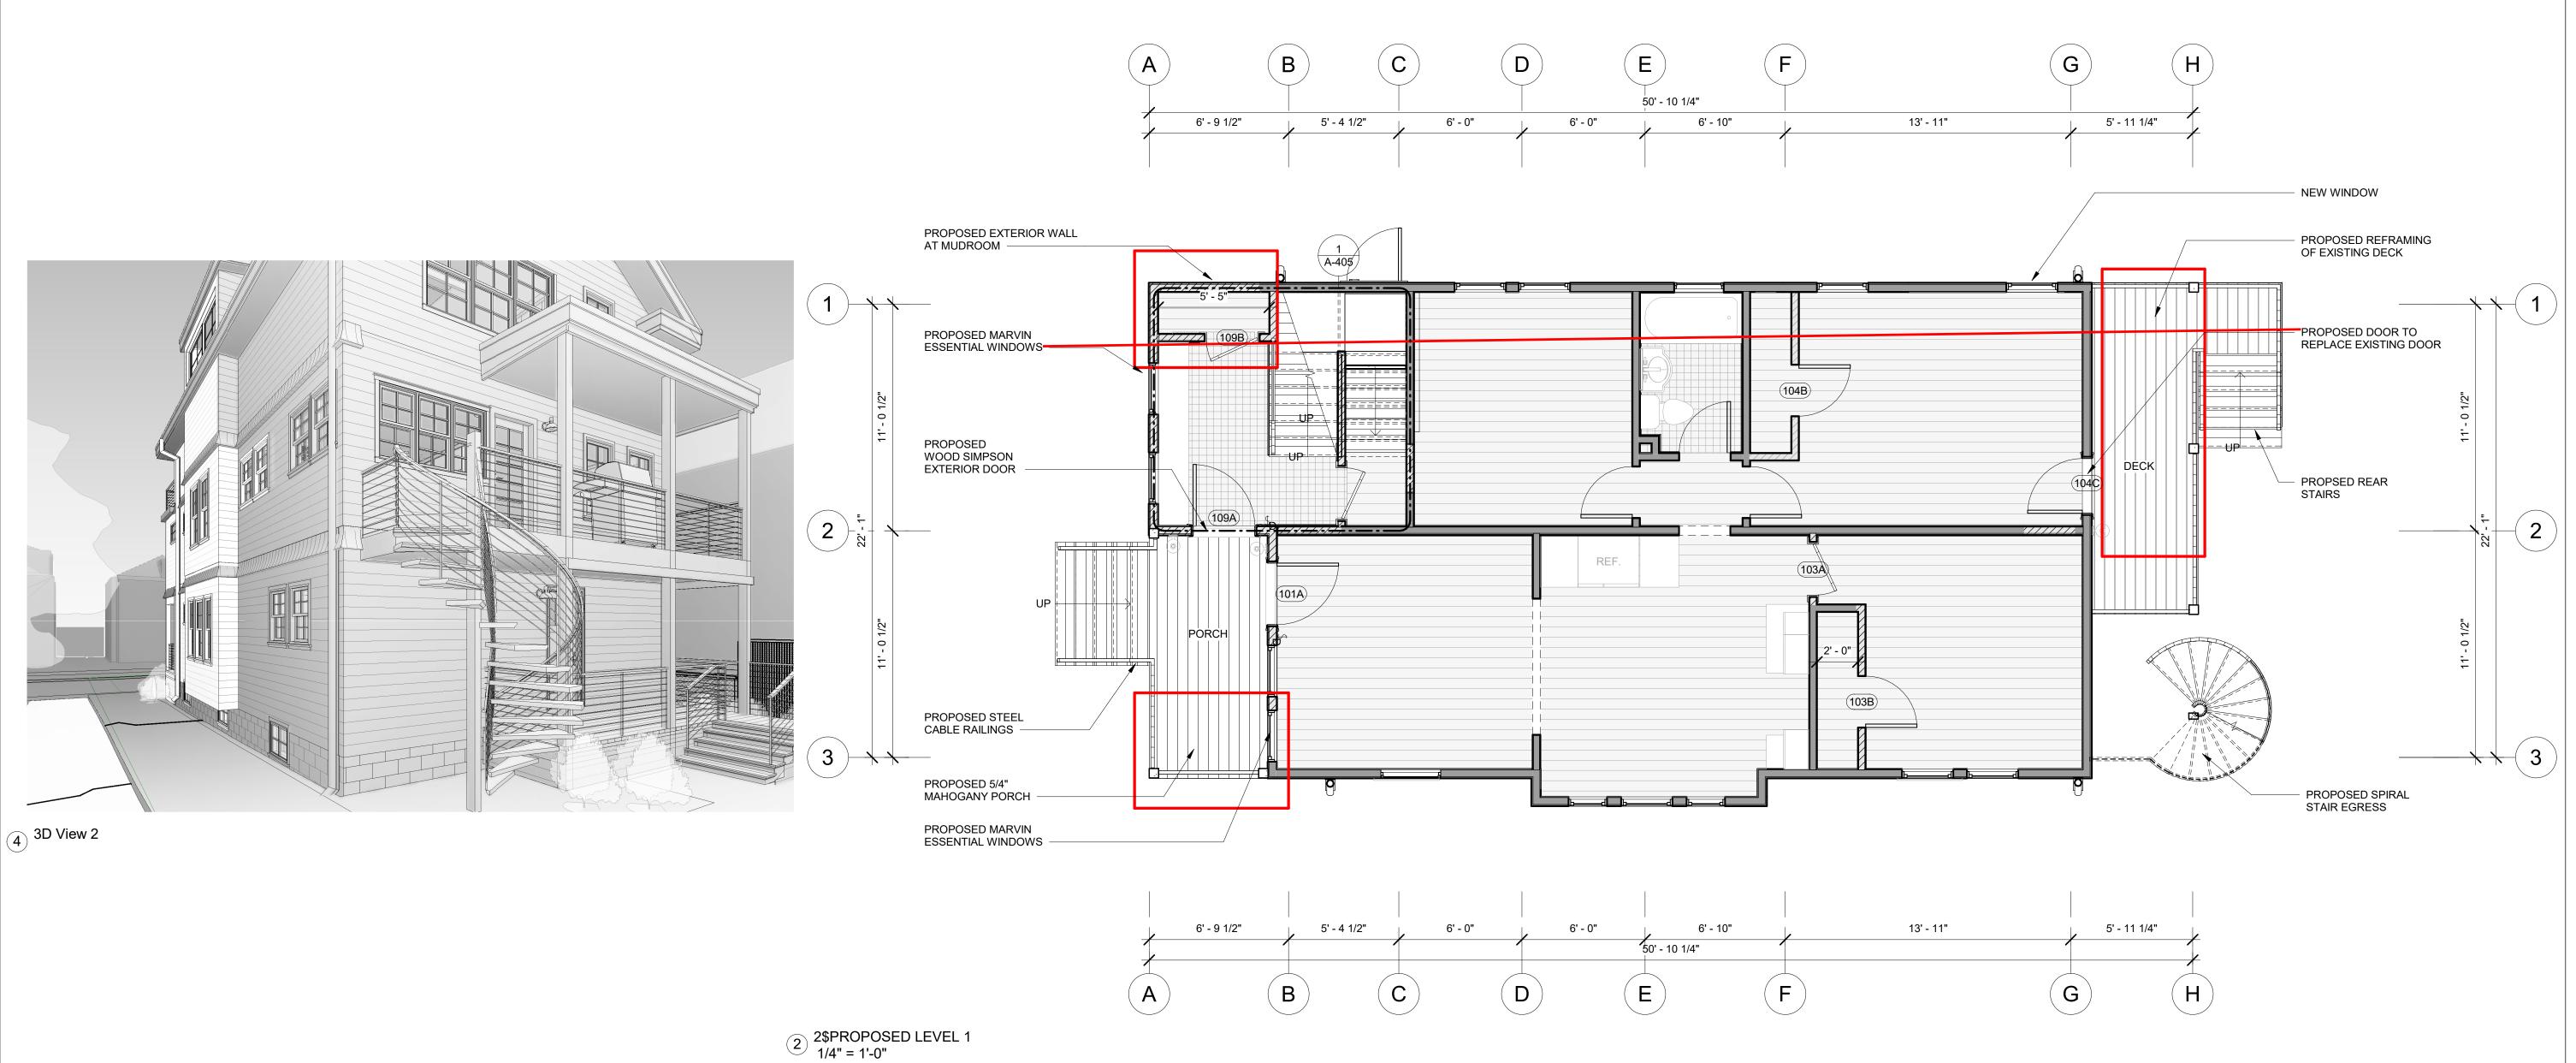
Drawn by Author

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P-003

Scale 3/16" = 1'-0"



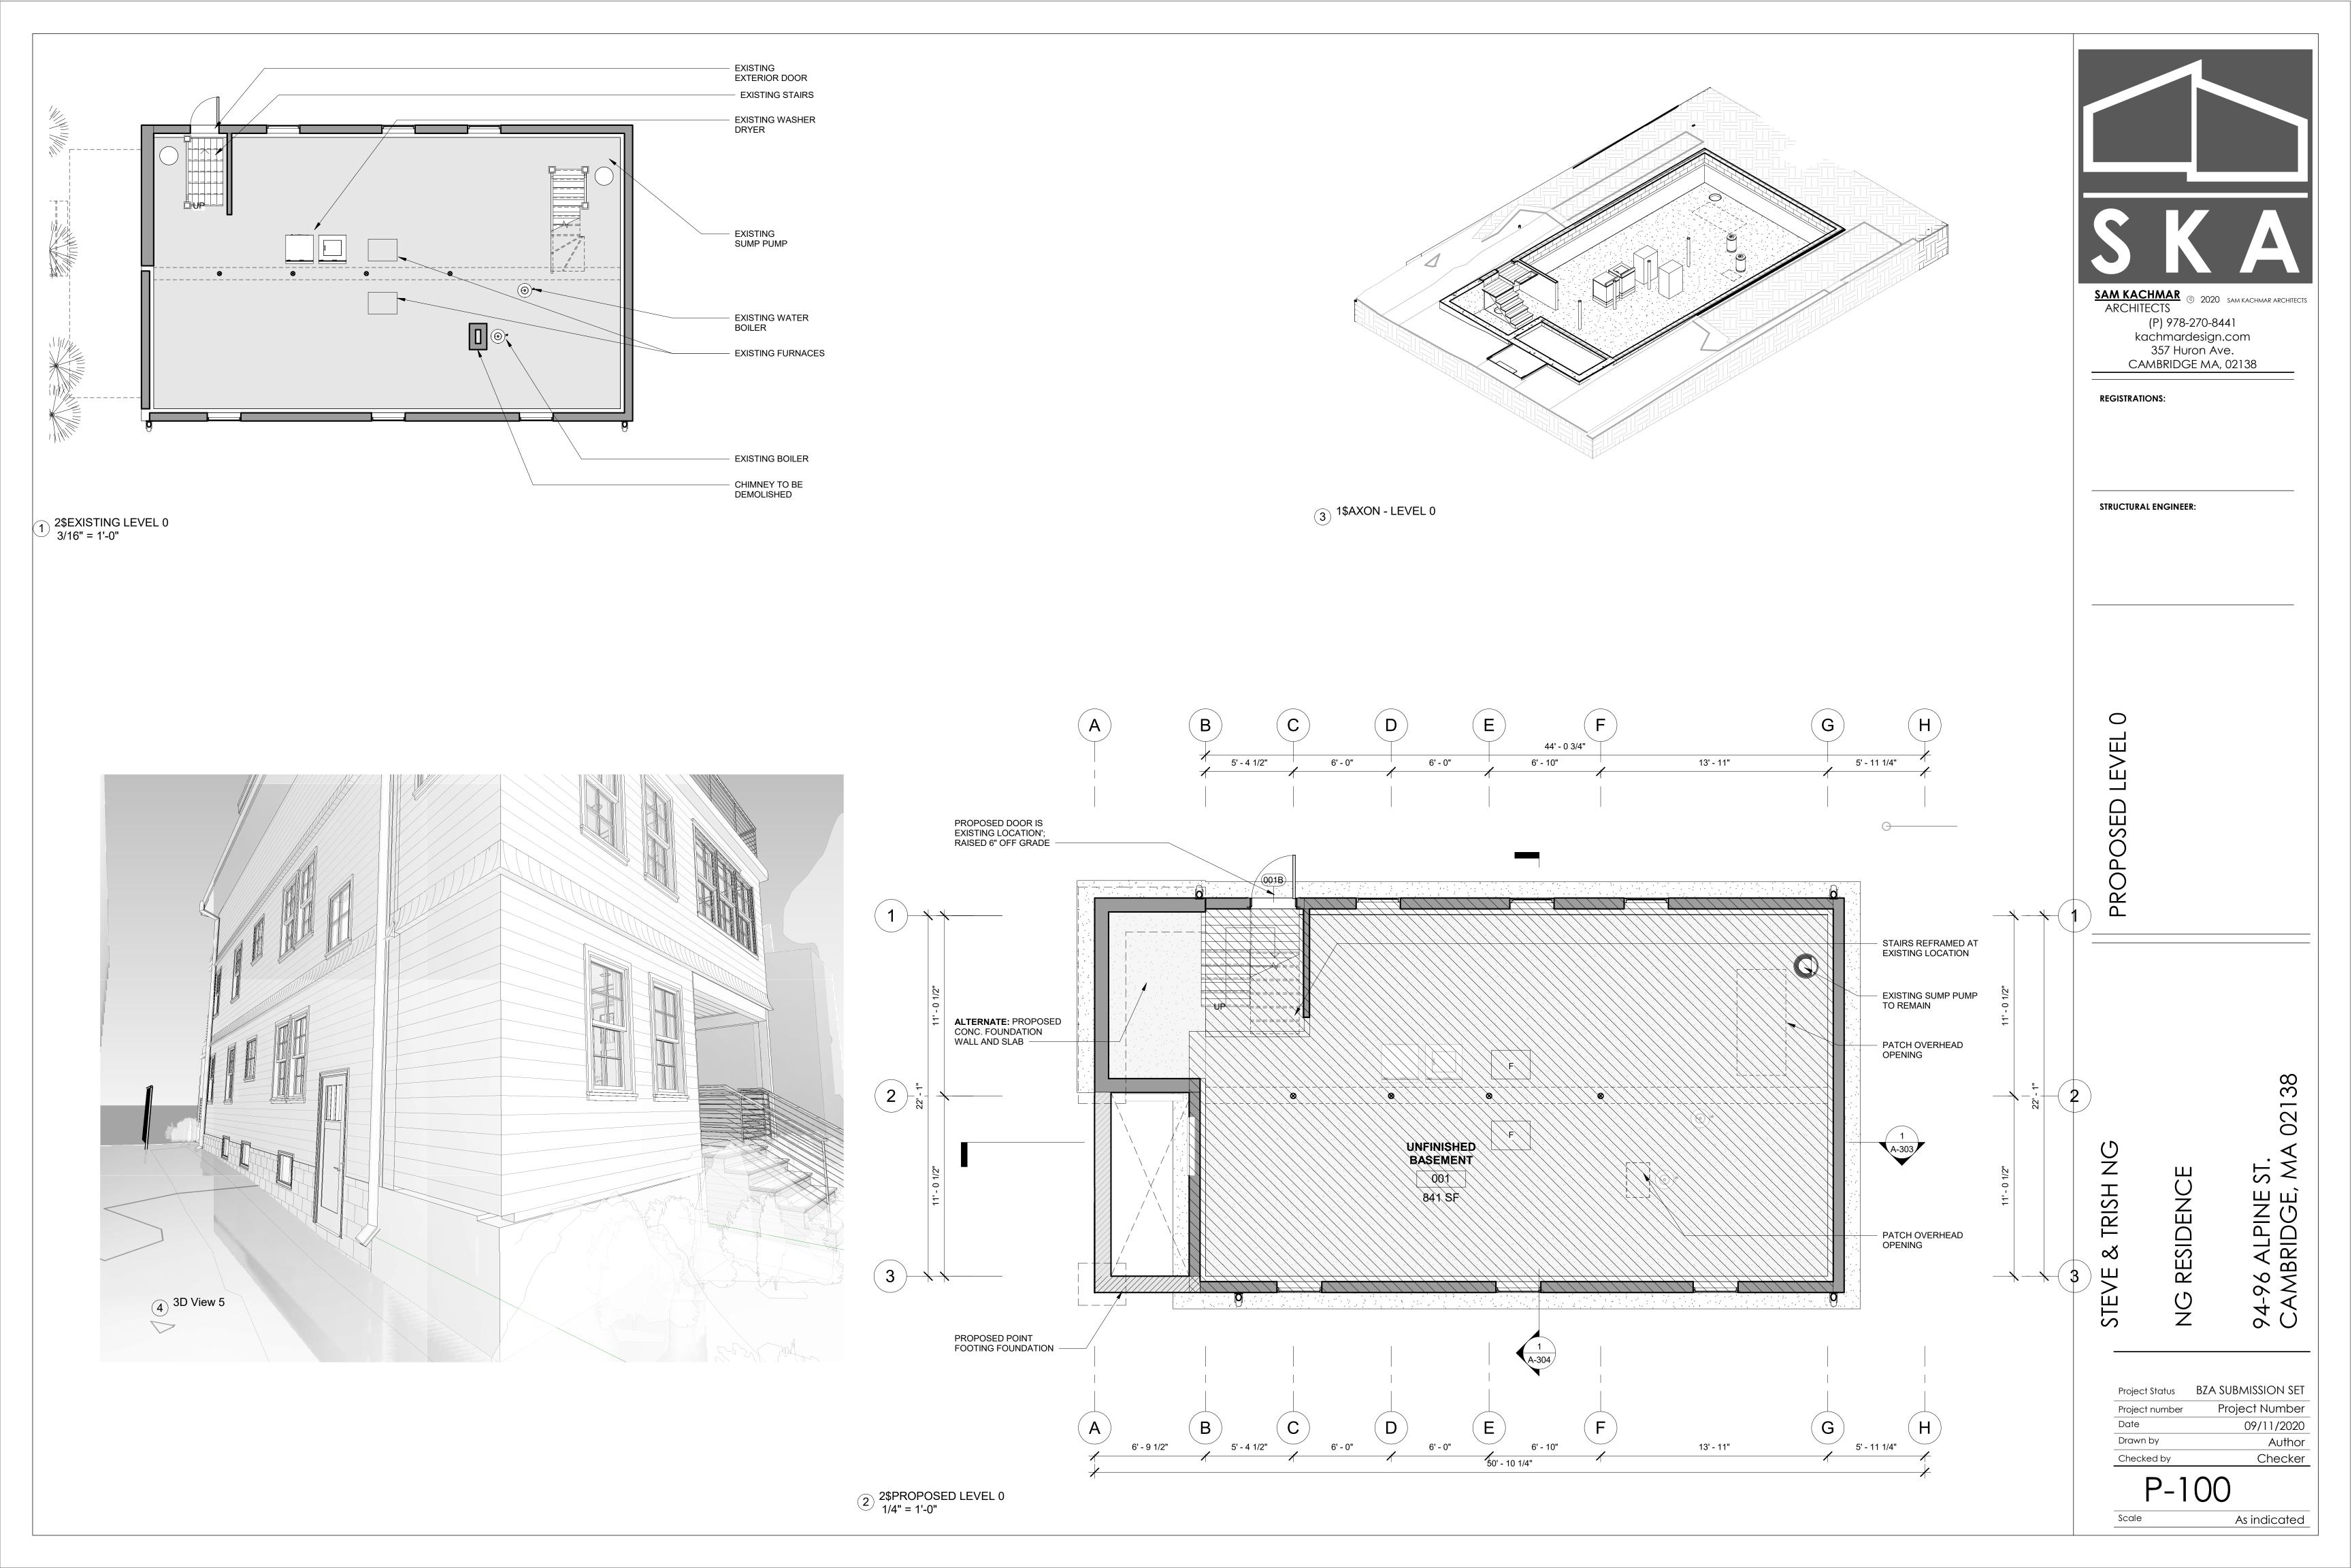


1 2\$EXISTING LEVEL 1 3/16" = 1'-0"

BEDROOM

LIVING ROOM

BEDROOM

4

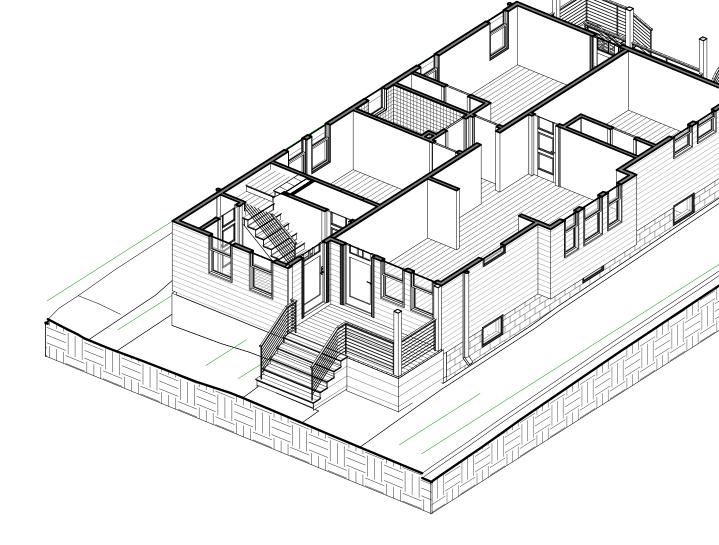

3 1\$AXON - PROPOSED LEVEL 1

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REGISTRATIONS:

STRUCTURAL ENGINEER:

TRISH NG

STEVE

02138


94-96 ALPINE ST. CAMBRIDGE, MA

Project Status BZA SUBMISSION SET Project Number Project number Date 09/11/2020 Drawn by Author Checker Checked by


NG RESIDENCE

Scale As indicated

2\$PROPOSED LEVEL 2 1/4" = 1'-0"

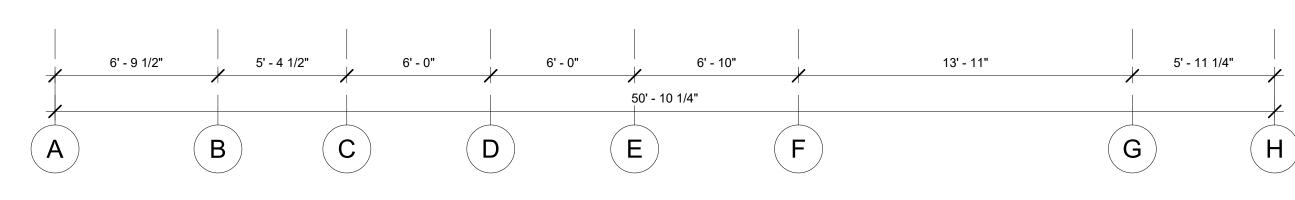




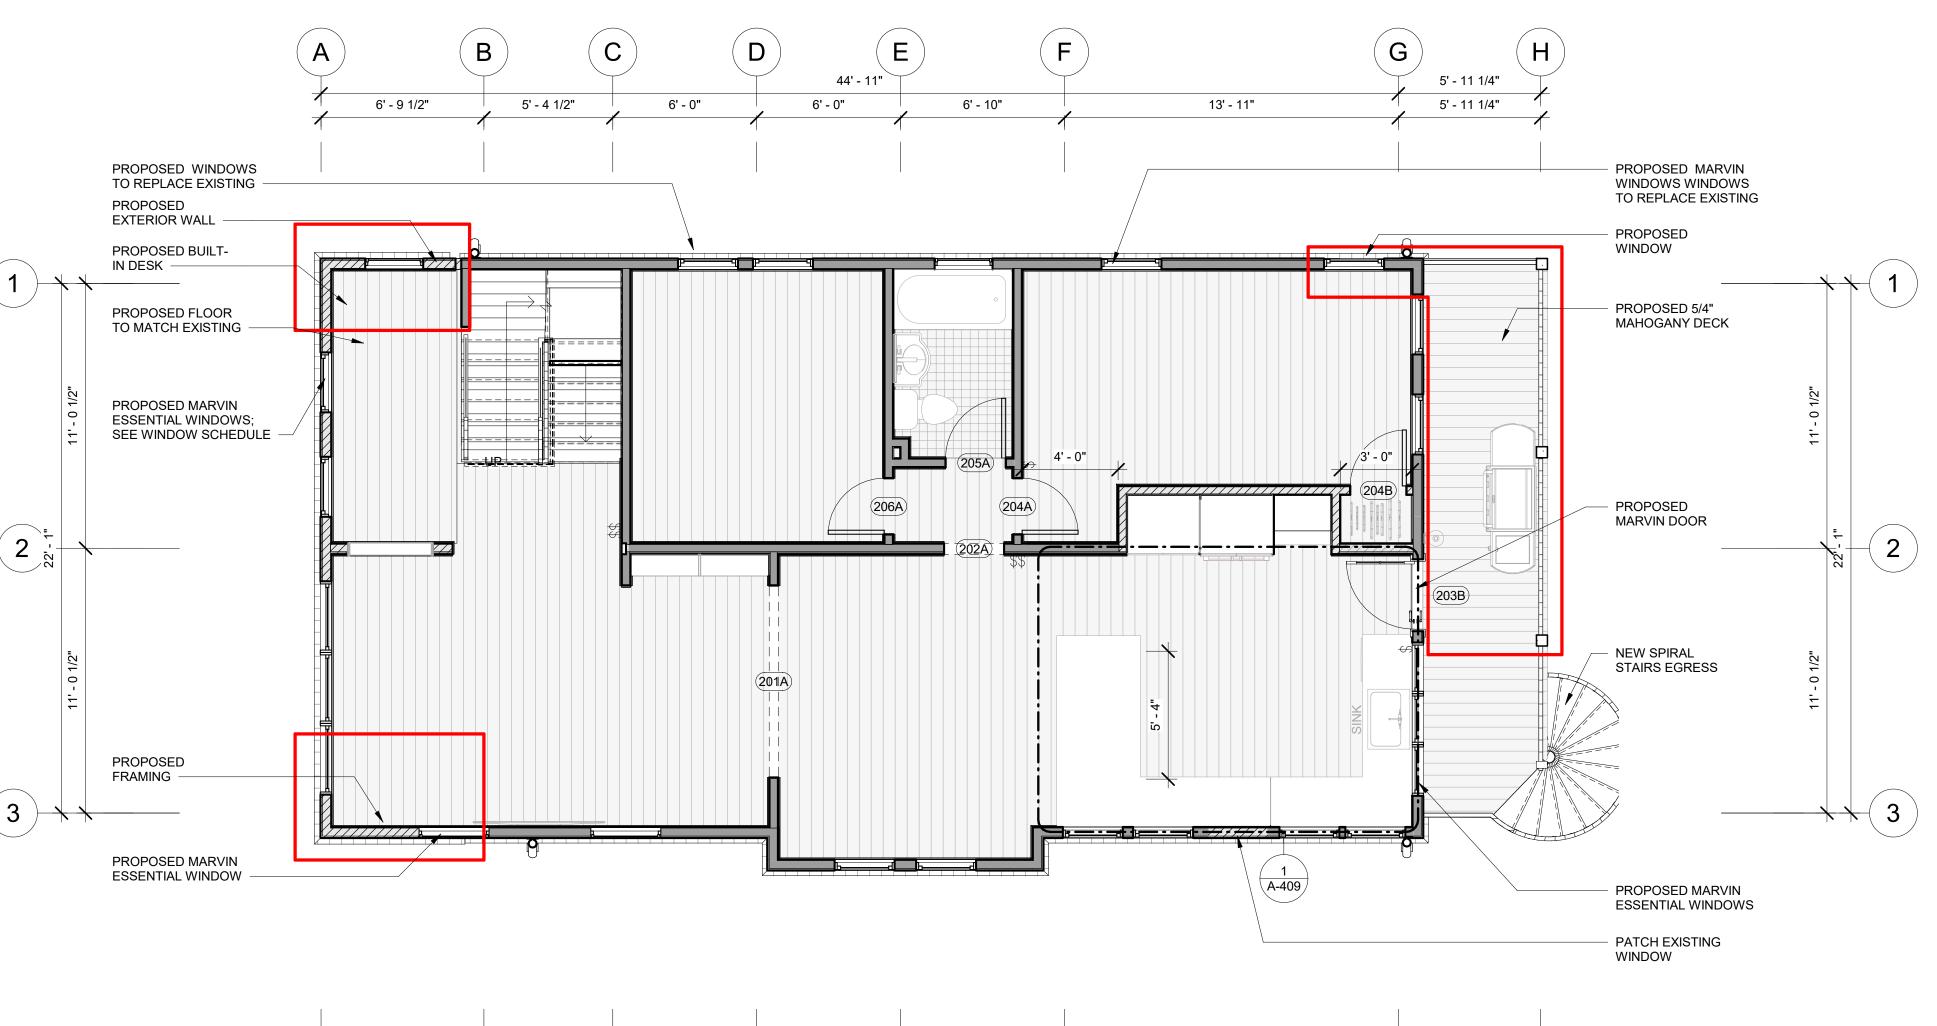

2\$EXISTING LEVEL 2 3/16" = 1'-0"



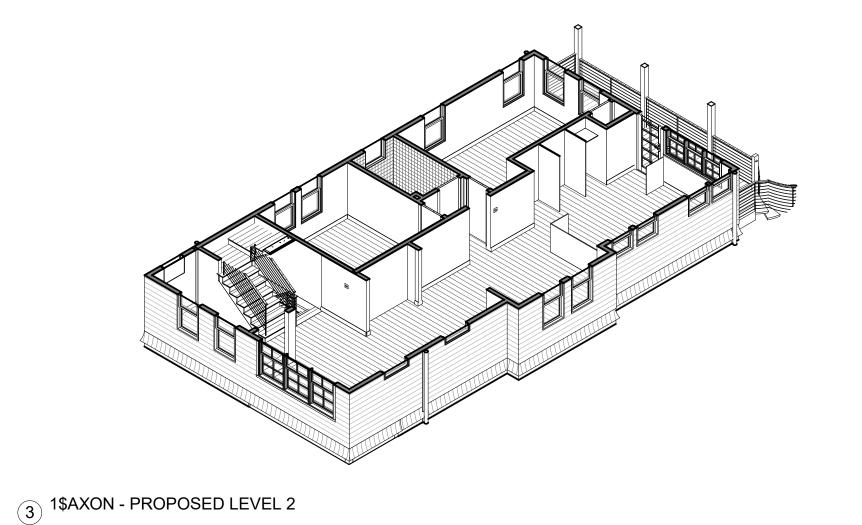

STEVE & TRISH NG

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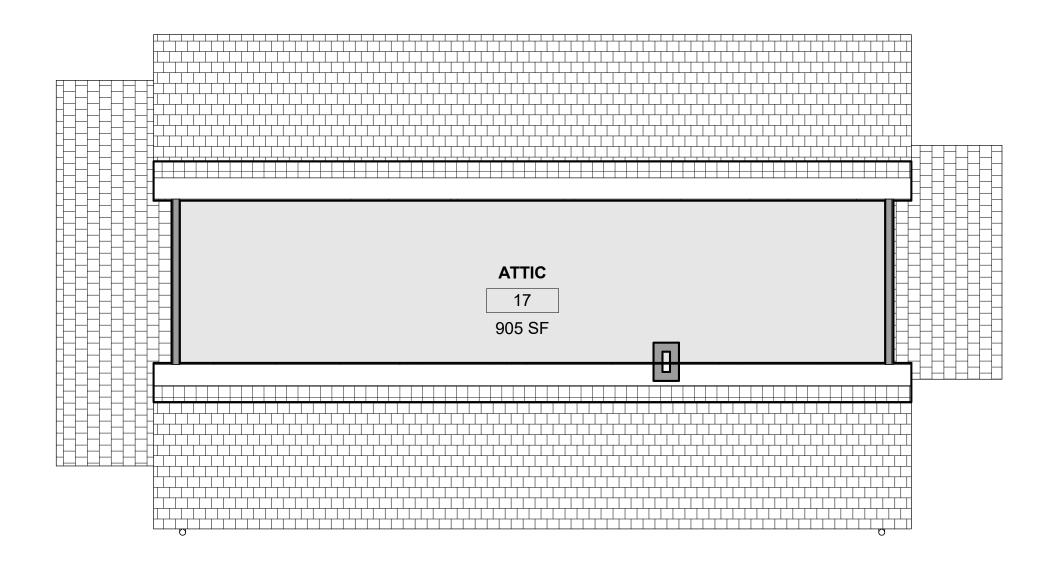
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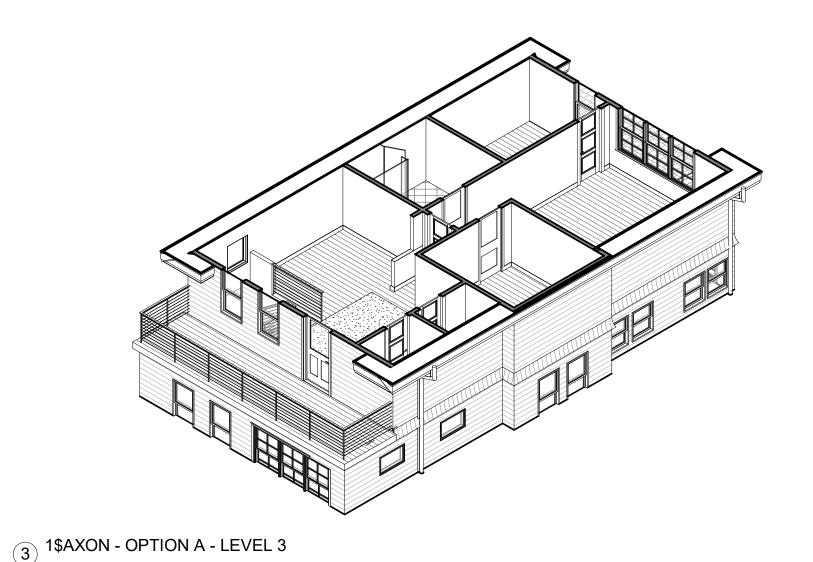
STRUCTURAL ENGINEER:

Project Status BZA SUBMISSION SET Project Number Project number Date 09/11/2020 Drawn by Author Checker

Checked by P-102

Scale As indicated







1\$PROPOSED LEVEL 4 3/16" = 1'-0"





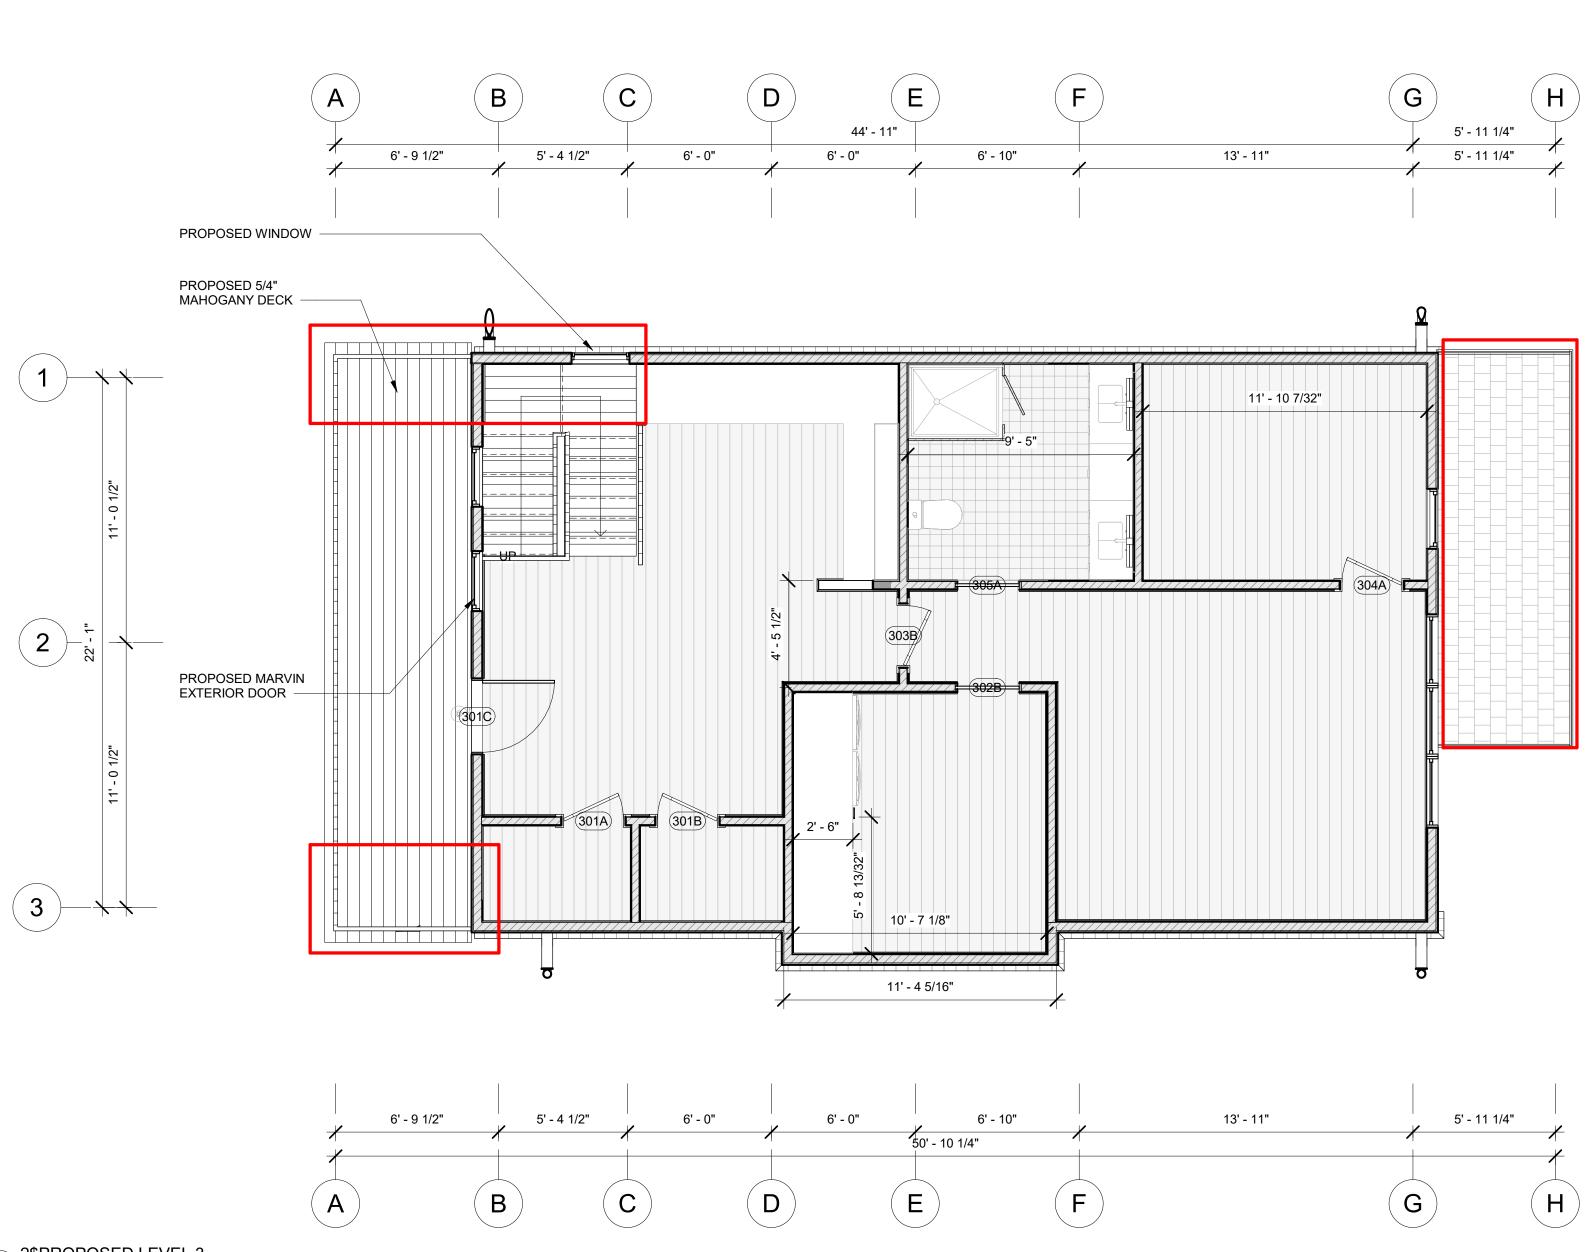

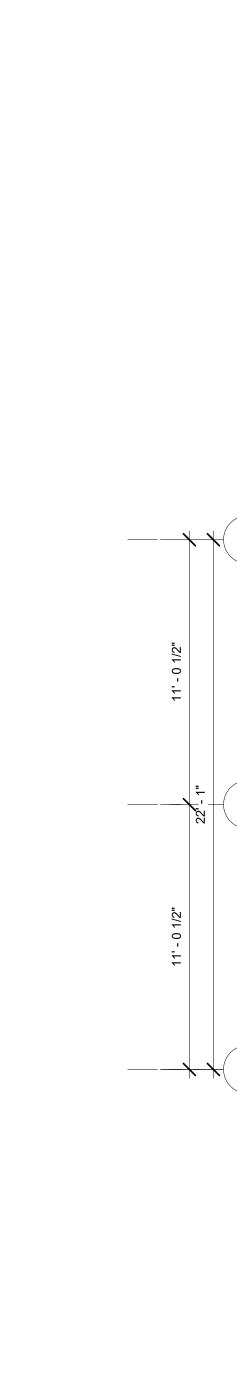

94-96 ALPINE ST. CAMBRIDGE, MA 02138 NG RESIDENCE

STEVE & TRISH NG

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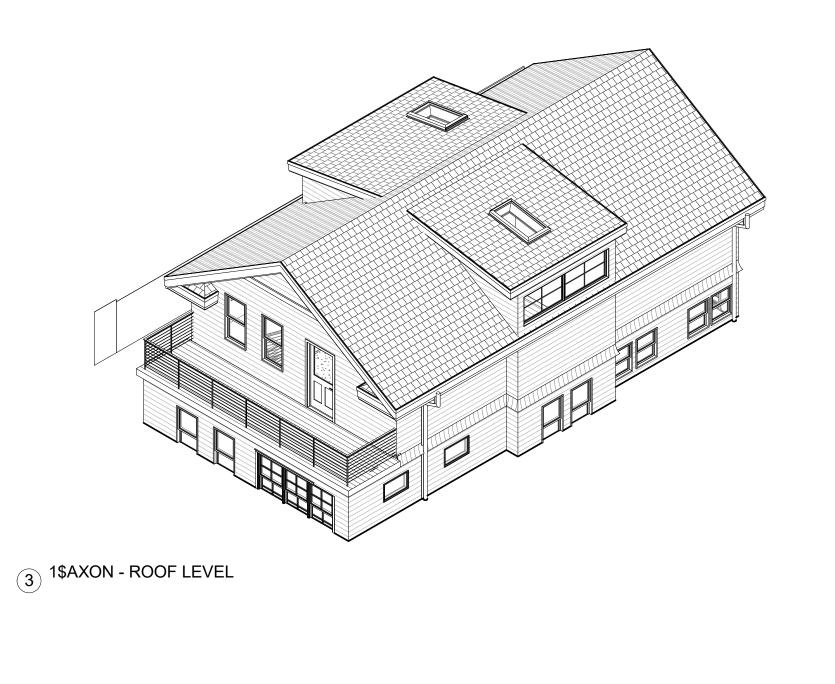
P-103


Scale As indicated

2\$PROPOSED LEVEL 3 1/4" = 1'-0"

1 1\$EXISTING ROOF RIDGE 3/16" = 1'-0"





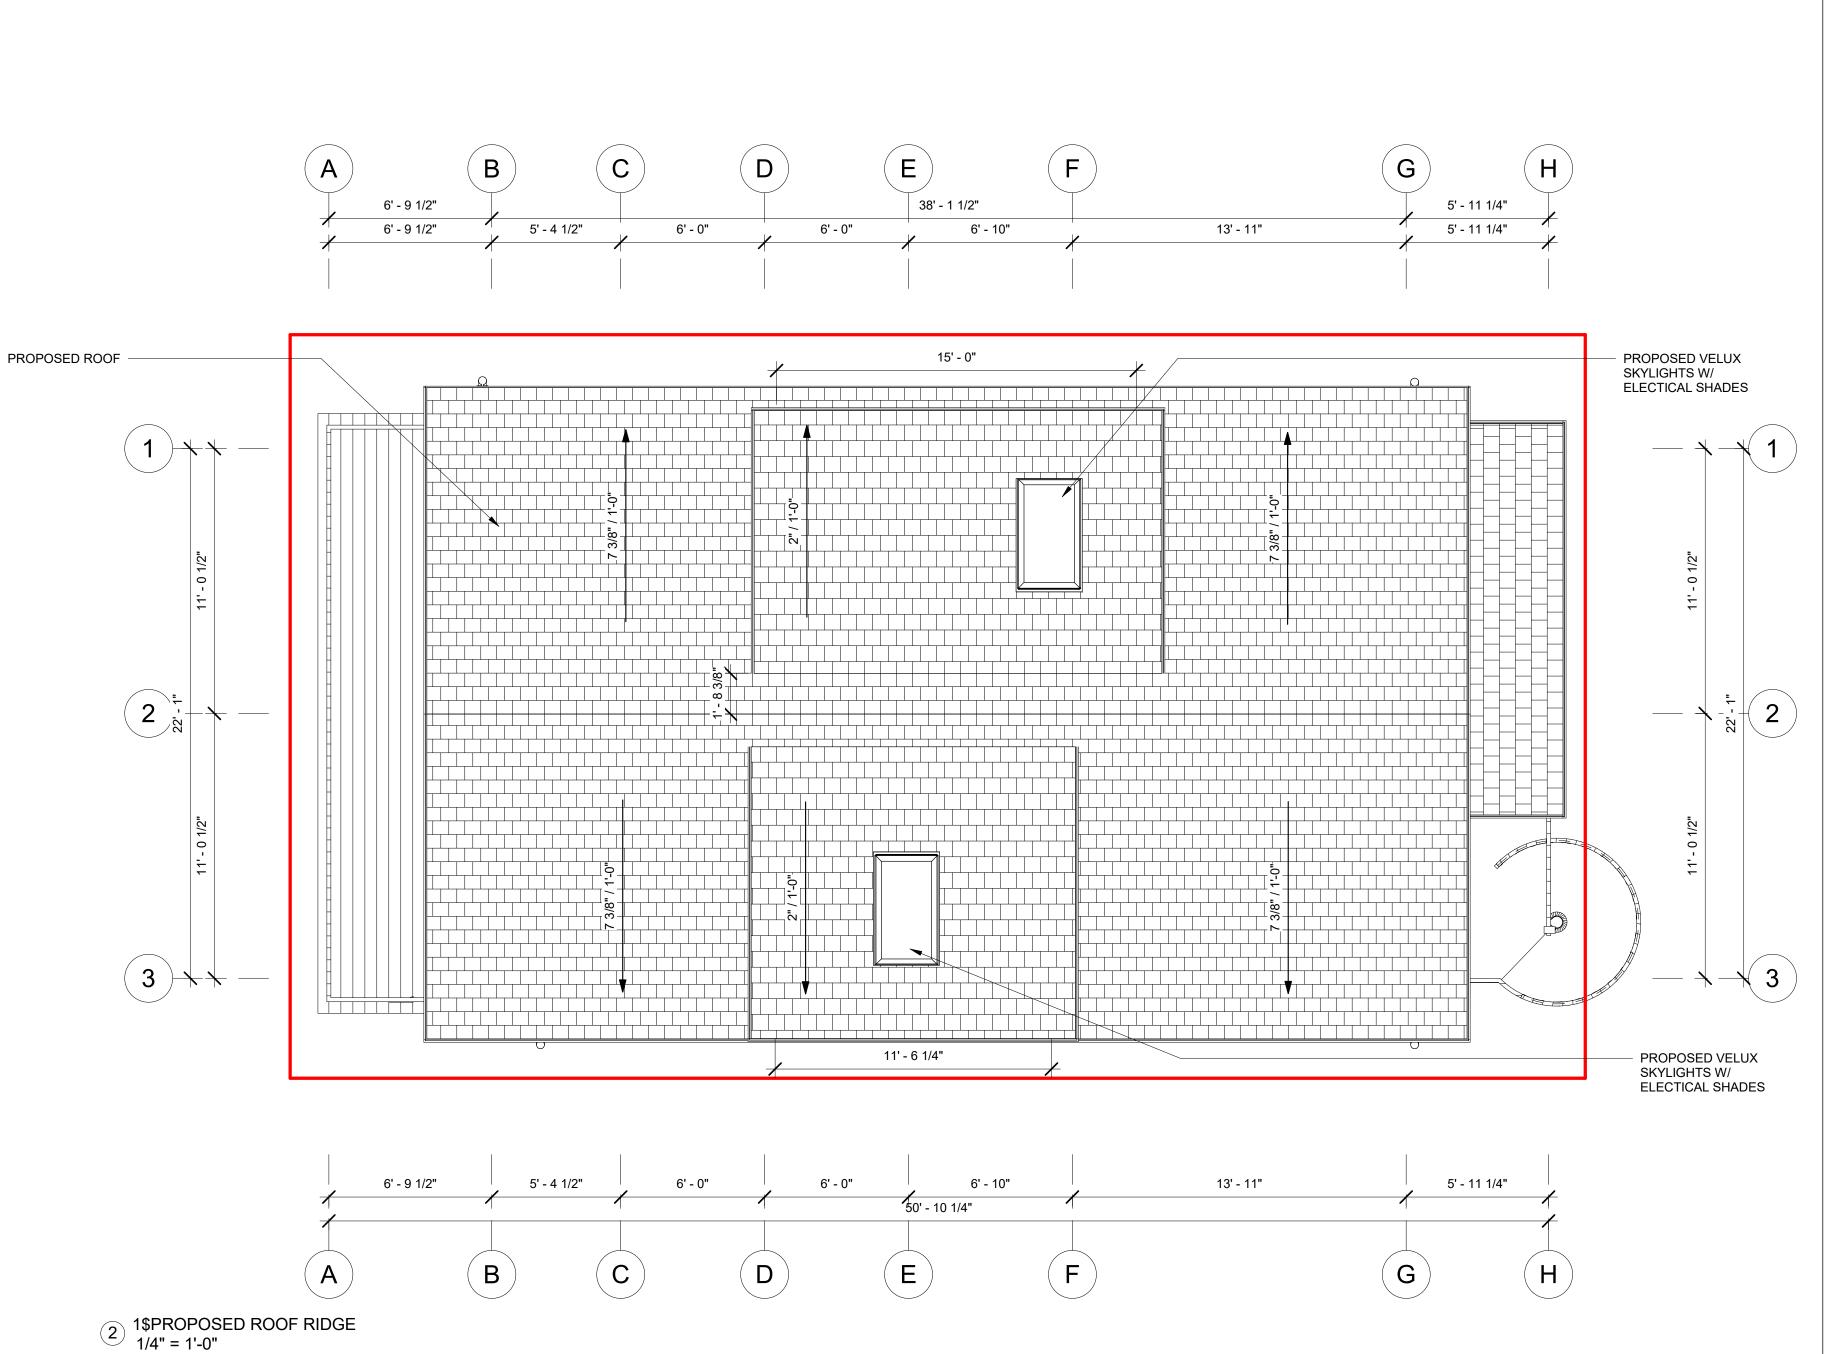



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& TRISH NG

STEVE

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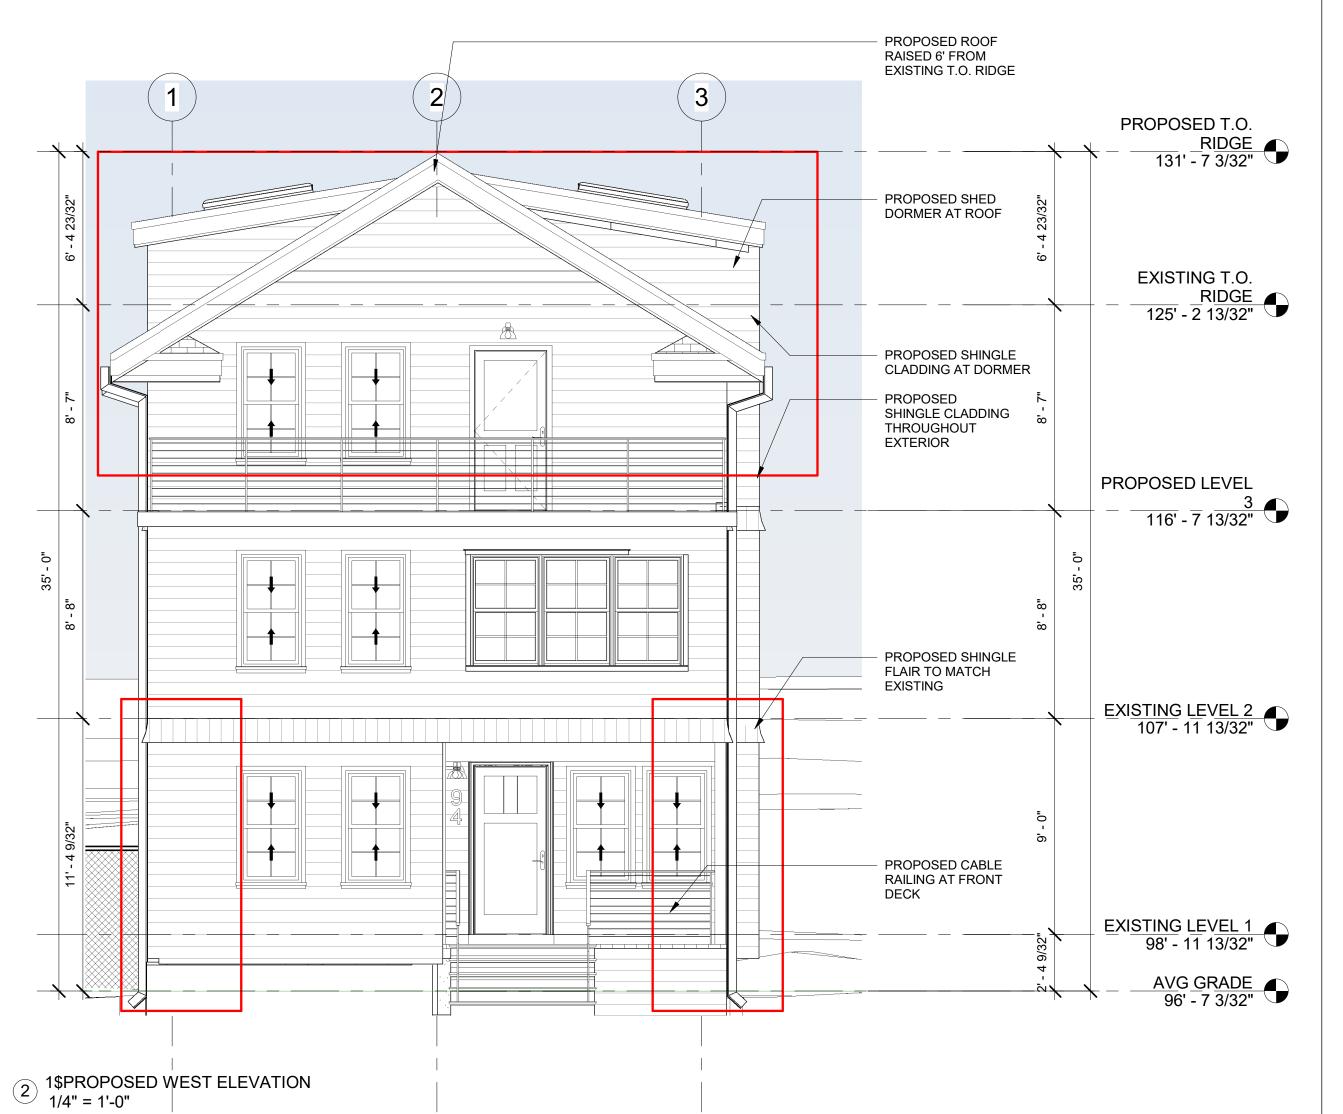
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Scale As indicated



3 PERSPECTIVE FRONT ELEVATION







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Project Status BZA SUBMISSION SET Project Number Project number Date 09/11/2020 Drawn by Author Checker

Checked by P-200

NG RESIDENCE

1/4'' = 1'-0''



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Project Status BZA SUBMISSION SET Project Number 09/11/2020 Drawn by Author Checker Checked by

P-201

NG RESIDENCE

1/4" = 1'-0"



EXISTING T.O.

RIDGE
125' - 2 13/32"


PROPOSED LEVEL

116' - 7 13/32" •

EXISTING LEVEL 2 107' - 11 13/32"

EXISTING LEVEL 1 98' - 11 13/32"

AVG GRADE 96' - 7 3/32"

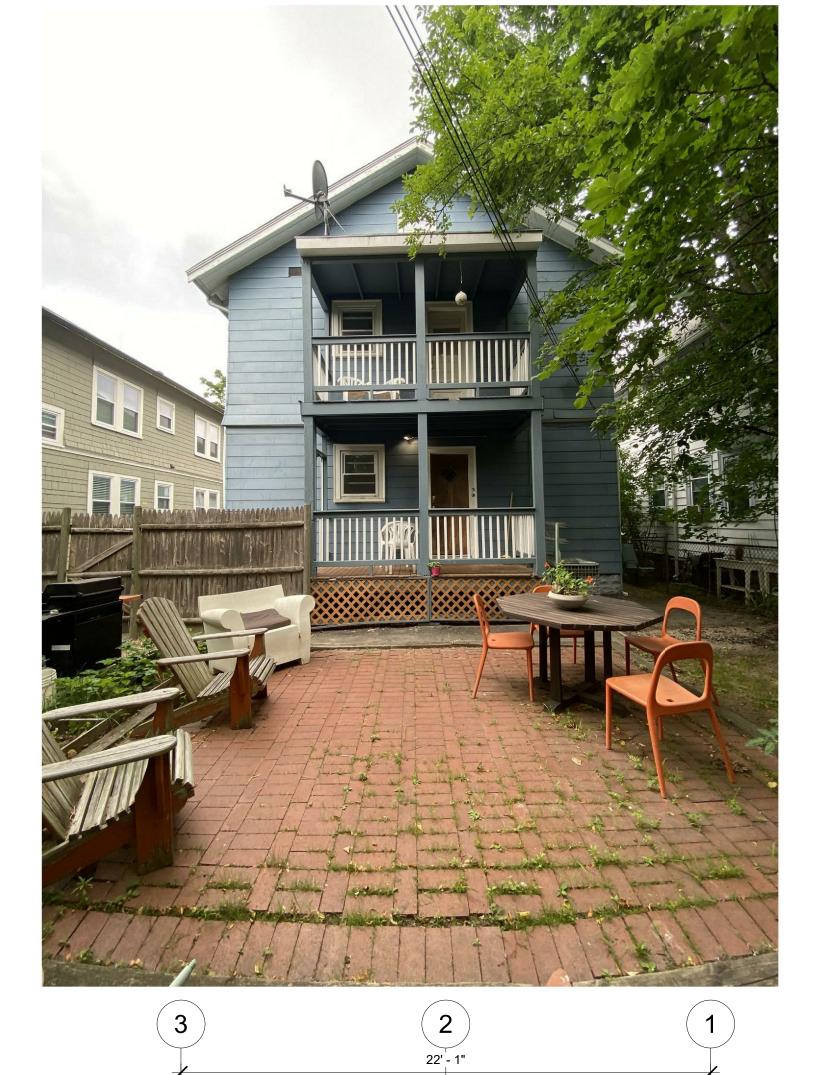



ELEV

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REGISTRATIONS:

STRUCTURAL ENGINEER:

& TRISH NG

STEVE

EXISTING LEVEL 1 98' - 11 13/32"

AVG GRADE 96' - 7 3/32"

94-96 ALPINE ST. CAMBRIDGE, MA 02138

Project Status BZA SUBMISSION SET Project Number Date 09/11/2020 Drawn by

Author

Checker Checked by P-202

NG RESIDENCE

Scale 1/4" = 1'-0"

3 PERSPECTIVE - EVELATION - EAST

1\$EXISTING EAST ELEVATION 1/4" = 1'-0"

PROPOSED T.O.

RIDGE
131' - 7 3/32" EXISTING T.O.

RIDGE
125' - 2 13/32" PROPOSED LEVEL 116' - 7 13/32" EXISTING LEVEL 2 107' - 11 13/32"





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STRUCTURAL ENGINEER:

94-96 ALPINE ST. CAMBRIDGE, MA 02138 NG RESIDENCE

Project Status BZA SUBMISSION SET Project number

Date Project Number 09/11/2020 Drawn by Author Checker Checked by

P-203 Scale 1/4" = 1'-0"

MORTGAGE INSPECTION PLAN

NORTHERN ASSOCIATES, INC. 92 MAPLE AVENUE ANDOVER, MA 01810 TEL:(978) 837-3335 FAX:(978) 837-3336 MASSACHUSETTS

MORTGAGOR: STEVEN NG, PATRICIA NG & AUDREY NG

LOCATION: 94-96 ALPINE ST CITY, STATE: CAMBRIDGE, MA DATE: 11/25/19

DEED REF. 72187 /182 PLAN REF. #481 SCALE: 1"=20' JOB #: 2193744

40.00' LOT 119 $3800 \pm sf$ POR. 00 EXISTING 95. DWELLING 94 - 96**ENCL** POR. 40.00'

ALPINE STREET

CERTIFIED TO: GUARANTEED RATE AFFINITY LLC, ISAOA/ATIMA

Flood hazard zone has been determined by scale and is not necessarily accurate. Until definitive plans are issued by HUD and/or a vertical control survey is performed, precise elevations cannot be determined.

NOTE: This mortgage Inspection was prepared specifically for mortgage purpose only and is not to be relied upon as a land or property line survey, used for recording, preparing deed descriptions, or construction. No corners were set. Building location and offsets are approximately located on ground and are shown specifically for zoning determination only and are not to betweed to establish property lines. The matters shown hereon are based on client-furnished information and may be subject to further out—sales, takings, easements and rights of way, and other matters of record and preserptive or other rights. Northern Associates, Inc. assumes nuresponsibility herein to land owner or occupant, accepts no responsibility for damages resulting from reliance by anyone other than the said mortgage and the connection with its proposed mortgage financing to said mortgagor.



I render this mortgage inspection plan to be issued with the best of my knowledge, information and belief.

I further state that in my professional opinion that the structures shown conform with the local zoning horizontal dimensional setback requirements at the time of construction or are exempt under previsions of M.C.L. CH. 40—A Sec. 7.

■ 1. Property/House is not in Flood Hazard.

□ 2. Property/House is in a Flood Hazard Area.


□ 3. Information is insufficent to determine Flood Hazard.

Flood Hazard determined from latest Federal Flood Insurance Rate Map Panel 25017C0419E

Date 06/04/10

X Zone



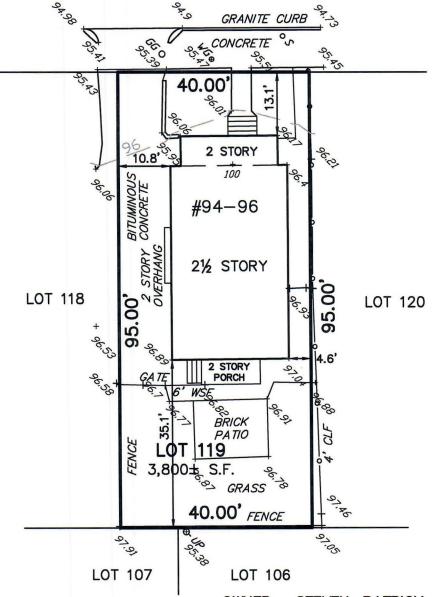

I HEREBY CERTIFY THAT THE BUILDING IS LOCATED AS SHOWN.

OWNER: STEVEN, PATRICIA & AUDRY NG

PROPOSED PLOT PLAN #92-94 ALPINE STREET

CAMBRIDGE, MA
(MIDDLESEX COUNTY)

SCALE: 1"= 20' DATE: 7/24/2020

0 20 40 60 ft

ROBER SURVEY

1072A MASSACHUSETTS AVENUE ARLINGTON, MA 02476 (781) 648-5533 6187PP1.DWG

CLIFFORD E. ROBER, PLS

DATE

THIS PLAN MAY HAVE BEEN ALTERED IF THE SIGNATURE IS NOT SIGNED IN BLUE.

Google Maps 97 Alpine St

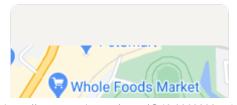


Image capture: Jul 2019 © 2020 Google

Cambridge, Massachusetts



Street View



Google Maps 94 Alpine St

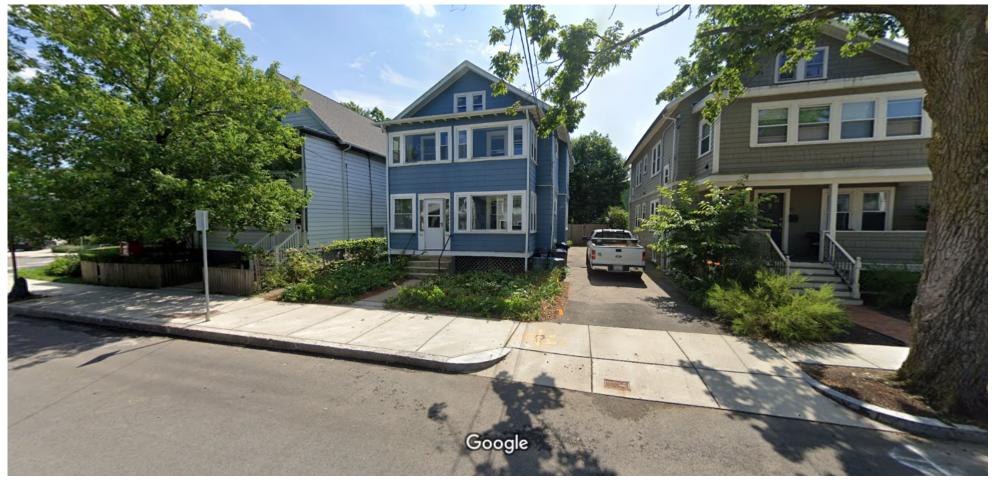



Image capture: Jul 2019 © 2020 Google

Cambridge, Massachusetts




Street View

Google Maps 96 Alpine St

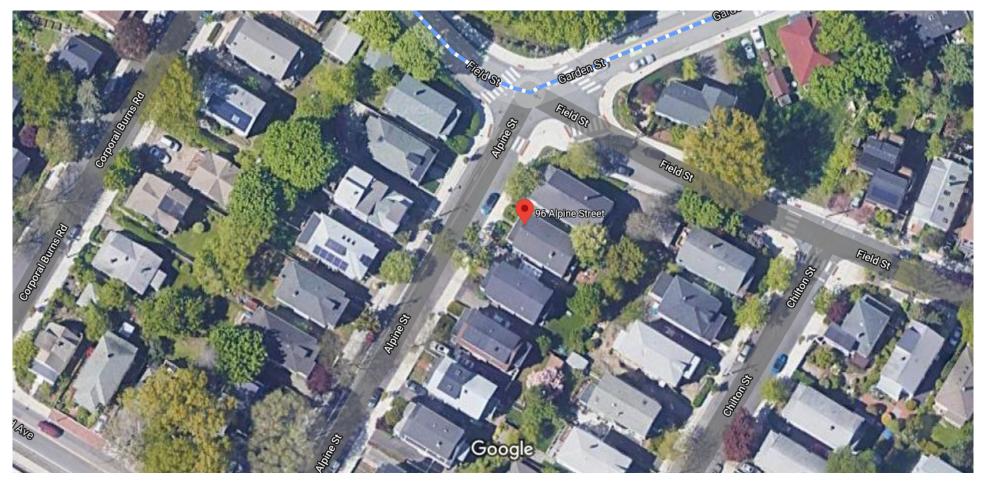

Imagery ©2020 MassGIS, Commonwealth of Massachusetts EOEA, Maxar Technologies, Map data ©2020 50 ft

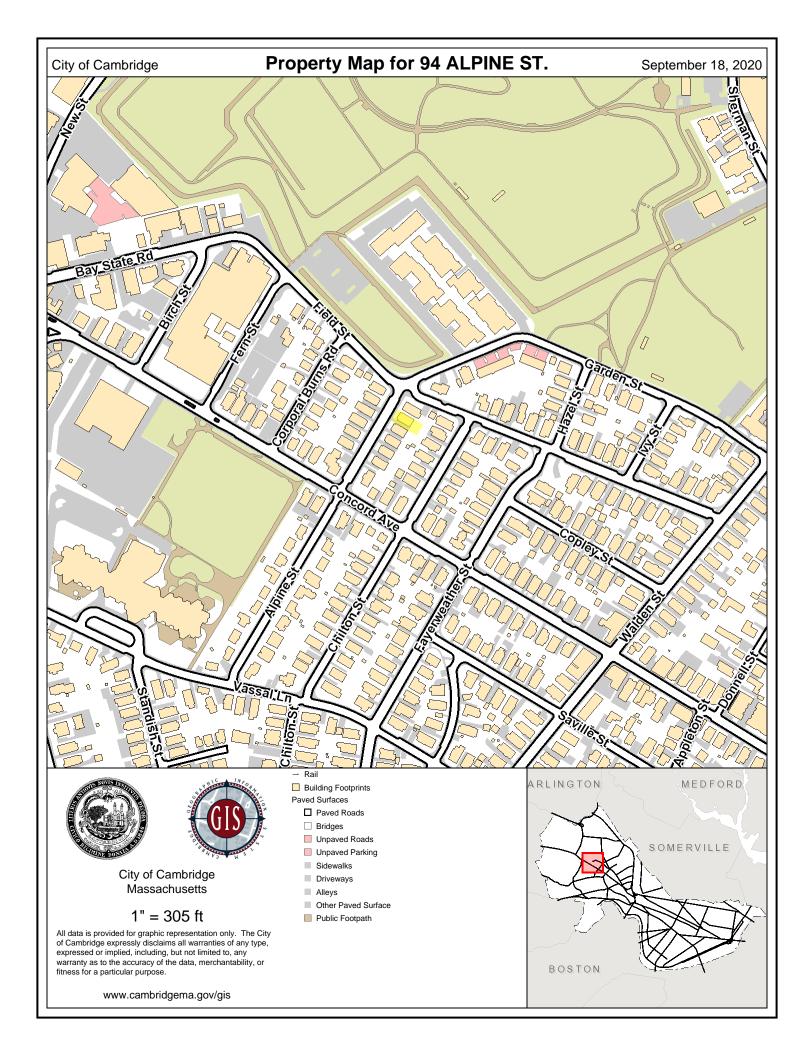

INFORMATIONAL ALERT | Coronavirus Updates



94 Alpine St

Property Information

Property Class	TWO-FAM-RES
State Class Code	104
Zoning (Unofficial)	В
Map/Lot	262-64
Land Area (sq. ft)	3,800


Property Value

Photos



Sketches

Year of Assessment	2020
Tax District	R8
Residential Exemption	No
Building Value	\$402,300
Land Value	\$784,500
Assessed Value	\$1,186,800
Sale Price	\$630,000
Book/Page	42813/224
Sale Date	May 17, 2004
Previous Assessed Value	\$1,061,900
Property Tax Amount	\$7,011.57
	This represents the total FY20 Real Estate Tax including the CPA Surcharge, but not including Residential Exemption or other Personal Exemptions deduction.

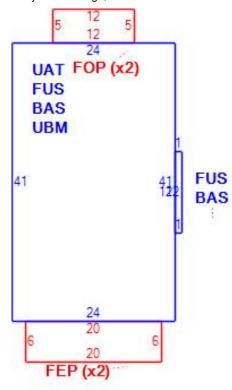

Owner Information

Owner(s)	REYBURN, ERIC N.
	2 WORCESTER
	STREET
	CAMBRIDGE, MA
	02139

Building Information

Residential Building Number 1, Section 1

Exterior

Style	OLD STYLE TWO FAM
Occupancy	TWO-FAM-RES
Number of Stories	2.25
Exterior Wall Type	Asbstos Shingl
Roof Type	Gable
Roof Material	Aspahlt Shingl

Interior

Living Area (sq. ft.)	1,992
Number of Units	2
Total Rooms	10
Bedrooms	4
Kitchens	2
Full Baths	2
Half Baths	0
Fireplaces	0

Systems

Heat Type	Forced Air
Heat Fuel	Gas
Central A/C	No

Condition & Grade

Year Built	1924
Interior Condition	Average
Overall Condition	Average
Overall Grade	Average

Parking

Open Parking	2
Covered Parking	0

Subareas

Code	Description	Gross Area	Living Area
BAS	First Floor	996	996
FEP	Porch, Enclosed	240	0
FOP	Porch, Open	120	0
FUS	Upper Story, Finished	996	996
UAT	Attic, Unfinished	984	0
UBM	Basement	984	0
	Total:	4,320	1,992

Bk: 73875 Pg: 99

Middlesex South Registry of Deeds

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Recording Information

Document Number : 203826 **Document Type** DEED

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Recorded Time : 08:24:41 AM

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MASSACHUSETTS EXCISE TAX Southern Middlesex District ROD # 001

Date: 12/23/2019 08:24 AM

Ctrl# 312660 03839 Doc# 00203826 Fee: \$5.700.00 Cons: \$1.250.000.00

> Middlesex South Registry of Deeds Maria C. Curtatone, Register 208 Cambridge Street Cambridge, MA 02141 617-679-6300 www.middlesexsouthregistry.com

Bk: 73875 Pg: 100

DEED

CMSBRC Holdings LLC, a Massachusetts limited liability company, having a mailing address of 2 Worcester Street, Cambridge, MA 02139

for consideration paid and in full consideration of One Million Two Hundred Fifty Thousand Dollars (\$1,250,000.00) Dollars grant(s) to

Two Thirds Interest to Steven Ng and Patricia D. Ng, as Husband and Wife, Tenants by the Entirety and One Third Interest to Audrey Ng, Individually now of 94-96 Alpine Street, Cambridge, MA

with Quitclaim Covenants

The land with the buildings thereon, situated in Cambridge, in the County of Middlesex, and Commonwealth of Massachusetts, being the lot numbered One Hundred Nineteen (119) as shown on a Plan of University Park, Cambridge, Massachusetts, surveyed for Joseph H. Allen & Otto M. Frank, Trustees, dated February 17, 1911, by W. A. Mason & Sons, Surveyors, duly recorded with Middlesex South District as filed Plan No. 481, bounded and described as follows:

NORTHWESTERLY	by Alpine Street, forty (40) feet;
NORTHEASERLY	by lot 120, as shown on said plan, ninety-five (95) feet;
SOUTHEASTERLY	by Lots 106 and 107, as shown on said plan, forty (40) feet; and
SOUTHWESTERLY	by lot 118, as shown on said plan, ninety-five (95) feet.

Containing 3,800 square feet of land, according to said plan.

The Grantor hereby certifies that it has not elected to be treated as a corporation for federal income tax purposes.

For title, see Deed dated January 31, 2019, and recorded with the Middlesex South District Registry of Deeds in Book 72187, Page 181.

{Signatures follow on next page}

Bk: 73875 Pg: 101

Executed as a sealed instrument day of December, 2019.

CMSBRC Holdings LLC

Name: Christopher M. Shachoy

Title: Manager


COMMONWEALTH OF MASSACHUSETTS

middlesex ss

On this $|\underline{b}|$ day of December, 2019, before me, the undersigned notary public, personally appeared Christopher M. Shachoy, Manager of CMSBRC Holdings LLC, proved to me by satisfactory evidence of identification, being (check whichever applies): \Box driver's license or other state or federal governmental document bearing a photographic image, \Box oath or affirmation of a credible witness known to me who knows the above signatory, or \Box my own personal knowledge of the identity of the signatory, to be the person whose name is signed above, and acknowledged the foregoing to be signed by him voluntarily for its stated purpose.

Notary Public

My Commission Expires:

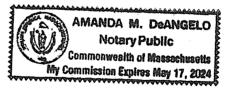



CITY OF CAMBRIDGE ASSESSING DEPARTMENT

795 MASS. AVE., CAMBRIDGE, MA 02139

Tel.: 617-349-4343 Fax: 617-349-4357

Andrew J. Johnson Deputy Director

Walter H. Pennell Assessor

Date: September 22, 2020

Certified List of Abutters

From:

Cambridge Board of Assessors

Parcel ID:

262-64

Location:

94 Alpine St

This is to certify that the names and addresses for the map and lot numbers stated on the attached list are correct according to the most current records in the Assessor's Office. Owners listed as of January 1, 2020.

Sincerely,

Gayle Willett

Director of Assessment

REM_ACCT_NUM	REM_PRCL_LOCN	REM_USE_CODE
261-140	89-91 ALPINE ST	104
261-156	95 ALPINE ST	199
261-156-1	95 ALPINE ST #1	102
261-156-2	95 ALPINE ST #2	102
262-49	98 ALPINE ST	104
262-50	169-171 CHILTON ST	199
262-50-169	169 CHILTON ST #169	102
262-50-171	169 CHILTON ST #171	102
262-51	161 CHILTON ST	104
262-52	157 CHILTON ST	104
262-53	153 CHILTON ST	104
262-62	88 ALPINE ST	104
262-63	90 ALPINE ST	104
262-64	94 ALPINE ST	104


REM_OWN_NAME
TERRY, WILLIAM & RUTH E. TERRY
CAMBRIDGE CT ASSOCIATES I LLC
DANNENBAUM, KARL THOMAS JAYARAM &
LEUNG LI, JUAN LUIS &
PHYSIC, CHARLES E.
WUNDERLICH, THOMAS M.
WUNDERLICH, THOMAS M.
DOTTIN, GREGORY F. & DELORES P. DOTTIN
157 CHILTON STREET LLC
BLAKE , TAMRA A.
GREENE, DONALD L. & EDNA C. GREENE, TRS
ALPINE REAL ESTATE LLC
REYBURN, ERIC N.

OWN_NAME1	OWN_NAME2
TERRY, WILLIAM & RUTH E. TERRY	
CAMBRIDGE CT ASSOCIATES I LLC	
DANNENBAUM, KARL THOMAS JAYARAM &	KEYA HARSHEY JAYARAM DANNENBAUM.
LEUNG LI, JUAN LUIS	
PHYSIC, CHARLES E.	
HALL, MIRIAM P.	
WUNDERLICH, THOMAS M.	
WUNDERLICH, THOMAS M.	
DOTTIN, GREGORY F. & DELORES P. DOTTIN	TRS. DOTTIN REALTY TRUST
157 CHILTON STREET LLC	
BLAKE , TAMRA A.	
GREENE, DONALD L. & EDNA C. GREENE, TRS	THE GREENE REALTY TRUST
ALPINE REAL ESTATE LLC	

MAD_MAIL_ADDR1	MAD_MAIL_ADDR2	MAD_MAIL_ADDR3
91 ALPINE ST		
90 SPENCER AVE		
95 ALPINE ST. UNIT 1		
95 ALPINE ST #2		
C/O CJL MANAGEMENT	50 GREER STREET	
169 CHILTON ST.		
169 CHILTON ST., # 171		
163 CHILTON ST		
134 MAIN ST UNIT #7		
10 WOODS ROAD		
88 ALPINE ST.		
32 AMBERWOOD DR		
C/O CMSBRC HOLDINGS LLC		2 WORCESTER ST

MAD_MAIL_CITY	MAD_MAIL_STATE	MAD_MAIL_ZIP
CAMBRIDGE	MA	02138-1224
CHELSEA	MA	02150
CAMBRIDGE	MA	02138
CAMBRIDGE	MA	02138
WALTHAM	MA	02452
CAMBRIDGE	MA	02138
CAMBRIDGE	MA	02138
CAMBRIDGE	MA	02138-1226
STONEHAM	MA	02180
BELMONT	MA	02478
CAMBRIDGE	MA	02138-1225
WINCHESTER	MA	01890
CAMBRIDGE	MA	02139

MAP TITLE

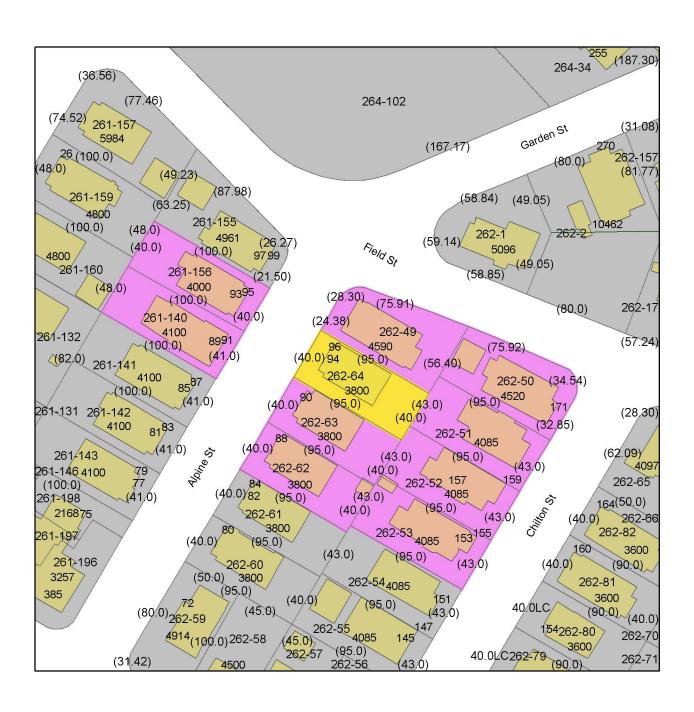

Cambridge, MA Assessing Department
Gayle Willett, Director




261-140 TERRY, WILLIAM & RUTH E. TERRY 91 ALPINE ST CAMBRIDGE, MA 02138-1224 261-156 CAMBRIDGE CT ASSOCIATES I LLC 90 SPENCER AVE CHELSEA, MA 02150 261-156-1 DANNENBAUM, KARL THOMAS JAYARAM & KEYA HARSHEY JAYARAM DANNENBAUM. 95 ALPINE ST. UNIT 1 CAMBRIDGE, MA 02138

261-156-2 LEUNG LI, JUAN LUIS 95 ALPINE ST #2 CAMBRIDGE, MA 02138 262-49 PHYSIC, CHARLES E. C/O CJL MANAGEMENT 50 GREER STREET WALTHAM, MA 02452 262-50 HALL, MIRIAM P.

262-50-169 WUNDERLICH, THOMAS M. 169 CHILTON ST. CAMBRIDGE, MA 02138 262-50-171 WUNDERLICH, THOMAS M. 169 CHILTON ST., # 171 CAMBRIDGE, MA 02138 262-51 DOTTIN, GREGORY F. & DELORES P. DOTTIN TRS. DOTTIN REALTY TRUST 163 CHILTON ST CAMBRIDGE, MA 02138-1226

262-52 157 CHILTON STREET LLC 134 MAIN ST UNIT #7 STONEHAM, MA 02180 262-53 BLAKE , TAMRA A. 10 WOODS ROAD BELMONT, MA 02478 262-62 GREENE, DONALD L. & EDNA C. GREENE, TRS THE GREENE REALTY TRUST 88 ALPINE ST. CAMBRIDGE, MA 02138-1225

262-63 ALPINE REAL ESTATE LLC 32 AMBERWOOD DR WINCHESTER, MA 01890 262-64 REYBURN, ERIC N. C/O CMSBRC HOLDINGS LLC 2 WORCESTER ST CAMBRIDGE, MA 02139 96 Alpine St.

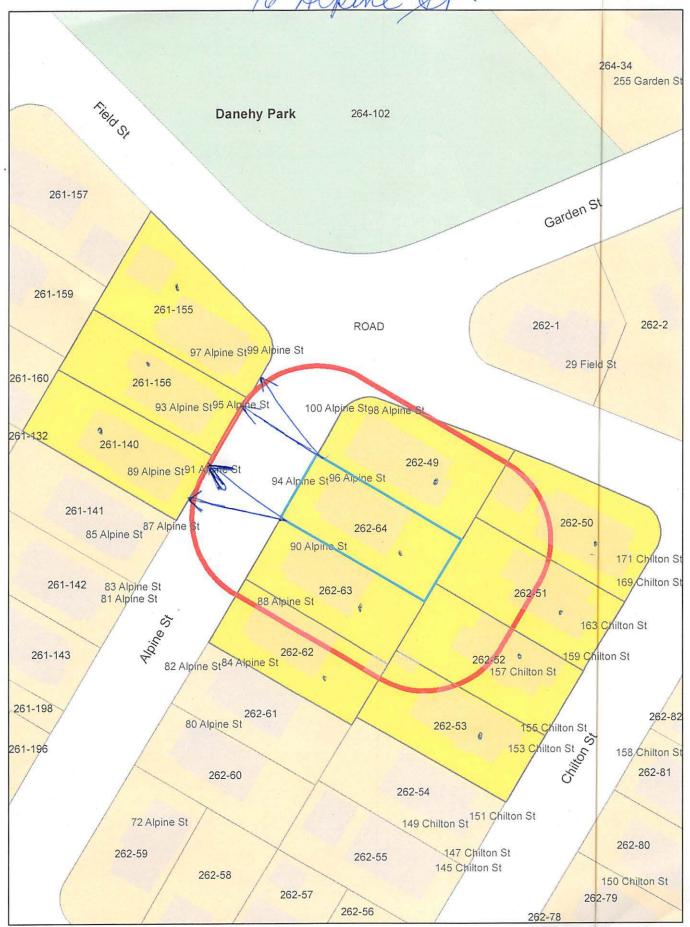

96 Alpine St.

261-140 TERRY, WILLIAM & RUTH E. TERRY 91 ALPINE ST CAMBRIDGE, MA 02138-1224

262-49
PHYSIC, CHARLES E.
C/O CJL MANAGEMENT
50 GREER STREET
WALTHAM, MA 02452

262-51 DOTTIN, GREGORY F. & DELORES P. DOTTIN TRS. DOTTIN REALTY TRUST 163 CHILTON ST CAMBRIDGE, MA 02138-1226

261-156 DANNENBAUM, KARL THOMAS JAYARAM & KEYA HARSHEY JAYARAM DANNENBAUM. 95 ALPINE ST. UNIT 1 CAMBRIDGE, MA 02138

262-52 LIU, CHARLIE C. PATRICE ANNE LIU 159 CHILTON ST CAMBRIDGE, MA 02138 261-155 KOZACHUK, DOMENNA , G REGORY M. KOZACHUK 99 ALPINE ST CAMBRIDGE, MA 02138

262-63 ALPINE REAL ESTATE LLC 32 AMBERWOOD DR WINCHESTER, MA 01890

262-62 GREENE, DONALD L. & EDNA C. GREENE, TRS THE GREENE REALTY TRUST 88 ALPINE ST. CAMBRIDGE, MA 02138-1225

262-64 NG, STEVEN & PATRICIA D. NG AUDREY NG 94-96 ALPINE ST CAMBRIDGE, MA 02138

262-53 BLAKE , TAMRA A. 10 WOODS ROAD BELMONT, MA 02478 BLATMAN, BOBROWSKI & HAVERTY, LLC C/O CHRISTOPHER J. ALPHEN, ESQ. 9 DAMONMILL SQ. – SUITE 4A4 CONCORD, MA 01742

262-50 WUNDERLICH, THOMAS M. 169 CHILTON ST., # 171 CAMBRIDGE, MA 02138

262-50 WUNDERLICH, THOMAS M. 169 CHILTON ST. CAMBRIDGE, MA 02138

261-156 LEUNG LI, JUAN LUIS 95 ALPINE ST UNIT 2 CAMBRIDGE, MA 02138

NG RESIDENCE

STEVE & TRISH NG

94-96 ALPINE ST. CAMBRIDGE, MA 02138





ARCHITECT:

SKA

SAM KACHMAR

© 2020 SAM KACHAMR ARCHITECTS

ARCHITECTS
(p)978-270-8441
kachmardesign.com
357 HURON AVE.
CAMBRIDGE MA, 02138

CLIENTS:

GENERAL CONTRACTOR:

STEVE & TRISH NG

THE NG RESIDENCE LOCATED AT 94-96
ALPINE ST WILL INCLUDE THE
RENOVATION OF THE FRONT AND REAR
PORCH, THE RENOVATION OF THE 2ND
FLOOR APARTMENT AND THE RAISING
OF THE ROOF TO 35' BUILDING LIMIT

STRUCTURAL ENGINEER:



ROOME & GUARRACINO LLC

Sheet Number	Sheet Name	Designed By	
P-000	COVER	SKA	
P-001	GENERAL NOTES	SKA	
P-002	PLOT PLAN & AREA PLAN	SKA	
P-003	SITE AXON	SKA	
P-004	SHADOW STUDY	SKA	
P-005	STREET VIEW PERSPECTIVE	SKA	
P-006	STREET VIEW PERSPECTIVE	SKA	
P-100	PROPOSED LEVEL 0	SKA	
P-101	PROPOSED LEVEL 1	SKA	
P-102	PROPOSED LEVEL 2	SKA	
P-103	PROPOSED LEVEL 3 SKA		

Sheet Number	Sheet Name	Designed By	
	·		
P-104	PROPOSED ROOF PLAN	SKA	
P-200	ELEVATION WEST	SKA	
P-201	ELEVATION NORTH	SKA	
P-202	ELEVATION EAST	SKA	
P-203	ELEVATION SOUTH	SKA	
P-500	QR CODE	SKA	
P-501	EXISTING	SKA	
P-502	EXISTING	SKA	
P-503	EXISTING	Designer	
P-504	PLOT PLAN	SKA	
P-505	LANDSCAPE PLAN	SKA	
P-506	EXISTING AERIAL VIEW Designer		


BZA SUBMISSION SET

11/13/2020


Grand total: 23

L	LENGTH
LAM	LAMINATE, LAMINATED
LB	POUND
LGMF	LIGHT GAGE METAL FRAMING
LT	LIGHT
LT WT	LIGHT WEIGHT
MAX	MAXIMUM
MDF	MEDIUM DENSITY FIBER
MECH	MECHANICAL
MED	MEDIUM
MFR	MANUFACTURER
MIN	MINIMUM
MISC	MISCELLANEOUS
MTD	MOUNTED
MTL	METAL
N	NORTH
N/A	NOT APPLICABLE
NIC	NOT IN CONTRACT
NOM	NOMINAL
NTS	NOT TO SCALE
OC	ON CENTER
OD	OUTSIDE DIAMETER
OH	OPPOSITE HAND
OPP	OPPOSITE
OSB	ORIENTED STRANDBOARD
OVHD	OVERHEAD
OZ	OUNCE (S)
PATT	PATTERN (ED)
PERF	PERFORATED
PERP	PERPENDICULAR
PLAM	PLASTIC LAMINATE
PLYWD	PLYWOOD
PNT	PAINT, PAINTED
PR	PAIR
PREFAB	PREFABRICATE, PREFABRICATED
QTY	QUANTITY
RAD	RADIUS
	RADIUS RUBBER
RAD	
RAD RBR RD	RUBBER
RAD RBR	RUBBER ROOF DRAIN REFERENCE
RAD RBR RD REF	RUBBER ROOF DRAIN
RAD RBR RD REF REFR	RUBBER ROOF DRAIN REFERENCE REFRIGERATE, REFRIGERATOR
RAD RBR RD REF REFR REINF	RUBBER ROOF DRAIN REFERENCE REFRIGERATE, REFRIGERATOR REINFORCE, REINFORCED
RAD RBR RD REF REFR REINF REQ	RUBBER ROOF DRAIN REFERENCE REFRIGERATE, REFRIGERATOR REINFORCE, REINFORCED REQUIRE
RAD RBR RD REF REFR REINF REQ REV	RUBBER ROOF DRAIN REFERENCE REFRIGERATE, REFRIGERATOR REINFORCE, REINFORCED REQUIRE REVISION, REVISE, REVISED
RAD RBR RD REF REFR REINF REQ REV RM	RUBBER ROOF DRAIN REFERENCE REFRIGERATE, REFRIGERATOR REINFORCE, REINFORCED REQUIRE REVISION, REVISE, REVISED ROOM
RAD RBR RD REF REFR REINF REQ REV RM RO	RUBBER ROOF DRAIN REFERENCE REFRIGERATE, REFRIGERATOR REINFORCE, REINFORCED REQUIRE REVISION, REVISE, REVISED ROOM ROUGH OPENING
RAD RBR RD REF REFR REINF REQ REV RM RO S	RUBBER ROOF DRAIN REFERENCE REFRIGERATE, REFRIGERATOR REINFORCE, REINFORCED REQUIRE REVISION, REVISE, REVISED ROOM ROUGH OPENING SOUTH
RAD RBR RD REF REFR REINF REQ REV RM RO S SCHED	RUBBER ROOF DRAIN REFERENCE REFRIGERATE, REFRIGERATOR REINFORCE, REINFORCED REQUIRE REVISION, REVISE, REVISED ROOM ROUGH OPENING SOUTH SCHEDULE
RAD RBR RD REF REFR REINF REQ REV RM RO S SCHED	RUBBER ROOF DRAIN REFERENCE REFRIGERATE, REFRIGERATOR REINFORCE, REINFORCED REQUIRE REVISION, REVISE, REVISED ROOM ROUGH OPENING SOUTH SCHEDULE SQUARE FEET
RAD RBR RD REF REFR REINF REQ REV RM RO S SCHED SF SI	RUBBER ROOF DRAIN REFERENCE REFRIGERATE, REFRIGERATOR REINFORCE, REINFORCED REQUIRE REVISION, REVISE, REVISED ROOM ROUGH OPENING SOUTH SCHEDULE SQUARE FEET SQUARE INCHES
RAD RBR RD REF REFR REINF REQ REV RM RO S SCHED SF SI SIM	RUBBER ROOF DRAIN REFERENCE REFRIGERATE, REFRIGERATOR REINFORCE, REINFORCED REQUIRE REVISION, REVISE, REVISED ROOM ROUGH OPENING SOUTH SCHEDULE SQUARE FEET SQUARE INCHES SIMILAR
RAD RBR RD REF REFR REINF REQ REV RM RO S SCHED SF SI SIM SPEC	RUBBER ROOF DRAIN REFERENCE REFRIGERATE, REFRIGERATOR REINFORCE, REINFORCED REQUIRE REVISION, REVISE, REVISED ROOM ROUGH OPENING SOUTH SCHEDULE SQUARE FEET SQUARE INCHES SIMILAR SPECIFICATION
RAD RBR RD REF REFR REINF REQ REV RM RO S SCHED SF SI SIM SPEC SQ	RUBBER ROOF DRAIN REFERENCE REFRIGERATE, REFRIGERATOR REINFORCE, REINFORCED REQUIRE REVISION, REVISE, REVISED ROOM ROUGH OPENING SOUTH SCHEDULE SQUARE FEET SQUARE INCHES SIMILAR SPECIFICATION SQUARE
RAD RBR RD REF REFR REINF REQ REV RM RO S SCHED SF SI SIM SPEC SQ SS, SST	RUBBER ROOF DRAIN REFERENCE REFRIGERATE, REFRIGERATOR REINFORCE, REINFORCED REQUIRE REVISION, REVISE, REVISED ROOM ROUGH OPENING SOUTH SCHEDULE SQUARE FEET SQUARE INCHES SIMILAR SPECIFICATION SQUARE STAINLESS STEEL
RAD RBR RD REF REFR REINF REQ REV RM RO S SCHED SF SI SIM SPEC SQ SS, SST STC	RUBBER ROOF DRAIN REFERENCE REFRIGERATE, REFRIGERATOR REINFORCE, REINFORCED REQUIRE REVISION, REVISE, REVISED ROOM ROUGH OPENING SOUTH SCHEDULE SQUARE FEET SQUARE INCHES SIMILAR SPECIFICATION SQUARE STAINLESS STEEL SOUND TRANSMISSION CLASS
RAD RBR RD REF REFR REINF REQ REV RM RO S SCHED SF SI SIM SPEC SQ SS, SST STC STL	RUBBER ROOF DRAIN REFERENCE REFRIGERATE, REFRIGERATOR REINFORCE, REINFORCED REQUIRE REVISION, REVISE, REVISED ROOM ROUGH OPENING SOUTH SCHEDULE SQUARE FEET SQUARE INCHES SIMILAR SPECIFICATION SQUARE STAINLESS STEEL SOUND TRANSMISSION CLASS STEEL
RAD RBR RD REF REFR REINF REQ REV RM RO S SCHED SF SI SIM SPEC SQ SS, SST STC STL STOR	RUBBER ROOF DRAIN REFERENCE REFRIGERATE, REFRIGERATOR REINFORCE, REINFORCED REQUIRE REVISION, REVISE, REVISED ROOM ROUGH OPENING SOUTH SCHEDULE SQUARE FEET SQUARE INCHES SIMILAR SPECIFICATION SQUARE STAINLESS STEEL SOUND TRANSMISSION CLASS STEEL STORAGE
RAD RBR RD REF REFR REINF REQ REV RM RO S SCHED SF SI SIM SPEC SQ SS, SST STC STL STOR STR	RUBBER ROOF DRAIN REFERENCE REFRIGERATE, REFRIGERATOR REINFORCE, REINFORCED REQUIRE REVISION, REVISE, REVISED ROOM ROUGH OPENING SOUTH SCHEDULE SQUARE FEET SQUARE INCHES SIMILAR SPECIFICATION SQUARE STAINLESS STEEL SOUND TRANSMISSION CLASS STEEL STORAGE STAIR
RAD RBR RD REF REFR REINF REQ REV RM RO S SCHED SF SI SIM SPEC SQ SS, SST STC STL STOR STR T.O.	RUBBER ROOF DRAIN REFERENCE REFRIGERATE, REFRIGERATOR REINFORCE, REINFORCED REQUIRE REVISION, REVISE, REVISED ROOM ROUGH OPENING SOUTH SCHEDULE SQUARE FEET SQUARE INCHES SIMILAR SPECIFICATION SQUARE STAINLESS STEEL SOUND TRANSMISSION CLASS STEEL STORAGE STAIR TOP OF
RAD RBR RD REF REFR REINF REQ REV RM RO S SCHED SF SI SIM SPEC SQ SS, SST STC STL STOR STR T.O. U.O.	RUBBER ROOF DRAIN REFERENCE REFRIGERATE, REFRIGERATOR REINFORCE, REINFORCED REQUIRE REVISION, REVISE, REVISED ROOM ROUGH OPENING SOUTH SCHEDULE SQUARE FEET SQUARE INCHES SIMILAR SPECIFICATION SQUARE STAINLESS STEEL SOUND TRANSMISSION CLASS STEEL STORAGE STAIR TOP OF UNDERSIDE OF
RAD RBR RD REF REFR REINF REQ REV RM RO S SCHED SF SI SIM SPEC SQ SS, SST STC STL STOR STR T.O. U.O. UON	RUBBER ROOF DRAIN REFERENCE REFRIGERATE, REFRIGERATOR REINFORCE, REINFORCED REQUIRE REVISION, REVISE, REVISED ROOM ROUGH OPENING SOUTH SCHEDULE SQUARE FEET SQUARE INCHES SIMILAR SPECIFICATION SQUARE STAINLESS STEEL SOUND TRANSMISSION CLASS STEEL STORAGE STAIR TOP OF UNDERSIDE OF UNLESS OTHERWISE NOTED
RAD RBR RD REF REFR REINF REQ REV RM RO S SCHED SF SI SIM SPEC SQ SS, SST STC STL STOR STR T.O. U.O. UON WD	RUBBER ROOF DRAIN REFERENCE REFRIGERATE, REFRIGERATOR REINFORCE, REINFORCED REQUIRE REVISION, REVISE, REVISED ROOM ROUGH OPENING SOUTH SCHEDULE SQUARE FEET SQUARE INCHES SIMILAR SPECIFICATION SQUARE STAINLESS STEEL SOUND TRANSMISSION CLASS STEEL STORAGE STAIR TOP OF UNDERSIDE OF UNLESS OTHERWISE NOTED WOOD WEIGHT
RAD RBR RD REF REFR REINF REQ REV RM RO S SCHED SF SI SIM SPEC SQ SS, SST STC STL STOR STR T.O. U.O. UON WD WT	RUBBER ROOF DRAIN REFERENCE REFRIGERATE, REFRIGERATOR REINFORCE, REINFORCED REQUIRE REVISION, REVISE, REVISED ROOM ROUGH OPENING SOUTH SCHEDULE SQUARE FEET SQUARE INCHES SIMILAR SPECIFICATION SQUARE STAINLESS STEEL SOUND TRANSMISSION CLASS STEEL STORAGE STAIR TOP OF UNDERSIDE OF UNLESS OTHERWISE NOTED WOOD



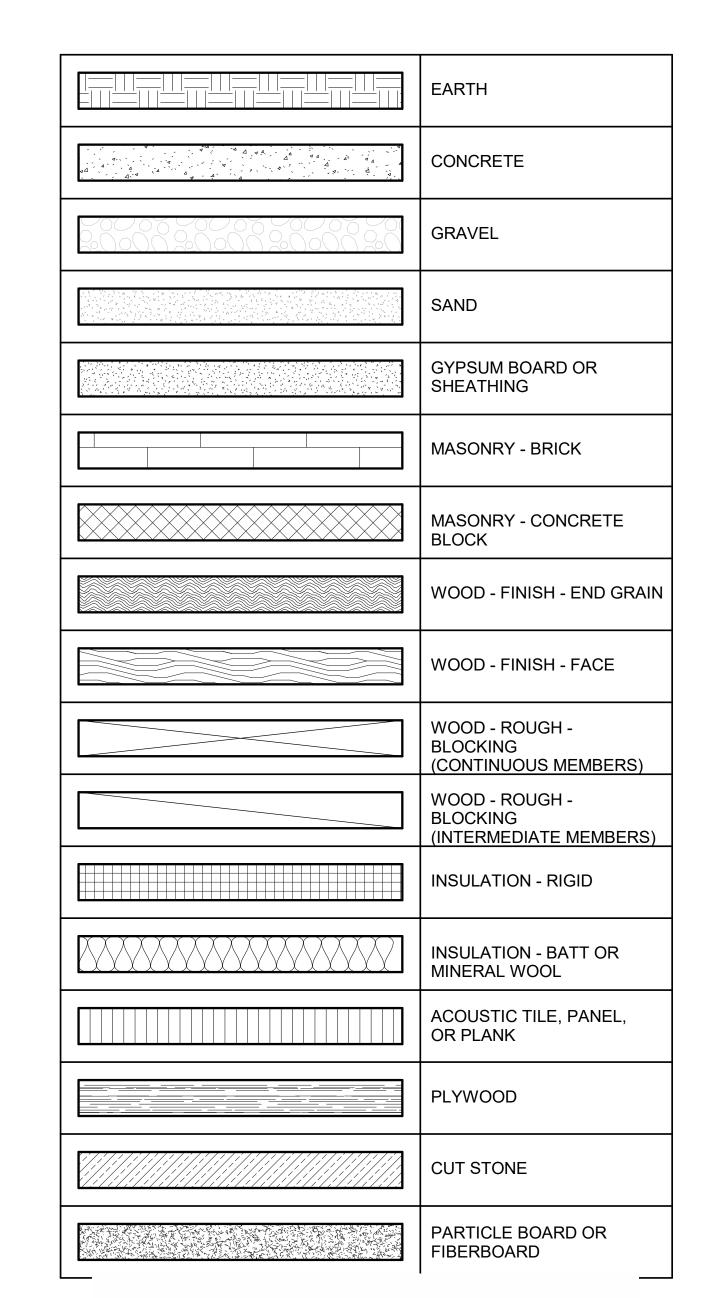

P-MATERIALS ¹ 1 1/2" = 1'-0"

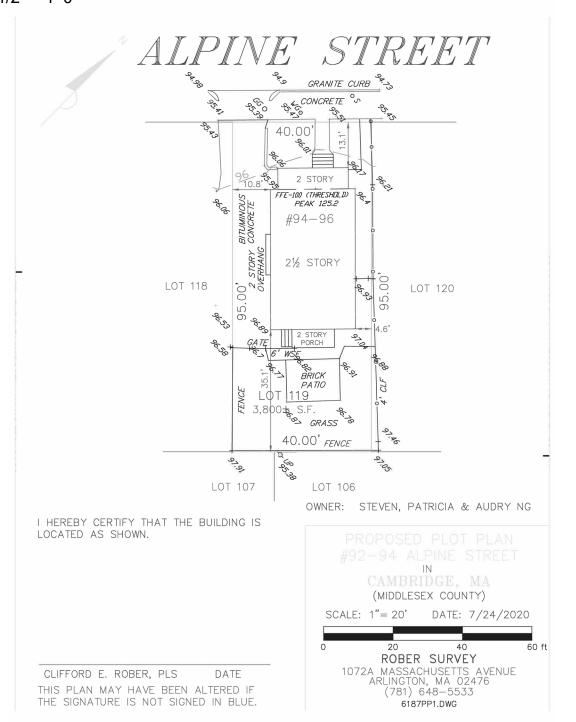

VIEW # VIEW NAME			DRAWING TITLE		
SHEET O.H. / SIM			EXTERIOR ELEVATION KEY		
SHEET			INTERIOR ELEVATION KEY		
O.H. / SIM VIEW #		I	BUILDING SECTION MARKER		
VIEW # O.H. / SIM		J	WALL SEC	WALL SECTION MARKER	
VIEW # O.H. / SIM			DETAIL AR	DETAIL AREA MARKER	
VIEW # O.H. / SIM SHEET		-	DETAIL SE	CTION MARKER	
COLUMN	COLUMN			GRID LINE	
Name Elevation	Name Elevation			VERTICAL ELEVATION KEY (ELEV)	
0' - 0"			SPOT ELEVATION W/ TARGET (PLAN)		
0'-0"			SPOT ELEVATION NO TARGET (PLAN)		
	REV,#		REVISION REVISION	CLOUD AND TAG	
ROOM NAME ROOM #	ROOM TAG		ب	CENTERLINE	
AREA NAME AREA	AREA TAG	SHEET		MATCH LINE	
DOOR#	DOOR TAG			HINGE SIDE OF DOOR	
# TYPE	WINDOW TAG	Ť		ALIGN SURFACE	
		R F	ROOM NAME OOM # FLOOR BASE WALL FEILING	FINISH TAG	

3 P-SYMBOLS 1 1/2" = 1'-0"

ALL WORK SHALL BE CONSIDERED NEW, UNLESS OTHERWISE
INDICATED.
DO NOT SCALE DRAWINGS
VERIFY DIMENSIONS, GRADES, BOUNDARIES, AND CONSTRUCTION
AND IMMEDIATELY REPORT ANY DISCREPANCIES BEFORE

PROCEEDING WITH THE WORK. 4. TO THE EXTENT PRACTICABLE, VERIFY DIMENSIONS AND FIELD CONDITIONS AT THE SITE PRIOR TO THE BID SUBMISSION CONFLICTS, OMISSIONS AND DISCREPANCIES WITHIN THE CONTRACT DOCUMENTS SHALL BE REPORTED IN WRITING TO THE ARCHITECT, IN ACCORDANCE WITH THE CONTRACT DOCUMENTS, PRIOR TO THE BID SUBMISSION. THE CONTRACTOR WARRANTS, BY TENDERING HIS BID, THAT THE WORK IS BUILDABLE AS SHOWN.

5. LAYOUT ALL WORK WITHIN THE CONFINES OF EXISTING CONSTRUCTION AND RESOLVE DISCREPANCIES PRIOR TO INITIATION OF NEW WORK.

6. ARCHITECT IS NOT RESPONSIBLE FOR CONSTRUCTION THAT IS STARTED PRIOR TO PERMIT BEING ISSUED.

7. DIMENSIONS, NOTES, FINISHES AND FIXTURES SHOWN ON TYPICAL FLOOR PLANS, SECTION OR DETAILS SHALL APPLY TO SIMILAR, SYMMETRICAL OR OPPOSITE HAND PLANS SECTIONS OR DETAILS, UNLESS NOTED OTHERWISE.

8. TYPICAL OR "TYP" SHALL MEAN THAT THE CONDITION IS REPRESENTATIVE FOR SIMILAR CONDITIONS THROUGHOUT, UNLESS NOTED OTHERWISE. DETAILS ARE USUALLY KEYED AND NOTED "TYP" ONLY ONE TIME, WHEN THEY FIRST OCCUR.

9. IMMEDIATELY NOTIFY THE ARCHITECT IN WRITING OF ANY DISCREPANCIES BETWEEN PROJECT MANUAL, LARGE SCALE DRAWINGS, SMALL SCALE DRAWINGS AND DETAILS. THE CONTRACTOR SHALL NOT PROCEED WITH AFFECTED WORK UNTIL ARCHITECT PROVIDES CLARIFICATION.

10. PARTITIONS ARE DIMENSIONED FROM FINISHED FACE TO FINISHED FACE UNLESS OTHERWISE NOTED. DIMENSIONS TO MASONRY ARE TO ACTUAL FINISHED FACE, UNLESS OTHERWISE NOTED.

11. VERIFY THAT DRAWINGS ARE THE LATEST ISSUE PRIOR TO COMMENCING CONSTRUCTION. THE GENERAL CONTRACTOR SHALL BE RESPONSIBLE FOR COMMUNICATING AND DISTRIBUTING ALL CONSTRUCTION DOCUMENT UPDATES TO ALL TRADES.

12. WORK SHALL CONFORM TO THE REQUIREMENTS OF APPLICABLE STATE, FEDERAL AND CITY/COUNTY CODES. STATE AND FEDERAL CODES ARE TO TAKE PRECEDENCE OVER THE DRAWINGS AND SPECIFICATIONS. IF ANY DISCREPANCY IS NOTED, IMMEDIATELY INFORM THE ARCHITECT, PRIOR TO PROCEEDING WITH THE WORK.

13. FILE, OBTAIN AND PAY FEES FOR BUILDING DEPARTMENT PERMITS, CONTROLLED INSPECTIONS, OTHER AGENCY APPROVALS AND PERMITS WHERE REQUIRED, AND FINAL WRITE-OFFS FOR PROJECT COMPLETION. COPIES OF TRANSACTIONS SHALL BE FORWARDED TO THE OWNER OR OWNER'S REPRESENTATIVE.

14. EXECUTE INSPECTIONS NECESSARY TO OBTAIN A CERTIFICATE OF OCCUPANCY.

15. WORK AREA SHALL BE MAINTAINED, CLEAN AND FREE OF DEBRIS AT ALL TIMES.

16. PATCH ALL SURFACES TO MATCH ADJACENT IN A MANNER SUITABLE TO RECEIVE FINISHES.

17. PATCH, REPAIR AND FINISH ALL SURFACES IN AREAS OUTSIDE OF THE EXISTING SCOPE THAT ARE DISTURBED AS A RESULT OF THE WORK.

18. COORDINATE AND PROVIDE BLOCKING AND STRAPPING WITHIN PARTITIONS FOR MILLWORK AND OTHER WALL ATTACHED ITEMS.

19. APPLY, INSTALL, CONNECT, CLEAN AND/OR CONDITION MANUFACTURED ARTICLES, MATERIALS AND/OR EQUIPMENT PER MANUFACTURER'S INSTRUCTIONS. IN CASE OF CONFLICT BETWEEN MANUFACTURER'S INSTRUCTIONS AND THE CONTRACT DOCUMENTS. THE CONTRACTOR SHALL OBTAIN WRITTEN CLARIFICATION FROM

THE ARCHITECT BEFORE PROCEEDING. 20. GLASS 18" OR LESS FROM FLOOR LINE OR ADJACENT TO A DOOR SWING SHALL BE SAFETY GLASS AS REQUIRED BY APPLICABLE CODE(S). THE CONTRACTOR SHALL BE RESPONSIBLE FOR PROVIDING ." SAFETY GLASS, UNLESS OTHERWISE NOTED, TO COMPLY WITH BUILDING AND LIFE SAFETY CODES, INDUSTRY STANDARDS AND OTHER APPLICABLE FEDERAL AND STATE CODES

21. FLASHING AT EXTERIOR WALLS SHALL BE INSTALLED WITH SEALED JOINTS, SEALED PENETRATIONS AND ENDS TURNED UP. IT SHALL BE FABRICATED AND INSTALLED TO ENSURE THAT MOISTURE IN WALLS WILL BE DIRECTED TO WICKS AND WEEP HOLES.

22. COORDINATE ALL DIMENSIONS CONCERNING DOORS/PANELS/WINDOWS, STAIRS AND THEIR OPENINGS WITH PRODUCT MANUFACTURERS PRIOR TO FABRICATION AND CONSTRUCTION.

23. PROVIDE WEATHERSTRIP AT EXTERIOR DOORS

24. PROVIDE FLASHING AND/OR SEALANT AT OPENINGS IN ROOF OR WALLS TO ENSURE A WEATHERTIGHT BUILDING.

25. LOCATE THERMOSTATS ADJACENT TO SWITCH PLATES WHERE POSSIBLE. VERIFY LOCATION WITH THE ARCHITECT PRIOR TO INSTALLATION TO AVOID CONFLICTS WITH BUILT-INS OR SYSTEMS FURNITURE OR DESIGN ELEMENTS.

26. ALIGN OUTLETS, WALL SWITCHES, TEL-DATA JACKS, ETC.,

INDICATED TO BE MOUNTED AT NEAR EQUIVALENT ELEVATIONS. 27. ALL DOORS SHALL BE LOCATED 6" OFF THE ADJACENT PARTITION, OR ONE MASONRY COURSE AT CMU PARTITIONS, UNLESS NOTED OTHERWISE.

28. DURING DEMOLITION AND CONSTRUCTION PROTECT ALL EXISTING FINISHES TO REMAIN.

29. ALL WOOD SHALL BE FSC CERTIFIED.

30. ALL WOOD FRAMING SIZES ARE BASED ON SPF-SS

31. ALL WOOD IN CONTACT WITH CONCRETE OR MASONRY SHALL BE PRESSURE TREATED (P.T.).

32. CORRECT ALL DEFECTS FOUND IN EXISTING BUILDING WHICH INTERFERE WITH NEW CONSTRUCTION. THIS INCLUDES BUT IS NOT LIMITED TO UNEVEN SURFACES AND FINISHES AT GWB.

1 P-GENERAL NOTES 1 1/2" = 1'-0"



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REGISTRATIONS:

STRUCTURAL ENGINEER:

Ш

TRISH

ST. RESIDENC S ALPINE BRIDGE % | | | | |


38

02

BZA SUBMISSION SET Project Number Project number

Date 11/13/2020 Drawn by Author Checker Checked by

Scale 1 1/2" = 1'-0"

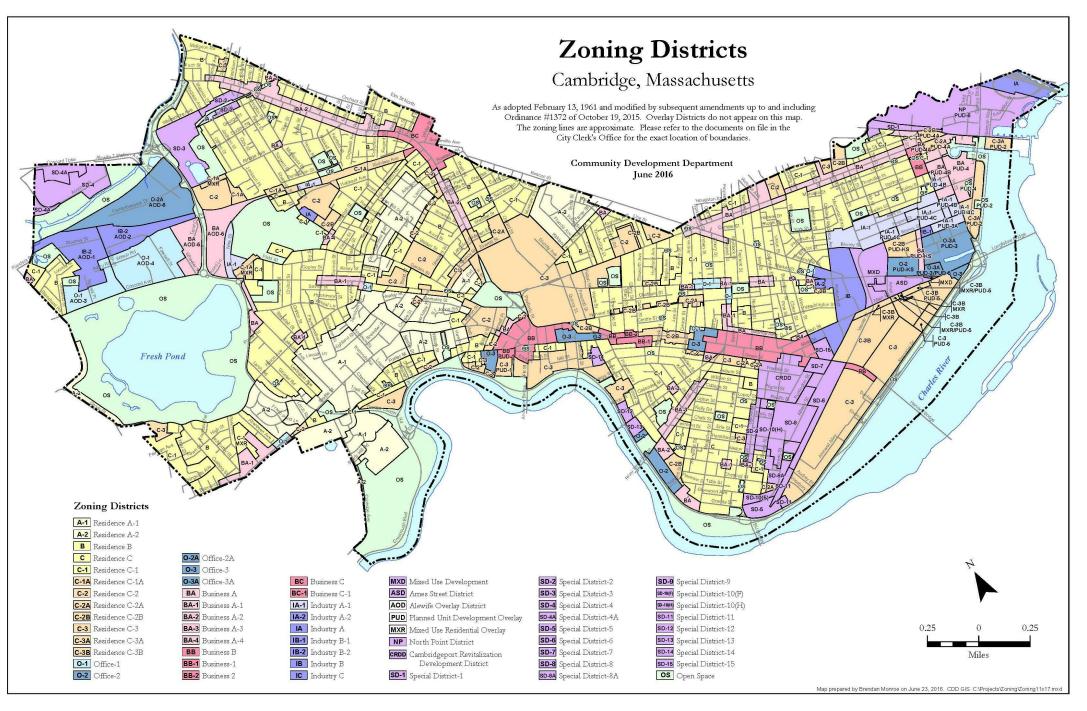

	EXIS	TING FAR		
Level	Area	Comments	Count	Name
	·			
EXISTING LEVEL 1	982 SF		1	FINISHED
EXISTING LEVEL 1	118 SF		1	FRONT PORCH
EXISTING LEVEL 1	64 SF		1	BACK DECK
EXISTING LEVEL 2	918 SF		1	FINISHED
EXISTING LEVEL 2	63 SF		1	DECK
EXISTING LEVEL 2	118 SF		1	PORCH
	'	•	•	<u>'</u>
PROPOSED LEVEL 3	528 SF		1	ATTIC
	2791 SF	'	•	'

Proposed FAR				
Level	Area	Comments	Count	Name
EXISTING LEVEL 1	69 SF		1	PORCH
EXISTING LEVEL 1	1000 SF		1	FINISHED
EXISTING LEVEL 1	84 SF		1	DECK
EXISTING LEVEL 1	55 SF		1	STAIRWELL
EXISTING LEVEL 2	1073 SF		1	FINISHED
EXISTING LEVEL 2	79 SF		1	DECK
PROPOSED LEVEL 3	925 SF		1	FINISHED
	3285 SF			

ZONE: RESIDENCE B SINGLE- & TWO-FAMILY DETACHED DWELLING TOWNHOUSE DWELLINGS

FRONT YARD SETBACK: 15' LEFT SIDE SETBACK: 4' - 6" RIGHT SIDE SETBACK: 7' - 6" REAR YARD SETBACK: 25'

35' MAXIMUM BUILDING HEIGHT

LOT SIZE: 3,800 SQ. FT.

MAXIMUM FAR: 0.50 EXISTING FAR = .73PROPOSED FAR = .86

PROPOSED FAR INCREASE = .13

EXISTING OPEN SPACE: MINIMUM 40% REQUIREMENT

EXISTING OPEN SPACE: .61

NEW OPEN SPACE: .59

EXISTING RIDGE HEIGHT= 29' - 0"

NEW RIDGE HEIGHT = 35' - 0"

INCREASE ROOF HEIGHT= 6' - 0"

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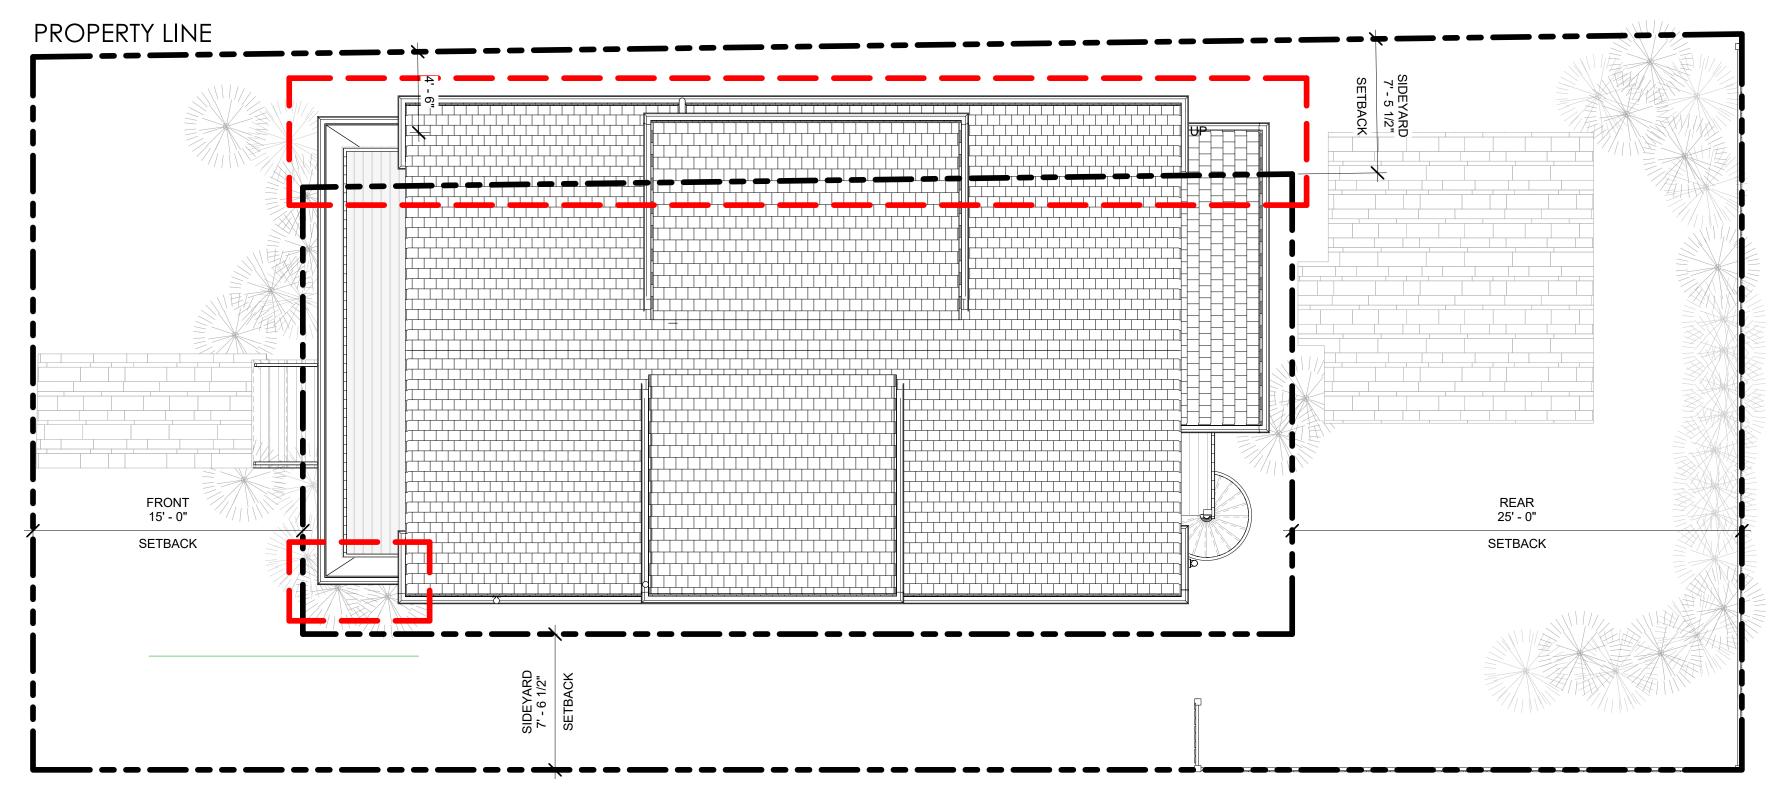
Project Status	BZA SUBMISSION SET
Project number	Project Number
Date	11/13/2020
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Checked by	Checker

P-002

As indicated

<u>DECK</u> 141 SF Existing FAR Proposed FAR ATTIC DECK 9 P-EXISTING LEVEL 3 1/16" = 1'-0" FINISHED 5 P-PROPOSED LEVEL 3 1/16" = 1'-0"





PROPOSED EXISTING







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94-96 ALPINE ST. CAMBRIDGE, MA

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P-004

1" = 30'-0"







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P-005







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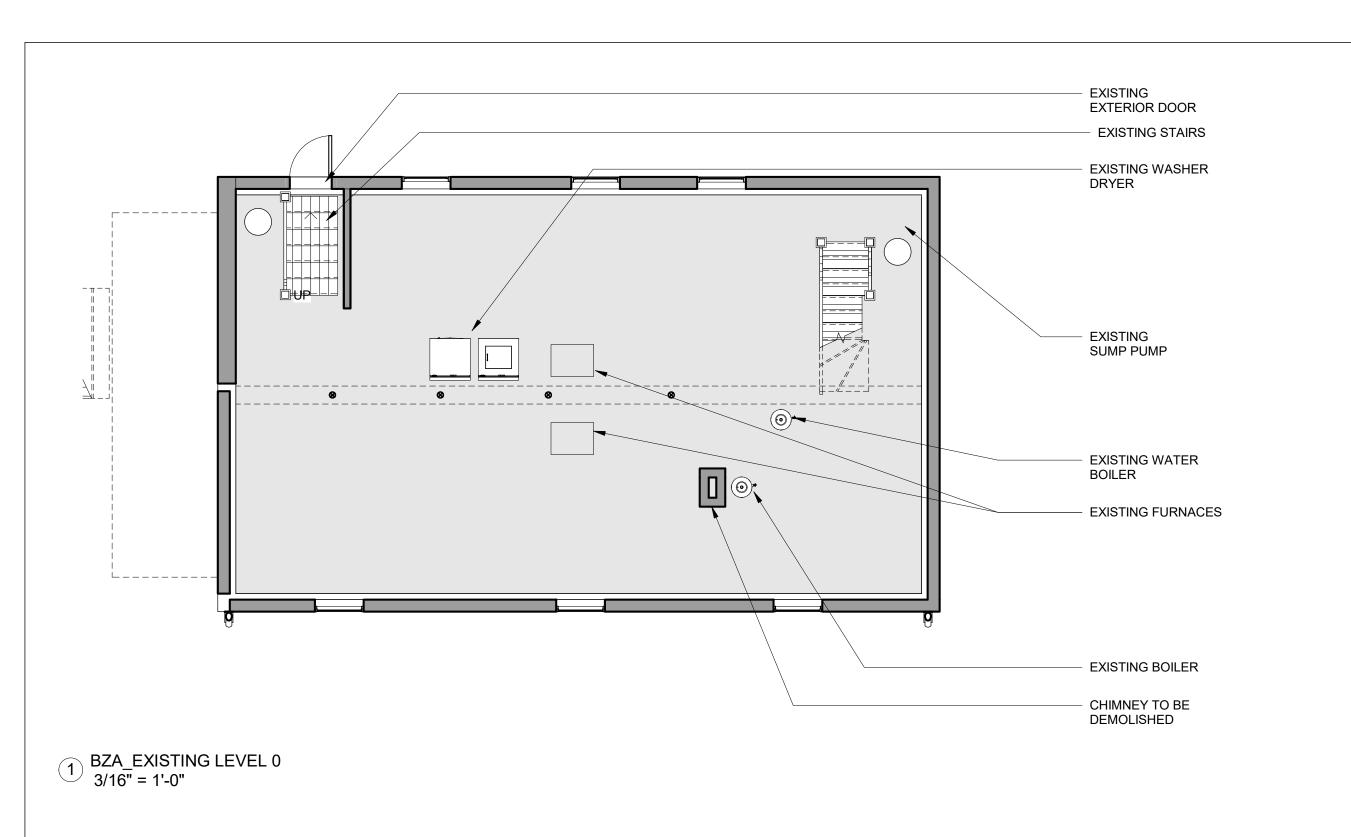
TREET VIEW PERSPECTIVE


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P-006

Scale





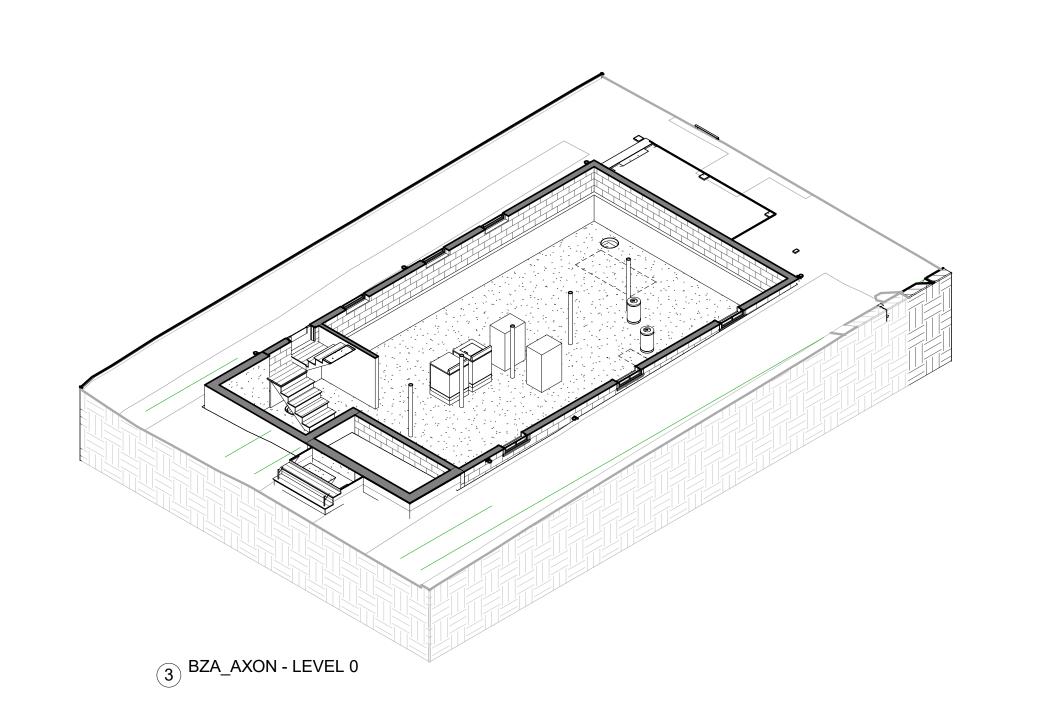

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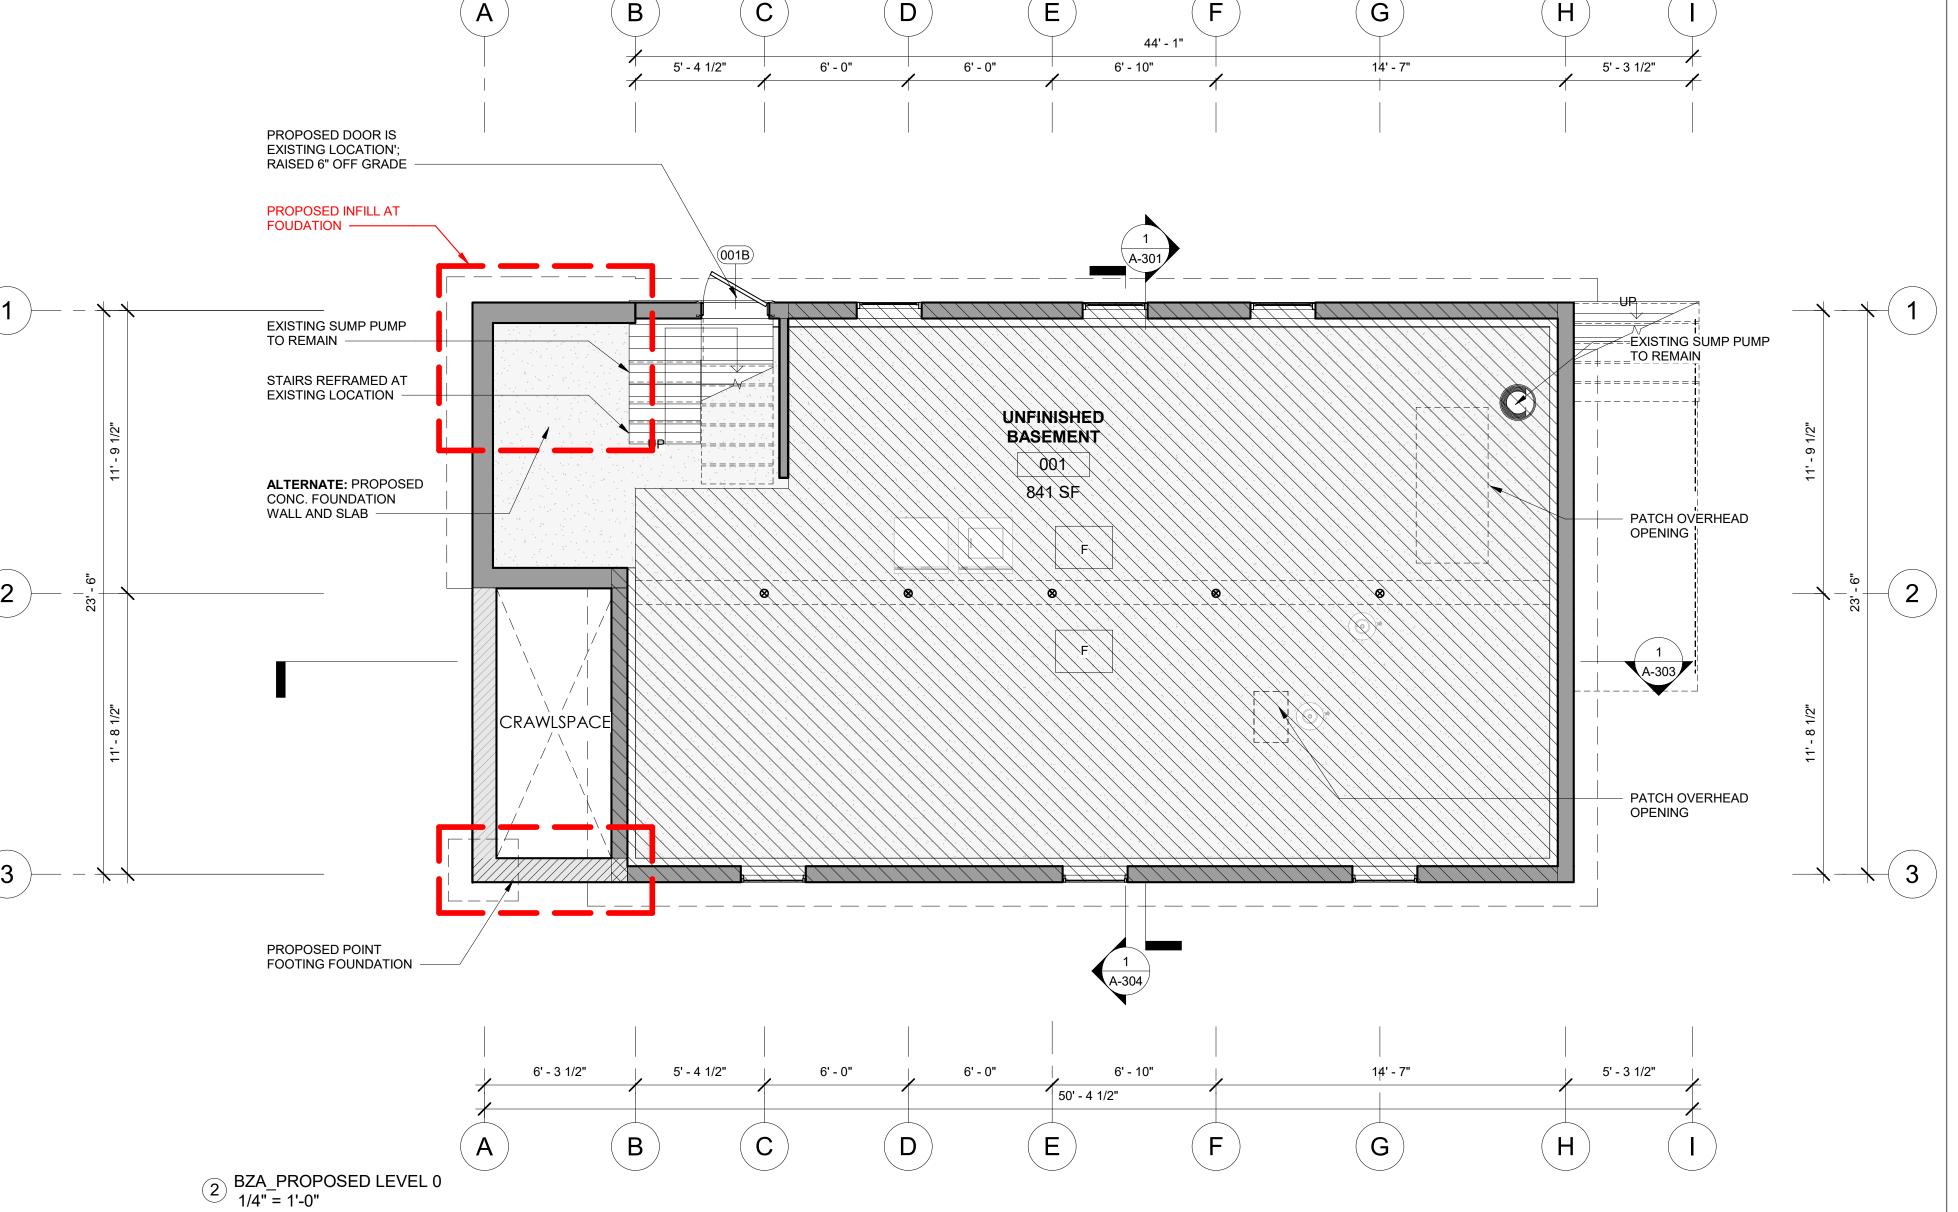
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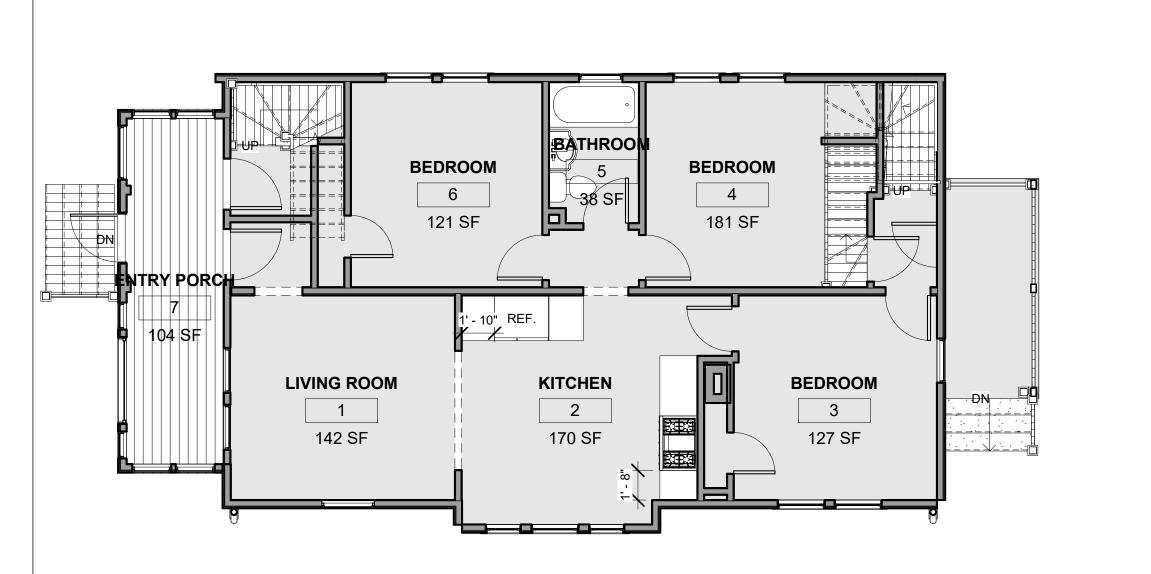
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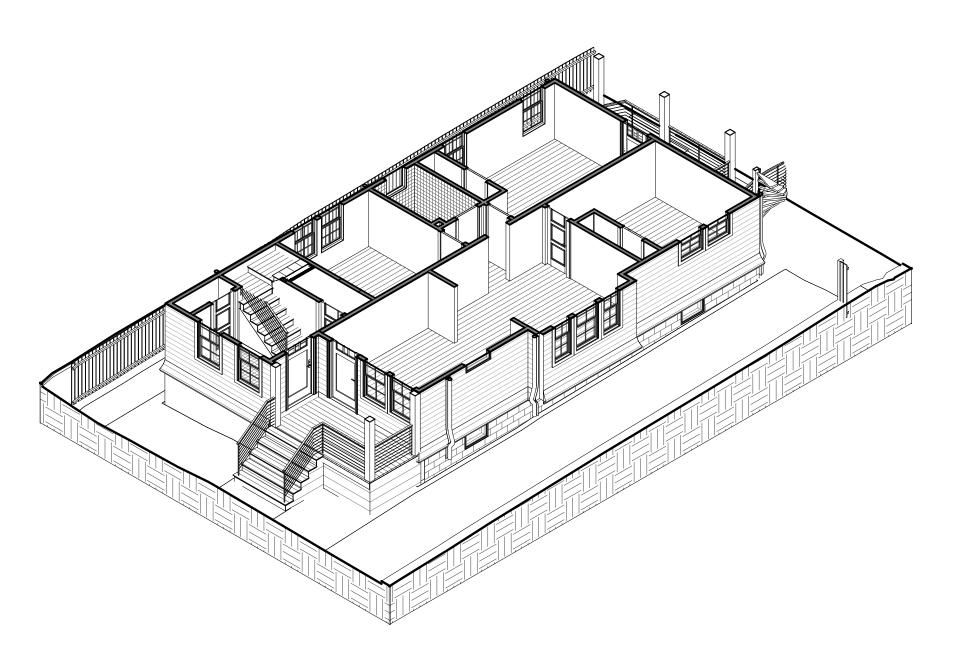
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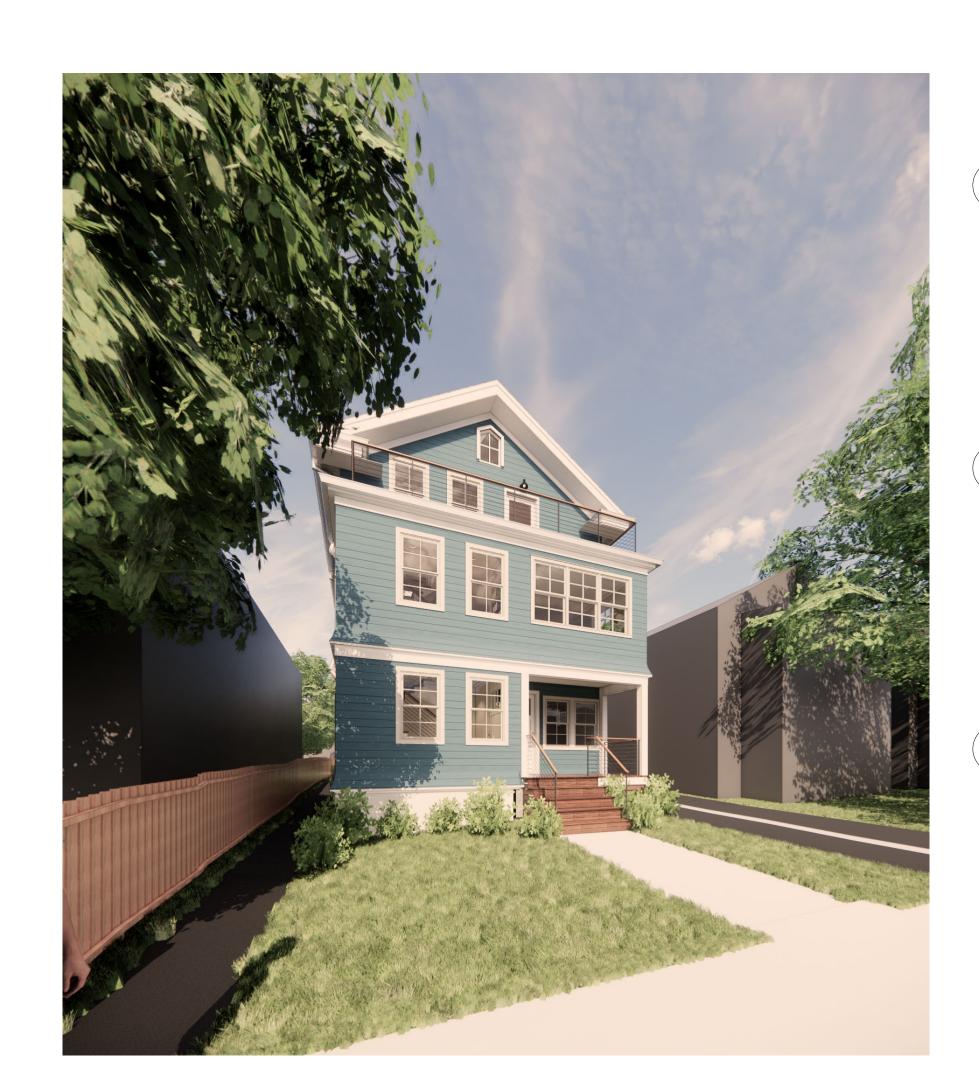





1 BZA_EXISTING LEVEL 1 3/16" = 1'-0"



BZA_AXON - PROPOSED LEVEL 1



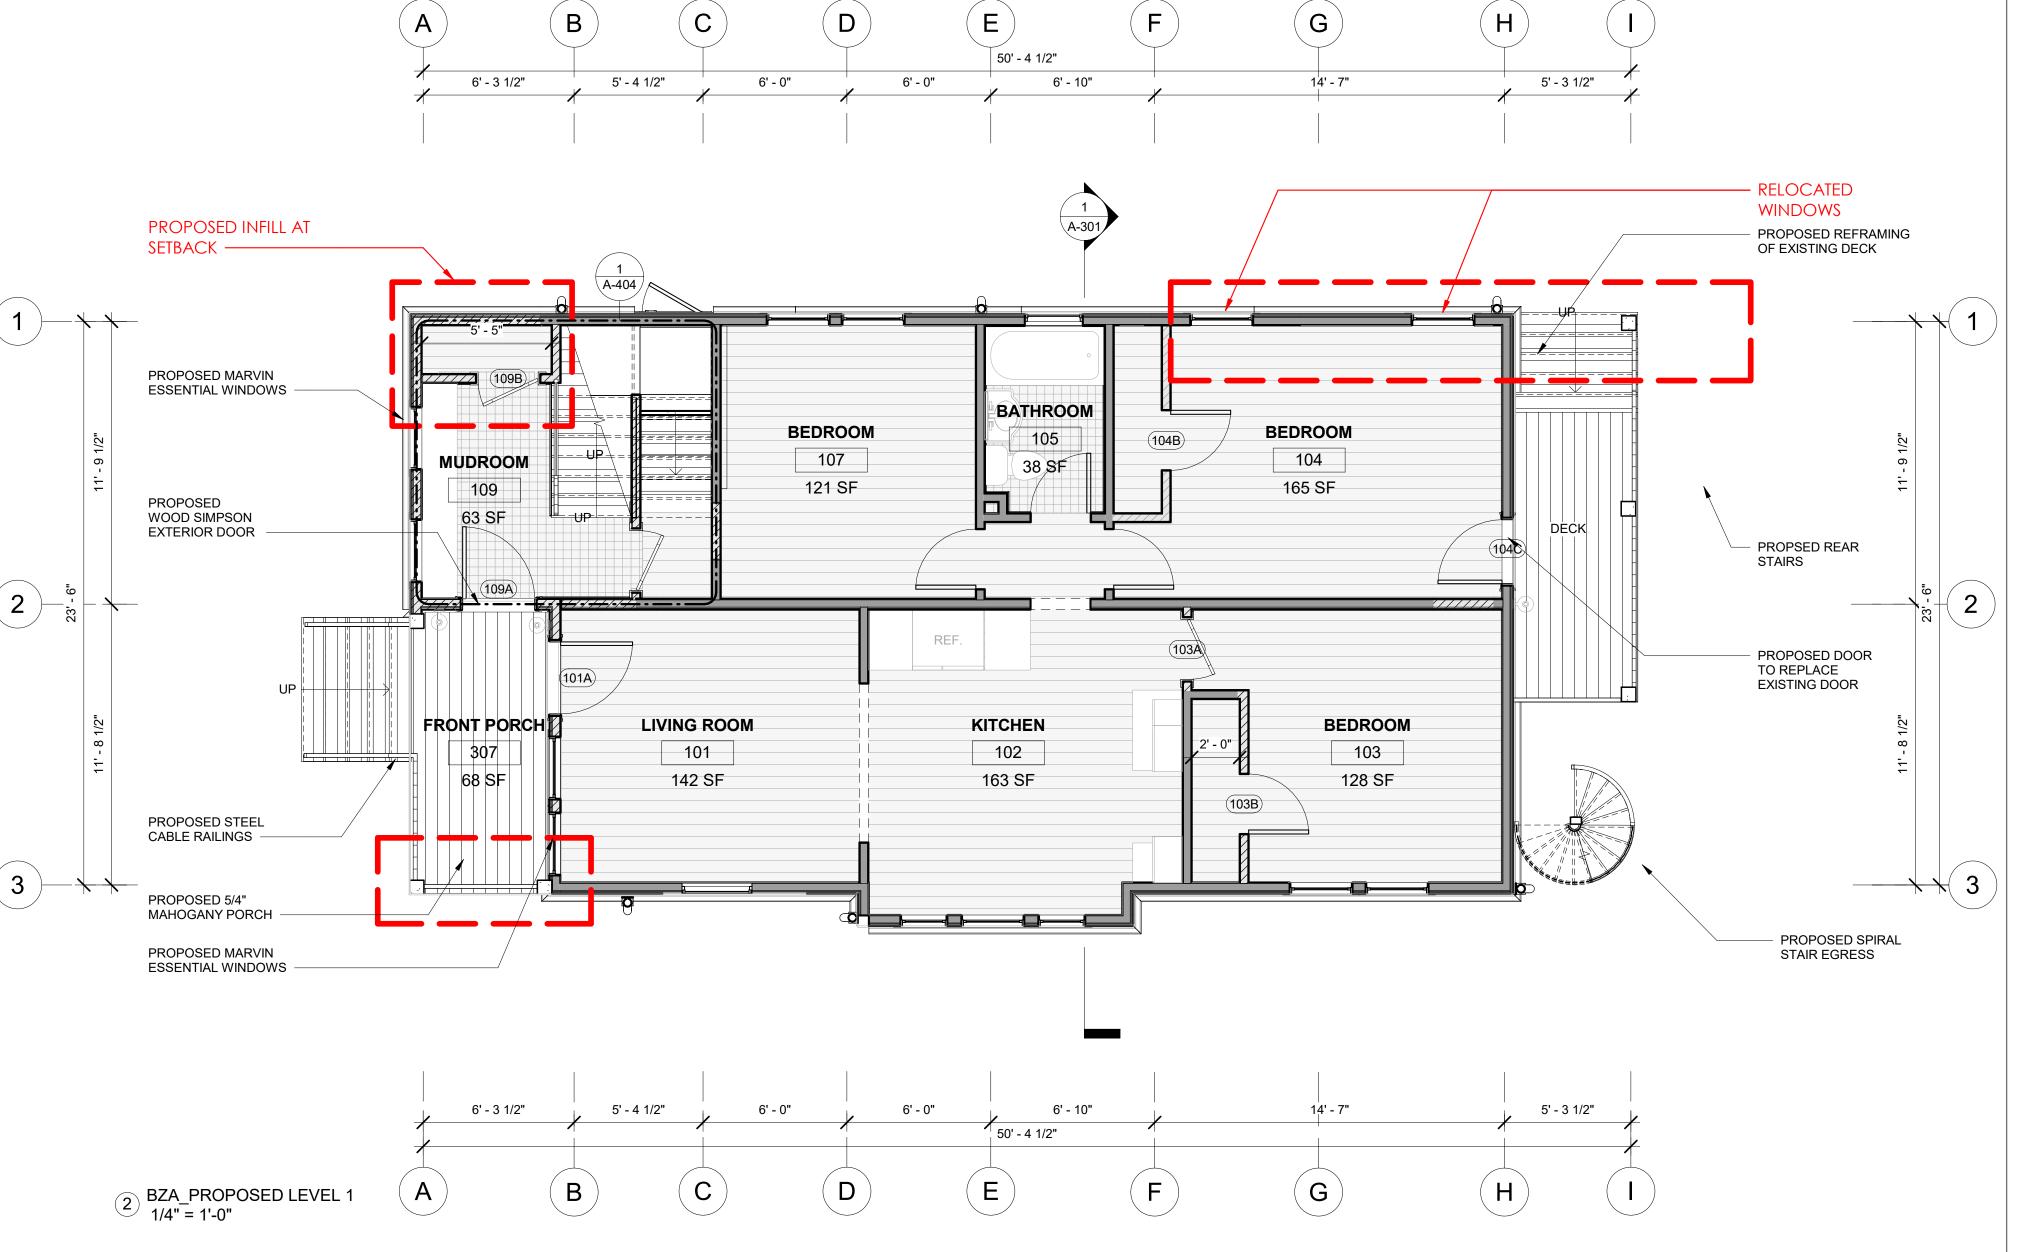

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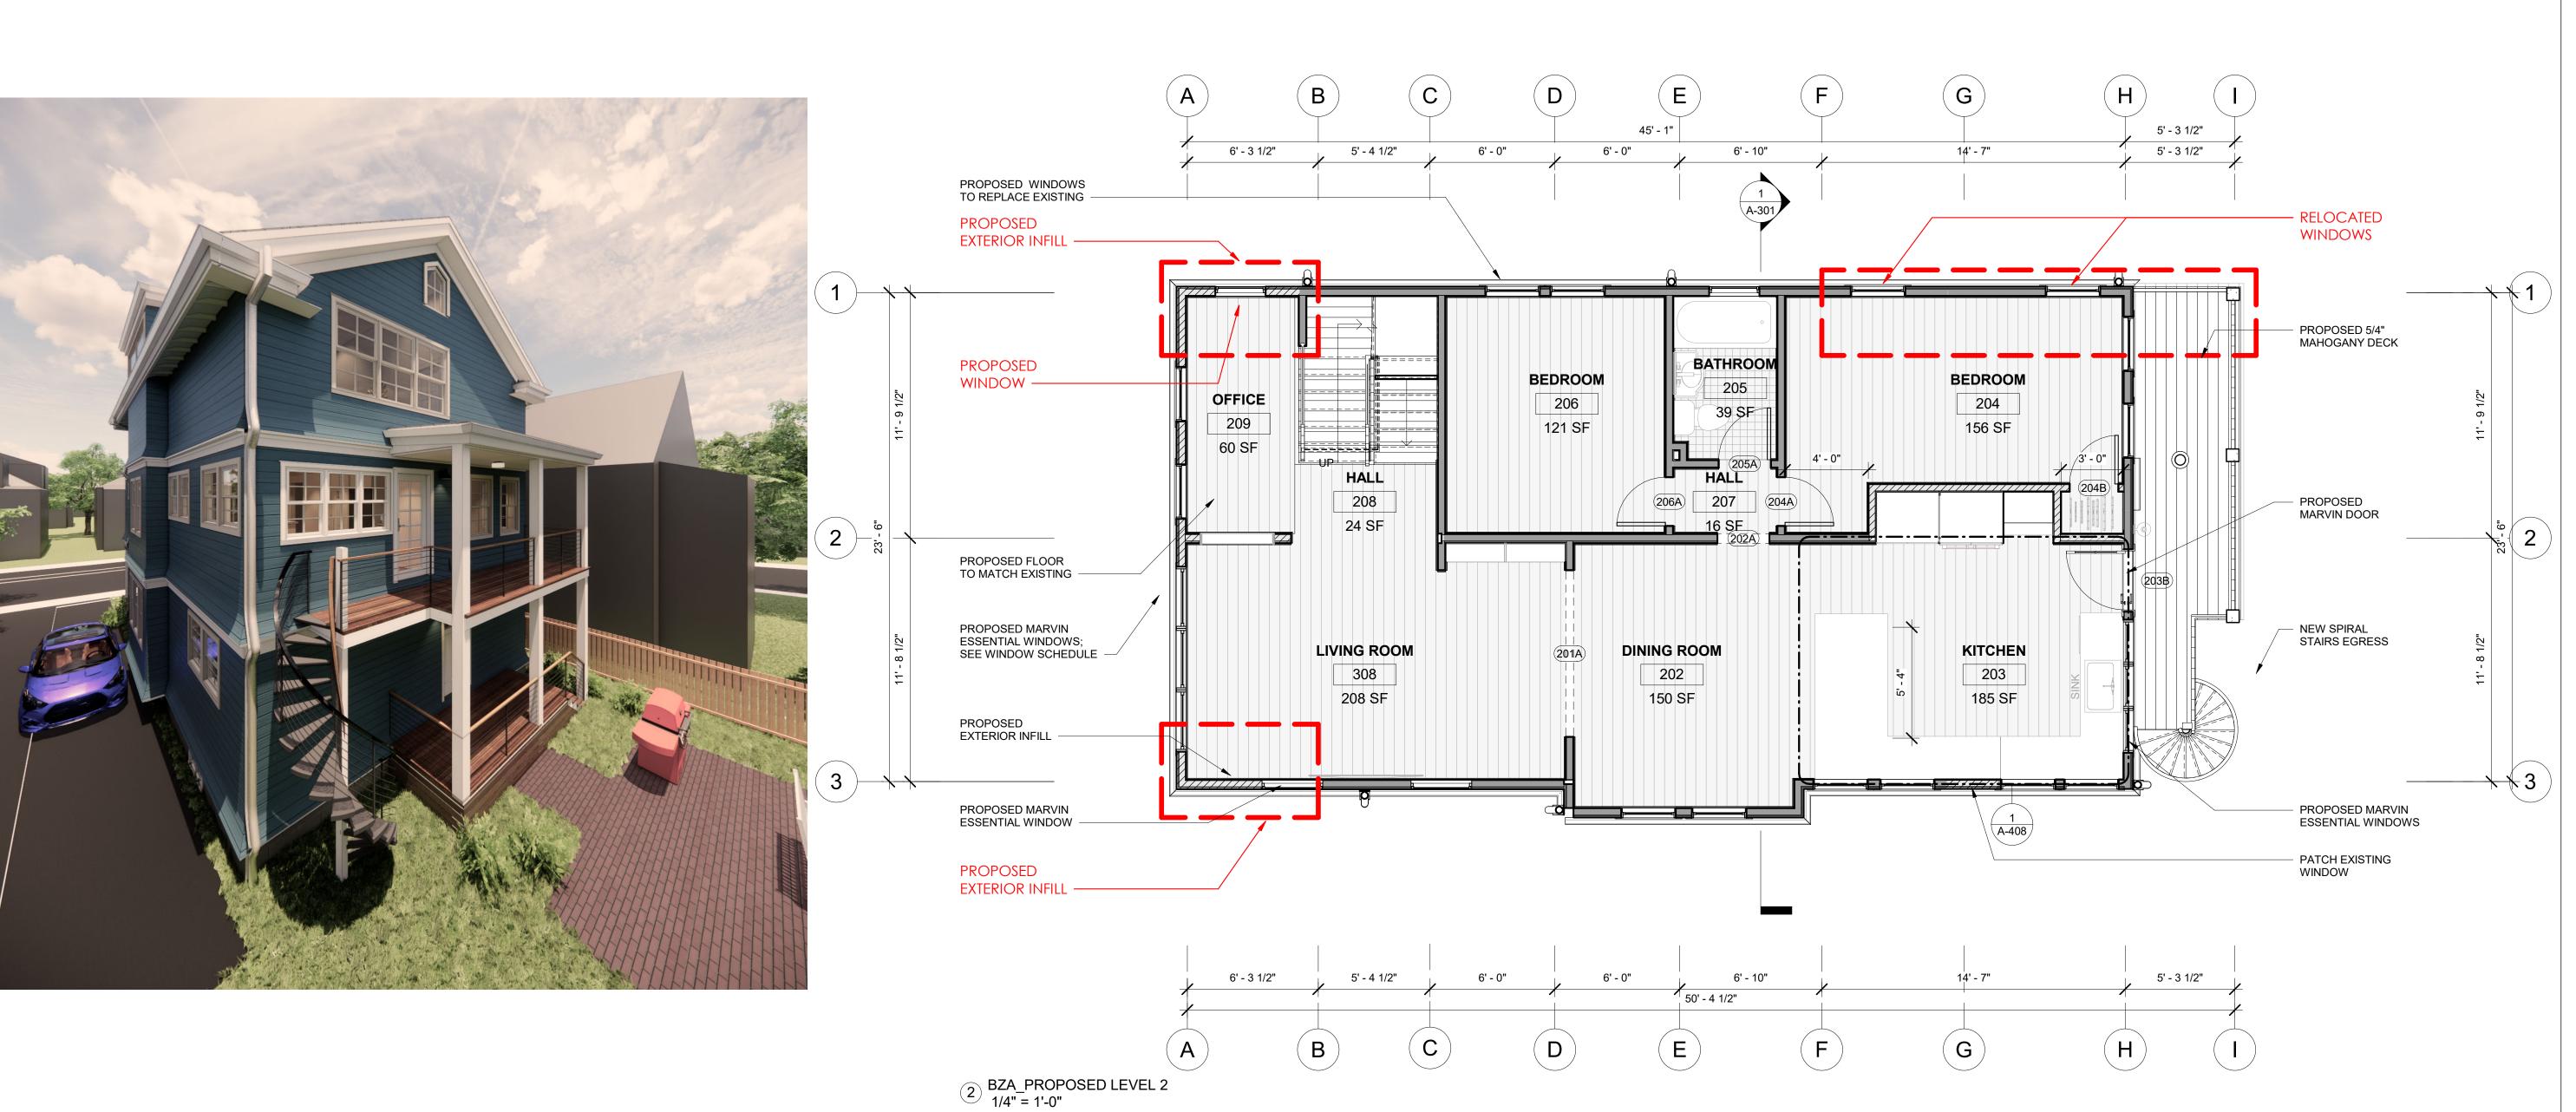
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94-96 ALPINE ST. CAMBRIDGE, MA

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3 BZA_AXON - PROPOSED LEVEL 2

BEDROOM

13 110 SF

KITCHEN

11

171 SF

BEDROOM

12

16

LIVING ROOM

10

142 SF

104 SF

1 BZA_EXISTING LEVEL 2 3/16" = 1'-0"

STRUCTURAL ENGINEER:

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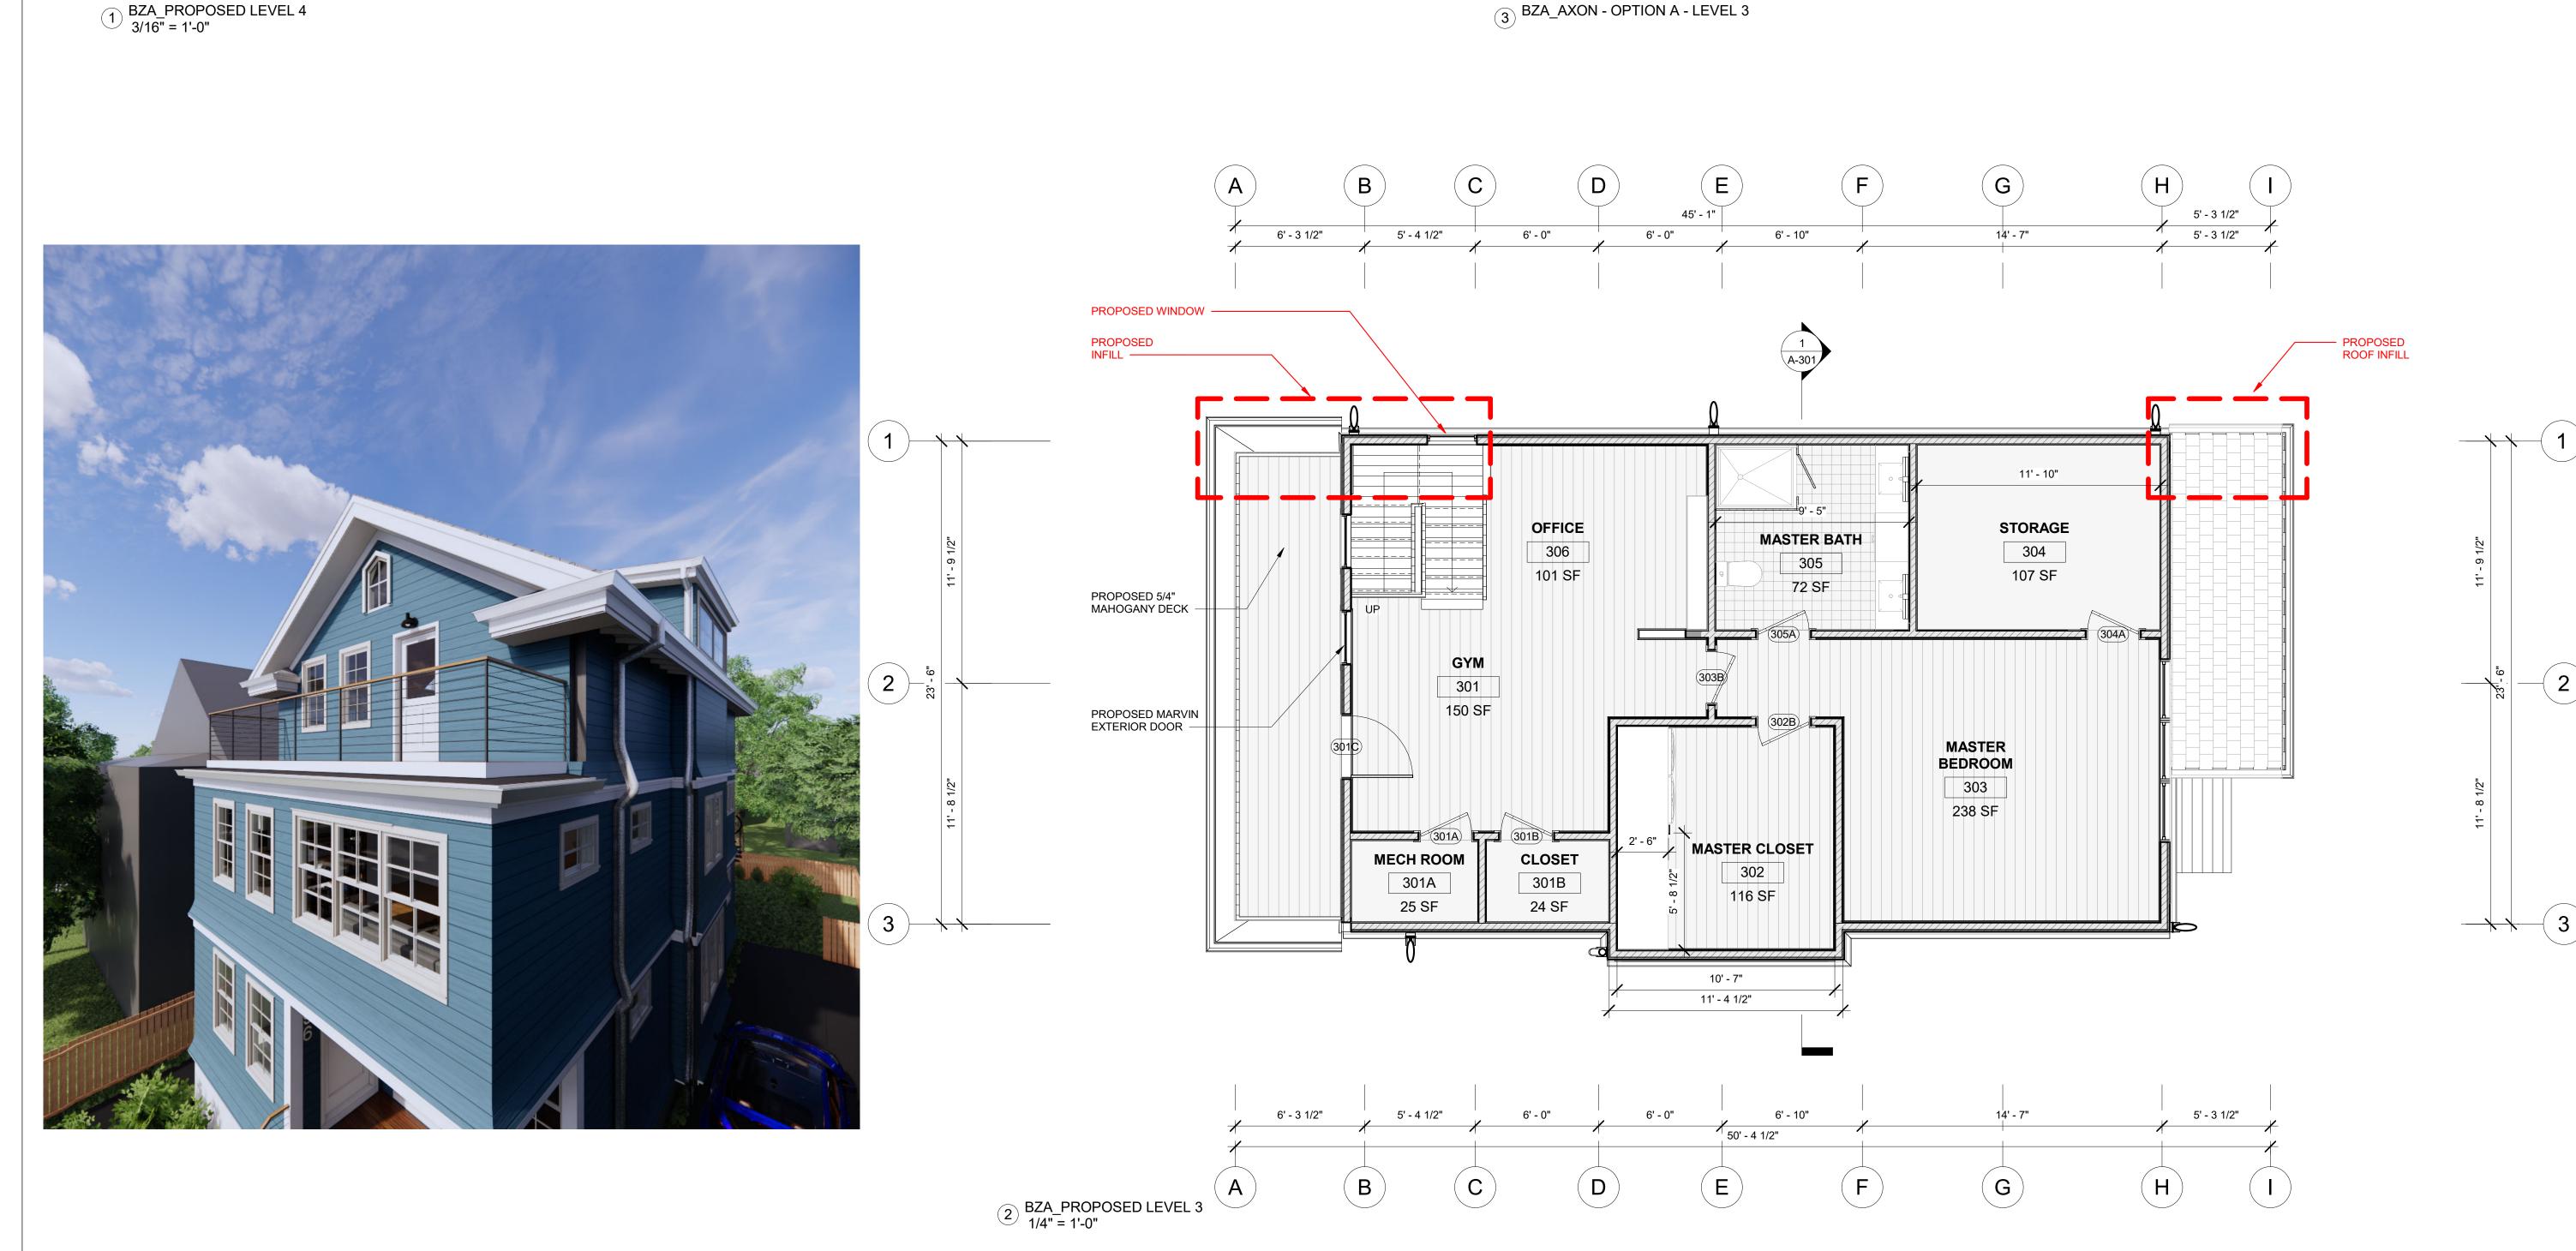
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STEVE Drawn by

TRISH NG



17

3 BZA_AXON - OPTION A - LEVEL 3

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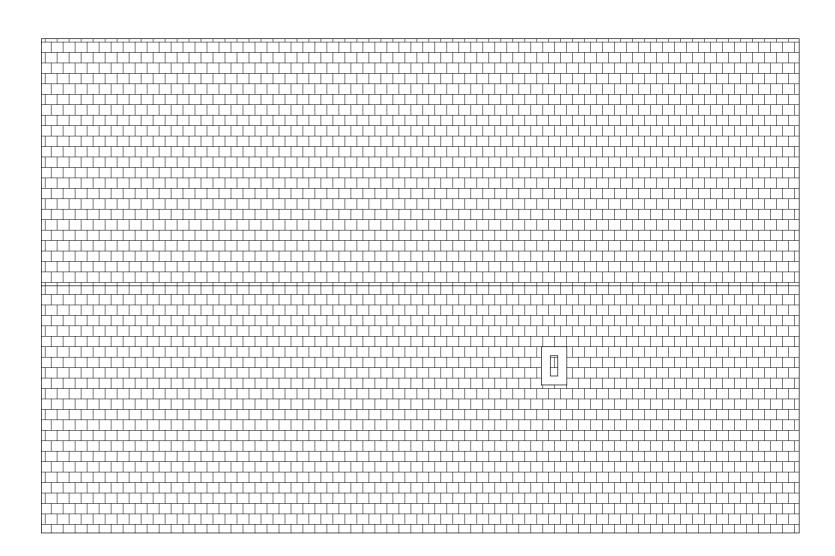
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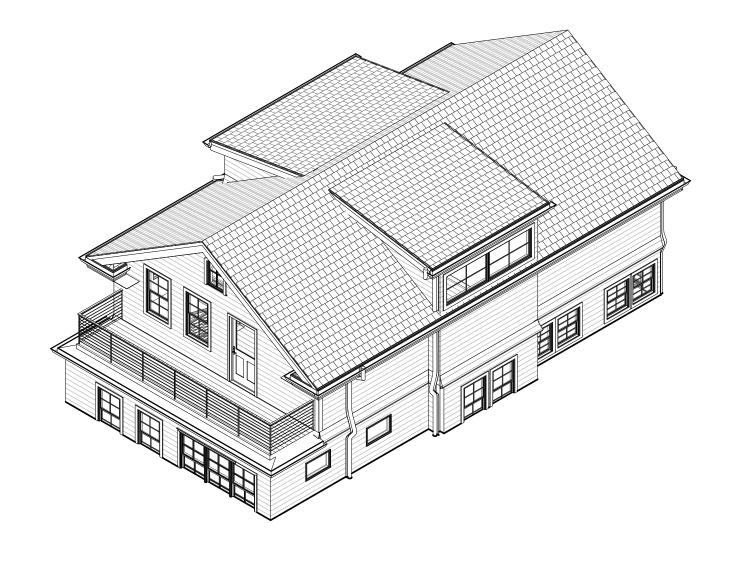
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P-103 Scale

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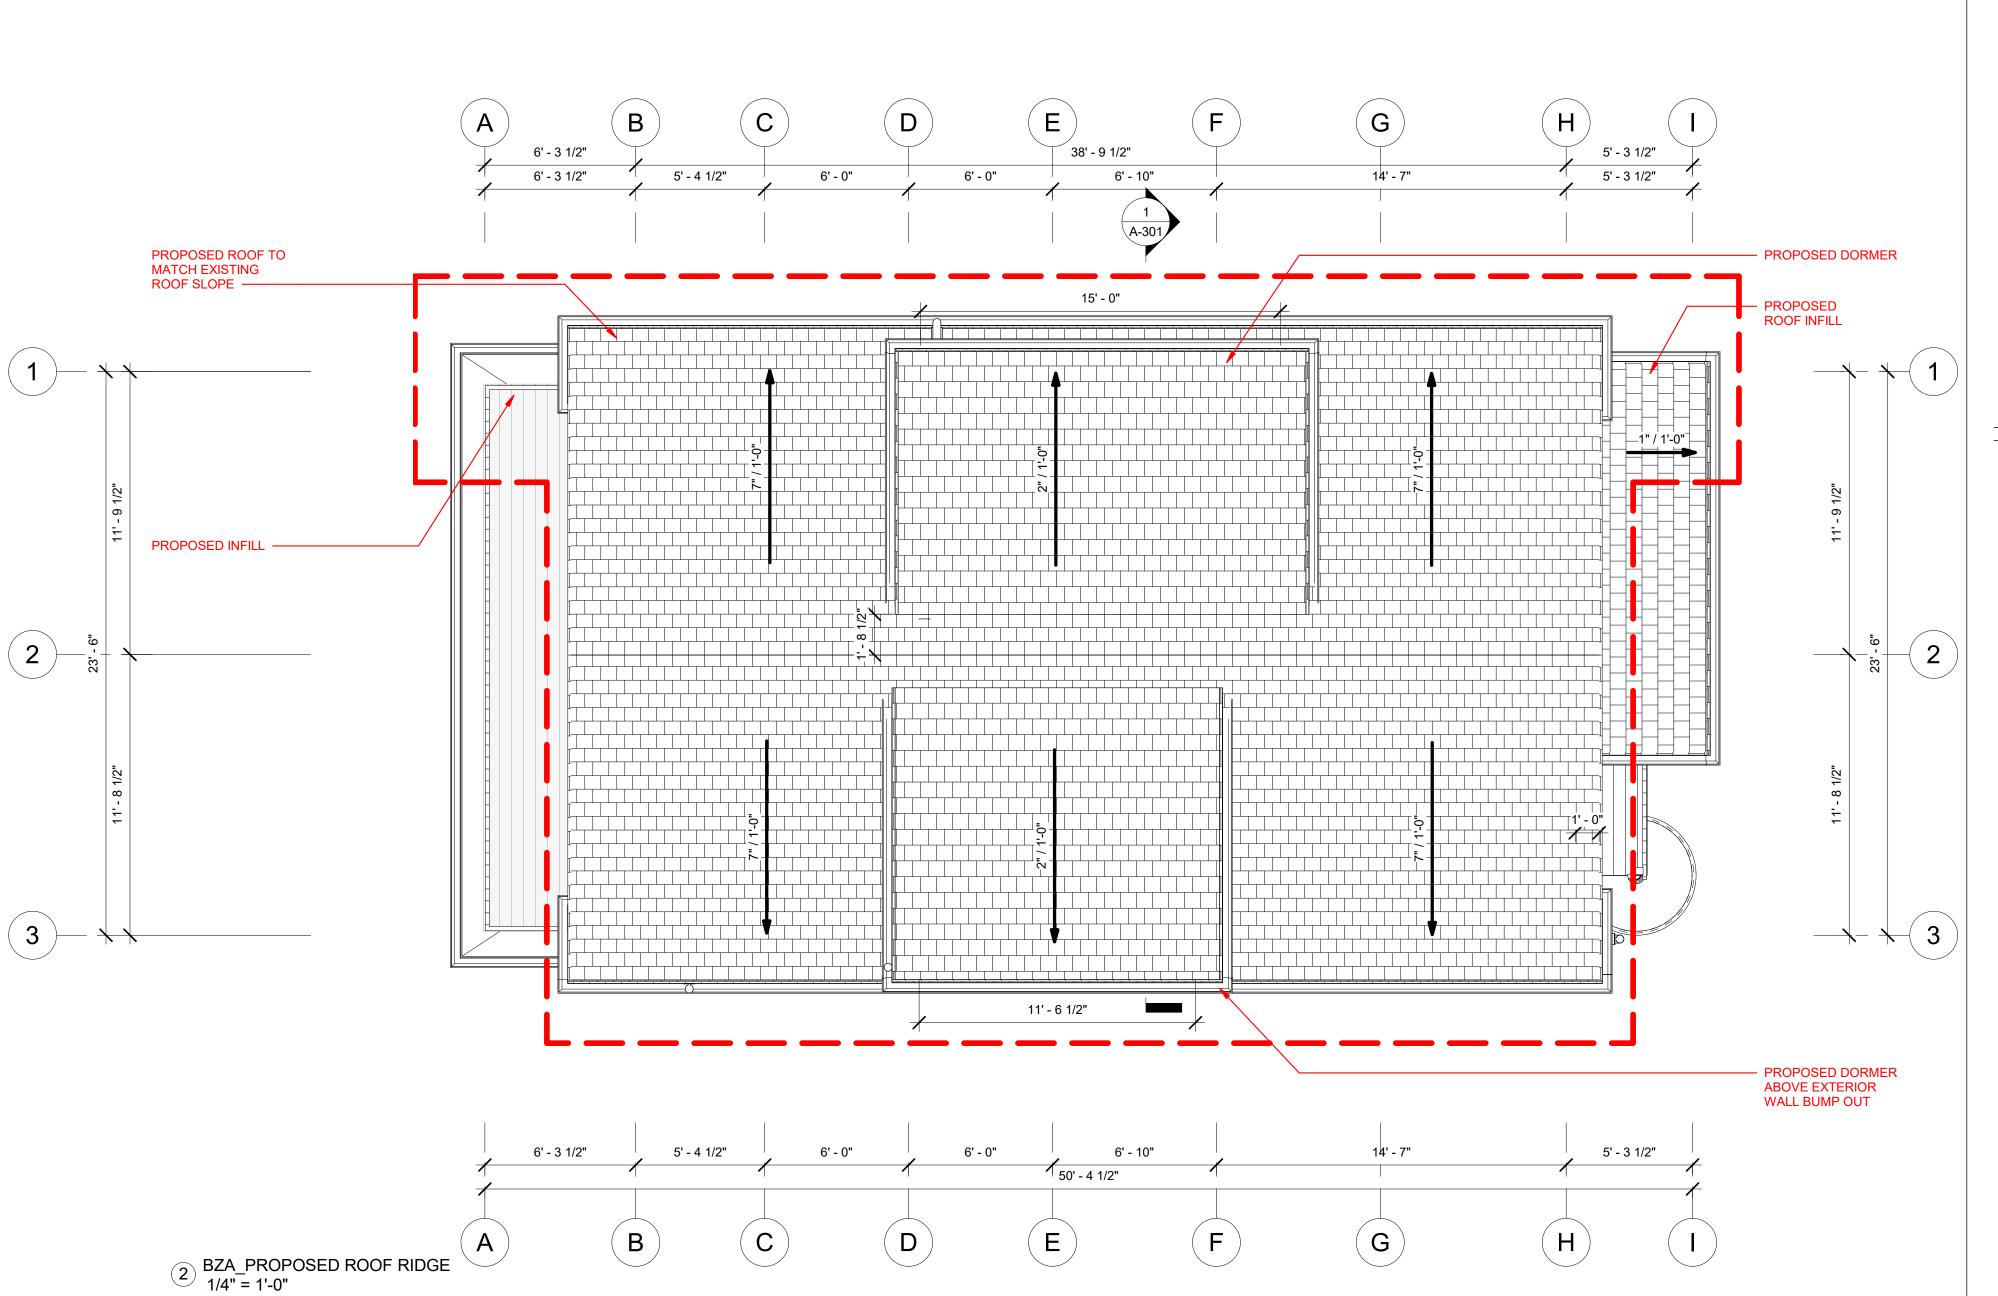


1 BZA_EXISTING ROOF RIDGE 3/16" = 1'-0"



3 BZA_AXON - ROOF LEVEL





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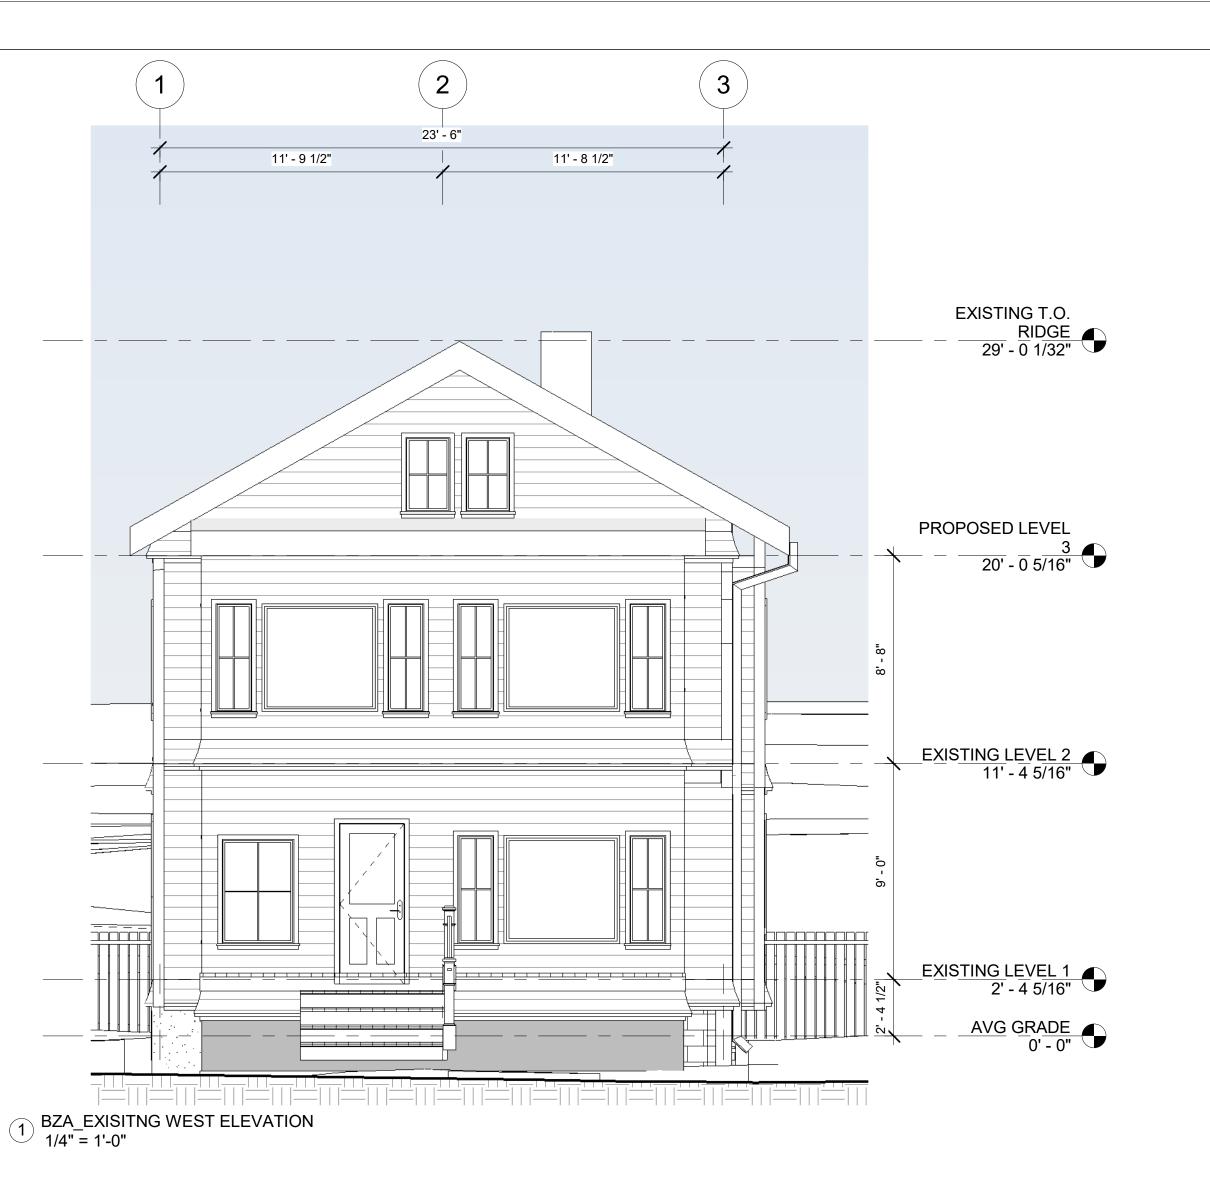
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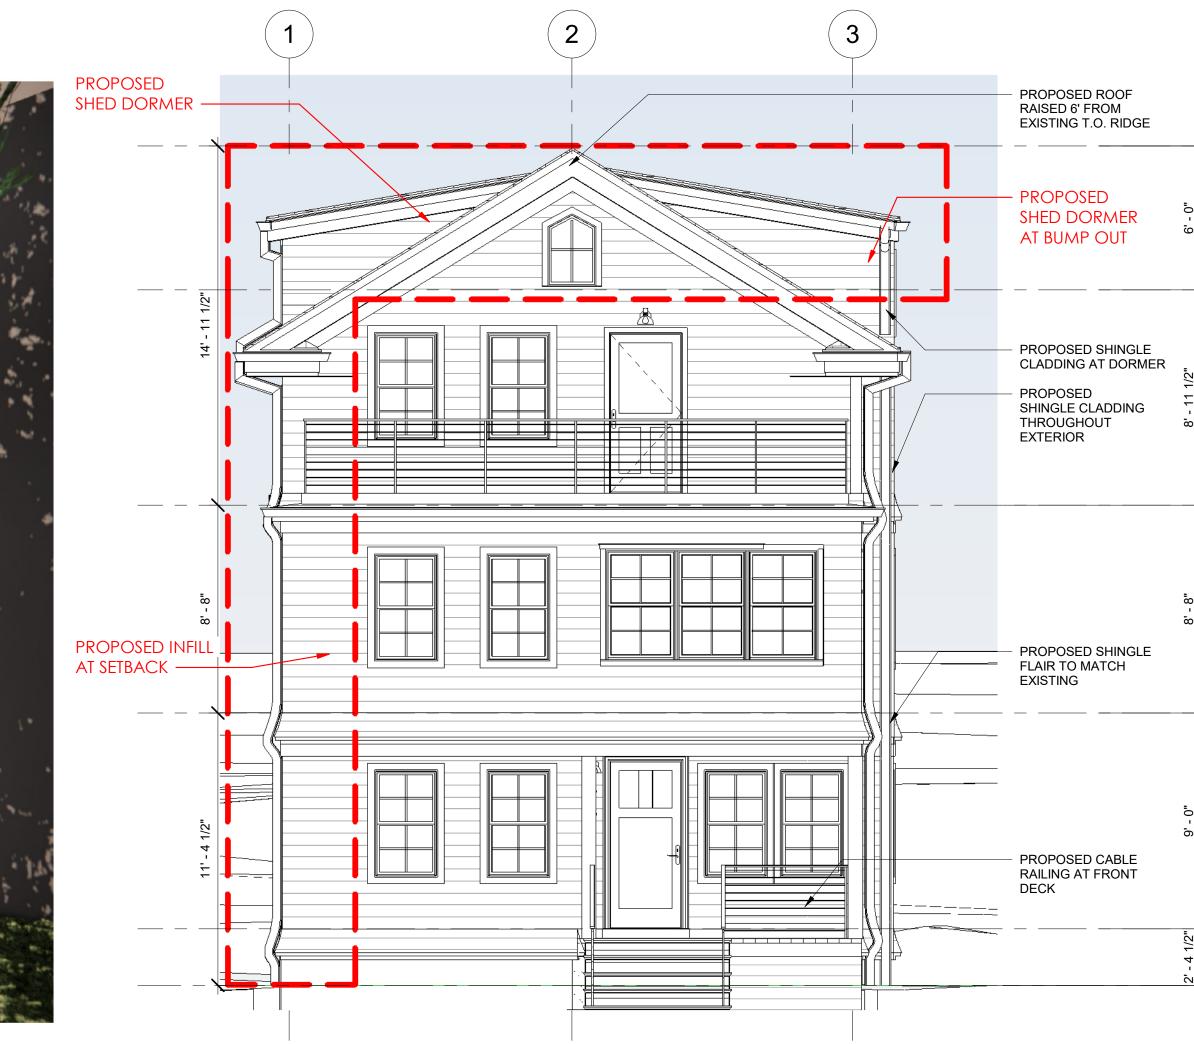
94-96 ALPINE ST. CAMBRIDGE, MA

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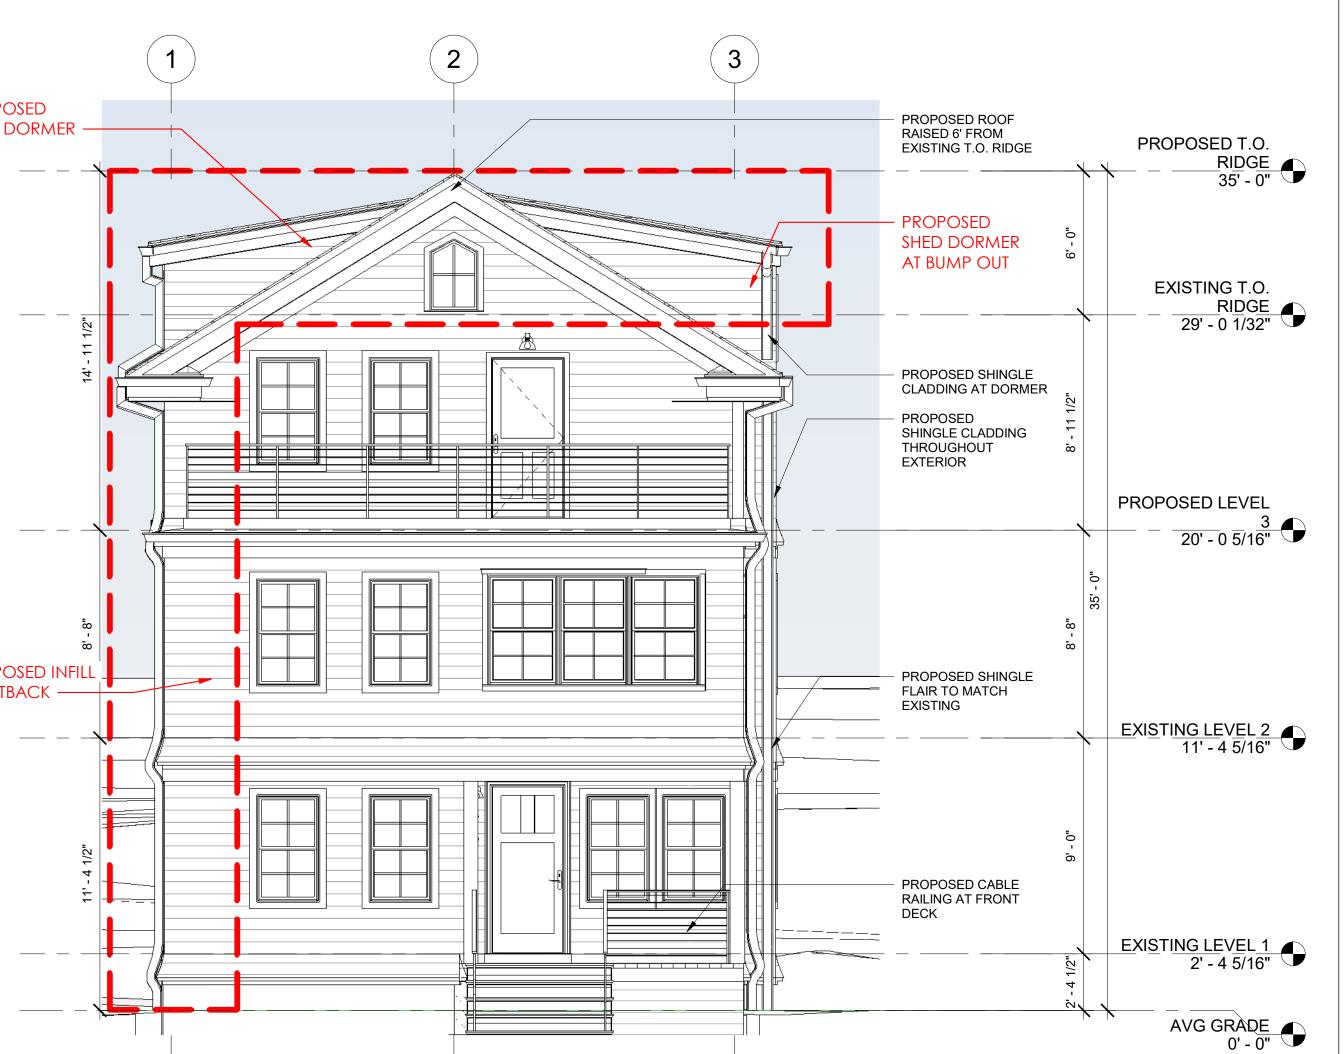
Scale As indicated







2 BZA_PROPOSED WEST ELEVATION 1/4" = 1'-0"





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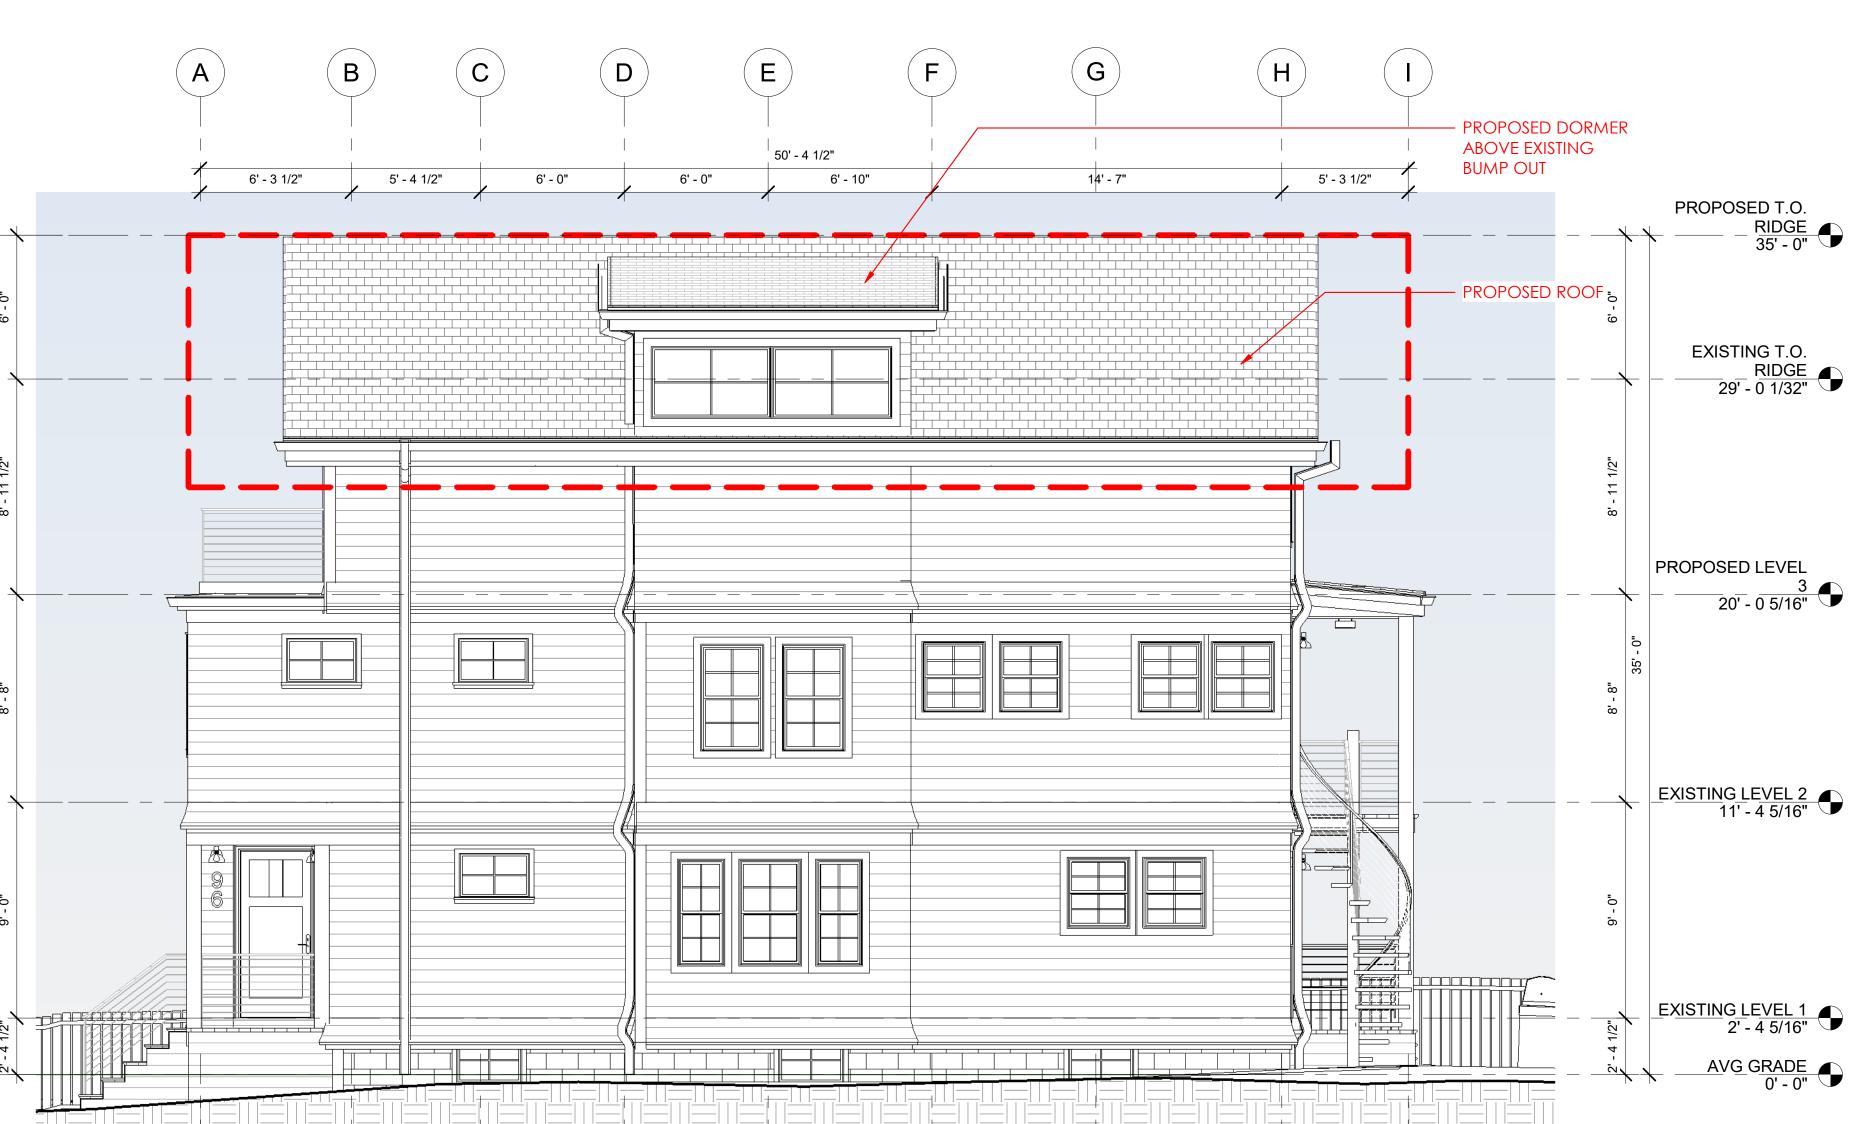
1/4" = 1'-0"











TRISH NG ∞ STEVE

NG RESIDENCE

02138


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P-201


Scale 1/4" = 1'-0"

2 BZA_PROPOSED SOUTH ELEVATION 1/4" = 1'-0"





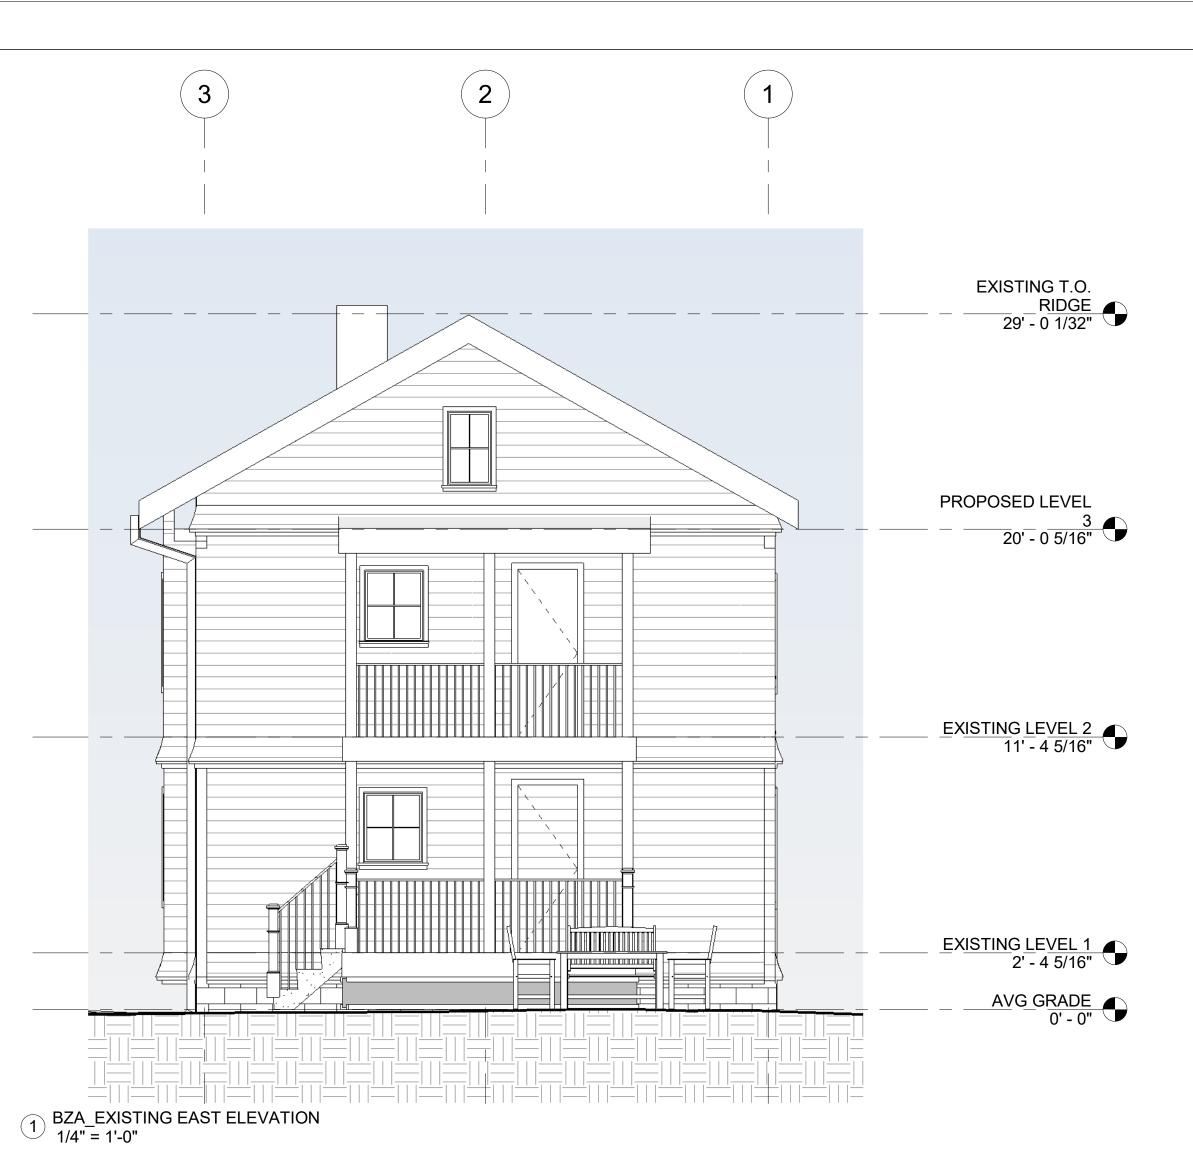

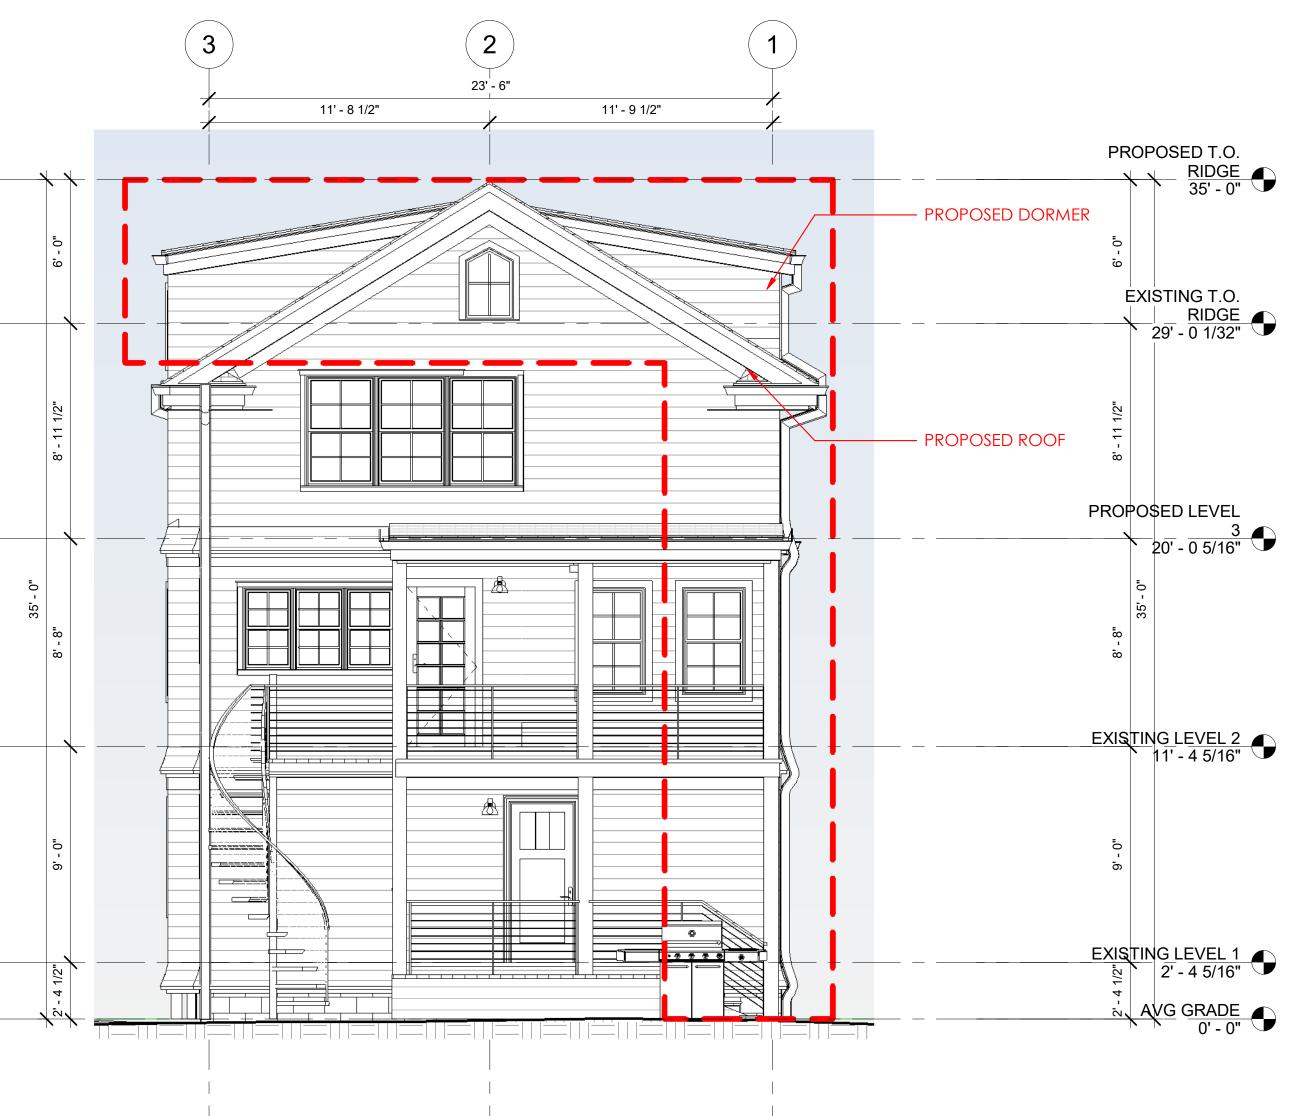

2 BZA_PROPOSED EAST ELEVATION 1/4" = 1'-0"



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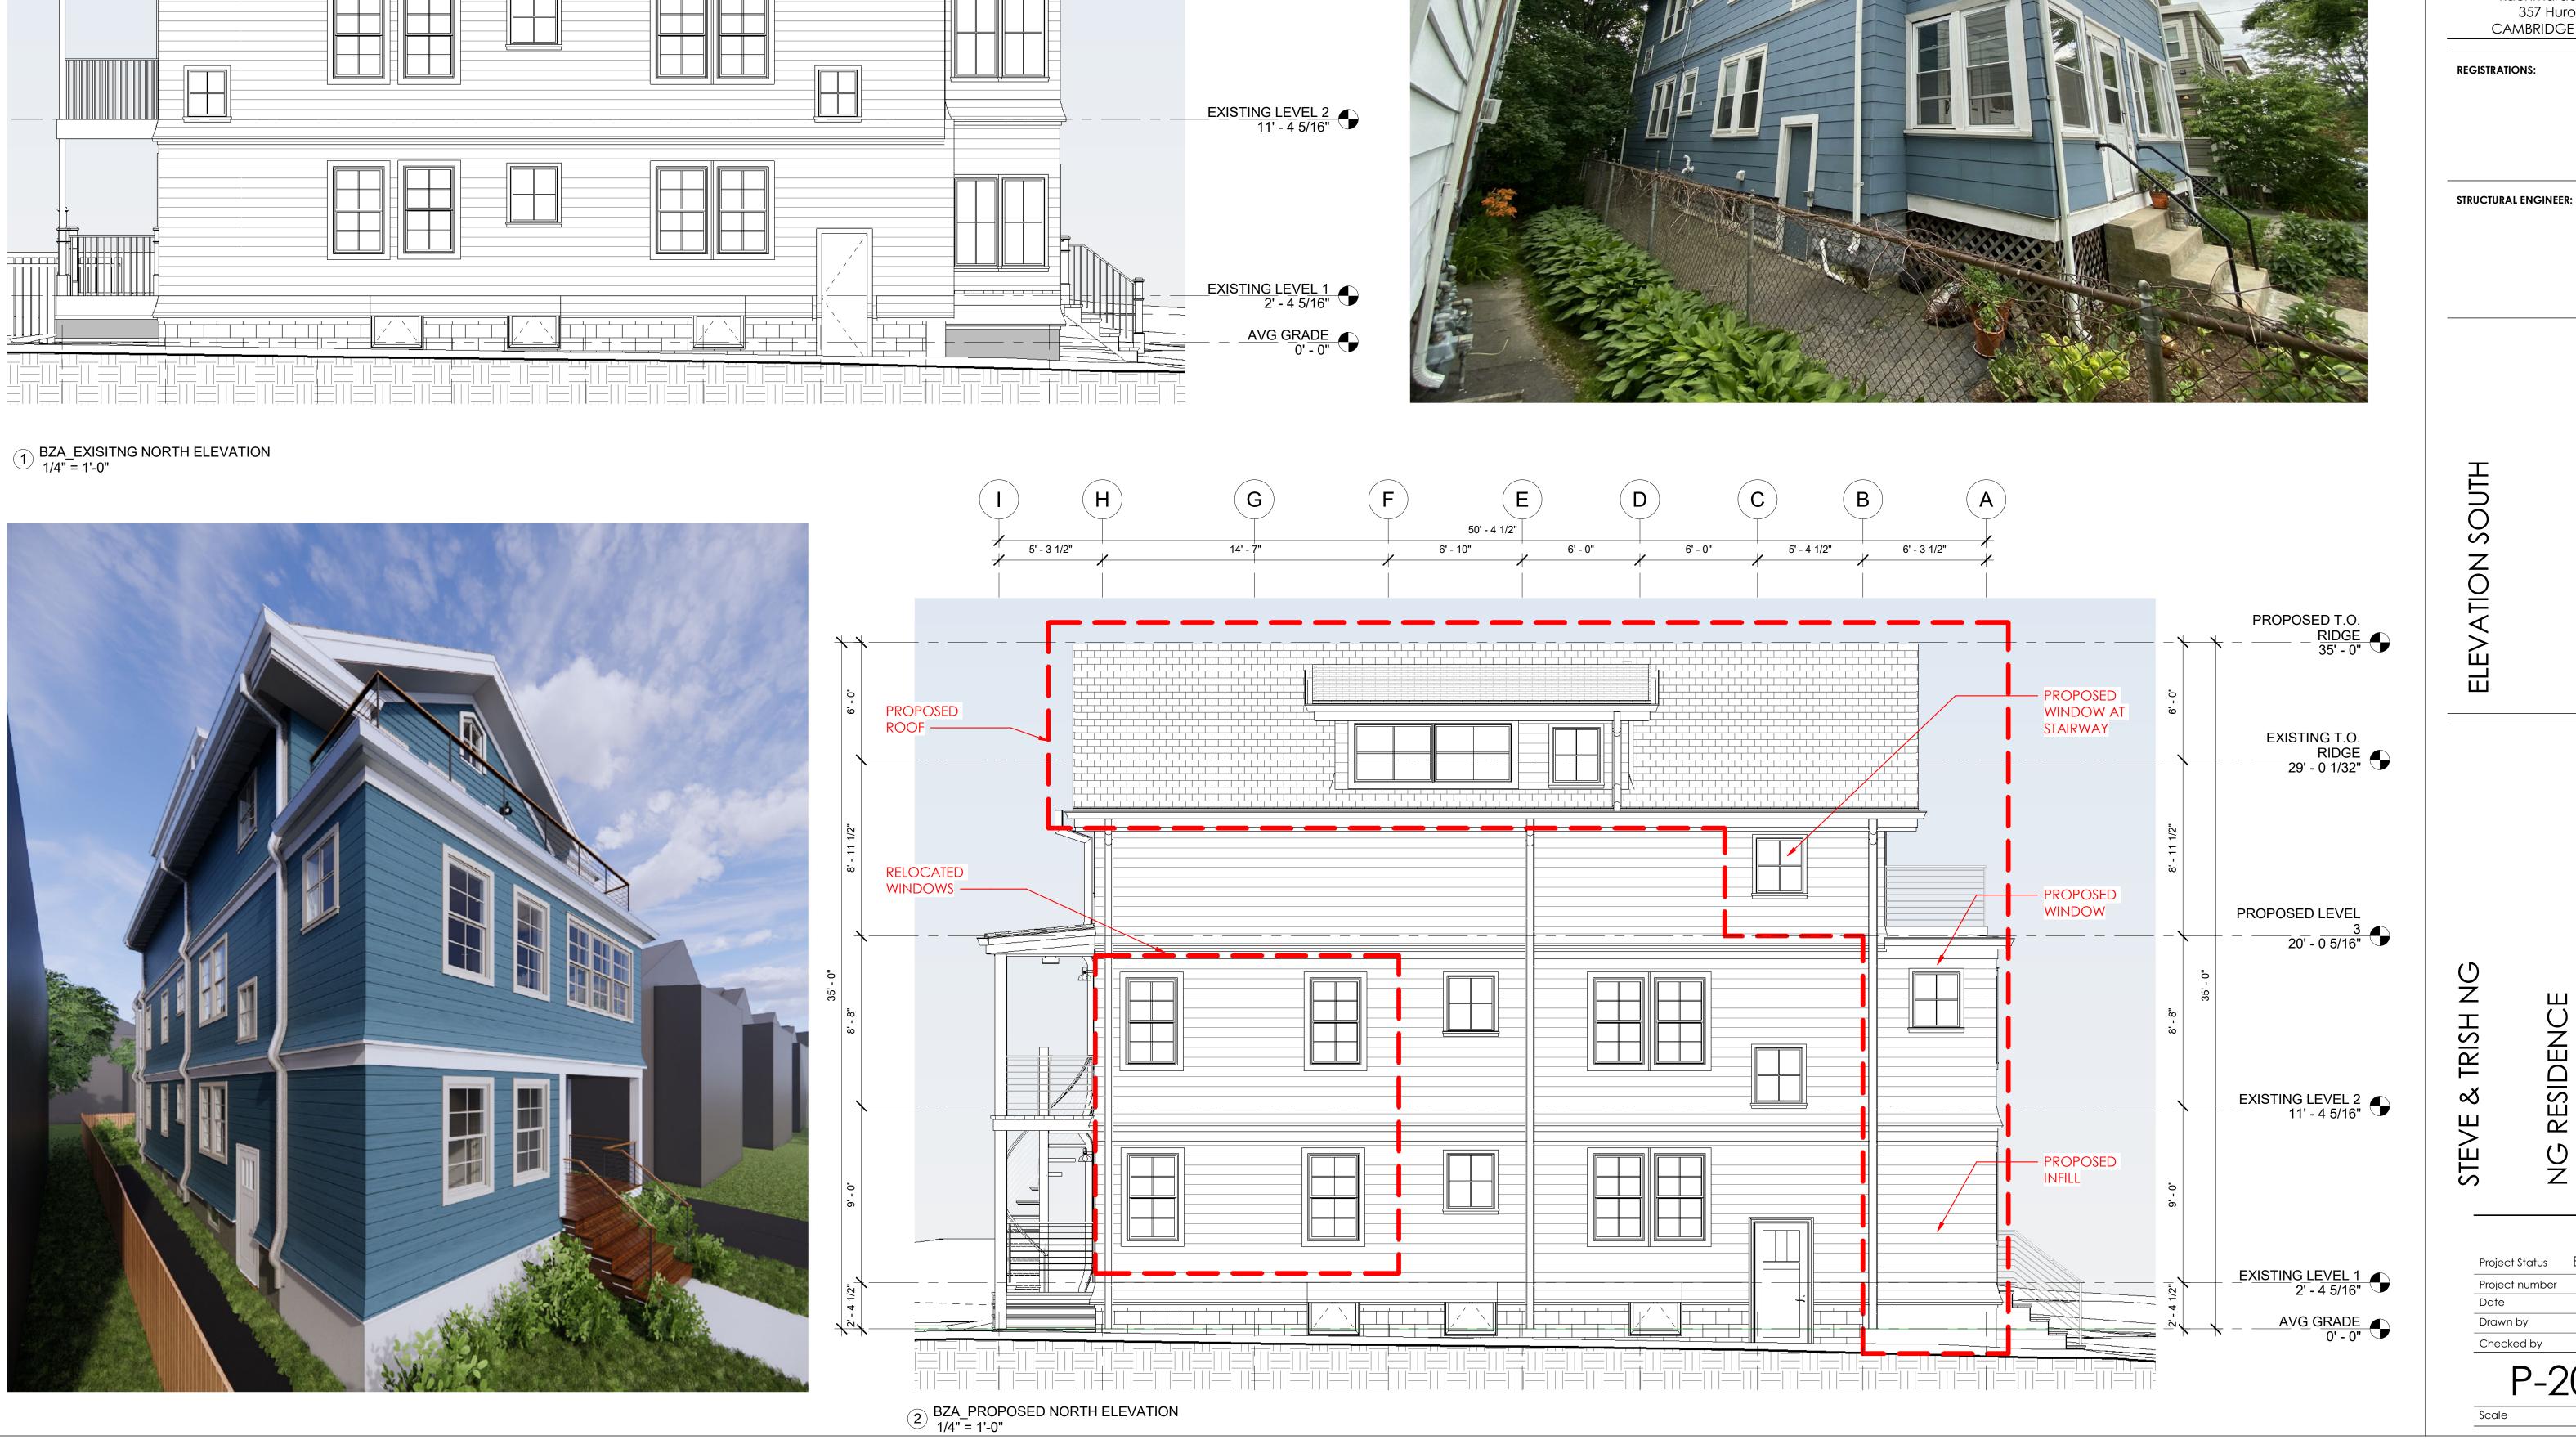
02138 94-96 ALPINE ST. CAMBRIDGE, MA NG RESIDENCE

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P-202

Scale 1/4" = 1'-0"



PROPOSED LEVEL

20' - 0 5/16"



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NG RESIDENCE


P-203 Scale 1/4" = 1'-0"

END OF PRESENTATION

94-96 ALPINE EXTERIOR VIDEO RENDER



SUPLEMENTARY SHEETS FOR REFERENCE BELOW

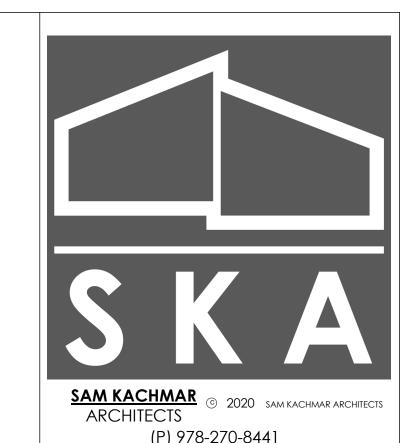

CAMBRIDGE MA, 02138

REGISTRATIONS:

STRUCTURAL ENGINEER:

QR CODE

DN ECIMI & HAID

NG RESIDENCE

02138

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Date 11/13/2020


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P-500

Scale







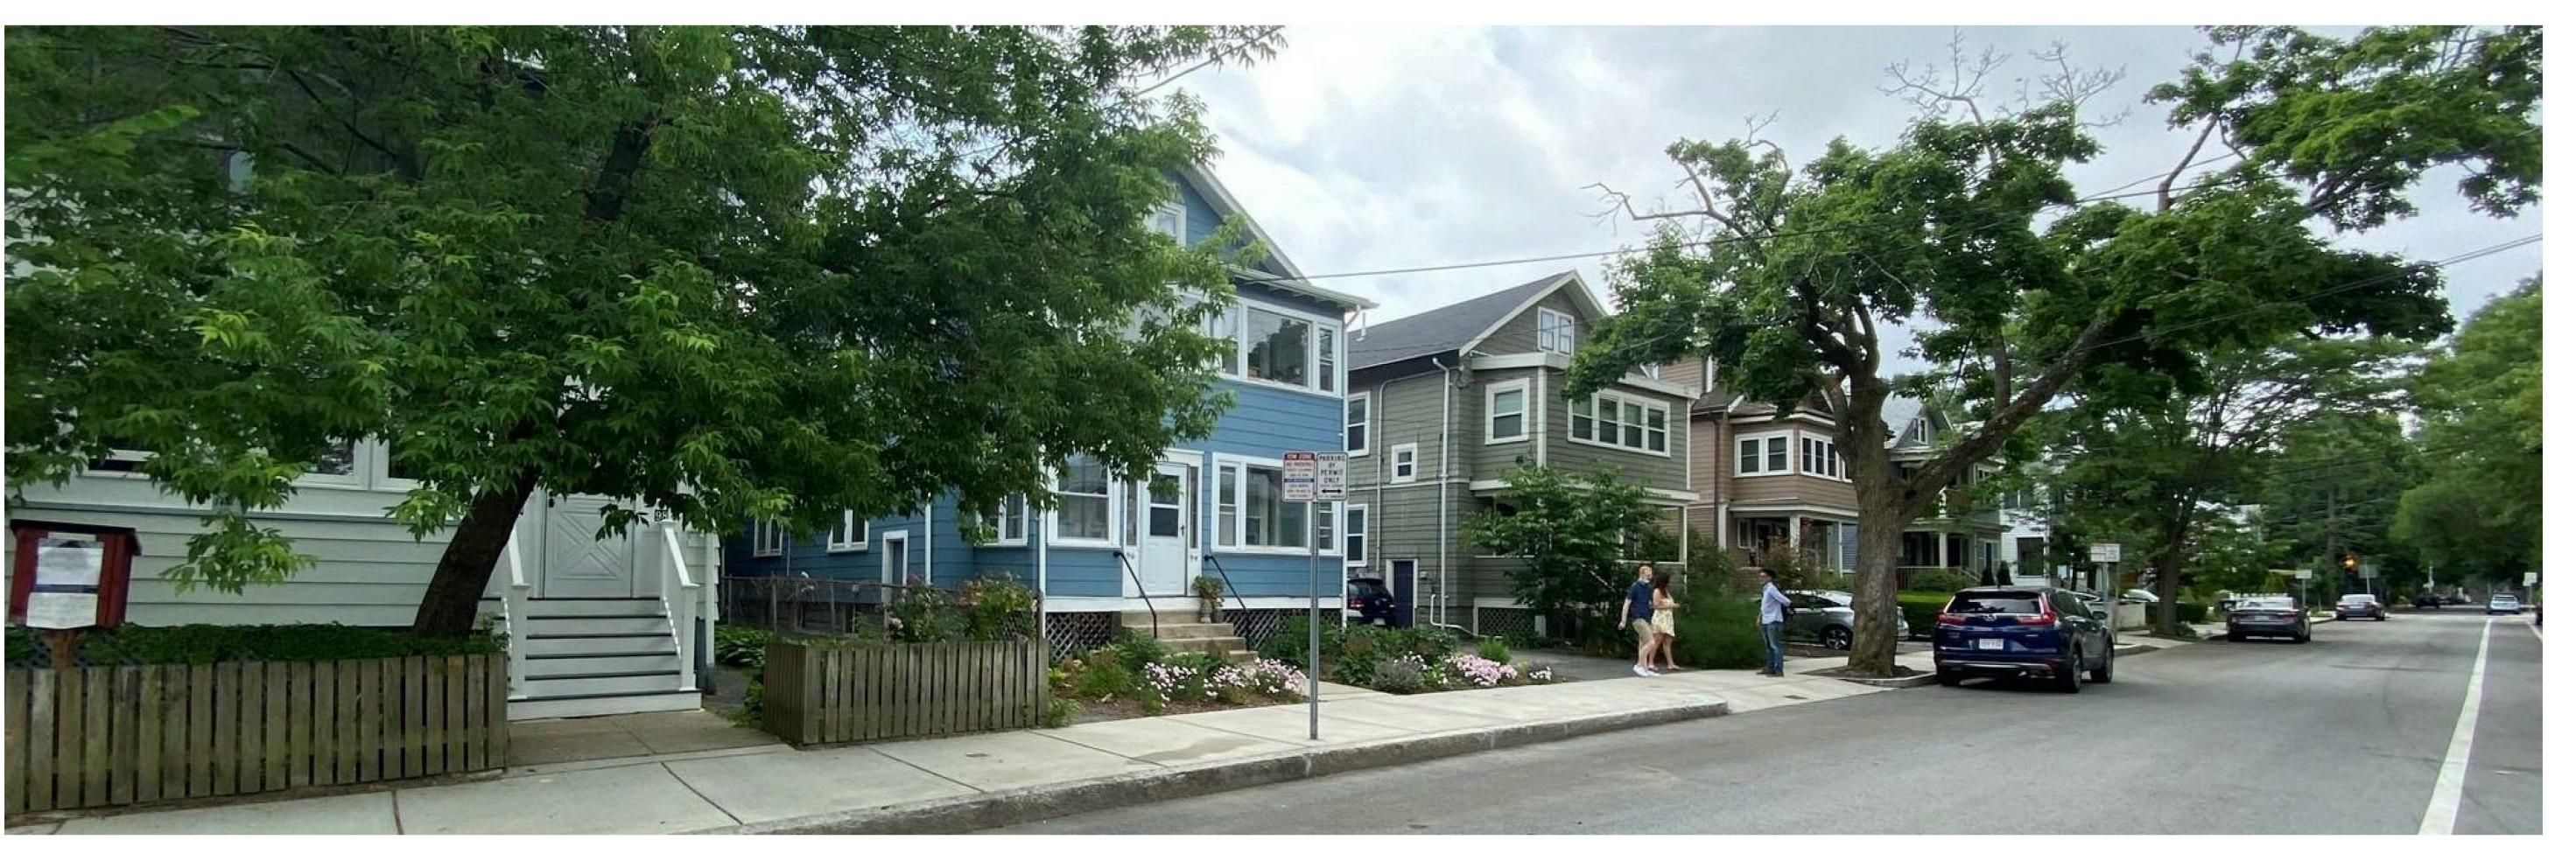

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& TRISH NG

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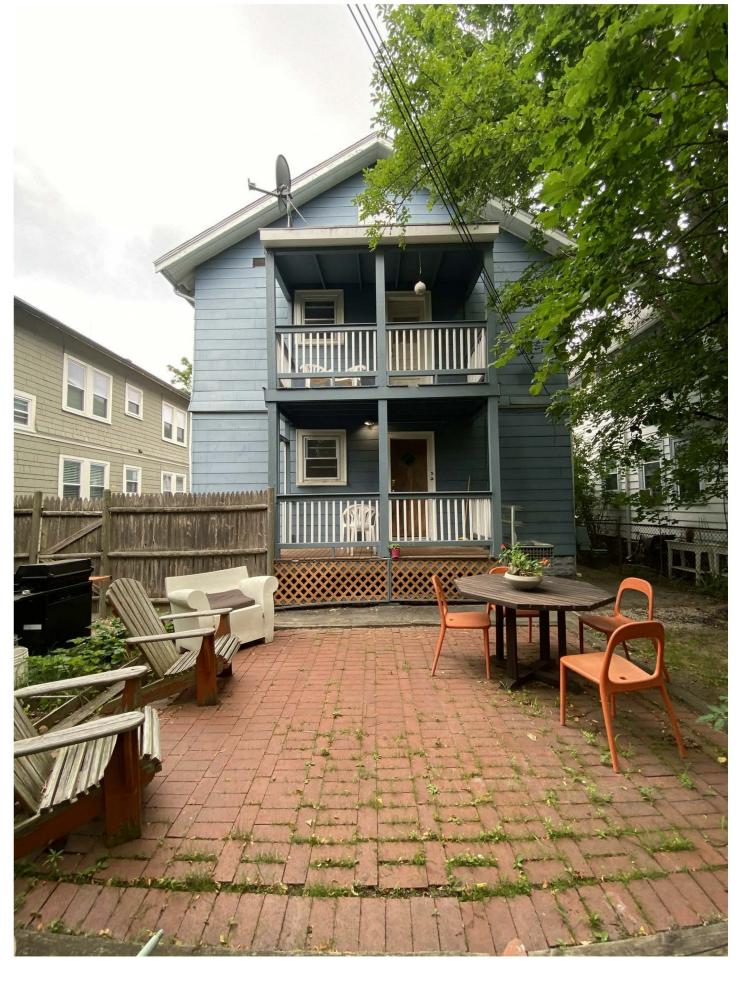
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P-501











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STEVE & TRISH NG

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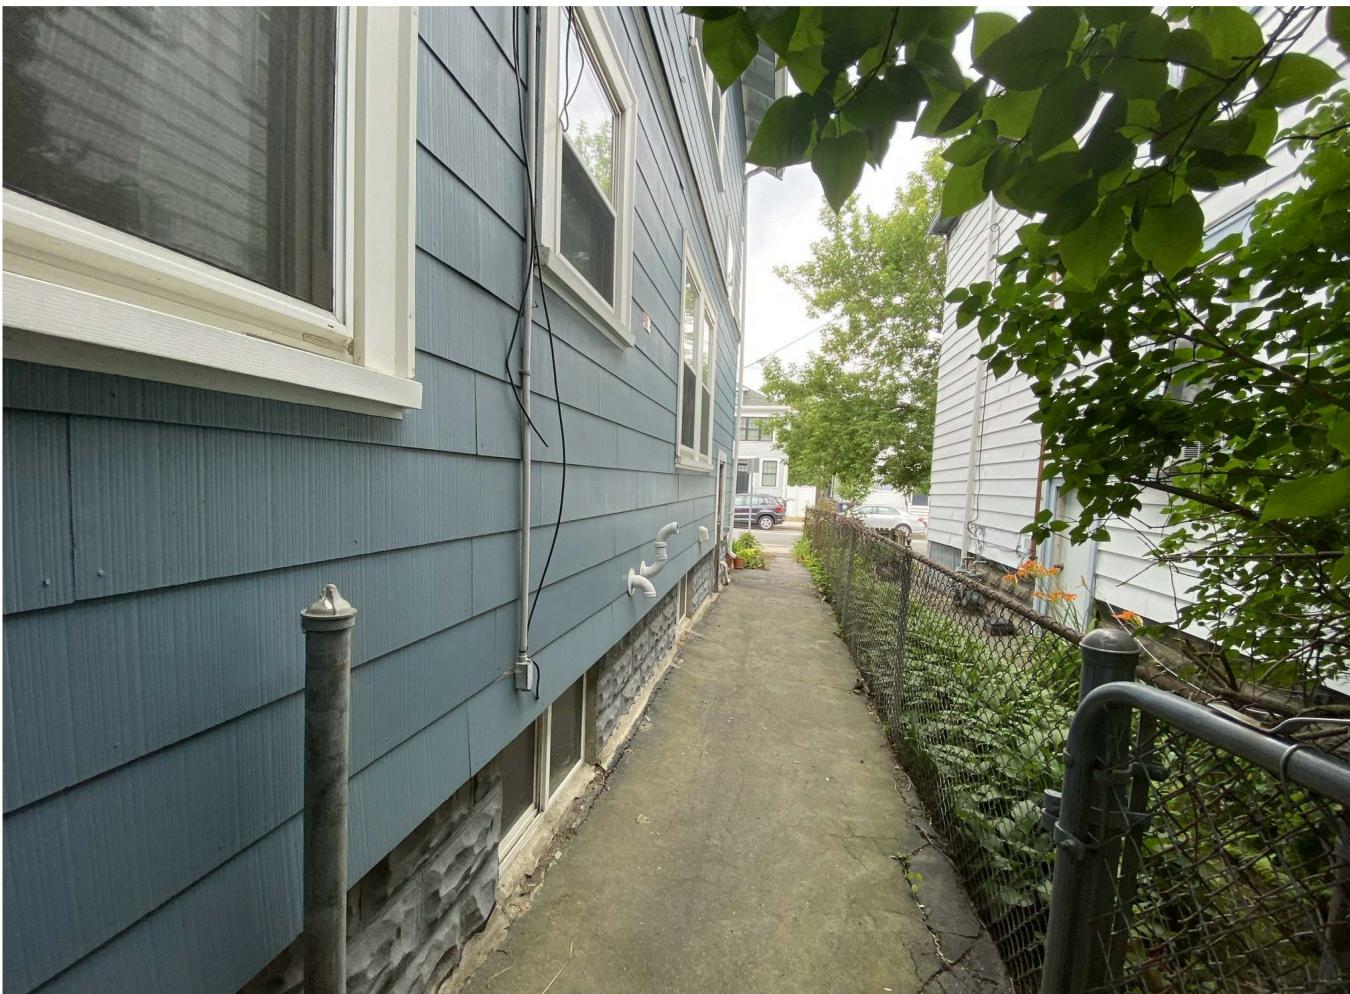
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P-502

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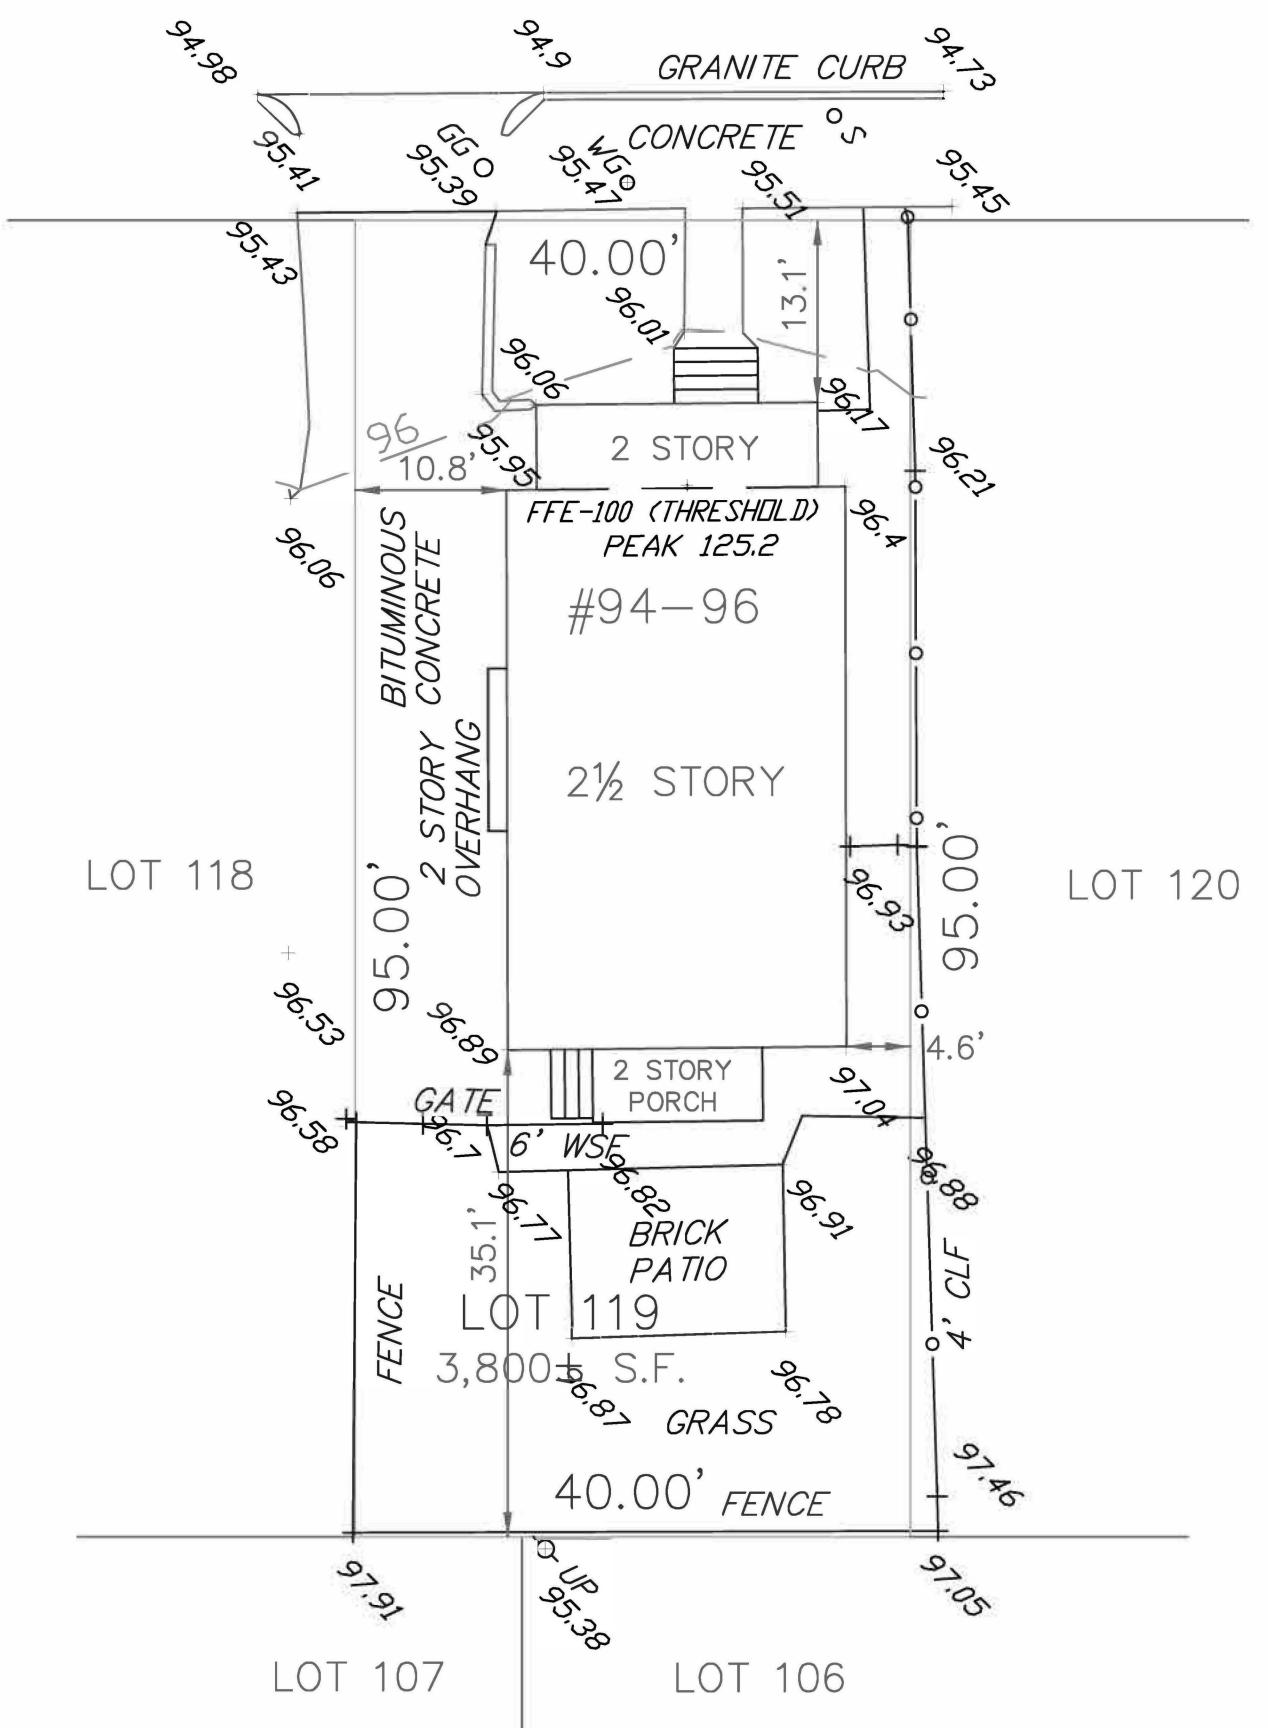
STEVE & TRISH NG

4-96 ALPINE ST. SAMBRIDGE, MA (

Project Number Project number 11/13/2020 Drawn by Author Checker Checked by

P-503

ALPINE SIREI



OWNER: STEVEN, PATRICIA & AUDRY NG

I HEREBY CERTIFY THAT THE BUILDING IS LOCATED AS SHOWN.

#92-94 ALPINE STREET
IN
CAMBRIDGE, MA

(MIDDLESEX COUNTY)

SCALE: 1"= 20' DATE: 7/24/2020

0 20 40 60 ft


ROBER SURVEY

1072A MASSACHUSETTS AVENUE
ARLINGTON, MA 02476
(781) 648-5533

6187PP1.DWG

CLIFFORD E. ROBER, PLS DATE
THIS PLAN MAY HAVE BEEN ALTERED IF
THE SIGNATURE IS NOT SIGNED IN BLUE.



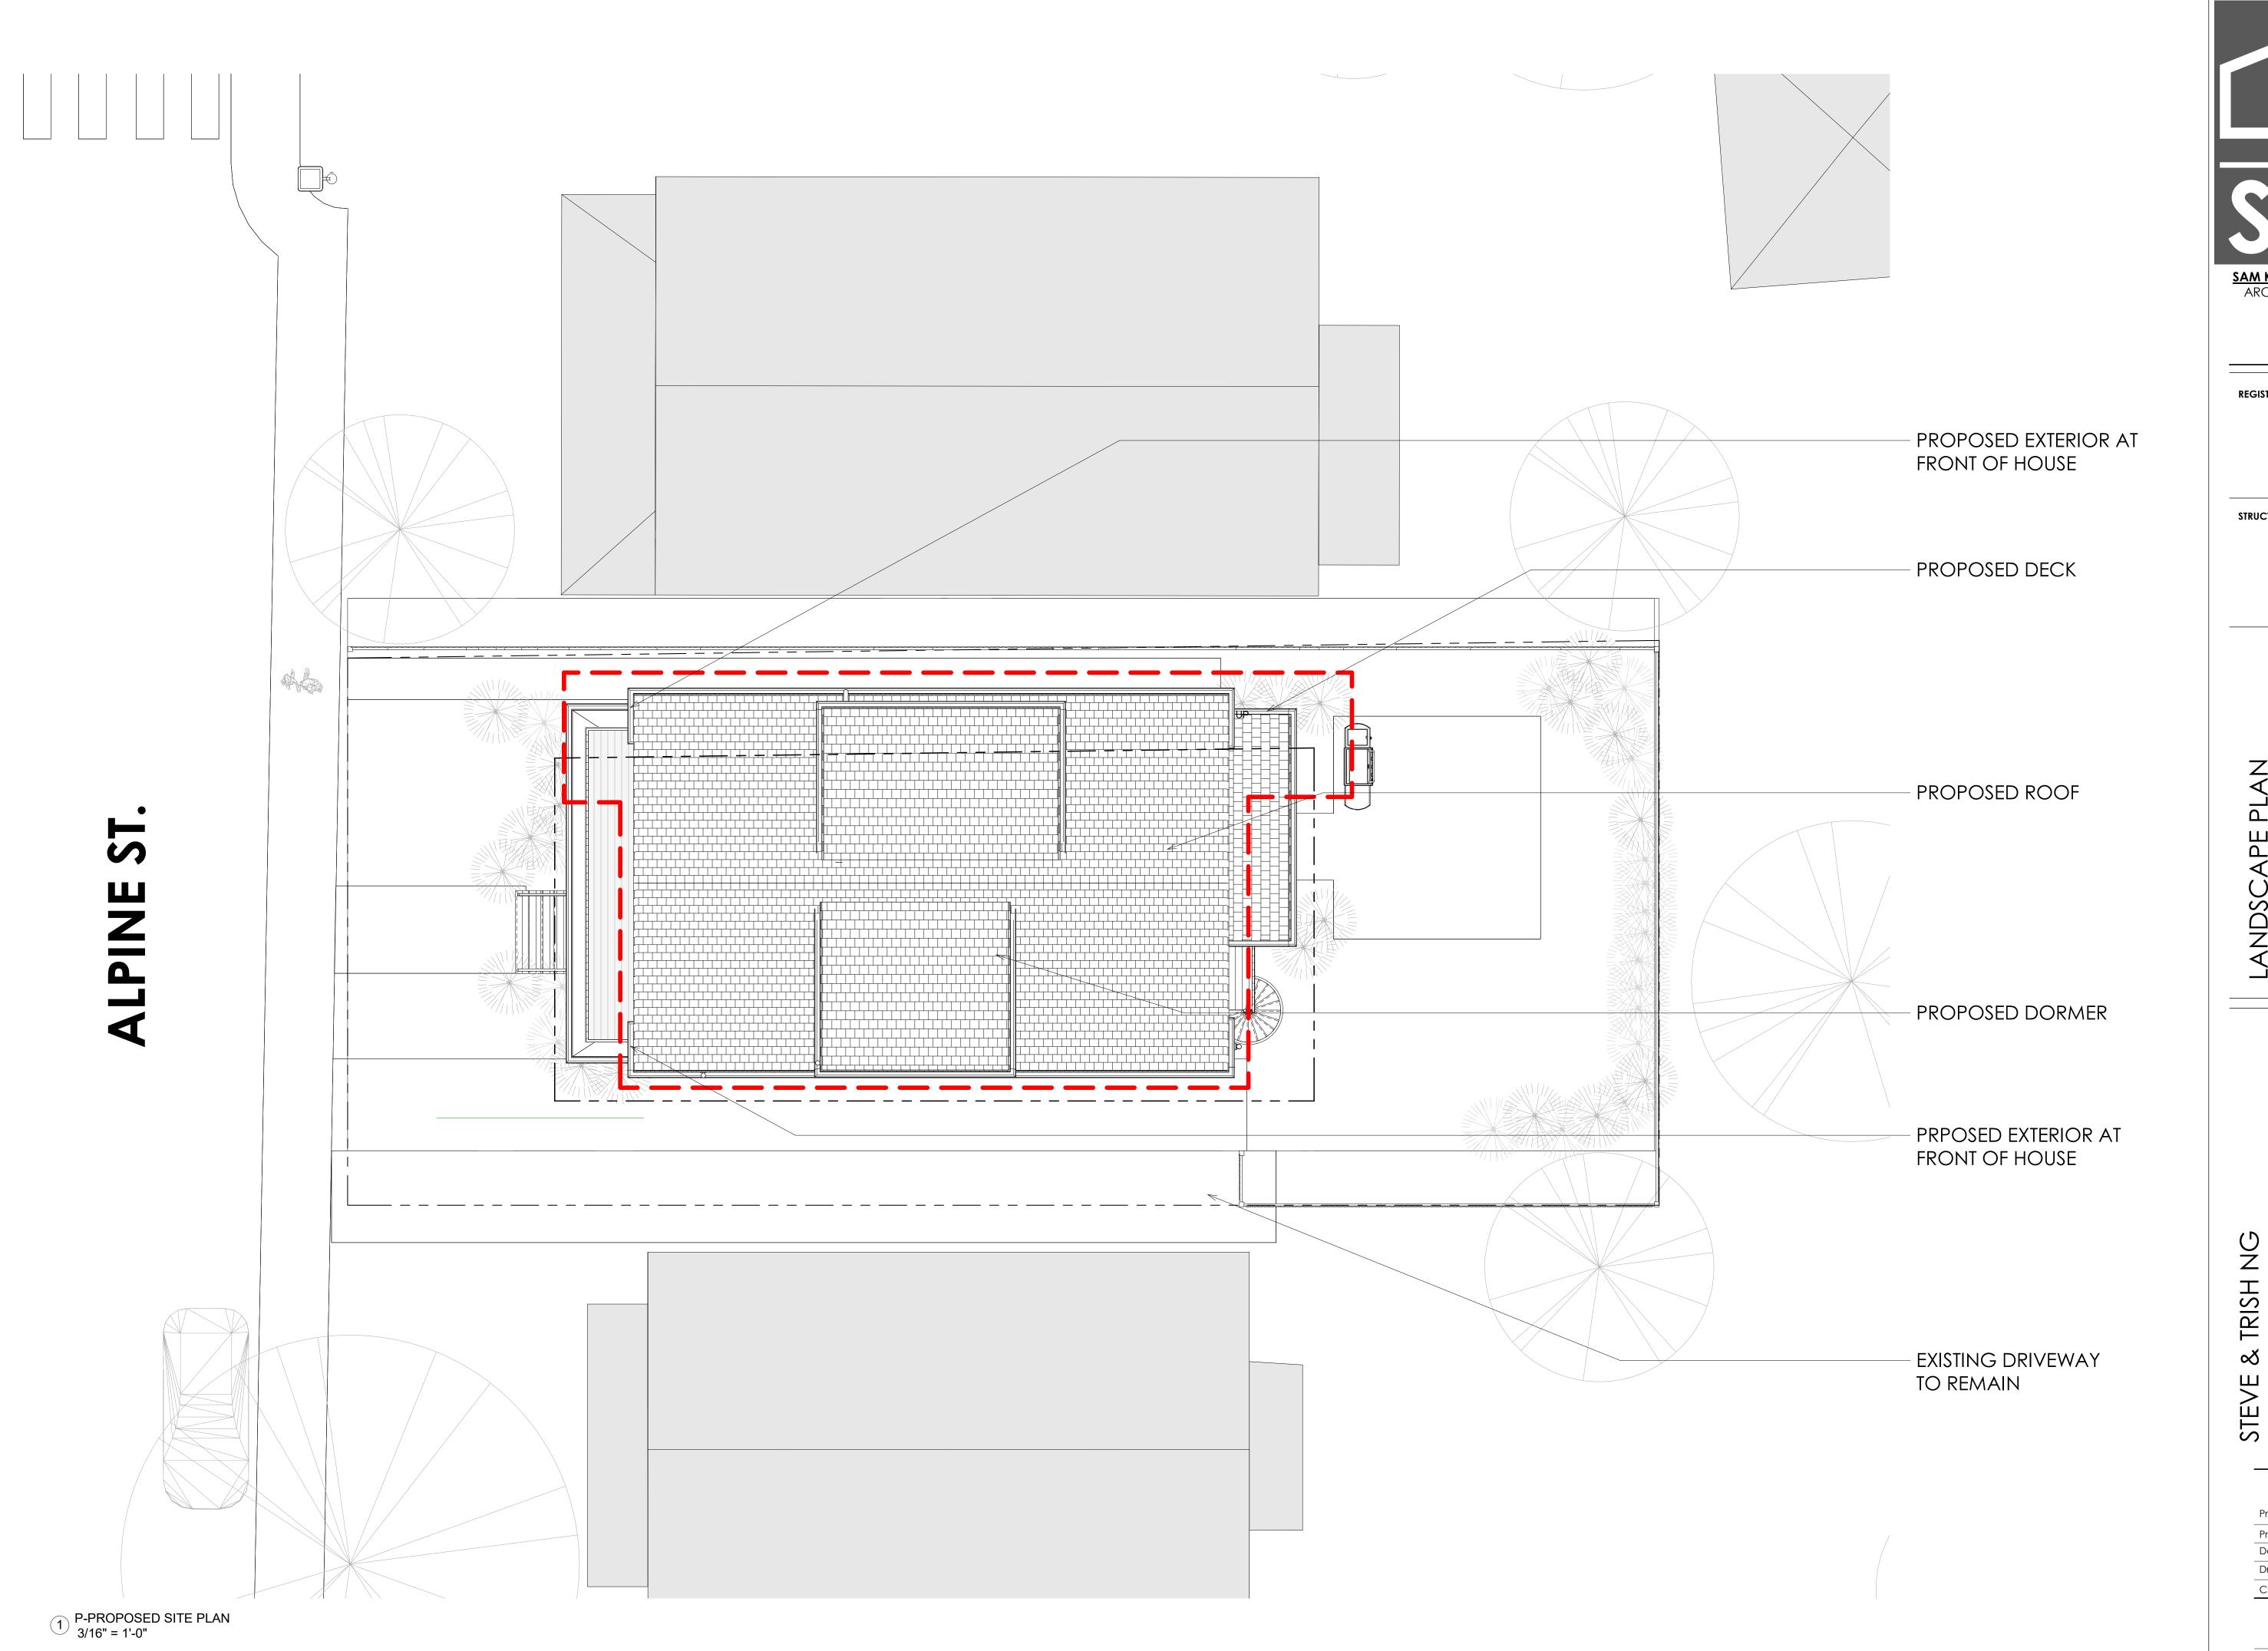



REGISTRATIONS:

STRUCTURAL ENGINEER:

94-96 ALPINE ST. CAMBRIDGE, MA 02138

Project Status BZA SUBMISSION SET

Project number Project Number

Date 11/13/2020

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P-505

Scale 3/16" = 1'-0"





REGISTRATIONS:

STRUCTURAL ENGINEER:

TRISH NG

02138

Checker

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Checked by P-506

1 1/2" = 1'-0"



City of Cambridge

MASSACHUSETTS

BOARD OF ZONING APPEAL

831 Mass Avenue, Cambridge, MA. (617) 349-6100

BZA

POSTING NOTICE - PICK UP SHEET

The undersigned picked up the notice board for the Board of Zoning Appeals Hearing.

Name:	hristopher	J. Aphen, Esq.	1	Date:	11/6	1/20
Address: _	96	Alpine St	*	*	•	
Case No	BrA-	93791		× ×		
Hearing Da	te:	11/19/20				

Thank you, Bza Members Sincerely,

Go to app

To Whom it May Concern:

My name is _____ A RO L KOZA CHUK _____ and I live at _____ 99 Alpane St ______ Concerns withing to state my support for my neighbors, Trish and Steve Ng. in their application for a special permit for their home at 96 Alpine Street.

The Concerns Street

**The Concer



SKA Architects rendering of proposed changes to 94 - 96 Alpine Street, Cambridge

1

Date: 10/12/20	
To Whom it May Concern:	
My name is <u>Laurie</u> Bartee	_ and I live at
97 Aspine St Cambridge, Ma 0438	
I am writing to state my support for my	neighbors, Trish
and Steve Ng, in their application for a special permit for their home a	t 96 Alpine Street.
Sincerely,	
Janu 1 Satte	



SKA Architects rendering of proposed changes to 94 - 96 Alpine Street, Cambridge

From: <u>Trish</u>

To: Steven Ng; Chris Alphen **Subject:** Fwd: Renovation

Date: Monday, October 05, 2020 1:48:18 PM

Trish

Begin forwarded message:

From: Susan Sukeforth <s.sukeforth@comcast.net>

Date: October 5, 2020 at 1:11:40 PM EDT

To: trshng@gmail.com Subject: Renovation

To whom it may concern:

My name is Susan Sukeforth and I live at 92 Alpine Street, Cambridge MA 02138. I am writing to state my support for my neighbors, Trish and Steve Ng, in their application for a special permit for their home at 96 Alpine Street.

Sincerely,

Susan Sukeforth

Sent from my iPad

Date: UC UC 2020	
To Whom it May Concern: My name is しいん	and I live at
95 Alpa of C	12(38)
I am writing to	state my support for my neighbors, Trish

and Steve Ng, in their application for a special permit for their home at 96 Alpine Street.

Sincerely,



SKA Architects rendering of proposed changes to 94 - 96 Alpine Street, Cambridge

Date:	OCT	19	0606
		,	

To Whom it M	The second secon	estation and the second and the seco	
My name is _	TOM	WUNDERLICH	and I live at
	171	CHILTON ST	
	03	$\frac{138}{6}$. I am writing to state my sup	oport for my neighbors, Trish

and Steve Ng, in their application for a special permit for their home at 96 Alpine Street.

Sincerely.

WITH PROPERTY VALUES BEING WHAT THEY ARE, I'D SAY IT'S CRAZY NOT TO MAKE USE OF GOOD SPACE LIKE THAT. DON'T FORGET SKYLIGHTS! OPEN A COUPLE SKYLIGHTS OPEN A COUPLE WINDOWS ON THE SHADY SIDE OF THE HOUSE —

DON'T NEED A-C!

SKA Architects rendering of proposed changes to 94 - 96 Alpine Street, Cambridge

NG RESIDENCE

STEVE & TRISH NG

94-96 ALPINE ST. CAMBRIDGE, MA 02138





ARCHITECT:

SKA

SAM KACHMAR

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ARCHITECTS
(p)978-270-8441
kachmardesign.com
357 HURON AVE.
CAMBRIDGE MA, 02138

CLIENTS:

GENERAL CONTRACTOR:

STEVE & TRISH NG

THE NG RESIDENCE LOCATED AT 94-96
ALPINE ST WILL INCLUDE THE
RENOVATION OF THE FRONT AND REAR
PORCH, THE RENOVATION OF THE 2ND
FLOOR APARTMENT AND THE RAISING
OF THE ROOF TO 35' BUILDING LIMIT

STRUCTURAL ENGINEER:



ROOME & GUARRACINO LLC

Sheet Number	Sheet Name	Designed By
P-000	COVER	SKA
P-001	GENERAL NOTES	SKA
P-002	PLOT PLAN & AREA PLAN	SKA
P-003	SITE AXON	SKA
P-004	SHADOW STUDY	SKA
P-005	STREET VIEW PERSPECTIVE	SKA
P-006	STREET VIEW PERSPECTIVE	SKA
P-100	PROPOSED LEVEL 0	SKA
P-101	PROPOSED LEVEL 1	SKA
P-102	PROPOSED LEVEL 2	SKA
P-103	PROPOSED LEVEL 3	SKA

Sheet Number	Sheet Name	Designed By
	·	
P-104	PROPOSED ROOF PLAN	SKA
P-200	ELEVATION WEST	SKA
P-201	ELEVATION NORTH	SKA
P-202	ELEVATION EAST	SKA
P-203	ELEVATION SOUTH	SKA
P-500	QR CODE	SKA
P-501	EXISTING	SKA
P-502	EXISTING	SKA
P-503	EXISTING	Designer
P-504	PLOT PLAN	SKA
P-505	LANDSCAPE PLAN	SKA
P-506	EXISTING AERIAL VIEW	Designer


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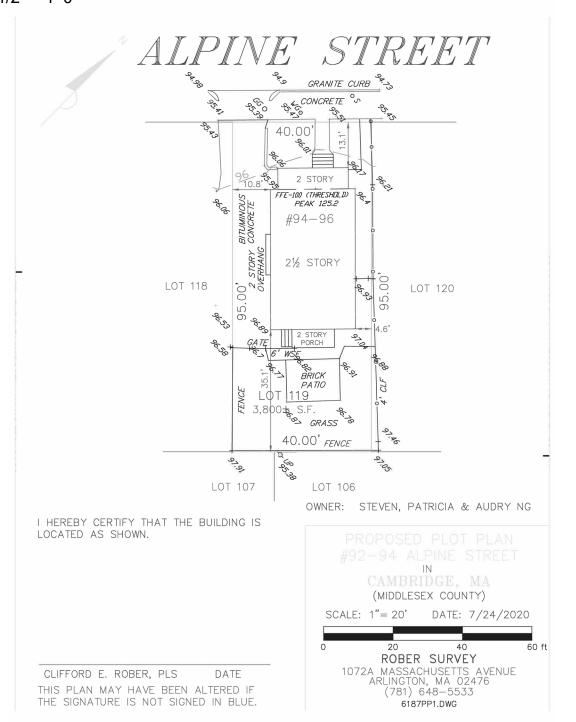
Grand total: 23

L	LENGTH
LAM	LAMINATE, LAMINATED
LB	POUND
LGMF	LIGHT GAGE METAL FRAMING
LT	LIGHT
LT WT	LIGHT WEIGHT
MAX	MAXIMUM
MDF	MEDIUM DENSITY FIBER
MECH	MECHANICAL
MED	MEDIUM
MFR	MANUFACTURER
MIN	MINIMUM
MISC	MISCELLANEOUS
MTD	MOUNTED
MTL	METAL
N	NORTH
N/A	NOT APPLICABLE
NIC	NOT IN CONTRACT
NOM	NOMINAL
NTS	NOT TO SCALE
OC	ON CENTER
OD	OUTSIDE DIAMETER
OH	OPPOSITE HAND
OPP	OPPOSITE
OSB	ORIENTED STRANDBOARD
OVHD	OVERHEAD
OZ	OUNCE (S)
PATT	PATTERN (ED)
PERF	PERFORATED
PERP	PERPENDICULAR
PLAM	PLASTIC LAMINATE
PLYWD	PLYWOOD
PNT	PAINT, PAINTED
PR	PAIR
PREFAB	PREFABRICATE, PREFABRICATED
QTY	QUANTITY
RAD	RADIUS
	RADIUS RUBBER
RAD	
RAD RBR RD	RUBBER
RAD RBR	RUBBER ROOF DRAIN REFERENCE
RAD RBR RD REF	RUBBER ROOF DRAIN
RAD RBR RD REF REFR	RUBBER ROOF DRAIN REFERENCE REFRIGERATE, REFRIGERATOR
RAD RBR RD REF REFR REINF	RUBBER ROOF DRAIN REFERENCE REFRIGERATE, REFRIGERATOR REINFORCE, REINFORCED
RAD RBR RD REF REFR REINF REQ	RUBBER ROOF DRAIN REFERENCE REFRIGERATE, REFRIGERATOR REINFORCE, REINFORCED REQUIRE
RAD RBR RD REF REFR REINF REQ REV	RUBBER ROOF DRAIN REFERENCE REFRIGERATE, REFRIGERATOR REINFORCE, REINFORCED REQUIRE REVISION, REVISE, REVISED
RAD RBR RD REF REFR REINF REQ REV RM	RUBBER ROOF DRAIN REFERENCE REFRIGERATE, REFRIGERATOR REINFORCE, REINFORCED REQUIRE REVISION, REVISE, REVISED ROOM
RAD RBR RD REF REFR REINF REQ REV RM RO	RUBBER ROOF DRAIN REFERENCE REFRIGERATE, REFRIGERATOR REINFORCE, REINFORCED REQUIRE REVISION, REVISE, REVISED ROOM ROUGH OPENING
RAD RBR RD REF REFR REINF REQ REV RM RO S	RUBBER ROOF DRAIN REFERENCE REFRIGERATE, REFRIGERATOR REINFORCE, REINFORCED REQUIRE REVISION, REVISE, REVISED ROOM ROUGH OPENING SOUTH
RAD RBR RD REF REFR REINF REQ REV RM RO S SCHED	RUBBER ROOF DRAIN REFERENCE REFRIGERATE, REFRIGERATOR REINFORCE, REINFORCED REQUIRE REVISION, REVISE, REVISED ROOM ROUGH OPENING SOUTH SCHEDULE
RAD RBR RD REF REFR REINF REQ REV RM RO S SCHED	RUBBER ROOF DRAIN REFERENCE REFRIGERATE, REFRIGERATOR REINFORCE, REINFORCED REQUIRE REVISION, REVISE, REVISED ROOM ROUGH OPENING SOUTH SCHEDULE SQUARE FEET
RAD RBR RD REF REFR REINF REQ REV RM RO S SCHED SF SI	RUBBER ROOF DRAIN REFERENCE REFRIGERATE, REFRIGERATOR REINFORCE, REINFORCED REQUIRE REVISION, REVISE, REVISED ROOM ROUGH OPENING SOUTH SCHEDULE SQUARE FEET SQUARE INCHES
RAD RBR RD REF REFR REINF REQ REV RM RO S SCHED SF SI SIM	RUBBER ROOF DRAIN REFERENCE REFRIGERATE, REFRIGERATOR REINFORCE, REINFORCED REQUIRE REVISION, REVISE, REVISED ROOM ROUGH OPENING SOUTH SCHEDULE SQUARE FEET SQUARE INCHES SIMILAR
RAD RBR RD REF REFR REINF REQ REV RM RO S SCHED SF SI SIM SPEC	RUBBER ROOF DRAIN REFERENCE REFRIGERATE, REFRIGERATOR REINFORCE, REINFORCED REQUIRE REVISION, REVISE, REVISED ROOM ROUGH OPENING SOUTH SCHEDULE SQUARE FEET SQUARE INCHES SIMILAR SPECIFICATION
RAD RBR RD REF REFR REINF REQ REV RM RO S SCHED SF SI SIM SPEC SQ	RUBBER ROOF DRAIN REFERENCE REFRIGERATE, REFRIGERATOR REINFORCE, REINFORCED REQUIRE REVISION, REVISE, REVISED ROOM ROUGH OPENING SOUTH SCHEDULE SQUARE FEET SQUARE INCHES SIMILAR SPECIFICATION SQUARE
RAD RBR RD REF REFR REINF REQ REV RM RO S SCHED SF SI SIM SPEC SQ SS, SST	RUBBER ROOF DRAIN REFERENCE REFRIGERATE, REFRIGERATOR REINFORCE, REINFORCED REQUIRE REVISION, REVISE, REVISED ROOM ROUGH OPENING SOUTH SCHEDULE SQUARE FEET SQUARE INCHES SIMILAR SPECIFICATION SQUARE STAINLESS STEEL
RAD RBR RD REF REFR REINF REQ REV RM RO S SCHED SF SI SIM SPEC SQ SS, SST STC	RUBBER ROOF DRAIN REFERENCE REFRIGERATE, REFRIGERATOR REINFORCE, REINFORCED REQUIRE REVISION, REVISE, REVISED ROOM ROUGH OPENING SOUTH SCHEDULE SQUARE FEET SQUARE INCHES SIMILAR SPECIFICATION SQUARE STAINLESS STEEL SOUND TRANSMISSION CLASS
RAD RBR RD REF REFR REINF REQ REV RM RO S SCHED SF SI SIM SPEC SQ SS, SST STC STL	RUBBER ROOF DRAIN REFERENCE REFRIGERATE, REFRIGERATOR REINFORCE, REINFORCED REQUIRE REVISION, REVISE, REVISED ROOM ROUGH OPENING SOUTH SCHEDULE SQUARE FEET SQUARE INCHES SIMILAR SPECIFICATION SQUARE STAINLESS STEEL SOUND TRANSMISSION CLASS STEEL
RAD RBR RD REF REFR REINF REQ REV RM RO S SCHED SF SI SIM SPEC SQ SS, SST STC STL STOR	RUBBER ROOF DRAIN REFERENCE REFRIGERATE, REFRIGERATOR REINFORCE, REINFORCED REQUIRE REVISION, REVISE, REVISED ROOM ROUGH OPENING SOUTH SCHEDULE SQUARE FEET SQUARE INCHES SIMILAR SPECIFICATION SQUARE STAINLESS STEEL SOUND TRANSMISSION CLASS STEEL STORAGE
RAD RBR RD REF REFR REINF REQ REV RM RO S SCHED SF SI SIM SPEC SQ SS, SST STC STL STOR STR	RUBBER ROOF DRAIN REFERENCE REFRIGERATE, REFRIGERATOR REINFORCE, REINFORCED REQUIRE REVISION, REVISE, REVISED ROOM ROUGH OPENING SOUTH SCHEDULE SQUARE FEET SQUARE INCHES SIMILAR SPECIFICATION SQUARE STAINLESS STEEL SOUND TRANSMISSION CLASS STEEL STORAGE STAIR
RAD RBR RD REF REFR REINF REQ REV RM RO S SCHED SF SI SIM SPEC SQ SS, SST STC STL STOR STR T.O.	RUBBER ROOF DRAIN REFERENCE REFRIGERATE, REFRIGERATOR REINFORCE, REINFORCED REQUIRE REVISION, REVISE, REVISED ROOM ROUGH OPENING SOUTH SCHEDULE SQUARE FEET SQUARE INCHES SIMILAR SPECIFICATION SQUARE STAINLESS STEEL SOUND TRANSMISSION CLASS STEEL STORAGE STAIR TOP OF
RAD RBR RD REF REFR REINF REQ REV RM RO S SCHED SF SI SIM SPEC SQ SS, SST STC STL STOR STR T.O. U.O.	RUBBER ROOF DRAIN REFERENCE REFRIGERATE, REFRIGERATOR REINFORCE, REINFORCED REQUIRE REVISION, REVISE, REVISED ROOM ROUGH OPENING SOUTH SCHEDULE SQUARE FEET SQUARE INCHES SIMILAR SPECIFICATION SQUARE STAINLESS STEEL SOUND TRANSMISSION CLASS STEEL STORAGE STAIR TOP OF UNDERSIDE OF
RAD RBR RD REF REFR REINF REQ REV RM RO S SCHED SF SI SIM SPEC SQ SS, SST STC STL STOR STR T.O. U.O. UON	RUBBER ROOF DRAIN REFERENCE REFRIGERATE, REFRIGERATOR REINFORCE, REINFORCED REQUIRE REVISION, REVISE, REVISED ROOM ROUGH OPENING SOUTH SCHEDULE SQUARE FEET SQUARE INCHES SIMILAR SPECIFICATION SQUARE STAINLESS STEEL SOUND TRANSMISSION CLASS STEEL STORAGE STAIR TOP OF UNDERSIDE OF UNLESS OTHERWISE NOTED
RAD RBR RD REF REFR REINF REQ REV RM RO S SCHED SF SI SIM SPEC SQ SS, SST STC STL STOR STR T.O. U.O. UON WD	RUBBER ROOF DRAIN REFERENCE REFRIGERATE, REFRIGERATOR REINFORCE, REINFORCED REQUIRE REVISION, REVISE, REVISED ROOM ROUGH OPENING SOUTH SCHEDULE SQUARE FEET SQUARE INCHES SIMILAR SPECIFICATION SQUARE STAINLESS STEEL SOUND TRANSMISSION CLASS STEEL STORAGE STAIR TOP OF UNDERSIDE OF UNLESS OTHERWISE NOTED WOOD WEIGHT
RAD RBR RD REF REFR REINF REQ REV RM RO S SCHED SF SI SIM SPEC SQ SS, SST STC STL STOR STR T.O. U.O. UON WD WT	RUBBER ROOF DRAIN REFERENCE REFRIGERATE, REFRIGERATOR REINFORCE, REINFORCED REQUIRE REVISION, REVISE, REVISED ROOM ROUGH OPENING SOUTH SCHEDULE SQUARE FEET SQUARE INCHES SIMILAR SPECIFICATION SQUARE STAINLESS STEEL SOUND TRANSMISSION CLASS STEEL STORAGE STAIR TOP OF UNDERSIDE OF UNLESS OTHERWISE NOTED WOOD





P-MATERIALS ¹ 1 1/2" = 1'-0"

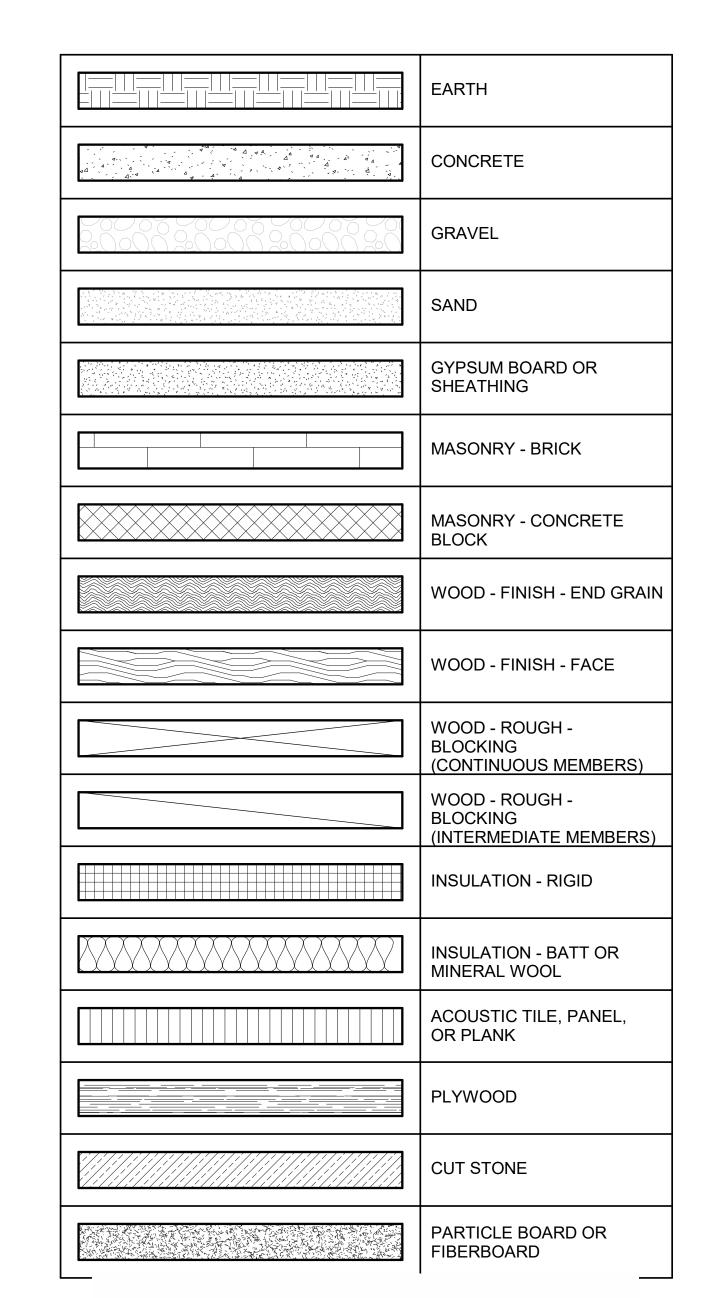

VIEW # VIEW SCALE:1/X	NAME	-	DRAWING	TITLE
SHEET VIEW #	_		EXTERIOR KEY	ELEVATION
SHEET			INTERIOR	ELEVATION KEY
O.H. / SIM VIEW #		I	BUILDING	SECTION MARKER
VIEW # O.H. / SIM		J	WALL SEC	TION MARKER
VIEW # O.H. / SIM			DETAIL AR	EA MARKER
VIEW # O.H. / SIM SHEET		-	DETAIL SE	CTION MARKER
COLUMN		_	GRID LINE	
Name Elevation			VERTICAL KEY (ELEV	ELEVATION)
0' - 0"	^		SPOT ELE\ W/ TARGE	
0' - 0"			SPOT ELE\ NO TARGE	
	REV,#		REVISION REVISION	CLOUD AND TAG
ROOM NAME ROOM #	ROOM TAG		ب	CENTERLINE
AREA NAME AREA	AREA TAG	SHEET		MATCH LINE
DOOR#	DOOR TAG			HINGE SIDE OF DOOR
# TYPE	WINDOW TAG	Ť		ALIGN SURFACE
		R F	ROOM NAME OOM # FLOOR BASE WALL FEILING	FINISH TAG

3 P-SYMBOLS 1 1/2" = 1'-0"

ALL WORK SHALL BE CONSIDERED NEW, UNLESS OTHERWISE
INDICATED.
DO NOT SCALE DRAWINGS
VERIFY DIMENSIONS, GRADES, BOUNDARIES, AND CONSTRUCTION
AND IMMEDIATELY REPORT ANY DISCREPANCIES BEFORE

PROCEEDING WITH THE WORK. 4. TO THE EXTENT PRACTICABLE, VERIFY DIMENSIONS AND FIELD CONDITIONS AT THE SITE PRIOR TO THE BID SUBMISSION CONFLICTS, OMISSIONS AND DISCREPANCIES WITHIN THE CONTRACT DOCUMENTS SHALL BE REPORTED IN WRITING TO THE ARCHITECT, IN ACCORDANCE WITH THE CONTRACT DOCUMENTS, PRIOR TO THE BID SUBMISSION. THE CONTRACTOR WARRANTS, BY TENDERING HIS BID, THAT THE WORK IS BUILDABLE AS SHOWN.

5. LAYOUT ALL WORK WITHIN THE CONFINES OF EXISTING CONSTRUCTION AND RESOLVE DISCREPANCIES PRIOR TO INITIATION OF NEW WORK.

6. ARCHITECT IS NOT RESPONSIBLE FOR CONSTRUCTION THAT IS STARTED PRIOR TO PERMIT BEING ISSUED.

7. DIMENSIONS, NOTES, FINISHES AND FIXTURES SHOWN ON TYPICAL FLOOR PLANS, SECTION OR DETAILS SHALL APPLY TO SIMILAR, SYMMETRICAL OR OPPOSITE HAND PLANS SECTIONS OR DETAILS, UNLESS NOTED OTHERWISE.

8. TYPICAL OR "TYP" SHALL MEAN THAT THE CONDITION IS REPRESENTATIVE FOR SIMILAR CONDITIONS THROUGHOUT, UNLESS NOTED OTHERWISE. DETAILS ARE USUALLY KEYED AND NOTED "TYP" ONLY ONE TIME, WHEN THEY FIRST OCCUR.

9. IMMEDIATELY NOTIFY THE ARCHITECT IN WRITING OF ANY DISCREPANCIES BETWEEN PROJECT MANUAL, LARGE SCALE DRAWINGS, SMALL SCALE DRAWINGS AND DETAILS. THE CONTRACTOR SHALL NOT PROCEED WITH AFFECTED WORK UNTIL ARCHITECT PROVIDES CLARIFICATION.

10. PARTITIONS ARE DIMENSIONED FROM FINISHED FACE TO FINISHED FACE UNLESS OTHERWISE NOTED. DIMENSIONS TO MASONRY ARE TO ACTUAL FINISHED FACE, UNLESS OTHERWISE NOTED.

11. VERIFY THAT DRAWINGS ARE THE LATEST ISSUE PRIOR TO COMMENCING CONSTRUCTION. THE GENERAL CONTRACTOR SHALL BE RESPONSIBLE FOR COMMUNICATING AND DISTRIBUTING ALL CONSTRUCTION DOCUMENT UPDATES TO ALL TRADES.

12. WORK SHALL CONFORM TO THE REQUIREMENTS OF APPLICABLE STATE, FEDERAL AND CITY/COUNTY CODES. STATE AND FEDERAL CODES ARE TO TAKE PRECEDENCE OVER THE DRAWINGS AND SPECIFICATIONS. IF ANY DISCREPANCY IS NOTED, IMMEDIATELY INFORM THE ARCHITECT, PRIOR TO PROCEEDING WITH THE WORK.

13. FILE, OBTAIN AND PAY FEES FOR BUILDING DEPARTMENT PERMITS, CONTROLLED INSPECTIONS, OTHER AGENCY APPROVALS AND PERMITS WHERE REQUIRED, AND FINAL WRITE-OFFS FOR PROJECT COMPLETION. COPIES OF TRANSACTIONS SHALL BE FORWARDED TO THE OWNER OR OWNER'S REPRESENTATIVE.

14. EXECUTE INSPECTIONS NECESSARY TO OBTAIN A CERTIFICATE OF OCCUPANCY.

15. WORK AREA SHALL BE MAINTAINED, CLEAN AND FREE OF DEBRIS AT ALL TIMES.

16. PATCH ALL SURFACES TO MATCH ADJACENT IN A MANNER SUITABLE TO RECEIVE FINISHES.

17. PATCH, REPAIR AND FINISH ALL SURFACES IN AREAS OUTSIDE OF THE EXISTING SCOPE THAT ARE DISTURBED AS A RESULT OF THE WORK.

18. COORDINATE AND PROVIDE BLOCKING AND STRAPPING WITHIN PARTITIONS FOR MILLWORK AND OTHER WALL ATTACHED ITEMS.

19. APPLY, INSTALL, CONNECT, CLEAN AND/OR CONDITION MANUFACTURED ARTICLES, MATERIALS AND/OR EQUIPMENT PER MANUFACTURER'S INSTRUCTIONS. IN CASE OF CONFLICT BETWEEN MANUFACTURER'S INSTRUCTIONS AND THE CONTRACT DOCUMENTS. THE CONTRACTOR SHALL OBTAIN WRITTEN CLARIFICATION FROM

THE ARCHITECT BEFORE PROCEEDING. 20. GLASS 18" OR LESS FROM FLOOR LINE OR ADJACENT TO A DOOR SWING SHALL BE SAFETY GLASS AS REQUIRED BY APPLICABLE CODE(S). THE CONTRACTOR SHALL BE RESPONSIBLE FOR PROVIDING ." SAFETY GLASS, UNLESS OTHERWISE NOTED, TO COMPLY WITH BUILDING AND LIFE SAFETY CODES, INDUSTRY STANDARDS AND OTHER APPLICABLE FEDERAL AND STATE CODES

21. FLASHING AT EXTERIOR WALLS SHALL BE INSTALLED WITH SEALED JOINTS, SEALED PENETRATIONS AND ENDS TURNED UP. IT SHALL BE FABRICATED AND INSTALLED TO ENSURE THAT MOISTURE IN WALLS WILL BE DIRECTED TO WICKS AND WEEP HOLES.

22. COORDINATE ALL DIMENSIONS CONCERNING DOORS/PANELS/WINDOWS, STAIRS AND THEIR OPENINGS WITH PRODUCT MANUFACTURERS PRIOR TO FABRICATION AND CONSTRUCTION.

23. PROVIDE WEATHERSTRIP AT EXTERIOR DOORS

24. PROVIDE FLASHING AND/OR SEALANT AT OPENINGS IN ROOF OR WALLS TO ENSURE A WEATHERTIGHT BUILDING.

25. LOCATE THERMOSTATS ADJACENT TO SWITCH PLATES WHERE POSSIBLE. VERIFY LOCATION WITH THE ARCHITECT PRIOR TO INSTALLATION TO AVOID CONFLICTS WITH BUILT-INS OR SYSTEMS FURNITURE OR DESIGN ELEMENTS.

26. ALIGN OUTLETS, WALL SWITCHES, TEL-DATA JACKS, ETC.,

INDICATED TO BE MOUNTED AT NEAR EQUIVALENT ELEVATIONS. 27. ALL DOORS SHALL BE LOCATED 6" OFF THE ADJACENT PARTITION, OR ONE MASONRY COURSE AT CMU PARTITIONS, UNLESS NOTED OTHERWISE.

28. DURING DEMOLITION AND CONSTRUCTION PROTECT ALL EXISTING FINISHES TO REMAIN.

29. ALL WOOD SHALL BE FSC CERTIFIED.

30. ALL WOOD FRAMING SIZES ARE BASED ON SPF-SS

31. ALL WOOD IN CONTACT WITH CONCRETE OR MASONRY SHALL BE PRESSURE TREATED (P.T.).

32. CORRECT ALL DEFECTS FOUND IN EXISTING BUILDING WHICH INTERFERE WITH NEW CONSTRUCTION. THIS INCLUDES BUT IS NOT LIMITED TO UNEVEN SURFACES AND FINISHES AT GWB.

1 P-GENERAL NOTES 1 1/2" = 1'-0"



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REGISTRATIONS:

STRUCTURAL ENGINEER:

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TRISH

ST. RESIDENC S ALPINE BRIDGE % | | | | |


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02

BZA SUBMISSION SET Project Number Project number

Date 11/13/2020 Drawn by Author Checker Checked by

Scale 1 1/2" = 1'-0"

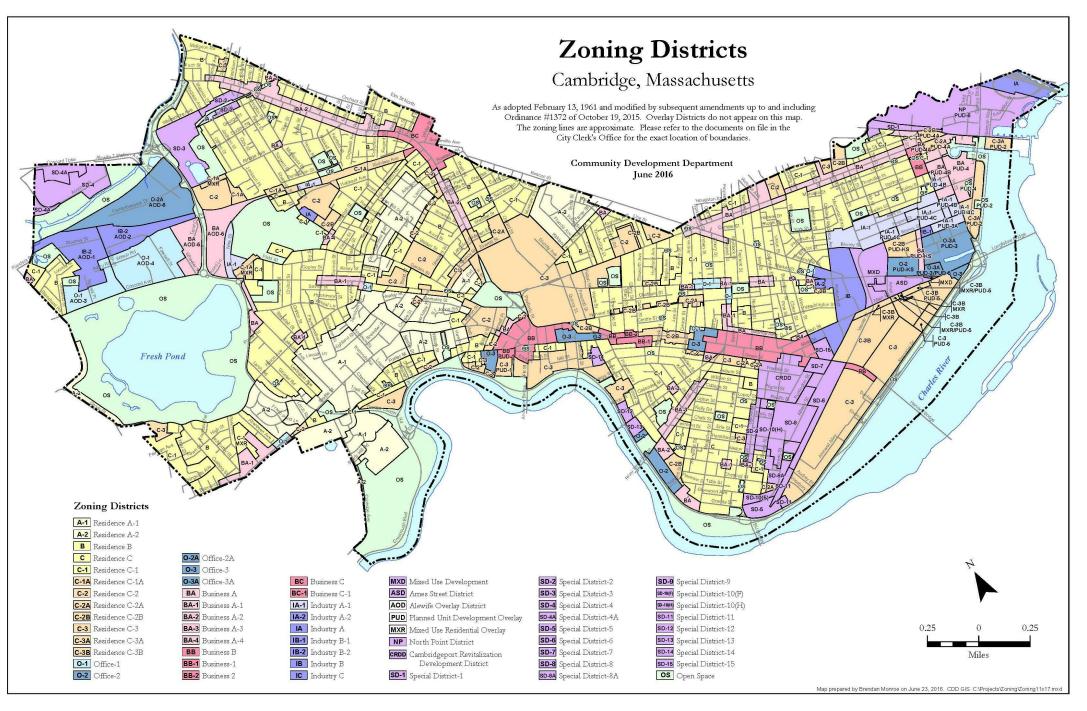

EXISTING FAR						
Level	Area	Comments	Count	Name		
	·					
EXISTING LEVEL 1	982 SF		1	FINISHED		
EXISTING LEVEL 1	118 SF		1	FRONT PORCH		
EXISTING LEVEL 1	64 SF		1	BACK DECK		
EXISTING LEVEL 2	918 SF		1	FINISHED		
EXISTING LEVEL 2	63 SF		1	DECK		
EXISTING LEVEL 2	118 SF		1	PORCH		
	'	•	•	<u>'</u>		
PROPOSED LEVEL 3	528 SF		1	ATTIC		
	2791 SF	'	•	'		

Proposed FAR				
Level	Area	Comments	Count	Name
EXISTING LEVEL 1	69 SF		1	PORCH
EXISTING LEVEL 1	1000 SF		1	FINISHED
EXISTING LEVEL 1	84 SF		1	DECK
EXISTING LEVEL 1	55 SF		1	STAIRWELL
EXISTING LEVEL 2	1073 SF		1	FINISHED
EXISTING LEVEL 2	79 SF		1	DECK
PROPOSED LEVEL 3	925 SF		1	FINISHED
	3285 SF	•		-

ZONE: RESIDENCE B SINGLE- & TWO-FAMILY DETACHED DWELLING TOWNHOUSE DWELLINGS

FRONT YARD SETBACK: 15' LEFT SIDE SETBACK: 4' - 6" RIGHT SIDE SETBACK: 7' - 6" REAR YARD SETBACK: 25'

35' MAXIMUM BUILDING HEIGHT

LOT SIZE: 3,800 SQ. FT.

MAXIMUM FAR: 0.50 EXISTING FAR = .73PROPOSED FAR = .86

PROPOSED FAR INCREASE = .13

EXISTING OPEN SPACE: MINIMUM 40% REQUIREMENT

EXISTING OPEN SPACE: .61

NEW OPEN SPACE: .59

EXISTING RIDGE HEIGHT= 29' - 0"

NEW RIDGE HEIGHT = 35' - 0"

INCREASE ROOF HEIGHT= 6' - 0"

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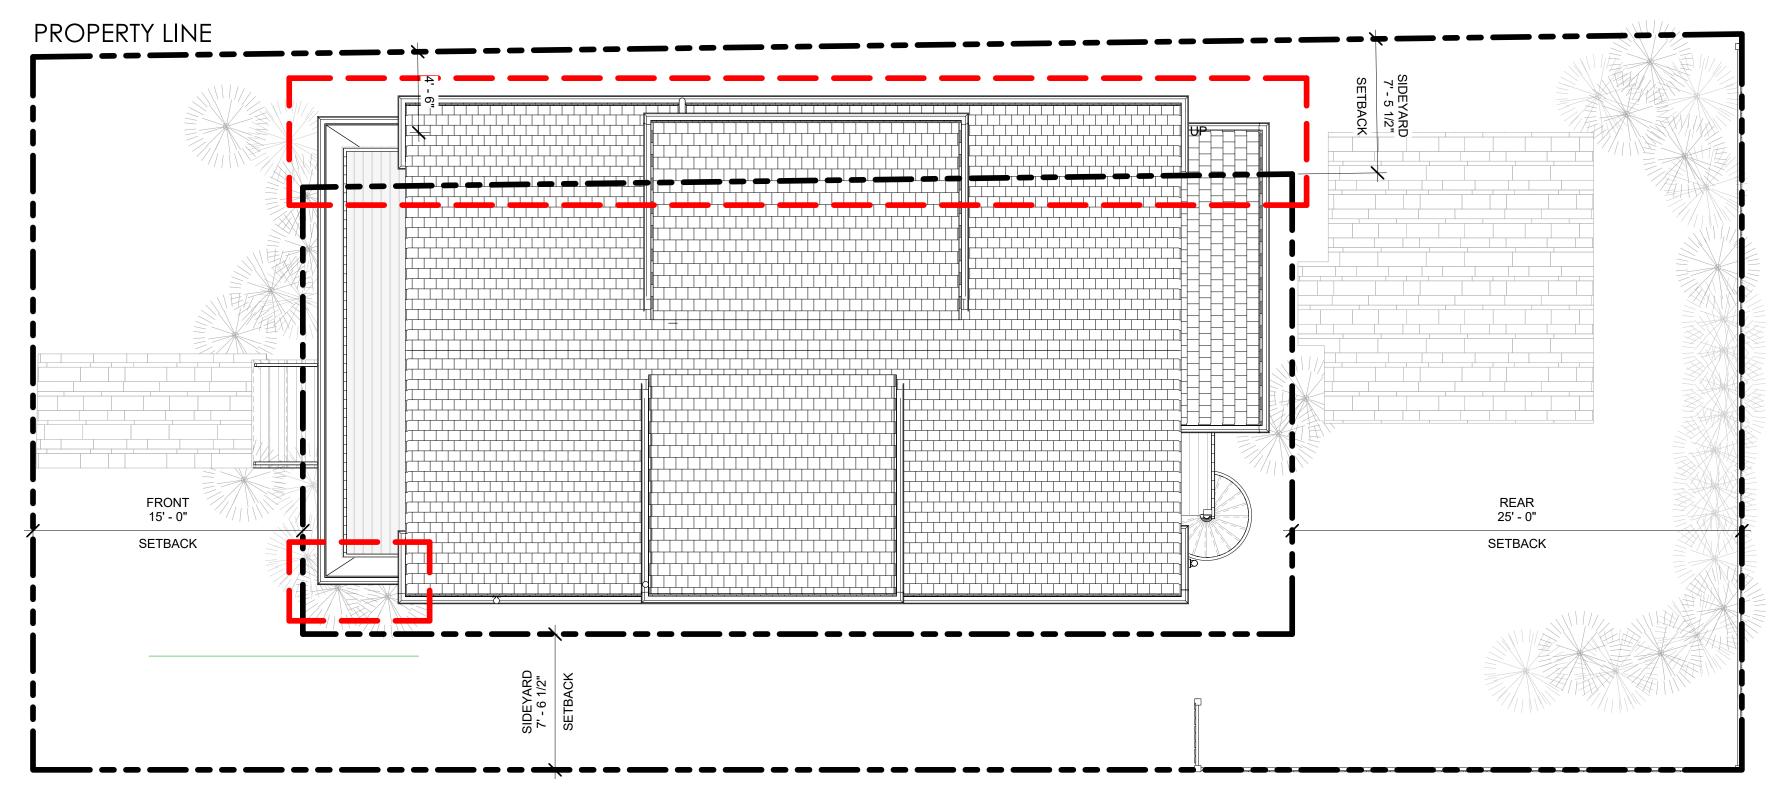
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Project number	Project Number
Date	11/13/2020
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P-002

As indicated

<u>DECK</u> 141 SF Existing FAR Proposed FAR ATTIC DECK 9 P-EXISTING LEVEL 3 1/16" = 1'-0" FINISHED 5 P-PROPOSED LEVEL 3 1/16" = 1'-0"





PROPOSED EXISTING







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P-004

1" = 30'-0"







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STREET VIEW PERSPEC

RESIDENCE


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Date 11/13/2020


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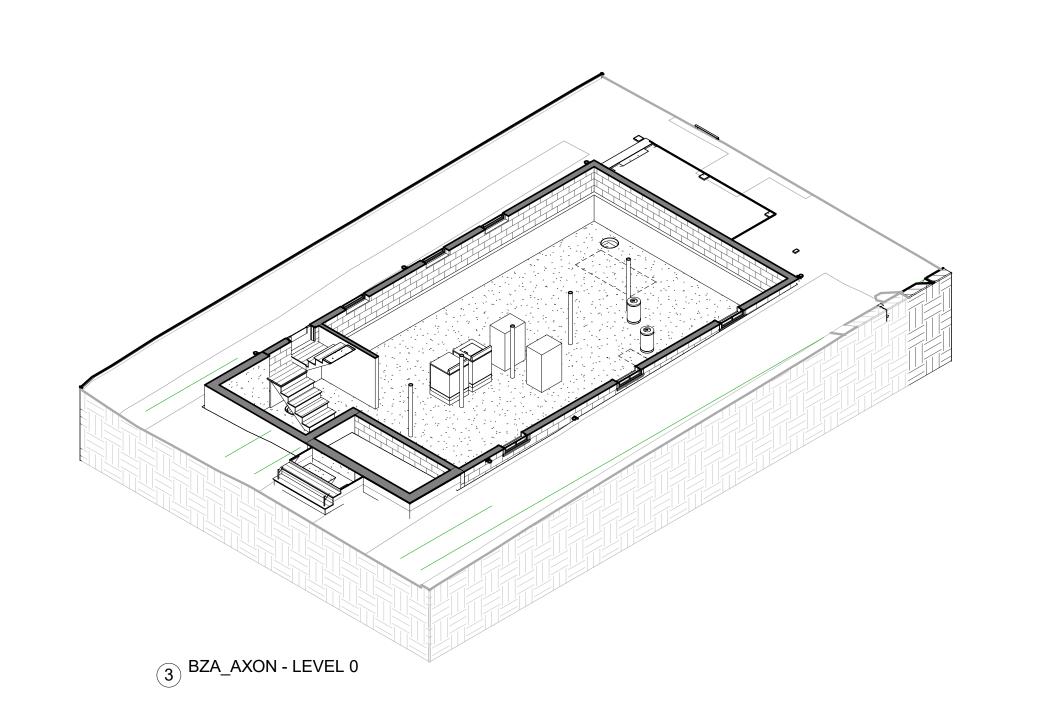
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STREET VIEW PERSPECTIVE

-96 ALPINE ST.





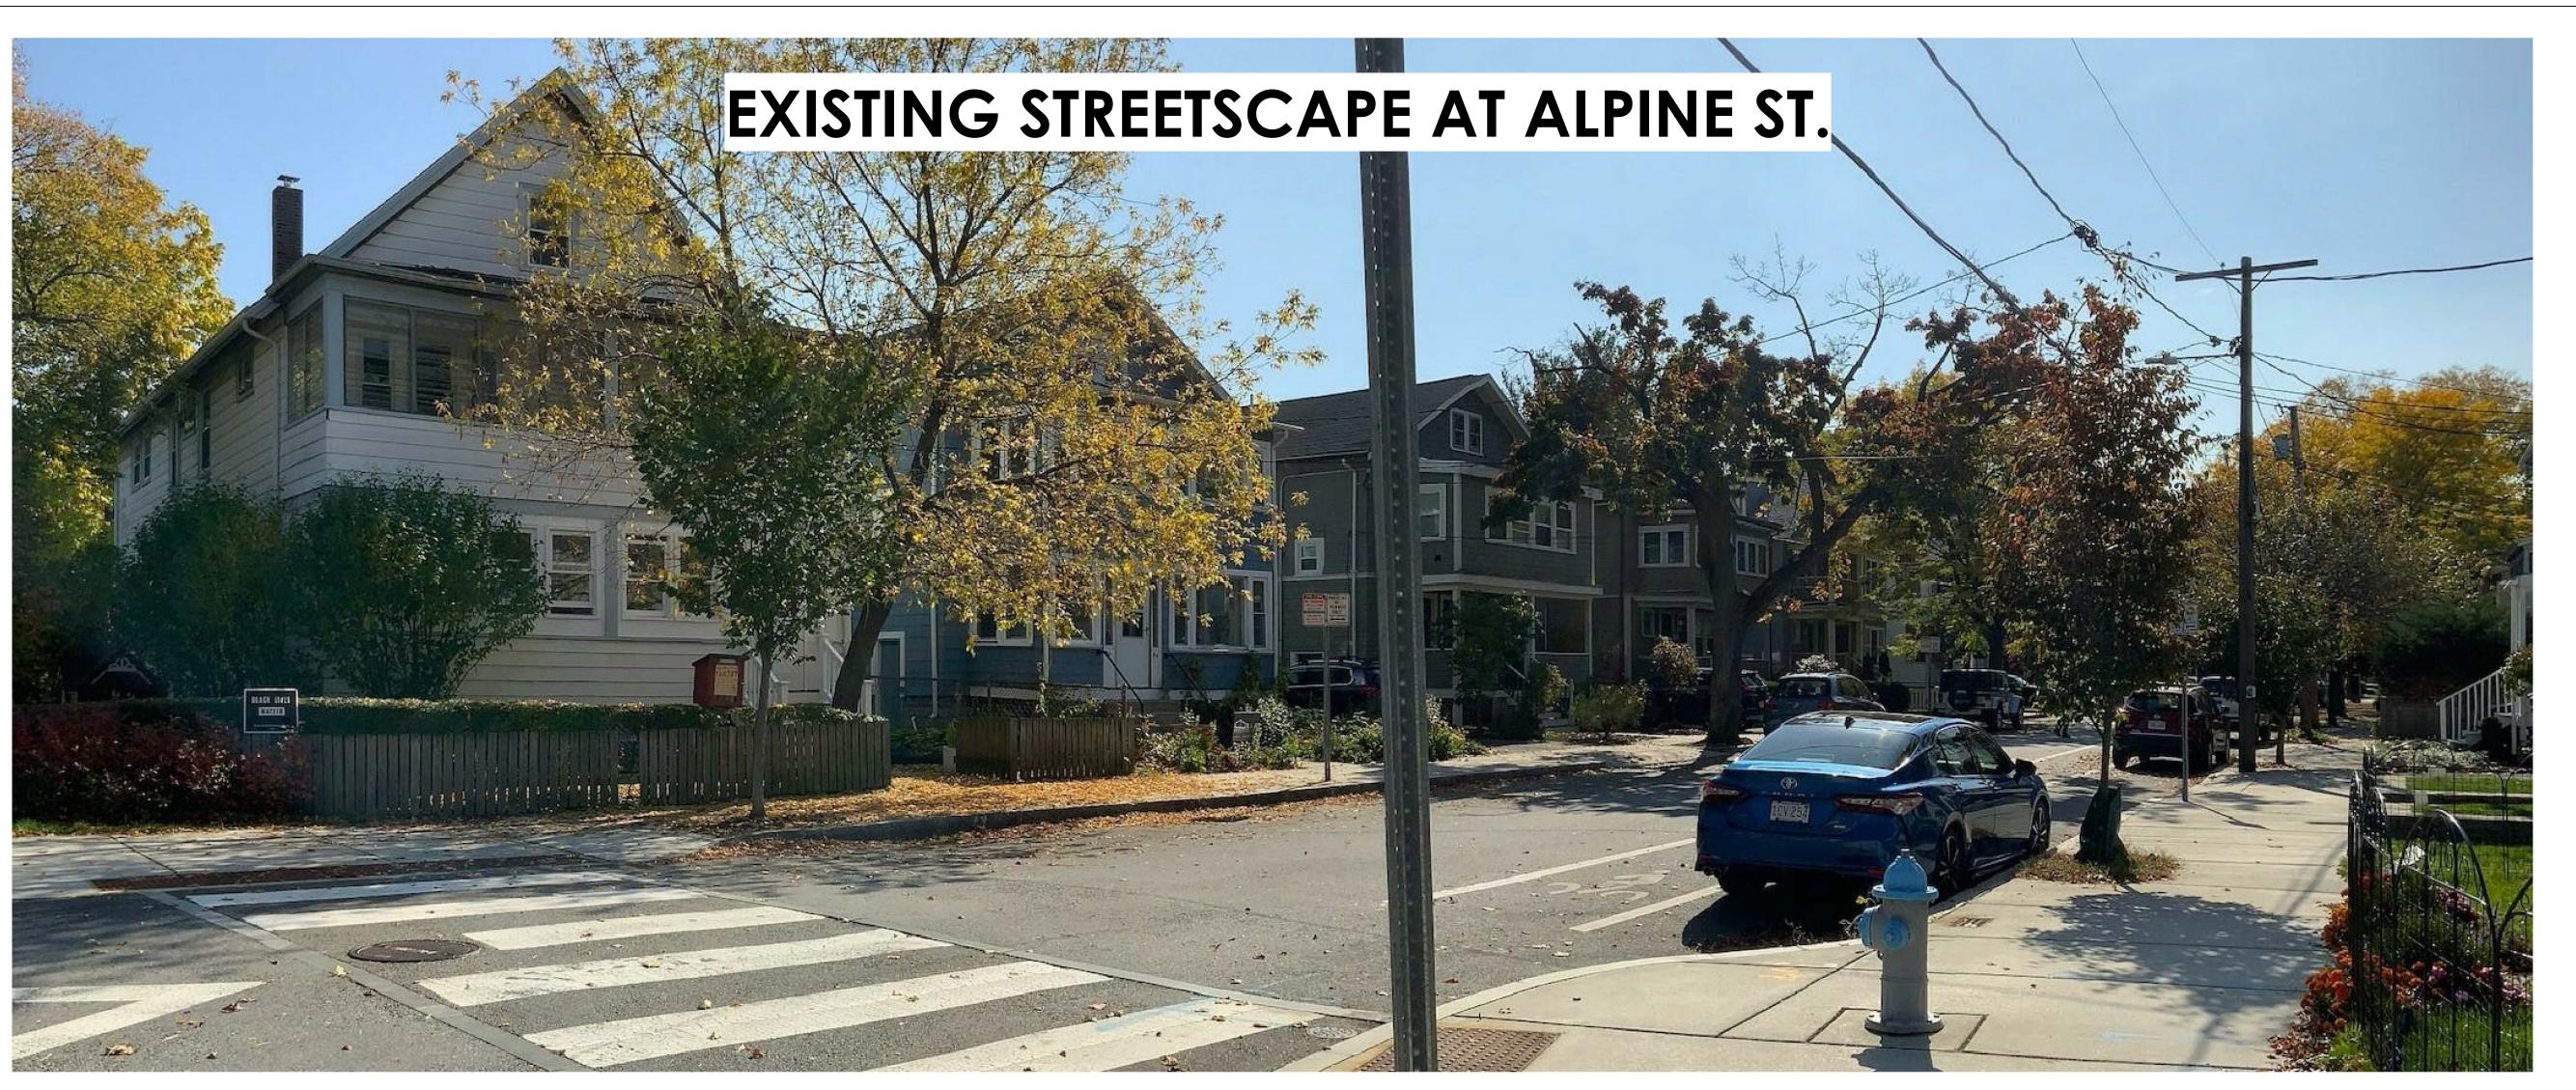
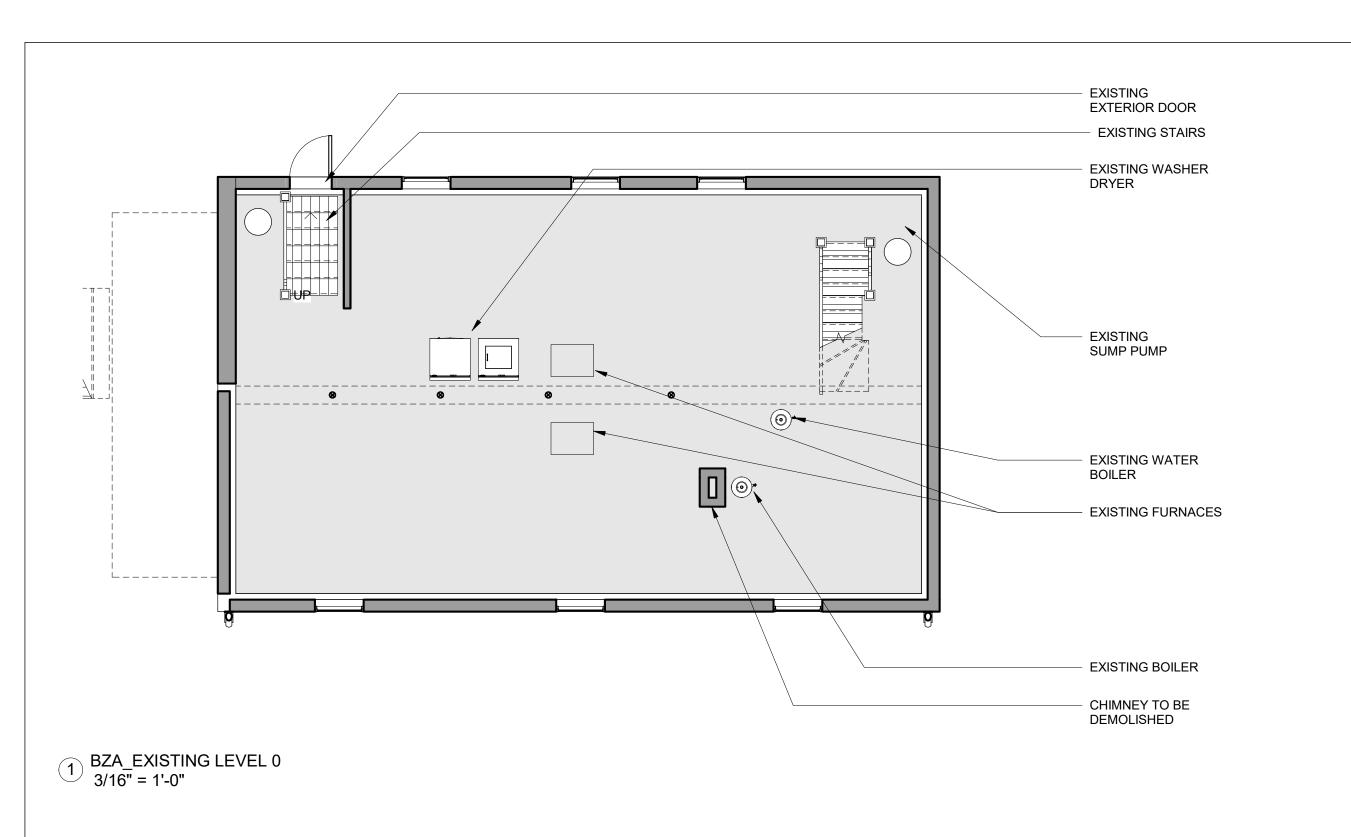
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STEVE


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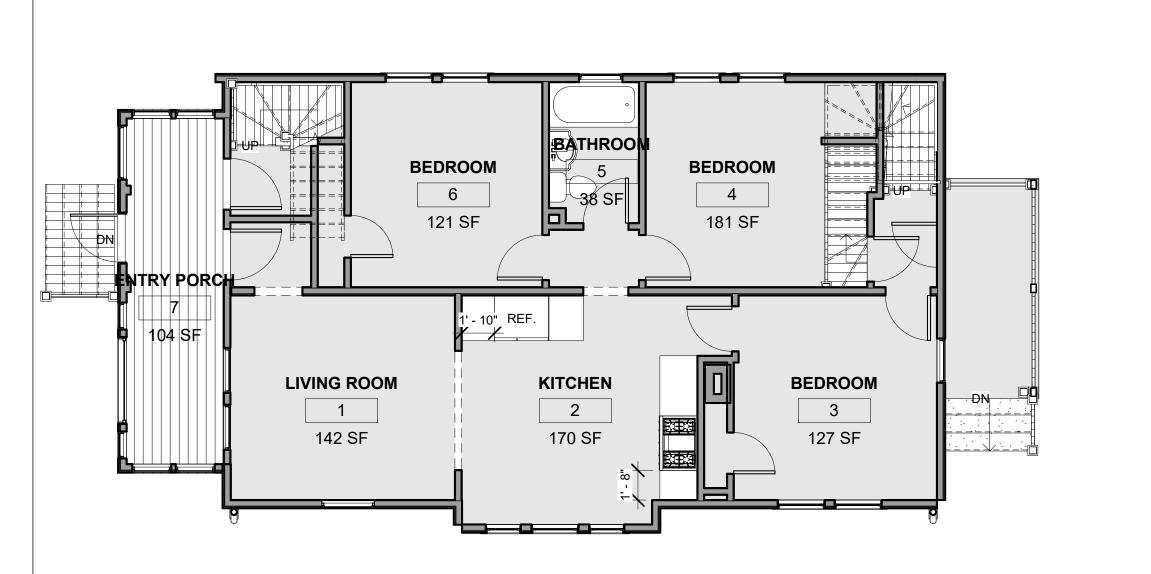
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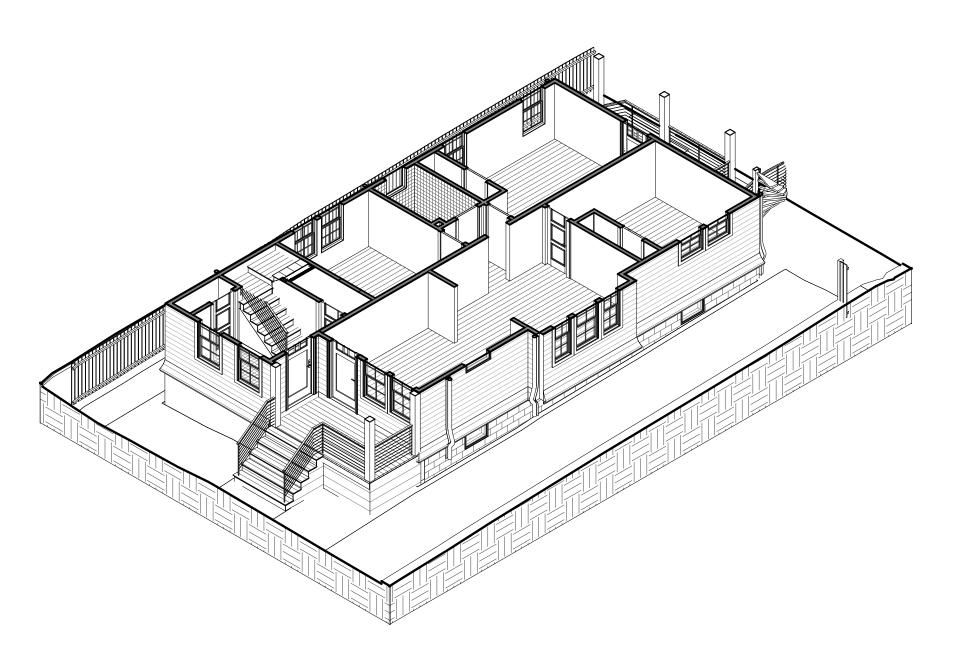
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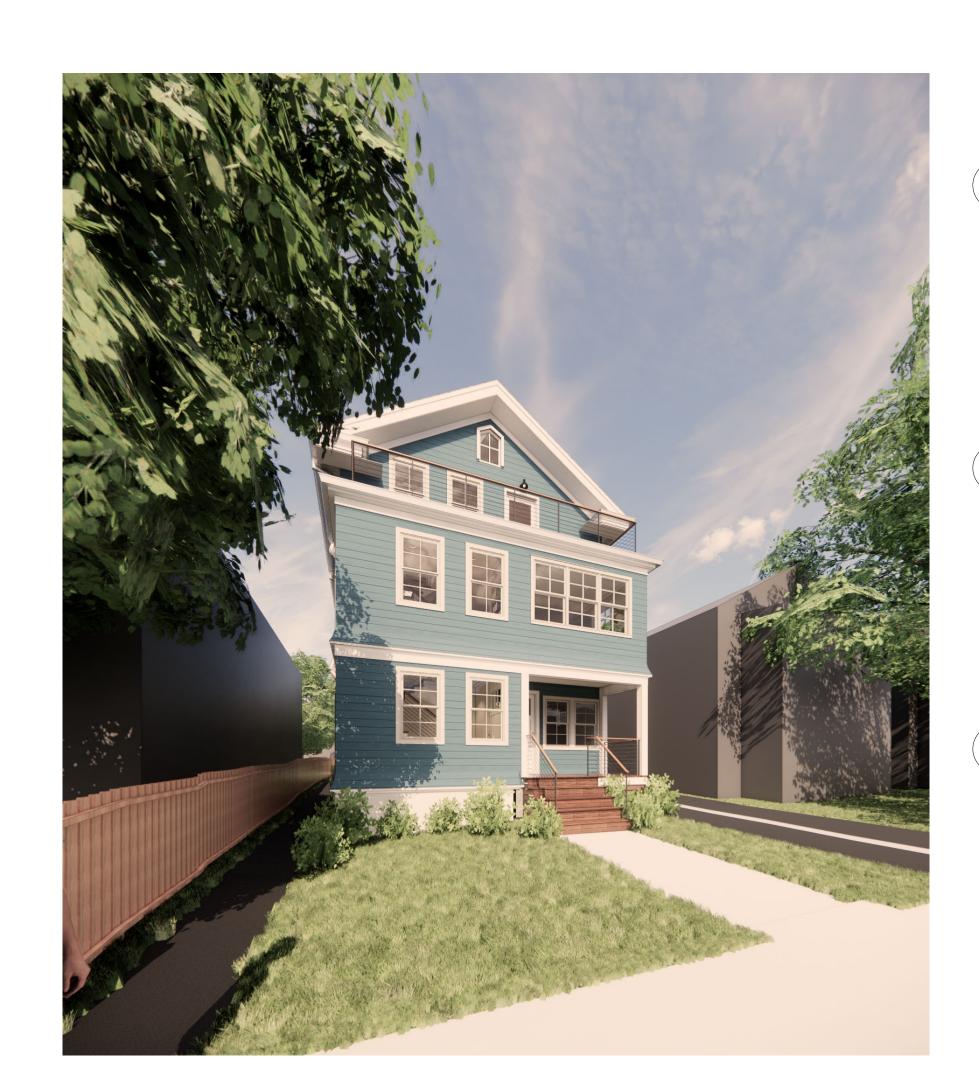





1 BZA_EXISTING LEVEL 1 3/16" = 1'-0"



BZA_AXON - PROPOSED LEVEL 1

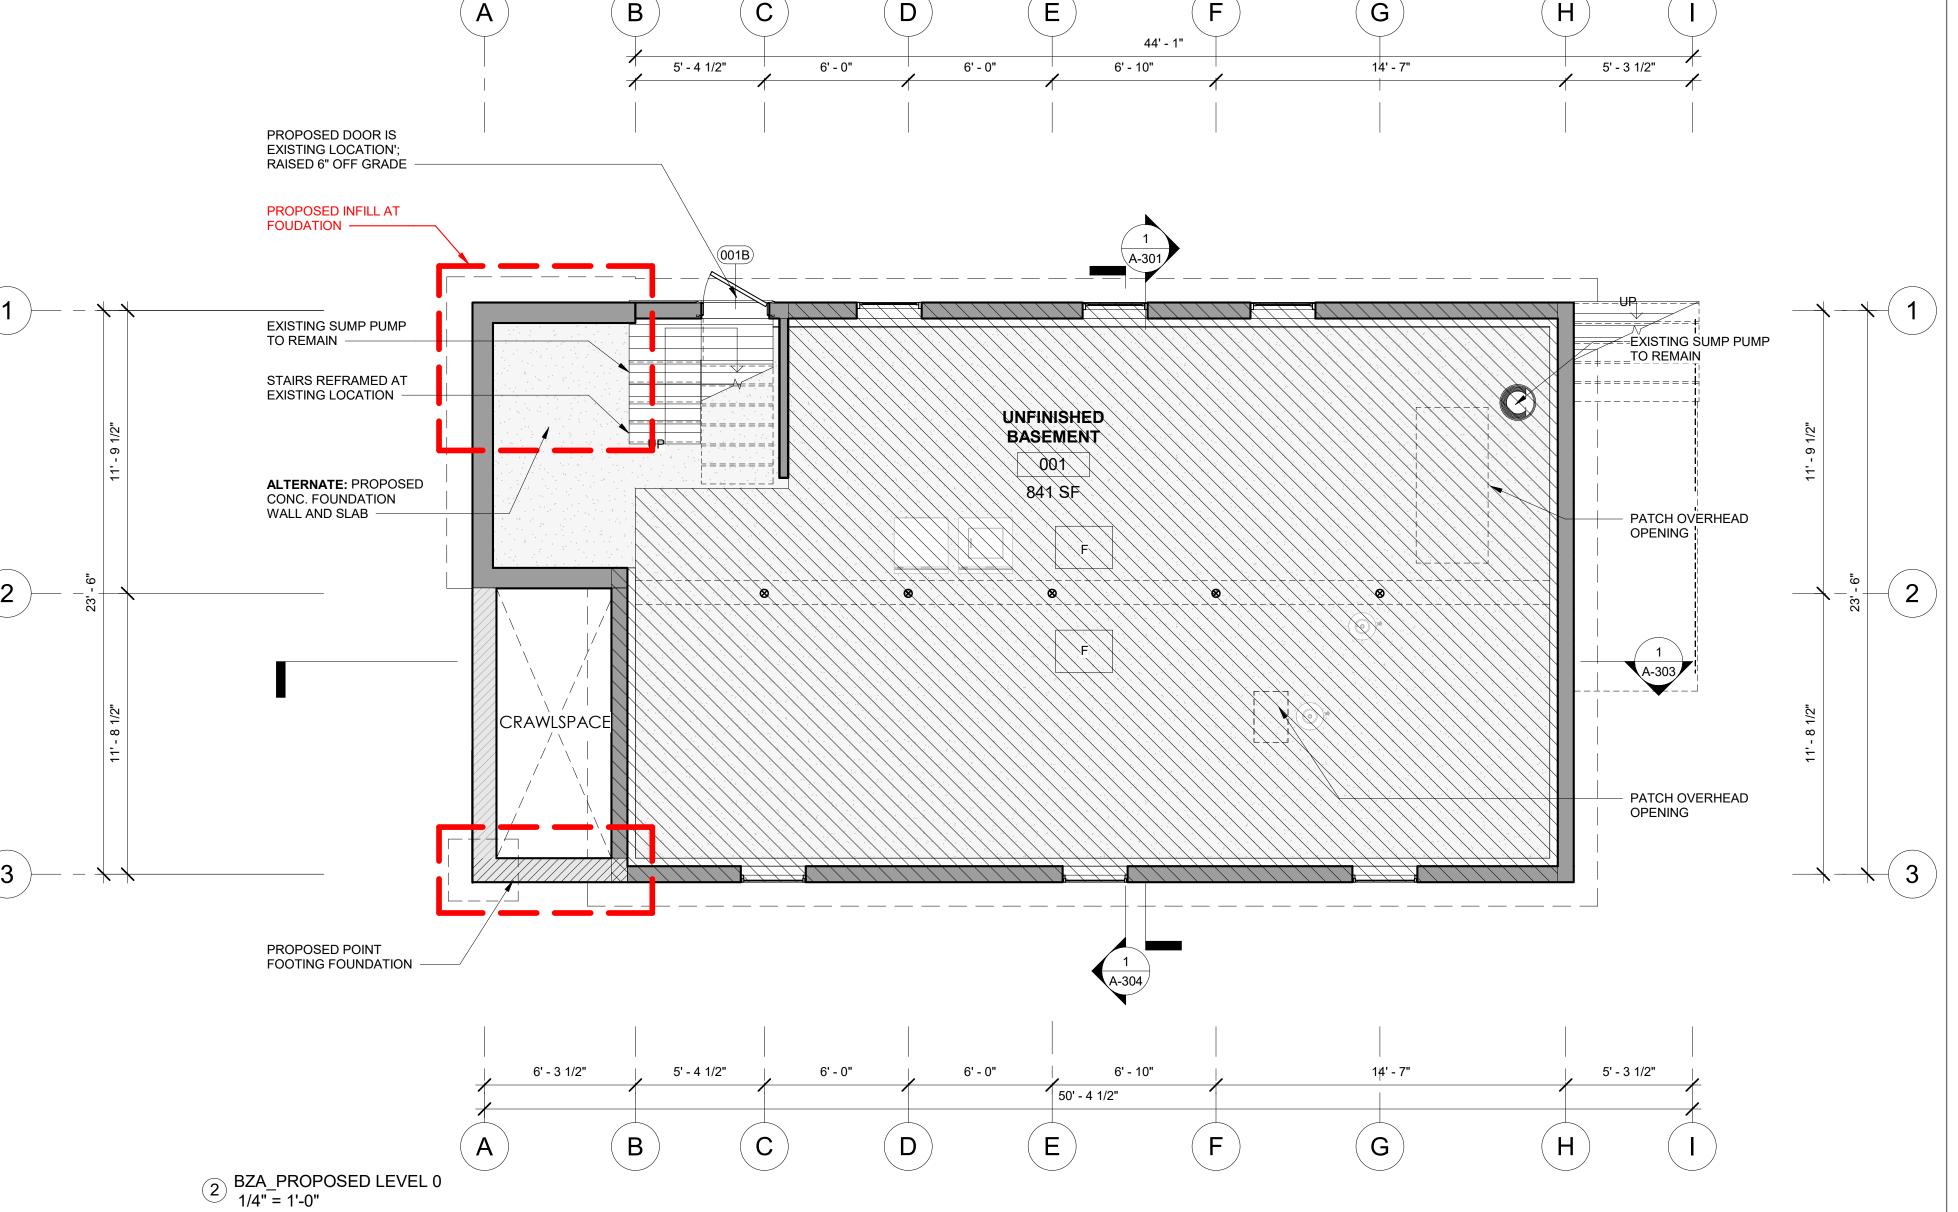

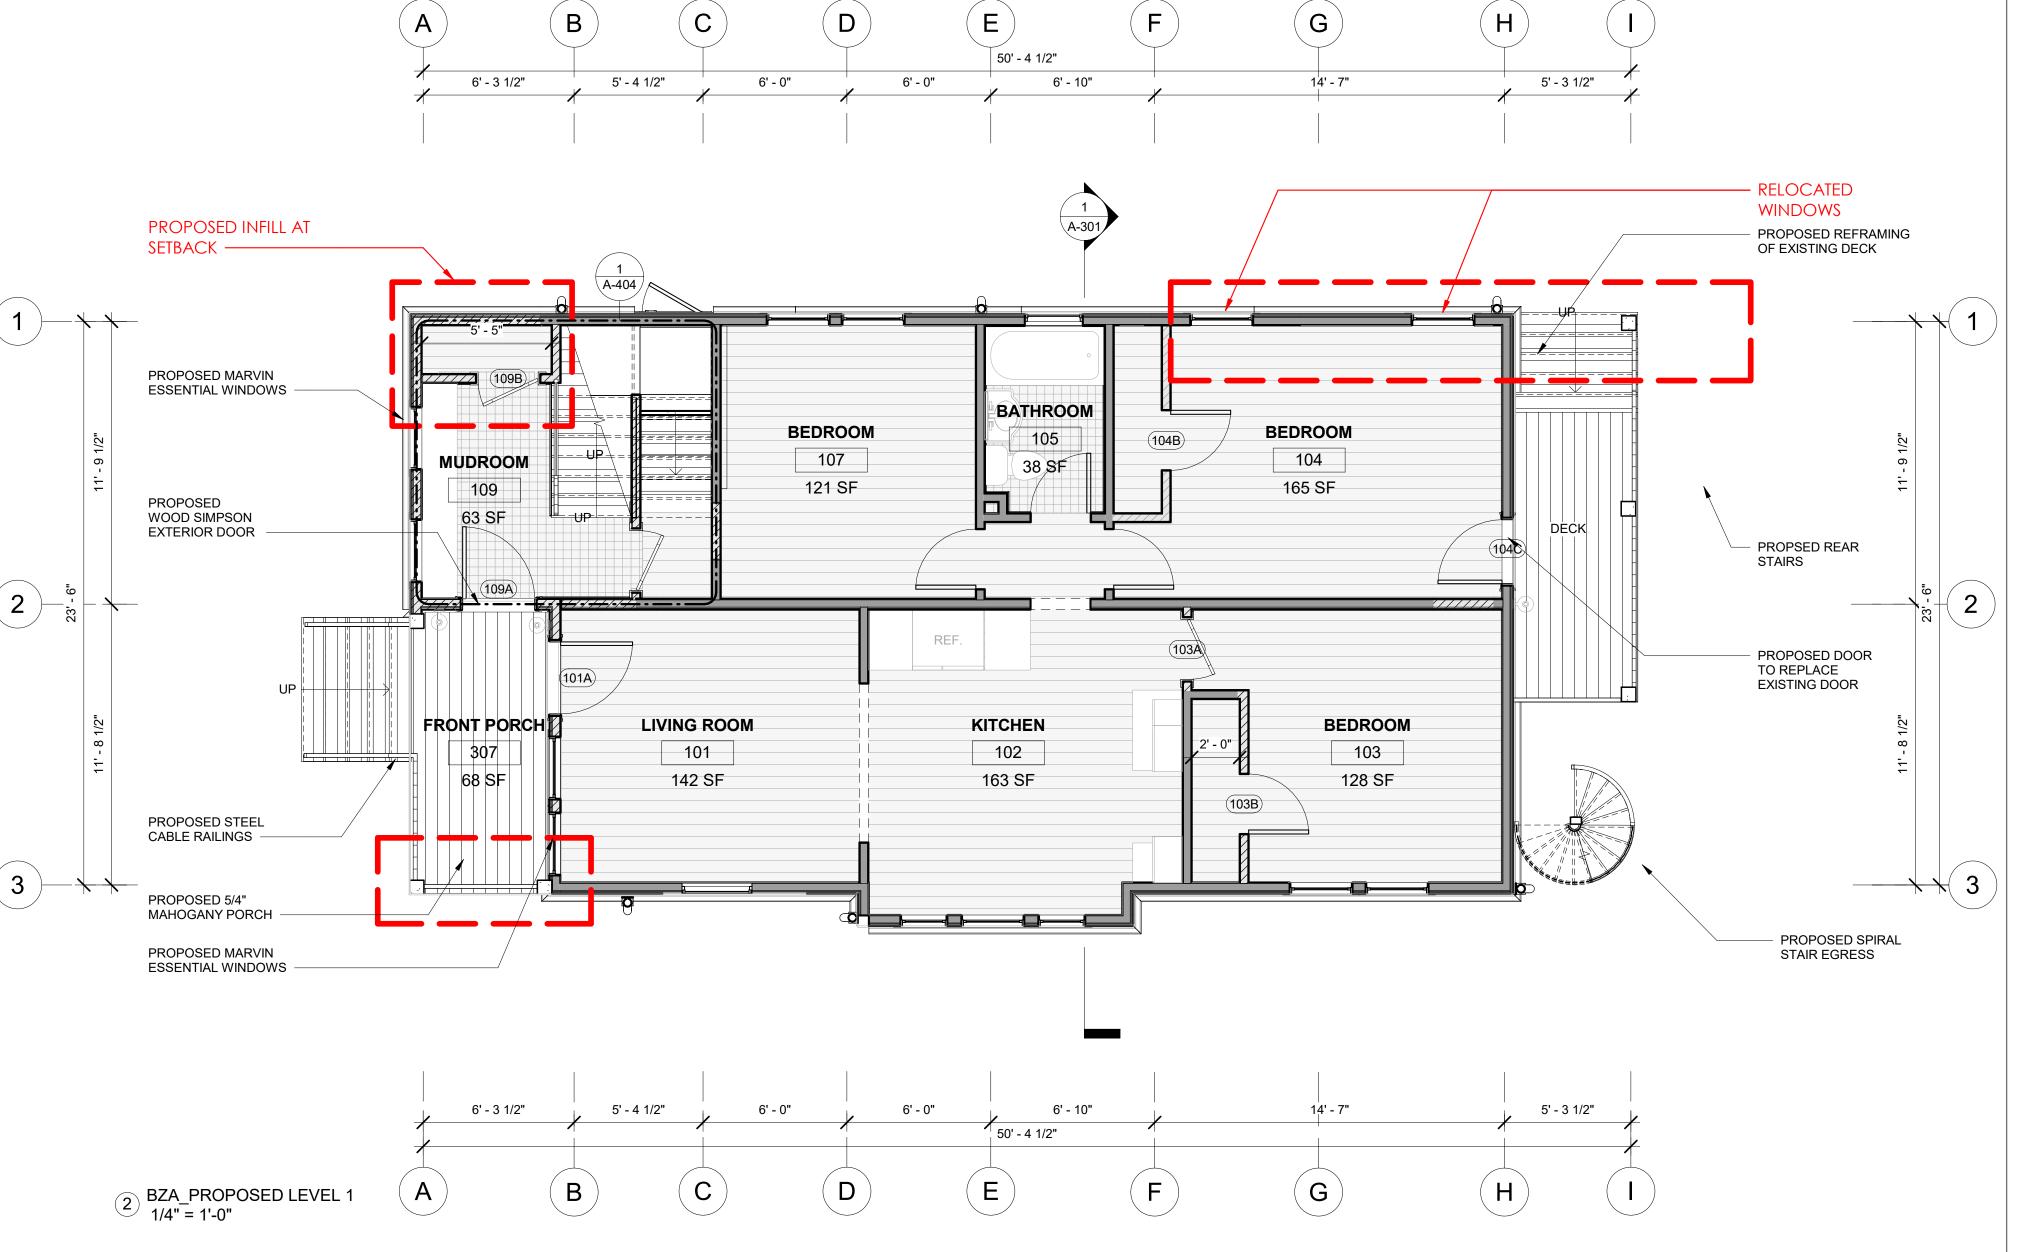

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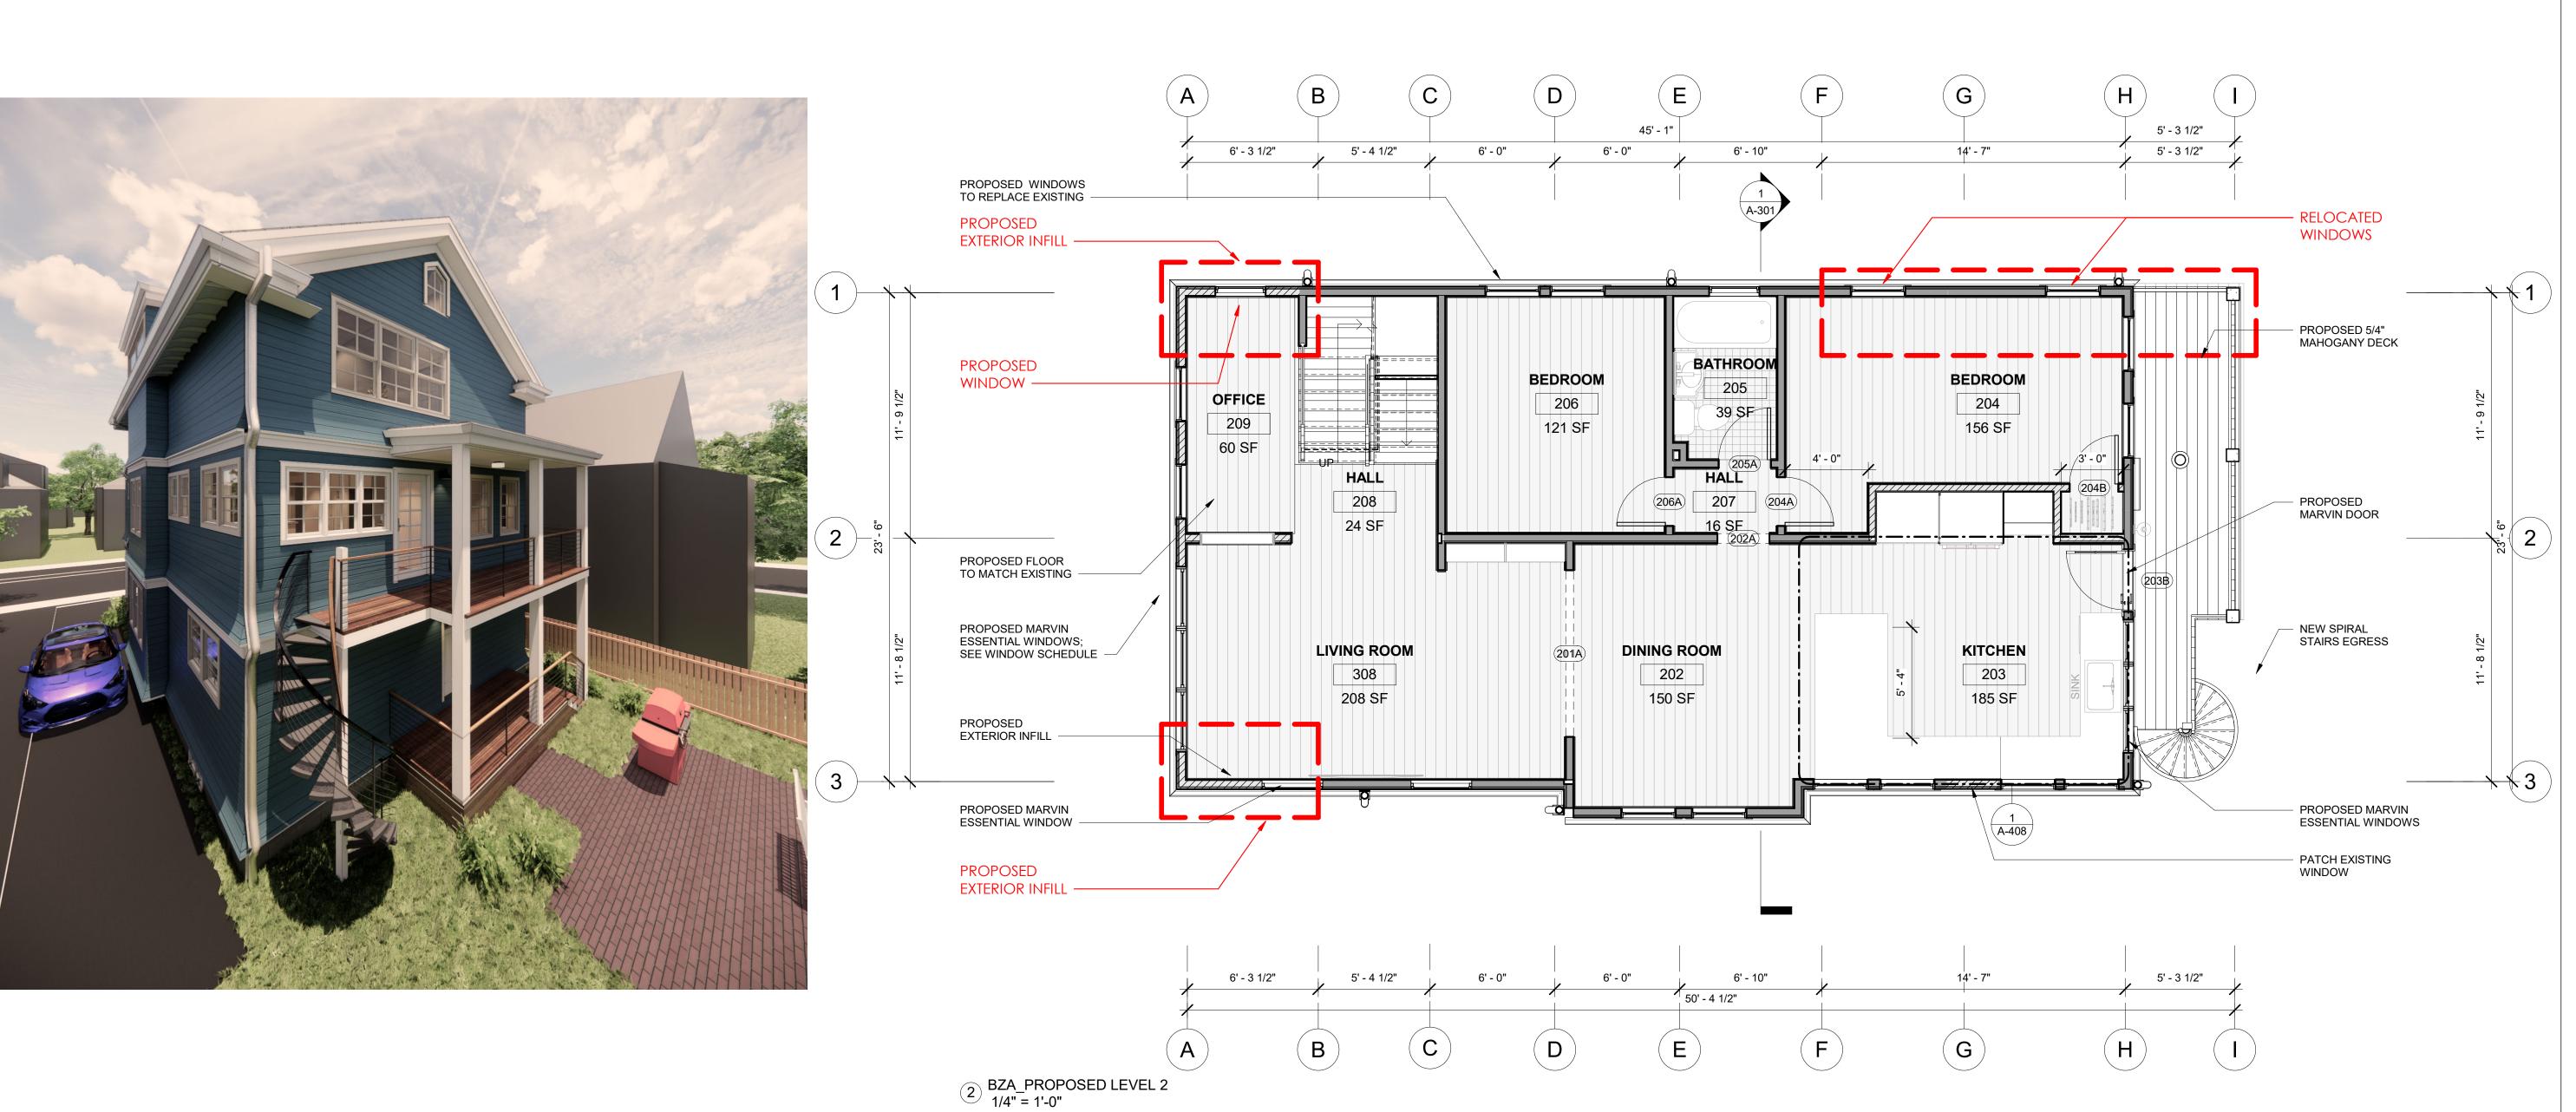
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3 BZA_AXON - PROPOSED LEVEL 2

BEDROOM

13 110 SF

KITCHEN

11

171 SF

BEDROOM

12

16

LIVING ROOM

10

142 SF

104 SF

1 BZA_EXISTING LEVEL 2 3/16" = 1'-0"

STRUCTURAL ENGINEER:

REGISTRATIONS:

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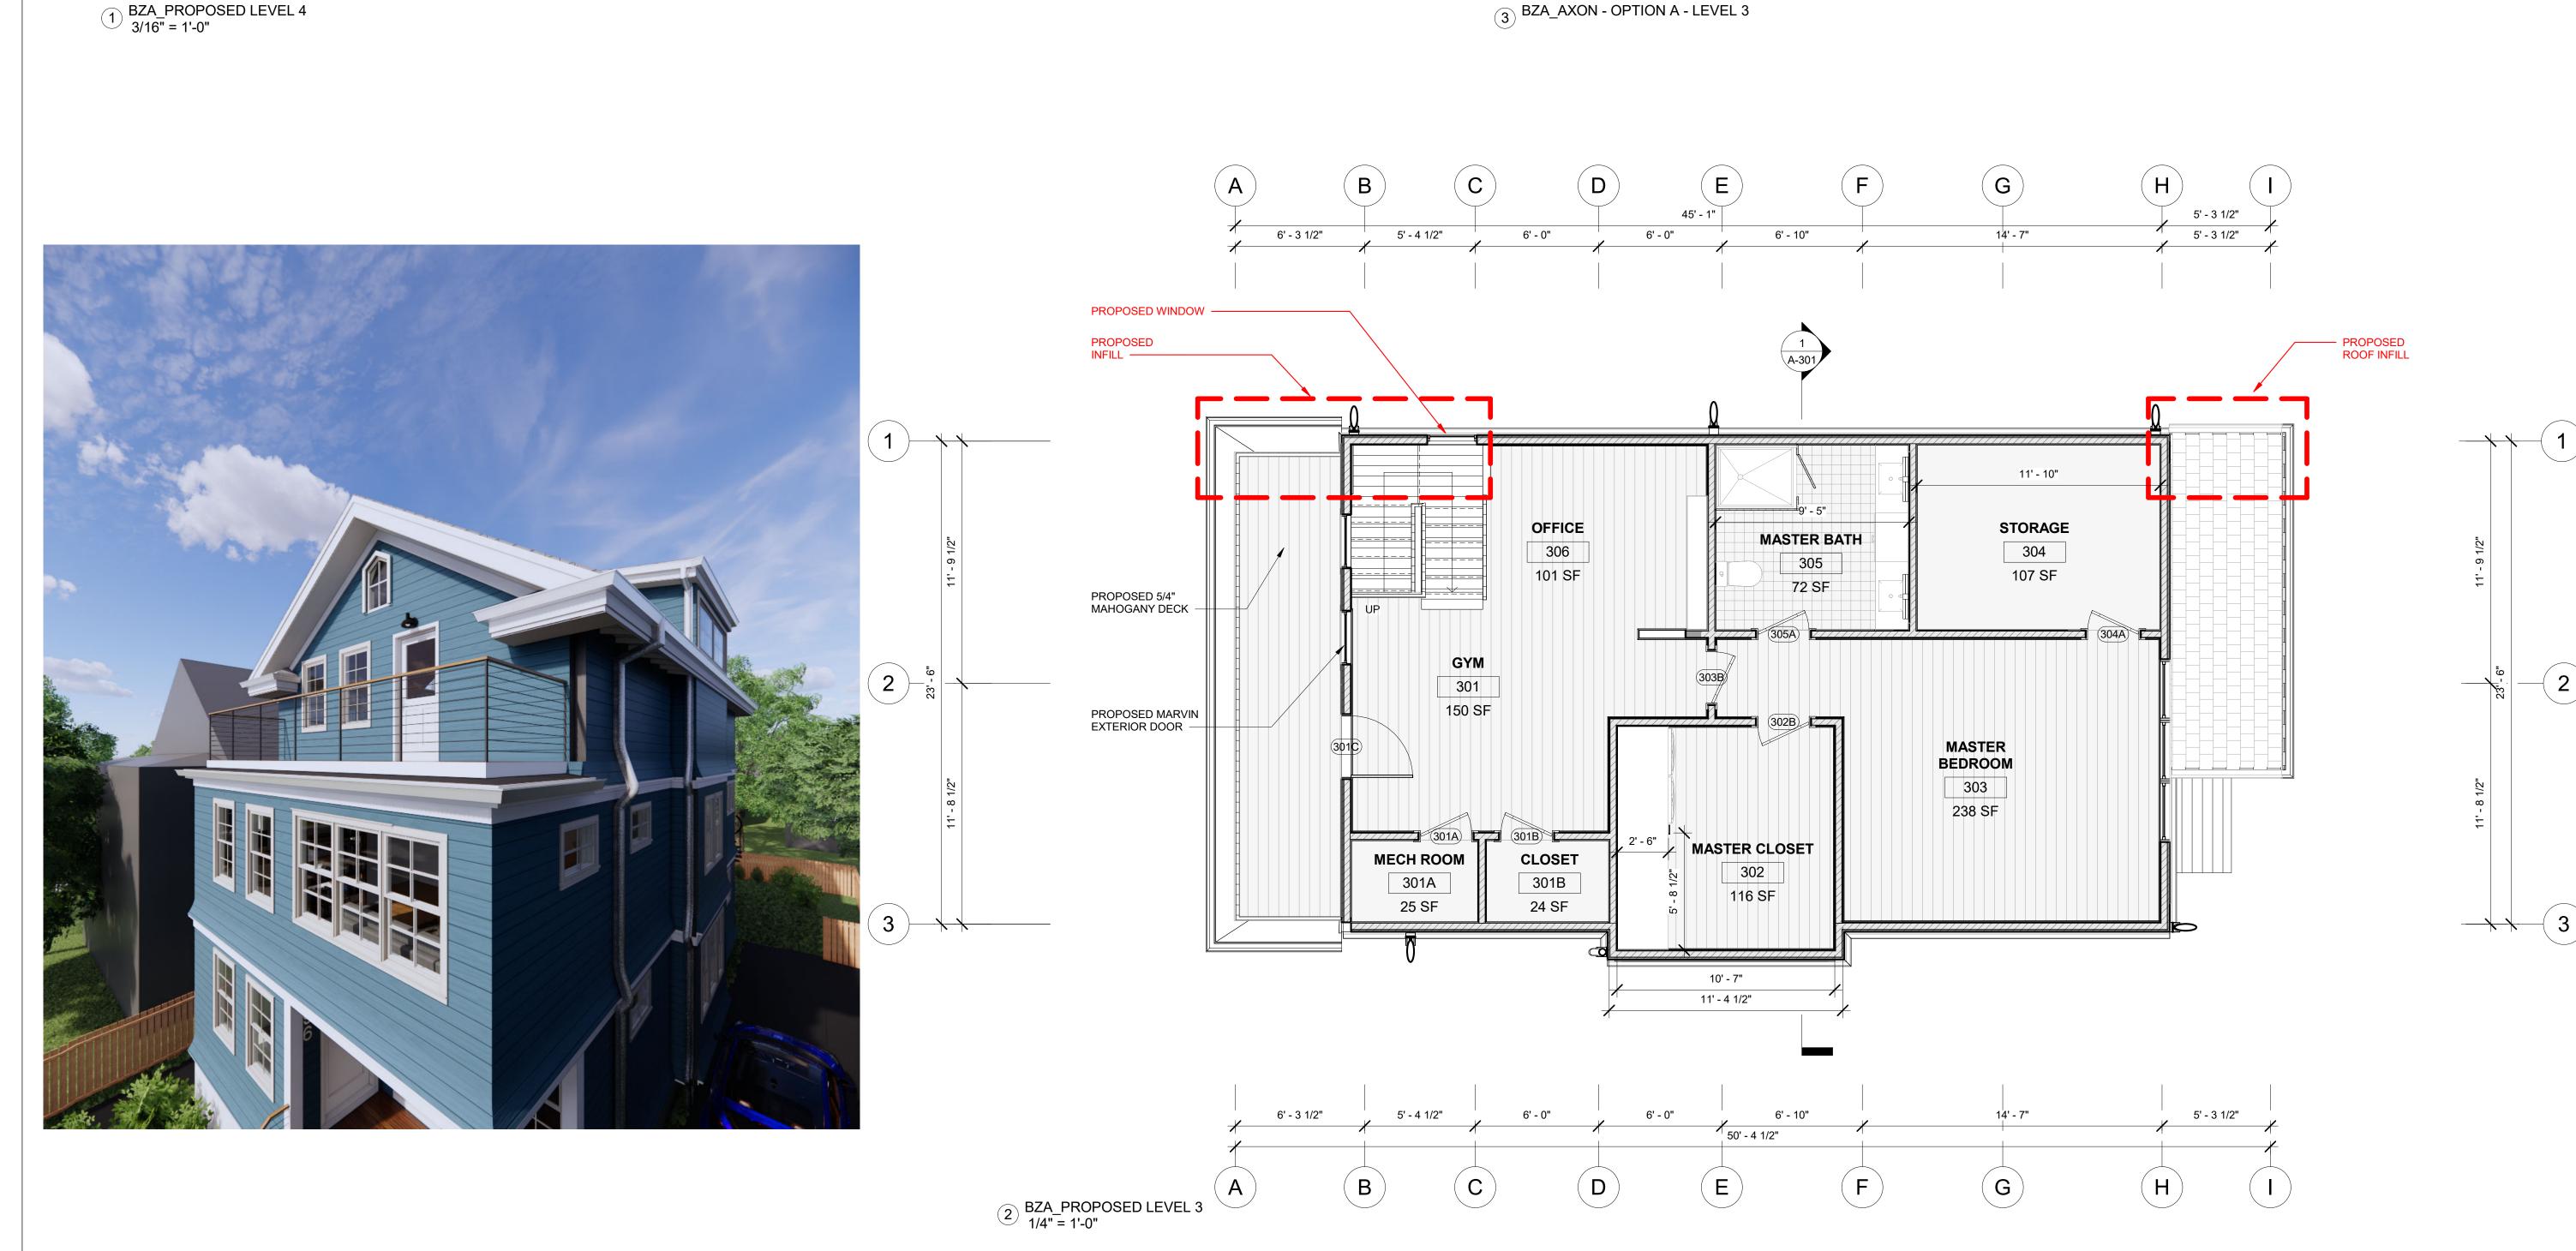
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3 BZA_AXON - OPTION A - LEVEL 3

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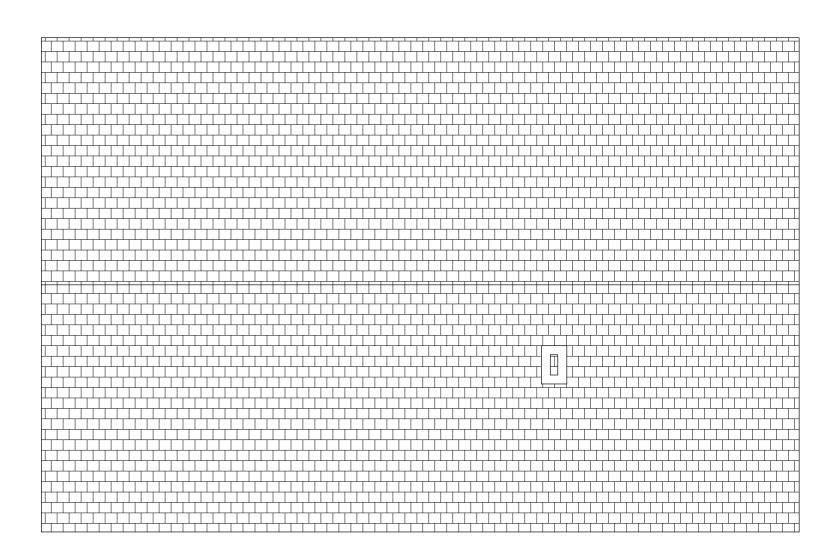
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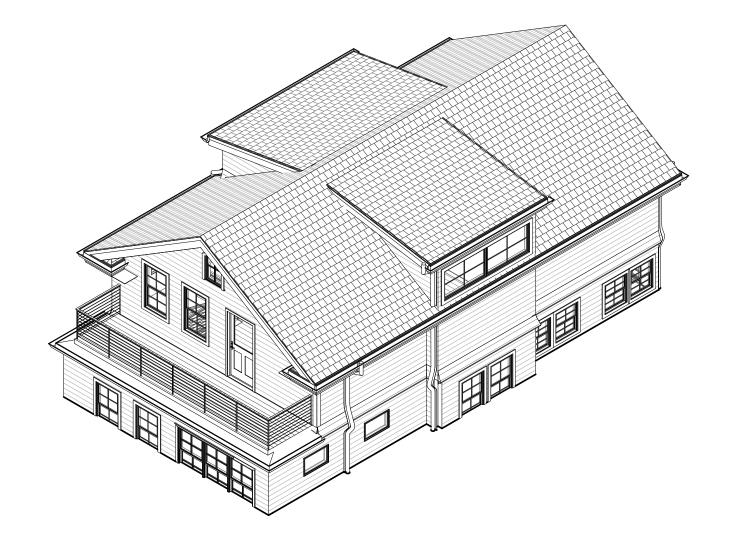
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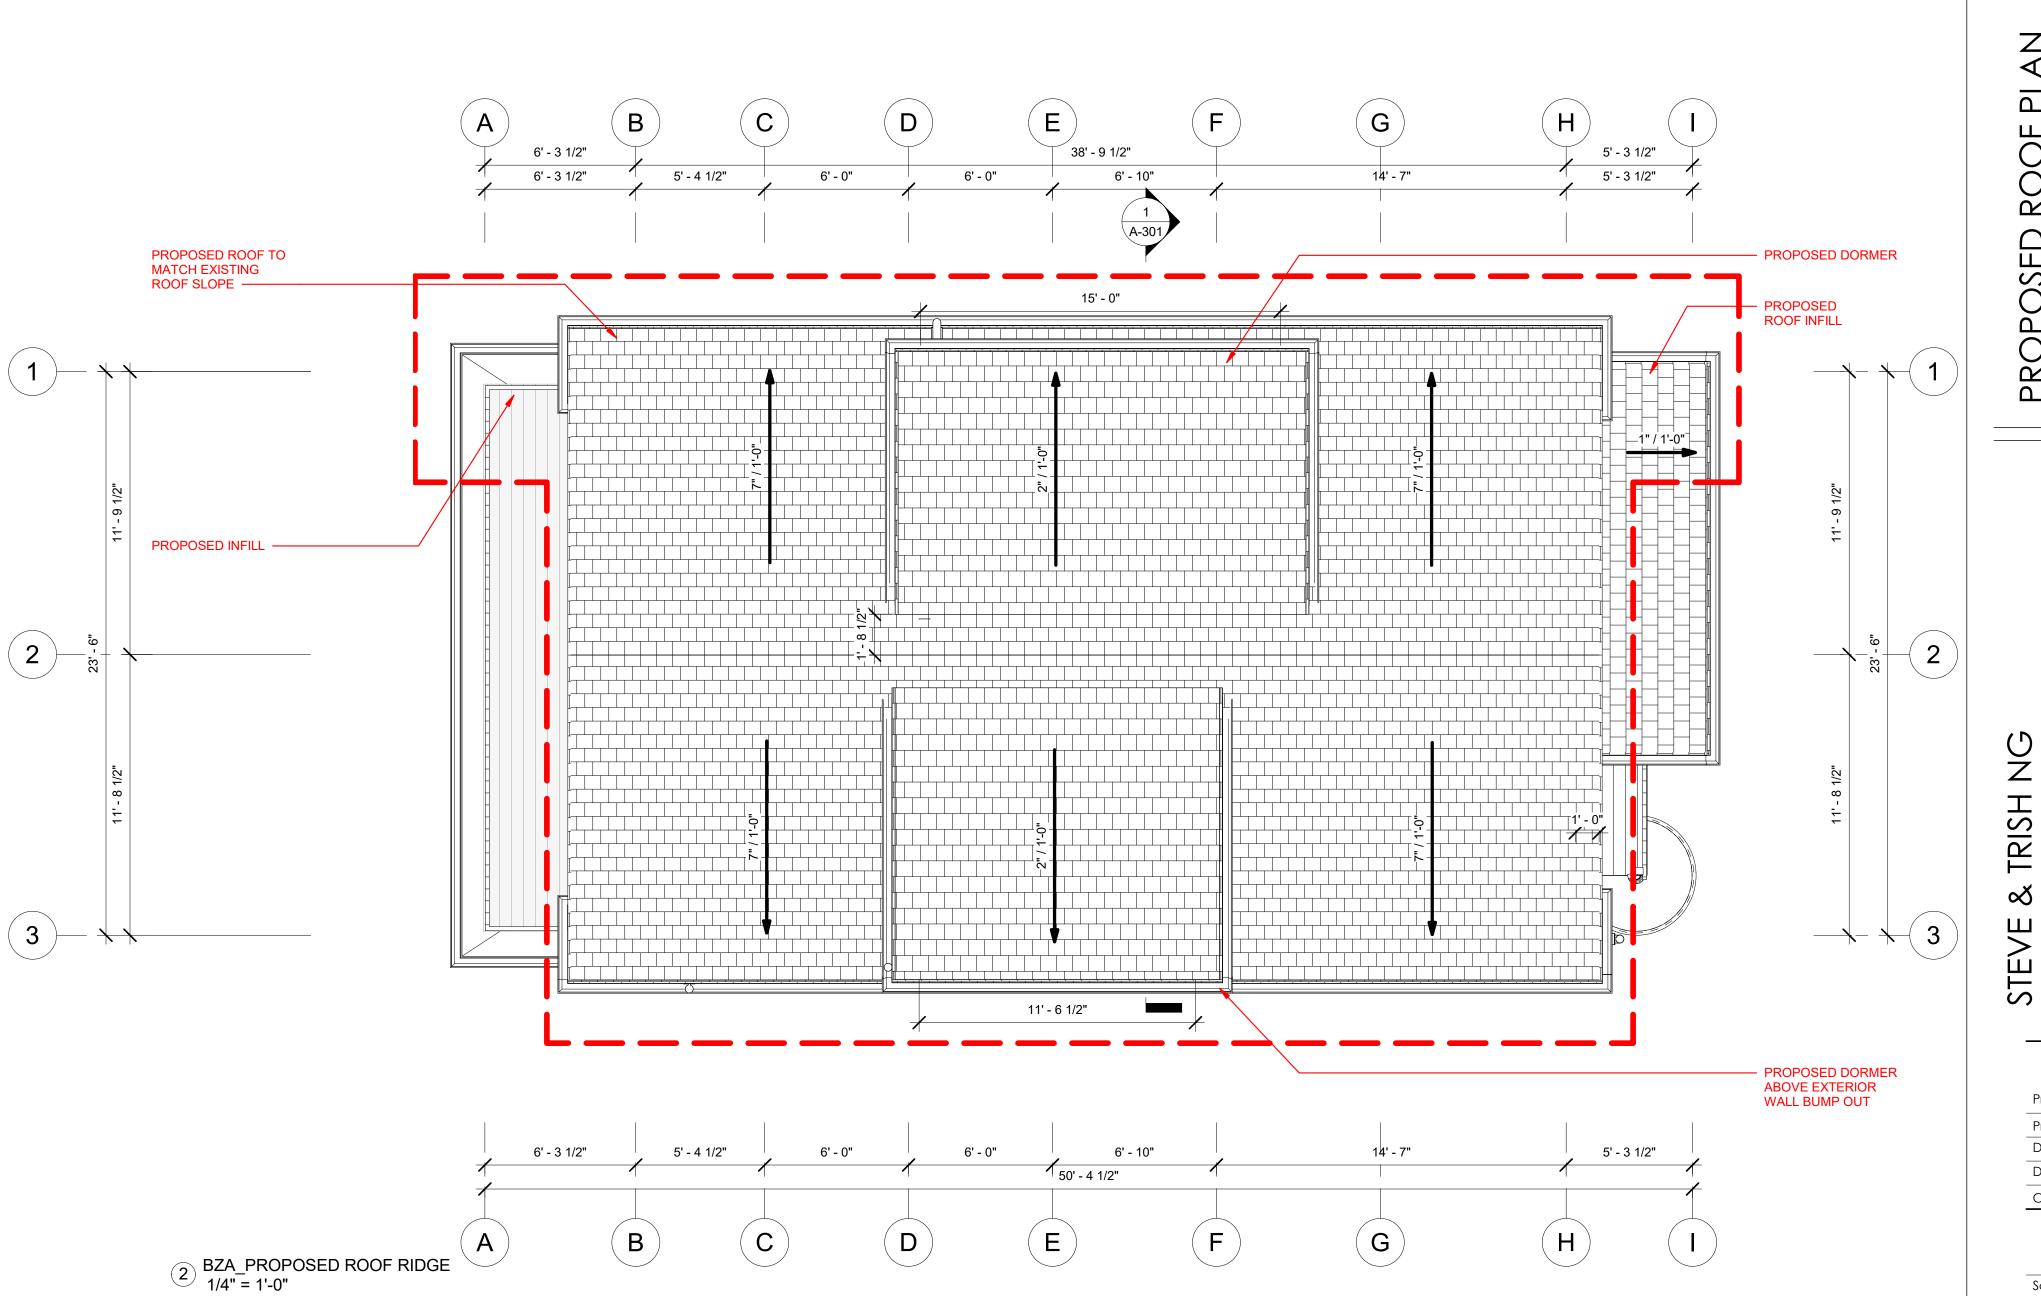


1 BZA_EXISTING ROOF RIDGE 3/16" = 1'-0"



3 BZA_AXON - ROOF LEVEL





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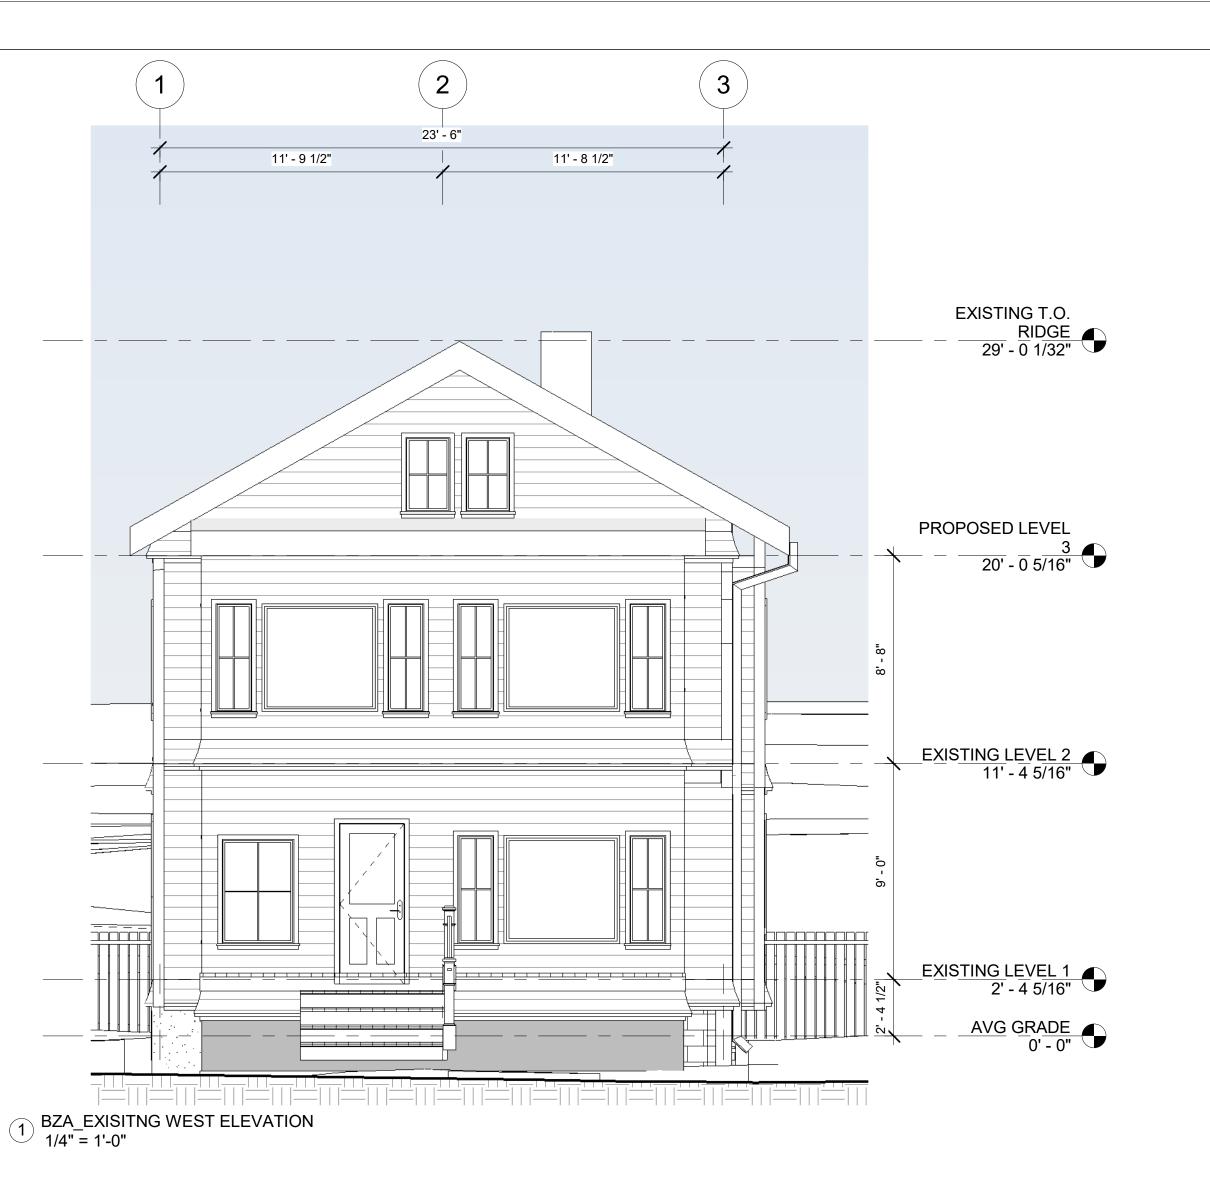
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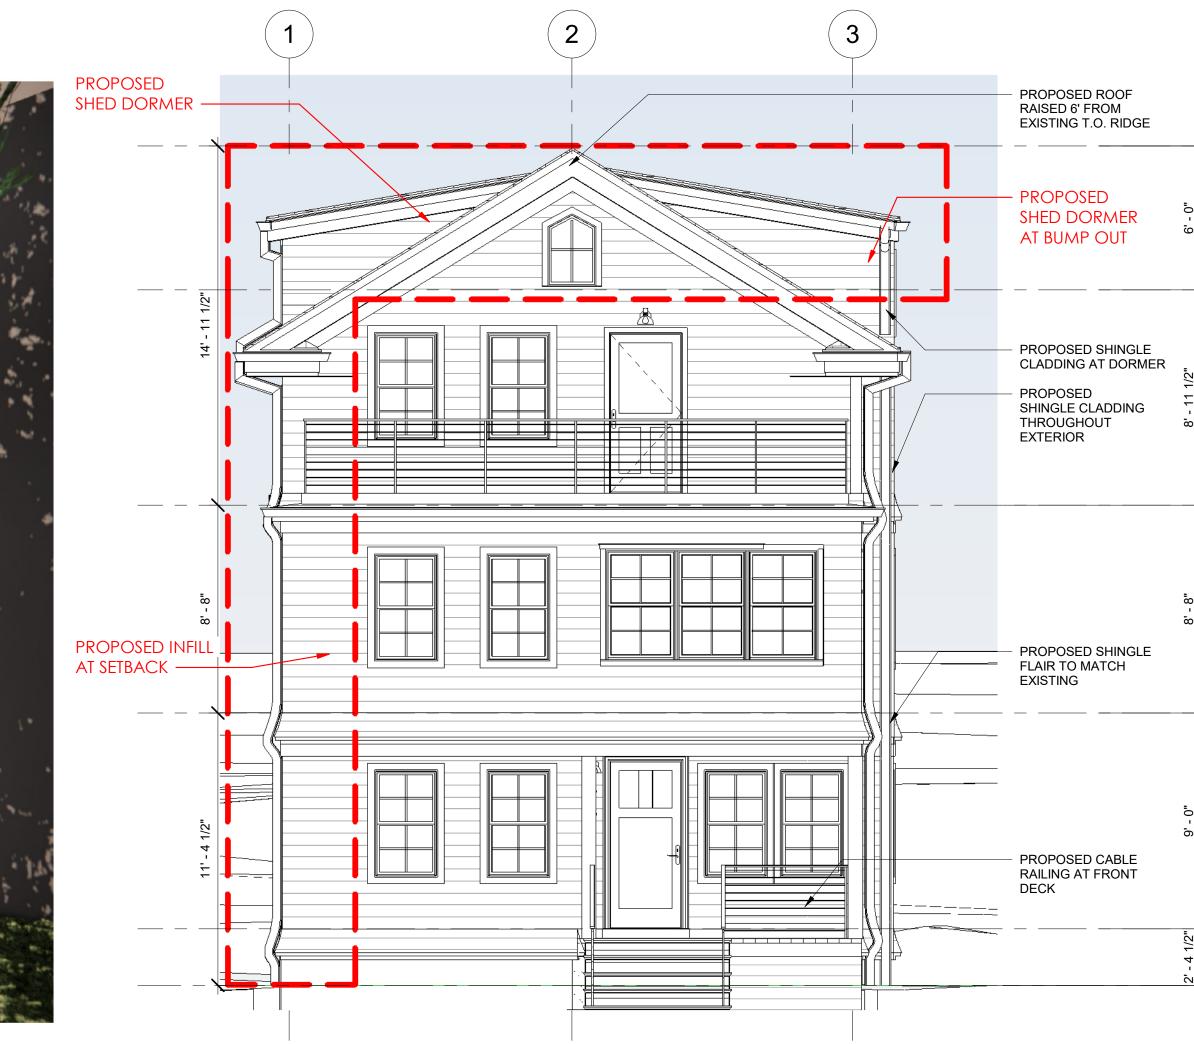
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P-104


Scale As indicated







2 BZA_PROPOSED WEST ELEVATION 1/4" = 1'-0"

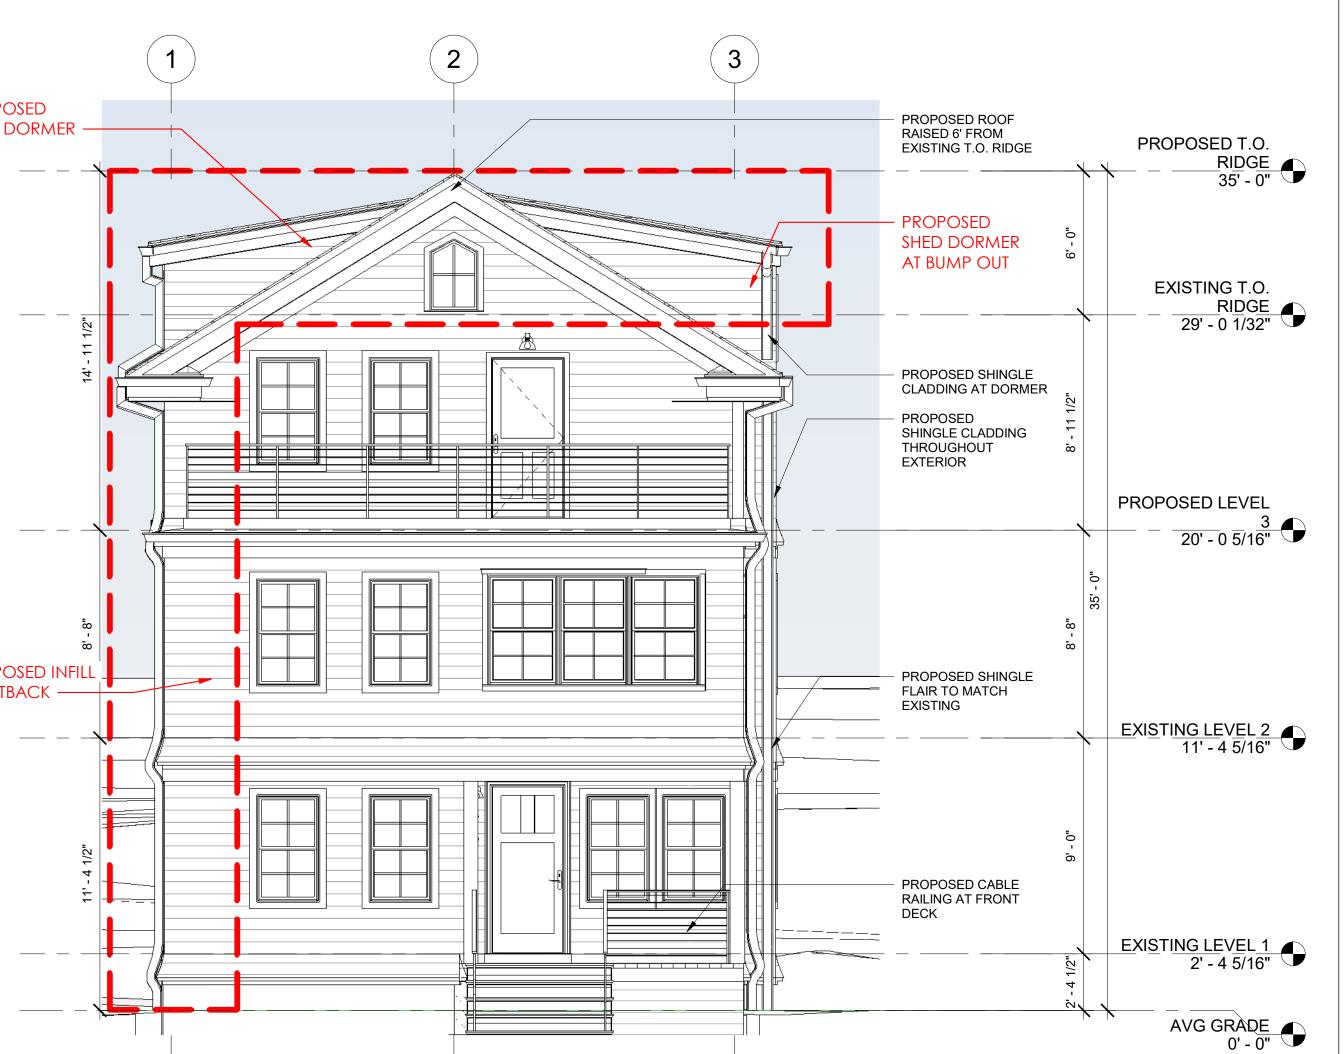



SAM KACHMAR © 2020 SAM KACHMAR ARCHITECTS (P) 978-270-8441 kachmardesign.com 357 Huron Ave. CAMBRIDGE MA, 02138

REGISTRATIONS:

STRUCTURAL ENGINEER:

TRISH NG

STEVE

02138 94-96 ALPINE ST. CAMBRIDGE, MA

BZA SUBMISSION SET Project Number Project number Date 11/13/2020 Drawn by

Author Checker Checked by P-200


1/4" = 1'-0"









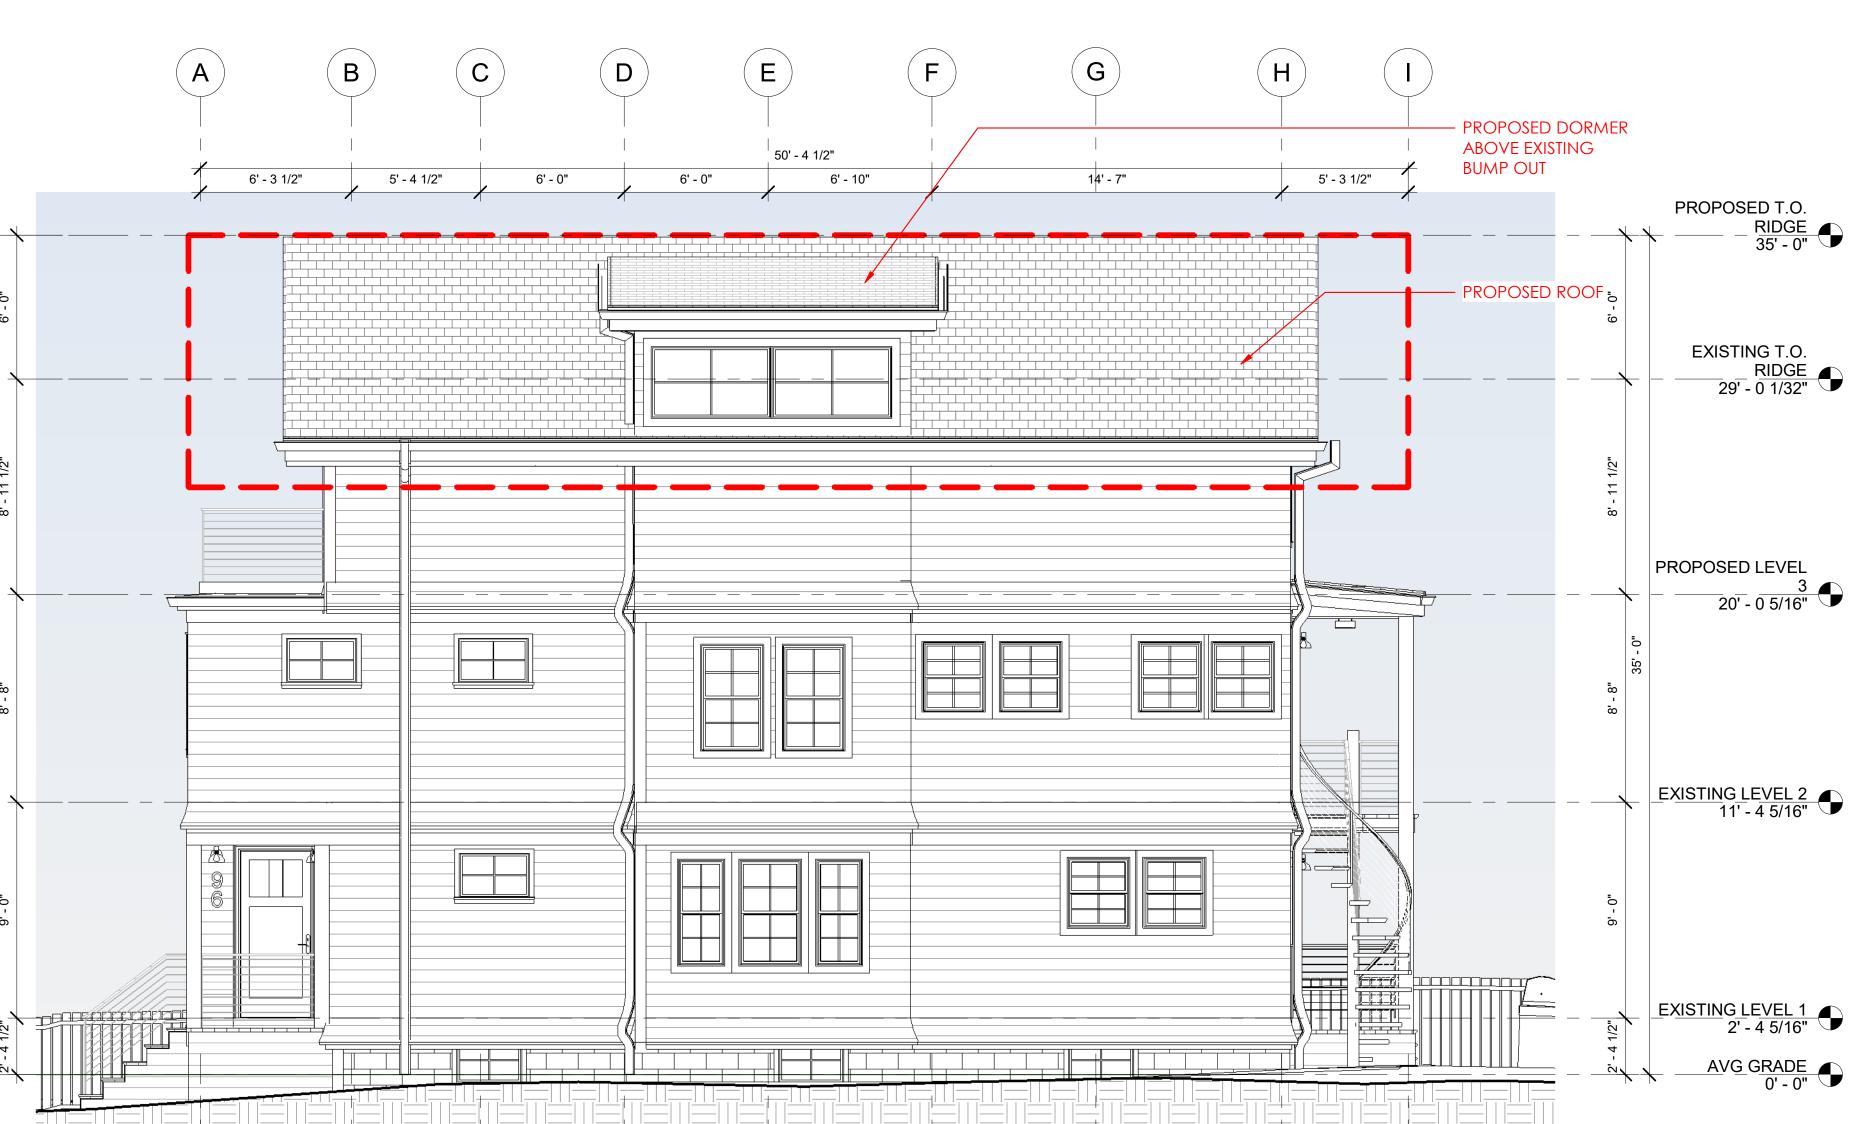

TRISH NG ∞ STEVE

NG RESIDENCE

02138


94-96 ALPINE ST. CAMBRIDGE, MA

BZA SUBMISSION SET Project Number Project number Date 11/13/2020 Drawn by Author Checker Checked by

P-201


Scale 1/4" = 1'-0"

2 BZA_PROPOSED SOUTH ELEVATION 1/4" = 1'-0"

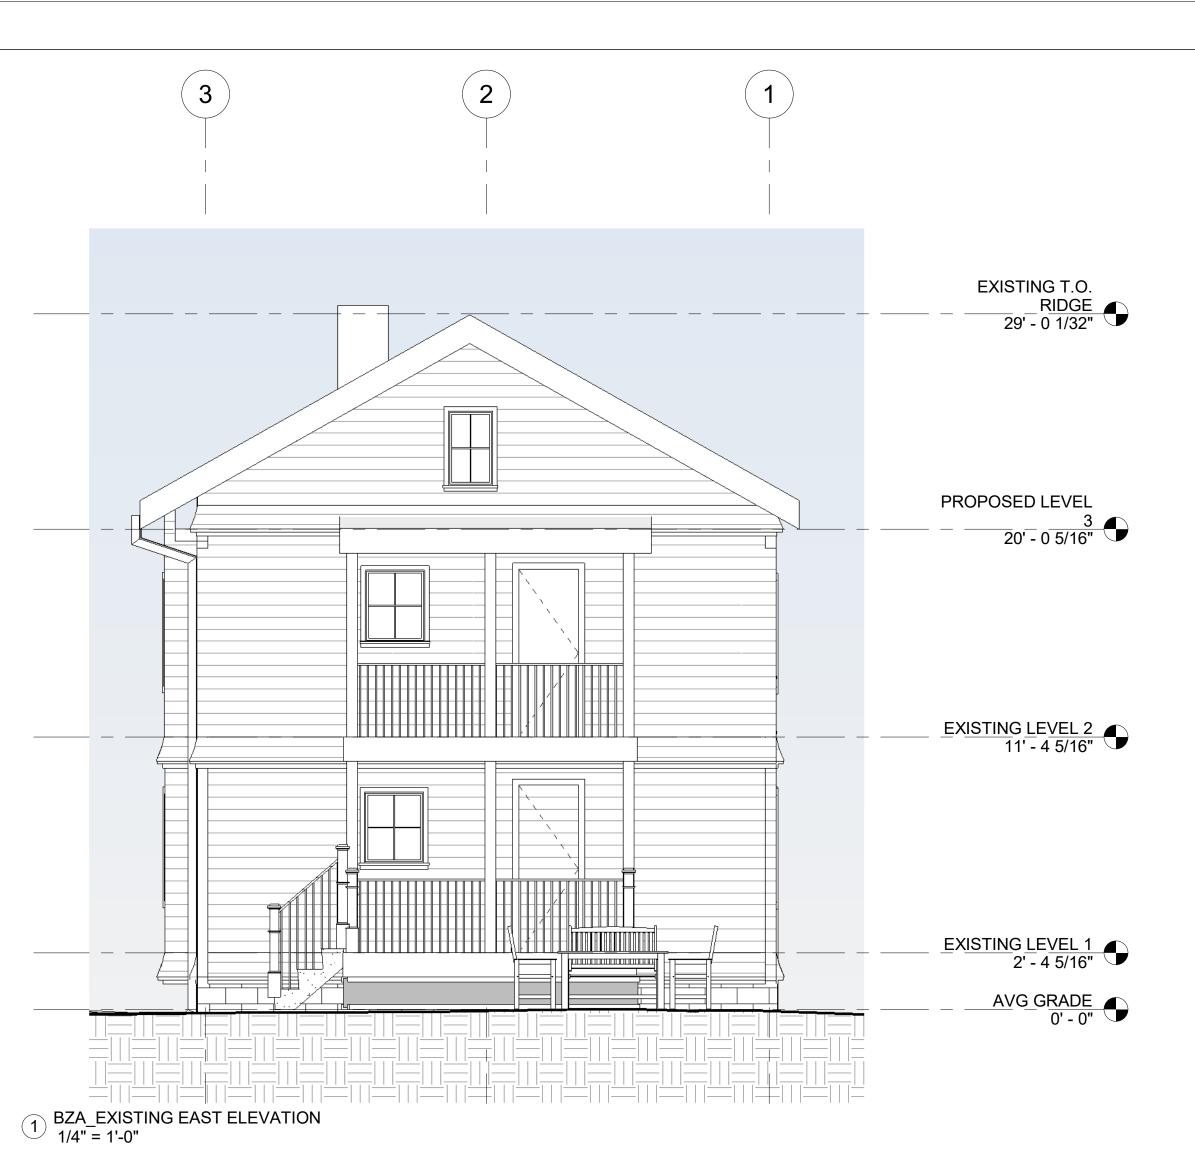





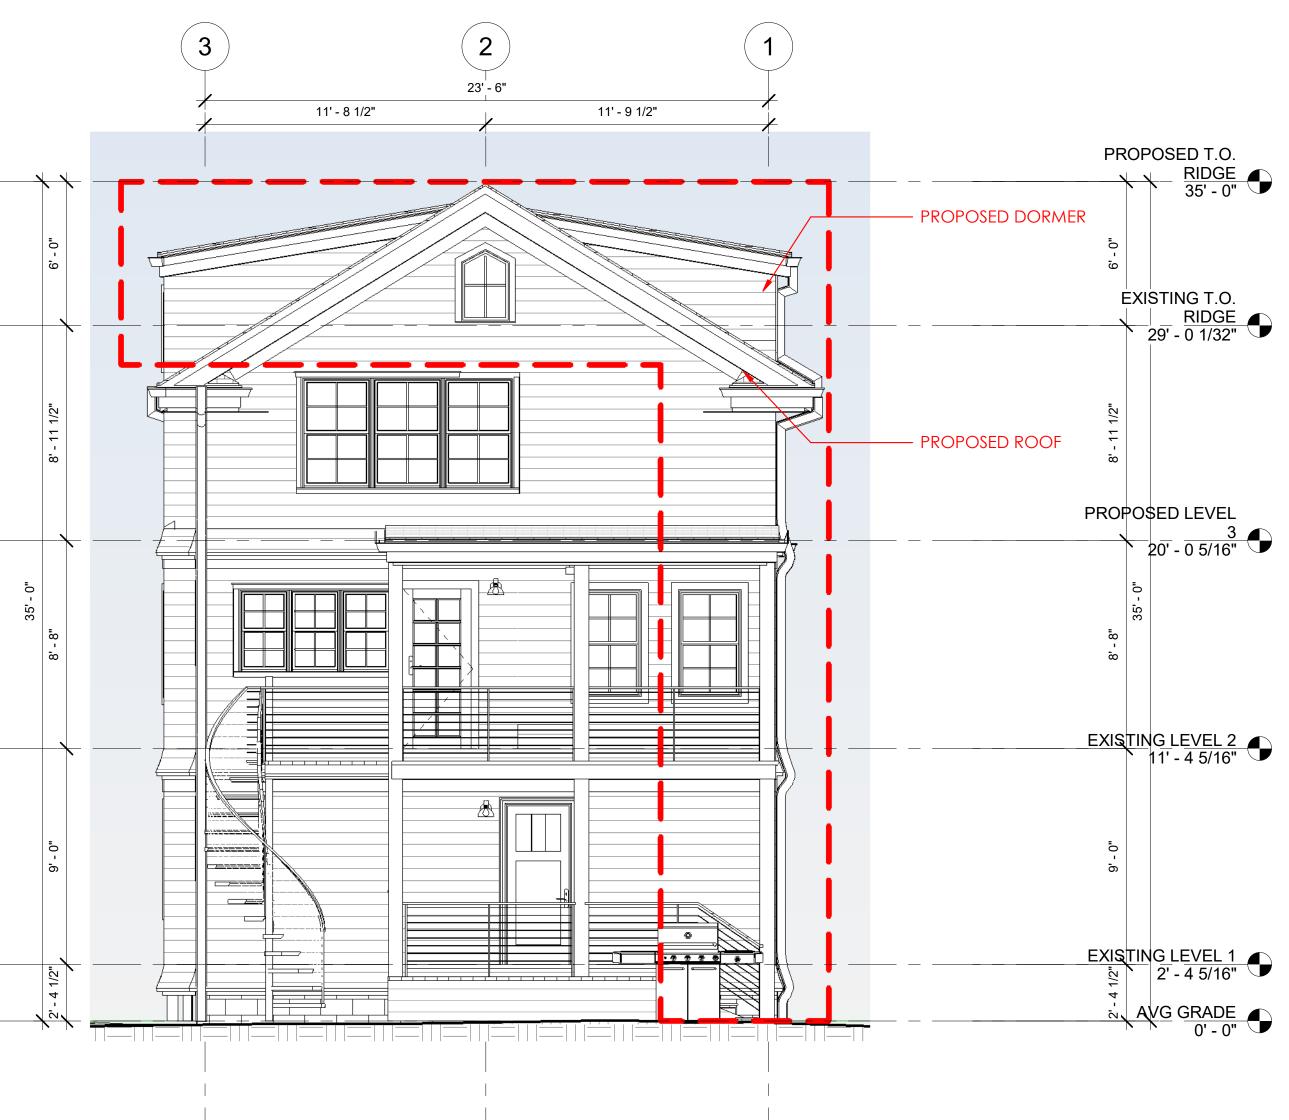

2 BZA_PROPOSED EAST ELEVATION 1/4" = 1'-0"



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STEVE


02138 94-96 ALPINE ST. CAMBRIDGE, MA

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Author Checker Checked by P-202

Scale 1/4" = 1'-0"



PROPOSED LEVEL

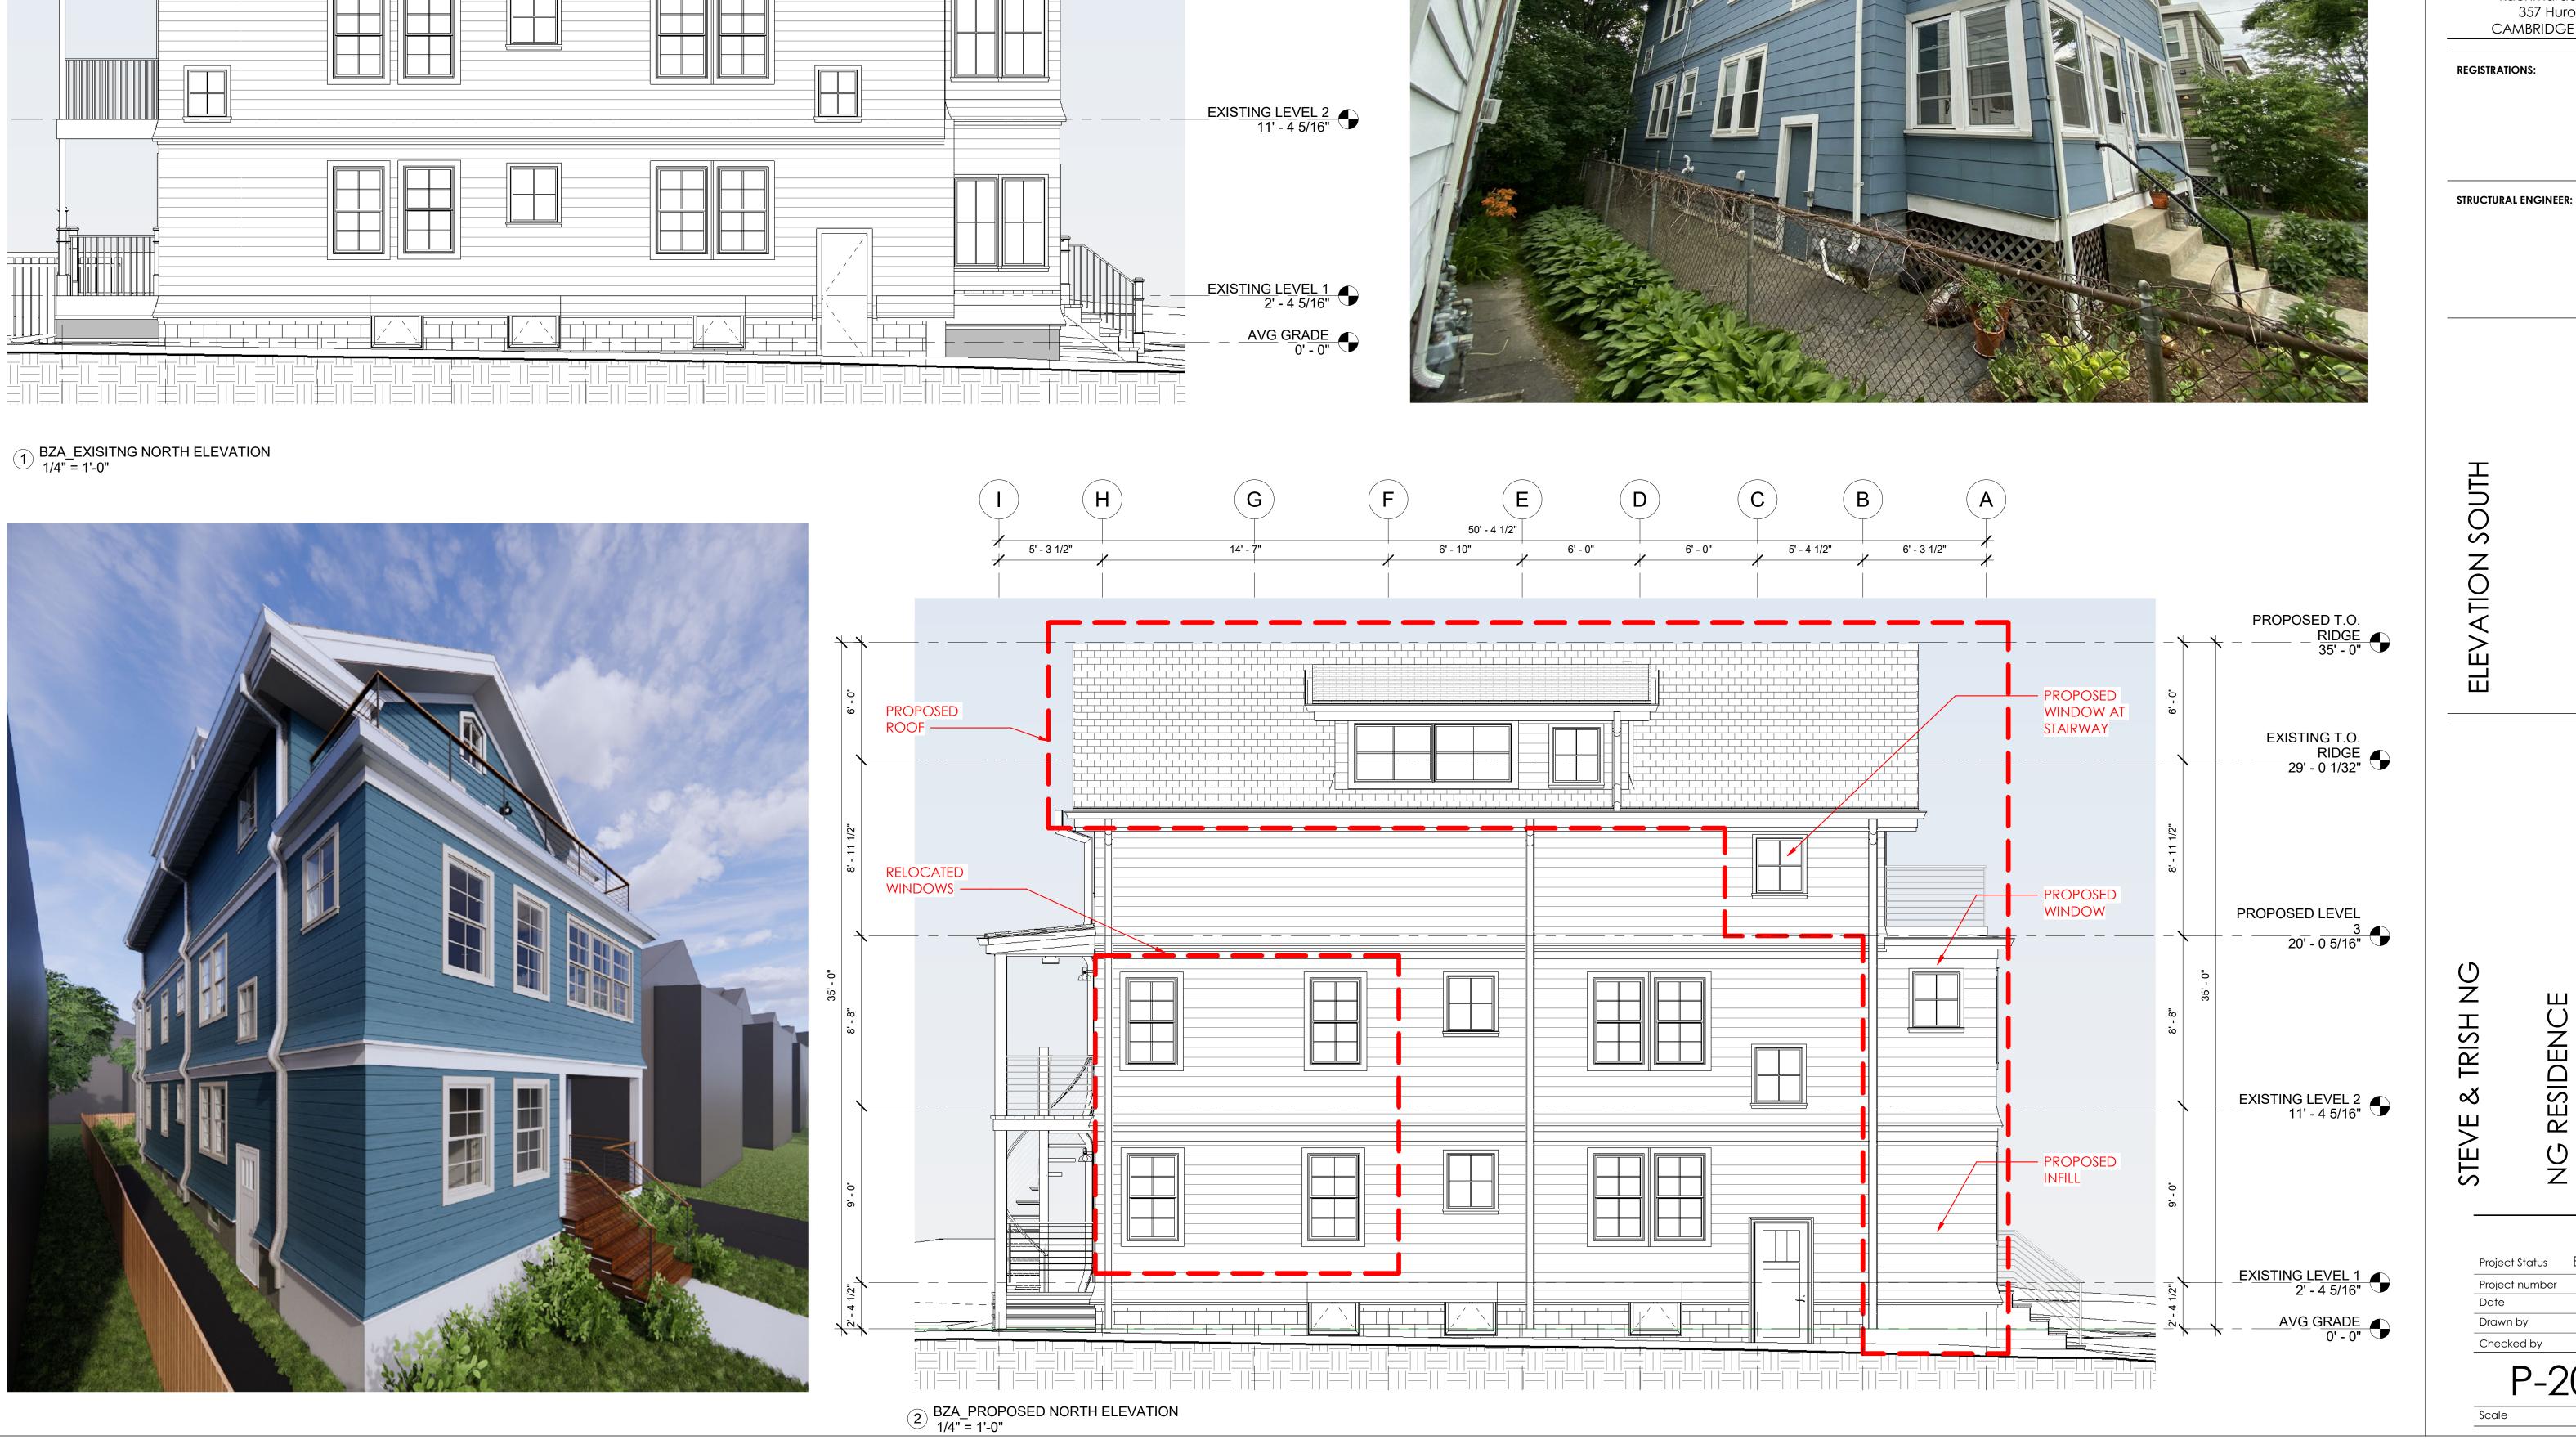20' - 0 5/16"



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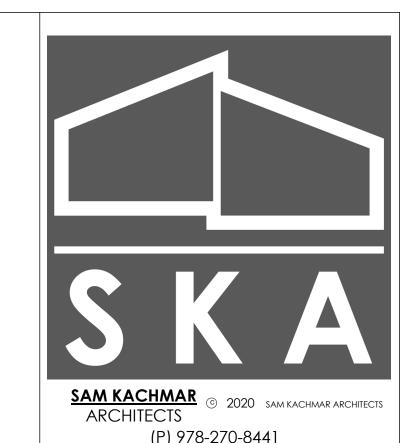
P-203 Scale 1/4" = 1'-0"

END OF PRESENTATION

94-96 ALPINE EXTERIOR VIDEO RENDER



SUPLEMENTARY SHEETS FOR REFERENCE BELOW



CAMBRIDGE MA, 02138

REGISTRATIONS:

STRUCTURAL ENGINEER:

QR CODE

DN ECIMI & HAID

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02138

Checker

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Project number Project Number

Date 11/13/2020


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P-500

Scale







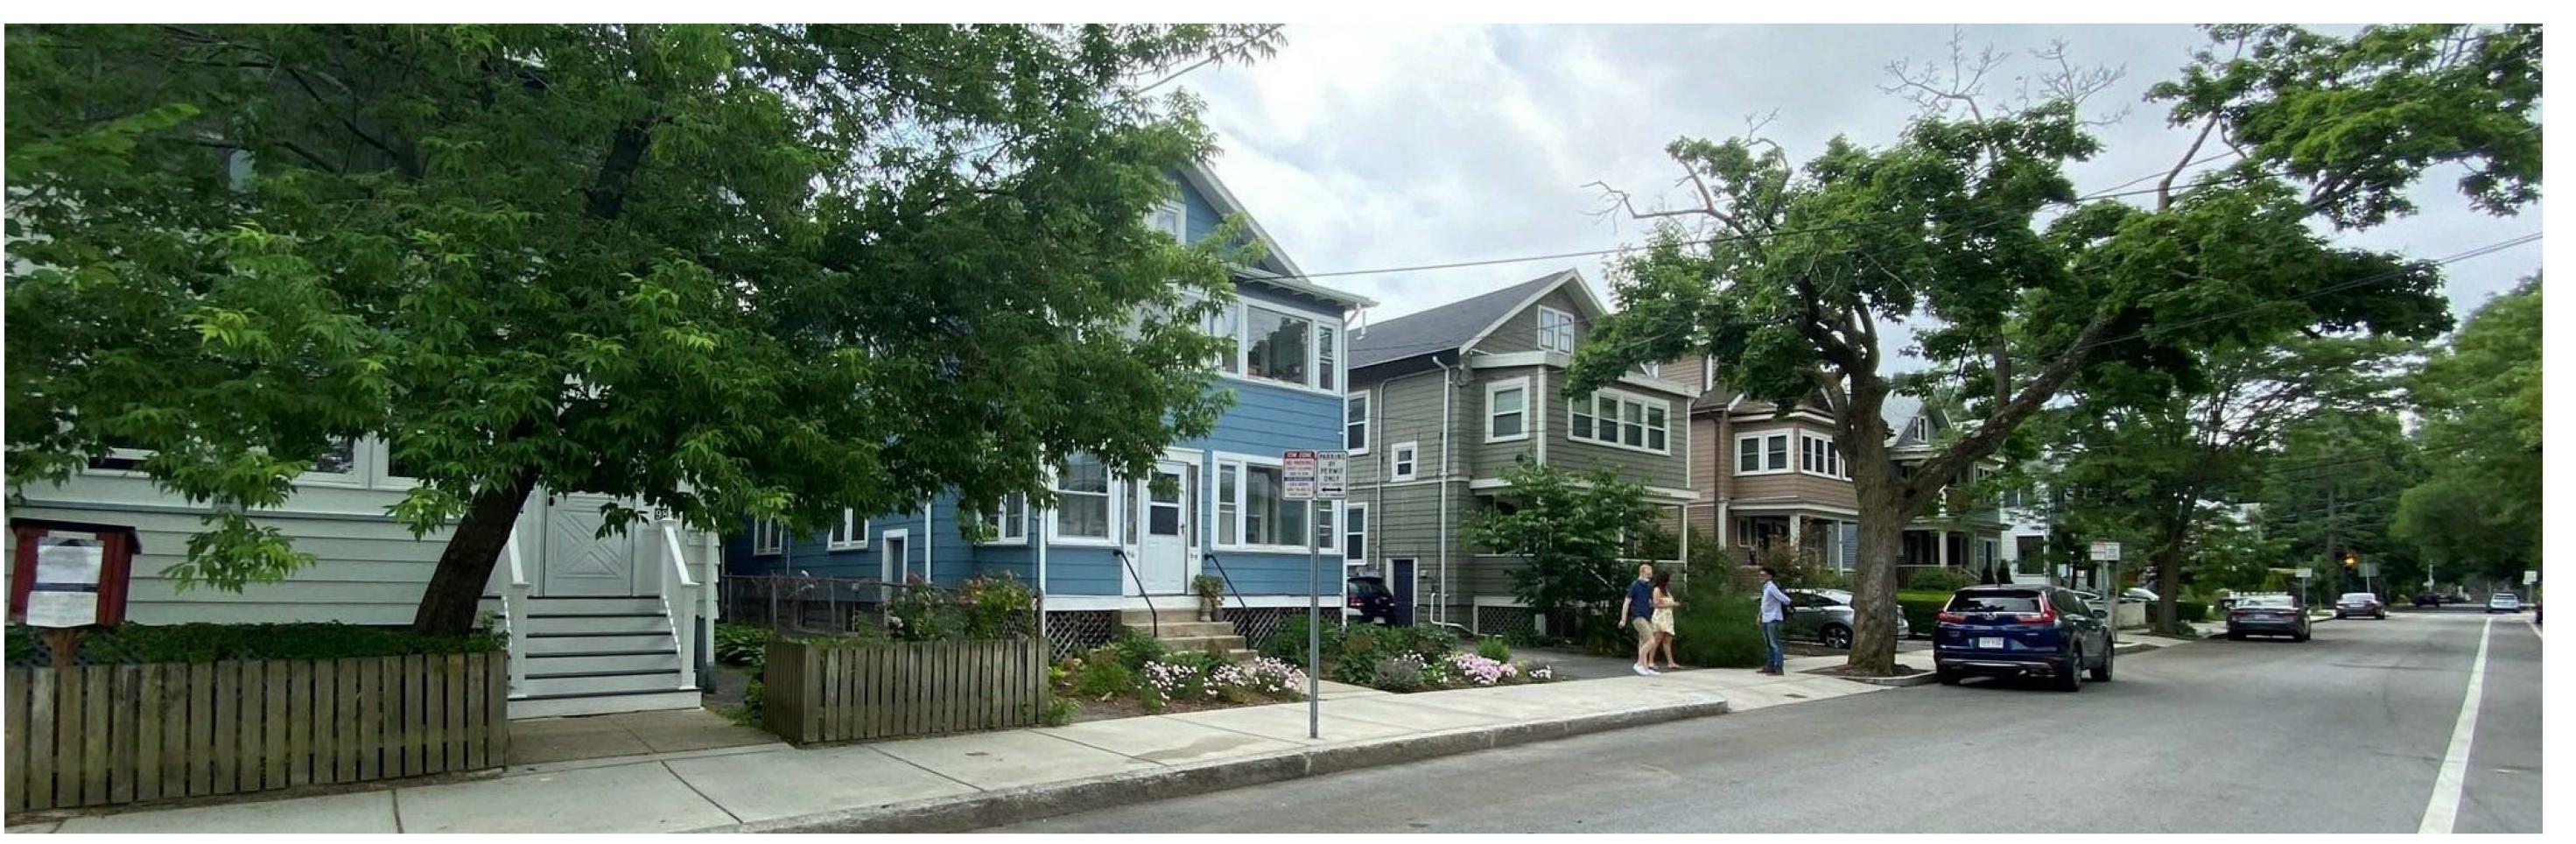

REGISTRATIONS:

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CNILCIXE

VE & TRISH NG

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Project number Project Number

Date 11/13/2020

Drawn by Author


Checked by Checker

P-501

Scal





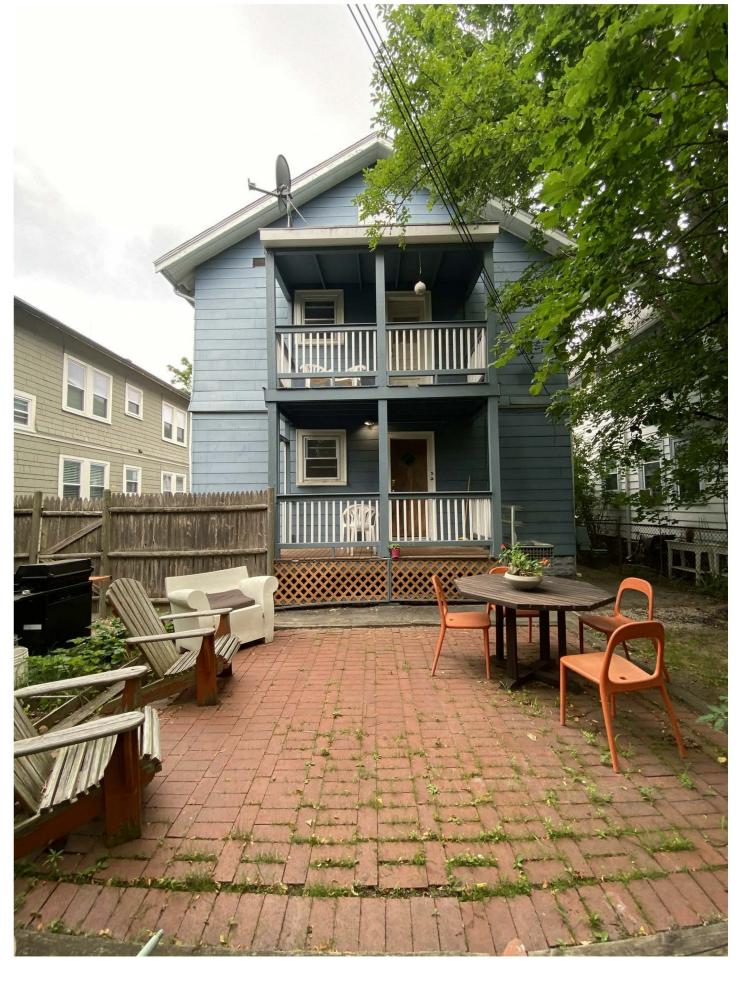





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STRUCTURAL ENGINEER:

XISTING

STEVE & TRISH NG

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Project number Project Number

94-96 ALPINE ST. CAMBRIDGE, MA 02138


Date 11/13/2020
Drawn by Author
Checked by Checker

P-502

Scal

Sc



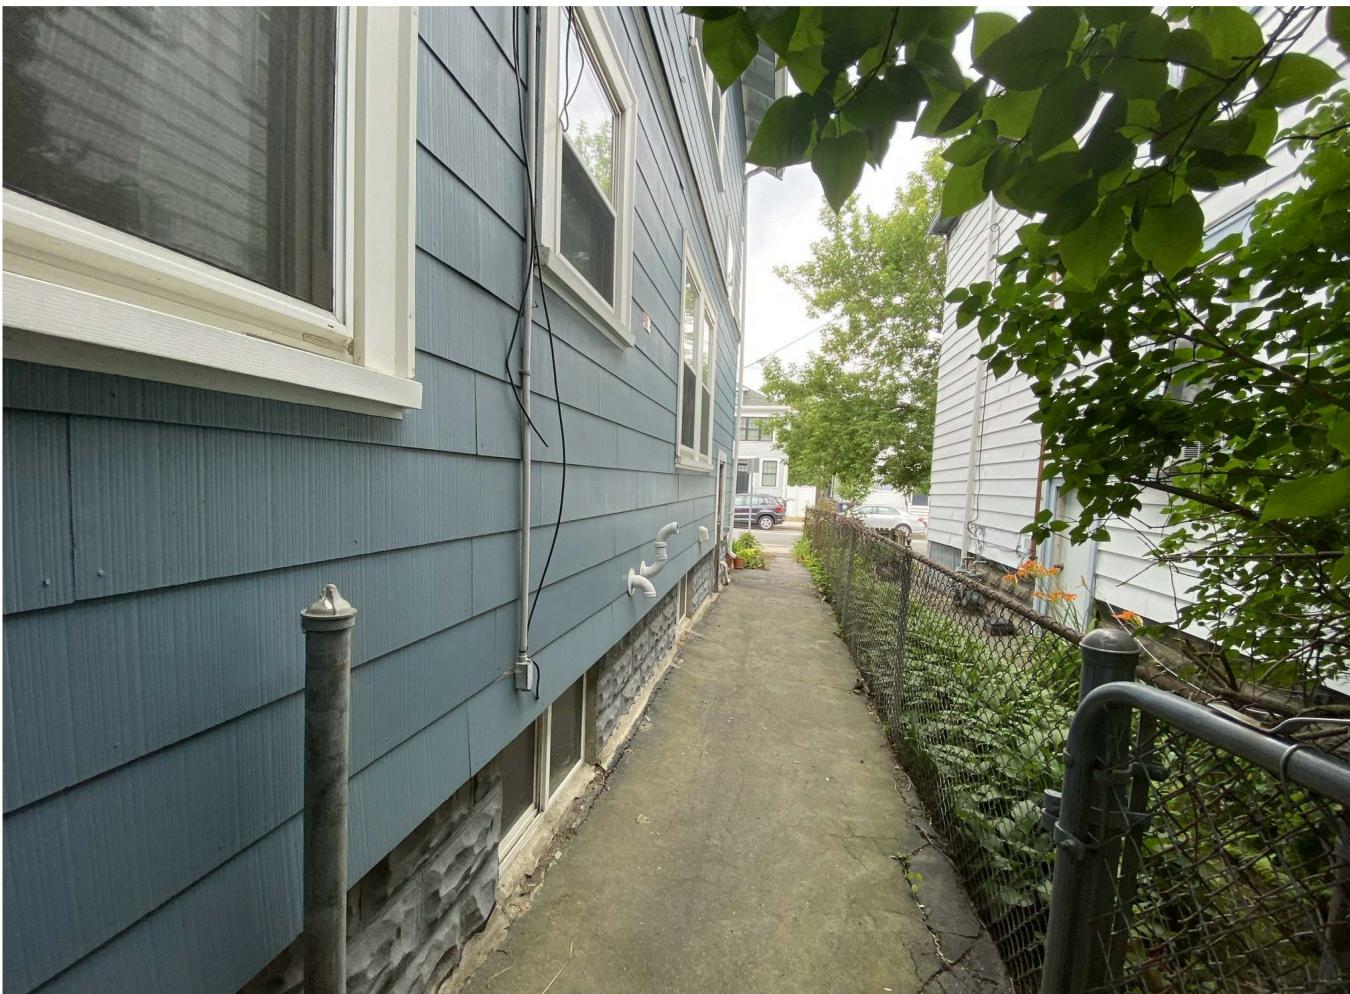





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STRUCTURAL ENGINEER:


STEVE & TRISH NG

4-96 ALPINE ST. SAMBRIDGE, MA (

Project Number Project number 11/13/2020 Drawn by Author Checker Checked by

P-503

ALPINE SIREI

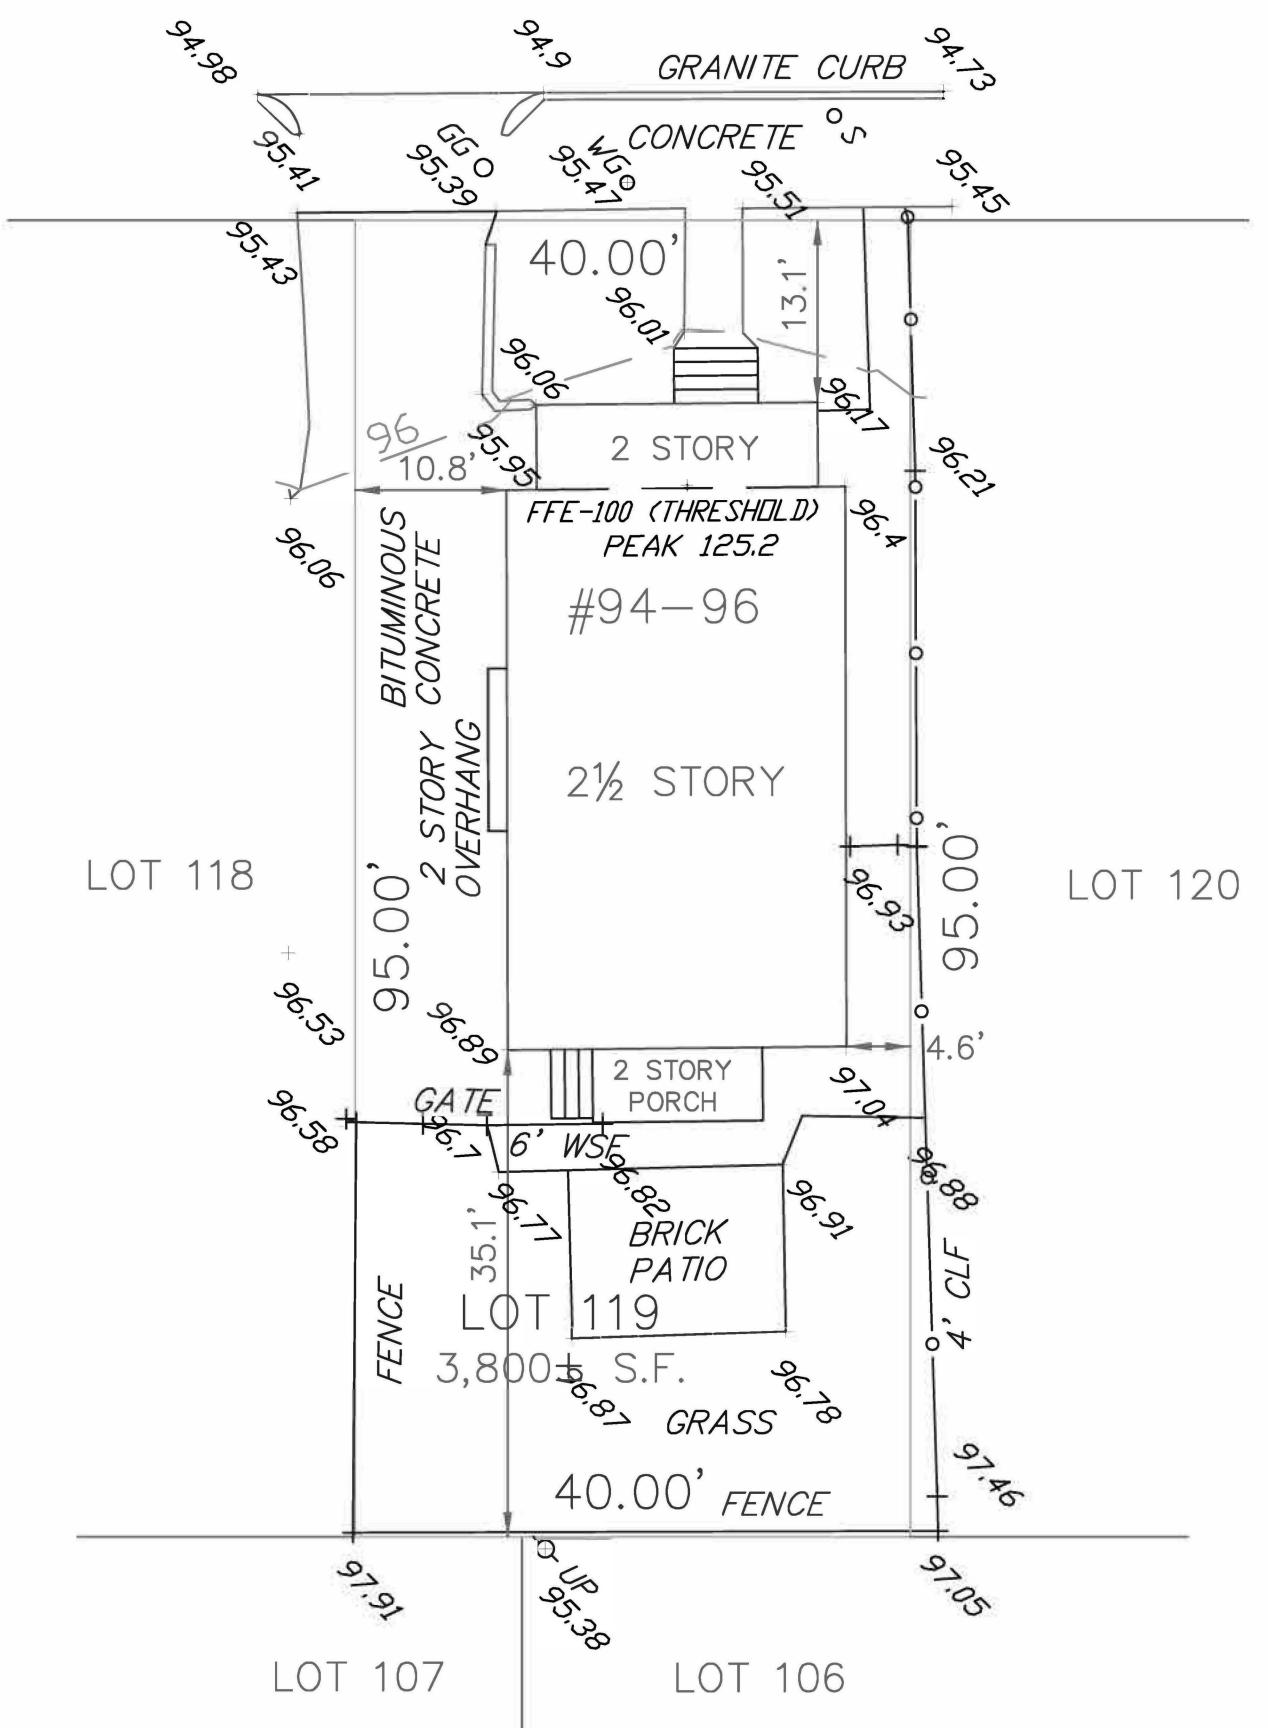

OWNER: STEVEN, PATRICIA & AUDRY NG

I HEREBY CERTIFY THAT THE BUILDING IS LOCATED AS SHOWN.

#92-94 ALPINE STREET
IN
CAMBRIDGE, MA

(MIDDLESEX COUNTY)

SCALE: 1"= 20' DATE: 7/24/2020

0 20 40 60 ft


ROBER SURVEY

1072A MASSACHUSETTS AVENUE
ARLINGTON, MA 02476
(781) 648-5533

6187PP1.DWG

CLIFFORD E. ROBER, PLS DATE
THIS PLAN MAY HAVE BEEN ALTERED IF
THE SIGNATURE IS NOT SIGNED IN BLUE.



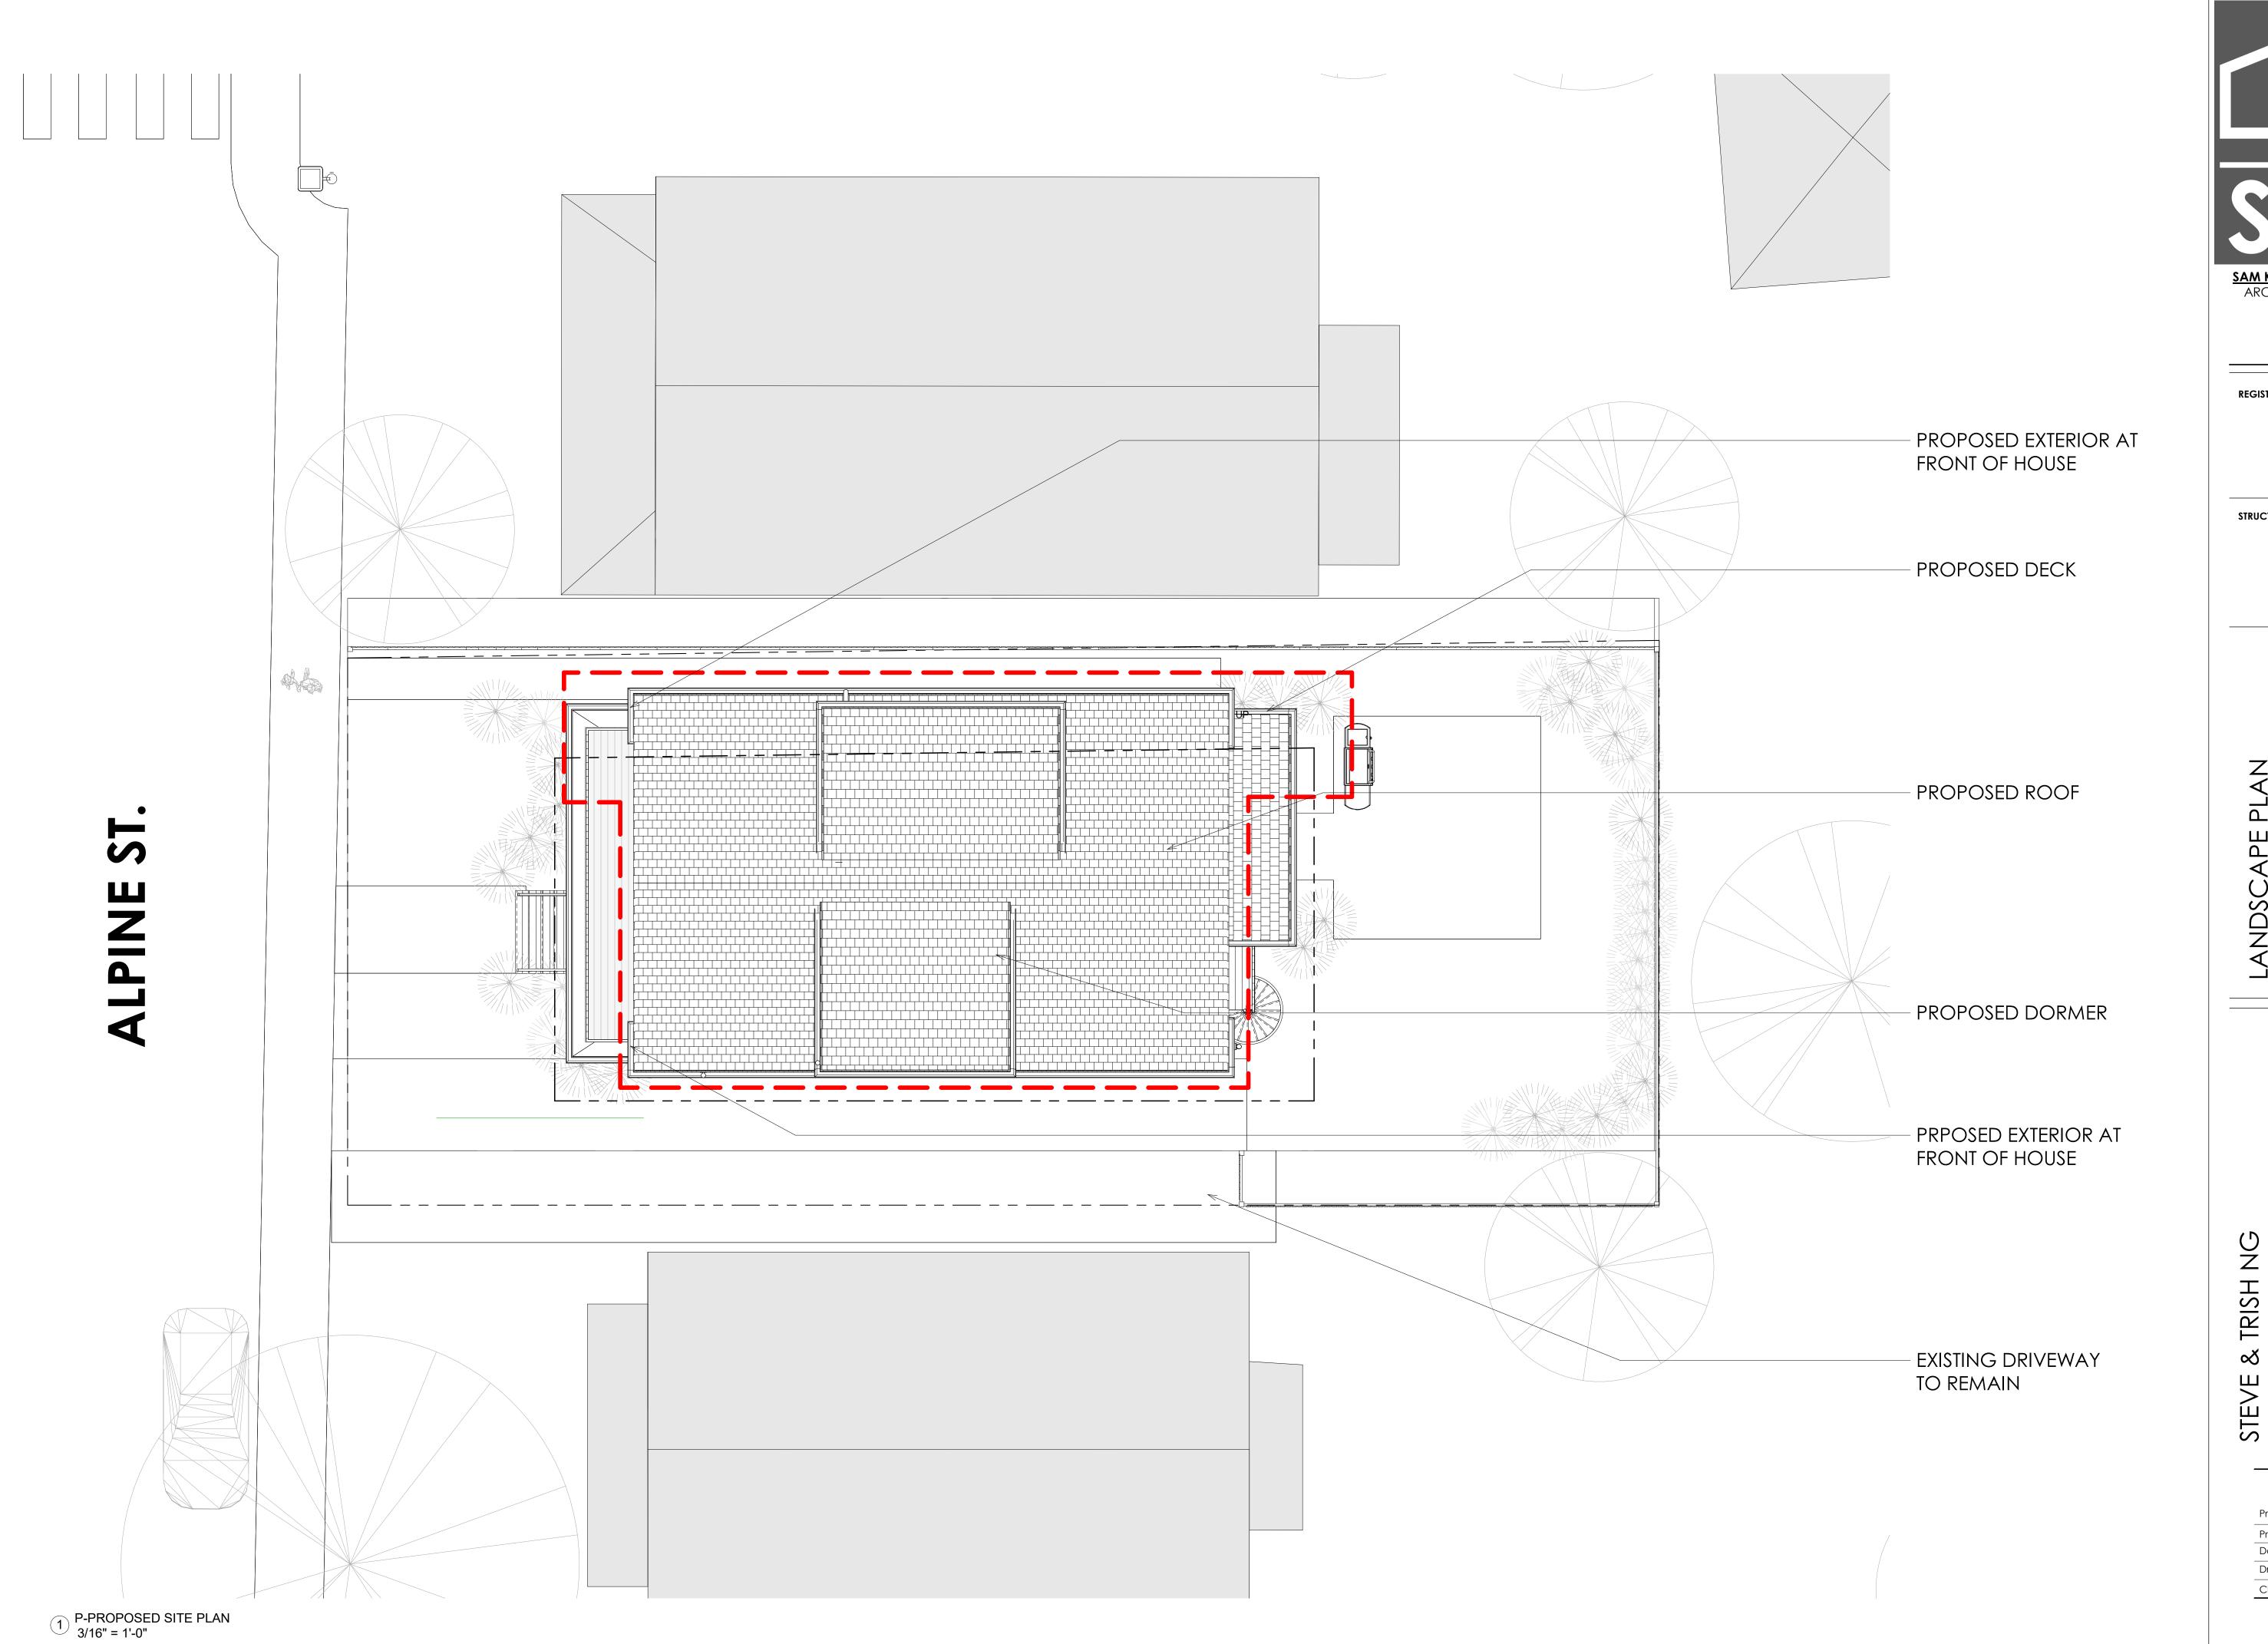



REGISTRATIONS:

STRUCTURAL ENGINEER:

94-96 ALPINE ST. CAMBRIDGE, MA 02138

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P-505

3/16" = 1'-0"





REGISTRATIONS:

STRUCTURAL ENGINEER:

TRISH NG

BZA SUBMISSION SET

02138

Project Number Project number 11/13/2020 Author Drawn by Checker Checked by

P-506

1 1/2" = 1'-0"

1 1/2" = 1'-0"