

MEETING NOTES

DATE: 1/15/20

PROJECT: Development at 57 JFK St.

Page | 1

IN ATTENDANCE: Susan Barroso, Laquita Sanders, Alex Monteiro De Pina, Jonathan Wong, Richard Lawlor, (Eversource); R. Dhanda, J. Hass, (Owner); M. Rimmel (Nauset); Muzi Zade (Zade); M. Banville, (Siegel), A. Heidebrecht, L. Deevy (PQA)

AGENDA: Electrical Service- SC Station Vault- review of revised layouts with Eversource.

Meeting at 57 JFK St., 1/15/20, to review the revised SC Station Vault layout. This meeting was a follow-up to the meeting November 26, during which Eversource rejected the design that had been developed with them for over a year. The layout presented at this latest meeting, 1/15/20, was the revised layout, which extended the SC Station into the Basement of 57 JFK. This layout is to serve 57 JFK only.

Eversource verbally approved the schematic design with the following comments:

1. The exterior roll-up door to have a minimum opening size 8'-0" wide x 8'-9" high, (because the Switchgear is installed standing upright).
2. Stairs next to the roll-up door to be removable.
3. Transformer and Switchgear could be installed with a forklift. Transformer may be able to be installed without support from steel above- Eversource to review installation with their install group and advise design team.
4. 4" curb required at doorways to contain equipment fluid.
5. Transformer and Switchgear to be on 4" high pads that extend 4" beyond the equipment. Structural column next to Switchgear to be kept clear of the pad.
6. Two means of cooling Vault reviewed- air conditioning vs. ventilation. Owner expressed preference for ventilation. Design team to look at placing vent on roof of Vault in Alley. Eversource said heating unit would still be required for winter.
7. A ground bar will run around room and over doors.

8. Vault to have two wall outlets: one NON-GFCI and one GFCI.
9. Eversource prefer no sprinklers but will allow sprinklers if required by building code. Sprinklers shall be double, interlocked, pre-action sprinkler system. Wet-pipe sprinklers and dry-action sprinklers are not allowed.
10. Eversource confirmed in email, 1/17, that 3HR rated enclosure required- no exceptions given if vault is sprinklered.
11. Eversource to forward to specs of Indoor Vaults and sizes of Switchgear and Transformers to PQA/ Zade. (*received 1/16*).

Eversource asked if the Owner had considered powering the Eliot St building from a combined Vault in 57 JFK:

12. Various ways of doing a combined vault were discussed. It was concluded that the best way would be two separate transformers and one combined 5-bay Switchgear. (The alternative approach- one combined transformer- would require two step-down transformers, which is more costly and space consuming).
13. The design team will work up a layout of a two-building Vault for Owner review. (*forwarded to Owner and Nauset 1/17 with additional drawings and comments sent to Nauset 1/20 for order of magnitude cost increase estimate*).
14. PQA to inform Eversource which way we are moving forward once decision made on substation design.
15. Design team to wrap-up Phase 2 Re-Permit drawings once decision made on substation design. CD drawings of Vault to be developed after that.

cc. Team



10 KEARNEY ROAD, SUITE 307, NEEDHAM, MA 02494
TEL: 781.453.2220. FAX: 781.453.2250. WEB: WWW.NAUSET.COM

Nauset Construction Corp.

Construction Management Plan – 57 JFK Eversource Transformer Vault Phase

February 25, 2020

Reference enclosed Site Logistics Plan dated 2/25/20.

To serve the proposed three-story addition at 57 JFK (permit application #67164), Eversource is requiring the installation of an underground electric vault to house a new transformer. Due to site constraints, Nauset has applied for a separate building permit to construct the new vault prior to the start of the 57 JFK building renovation/addition. An early completion of the underground vault will provide required access and egress to patrons during the construction of the 57 JFK addition.

Upon issuance of the building permit, Nauset will mobilize the site and install chain link fencing at the alley between 57 JFK and 96 Winthrop Street to permit pedestrian egress from the 57 JFK building onto Winthrop Street. The fencing will be installed to maintain a 4'0" path of egress for use of patrons in the event of an emergency. The balance of the alley will be utilized for construction lay down of materials, tools and "light" equipment.

The alley located between 16-18 Eliot and the Harvard Square Parking Garage (20 Eliot Street) will be Nauset's primary location to stage "heavy" equipment for the excavation, underpinning operation and concrete formwork required to construct the underground vault. A temporary gate will be installed roughly 15' from the alley entrance (off Eliot Street). Construction vehicles will be directed to access and egress from Eliot Street. A separate 6' temporary fence will be installed separating the existing retaining wall from the "work zone". Temporary toilets will be located within the work zone. Due to the anticipated amount of materials and equipment that will be required within the work zone, pedestrian and vehicle access will not be permitted within the work zone during this phase of work.

Throughout this phase of work, Nauset does not anticipate impacting (renting) the public streets or sidewalks along JFK, Winthrop or Eliot Street. Sidewalks will remain open to pedestrians. Police details will be engaged, as necessary, to assist with traffic flow during periods of heavy/active work.

The construction of the Eversource Vault is anticipated to commence on or about mid-April and anticipated to be complete by mid-June.


Emergency Contacts/Phone Numbers:

Bob Calvano, Superintendent	617.459.9795
Scott Southwick, General Superintendent	339.237.8775
Mike Rimmel, Sr. Project Manager	781.707.8285
Rob Johnstone, Project Executive	339.225.8507
Nauset Construction – Main Office	781.453.2220



Transformer Vault
Installation Phase

2.25.20

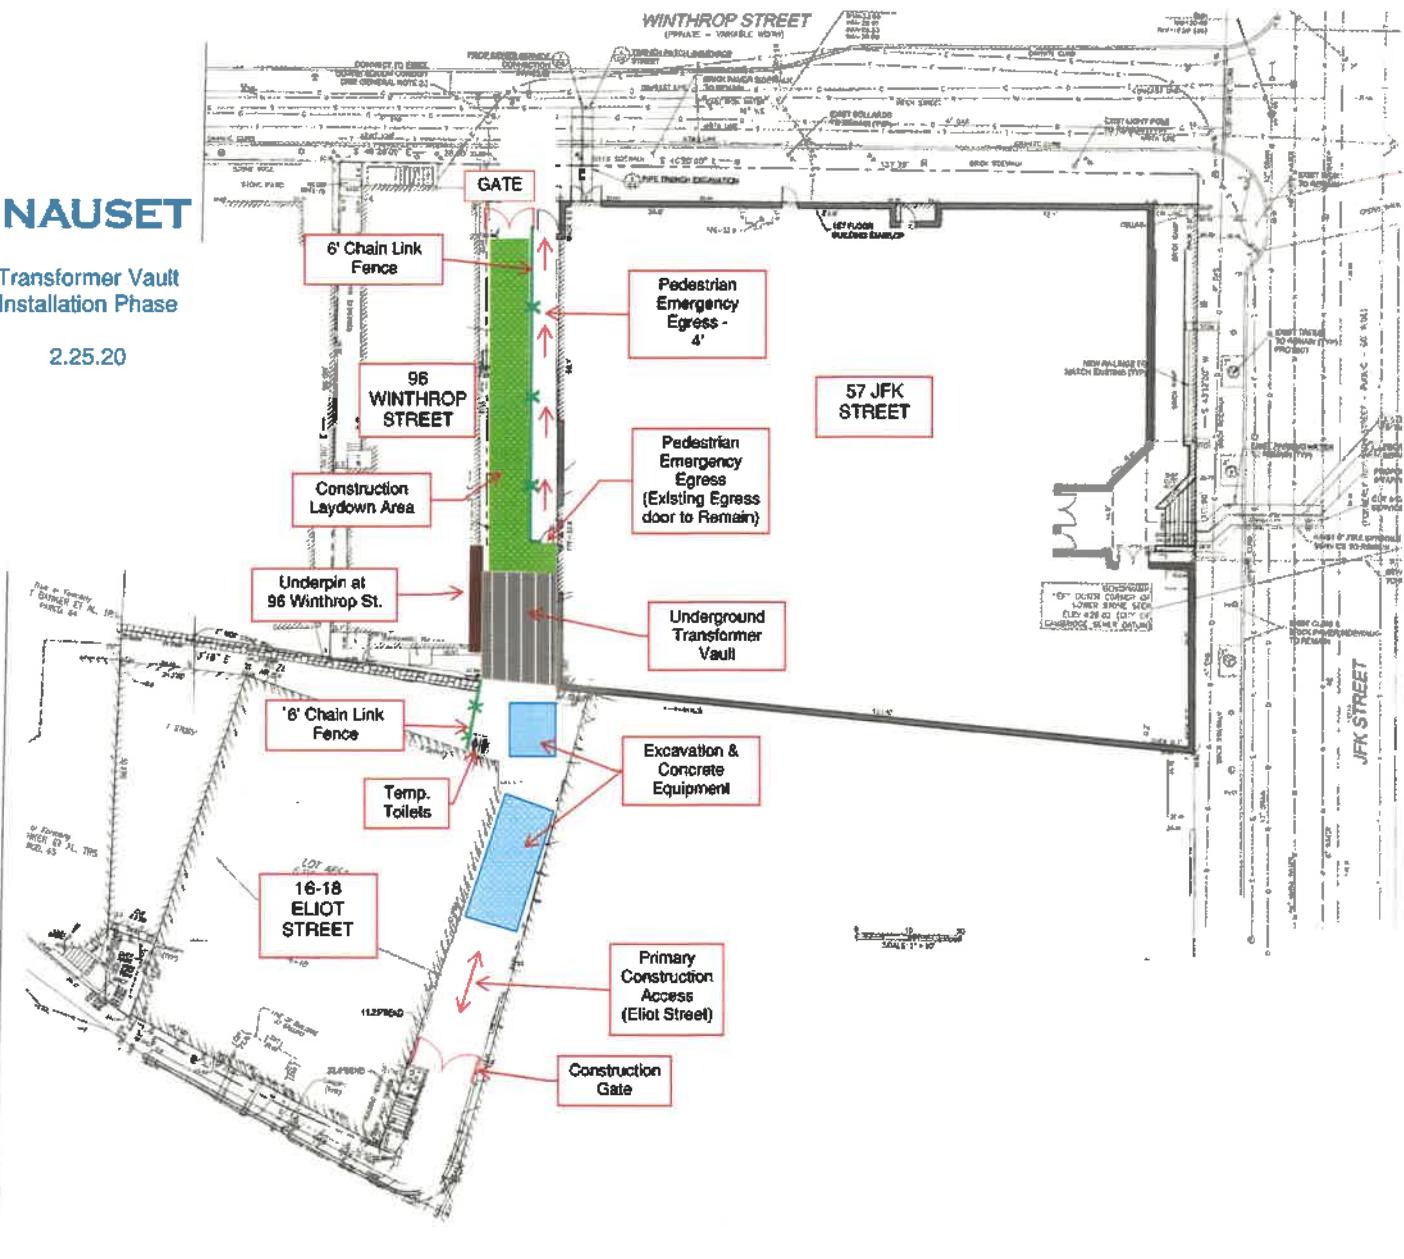


NAUSET CONSTRUCTION CORP.

57 JFK - TRANSFORMER VAULT Cambridge, MA

February 24, 2020

ID	Task Name	Duration	Start	Finish	Predecessors	Qtr 1, 2020	Qtr 2, 2020	Qtr 3, 2020	Jul	Aug	Sep	Oct
			Jan	Feb	Mar	Apr	May	Jun	Jul	Aug	Sep	Oct
1	Transformer Vault	102 days	Mon 2/24/20	Tue 7/14/20								
2	Permitting	21 days	Mon 2/24/20	Mon 3/23/20								
3	Permit Submission	1 day	Mon 2/24/20	Mon 2/24/20								
4	Permit Review	20 days	Tue 2/25/20	Mon 3/23/20	3							
5	Issuance of Bldg. Permit	0 days	Man 3/23/20	Mon 3/23/20	4							
6	Procure Trades	10 days	Tue 3/24/20	Mon 4/6/20								
7	Procure Trades	10 days	Tue 3/24/20	Mon 4/6/20	5							
8	Elec. Vault Construction	71 days	Tue 4/7/20	Tue 7/14/20								
9	Mobilize Site	2 days	Tue 4/7/20	Wed 4/8/20	7							
10	Site Fencing/Safety	2 days	Tue 4/7/20	Wed 4/8/20	9SS							
11	Demo Stair & Gas Meter Shed	5 days	Thu 4/9/20	Wed 4/15/20	9,10							
12	Cut Pad 5'	3 days	Thu 4/16/20	Mon 4/20/20	11							
13	Underpin	20 days	Tue 4/21/20	Mon 5/18/20	12							
14	Excavate Footings	2 days	Tue 5/19/20	Wed 5/20/20	13							
15	Compact Fill	2 days	Thu 5/21/20	Fri 5/22/20	14							
16	FRP Footings	4 days	Mon 5/25/20	Thu 5/28/20	15							
17	FRP Conc. Walls	10 days	Fri 5/29/20	Thu 6/11/20	16							
18	FRP Conc. Slab	5 days	Fri 6/12/20	Thu 6/18/20	17							
19	Back Fill / Grade	3 days	Fri 6/19/20	Tue 6/23/20	18							
20	Vault Complete	0 days	Tue 6/23/20	Tue 6/23/20	19							
21	Cut Wall	3 days	Wed 6/24/20	Fri 6/26/20	20							
22	Structural Steel	5 days	Mon 6/29/20	Fri 7/3/20	21							
23	Vault Walls	5 days	Mon 7/6/20	Fri 7/10/20	22							
24	Install Doors & Hdwe	2 days	Mon 7/13/20	Tue 7/14/20	23							

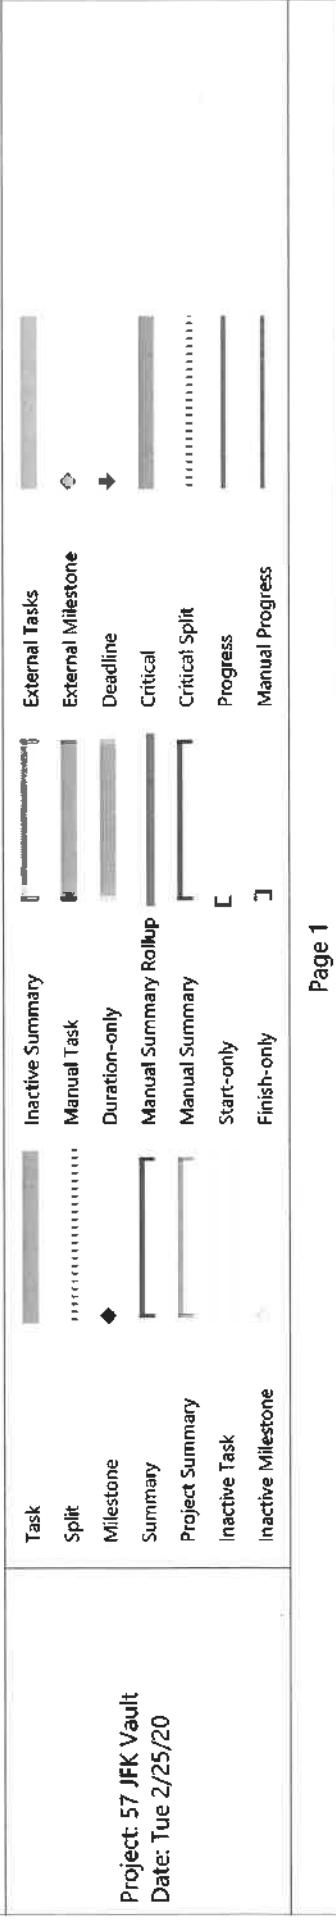

Project: 57 JFK Vault
Date: Tue 2/25/20

Milestone Summary
Inactive Task
Inactive Milestone

Inactive Milestone

Project Summary

Inactive Task

Inactive Milestone

Manual Task

Manual Progress

Manual Progress

Inactive Summary

Critical Progress

Critical Progress

External Tasks

Deadline

Deadline

Manual Summary

Critical

Critical

Start-only

Progress

Progress

Finish-only

Manual

Manual

PETER QUINN ARCHITECTS LLC
259 ELM STREET, SUITE 301
SOMERVILLE, MA 02144
PH 617-354-3989 FAX 617-868-0280

SEAL

CONSULTANT

PROJECT
ADDITION TO
57 JFK ST

57 JFK STREET
CAMBRIDGE, MA

PREPARED FOR

CRIMSON GALERIA, LP

166 BEACON ST
BROOKLINE, MA 02446

DRAWING TITLE










ZONING
COMPLIANCE
INCORPORATING
PHASE 1 AND 2

SCALE AS NOTED

REVISION / ISSUE	DATE
PHASE 2 RE-PERMIT	12 FEB 2020
PHASE 2 CD SET	27 JUL 2018
PHASE 2 PERMIT	21 DEC 2017
REV PARTIAL PERMIT	8 DEC 2017
PARTIAL PERMIT	8 SEPT 2016
PRICING SET	23 FEB 2016
DRAWN BY	REVIEWED BY
MY/KVS	PQ

SHEET

Z1.1

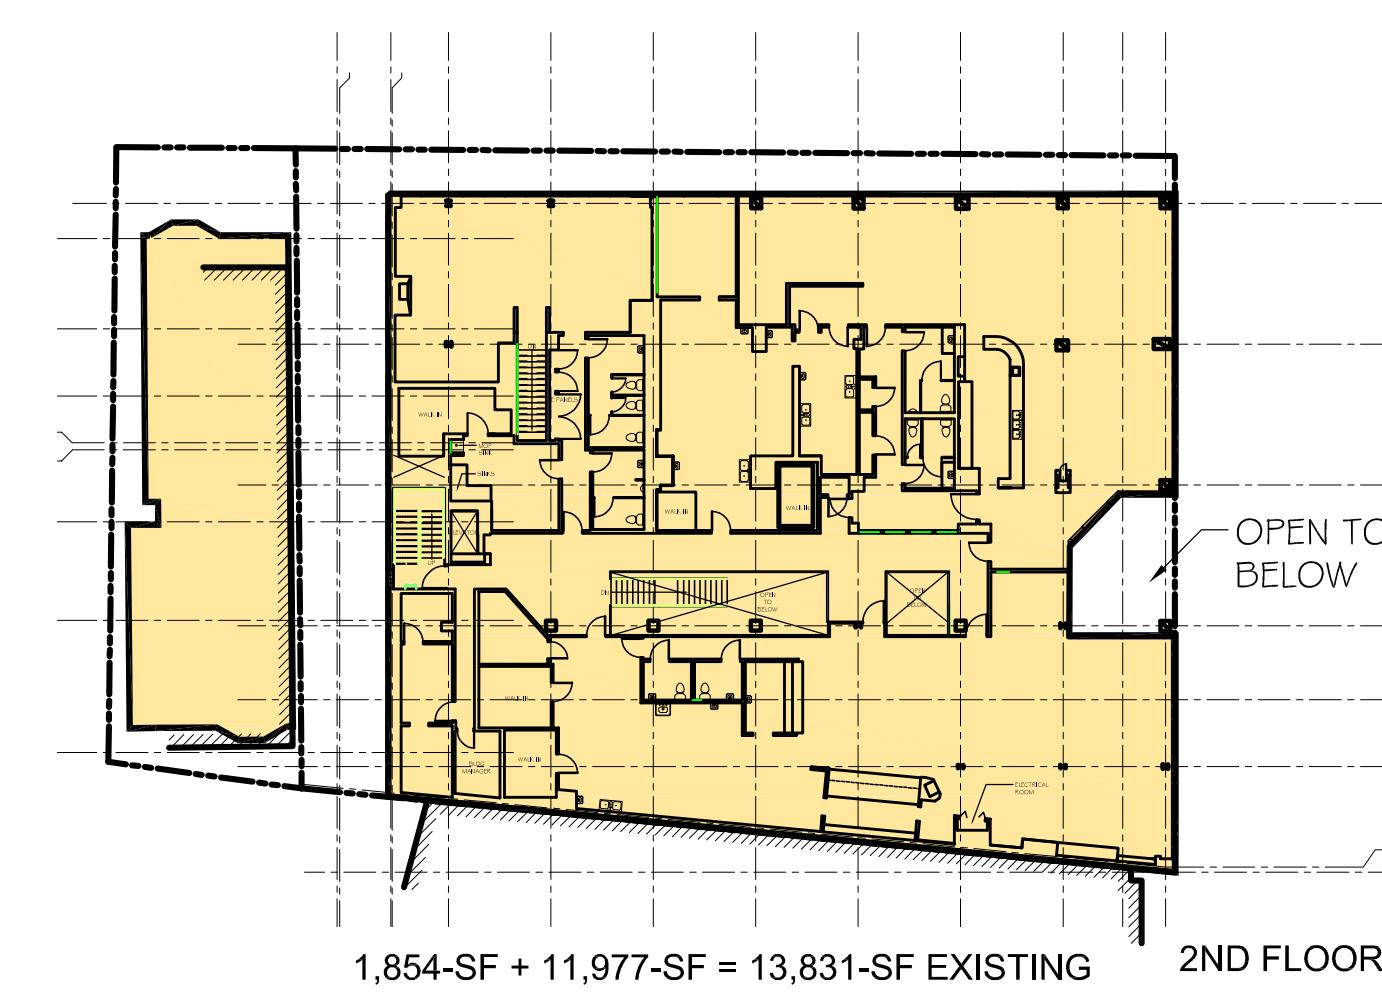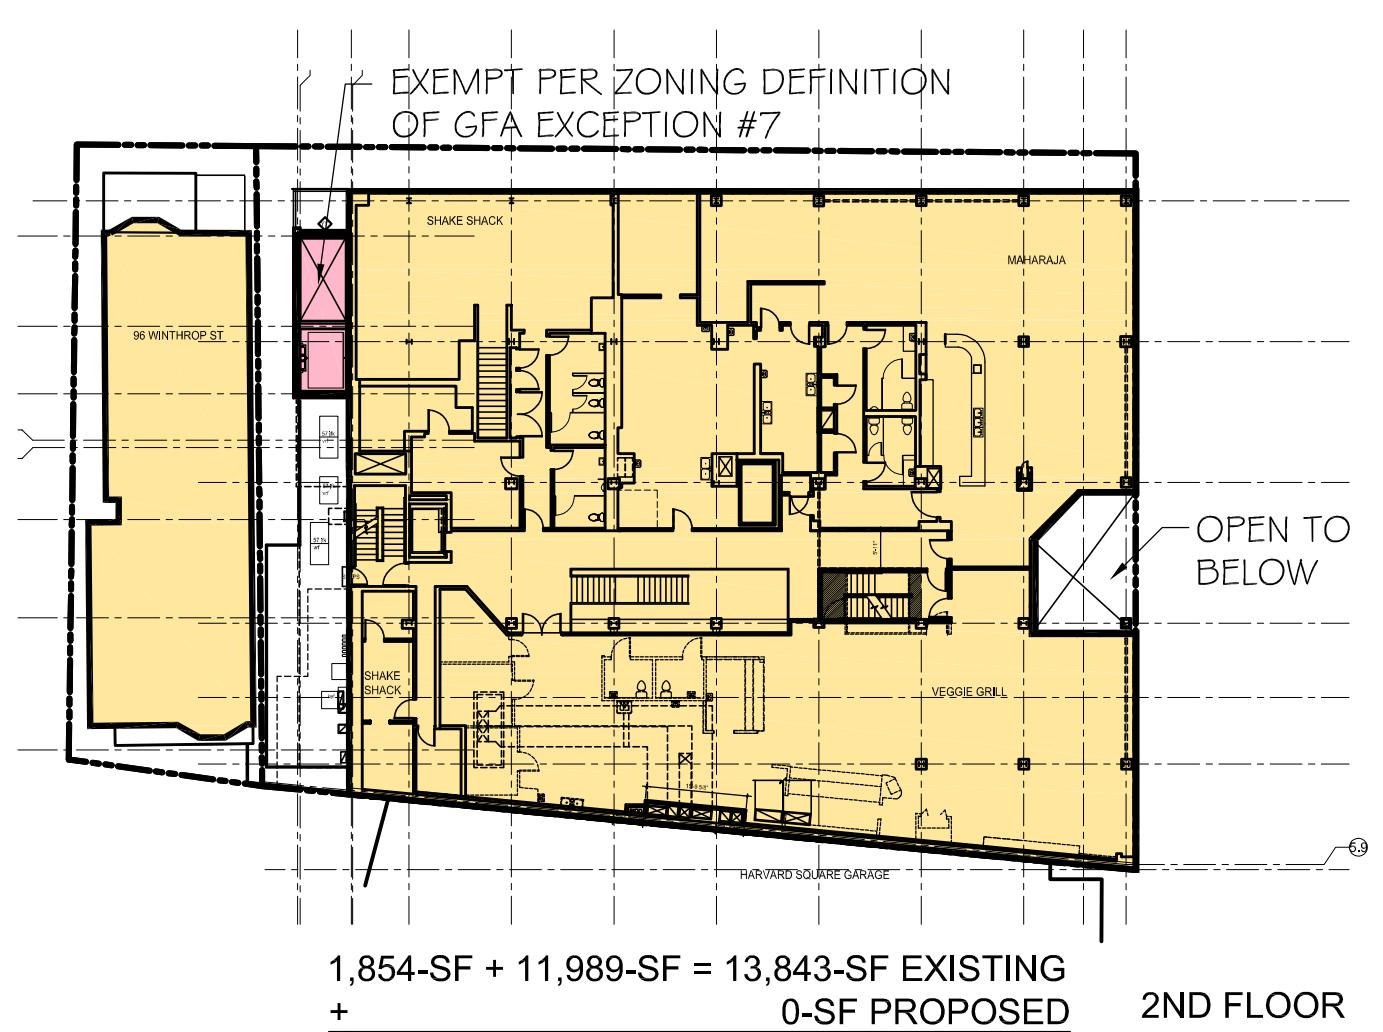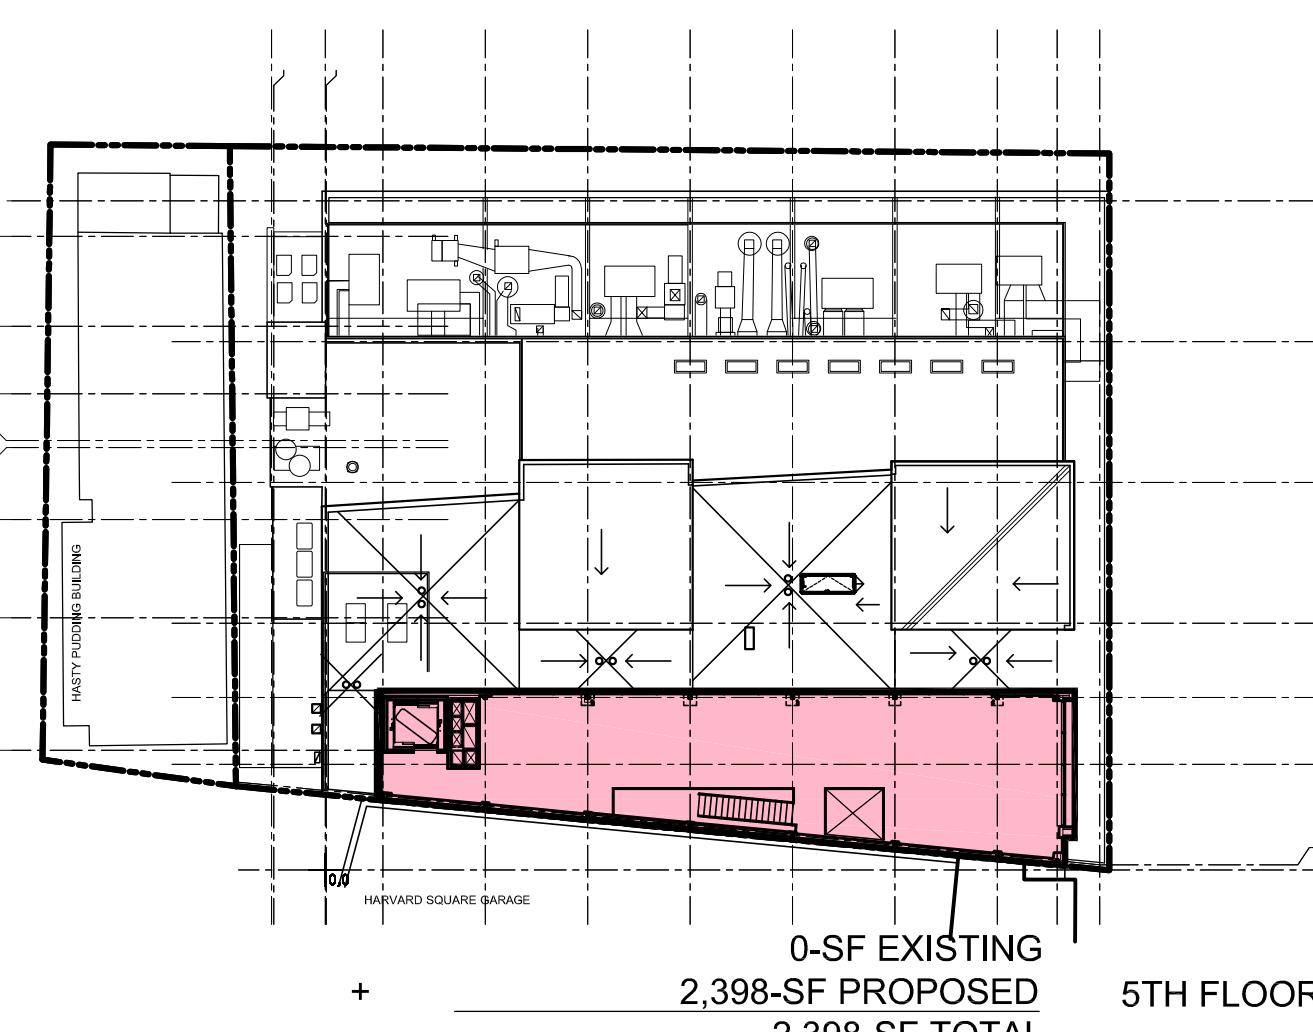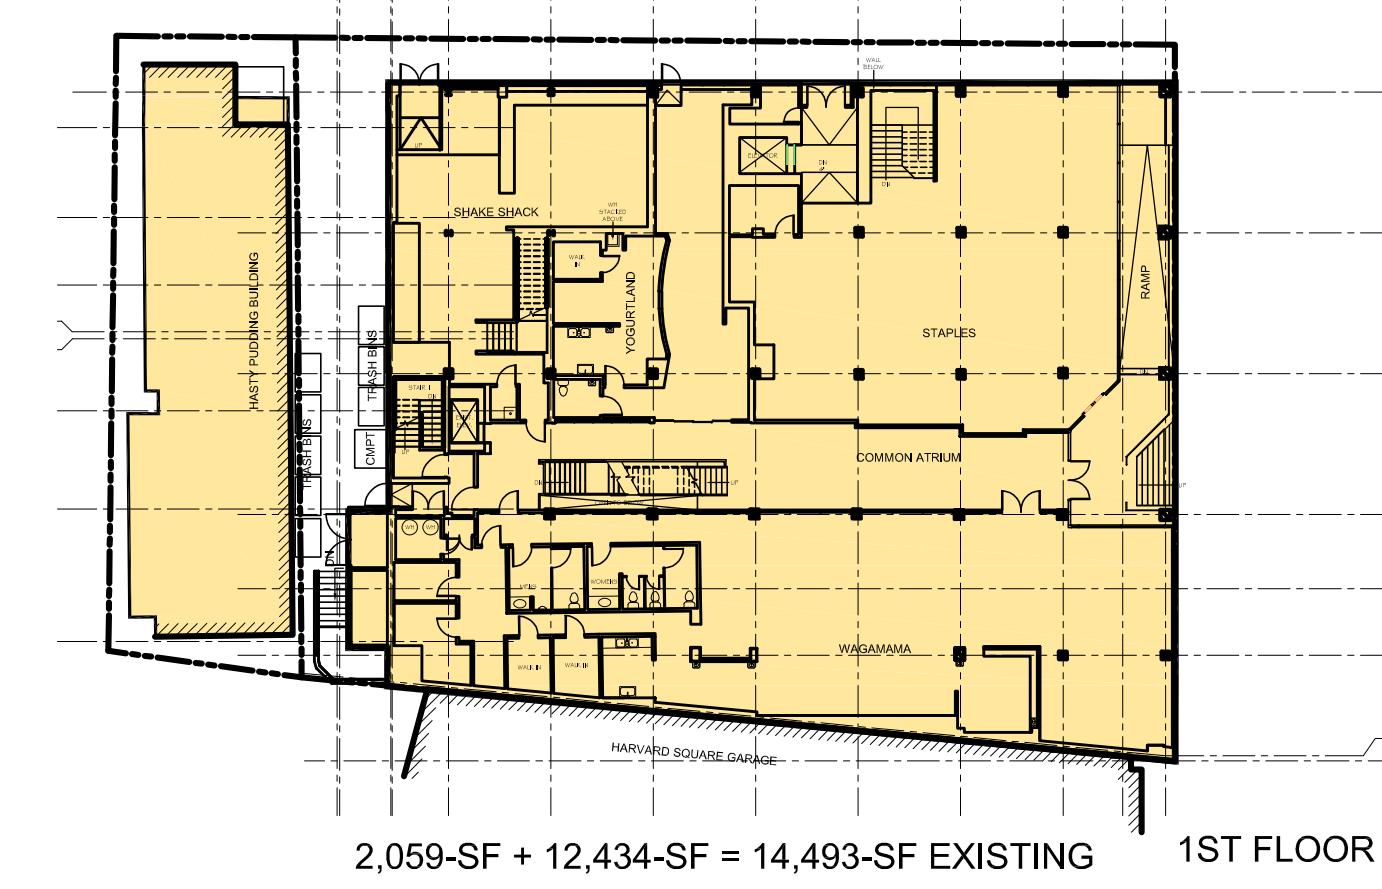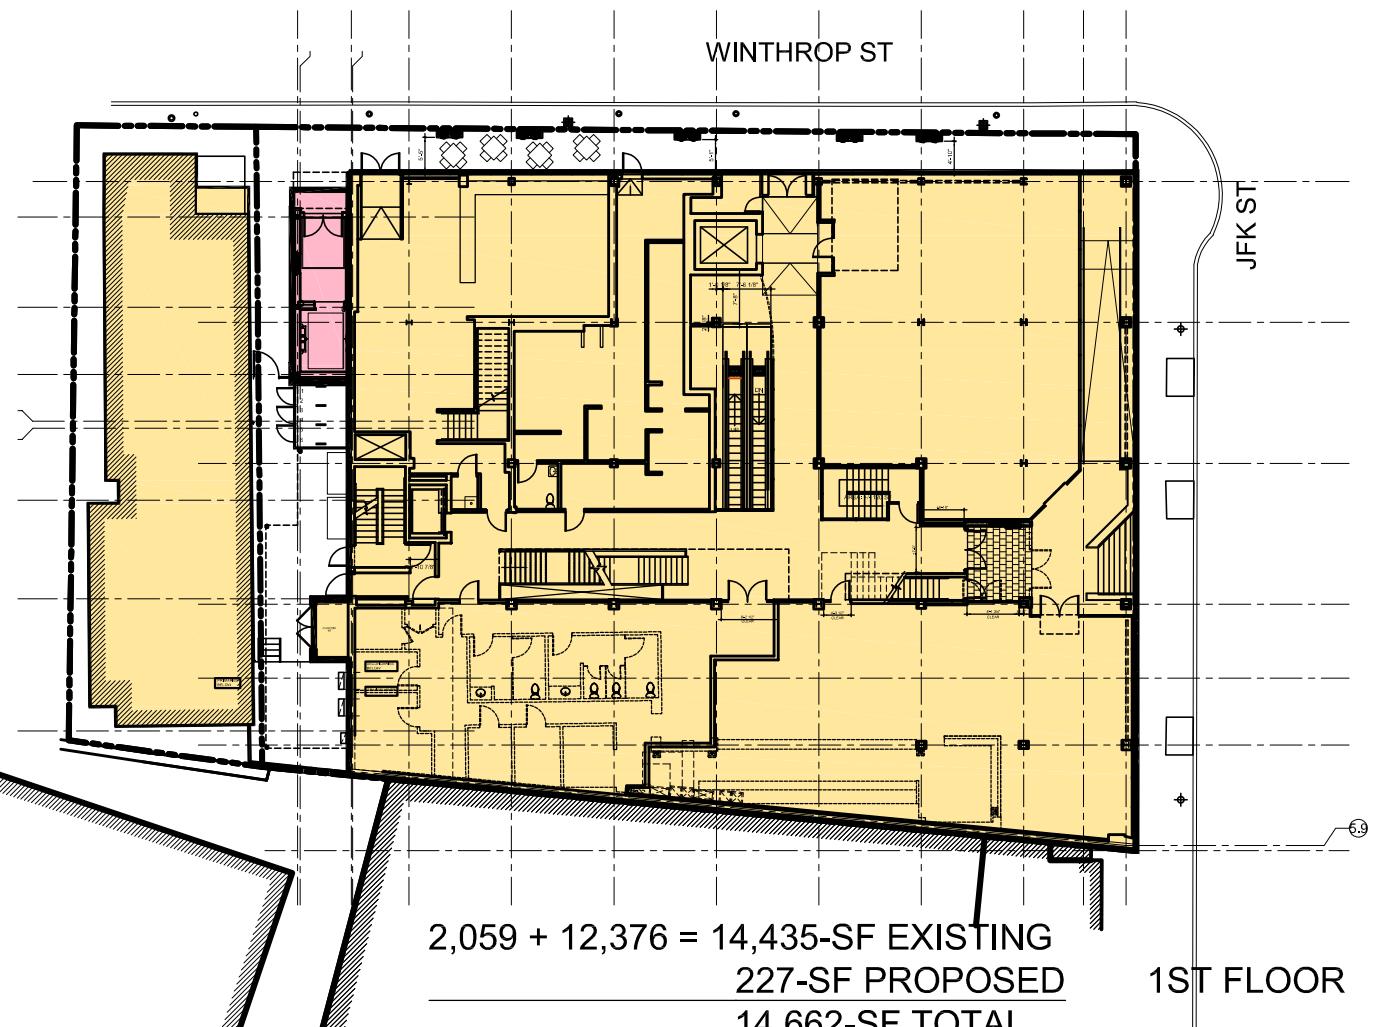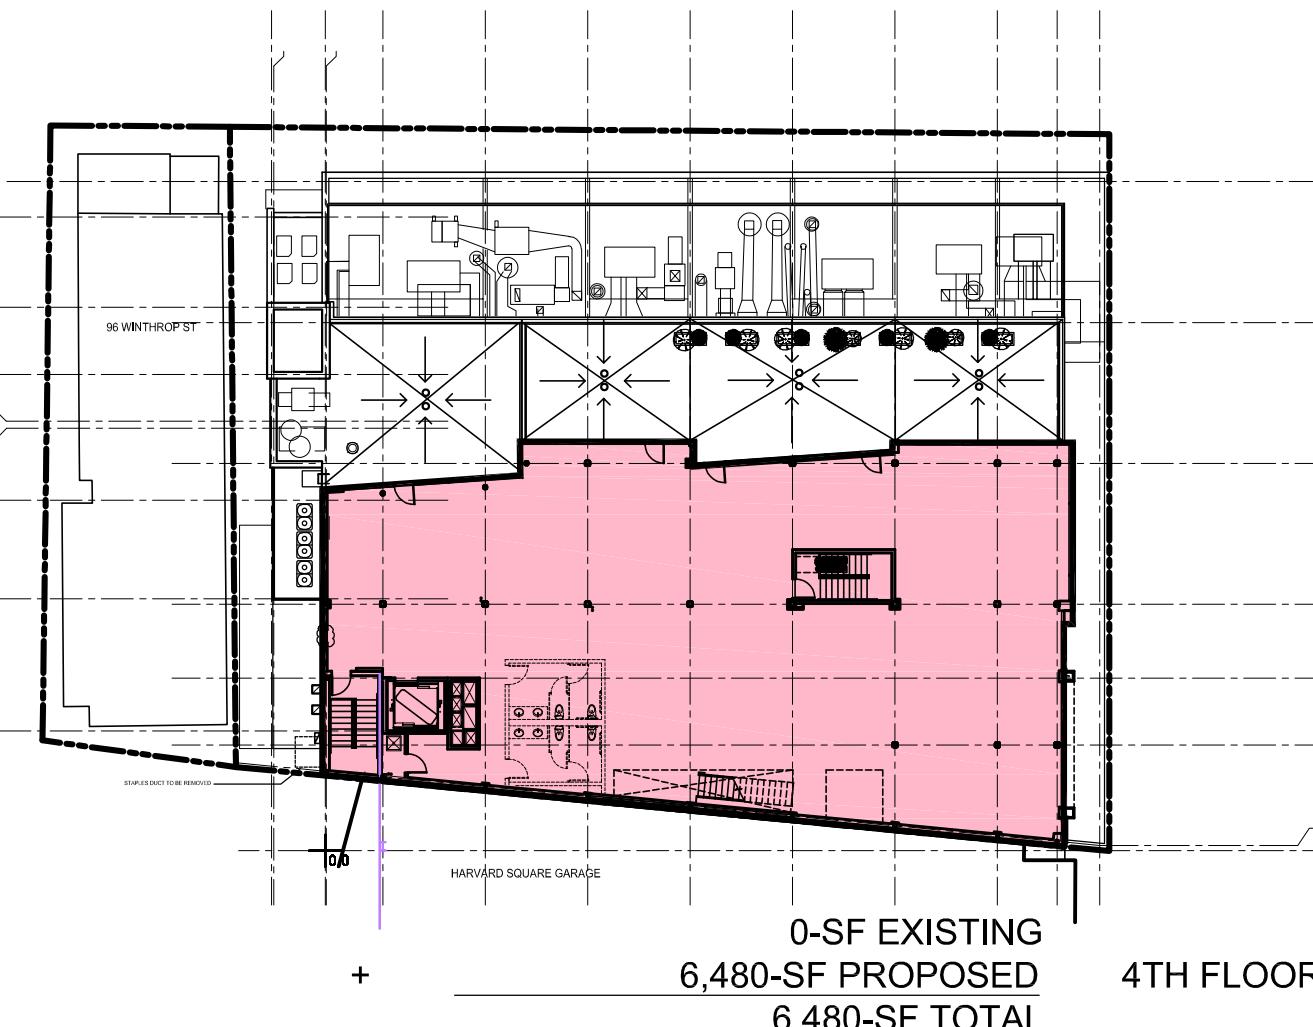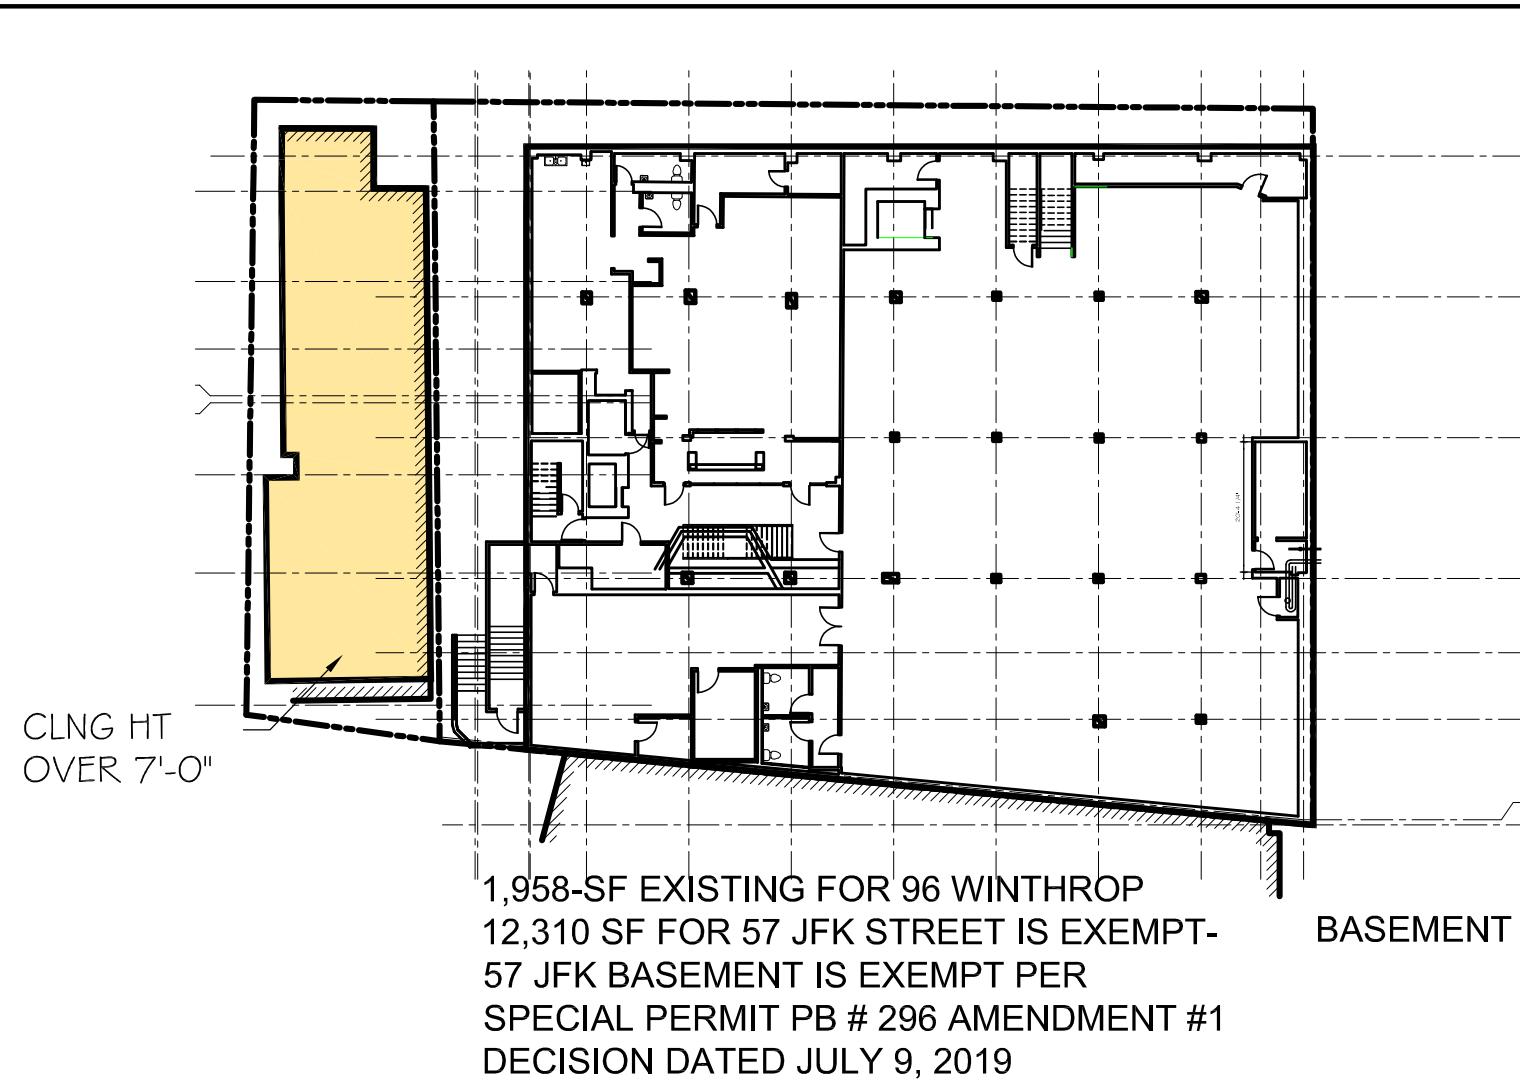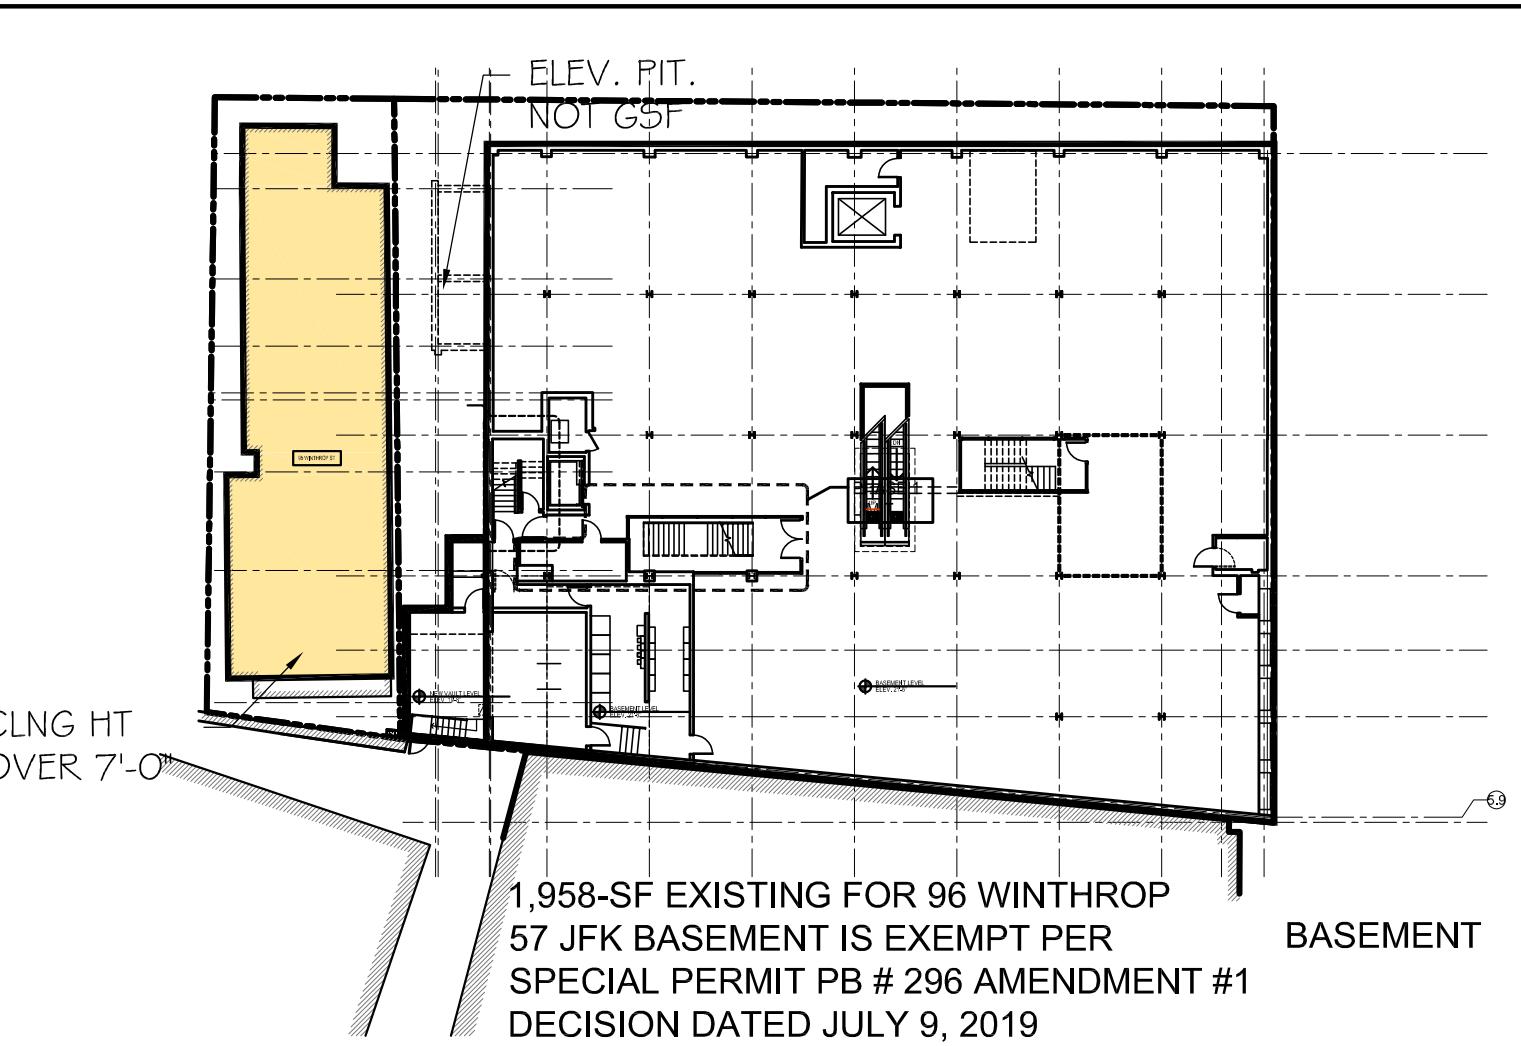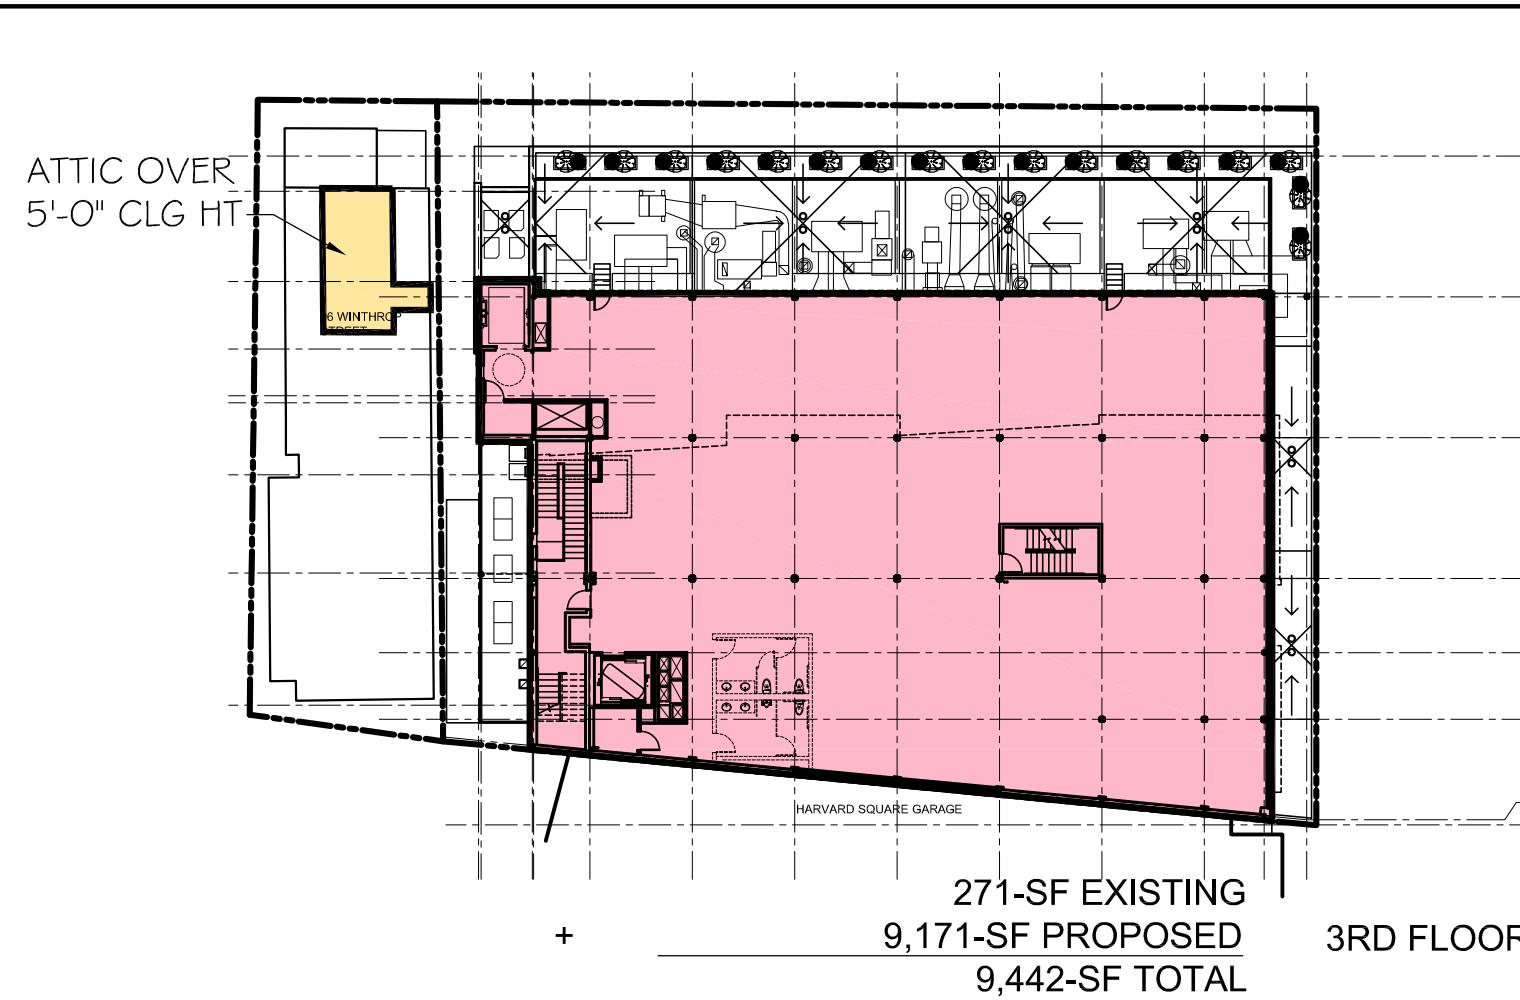



EXISTING COMMERCIAL GSF = 30,507-SF
PROPOSED COMM GSF = 18,276-SF
PROPOSED RES GSF = 0-SF
TOTAL PROPOSED GFA = 48,783-GSF

EXISTING & PROPOSED GFA
SCALE 1"=30'

EXISTING COMMERCIAL GSF = 30,553-SF
EXISTING RES GSF = 0-SF
TOTAL EXISTING GFA = 30,553-GSF

EXISTING FLOOR PLANS
SCALE 1"=30'

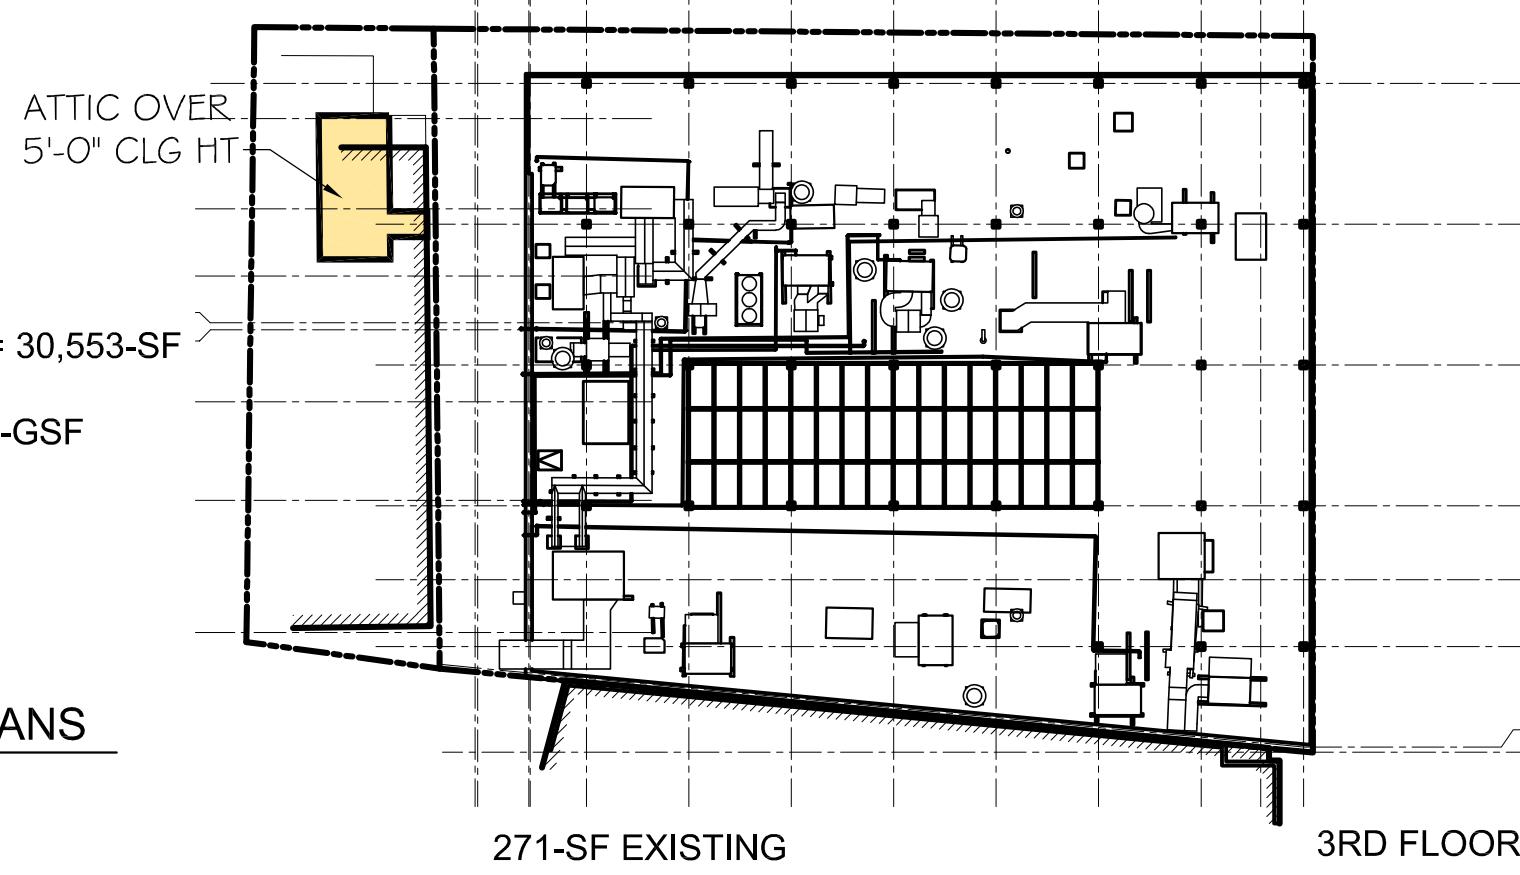

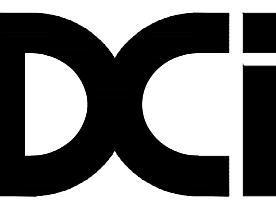

PROJECT
**ADDITION TO
57 JFK ST**

57 JFK STREET
CAMBRIDGE, MA

PREPARED FOR
CRIMSON GALERIA, LP

166 BEACON ST
BROOKLINE, MA 02446

DRAWING TITLE

**SITE LAYOUT,
UTILITIES &
DRAINAGE
PLAN**

SCALE AS NOTED

REVISION / ISSUE	DATE
PHASE 2 RE-PERMIT	12 FEB 2020
PHASE 2 CD SET	27 JUL 2018
PHASE 2 PERMIT	21 DEC 2017
REV PARTIAL PERMIT	8 DEC 2017
PARTIAL PERMIT	8 SEPT 2016
PRICING SET	23 FEB 2016
DRAWN BY GS	REVIEWED BY SBS
SHEET	

C-1

GENERAL NOTES:

1. THIS PLAN DOES NOT NECESSARILY DEPICT THE EXACT LOCATION AND SIZE OF ALL UTILITIES WHICH MAY EXIST AT THIS TIME INSIDE OR OUTSIDE OF EXISTING OR PROPOSED BUILDINGS, ON THE SUBJECT PROPERTY, WITHIN THE STREET R.O.W. OR ON ABUTTING LOTS.
2. THE CONTRACTOR IS RESPONSIBLE FOR VERIFYING AND RECORDING THE LOCATION OF EACH PROPOSED UTILITY CONNECTION.
3. THE CITY OF CAMBRIDGE WATER AND ELECTRIC UTILITIES ARE PART OF DIG-SAFE, HOWEVER CAMBRIDGE SEWERS ARE NOT. THE CONTRACTOR SHALL CONTACT THE CITY OF CAMBRIDGE FOR THE MARKING OF CAMBRIDGE MUNICIPAL UTILITIES, AND SHALL ALSO CONTACT DIG-SAFE AT 1-888-344-7233 OR 1-800-322-4844 AT LEAST 72 HOURS PRIOR TO EXCAVATION.
4. THE CONTRACTOR SHALL SUPPLY ALL PIPING, STRUCTURES, MATERIALS, AND APPURTENANCES, NECESSARY TO PERFORM ALL WET AND/OR DRY TAPS AS PART OF THIS CONTRACT.
5. NEW WATER SERVICES SHALL BE LEFT SHUT OFF AT THE MAIN ON THE STREET UNTIL ACTIVATED BY THE CITY OF CAMBRIDGE.
6. A DYE TEST SHALL BE PERFORMED BY A CITY OF CAMBRIDGE INSPECTOR PRIOR TO THE ISSUANCE OF AN OCCUPANCY PERMIT.
7. THE RESPONSIBILITY OF OWNERSHIP AND MAINTENANCE OF THE SEWER, WATER, AND DRAIN CONNECTIONS ON PRIVATE PROPERTY AND/OR PRIVATE AND PUBLIC WAYS SHALL REMAIN THAT OF THE OWNER.
8. THE CITY OF CAMBRIDGE RESERVES THE RIGHT TO INSPECT ALL PRIVATE FACILITIES DISCHARGING TO MUNICIPAL FACILITIES.
9. DURING EXCAVATION AND CONSTRUCTION OF PIPES AND STRUCTURES, TRENCHES MUST BE ADEQUATELY BRACED AND PROTECTED AGAINST CAVE-IN.
10. ALL WORK PERFORMED AS PART OF THIS PROJECT SHALL CONFORM TO STANDARDS OF THE CITY OF CAMBRIDGE, DEPARTMENT OF PUBLIC WORKS AND ANY OTHER AGENCY OR BODY WITH AUTHORITY IN THIS AREA.
11. ALL EXISTING UTILITY SERVICE CONNECTIONS, SEWER DISPOSAL FACILITIES, AND WELLS SHALL BE ABANDONED UNLESS NOTED OTHERWISE. THE CONTRACTOR IS RESPONSIBLE FOR VERIFYING THE EXACT LOCATION OF EACH CONNECTION. THE WATER, DRAIN, AND SEWER SERVICES SHALL BE CAPPED AND CUT AT THE MAIN IN THE STREET BY THE CONTRACTOR. ABANDONMENT OF EXISTING CONNECTIONS SHALL BE COORDINATED BY THE CONTRACTOR WITH THE RESPECTIVE UTILITY COMPANY.
12. ALL UTILITIES SHOWN ON THIS SITE ARE TO THE EXTERIOR OF THE BUILDING FOUNDATION ONLY. UTILITIES THROUGH THE FOUNDATION AND INSIDE THE BUILDING ARE APPROXIMATE AND THE RESPONSIBILITY OF THE MECHANICAL ENGINEER. (SEE MECHANICAL ENGINEER PLANS)
13. ELEVATIONS DEPICTED HEREON ARE ON CITY OF CAMBRIDGE SEWER DATUM.

PIPE MATERIALS:

SEWER & DRAIN SERVICE: 6 & 8 INCH PVC ASTM D3034-SDR 35 - SEE PLAN, SLOPE=0.02 FT/FT (MINIMUM)

WATER SERVICE: 4" CLASS 56 DUCTILE IRON CEMENT LINED PIPE


THRUST BLOCKS:


CONCRETE THRUST BLOCKS TO BE USED ONLY WHERE IT WILL BEAR ON UNDISTURBED EARTH. USE RESTRAINED JOINT FITTINGS (MEGALUG OR APPROVED EQUAL) WHERE CONCRETE THRUST BLOCK IS UNACCEPTABLE. SIZE OF BLOCK OR MEGALUG TO BE DESIGNED FOR SPECIFIC CONDITIONS.

SEWER CLEANOUTS & INTERNAL SEWER SERVICES:

THE OWNER SHALL FURNISH AND INSTALL ALL SEWER CLEANOUTS. EXACT LOCATION OF ALL SEWER CLEANOUTS AND INTERNAL SEWER SERVICES TO BE CONFIRMED/ COORDINATED BY MECHANICAL ENGINEER AND ARCHITECT.

PRECAST STRUCTURES:
DESIGN FOR H-20 LOADING

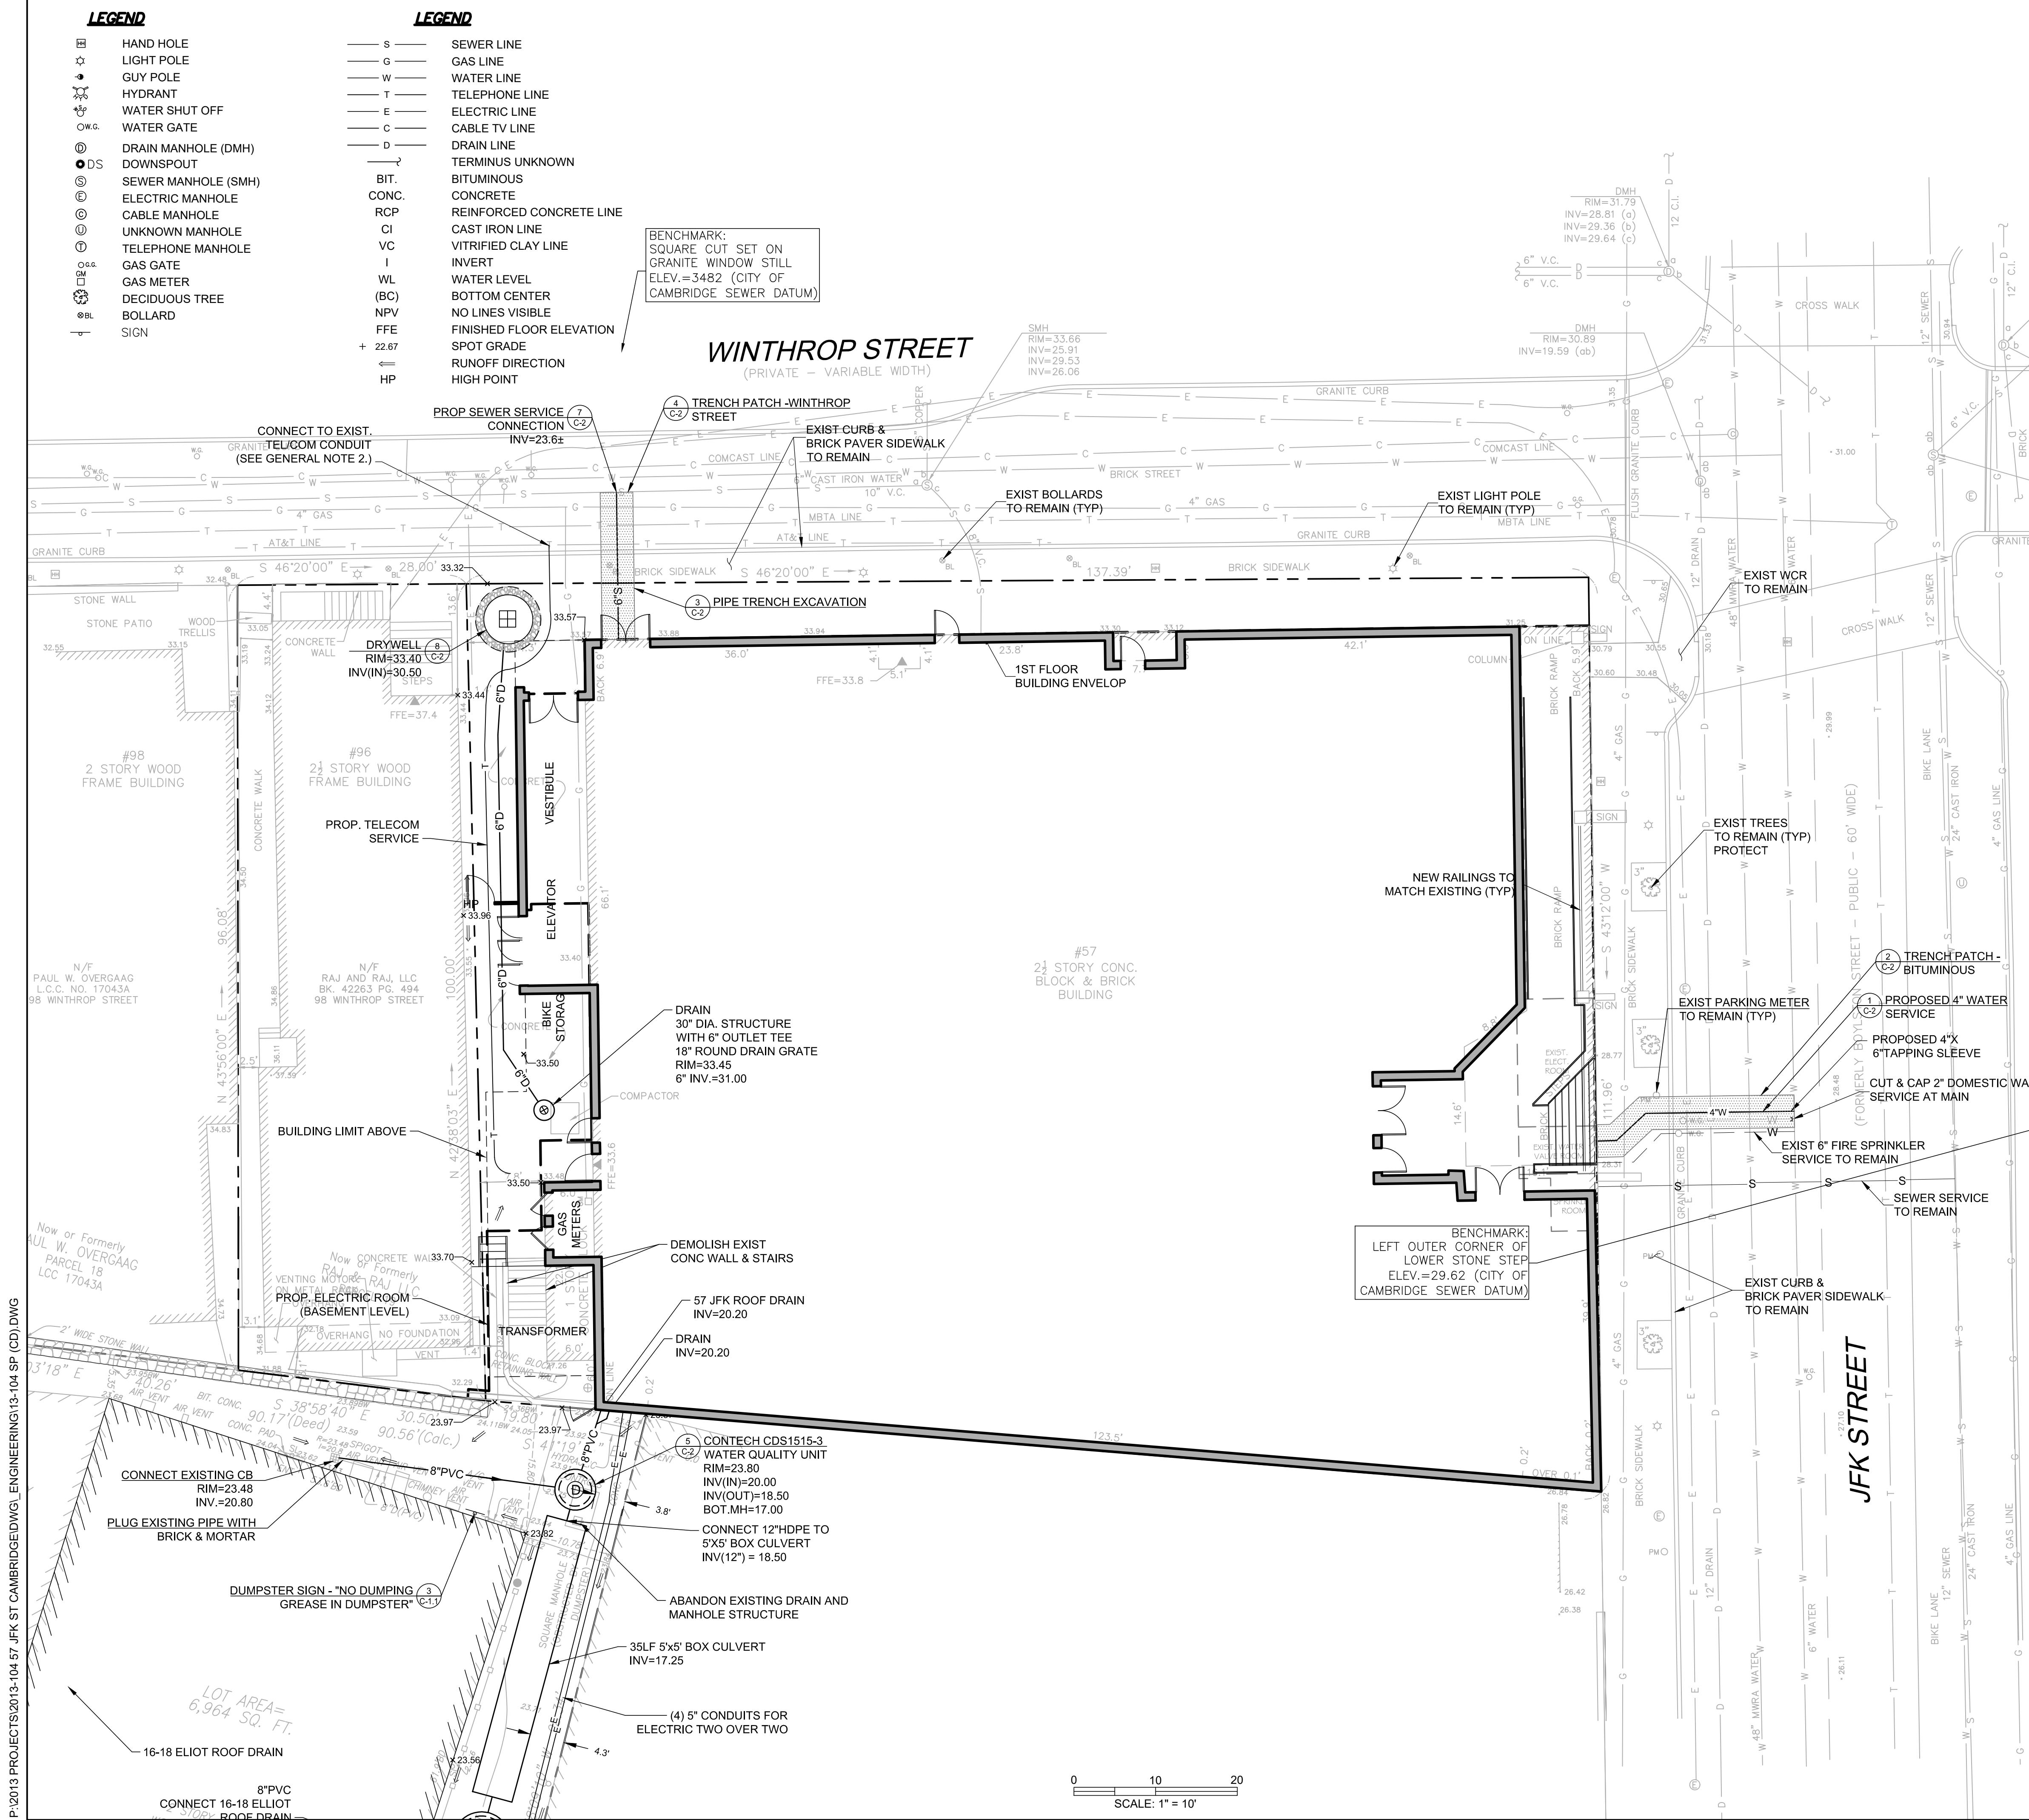

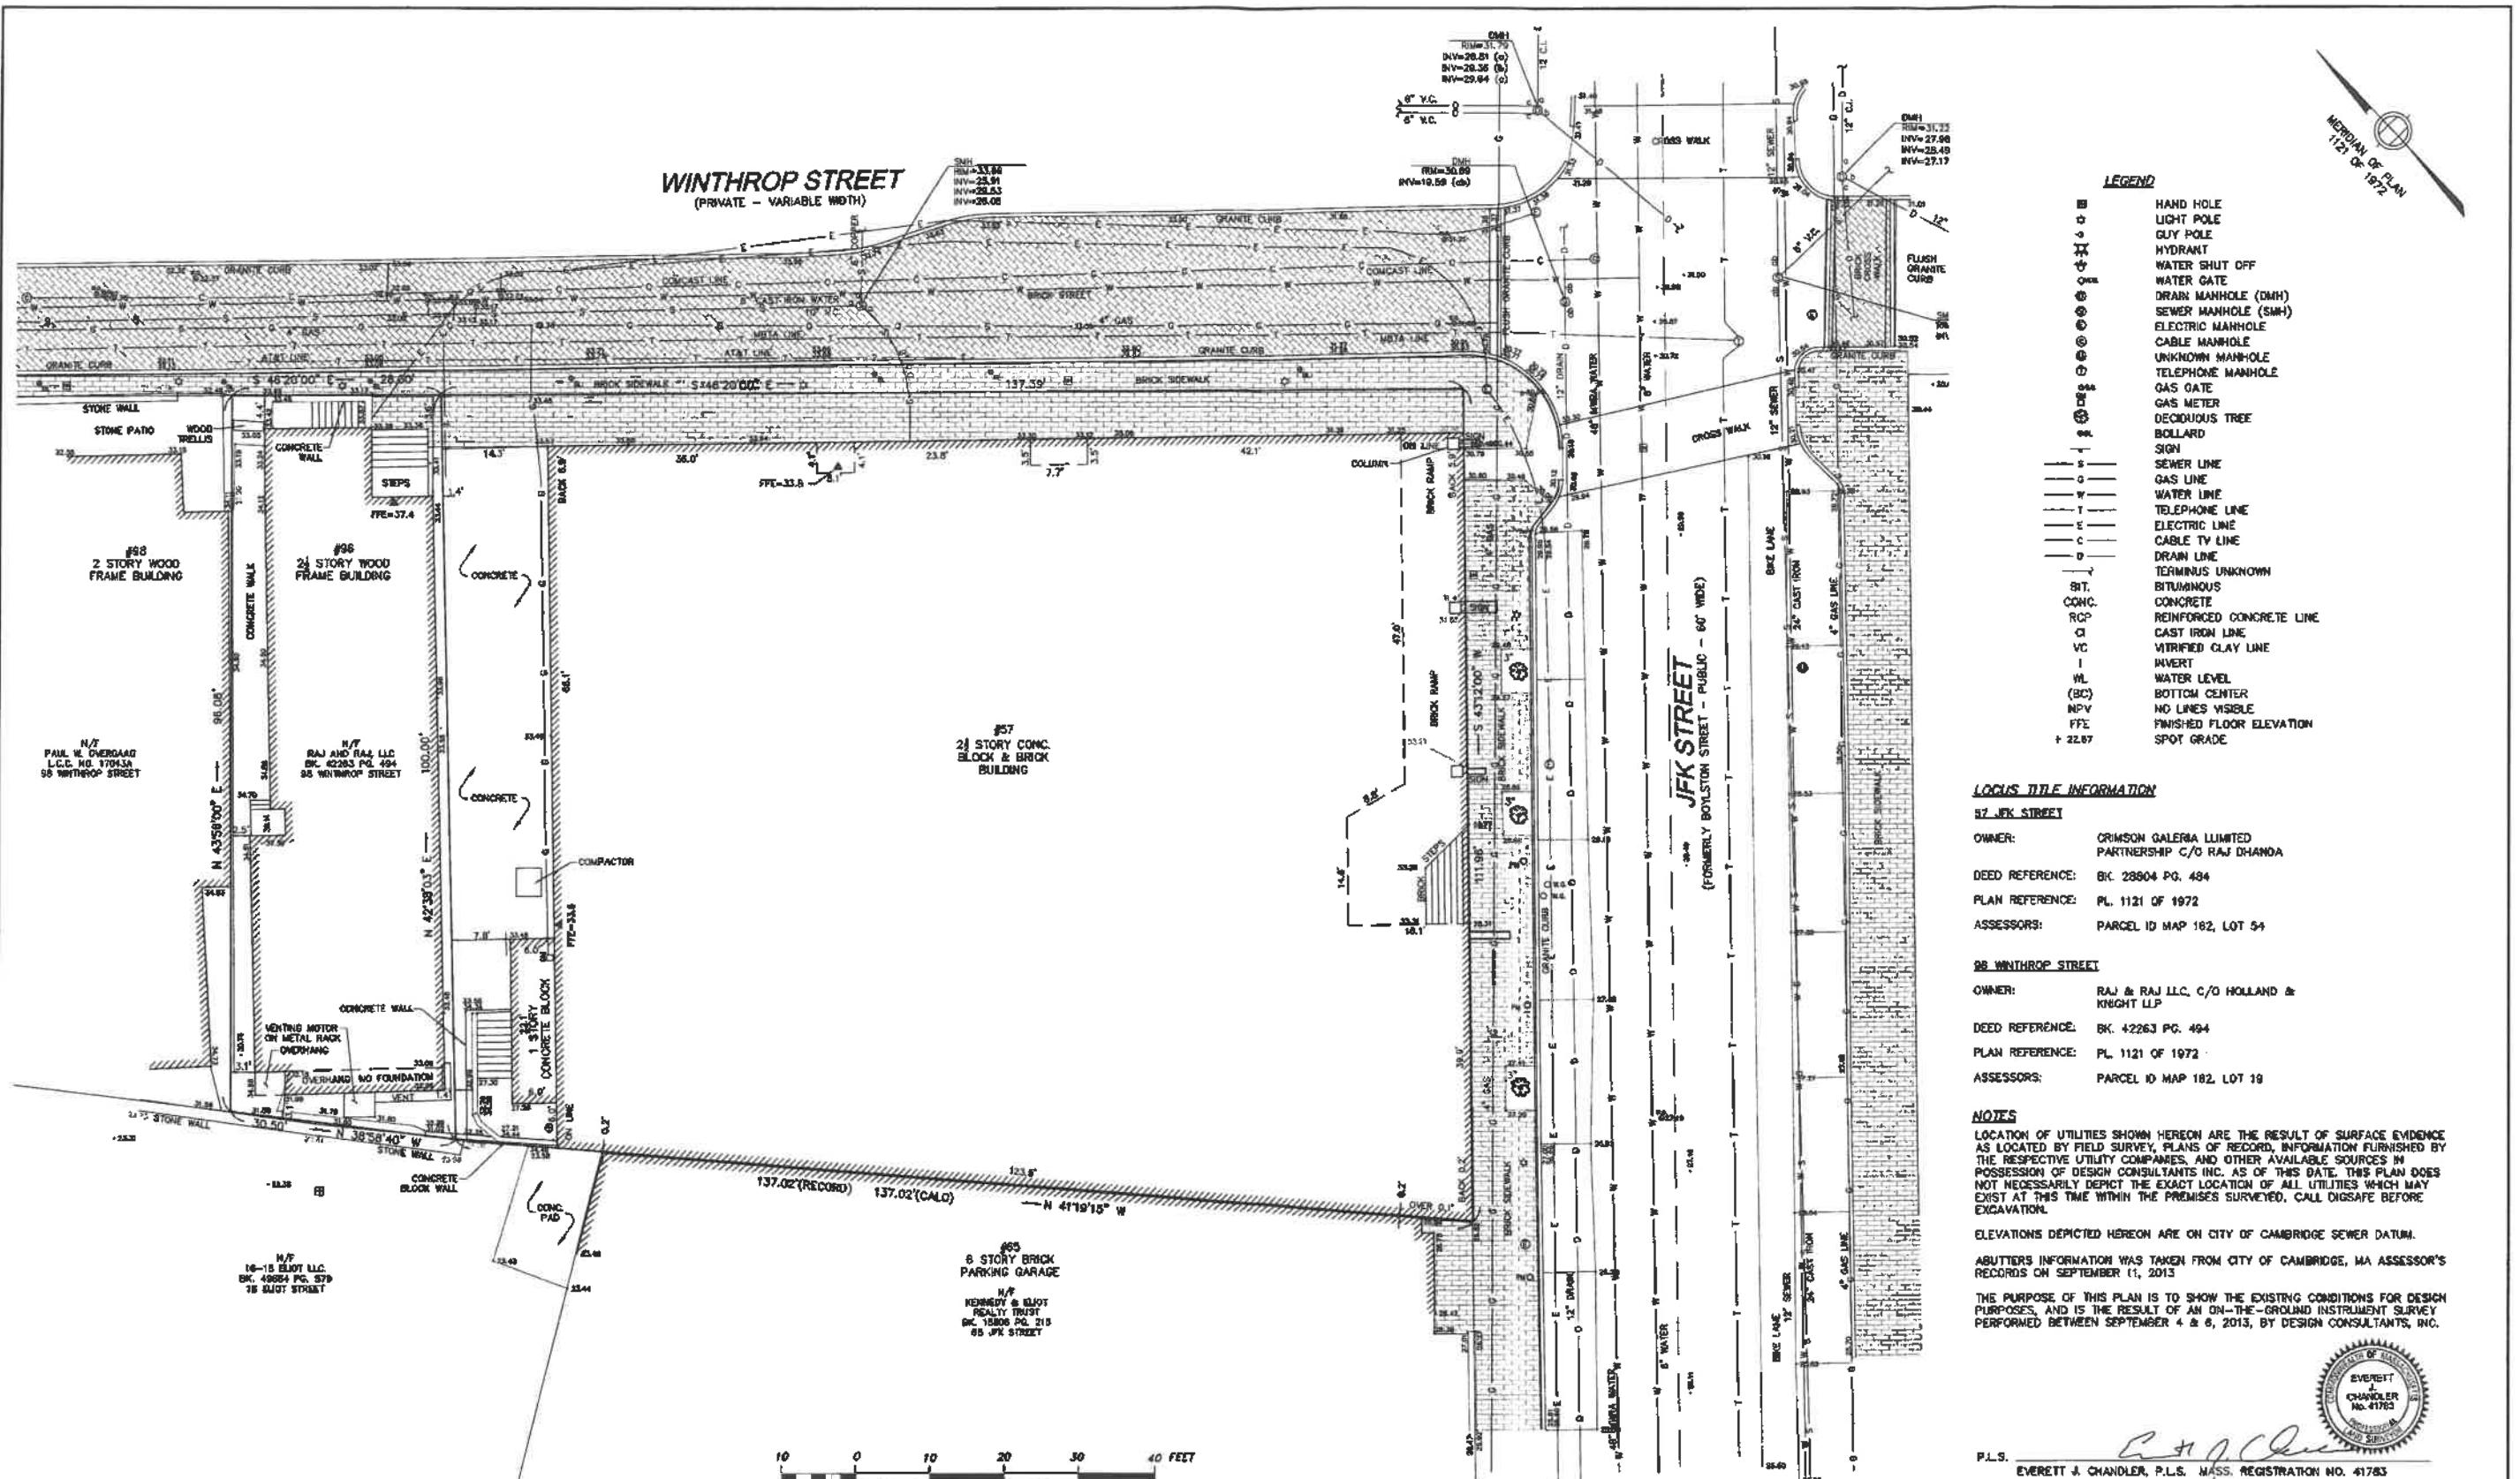

Copyright 2013 Design Consultants, Inc.

Design Consultants, Inc.
Consulting Engineers and Surveyors

120 MIDDLESEX AVENUE
SOMERVILLE, MA 02145
617-776-3350

68 PLEASANT STREET
NEWBURYPORT, MA 01950
978-566-7173

SCALE:
HORIZ: 1" = 10'
VERT:

NO. DATE BY
REVISIONS

FIELD: LG
CALCS: AR
CHECKED: EJC
APPROVED: EJC

EXISTING CONDITIONS
57 JFK STREET &
96 WINTHROP STREET



PLAN OF LAND IN
CAMBRIDGE, MASSACHUSETTS
SURVEYED FOR
CRIMSON GALERIA LP



P.L.S.
EVERETT J. CHANDLER, P.L.S. MASS. REGISTRATION NO. 41783

DATE 11/14/13

PROJECT NO.
2013-104
DATE: SEPT. 11, 2013
SHEET NO.
1 OF 1

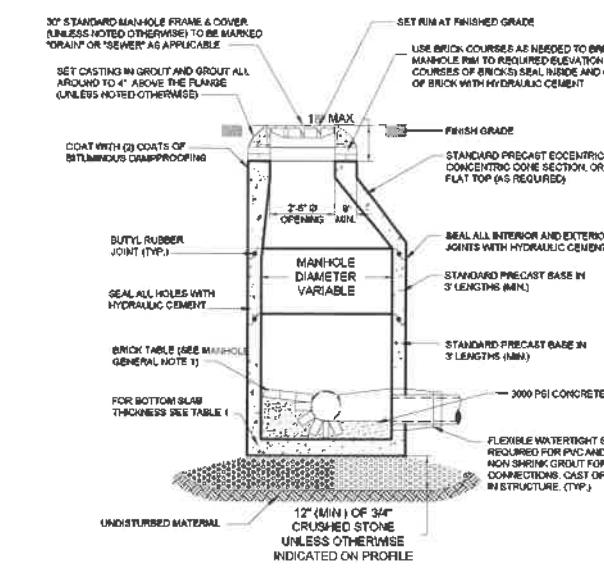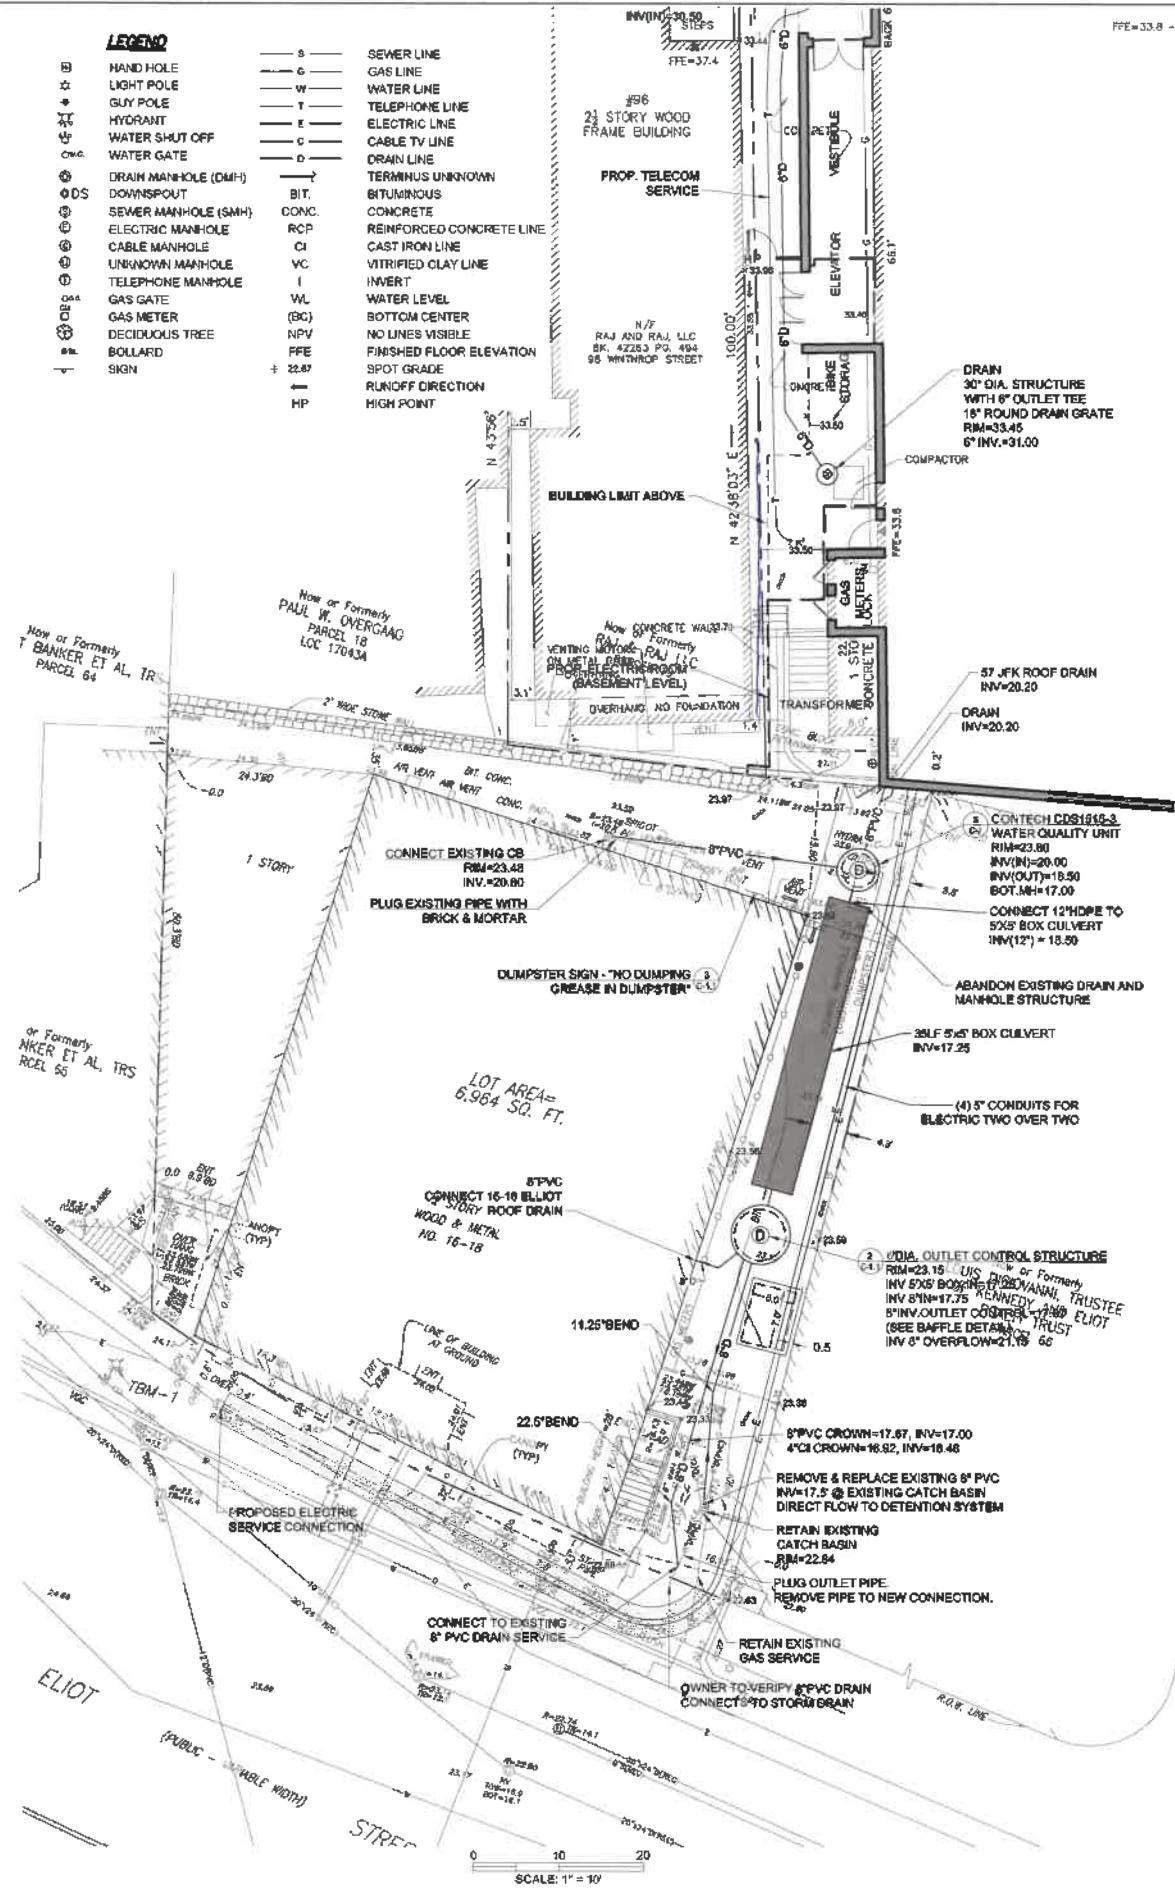

1 PRECAST CONCRETE MANHOLE
NOT TO SCALE

1. THIS PLAN DOES NOT NECESSARILY DEPICT THE EXACT LOCATION AND SIZE OF ALL UTILITIES WHICH MAY EXIST AT THIS TIME INSIDE OR OUTSIDE OF EXISTING OR PROPOSED BUILDINGS, ON THE SUBJECT PROPERTY, WITHIN THE STREET ROW, OR ON ADJACENT LOTS.
 2. THE CONTRACTOR IS RESPONSIBLE FOR VERIFYING AND RECORDING THE LOCATION OF EACH PROPOSED UTILITY CONNECTION.
 3. THE CITY OF CAMBRIDGE WATER AND ELECTRIC UTILITIES ARE PART OF DIG-SAFE, HOWEVER CAMBRIDGE SEWERS ARE NOT. THE CONTRACTOR SHALL CONTACT THE CITY OF CAMBRIDGE FOR THE MARKING OF CAMBRIDGE MUNICIPAL UTILITIES, AND SHALL ALSO CONTACT DIG-SAFE AT 1-888-344-7233 OR 1-800-322-4844 AT LEAST 72 HOURS PRIOR TO EXCAVATION.
 4. THE CONTRACTOR SHALL SUPPLY ALL PIPING, STRUCTURES, MATERIALS, AND APPURTENANCES, NECESSARY TO PERFORM ALL NEW AND/OR DRY TAPS AS PART OF THIS CONTRACT
 5. NEW WATER SERVICES MUST BE LEFT SHUT OFF AT THE MAIN ON THE STREET UNTIL ACTIVATED BY THE CITY OF CAMBRIDGE.
 6. A ~~DRY~~ TEST SHALL BE PERFORMED BY A CITY OF CAMBRIDGE INSPECTOR PRIOR TO THE ISSUANCE OF AN OCCUPANCY PERMIT.
 7. THE RESPONSIBILITY OF OWNERSHIP AND MAINTENANCE OF THE SEWER, WATER, AND DRAIN CONNECTIONS ON PRIVATE PROPERTY AND/OR PRIVATE AND PUBLIC WAYS SHALL REMAIN THAT OF THE OWNER.
 8. THE CITY OF CAMBRIDGE RESERVES THE RIGHT TO INSPECT ALL PRIVATE FACILITIES DISCHARGING TO MUNICIPAL FACILITIES.
 9. DURING EXCAVATION AND CONSTRUCTION OF PIPES AND STRUCTURES, TRENCHES MUST BE ADEQUATELY BRACED AND PROTECTED AGAINST CAVE-IN.
 10. ALL WORK PERFORMED AS PART OF THIS PROJECT SHALL CONFORM TO STANDARDS OF THE CITY OF CAMBRIDGE, DEPARTMENT OF PUBLIC WORKS AND ANY OTHER AGENCY OR BODY WITH AUTHORITY IN THIS AREA.
 11. ALL EXISTING UTILITY SERVICE CONNECTIONS, SEWER DISPOSAL FACILITIES, AND WELLS SHALL BE ABANDONED UNLESS NOTED OTHERWISE. THE CONTRACTOR IS RESPONSIBLE FOR VERIFYING THE EXACT LOCATION OF EACH CONNECTION. THE WATER, DRAIN, AND SEWER SERVICES SHALL BE CAPPED AND CUT AT THE MAIN IN THE STREET BY THE CONTRACTOR. ABANDONMENT OF EXISTING CONNECTIONS SHALL BE COORDINATED BY THE CONTRACTOR WITH THE RESPECTIVE UTILITY COMPANY.



SONS OF TANT



**ADDITION TO
57 JFK ST**

7 JFK STREET
CAMBRIDGE, MA


REARED FOR

CRIMSON GALERIA, LP


86 BEACON ST
BROOKLINE, MA 02446

DRAINAGE PLAN

CALENDAR NOTES	
REVISION / ISSUE	DATE
PHASE 2 RE-PERMIT	12 FEB 2020
PHASE 2 CD SET	27 JUL 2018
PHASE 2 PERMIT	21 DEC 2017
REV PARTIAL PERMIT	8 DEC 2017
PARTIAL PERMIT	8 SEPT 2016
PRICING SET	23 FEB 2016
DRAWN BY S	REVIEWED BY SBS

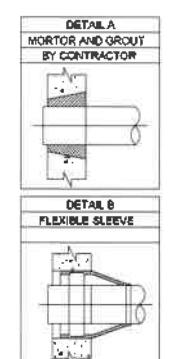

2 PRECAST OUTLET CONTROL STRUCTURE

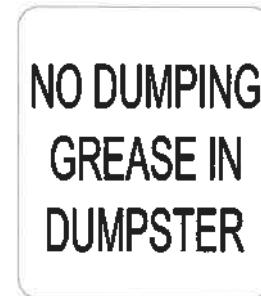

**3 DUMPSTER SIGN
NOT TO SCALE**

PETER QUINN ARCHITECTS

ARCHITECTURE
PLANNING
COMMUNITY DESIGN

PETER QUINN ARCHITECTS LLC
239 ELM STREET, SUITE 301
SOMERVILLE, MA 02144
PH 617-354-3999 FAX 617-669-0260



CONSULTANT

PROJECT ADDITION TO 57 JFK ST

57 JFK STREET
CAMBRIDGE, MA

PREPARED FOR

CRIMSON GALERIA, LP


166 BEACON ST
BROOKLINE, MA 02446

DRAWING TITLE SECTION THROUGH ELEVATOR #2 LOBBY

SCALE AS NOTED

REVISION / ISSUE	DATE
PHASE 2 RE-PERMIT	12 FEB 2020
PHASE 2 CD SET	27 JUL 2018
PHASE 2 PERMIT	21 DEC 2017
REV PARTIAL PERMIT	8 DEC 2017
PARTIAL PERMIT	8 SEPT 2016
PRICING SET	23 FEB 2016
DRAWN BY	REVIEWED BY
WFD/ASH/NDW	
SHEET	

A3.6

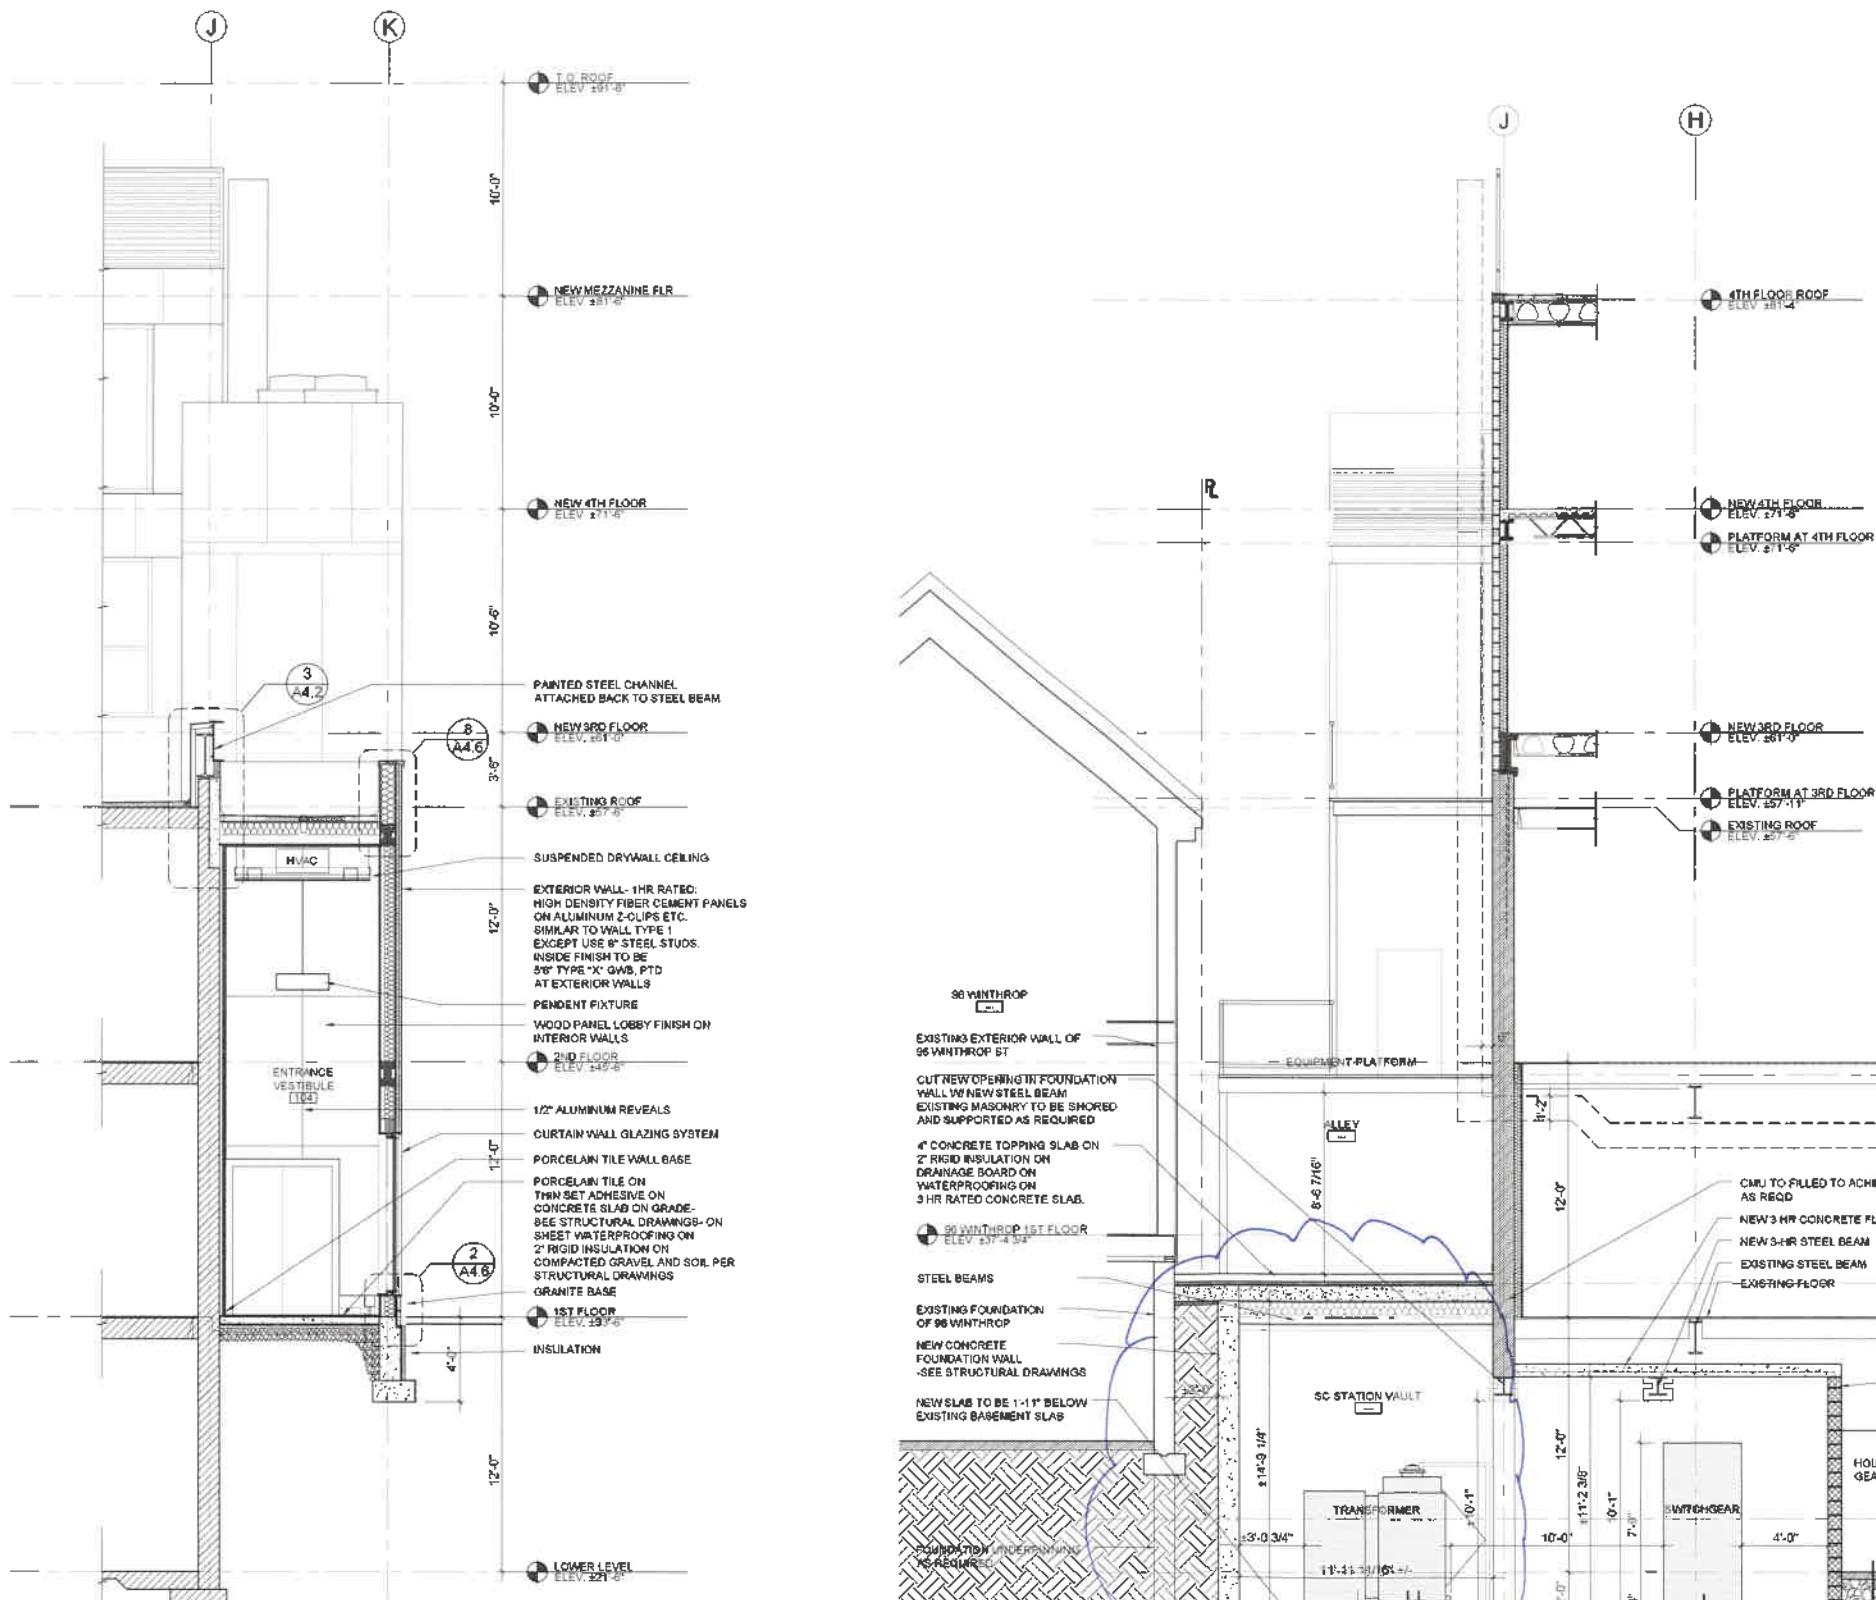

CROSS SECTION THROUGH SUBSTATION
SCALE 1/4" = 1'-0"

PETER
QUINN
ARCHI
TECTS

ARCHITECTURE
PLANNING
COMMUNITY DESIGN

PETER QUINN ARCHITECTS LLC
259 ELM STREET, SUITE 301
SOMERVILLE, MA 02144
PH 617-354-3969 FAX 617-568-0280

SEAL

CONSULTANT

PROJECT

**ADDITION TO
57 JFK ST**

57 JFK STREET
CAMBRIDGE, MA

PREPARED FOR

CRIMSON GALERIA, LP

1299 BEACON ST
BROOKLINE, MA 02446

DRAWING TITLE

**LOWER LEVEL
PLAN-
ENLARGED PLAN**

SCALE AS NOTED

REVISION / ISSUE	DATE
------------------	------

REVISION 7	31 JAN 2020
------------	-------------

REVISION 6	3 JAN 2020
------------	------------

REVISION 5	11 NOV 2019
------------	-------------

REVISION 4	16 MAR 2019
------------	-------------

DRAWN BY	REVIEWED BY
----------	-------------

SMITH

LDASH	
-------	--

A6.4

95 WINTHROP ST

EXISTING OPENING
NEW CONCRETE SLAB
NEW CONCRETE FOUNDATION WALL
NEW 3 HR RATED DOOR
4' HIGH CURB

NEW 3 HR RATED FOUNDATION WALL-
SHORE EXISTING BUILDING AS REQUIRED-
SEE STRUCTURAL DRAWINGS

NEW OPENING IN FOUNDATION WALL-
SEE STRUCTURAL DRAWINGS
NEW SLAB AT BASEMENT LEVEL

STEEL STAIRS
MAKE-UP AIR LOUVER
W/DAMPER
NEW CONCRETE WALL

HISTORIC STONE WALL
3-HR RATED 3'-0" WIDE DOOR
4'-0" GRADE CHANGE
8'-0" WIDE X 8'-0" HIGH INSULATED ROLL-UP DOOR, 3-HR RATED.
SUBSTATION SMOKE EXHAUST

16-18 ELIOT ST

ELIOT ALLEY

ELECTRICAL SERVICE
TRANSFORMERS
TWO 100 KVA TRANSFORMERS

HARVARD SQUARE GARAGE

02/01/20-


SINGLE LEVEL TRANSFORMER STATION-
GRADE CHANGE 4'-8" TO ELIOT ALLEY

1 LOWER LEVEL (BELOW GRADE)

LEGEND	
—	EXISTING WALL TO REMAIN
—	EXISTING WALL TO BE DEMOLISHED (SEE DEMO PLAN)
—	PROPOSED NEW WALL


PROJECT NORTH



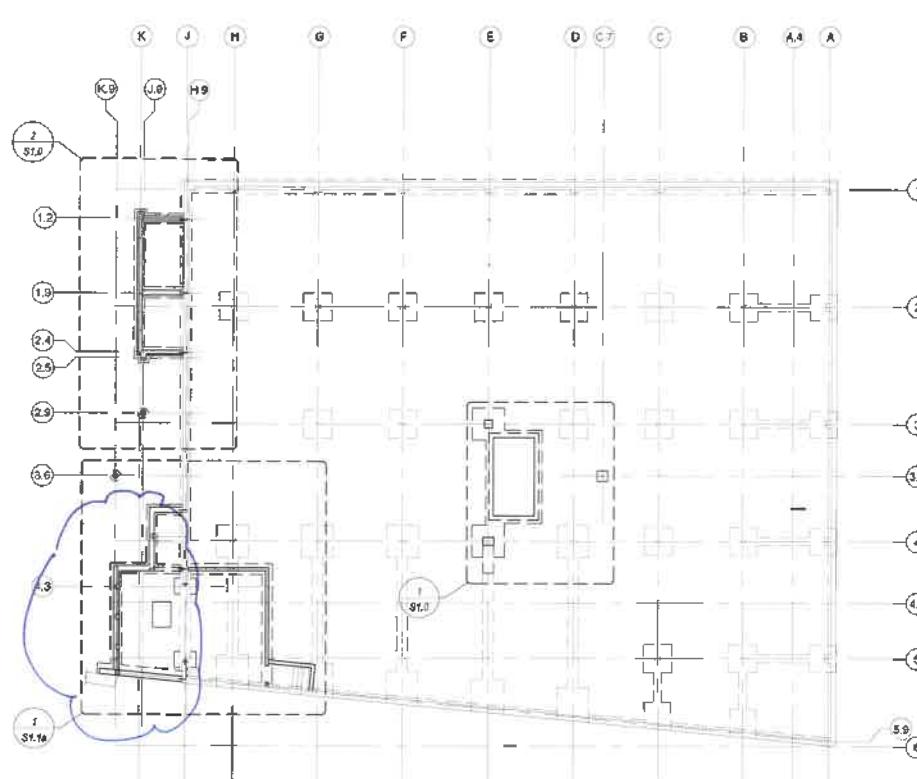


FOUNDATION LOCUS PLA

Scalat: 1/16" = 1

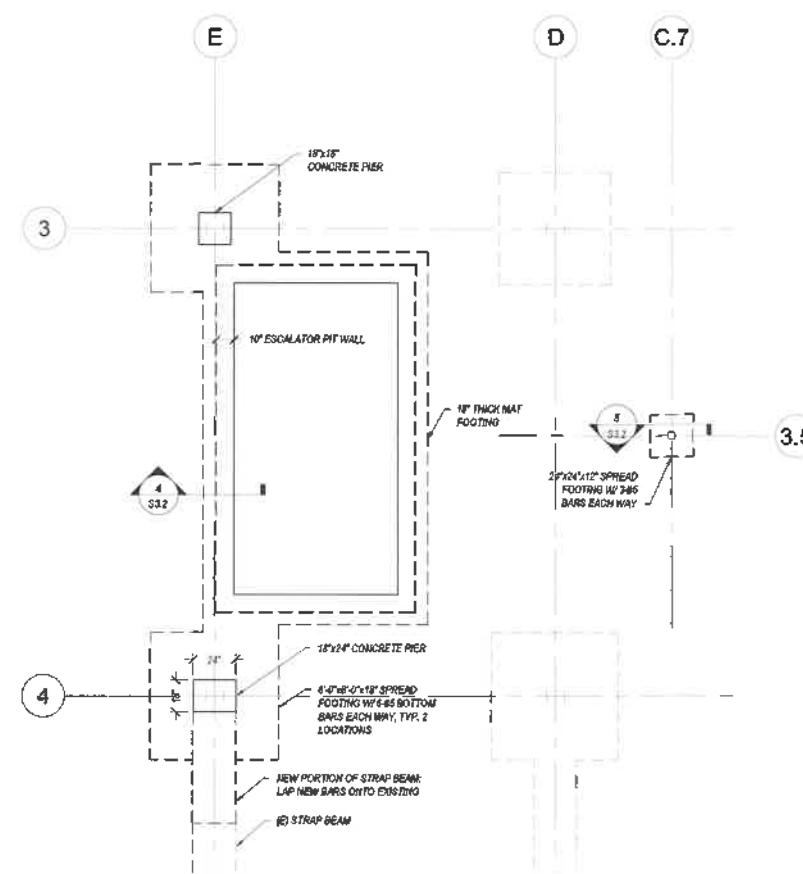

1 FOUNDATION PLAN AT ESCALATOR PI

Scale: 1/4" = 1'-0"

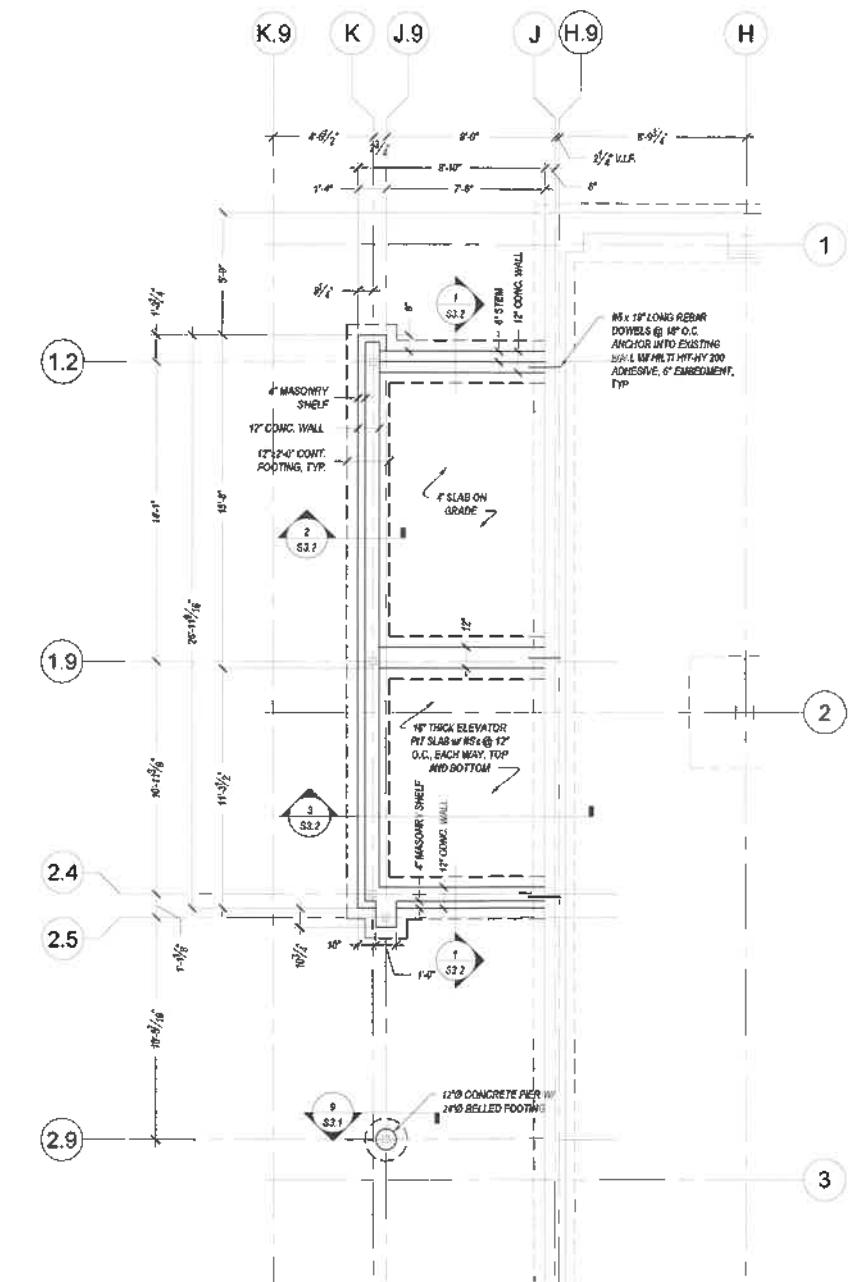

FOUNDATION PLAN AT LOBBY

NOTE:
"SLAB ON GRADE" DENOTES # OF SLAB ON GRADE WIT

Page 149 of 200

1

S1.0

PETER
QUINN
ARCHI-
TECTS

ARCHITECTURE
PLANNING
COMMUNITY DESIGN

TER QUINN ARCHITECTS LLC
59 ELM STREET, SUITE 301
SOMERVILLE, MA 02144
617-354-3989 FAX 617-888-0280



EXCELSIOR

SIEGEL
ASSOCIATES

STRUCTURAL ENGINEERS
Metrical Street
Box 2000, MA 02489
244.1612 tel
244.1732 fax
sse@metrical.com

61

DITION TO
JFK ST

STREET
RIDGE, MA

REO FOR

SON GALERIA, LP

NO TITLE

AS NOTED

PERMIT NUMBER	PERMIT TYPE	PERMIT DATE
1234567890	GENERAL PERMIT	12 FEB 2020
1234567890	CD SET	27 JUL 2018
1234567890	PERMIT	21 DEC 2017
1234567890	PARTIAL PERMIT	8 DEC 2017
1234567890	PERMIT	8 SEPT 2016
1234567890	CD SET	23 FEB 2016
1234567890	REVIEWED BY	REVIEWED BY

PETER QUINN ARCHITECTS

ARCHITECTURE
PLANNING
COMMUNITY DESIGN

PETER QUINN ARCHITECTS LLC
269 ELM STREET, SUITE 301
SOMERVILLE, MA 02144
PH 617-354-3989 FAX 617-668-0280



CONSULTANT

SIEGEL ASSOCIATES

STRUCTURAL ENGINEERS
860 VANDER ST.
NEWTON CENTER, MA 02459
617.244.1612 tel
617.244.1732 fax
www.siegelassociates.com

PROJECT

ADDITION TO 57 JFK ST

57 JFK STREET
CAMBRIDGE, MA

PREPARED FOR

CRIMSON GALERIA, LP

166 BEACON ST
BROOKLINE, MA 02446

DRAWING TITLE

FIRST FLOOR FRAMING PLAN

SCALE AS NOTED

REVISION / ISSUE	DATE
------------------	------

PHASE 2 RE-PERMIT 12 FEB 2020

PHASE 2 CD SET 27 JUL 2018

PHASE 2 PERMIT 21 DEC 2017

REV PARTIAL PERMIT 8 DEC 2017


PARTIAL PERMIT 8 SEPT 2016

PRICING SET 23 FEB 2016

DRAWN BY	REVIEWED BY
AJO	

SHEET

S1.1

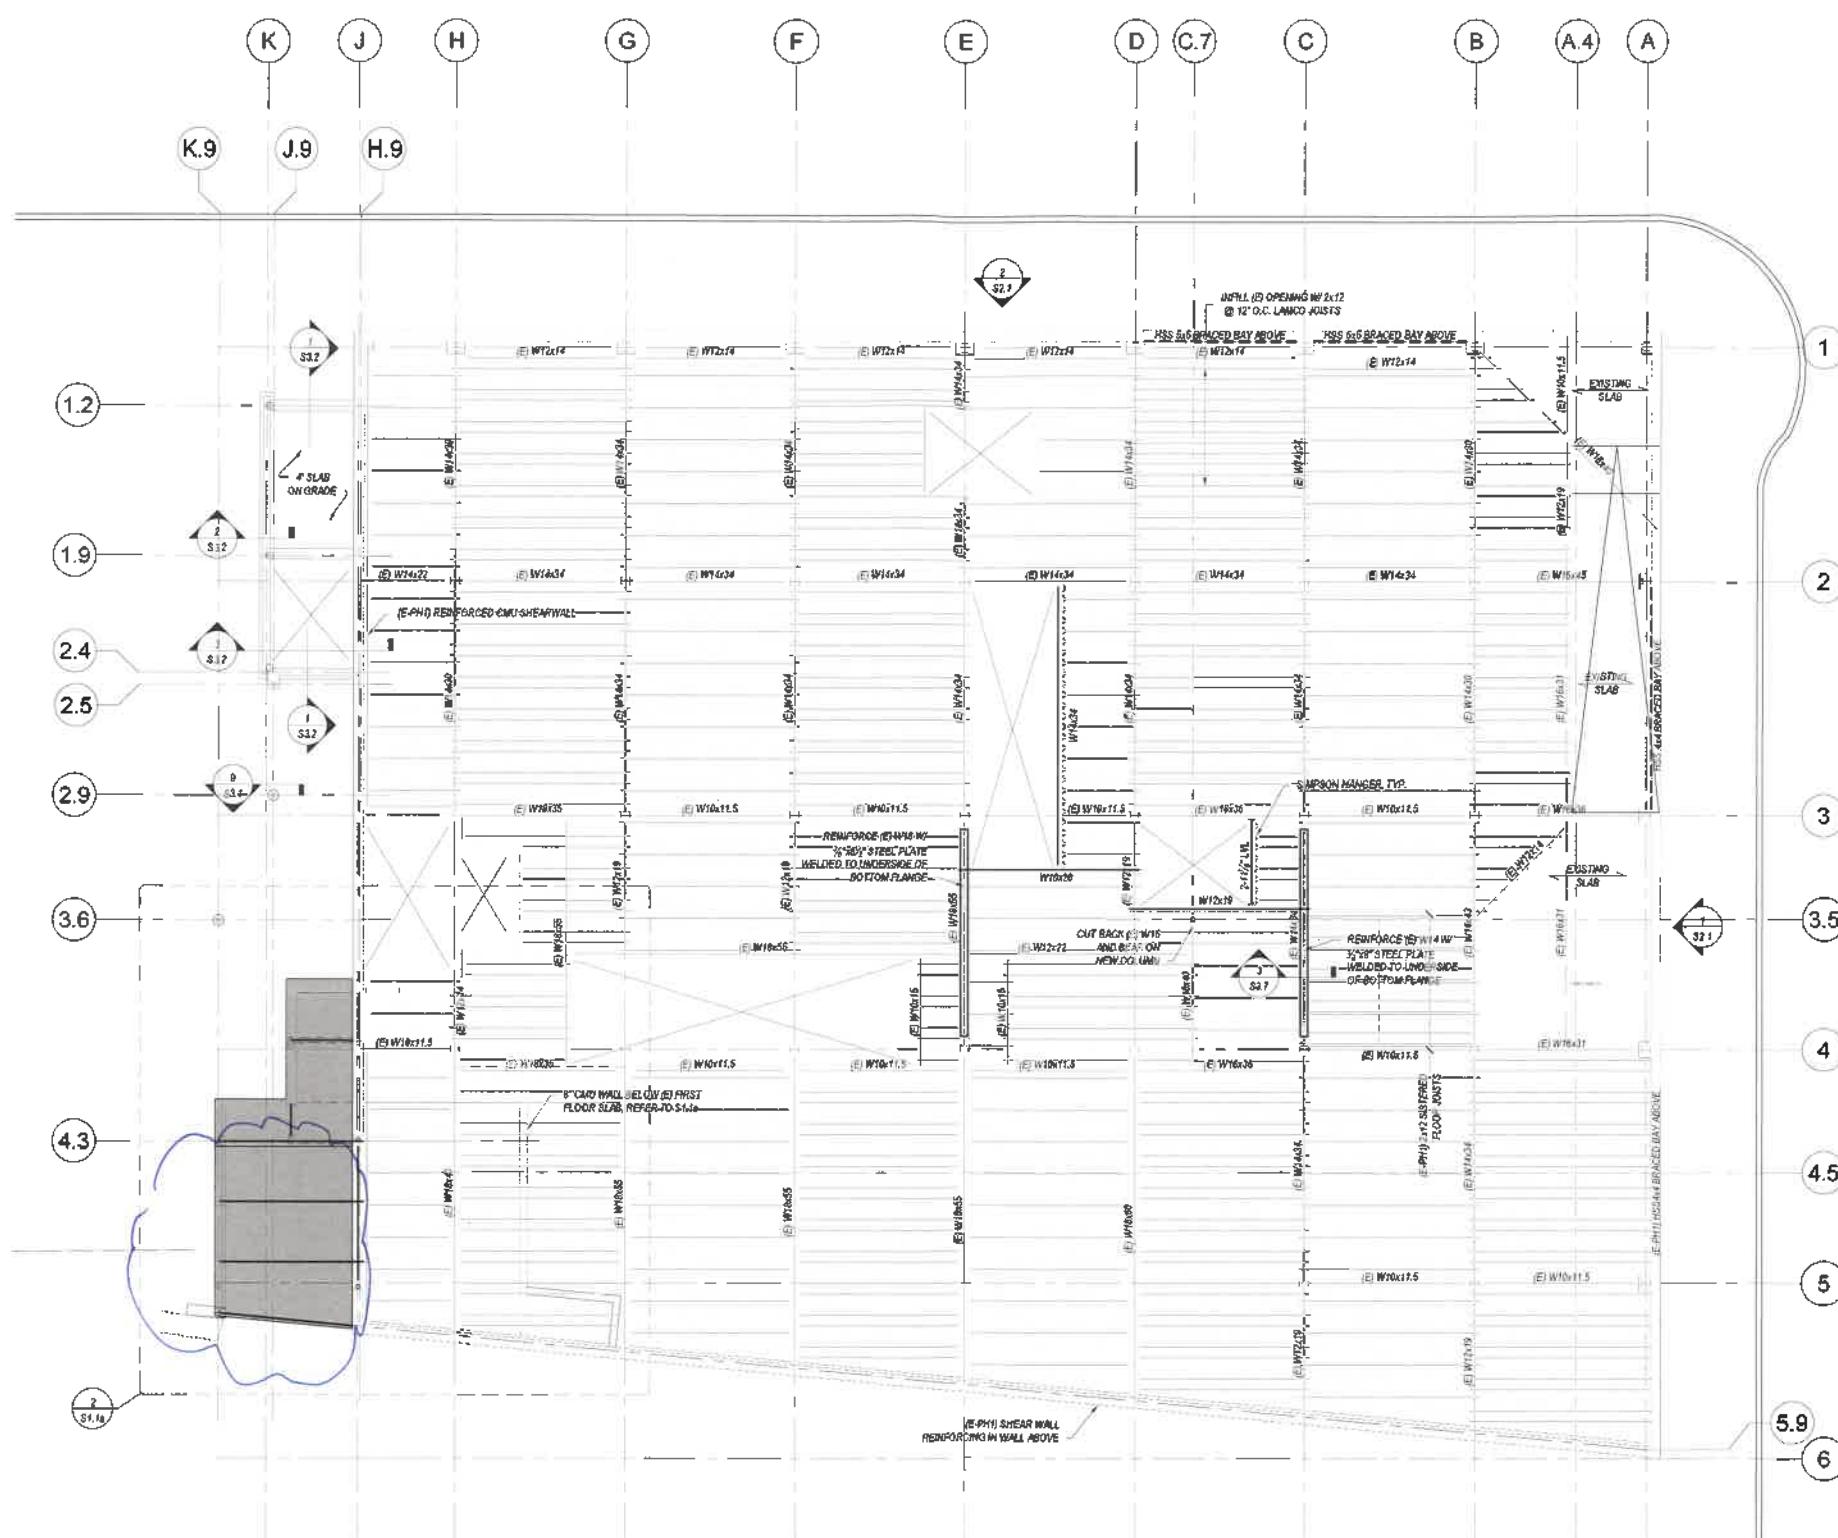

1 FIRST FLOOR FRAMING PLAN

NOTES: Scale: 1/8"-1'-0"

1. TOP OF FLOOR SHEARING IS 27'-6" X 11'-0".
2. TOP OF STRUCTURE IS 3 FEET ELEVATION 3'-0", UNLESS NOTED OTHERWISE.
3. "SLAB ON GRADE" DENOTES 4" SLAB ON GRADE WITH 8" CMU 40#I-14WPC.
4. "(E.P.H.)" DENOTES STRUCTURAL WORK COMPLETED DURING THE PHASE 1 PORTION OF THE PROJECT. REFER TO THE "PRELIMINARY STRUCTURAL WORK TO 57 JFK STREET" DRAWINGS DATED 11-17-2017.



**PETER
QUINN
ARCHI-
TECTS**

ARCHITECTURE
PLANNING
COMMUNITY DESIGN

PETER QUINN ARCHITECTS LLC
268 ELM STREET, SUITE 301
SOMERVILLE, MA 02144
PH 617-354-3989 FAX 617-858-0280



CONSULTANT

**SIEGEL
ASSOCIATES**

STRUCTURAL ENGINEERS
460 Waltham Street
Newton Center, MA 02459
617-244-1612 tel
617-244-1732 fax
www.siegelassociates.com

PROJECT

**ADDITION TO
57 JFK ST**

57 JFK STREET
CAMBRIDGE, MA

PREPARED FOR

CRIMSON GALERIA, LP

166 BEACON ST
BROOKLINE, MA 02446

DRAWING TITLE

**FOUNDATION
AND FIRST
FLOOR
FRAMING PLAN
DETAILS**

SCALE AS NOTED

REVISION / ISSUE DATE

PHASE 2 RE-PERMIT 12 FEB 2020

PHASE 2 CD SET 27 JUL 2018

PHASE 2 PERMIT 21 DEC 2017

REV PARTIAL PERMIT 8 DEC 2017



PARTIAL PERMIT 8 SEPT 2016

PRICING SET 23 FEB 2016

DRAWN BY REVIEWED BY
AJO

SHEET

S1.1a

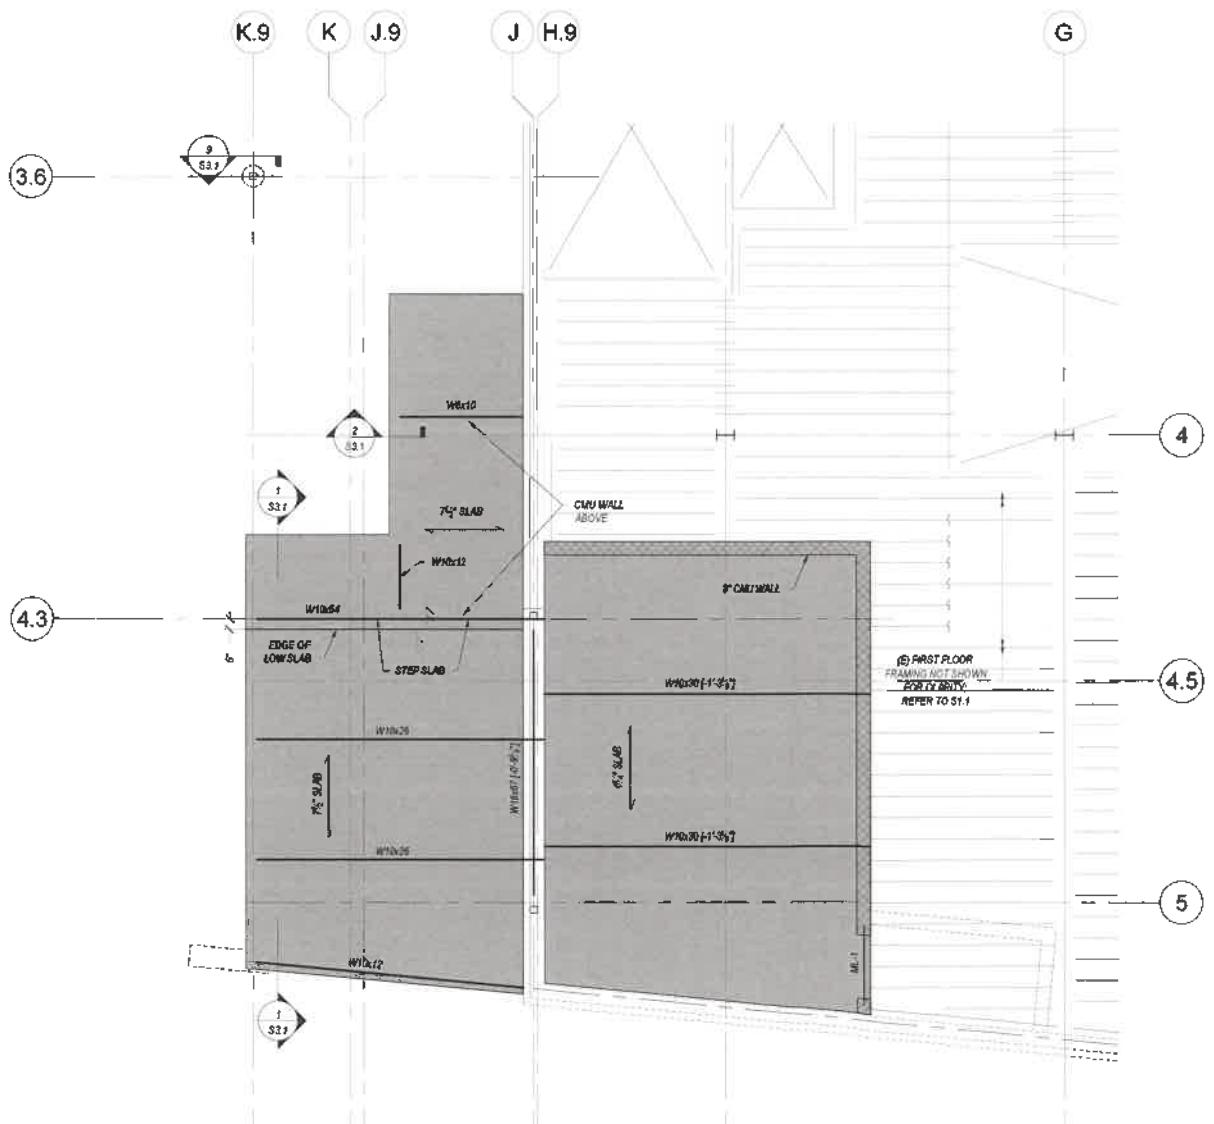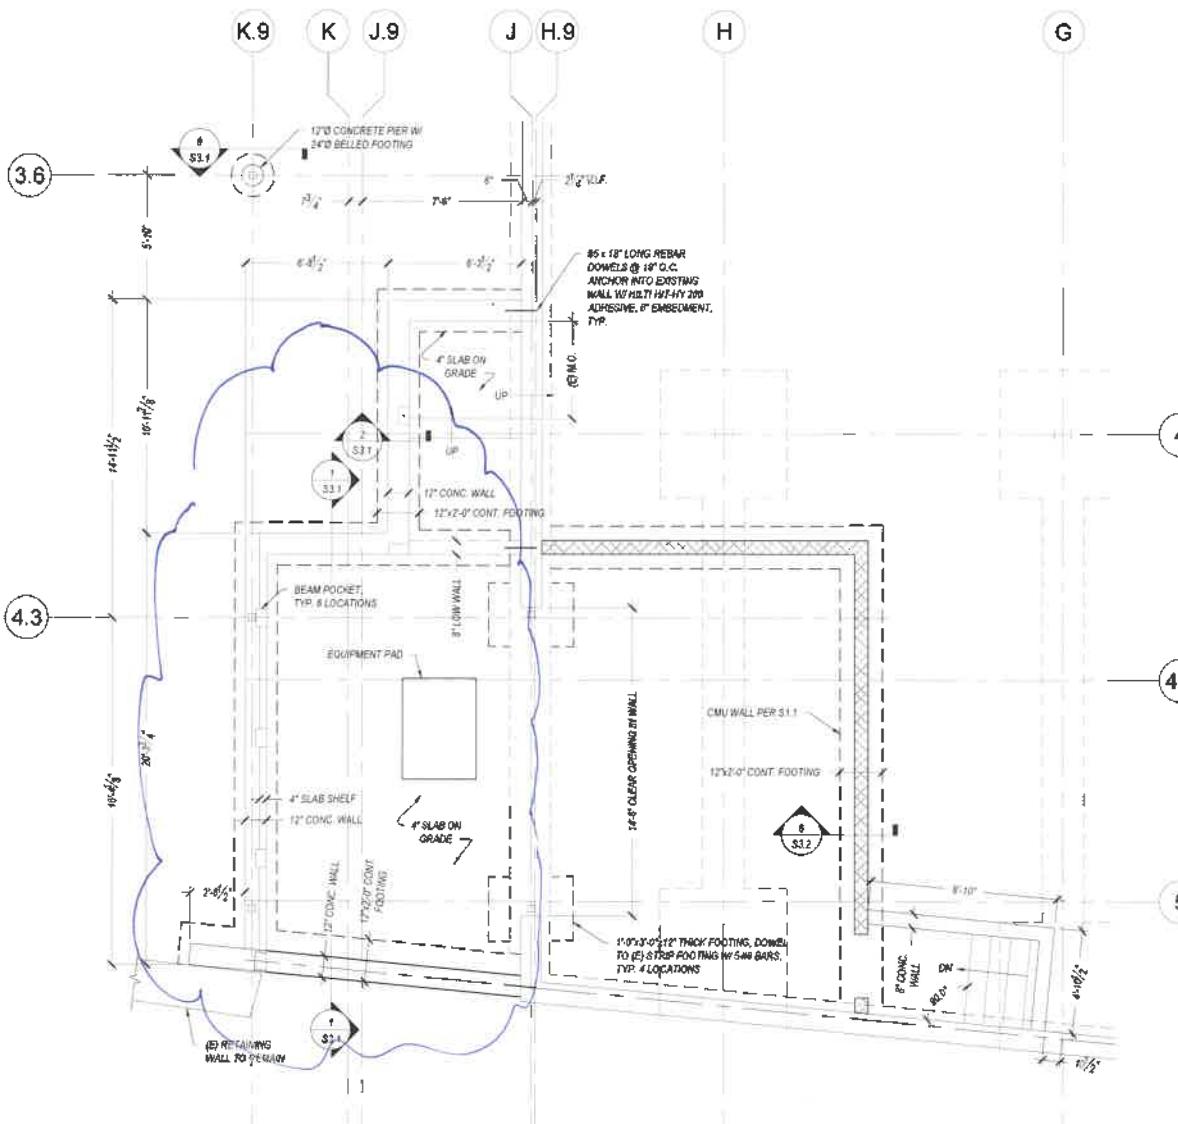

PETER QUINN ARCHITECTS

ARCHITECTURE
PLANNING
COMMUNITY DESIGN

PETER QUINN ARCHITECTS LLC
259 ELM STREET, SUITE 301
SOMERVILLE, MA 02144
PH 617-354-3989 FAX 617-868-0280



CONSULTANT
SIEGEL ASSOCIATES
STRUCTURAL ENGINEERS
260 WINDSOR STREET
NEWTON CENTER, MA 02459
617-284-1612 tel
617-284-1782 fax
www.siegalassociates.com

PROJECT
**ADDITION TO
57 JFK ST**

57 JFK STREET
CAMBRIDGE, MA



PREPARED FOR
CRIMSON GALERIA, LP

166 BEACON ST
BROOKLINE, MA 02446


DRAWINGS TITLE
FOUNDATION DETAILS

SCALE AS NOTED	
REVISION / ISSUE	DATE
PHASE 2 RE-PERMIT	12 FEB 2020
PHASE 2 CD SET	27 JUL 2018
PHASE 2 PERMIT	21 DEC 2017
REV PARTIAL PERMIT	8 DEC 2017
PARTIAL PERMIT	8 SEPT 2016
PRICING SET	23 FEB 2016
DRAWN BY	REVIEWED BY
AJO	

SHEET
S3.1

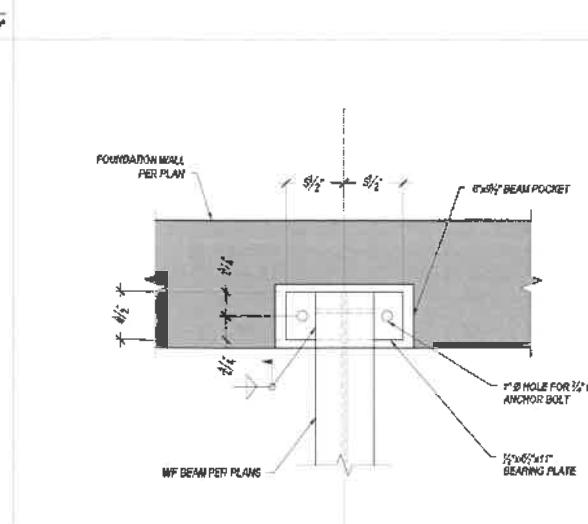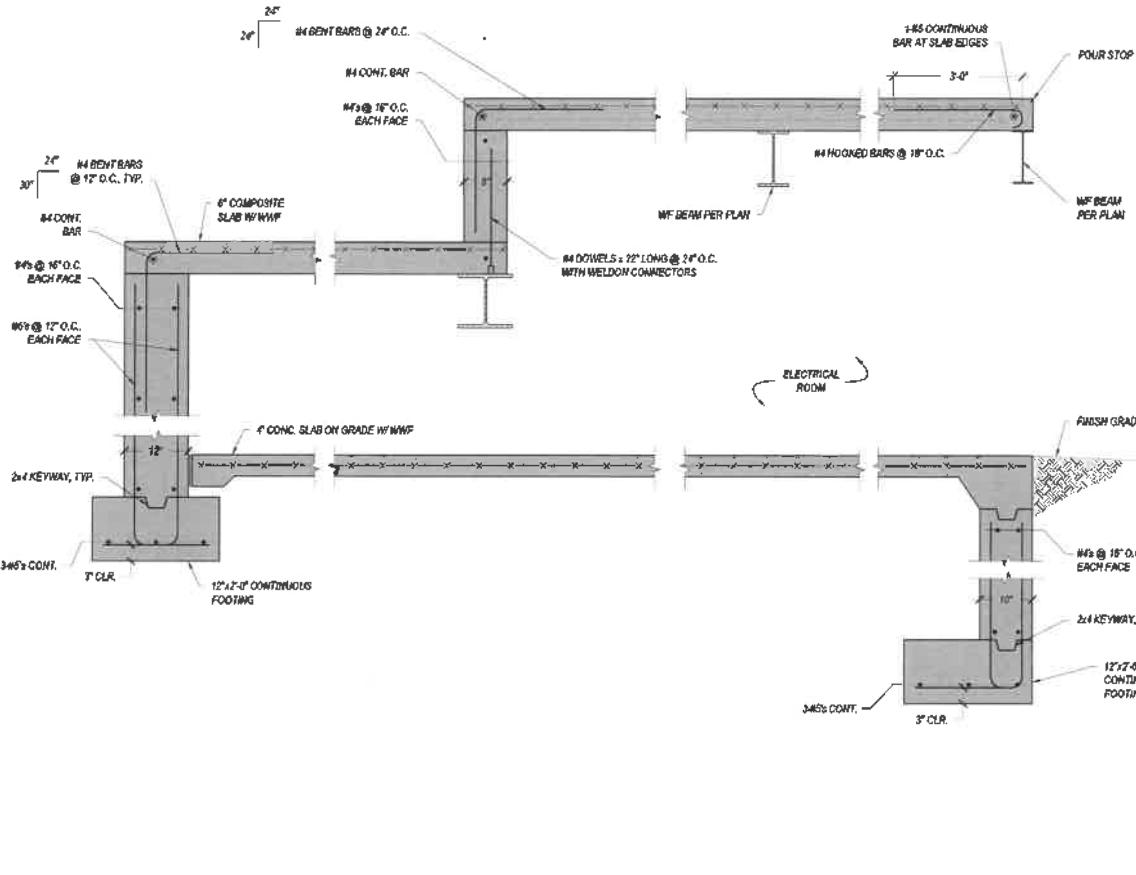

8 BEAM POCKET DETAIL

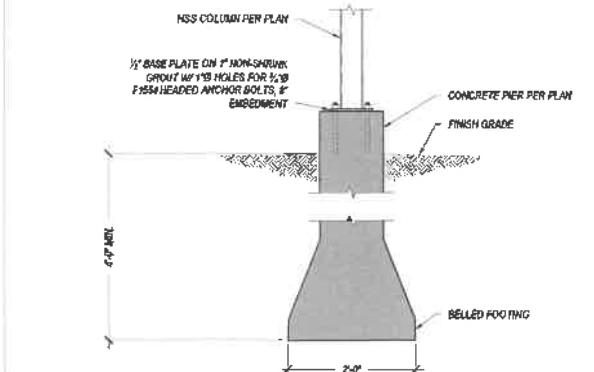

9 ISOLATED PIER ON BELLED FOOTING DETAIL

Scale: 1/2" = 1'-0"

2 BEAM POCKET SECTION

Scale: 3/4" = 1'-0"

Scale: 3/4" = 1'-0"