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Cover Letter

ADAMS & RAFFERTY

ATTORNEYS AT LAW
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July 1, 2022

Swaathi Joseph Project Planner Community Development Department 344 Broadway Cambridge, MA 02139

RE: Planning Board Case No. 344

24 Brattle Street Cambridge, MA

Dear Ms. Joseph:

As part of the ongoing design review condition contained in the above captioned Special Permit, attached please find elevations, plans, and narratives in support of proposed façade and storefront modifications.

I would request that this matter be placed on the General Business Agenda of the next available Planning Board hearing.

Please advise if any additional information is necessary in order to accommodate this request.

Thank you for your assistance.


very truly yours

James J. Rafferty


cc: Sam Stiebel, Vice President

Presentation

Ground Floor (Previously Approved 2/27/17)

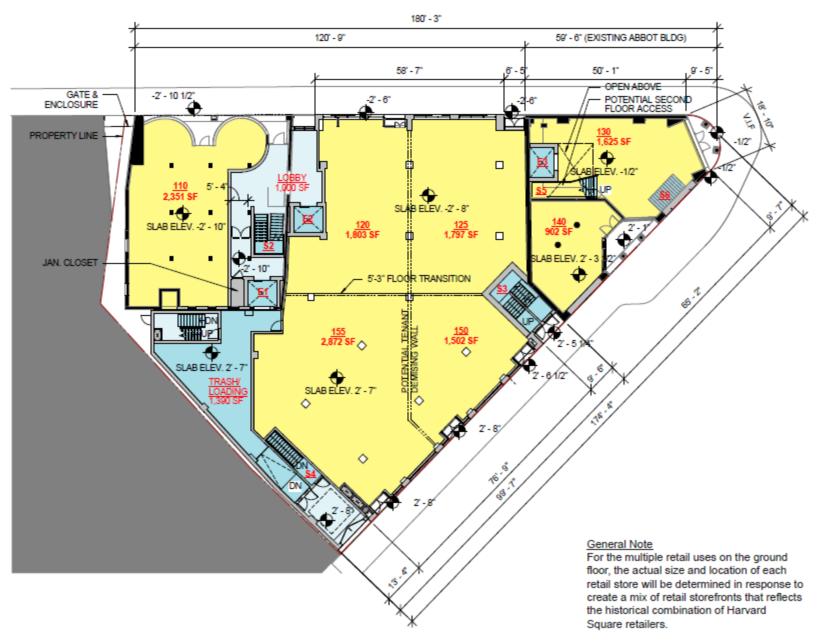

Ground Floor (Proposed)

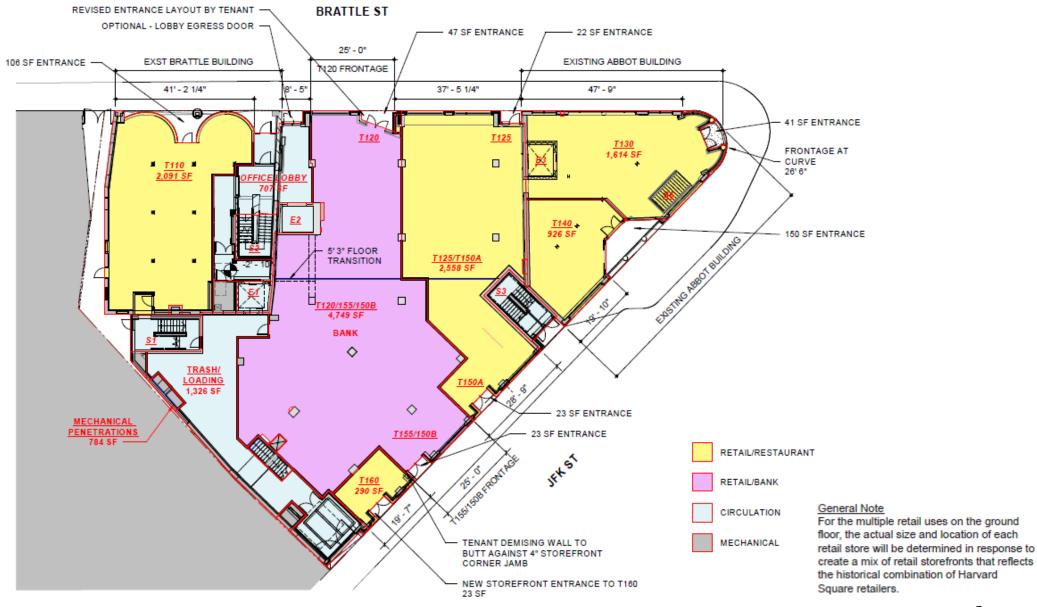

Bank Layout

The bank proposes two main points of entry into the space:

- Brattle Street
- JFK Street

Each entrance also acts as an ATM vestibule that only houses one ATM machine in each vestibule.

Brattle Street shows a throughthe-wall ATM & an after-hours depository & JFK shows a frontloading ATM (depicted below)








Note: All storefronts/vestibules will be clear glass on both streets and both entrances will be main entrances (example below)

Interior-facing view of a vestibule

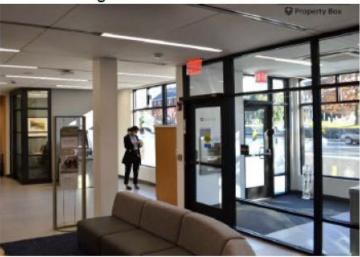

Exterior-facing view of a vestibule







Brattle with Signage







JFK with Signage



JFK Frontage – Bank and New Adjoining Retail Space (Illustrative)



Staff Comments and Responses

Staff Comments (Applicant Responses in Green)

revised to delete note on gyp. board.

Questions, coordination, and requests for additional information to be included in the submission to the Planning Board:

- 1. Elevations: Please provide enlarged exterior elevations with material notes. Please resolve the differences between the proposed elevations shown in "AbootSpecialPermitReview7122.pdf" and the interior elevations shown on sheet A601.
 - See sheet A2.1.0 For exterior elevations & Sheet A6.01 for interior elevations. Elevations have been updated with material notes. Abbot elevations have been revised to resolve the differences between the two elevations.
- 2. Material for new walls at the sides of the recessed shopfronts: Detail plans 5 and 6/A5.2.1 indicate: "Exterior finish to match existing exterior finish by landlord". The existing finish is stone. Will the new stone have drafted joints to match the existing stone on the jamb faces of the piers? Is sufficient allowance made for the thickness of the stone? The plans, 1 and 5/A6.01 label the material in these locations as Gyp Board, please coordinate. Sheet A5.2.1 has been revised to delete note on existing materials and instead to show brake metal connections where new storefront meets existing exterior walls. Sheet A6.01 has been
- 3. Kneewall below windows: 3/A5.2.1 shows "existing exterior wall", but there isn't an existing exterior wall in the new locations. Will the exterior side of the new kneewalls match the kneewalls elsewhere on the building?
 - New kneewalls to match existing kneewalls elsewhere on the building. Detail 3/A5.2.1 has been revised to better match existing kneewalls of the rest of the building.
- 4. Paving in recessed entries: Section 7/A5.2.1 shows "to match existing tile by landlord". Section 4/A5.2.1 shows concrete, but there is tile in the existing recesses. Please coordinate. Detail 4/A5.2.1 has been revised to show tile to match existing tile in existing recess.
- 5. The demolition plan for the JFK Street vestibule (D1.1.1A) shows the demolition of the corner of the small retail space south of the bank entrance. Plan 1/A6.01 shows a solid wall perpendicular to the street and doesn't show what material will face the sidewalk. The rendering shows a whitish opaque material. Please coordinate. Staff recommend transparent glass on both the street facing and perpendicular-to-the-street sides of the retail space at this corner. Perpendicular wall has been changed to a storefront on kneewall to match the storefront of the rest of the building. Abbot elevations have been revised to show storefront to match CSG elevations.
- 6. Will there be exterior lighting, for example soffit lighting above the recessed entry areas? There will be new exterior soffits with exterior lighting & access panels to service the exterior lights. Refer to details 7A & 7B on sheet A5.2.1 for more information.
- 7. Where will the motorized shades shown on 17/A5.2.1 be located? If they are in the street-facing shopfronts, add them to the section 7/A5.2.1. Will their housing enclosures be recessed into the ceiling?
 - Motorized shades will not be part of scope for this project. Detail 17/A5.2.1 has been removed from the project.
- 8. Interiors of the vestibules: What colors of paint will be used? Will there be branding material in addition to the ATMs themselves?
 - Paint Colors & Specifications are located on Sheet A3.3.2. Paint used in Vestibules to be PT-500: Sherwin Williams CC-40 "Cloud White". Wallcovering at eATM & Thru-Wall ATM walls to be WC-

- 402: Momentum Textiles Recore Baccarat #NA-4C-JPM501 "Basalt". Wood finish at Octagonal Signage for the 24-Hour Vestibule facing JFK Street to be WD-502: Pioneer Millworks Modern Farmhouse "Clean Ash" (Raked finish). There will be a 48" Octagonal signage to be installed per sheet A6.01. Refer to separate Signage Brand Book.
- 9. Will there be any vinyl appliques on the windows or other materials that will obscure views into the interior from the sidewalk?
 - No vinyl window decals are planned for either storefront of the 24-hour Vestibules.

Advisory Comments and Suggestions:

- 1. A large vestibule is proposed on JFK Street. In addition to the pedestrian passage area between the outer and the inner doors at its southern end, the vestibule has a space about 12' x 15' at its northern end, which is indicated as containing only a free-standing ATM. What will that space look like? Should the doors be moved to the northern end of the three bays facing JFK Street that are controlled by the Bank tenant, thereby increasing the size of the retail space, allowing a through-the-wall ATM (instead of free-standing) on the south side of the vestibule, and aligning people entering the doors with the bank lobby's circulation space instead of with its seating area?
 - Refer to sheet A6.01 for what the proposed vestibules will look like. The exterior sidewalk slopes down as it runs north and will create an accessibility issue if the doors were moved north along the JFK Street side.
- 2. Awnings: More modest awnings with colors selected for compatibility with the building rather than for branding would make a more positive contribution to the streetscape. Staff suggests that consideration be given to utilizing retractable awnings rather than rigid ones. Awnings to be changed to a black color to better match the existing canopies & surroundings of the area. Due to concerns with snow loads and weather we suggest keeping awnings as rigid.
- 3. When installing the new shopfronts, it would be preferable to use the small round weepholes typical on the JFK Street side of the building, instead of the wide horizontal ones typical on the Brattle Street side.
 - Small weepholes will be used for the storefronts on the JFK Street side of the building.
- 4. Note that signage will be reviewed separately.

Plans



JP MORGAN CHASE, N.A.

HARVARD SQUARE

9 JFK STREET

CAMBRIDGE, MA 02138 CHASE OVP#38100P322595

PERMIT SET - 2021.07.15

PROJECT DIRECTORY

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CLIENT REPRESENTATIVE JONES LANG LASALLE PHONE: 386.225.0177 CONTACT: LAUREN GILBERT

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LOCATION MAP

KEY PLAN

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PLUMBING ENGINEER

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FIRE SPRINKLER

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CODE INFORMATION

CITY OF CAMBRIDGE INSPECTIONAL SERVICES DEPARTMENT 831 MASSACHUSETTS AVENUE CAMBRIDGE, MA 02139

PHONE: 617-349-6100

INTERNATIONAL BUILDING CODE 2015 EDITION W/ 780 CMR MA AMENDMENTS INTERNATIONAL EXISTING BUILDING CODE 2015 EDITION

UNIFORM STATE PLUMBING CODE W/ 248 CMR 10.00 INTERNATIONAL MECHANICAL CODE 2015 EDITION W/ 527 CMR MA AMENDMENTS

INTERNATIONAL FUEL GAS CODE 2015 EDITION W/ MA AMENDEMENTS INTERNATIONAL ENERGY CONSERVATION CODE 2018 EDITION W/ 780 CMR 13 & 51 MA AMENDMENTS INTERNATIONAL FIRE CODE 2015 EDITION & ANY REFERENCE TO NFPA W/ 527 CMR 1.00 AMENDMENTS

NATIONAL ELECTRICAL CODE 2017 EDITION; NFPA-70 W/ 527 CMR 1200 MA AMENDMENTS INTERNATIONAL PERFORMANCE CODE 2015 EDITION INTERNATIONAL WILDLAND - URBAN INTERFACE CODE 2015 ACCESSIBILITY/2015 INTERNATIONAL BUILDING CODE CHAPTER 11 AND 521 CMR - MA ACCESSIBILITY REGULATIONS

TENANT FIT-IN OF A NEW COMMERCIAL BANKING CENTER. THE SCOPE INCLUDES ARCHITECTURAL, STRUCTURAL, MECHANICAL, PLUMBING, ELECTRICAL, AND FIRE PROTECTION.

ENERGY CODE COMPLIANCE CHART

CLIMATE ZONE 6B - IECC 2018 WITH 2020 MA AMENDMENTS	
OPAQUE THERMAL ENVELOPE REQUIREMENTS	R-VALUE
ROOF - INSULATION ENTIRELY ABOVE DECK	N/A
ATTIC & OTHER	N/A

ROOF - INSULATION ENTIRELY ABOVE DECK	N/A
ATTIC & OTHER	N/A
WALL ABOVE GRADE - METAL FRAMED	R-13 + R-11ci
SLAB ON GRADE FLOORS	R-15 FOR 24" BELOW
BUILDING ENVELOPE REQUIREMENTS: FENESTRATION	<u>U-VALUE</u>
FIXED FENESTRATION	0.36
ENTRANCE DOORS	0.77
SHGC	0.38

FIRE-RESISTANCE RATING REQUIREMENTS

PER 2018 IBC TABLE 601 - CONSTRUCTION TYPE II-B

REQUIRED BEARING WALLS EXTERIOR / INTERIOR 0 HR

REQUIRED NONBEARING WALLS EXTERIOR / INTERIOR 0 HR


REQUIRED PRIMARY STRUCTURAL FRAME

REQUIRED FLOOR CONSTRUCTION



REQUIRED ROOF CONSTRUCTION

FLAME SPREAD DATA

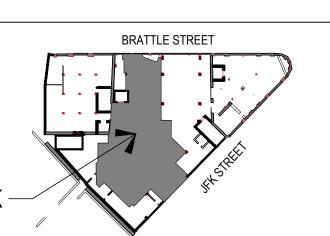

SECURITY ALARM

LOW VOLTAGE

SEPARATE SUBMITTALS

GC SHALL OBTAIN PERMITS LISTED BELOW PRIOR TO INSTALLATION PER LOCAL JURISDICTION REQUIREMENTS. SIGNAGE PACKAGE 4. SITE/CIVIL PACKAGE

PROJECT DATA

CLASSIFICATION OF WORK	TENANT FIT-IN OF NEWLY E	TENANT FIT-IN OF NEWLY BUILT SPACE	
SQUARE FOOTAGE	4,990 GSF	4,990 GSF	
OCCUPANCY CLASSIFICATION	BUSINESS GROUP B		
OCCUPANCY LOAD			
OCCUPANCY LOAD PER CLASSIFICATION:	100 GROSS SF		
4,990 GSF / 100 GSF = 50 OCCUPANTS	50 = TOTAL OCCUPANTS		
	•		
CONSTRUCTION TYPE	II-B		
SPRINKLERED	REQUIRED	REQUIRED	
FIRE ALARM	REQUIRED	REQUIRED	
EGRESS WIDTH:	REQUIRED	PROVIDED	
OCCUPANTS x (0.2 - OTHER EGRESS COMPONENTS)			
50 x 0.2" = 10.0" WIDTH REQUIRED	10"	136"	
	<u>.</u>		
EXITS AND EXIT ACCESS DOORWAYS			
EXITS			
DOOR WIDTH			
COMMON PATH OF TRAVEL	SEE LIFE SAFE	TY PLAN A1.1.0	

NEW RETAIL BANKING CENTER

EXITS AND EXIT ACCESS DOORWAYS	
EXITS	
DOOR WIDTH	
COMMON PATH OF TRAVEL	SEE LIFE SAFETY PLAN A1.1
EXIT ACCESS TRAVEL DISTANCE	
DEAD END CORRIDORS	
PLUMBING FIXTURES	

PUBLIC FLOOR AREA / 100 GSF		
4,990 GSF / 100 = 50 OCCUPANTS	= 50 TOTAL OCCUPANTS	
URES (PER 248 CMR 10.00 TABLE 1)	REQUIRED	PROVIDED
WATER CLOSETS - MEN / WOMEN (1 PER 25/20)	1/2	1 / 1 / 1 (UNISEX)
LAVATORIES - MEN / WOMEN (1 PER 50)	1	1/1
DRINKING FOUNTAIN (1 PER FLOOR)	1	1 LOW + 1 BOTTLE FILLER

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W/O REVISION O

ARCHITECTURAL

UL LISTING

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INTERIOR STAIRS AND ADA LIFT DETAILS

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FURNITURE & EQUIPMENT PLAN FURNITURE & EQUIPMENT PLAN

REFLECTED CEILING PLAN

WALL TYPES, FLOOR TYPES, ROOF TYPES

DETAILS: WALL OPENINGS & INTERIOR DETAILS

TRANSACTION VESTIBULE: INTERIOR ELEVATIONS

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DETAILS: ATM

STRUCTURAL

MECHANICAL

DETAILS: CABINETRY

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MECHANICAL FLOOR PLAN

MECHANICAL PIPING PLAN

MECHANICAL SCHEDULES

SECOND-FLOOR SUPPORT PLAN

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PLUMBING ABBREVIATION, LEGENDS & NOTES

PLUMBING SANITARY, STORM, & VENT PLAN

PLUMBING SANITARY, STORM, & VENT PLAN

BUILDING MANAGEMENT SYSTEM DETAILS

LIGHTING SCHEDULE AND ELECTRICAL DETAILS

PLUMBING DOMESTIC WATER PLAN

PLUMBING RISER DIAGRAMS

LIGHTING PLAN POWER PLAN

SYSTEMS PLAN

SYSTEMS PLAN

FIRE ALARM PLAN FIRE ALARM PLAN

FIRE SPRINKLER

UNDERGROUND CONDUIT PLAN

ENLARGED PLAN AND ELEVATIONS

POWER DETAILS AND SCHEDULES

FIRE SPRINKLER GENERAL NOTES

FIRE SPRINKLER PLAN FIRE SPRINKLER PLAN CONT.

GENERAL NOTES, RESPONSIBILITY SCHEDULE, DRAWING CONVENTIONS, & ABBREVIATIONS

INTERIOR FINISH SCHEDULE, FLOOR TRANSITION TYPES & FINISHES SCHEDULE VENDOR CONTACTS

APPLIANCE SCHEDULE, RESTROOM ACCESSORIES, ELECTRICAL DEVICES FINISHES

MAIN BANKING FLOOR: INTERIOR ELEVATIONS AND MARKETING POSITIONING DETAILS

PRIVATE CONSULATION SPACE, CASUAL MEETING SPACE, CONFERENCE ROOM: INTERIOR ELEVATIONS

INTERIOR THROUGH-WALL WALK-UP ATM & AFTER-HOURS DEPOSITORY

CASH / ATM EQUIP ROOM: ENLARGED PLANS AND INTERIOR ELEVATIONS

RESTROOM AND JANITOR: ENLARGED PLANS AND INTERIOR ELEVATIONS

LOUNGE, FILE, AND PRINTER ROOM: ENLARGED PLANS AND INTERIOR ELEVATIONS

MANUAL TRANSACTION: ENLARGED PLAN, INTERIOR ELEVATIONS, AND DETAILS

CAFE AND BOOTH: ENLARGED PLANS, ELEVATIONS, AND DETAILS

DETAILS: DEMOUNTABLE PARTITIONS, CEILING TRANSITIONS

OFFICE EQUIPMENT BY PROGRAMMATIC ELEMENT, OFFICE EQUIPMENT SCHEDULE, MISCELLANEOUS EQUIPMENT SCHEDULE

	E1.0
	E1.1
	E2.0
	E2.1
PROVIDED	E3.0
TROVIDED	E3.1
1 / 1 / 1 (UNISEX)	E4.0
1/1	E5.0
1 LOW + 1 BOTTLE FILLER	E6.0
1	FA1.0
	E A 4 4

PROJECT SPECIFIC ITEMS

SERVICE SINK (1 PER FLOOR)

SECURITY ENAHNCEMENTS: DATE OF DRC ISSUED: INCLUDES RETAIL DESIGN COMMUNICATION UP TO: RDC-20-014 DATED 12/16/2020 REMOTE DRIVE-UP ATM:

DRAWING ISSUE



ARCHITECT OF RECORD

JAMES T. LALLI, AIA, ARCHITECT LICENSE NO. 32254

HESE DRAWINGS ARE NOT COMPLETE WITHOUT THE SEPARATE TYPE WRITTEN SPECIFICATIONS MANUAL WHICH ARE PART OF THE CONTRACT DOCUMENTS.


> DESCRIPTION 2022.07.15 PERMIT SET

PROJECT INFORMATION PROJECT NO:

2022.07.15 PROTOTYPE: K.KELLY DRAWN BY: M.SIDES CHECKED BY: VERSION: SSE_1.00 SHEET TITLE

COVER SHEET

SHEET NUMBER

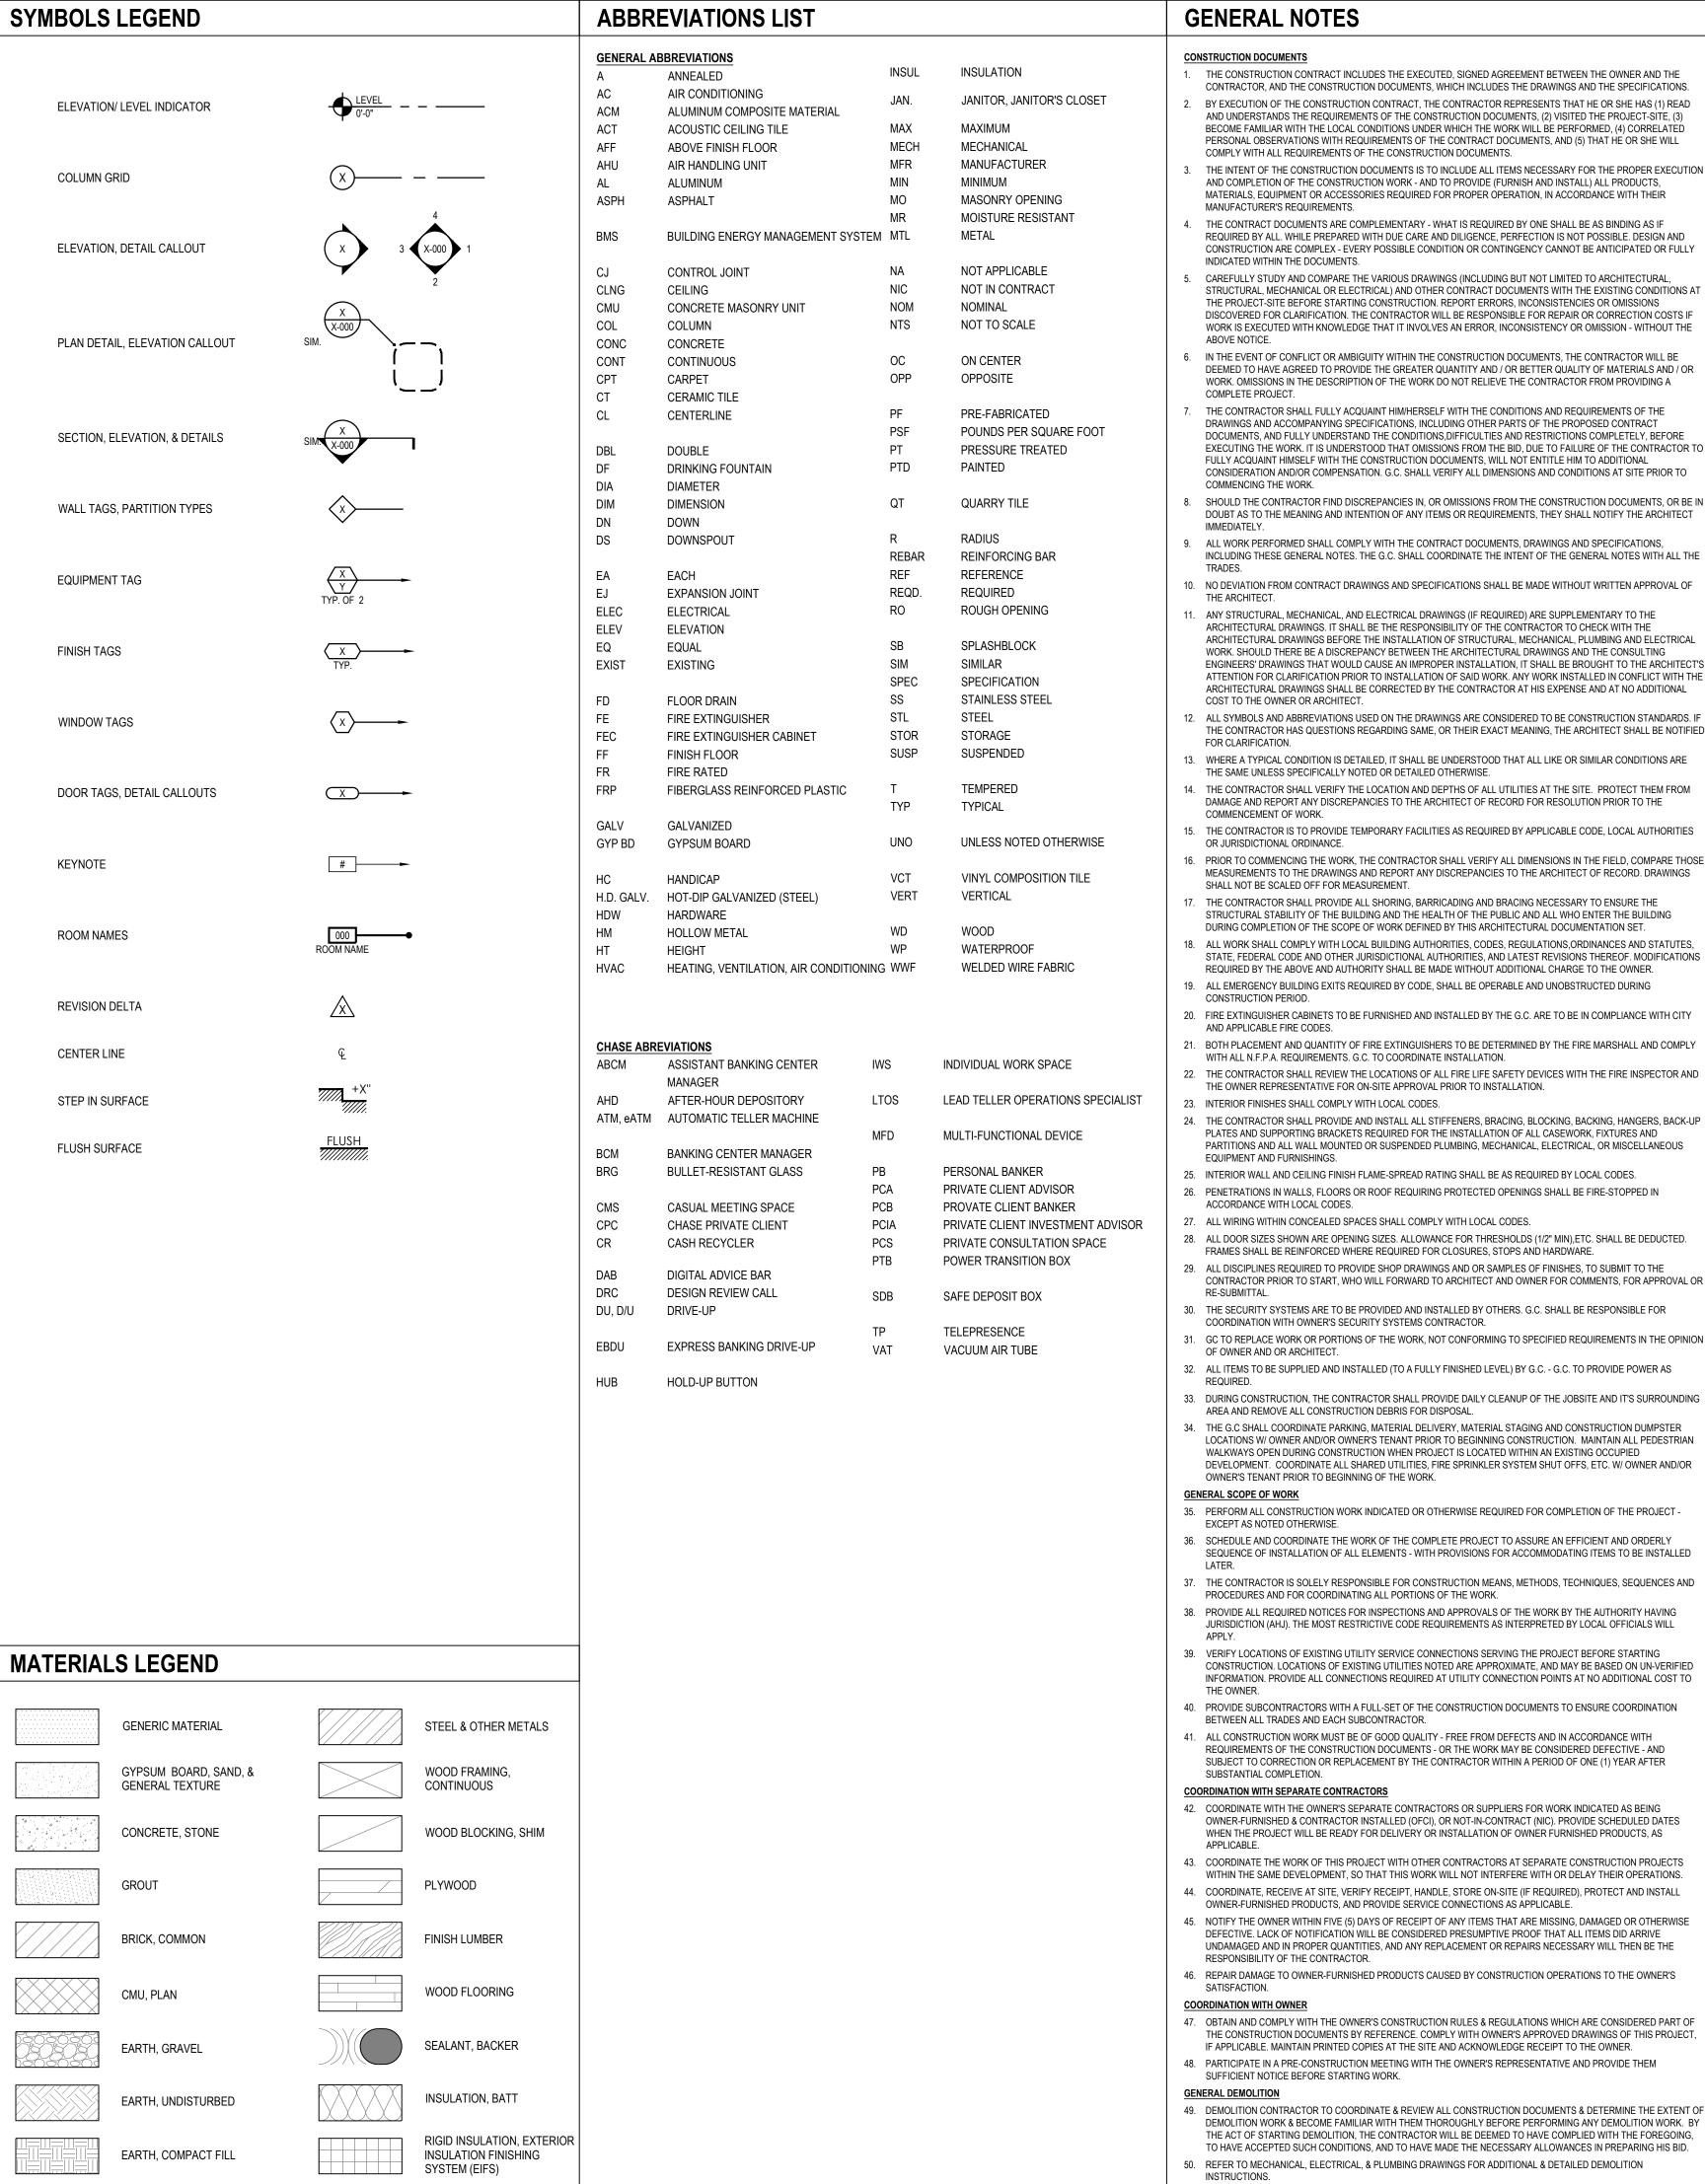

GENERAL NOTES

- THE CONSTRUCTION CONTRACT INCLUDES THE EXECUTED, SIGNED AGREEMENT BETWEEN THE OWNER AND THE CONTRACTOR, AND THE CONSTRUCTION DOCUMENTS, WHICH INCLUDES THE DRAWINGS AND THE SPECIFICATIONS BY EXECUTION OF THE CONSTRUCTION CONTRACT, THE CONTRACTOR REPRESENTS THAT HE OR SHE HAS (1) READ AND UNDERSTANDS THE REQUIREMENTS OF THE CONSTRUCTION DOCUMENTS. (2) VISITED THE PROJECT-SITE. (3) BECOME FAMILIAR WITH THE LOCAL CONDITIONS LINDER WHICH THE WORK WILL BE PERFORMED. (4) CORRELATED.
- COMPLY WITH ALL REQUIREMENTS OF THE CONSTRUCTION DOCUMENTS. THE INTENT OF THE CONSTRUCTION DOCUMENTS IS TO INCLUDE ALL ITEMS NECESSARY FOR THE PROPER EXECUTION AND COMPLETION OF THE CONSTRUCTION WORK - AND TO PROVIDE (FURNISH AND INSTALL) ALL PRODUCTS, MATERIALS, EQUIPMENT OR ACCESSORIES REQUIRED FOR PROPER OPERATION, IN ACCORDANCE WITH THEIR

PERSONAL OBSERVATIONS WITH REQUIREMENTS OF THE CONTRACT DOCUMENTS, AND (5) THAT HE OR SHE WILL

- MANUFACTURER'S REQUIREMENTS THE CONTRACT DOCUMENTS ARE COMPLEMENTARY - WHAT IS REQUIRED BY ONE SHALL BE AS BINDING AS IF REQUIRED BY ALL. WHILE PREPARED WITH DUE CARE AND DILIGENCE, PERFECTION IS NOT POSSIBLE. DESIGN AND CONSTRUCTION ARE COMPLEX - EVERY POSSIBLE CONDITION OR CONTINGENCY CANNOT BE ANTICIPATED OR FULLY
- INDICATED WITHIN THE DOCUMENTS. CARFFULLY STUDY AND COMPARE THE VARIOUS DRAWINGS (INCLUDING BUT NOT LIMITED TO ARCHITECTURAL STRUCTURAL. MECHANICAL OR ELECTRICAL) AND OTHER CONTRACT DOCUMENTS WITH THE EXISTING CONDITIONS AT THE PROJECT-SITE BEFORE STARTING CONSTRUCTION, REPORT ERRORS, INCONSISTENCIES OR OMISSIONS DISCOVERED FOR CLARIFICATION. THE CONTRACTOR WILL BE RESPONSIBLE FOR REPAIR OR CORRECTION COSTS IF
- IN THE EVENT OF CONFLICT OR AMBIGUITY WITHIN THE CONSTRUCTION DOCUMENTS. THE CONTRACTOR WILL BE DEFMED TO HAVE AGREED TO PROVIDE THE GREATER QUANTITY AND / OR BETTER QUALITY OF MATERIALS AND / OR WORK. OMISSIONS IN THE DESCRIPTION OF THE WORK DO NOT RELIEVE THE CONTRACTOR FROM PROVIDING A

WORK IS EXECUTED WITH KNOWLEDGE THAT IT INVOLVES AN ERROR, INCONSISTENCY OR OMISSION - WITHOUT THE

- THE CONTRACTOR SHALL FULLY ACQUAINT HIM/HERSELF WITH THE CONDITIONS AND REQUIREMENTS OF THE DRAWINGS AND ACCOMPANYING SPECIFICATIONS, INCLUDING OTHER PARTS OF THE PROPOSED CONTRACT DOCUMENTS, AND FULLY UNDERSTAND THE CONDITIONS DIFFICULTIES AND RESTRICTIONS COMPLETELY, BEFORE EXECUTING THE WORK. IT IS UNDERSTOOD THAT OMISSIONS FROM THE BID. DUE TO FAILURE OF THE CONTRACTOR TO FULLY ACQUAINT HIMSELF WITH THE CONSTRUCTION DOCUMENTS. WILL NOT ENTITLE HIM TO ADDITIONAL CONSIDERATION AND/OR COMPENSATION. G.C. SHALL VERIFY ALL DIMENSIONS AND CONDITIONS AT SITE PRIOR TO
- COMMENCING THE WORK. SHOULD THE CONTRACTOR FIND DISCREPANCIES IN, OR OMISSIONS FROM THE CONSTRUCTION DOCUMENTS, OR BE IN DOUBT AS TO THE MEANING AND INTENTION OF ANY ITEMS OR REQUIREMENTS. THEY SHALL NOTIFY THE ARCHITECT
- ALL WORK PERFORMED SHALL COMPLY WITH THE CONTRACT DOCUMENTS, DRAWINGS AND SPECIFICATIONS, INCLUDING THESE GENERAL NOTES. THE G.C. SHALL COORDINATE THE INTENT OF THE GENERAL NOTES WITH ALL THE
- NO DEVIATION FROM CONTRACT DRAWINGS AND SPECIFICATIONS SHALL BE MADE WITHOUT WRITTEN APPROVAL OF THE ARCHITECT.
- ANY STRUCTURAL, MECHANICAL, AND ELECTRICAL DRAWINGS (IF REQUIRED) ARE SUPPLEMENTARY TO THE ARCHITECTURAL DRAWINGS. IT SHALL BE THE RESPONSIBILITY OF THE CONTRACTOR TO CHECK WITH THE ARCHITECTURAL DRAWINGS BEFORE THE INSTALLATION OF STRUCTURAL, MECHANICAL, PLUMBING AND ELECTRICAL WORK. SHOULD THERE BE A DISCREPANCY BETWEEN THE ARCHITECTURAL DRAWINGS AND THE CONSULTING ENGINEERS' DRAWINGS THAT WOULD CAUSE AN IMPROPER INSTALLATION IT SHALL BE BROUGHT TO THE ARCHITECT'S ATTENTION FOR CLARIFICATION PRIOR TO INSTALLATION OF SAID WORK, ANY WORK INSTALLED IN CONFLICT WITH THE ARCHITECTURAL DRAWINGS SHALL BE CORRECTED BY THE CONTRACTOR AT HIS EXPENSE AND AT NO ADDITIONAL COST TO THE OWNER OR ARCHITECT
- ALL SYMBOLS AND ABBREVIATIONS USED ON THE DRAWINGS ARE CONSIDERED TO BE CONSTRUCTION STANDARDS. IF THE CONTRACTOR HAS QUESTIONS REGARDING SAME, OR THEIR EXACT MEANING, THE ARCHITECT SHALL BE NOTIFIED
- . WHERE A TYPICAL CONDITION IS DETAILED, IT SHALL BE UNDERSTOOD THAT ALL LIKE OR SIMILAR CONDITIONS ARE THE SAME UNLESS SPECIFICALLY NOTED OR DETAILED OTHERWISE
- 4. THE CONTRACTOR SHALL VERIFY THE LOCATION AND DEPTHS OF ALL UTILITIES AT THE SITE. PROTECT THEM FROM DAMAGE AND REPORT ANY DISCREPANCIES TO THE ARCHITECT OF RECORD FOR RESOLUTION PRIOR TO THE COMMENCEMENT OF WORK.
- 15. THE CONTRACTOR IS TO PROVIDE TEMPORARY FACILITIES AS REQUIRED BY APPLICABLE CODE, LOCAL AUTHORITIES OR JURISDICTIONAL ORDINANCE. PRIOR TO COMMENCING THE WORK, THE CONTRACTOR SHALL VERIFY ALL DIMENSIONS IN THE FIELD, COMPARE THOSE
- MEASUREMENTS TO THE DRAWINGS AND REPORT ANY DISCREPANCIES TO THE ARCHITECT OF RECORD. DRAWINGS SHALL NOT BE SCALED OFF FOR MEASUREMENT THE CONTRACTOR SHALL PROVIDE ALL SHORING, BARRICADING AND BRACING NECESSARY TO ENSURE THE
- STRUCTURAL STABILITY OF THE BUILDING AND THE HEALTH OF THE PUBLIC AND ALL WHO ENTER THE BUILDING DURING COMPLETION OF THE SCOPE OF WORK DEFINED BY THIS ARCHITECTURAL DOCUMENTATION SET ALL WORK SHALL COMPLY WITH LOCAL BUILDING AUTHORITIES, CODES, REGULATIONS, ORDINANCES AND STATUTES,
- STATE. FEDERAL CODE AND OTHER JURISDICTIONAL AUTHORITIES, AND LATEST REVISIONS THEREOF. MODIFICATIONS REQUIRED BY THE ABOVE AND AUTHORITY SHALL BE MADE WITHOUT ADDITIONAL CHARGE TO THE OWNER. ALL EMERGENCY BUILDING EXITS REQUIRED BY CODE, SHALL BE OPERABLE AND UNOBSTRUCTED DURING CONSTRUCTION PERIOD
- 0. FIRE EXTINGUISHER CABINETS TO BE FURNISHED AND INSTALLED BY THE G.C. ARE TO BE IN COMPLIANCE WITH CITY AND APPLICABLE FIRE CODES
- 1. BOTH PLACEMENT AND QUANTITY OF FIRE EXTINGUISHERS TO BE DETERMINED BY THE FIRE MARSHALL AND COMPLY WITH ALL N.F.P.A. REQUIREMENTS. G.C. TO COORDINATE INSTALLATION.
- 23. INTERIOR FINISHES SHALL COMPLY WITH LOCAL CODES. 24. THE CONTRACTOR SHALL PROVIDE AND INSTALL ALL STIFFENERS, BRACING, BLOCKING, BACKING, HANGERS, BACK-UP
- PLATES AND SUPPORTING BRACKETS REQUIRED FOR THE INSTALLATION OF ALL CASEWORK, FIXTURES AND EQUIPMENT AND FURNISHINGS.
- 25. INTERIOR WALL AND CEILING FINISH FLAME-SPREAD RATING SHALL BE AS REQUIRED BY LOCAL CODES. 26. PENETRATIONS IN WALLS, FLOORS OR ROOF REQUIRING PROTECTED OPENINGS SHALL BE FIRE-STOPPED IN ACCORDANCE WITH LOCAL CODES.
- ALL WIRING WITHIN CONCEALED SPACES SHALL COMPLY WITH LOCAL CODES.

THE OWNER REPRESENTATIVE FOR ON-SITE APPROVAL PRIOR TO INSTALLATION.

- 28. ALL DOOR SIZES SHOWN ARE OPENING SIZES. ALLOWANCE FOR THRESHOLDS (1/2" MIN), ETC. SHALL BE DEDUCTED. FRAMES SHALL BE REINFORCED WHERE REQUIRED FOR CLOSURES, STOPS AND HARDWARE.
- ALL DISCIPLINES REQUIRED TO PROVIDE SHOP DRAWINGS AND OR SAMPLES OF FINISHES. TO SUBMIT TO THE CONTRACTOR PRIOR TO START, WHO WILL FORWARD TO ARCHITECT AND OWNER FOR COMMENTS, FOR APPROVAL OR
- 30. THE SECURITY SYSTEMS ARE TO BE PROVIDED AND INSTALLED BY OTHERS. G.C. SHALL BE RESPONSIBLE FOR COORDINATION WITH OWNER'S SECURITY SYSTEMS CONTRACTOR.
- . GC TO REPLACE WORK OR PORTIONS OF THE WORK, NOT CONFORMING TO SPECIFIED REQUIREMENTS IN THE OPINION OF OWNER AND OR ARCHITECT.
- 2. ALL ITEMS TO BE SUPPLIED AND INSTALLED (TO A FULLY FINISHED LEVEL) BY G.C. G.C. TO PROVIDE POWER AS
- 33. DURING CONSTRUCTION, THE CONTRACTOR SHALL PROVIDE DAILY CLEANUP OF THE JOBSITE AND IT'S SURROUNDING AREA AND REMOVE ALL CONSTRUCTION DEBRIS FOR DISPOSAL.
- . THE G.C SHALL COORDINATE PARKING, MATERIAL DELIVERY, MATERIAL STAGING AND CONSTRUCTION DUMPSTER LOCATIONS W/ OWNER AND/OR OWNER'S TENANT PRIOR TO BEGINNING CONSTRUCTION. MAINTAIN ALL PEDESTRIAN WALKWAYS OPEN DURING CONSTRUCTION WHEN PROJECT IS LOCATED WITHIN AN EXISTING OCCUPIED DEVELOPMENT. COORDINATE ALL SHARED UTILITIES, FIRE SPRINKLER SYSTEM SHUT OFFS, ETC. W/ OWNER AND/OR OWNER'S TENANT PRIOR TO BEGINNING OF THE WORK.

35. PERFORM ALL CONSTRUCTION WORK INDICATED OR OTHERWISE REQUIRED FOR COMPLETION OF THE PROJECT EXCEPT AS NOTED OTHERWISE.

- SCHEDULE AND COORDINATE THE WORK OF THE COMPLETE PROJECT TO ASSURE AN EFFICIENT AND ORDERLY SEQUENCE OF INSTALLATION OF ALL ELEMENTS - WITH PROVISIONS FOR ACCOMMODATING ITEMS TO BE INSTALLED
- 37. THE CONTRACTOR IS SOLELY RESPONSIBLE FOR CONSTRUCTION MEANS, METHODS, TECHNIQUES, SEQUENCES AND
- PROCEDURES AND FOR COORDINATING ALL PORTIONS OF THE WORK 38 PROVIDE ALL REQUIRED NOTICES FOR INSPECTIONS AND APPROVALS OF THE WORK BY THE AUTHORITY HAVING
- JURISDICTION (AHJ). THE MOST RESTRICTIVE CODE REQUIREMENTS AS INTERPRETED BY LOCAL OFFICIALS WILL
- 39. VERIFY LOCATIONS OF EXISTING UTILITY SERVICE CONNECTIONS SERVING THE PROJECT BEFORE STARTING CONSTRUCTION. LOCATIONS OF EXISTING UTILITIES NOTED ARE APPROXIMATE, AND MAY BE BASED ON UN-VERIFIED INFORMATION. PROVIDE ALL CONNECTIONS REQUIRED AT UTILITY CONNECTION POINTS AT NO ADDITIONAL COST TO
- 40. PROVIDE SUBCONTRACTORS WITH A FULL-SET OF THE CONSTRUCTION DOCUMENTS TO ENSURE COORDINATION BETWEEN ALL TRADES AND EACH SUBCONTRACTOR.
- . ALL CONSTRUCTION WORK MUST BE OF GOOD QUALITY FREE FROM DEFECTS AND IN ACCORDANCE WITH REQUIREMENTS OF THE CONSTRUCTION DOCUMENTS - OR THE WORK MAY BE CONSIDERED DEFECTIVE - AND SUBJECT TO CORRECTION OR REPLACEMENT BY THE CONTRACTOR WITHIN A PERIOD OF ONE (1) YEAR AFTER SUBSTANTIAL COMPLETION.

COORDINATION WITH SEPARATE CONTRACTORS

- 42. COORDINATE WITH THE OWNER'S SEPARATE CONTRACTORS OR SUPPLIERS FOR WORK INDICATED AS BEING OWNER-FURNISHED & CONTRACTOR INSTALLED (OFCI), OR NOT-IN-CONTRACT (NIC), PROVIDE SCHEDULED DATES WHEN THE PROJECT WILL BE READY FOR DELIVERY OR INSTALLATION OF OWNER FURNISHED PRODUCTS, AS
- 3. COORDINATE THE WORK OF THIS PROJECT WITH OTHER CONTRACTORS AT SEPARATE CONSTRUCTION PROJECTS WITHIN THE SAME DEVELOPMENT, SO THAT THIS WORK WILL NOT INTERFERE WITH OR DELAY THEIR OPERATIONS.
- 4. COORDINATE, RECEIVE AT SITE, VERIFY RECEIPT, HANDLE, STORE ON-SITE (IF REQUIRED), PROTECT AND INSTALL OWNER-FURNISHED PRODUCTS, AND PROVIDE SERVICE CONNECTIONS AS APPLICABLE.
- 5. NOTIFY THE OWNER WITHIN FIVE (5) DAYS OF RECEIPT OF ANY ITEMS THAT ARE MISSING, DAMAGED OR OTHERWISE DEFECTIVE. LACK OF NOTIFICATION WILL BE CONSIDERED PRESUMPTIVE PROOF THAT ALL ITEMS DID ARRIVE UNDAMAGED AND IN PROPER QUANTITIES, AND ANY REPLACEMENT OR REPAIRS NECESSARY WILL THEN BE THE RESPONSIBILITY OF THE CONTRACTOR.
- 46. REPAIR DAMAGE TO OWNER-FURNISHED PRODUCTS CAUSED BY CONSTRUCTION OPERATIONS TO THE OWNER'S SATISFACTION.

- 47. OBTAIN AND COMPLY WITH THE OWNER'S CONSTRUCTION RULES & REGULATIONS WHICH ARE CONSIDERED PART OF THE CONSTRUCTION DOCUMENTS BY REFERENCE. COMPLY WITH OWNER'S APPROVED DRAWINGS OF THIS PROJECT. IF APPLICABLE. MAINTAIN PRINTED COPIES AT THE SITE AND ACKNOWLEDGE RECEIPT TO THE OWNER.
- 48. PARTICIPATE IN A PRE-CONSTRUCTION MEETING WITH THE OWNER'S REPRESENTATIVE AND PROVIDE THEM SUFFICIENT NOTICE BEFORE STARTING WORK.

TO HAVE ACCEPTED SUCH CONDITIONS, AND TO HAVE MADE THE NECESSARY ALLOWANCES IN PREPARING HIS BID.

- **GENERAL DEMOLITION** 49. DEMOLITION CONTRACTOR TO COORDINATE & REVIEW ALL CONSTRUCTION DOCUMENTS & DETERMINE THE EXTENT OF DEMOLITION WORK & BECOME FAMILIAR WITH THEM THOROUGHLY BEFORE PERFORMING ANY DEMOLITION WORK. BY THE ACT OF STARTING DEMOLITION. THE CONTRACTOR WILL BE DEEMED TO HAVE COMPLIED WITH THE FOREGOING.
- . REFER TO MECHANICAL, ELECTRICAL, & PLUMBING DRAWINGS FOR ADDITIONAL & DETAILED DEMOLITION INSTRUCTIONS.

CHASE NOTES

51. PROTECT FROM DAMAGE DURING CONSTRUCTION ALL EXISTING WALLS. FLOORS, CEILINGS, ETC. THAT ARE TO REMAIN

52. IF CONTRACTOR ENCOUNTERS ANY HAZARDOUS MATERIALS DURING DEMOLITION OR CONSTRUCTION, HE SHALL

53. ALL DEMOLITION SHALL BE CARRIED OUT IN A SAFE MANNER & IN STRICT ACCORDANCE WITH OSHA REGULATIONS.

TO THE DEMOLITION AND REMOVAL OF ANY WALLS. COUNTERS, FURNITURE, BULKHEADS, DOORS, PLUMBING.

54. THE SUB-CONTRACTOR SHALL FIELD VERIFY THE EXTENT OF DEMOLITION. THE WORK INCLUDES, BUT IS NOT LIMITED

MECHANICAL AND ELECTRICAL ITEMS INCLUDING CONDUITS AND DUCTWORK AS SHOWN ON THE DRAWINGS OR AS

55. WHEN UTILITIES ARE REMOVED, CAP & SEAL A MINIMUM OF 8" BELOW FINISH FLOOR OR A MINIMUM OF 6" ABOVE FINISH

56. PROVIDE BARRIERS, FENCES AND OTHER CONTROLS TO PREVENT PUBLIC ENTRY TO CONSTRUCTION AREAS, AND TO

57. PROVIDE PROTECTION OF CONSTRUCTION MATERIALS FROM LOSS, DAMAGE, FIRE OR THEFT, AND PROTECT EXISTING

59. PROVIDE DUMPSTERS AND COLLECT WASTE DAILY. DISPOSE OF MATERIAL IN A LAWFUL MANNER. PLACE DUMPSTER IN

61. APPLICATION OF A MATERIAL OR EQUIPMENT ITEM TO WORK INSTALLED BY OTHERS CONSTITUTES ACCEPTANCE OF

THAT WORK AND ASSUMPTION OF RESPONSIBILITY FOR SATISFACTORY INSTALLATION AND PERFORMANCE.

62. INSPECT EACH ITEM OF MATERIAL OR EQUIPMENT IMMEDIATELY PRIOR TO INSTALLATION. REJECT DAMAGED AND

63. REVIEW THE OWNER'S SEPARATE CASEWORK/FIXTURES, FURNISHINGS, EQUIPMENT, & SIGNAGE DRAWINGS FOR UNIT

64. PROVIDE ALL HVAC. PLUMBING. GAS OR ELECTRIC SERVICE CONNECTIONS TO CASEWORK / FIXTURES, SIGNAGE, OR

65. VERIFY DISPOSITION OF ALL FURNISHINGS, MILLWORK, LIGHTING FIXTURES, ETC. TO BE REMOVED W/ OWNER. ALL

66. ESTABLISH AND MAINTAIN DURABLE MARKERS TO LOCATE ALL ELEMENTS OF THE WORK, INCLUDING BUT NOT LIMITED

TO PARTITIONS, CASEWORK, FIXTURES, EQUIPMENT AND LIGHT-FIXTURES, AND THEIR RELATED MECHANICAL,

67. AT PROJECTIONS OF FINISHED SURFACES, INCLUDING PILASTERS OR THICKENED WALLS, RETURN ALL EXPOSED

68. PERFORM ALL CUTTING, PATCHING AND FITTING TO ACCOMMODATE CONSTRUCTION WORK AND TO ACHIEVE THE

INTENT OF THE CONSTRUCTION DOCUMENTS. CUT & PATCH PARTITIONS FOR INSTALLATION OF PLUMBING OR

ELECTRICAL SERVICES AND FOR INSTALLATION OF WALL BLOCKING, IF NECESSARY. PROVIDE ESCUTCHEONS,

CONSTRUCTION ONLY TO STRUCTURAL ELEMENTS ABOVE - EVEN IF NOT SPECIFICALLY NOTED. DO NOT ANCHOR TO

70. JUST BEFORE OWNER OCCUPANCY. CLEAN ALL SURFACES INCLUDING FIXTURES AND EQUIPMENT FOR THE OWNER'S

USE AND OPERATION. POLISH GLASS AND PLUMBING FIXTURES TO BE WITHOUT NOTICEABLE STREAKS. VACUUM CLEAN

FLOORS AND DAMP WIPE WALLS, FIXTURES AND EQUIPMENT TO BE DUST-FREE WITHOUT STAINS, FILMS AND OTHER

REMOVE STAINS, SPILLS AND OTHER FOREIGN DEPOSITS. RAKE GROUNDS THAT ARE NEITHER PAVED NOR PLANTED,

72.1. PROVIDE MASONRY CONTROL-JOINTS AT 24 FT SPACING MAXIMUM (EVEN IF NOT NOTED), AND WHERE NOTED ON THE

73.1. PROVIDE .042 INCH (18 GA) COLD-FORMED METAL FRAMING AT 16 INCH OC AT EXTERIOR FRAMED WALLS MINIMUM, OR

74.2. PROVIDE FIRE-RETARDANT TREATED PLYWOOD BACKING AT ALL ELECTRICAL. PHONE AND SECURITY SYSTEM PANELS

74.3. PROVIDE CONCEALED WOOD BLOCKING, BRACING OR NAILERS FOR SECURE ANCHORAGE OF ALL SHELVES, RUNNING

74.4. CUT TO FIT ALL WOOD TRIM OR OTHER PREFINISHED TRIM UNITS AND FINISH ALL EXPOSED SURFACES TO MATCH

74.5. ANCHOR WOOD BLOCKING TO METAL STUD FRAMING W/ #12 TEK SCREWS @ 16" OC MAX - ANCHOR BLOCKING TO

75.1. VERIFY THAT ALL EXTERIOR FINISHED GRADES ADJACENT TO EXTERIOR WALL ARE BELOW THE FINISHED FLOOR

75.2. PROVIDE MIN 3-1/2" BATT INSULATION ON CEILINGS ABOVE AND WITHIN PARTITIONS AROUND AND BETWEEN ALL TOILET

75.3. SEAL ALL EXTERIOR BUILDING JOINTS AT BOTH THE OUTSIDE AND INSIDE SURFACES, AND OTHER OPENINGS AGAINST

75.4. PROVIDE SEALANT ALL-AROUND: DOOR OR WINDOW FRAMES. COUNTERTOPS & BACK-SPLASHES. WALL-MOUNTED

76.1. DOOR AND WINDOW DIMENSIONS NOTED ARE NOMINAL - COORDINATE WITH FIELD-CONDITIONS AND VERIFY WITH

77.2. PROVIDE BACK-TO-BACK DOUBLED .0312" (20 GA) METAL STUDS WHERE WALL-BLOCKING IS PROVIDED FOR SUPPORT

77.3. DRYWALL HEADERS: PROVIDE FRAMING @ 16" OC SUSPENDED FROM STRUCTURE ABV W/ 1 LAYER 5/8" GYP BD ON

77.4. PAINT OR STAIN FINISH ALL EXPOSED SURFACES OF CONSTRUCTION UNLESS NOTED OTHERWISE OR IF SURFACE IS

PRE-FINISHED. PROVIDE PAINT FINISH MIN AT ALL SURFACES NOT OTHERWISE INDICATED TO RECEIVE OTHER FINISH.

"RESTROOM" OR AS APPROPRIATE TO USE/TITLE OF ROOM - MOUNT 9" FROM STRIKE EDGE OF DOOR & 60 INCHES AFF

FINISH EXPOSED EDGES OR SURFACES OF CUT WOOD OR PREFINISHED TRIM TO MATCH ADJACENT SURFACES.

78.1. AT "ASSEMBLY" OCCUPANCIES PROVIDE "MAXIMUM OCCUPANCY" SIGN IN A CONSPICUOUS LOCATION AS APPROVED

78.2. ACCESSIBLE DOOR SIGN W/ RAISED LETTERS, PICTORIAL-SYMBOL & BRAILLE PLATE READING "MEN". "WOMEN".

78.3. TOWEL-DISPENSER AND WASTE RECEPTACLE AT EACH LAVATORY OR HAND SINK - PROVIDE WALL BLOCKING IF

79.1. PROVIDE WATER-SERVICE SHUTOFF-VALVE W/ BACK-FLOW PREVENTER (DOWNSTREAM OF VALVE) AT EA HOT- OR

80.1. SUBMIT SPRINKLER-SYSTEM DESIGN DRAWINGS TO AHJ AND OWNER (WHEN APPLICABLE) AND OBTAIN THEIR

81.3. MINIMUM SLOPE OF EXTERIOR PAVEMENT (WITHIN 10 FEET OF BUILDING) 2% DRAINING AWAY FROM BUILDING.

80.2. PROVIDE SEMI-CONCEALED TYPE SPRINKLER HEADS IN PUBLIC VIEW AREAS. PROVIDE STANDARD SURFACE-MTD

76.2. HARDWARE MATERIALS: PROVIDE NON-FERROUS MATERIALS AT EXTERIOR LOCATIONS.

77.1. PROVIDE 5/8" THICK GLASS-MAT GYPSUM BACKER-BOARD AT ALL PARTITIONS W/ TILE FINISH.

FIXTURES OR EQUIPMENT (INCLUDING LAVS OR SINKS) TO ADJACENT WALL SURFACES, AND OTHER SIMILAR

MOISTURE AND AIR-INFILTRATION. AT JOINTS AROUND STOREFRONT/CURTAIN WALL SYSTEMS, PROVIDE SHIM-SPACE

ELEVATION. IF NOT, PROVIDE WATERPROOF MEMBRANE WITH PROTECTION COURSE OVER EITHER

SMOOTH-SURFACED MASONRY OR CAST-IN-PLACE CONCRETE TURNED-UP FROM THE FLOOR SLAB

TRIM, RAILINGS, SUSPENDED ITEMS, DOOR-STOPS, GRAB-BARS, AND OTHER SIMILAR WOODWORK, HARDWARE,

ADJACENT FINISHED MATERIALS. INSTALL WOODWORK WITH A MINIMUM NUMBER OF JOINTS. COPE ALL RETURNS

MITER ALL CORNERS AND USE SCARF-JOINTS AT END-TO-END CONNECTIONS (BUTT JOINTS ARE NOT ACCEPTABLE).

CMU'S OR CONCRETE WITH 1/4" TAPCONS AT MAXIMUM 16" OC. STAGGER FASTENERS WHEN BLOCKING IS WIDER THAN

74.1. PROVIDE PRESERVATIVE-TREATED WOOD WHEN WOOD IS IN DIRECT CONTACT WITH CONCRETE OR MASONRY

71. CLEAN THE PROJECT SITE OF RUBBISH, LITTER AND OTHER FOREIGN SUBSTANCES. BROOM CLEAN PAVED AREAS AND

GROMMETS AND SIMILAR SURFACE CLOSURE OR FINISHED TRIMS AT EXPOSED PENETRATIONS OF FINISHED

69. BRACE PARTITIONS, SUSPEND CEILINGS OR SOFFITS, AND BRACE PLATFORMS, SUSPENDED ITEMS OR SIMILAR

ROOF DECK, PLUMBING / SPRINKLER PIPES, DUCTWORK, ELECTRICAL CONDUIT OR SIMILAR ELEMENTS.

REFER TO GENERAL NOTES SHEETS FOR EACH PROFESSIONAL DISCIPLINE FOR ALL OTHER CONSTRUCTION

REPORT DISCREPANCIES OR OMISSIONS OF EQUIPMENT REQUIREMENTS PRIOR TO INSTALLATION.

EQUIPMENT INDICATED (WHETHER UNITS ARE INSTALLED BY CONTRACTOR OR BY OTHERS).

ITEMS TO BE DISPOSED SHALL BE DISPOSED OF OFF-SITE AND IN AN EXPEDITIOUS MANNER.

SURFACE FINISHES BACK TO THE PRIMARY SURFACE EVEN IF NOT SPECIFICALLY NOTED.

SIZES, WEIGHTS, SERVICE-CONNECTIONS AND CLEARANCES REQUIRED - WHETHER FURNISHED OR INSTALLED BY THE

CONTRACTOR OR OTHERS. VERIFY THAT REQUIRED ROUGH-INS. CONNECTIONS AND CLEARANCES WILL BE PROVIDED.

PROVIDE OPENINGS AND DELIVERY ACCESS FOR FF&E ITEMS, AND PROVIDE STAGING SPACE FOR THEIR INSTALLATION.

58. PROVIDE TEMPORARY FIRE-PREVENTION MEASURES AND PROCEDURES INCLUDING FIRE-EXTINGUISHERS PER AHJ

60. STORE PRODUCTS PER MANUFACTURER'S INSTRUCTIONS, PROTECTED FROM DAMAGE OR ABUSE, AND WITH

IMMEDIATELY SUSPEND WORK & NOTIFY THE AREA CONSTRUCTION MANAGER BEFORE PROCEEDING.

REQUIRED TO COMPLETE THE INSTALLATION OF THE NEW WORK FOR A COMPLETE JOB.

PROTECT CONSTRUCTION WORKERS AND THE PUBLIC FROM HAZARDS OF CONSTRUCTION.

CONSTRUCTION FROM DAMAGE BY CONSTRUCTION OPERATIONS.

LOCATION APPROVED BY OWNER OR LANDLORD, AS APPLICABLE.

COORDINATION WITH FIXTURES, FURNISHINGS & EQUIPMENT (FF&E)

EXISTING ADJACENT CONSTRUCTION & FINISHES

TEMPORARY FACILITIES, UTILITIES & CONTROLS

VENTILATION TO AVOID CONDENSATION.

REQUIREMENTS

GENERAL PRODUCT REQUIREMENTS

GENERAL EXECUTION OF THE WORK

FINAL CLEANING

ELECTRICAL AND PLUMBING CONNECTIONS

TO A SMOOTH EVEN-TEXTURED SURFACE.

GREATER AS NOTED ON STRUCTURAL DRAWINGS.

SPECIALTIES, ACCESSORIES, FIXTURES OR EQUIPMENT

REFINISH ALL EXPOSED CUTS AND DAMAGED WOODWORK.

AND SEALANT INSIDE AND OUTSIDE WITH BACKER-ROD.

MANUFACTURERS BEFORE FABRICATION

77.1. DRYWALL CONTROL JOINTS: LOCATE AS NOTED.

EXPOSED SIDE(S) AND BOTTOM SURFACE.

NECESSARY FOR SECURE ATTACHMENT.

COLD-WATER CONNECTION TO EQUIPMENT (EXCEPT AT SINKS).

81.1. MAXIMUM ALLOWABLE SLOPE OF NEW PAVEMENT: 4.9% (1:21).

81.2. MAXIMUM ALLOWABLE CROSS-SLOPE OF NEW PAVEMENT: 2% (1:48).

79.2. PROVIDE SHUTOFF VALVES (STOPS), SUPPLIES AND TRAPS AT ALL LAVS OR SINKS.

SPRINKLER HEADS IN BACK AREAS NOT IN PUBLIC VIEW, UNLESS OTHERWISE NOTED.

OF GRAB-BARS OR SHELVING.

TO SIGN CENTERI INFS

80. DIVISION 21 - FIRE SUPPRESSION SYSTEM NOTES:

81. DIVISION 32 - SITE IMPROVEMENTS:

APPROVAL BEFORE STARTING WORK.

REQUIREMENTS NOT LISTED BELOW.

75. DIVISION 7 - THERMAL MOISTURE:

77. DIVISION 9 FINISHES:

78. DIVISION 10 - SPECIALTIES:

79. DIVISION 11 - EQUIPMENT:

72. DIVISION 4 - MASONRY

73. DIVISION 5 - METAL

74. DIVISION 6 - WOOD

CONTRACTOR TO PATCH & REPAIR ANY DAMAGED PORTIONS OF THE EXISTING BUILDING AS REQUIRED TO MATCH THE

- ALL WORK SHALL BE IN COMPLIANCE WITH APPLICABLE FEDERAL. STATE AND LOCAL BUILDING CODES, REGULATIONS. ORDINANCES AND STANDARDS INCLUDING ADA AND OR OTHER HANDICAP ACCESSIBILITY CODES.
- GENERAL CONTRACTOR IS RESPONSIBLE FOR COORDINATING WITH THE OWNER'S VENDORS REGARDING SCHEDULING ON SITE DURING CONSTRUCTION AND SEQUENCING OF THE WORK.
- THE CONSTRUCTION NOTES AND DRAWINGS ARE SUPPLIED TO ILLUSTRATE THE DESIGN INTENT AND GENERAL TYPE OF CONSTRUCTION DESIRED AND ARE INTENDED TO IMPLY THE FINEST QUALITY OF CONSTRUCTION, MATERIAL AND
- PRIOR TO COMMENCEMENT OF ANY CONSTRUCTION, CONTRACTOR SHALL VERIFY EXISTENCE AND LOCATION OF ALL EXISTING ABOVE AND BELOW GRADE, UTILITIES, INCLUDING SANITARY SEWER, STORM SEWER, WATER, GAS, ELECTRICAL, TELEPHONE,
- ETC. ANY DISCREPANCIES IN UTILITY LOCATIONS SHALL BE BROUGHT TO THE IMMEDIATE ATTENTION OF THE ARCHITECT. ALL PENETRATIONS SHALL RECEIVE CAULKING TO SEAL ANY TYPE OF ENERGY LOSS.

THE CONTRACTOR SHALL VERIFY AND COORDINATE ALL APPLICABLE DIMENSIONS OF FIXTURES AND EQUIPMENT SUPPLIED

- AND/OR INSTALLED BY OTHERS UPON COMPLETION OF PROJECT, G.C. TO OBTAIN ALL FINAL INSPECTIONS AS REQUIRED BY LOCAL JURISDICTIONS AND
- FURNISH OWNER WITH EVIDENCE OF ALL SUCH INSPECTIONS AND CERTIFICATES OF OCCUPANCY.
- SIGNS, LINESS NOTED OTHERWISE ARE PROVIDED BY OWNER'S SIGN CONTRACTOR. GENERAL CONTRACTOR TO PROVIDE ROUGH-IN & FINAL CONNECTION AND BRAILLE EXIT SIGN.
- GENERAL CONTRACTOR TO PROVIDE FOUR (4) 30 YARD DUMPSTERS DURING CHASE RETAIL MOVE-IN.
- GENERAL CONTRACTOR TO MAINTAIN SUPERINTENDENT AVAILABILITY DURING ENTIRE WEEK OF RETAIL MOVE-IN TO ASSIST
- 1. GENERAL CONTRACTOR SHALL BE RESPONSIBLE FOR SET-UP AND COORDINATION OF ALL THE UTILITY SERVICES FOR THE

. GENERAL CONTRACTOR SHALL PROVIDE ONE SKILLED LABORER FOR ONE WEEK DURING CHASE RETAIL MOVE-IN. (40 HOURS)

FURNISHED/ | FURNISHED/ | FURNISHED | COORDINATED

BY GENERAL

INSTALLED BY | INSTALLED BY | BY OWNER/

- 12. GENERAL CONTRACTOR TO PROVIDE FINAL KEYING ON DAY OF TURNOVER PER CHASE KEYING GUIDELINES.
- 13. REFER TO "PROJECT MANUAL" FOR ALL OTHER INSTRUCTIONS & DIRECTIVES NOT SHOWN IN DRAWINGS.

RESPONSIBILITY MATRIX

	OWNER'S EQUIPMENT CONTRACTOR	GENERAL CONTRACTOR	INSTALLED BY GENERAL CONTRACTOR	CONTRACT (YES/NC
EXTERIOR BLDG. SIGNAGE (SEE NOTE 4)	X			YES
ATM - WALK OR DRIVE-UP (SEE NOTE 3)	Х			YES
NIGHT DEPOSITORY	Х			YES
MERCHANT AND TELLER LINE COUNTERS	Х			YES
TELLER CASH DISPENSERS	Х			YES
UNDER COUNTER BANK EQUIPMENT	Х			YES
FURNITURE	Х			YES
PLASMA TVs (WHEN SHOWN)	Х			YES
EMPLOYEE LOCKERS		Х		YES
TELECOMMUNICATIONS	Х			YES
DATA PROCESSING	Х			NO
SECURITY SYSTEM (SEE NOTE 5)	REFER TO SECU	REFER TO SECURITY DRAWING FOR RESPONSIBILITIES		IES
COPY MACHINE	Х			NO
INTERIOR BLDG. SIGNAGE (SEE NOTE 4)	Х			NO
TEMPORARY CONSTRUCTION SIGN	Х			YES
TOILET ROOM SIGNS & ALL ACCESSORIES		Х		YES
MOTORIZED & MANUAL SHADES		Х		YES
CARPET TILE & RESILIENT FLOORING		Х		YES
VESTIBULE WALK OFF MAT		Х		YES
FLOORING		Х		YES
MILLWORK		Х		YES
PAINTING & WALL COVERING		Х		YES
MICROWAVE, REFRIGERATOR, TV		Х		YES
PERMANENT CORES/KEYING		Х		NO
CHECK DESKS			Х	YES
WASTE CONTAINER (EXT.)		Х		YES
UTILITIES & FIRE PROTECTION SERVICES		Х		YES
DOOR HARDWARE		Х		YES
MUZAK SOUND SYSTEM	Х			YES
AREA RUGS		Х		YES
MAILBOX (SEE NOTE 6)		Х		YES

- FOR OWNER'S EQUIPMENT GENERAL CONTRACTOR TO PROVIDE REQUIRED OPENINGS, ACCESS PANELS, AND ELECTRICAL REQUIREMENTS (INCLUDING FINAL HOOK-UP).
- MILLWORK ITEMS. GENERAL CONTRACTOR TO PROVIDE "BACK OF STORE" MILLWORK WHICH INCLUDES BASE AND WALL CABINETS, WORK COUNTERS AND SHELVING.
- EBK UNITS, ATM BUILDING, ATM SURROUNDS. GENERAL CONTRACTOR TO PROVIDE POWER & CONDUITS. SIGNAGE TO INCLUDE DIRECTIONAL SIGNAGE, AND MAIN BUILDING LETTER SET. GENERAL CONTRACTOR TO PROVIDE
- CONDUIT. ROUGH-IN & FINAL ELECTRICAL CONNECTIONS. ELECTRONIC SECURITY SYSTEM INCLUDING ALARM AND CCTV. GENERAL CONTRACTOR TO PROVIDE CONDUITS, POWER,
- AND PLYWOOD AT PHONE ROOM. REFER TO SECURITY PLAN FOR ITEMS TO BE ACCOMMODATED IN GENERAL CONTRACTORS BASE BID
- FINAL LOCATION DETERMINED BY BRANCH PLANNING. MONUMENT SIGN FOUNDATION/MASONRY BY CONSULTANT'S SIGN VENDOR. ELECTRICAL BY GENERAL CONTRACTOR.
- . EQUIPMENT CONTRACTOR IS A SUBCONTRACTOR OF THE OWNER. 9. GENERAL CONTRACTOR TO FURNISH QUANTITY TAKEOFF INCLUDING 10% ATTIC STOCK

ALL DIMENSIONS ARE FROM SUBSTRATE TO SUBSTRATE OR FACE OF MASONRY, U.N.O.

NOTIFY THE ARCHITECT OF ANY DISCREPANCIES PRIOR TO BEGINNING CONSTRUCTION.

DO NOT SCALE DRAWINGS. CONTRACTOR TO VERIFY ALL EXISTING CONDITIONS AND DIMENSION.

PROJECT INFORMATION

JAMES T. LALLI, AIA, ARCHITECT

LICENSE NO. 32254

HESE DRAWINGS ARE NOT COMPLETE WITHOUT THE

SEPARATE TYPE WRITTEN SPECIFICATIONS MANUAL

WHICH ARE PART OF THE CONTRACT DOCUMENTS.

DESCRIPTION

2022.07.15 | PERMIT SET

PROJECT NO: 2022.07.13 **PROTOTYPE** DRAWN BY: K.KELLY CHECKED BY: M.SIDES SSE 1.00 **VERSION:**

GENERAL NOTES, RESPONSIBILITY SCHEDULE, DRAWING CONVENTIONS. & ABBREVIATIONS

SHEET NUMBER

SHEET TITLE


GROUP

Galen Street

Watertown, MA 02472 617.576.0007

SSUE DATE

ARCHITECT OF RECORD

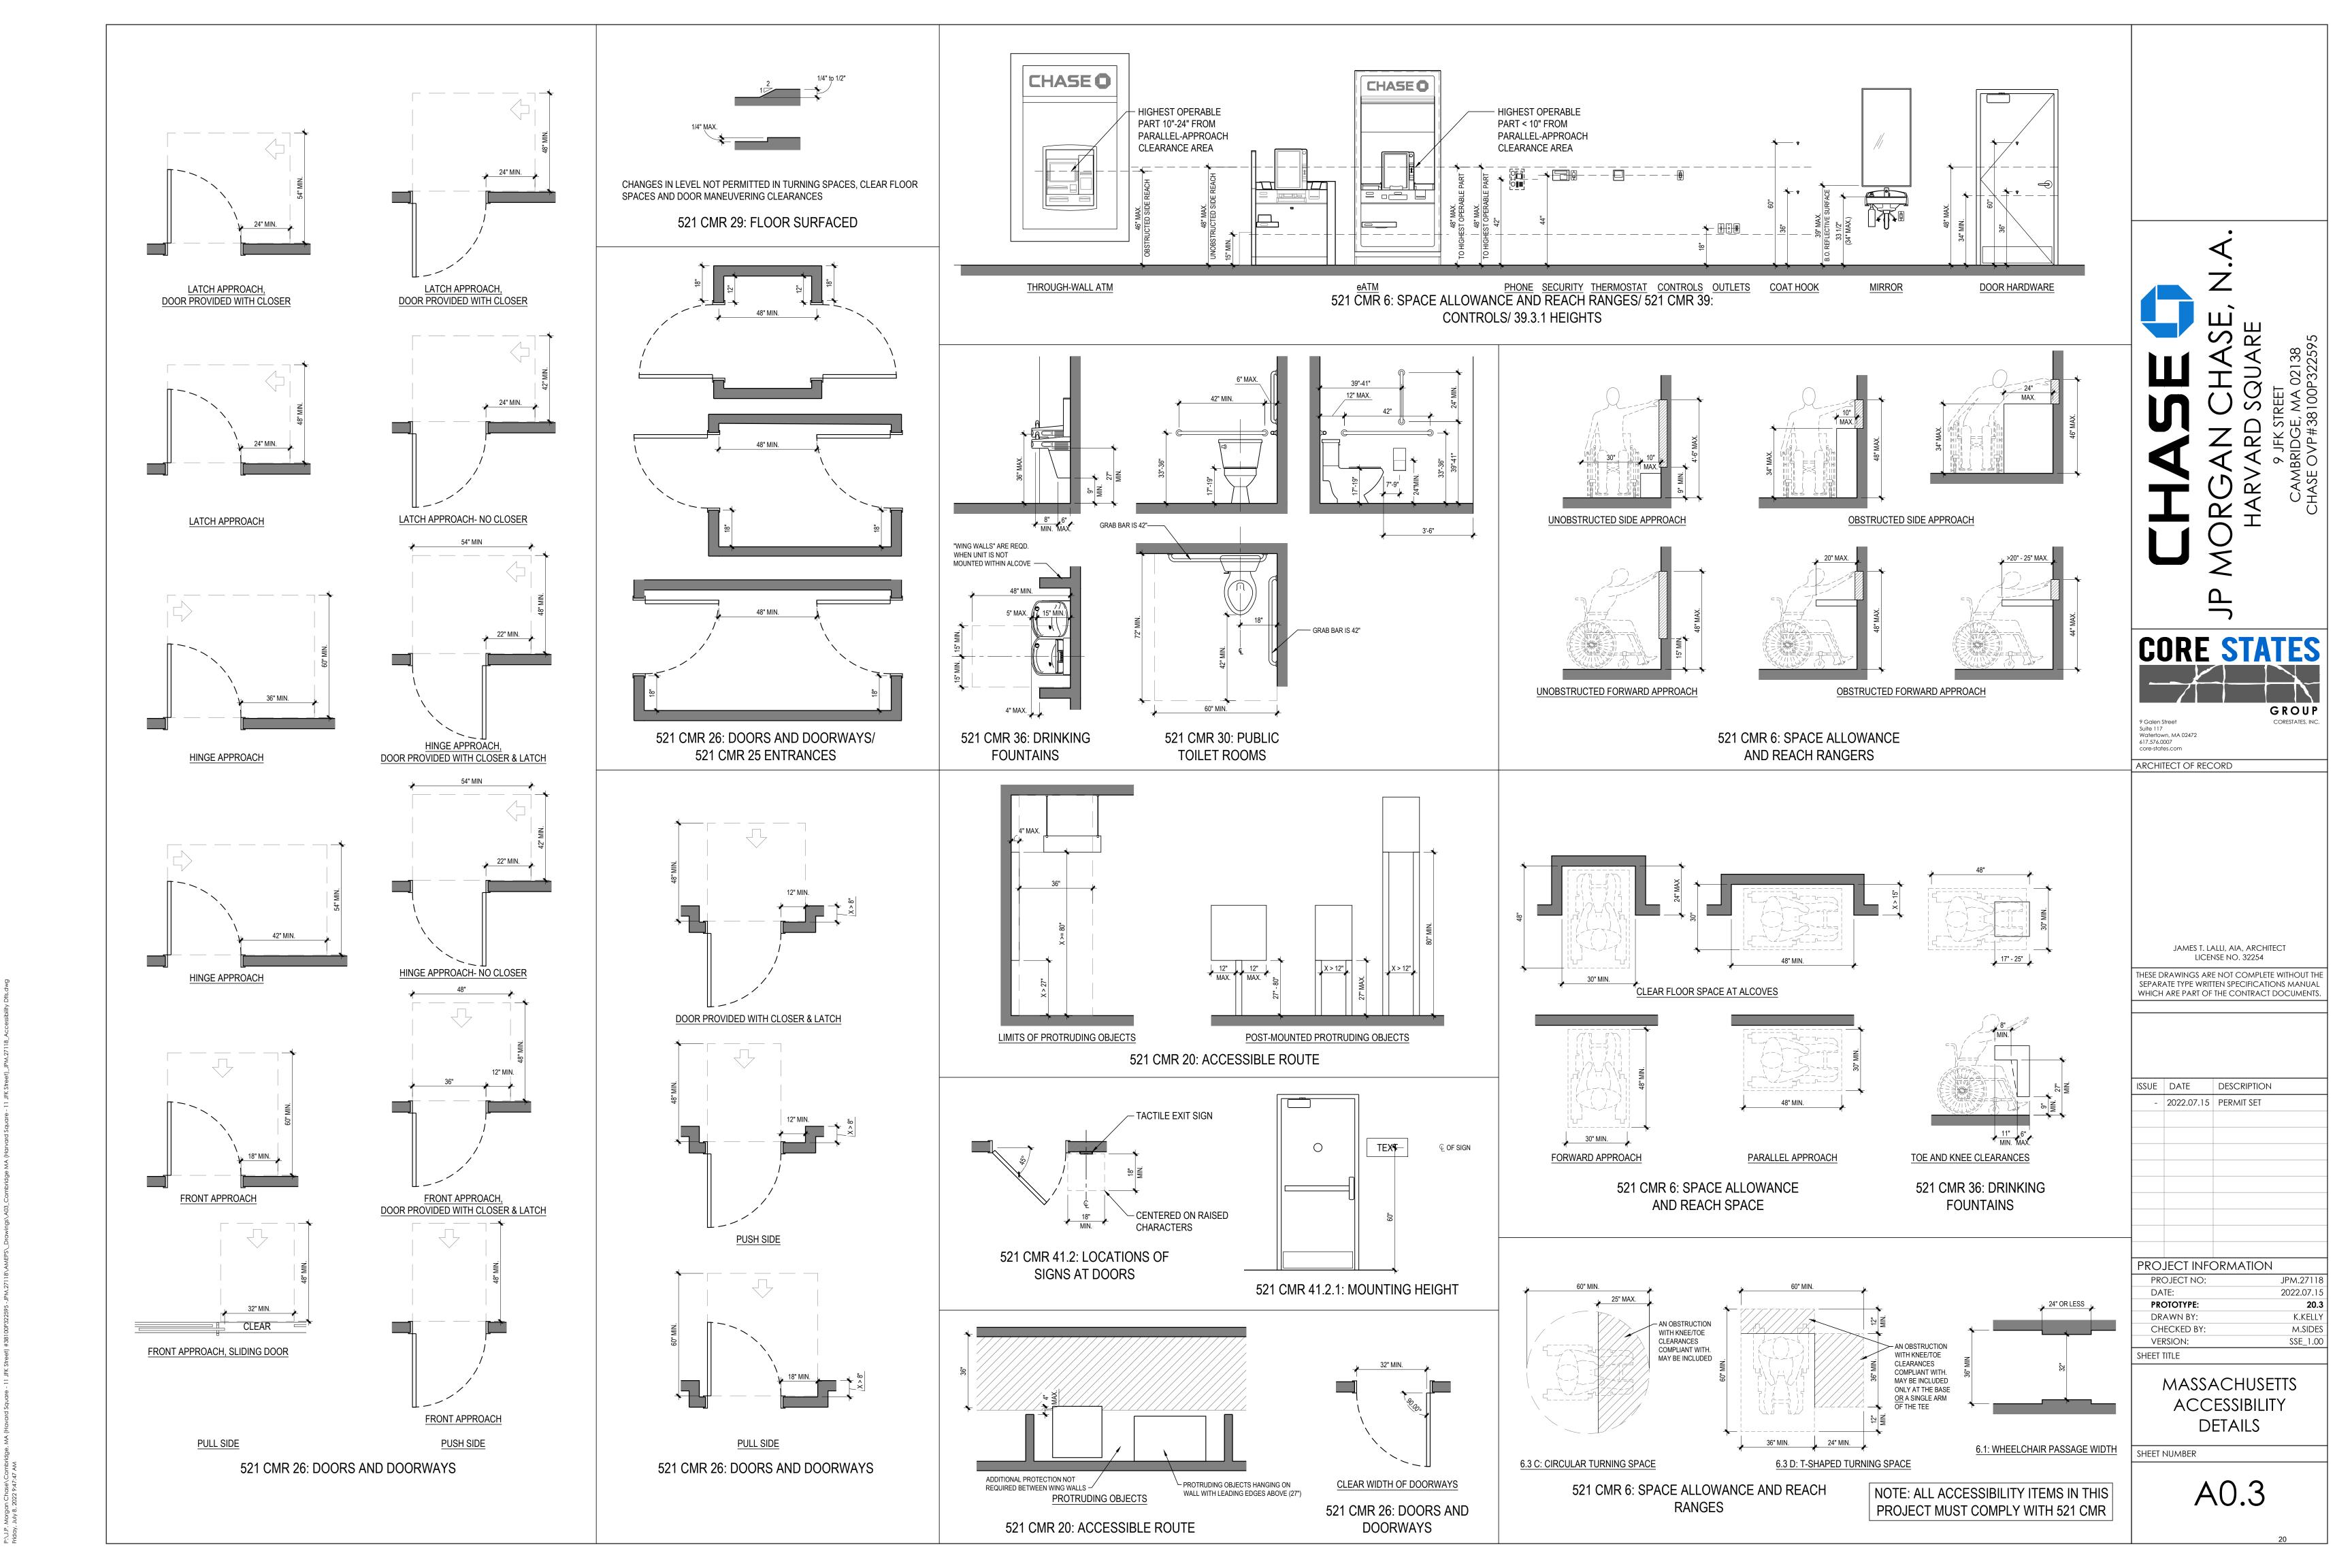

System No. W-L-1001


June 15, 2005

F Ratings - 1, 2, 3 and 4 Hr (See Items 2 and 3)

T Ratings - 0, 1, 2, 3, and 4 Hr (See Item 3)

L Rating At Ambient — less than 1 CFM/sq ft

L Rating At 400 F - less than 1 CFM/sq ft

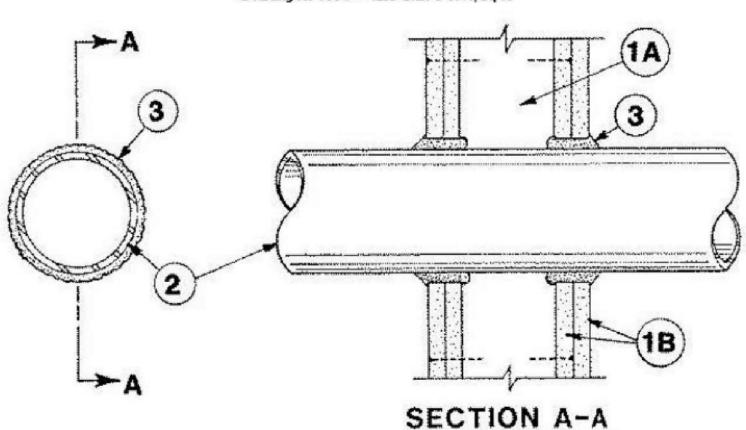

1. Wall Assembly — The 1, 2, 3 or 4 hr fire-rated gypsum wallboard/stud wall assembly shall be constructed of the materials and in the manner described in the individual U300 or U400 Series Wall or Partition Designs in the UL Fire Resistance Directory and shall include the following construction features:

> A. Stude — Wall framing may consist of either wood stude (max 2 h fire rated assembles) or steel channel studs. Wood studs to consist of nom 2 by 4 in. (51 by 102 mm) lumber spaced 16 in. (406 mm) OC with nom 2 by 4 in. (51 by 102 mm) lumber end plates and cross braces. Steel studs to be min 3-5/8 in. (92 mm) wide by 1-3/8 in. (35 mm) deep channels spaced max 24 in.

B. Gypsum Board* - Nom 1/2 or 5/8 in. (13 or 16 mm) thick, 4 ft. (122 cm) wide with square or tapered edges. The gypsum walboard type, thickness, number of layers, fastener type and sheet orientation shall be as specified in the individual U300 or U400 Series Design in the UL Fire Resistance Directory. Max diam of opening is 26 in. (660 mm).

Through-Penetrant — One metallic pipe, conduit or tubing installed either concentrically or eccentrically within the firestop system. The annular space between pipe, conduit or tubing and periphery of opening shall be min of 0 in / (0 mm). (point contact) to max 2 in. (51 mm) Pipe, conduit or tubing to be rigidly supported on both sides of wall assembly. The following types and sizes of metallic pipes, conduits or tubing may be used:

A. Steel Pipe - Nom 24 in. (610 mm) diam (or smaller) Schedule 10 (or heavier) steel pipe.

B. Iron Pipe — Nom 24 in. (610 mm) diam (or smaller) service weight (or heavier) cast iron soil pipe, nom 12 in (305 mm) diam (or smaler) or Class 50 (or heavier) ductile iron pressure pipe.

C. Conduit — Nom 6 in. (152 mm) diam (or smaller) steel conduit or nom 4 in (102 mm) diam (or smaller) steel electrical metallic tubing

D. Copper Tubing — Nom 6 in. (152 mm) diam (or smaller) Type L (or heavier) copper tubing

E. Copper Pipe - Nom 6 in. (152 mm) diam (or smaller) Regular (or heavier) copper pipe.

F. Through Penetrating Product* — Flexible Metal Piping The following types of steel flexible metal gas piping may be used:

1. Nom 2 in. (51 mm) diam (or smaller) steel flexible metal gas piping. Plastic covering on piping may or may not be removed on both sides of floor or wall assembly.

OMEGA FLEX INC

2. Nom 1 in. (25 mm) diam (or smaller) steel flexible metal gas piping. Plastic covering on piping may or may not be removed on both sides of floor or wall assembly.

GASTITE, DIV OF TITEFLEX

3. Norm 1 in. (25 mm) diam (or smaller) steel flexible metal gas piping. Plastic covering on piping may or may not be removed on both sides of floor or wall assembly.

WARD MFG L L C

3. Fill, Void or Cavity Material* — Caulk or Sealant — Min 5/8., 1-1/4,1-7/8 and 2-1/2 in. (16, 32, 48 and 64 mm) thickness of caulk for 1, 2, 3 and 4 hr rated assemblies, respectively, applied within annulus, flush with both surfaces of wall. Min 1/4 in. (6 mm) diam bead of caulk applied to gypsum board/penetrant interface at point contact location on both sides of wall. The hourly F Rating of the firestop system is dependent upon the hourly fire rating of the wall assembly in which it is installed, as shown in the following table. The hourly T Rating of the frestop system is dependent upon the type or size of the pipe or conduit and the hourly fire rating of the wall assembly in which it is installed, as tabulated below:

Max Pipe or Conduit Diam In (mm)	F Rating Hr	T Rating Hr
1 (25)	1 or 2	0+, 1 or 2
1 (25)	3 or 4	3 or 4
4 (102)	1 or 2	0
6 (152)	3 or 4	0
12 (305)	1 or 2	0

+When copper pipe is used, T Rating is 0 h.

3M COMPANY - CP 25WB+ or FB-3000 WT.

* Indicates such products shall bear the UL or cUL Certification Mark for jurisdictions employing the UL or cUL Certification (such as Canada), respectively.

THROUGH-PENETRATION FIRESTOP SYSTEM W-L-1001

A0.4 / N.T.S.


Through-penetration Firestop Systems

See General Information for Through-penetration Firestop Systems

System No. W-L-7005

October 31, 2006

F Rating - 2 Hr T Rating - 2 Hr

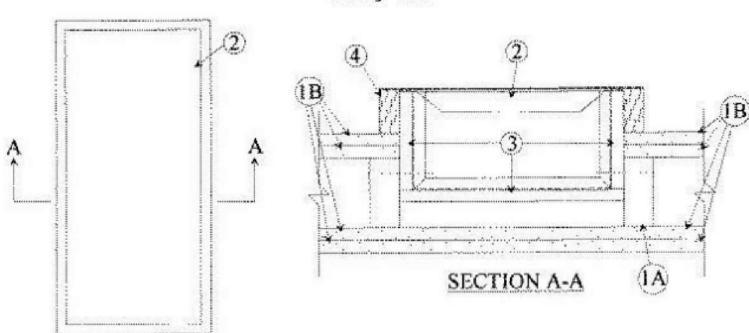

1. Wall Assembly - The fire-rated gypsum wallboard/stud wall assembly shall be constructed of the materials and in the manner specified in the individual U300 or U400 Series Wall and Partition Designs in the UL Fire Resistance Directory and shall include the following construction features:

> A. Studs - Wall framing may consist of wood studs or steel channel studs. Wood studs to consist of nom 2 by 4 in. lumber spaced 16 in. OC. Steel studs to be min 3-5/8 in. wide and spaced max 24 in. OC. When aluminum trim is used with cabinets, the wall opening shall be framed on all sides using lengths of studs installed between vertical studs and attached to the studs at each end.

B. Gypsum Board* - Two layers of nom 5/8 in, thick gypsum w allboard, as specified in the individual Wall and Partition Design.

2. Cabinets* - Fire extinguisher cabinet installed per manufacturers installation instructions in max 33-3/4 by 17-3/4 in. opening on one side of the wall. Max gap between cabinet and wallboard shall be 1/8 in.

MODERN METAL PRODUCTS - Models Nos. 101R-1, 101SR-2, 101SR-3.5, 102R-1, 102SR-2, 102SR-3, 102(6)R-1, 102(6)SR-2, 102(6)SR-3, 102(6)SR-4, 104R-1, 104SR-2, 104SR-3, 104SR-4, 105R-1, 105SR-2, 105SR-3, 105SR-4, 106SR-1, 106SR-2, 106SR-3, 106SR-4, 118R-1, 118SR-2, 118SR-3, 120R-1, 120SR-2, 120SR-3, 145R-1, 145SR-3, 147R-1, 147SR-3, 180R-1, 180SR-2, 180SR-3, 184R-1, 184SR-2, 184SR-3, 184SR-4, 186R-1, 186SR-2, 186SR-3, 186SR-4.

 Gypsum Board* — Any 5/8 in. thick gypsum wallboard bearing the UL Classification Marking as to Fire Resistance. Gypsum wallboard installed in the fire extinguisher cabinets (Item 2) per manufacturers installation instructions. See Gypsum Board category for names of manufacturers.

4. Mineral Wool - Min 4.0 pcf mineral wool batt insulation firmly packed inside cabinet trim.

* Indicates such products shall bear the UL or cUL Certification Mark for jurisdictions employing the UL or cUL Certification (such as Canada), respectively.


THROUGH-PENETRATION FIRESTOP SYSTEM W-L-7005

A0.4 / N.T.S.

Design No. U419

February 19, 2013

Nonbearing Wall Ratings - 1, 2, 3 or 4 Hr (See Items 4 & 5)

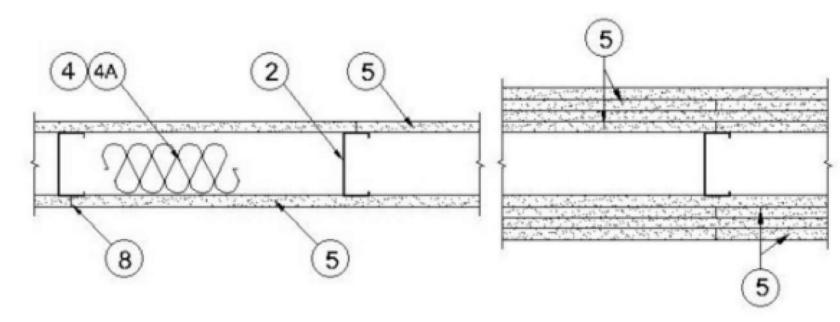

UL U419 1-HR RATED ASSEMBLY

 Floor and Ceiling Runners — (Not shown) — For use with Item 2 - Channel shaped, fabricated from min 25 MSG corrosion-protected steel, min depth to accommodate stud size, with min 1-1/4 in. long legs, attached to floor and ceiling with fasteners 24 in. OC max.

2. Steel Studs — Channel shaped, fabricated from min 25 MSG corrosion-protected steel, min depth as indicated under Item 5, spaced a max of 24 in. OC. Studs to be cut 3/8 to 3/4 in. less than assembly height.

3. Wood Structural Panel Sheathing — (Optional, For use with Item 5 Only.)- (Not Shown) - 4 ft wide, 7/16 in. thick oriented strand board (OSB) or 15/32 in. thick structural 1 sheathing (plywood) complying with DOC PS1 or PS2, or APA Standard PRP-108, manufactured with exterior glue, applied horizontally or vertically to the steel studs. Vertical joints centered on studs, and staggered one stud space from wallboard joints. Attached to studs with flat-head self-drilling tapping screws with a min. head diam. of 0.292 in. at maximum 6 in. OC. in the perimeter and 12 in. OC. in the field. When used, fastener lengths for gypsum panels increased by min. 1/2 in.

4. Batts and Blankets* - (Required as indicated under Item 5) - Mineral wool batts, friction fitted between studs and runners. Min nom thickness as indicated under Item 5. See Batts and Blankets (BKNV or BZJZ) Categories for names of Classified companies.

4A. Batts and Blankets* — (Optional) — Placed in stud cavities, any glass fiber or mineral wool insulation bearing the UL Classification Marking as to Surface Burning Characteristics and/or Fire Resistance. See Batts and Blankets (BKNV or BZJZ) Categories for names of Classified companies.

 Gypsum Board* — Gypsum panels with beveled, square or tapered edges, applied vertically or horizontally. Vertical joints centered over studs and staggered one stud cavity on opposite sides of studs. Vertical joints in adjacent layers (multilayer systems) staggered one stud cavity. Horizontal joints need not be backed by steel framing. Horizontal edge joints and horizontal butt joints on opposite sides of studs need not be staggered. Horizontal edge joints and horizontal butt joints in adjacent layers (multilayer systems) staggered a min of 12 in. The thickness and number of layers for the 1 hr, 2 hr. 3 hr and 4 hr ratings are as follows:

Gypsum Board Protection on Each Side of Wall

Rating, Hr	Min Stud Depth, in. Items 2, 2D, 2E, 2G and 2H	Min Stud Depth, in. Item 2A	No. of Layers & Thkns of Panel	Min Thkns of Insulation (Item 4)
1	3-1/2	3-5/8	1 layer, 5/8 in. thick	Optional
1	2-1/2	3-5/8	1 layer, 1/2 in. thick	1-1/2 in.
1	1-5/8	3-5/8	1 layer, 3/4 in. thick	Optional
2	1-5/8	2-1/2	2 layers, 1/2 in. thick	Optional
2	1-5/8	2-1/2	2 layers, 5/8 in. thick	Optional
2	3-1/2	3-5/8	1 layer, 3/4 in. thick	3 in.
3	1-5/8	2-1/2	3 layers, 1/2 in. thick	Optional
3	1-5/8	2-1/2	2 layers, 3/4 in. thick	Optional
3	1-5/8	2-1/2	3 layers, 5/8 in. thick	Optional
4	1-5/8	2-1/2	4 layers, 5/8 in. thick	Optional
4	1-5/8	2-1/2	4 layers, 1/2 in. thick	Optional
4	2-1/2	2-1/2	2 layers, 3/4 in. thick	2 in.

6. Fasteners — (Not shown) — For use with Items 2 and 2F - Type S or S-12 steel screws used to attach panels to stude (Item 2) or furring channels (Item 7). Single layer systems: 1 in. long for 1/2 and 5/8 in. thick panels or 1-1/4 in. long for 3/4 in. thick panels, spaced 8 in. OC when panels are applied horizontally, or 8 in. OC along vertical and bottom edges and 12 in. OC in the field when panels are applied vertically. Two layer systems: First layer- 1 in. long for 1/2 and 5/8 in. thick panels or 1-1/4 in. long for 3/4 in. thick panels, spaced 16 in. OC. Second layer- 1-5/8 in. long for 1/2 in., 5/8 in. thick panels or 2-1/4 in. long for 3/4 in. thick panels, spaced 16 in. OC with screws offset 8 in. from first layer. Three-layer systems: First layer- 1 in. long for 1/2 in., 5/8 in. thick panels, spaced 24 in. OC. Second layer- 1-5/8 in. long for 1/2 in., 5/8 in. thick panels, spaced 24 in. OC. Third layer- 2-1/4 in. long for 1/2 in., 5/8 in. thick panels or 2-5/8 in. long for 5/8 in. thick panels, spaced 12 in. OC. Screws offset min 6 in. from layer below. Four-layer systems: First layer- 1 in. long for 1/2 in., 5/8 in. thick panels, spaced 24 in. OC. Second layer- 1-5/8 in. long for 1/2 in., 5/8 in. thick panels, spaced 24 in. OC. Third layer- 2-1/4 in. long for 1/2 in. thick panels or 2-5/8 in. long for 5/8 in. thick panels, spaced 24 in. OC. Fourth layer- 2-5/8 in. long for 1/2 in. thick panels or 3 in. long for 5/8 in. thick panels, spaced 12 in. OC. Screws offset min 6 in. from layer below.

 Furring Channels — (Optional, not shown, for single or double layer systems) — Resilient furring channels fabricated from min 25 MSG corrosion-protected steel, spaced vertically a max of 24 in. OC. Flange portion attached to each intersecting stud with 1/2 in. long Type S-12 steel screws. Not for use with Item 5A and 5E.

8. Joint Tape and Compound — Vinyl or casein, dry or premixed joint compound applied in two coats to joints and screw heads of outer layers. Paper tape, nom 2 in. wide, embedded in first layer of compound over all joints of outer layer panels. Paper tape and joint compound may be omitted when gypsum panels are supplied with a square edge.

 Siding, Brick or Stucco — (Optional, not shown) — Aluminum, vinyl or steel siding, brick veneer or stucco, meeting the requirements of local code agencies, installed over gypsum panels. Brick veneer attached to studs with corrugated metal wall ties attached to each stud with steel screws, not more than each sixth course of brick.

 Caulking and Sealants* — (Optional, not shown) — A bead of acoustical sealant applied around the partition perimeter for sound control.

 Lead Batten Strips — (Not Shown, For Use With Item 5B) - Lead batten strips, min 1-1/2 in. wide, max 10 ft long with a max thickness of 0.125 in. Strips placed on the interior face of studs and attached from the exterior face of the stud with two 1 in. long Type S-12 pan head steel screws, one at the top of the strip and one at the bottom of the strip. Lead batten strips to have a purity of 99.9% meeting the Federal specification QQ-L-201f, Grade "C". Lead batten strips required behind vertical joints of lead backed gypsum wallboard (Item 5B) and optional at remaining stud locations. Required behind

11A. Lead Batten Strips — (Not Shown, For Use With Item 5H) Lead batten strips, 2 in. wide, max 10 ft long with a max thickness of 0.140 in. Strips placed on the face of studs and attached to the stud with two min. 1 in. long min. Type S-8 pan head steel screws, one at the top of the strip and one at the bottom of the strip or with one min. 1 in. long min. Type S-8 pan head steel screw at the top of the strip. Lead batten strips to have a purity of 99.9% meeting the Federal specification QQ-L-201f, Grades "A, B, C or D". Lead batten strips required behind vertical joints of lead backed gypsum wallboard and optional at remaining stud locations.

12. Lead Discs or Tabs — (Not Shown, For Use With Item 5B) - Used in lieu of or in addition to the lead batten strips (Item 11) or optional at other locations - Max 3/4 in. diam by max 0.125 in. thick lead discs compression fitted or adhered over steel screw heads or max 1/2 in. by 1-1/4 in. by max 0.125 in. thick lead tabs placed on gypsum boards (Item 5B) underneath screw locations prior to the installation of the screws. Lead discs or tabs to have a purity of 99.9% meeting the Federal specification QQ-L-201f, Grade "C".

12A. Lead Discs - (Not Shown, for use with Item 5H) Max 5/16 in. diam by max 0.140 in. thick lead discs compression fitted or adhered over steel screw heads. Lead discs to have a purity of 99.9% meeting the Federal Specification QQ-L-201f, Grades "A, B, C or D".

13. Lead Batten Strips — (Not Shown, For Use With Item 5E) Lead batten strips, 2 in. wide, max 10 ft long with a max thickness of 0.142 in. Strips placed on the face of studs and attached to the stud with two min. 1 in. long min. Type S-8 pan head steel screws, one at the top of the strip and one at the bottom of the strip or with one min. 1 in. long min. Type S-8 pan head steel screw at the top of the strip. Lead batten strips to have a purity of 99.9% meeting the Federal specification QQ-L-201f, Grade "C". Lead batten strips required behind vertical joints of lead backed gypsum wallboard (Item 5E) and optional at remaining stud locations.

14. Lead Tabs - (Not Shown, For Use With Item 5E) 2 in. wide, 5 in. long with a max thickness of 0.142 in. Tabs frictionfit around front face of stud, the stud folded back flange, and the back face of the stud. Tabs required at each location where a screw (that secures the gypsum boards, Item 5E) will penetrate the steel stud. Lead tabs to have a purity of 99.9% meeting the Federal specification QQ-L-201f, Grade "C". Lead tabs may be held in place with standard adhesive tape if necessary.



ARCHITECT OF RECORD

JAMES T. LALLI, AIA, ARCHITECT LICENSE NO. 32254

HESE DRAWINGS ARE NOT COMPLETE WITHOUT THE SEPARATE TYPE WRITTEN SPECIFICATIONS MANUAL WHICH ARE PART OF THE CONTRACT DOCUMENTS.


> DESCRIPTION ISSUE DATE 2022.07.15 | PERMIT SET

PROJECT INFORMATION PROJECT NO: JPM.27118 **PROTOTYPE**


2022.07.15 K.KELLY DRAWN BY: CHECKED BY: M.SIDES VERSION: SSE 1.00 SHEET TITLE


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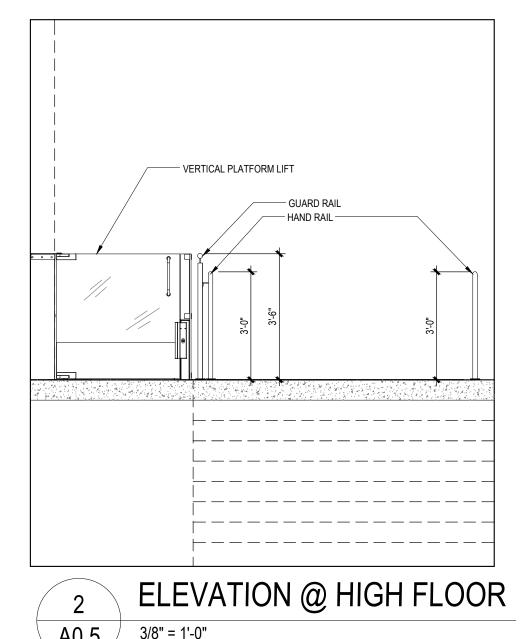
SHEET NUMBER

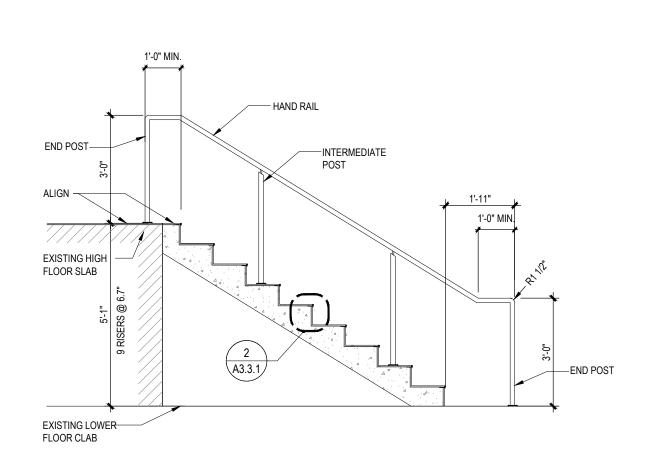


SECTION THRU STAIR




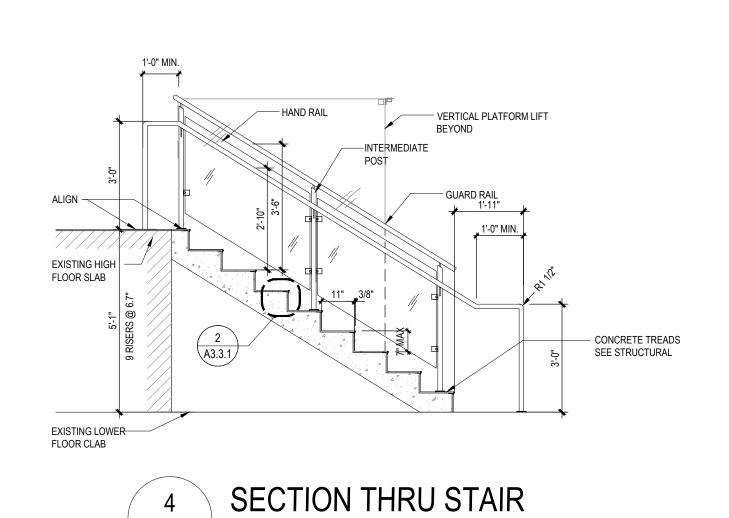


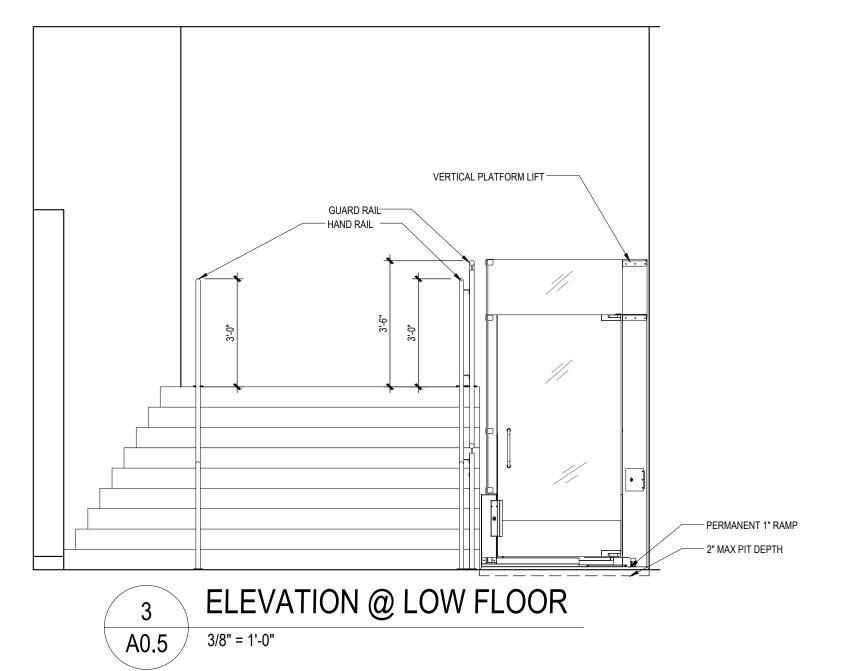

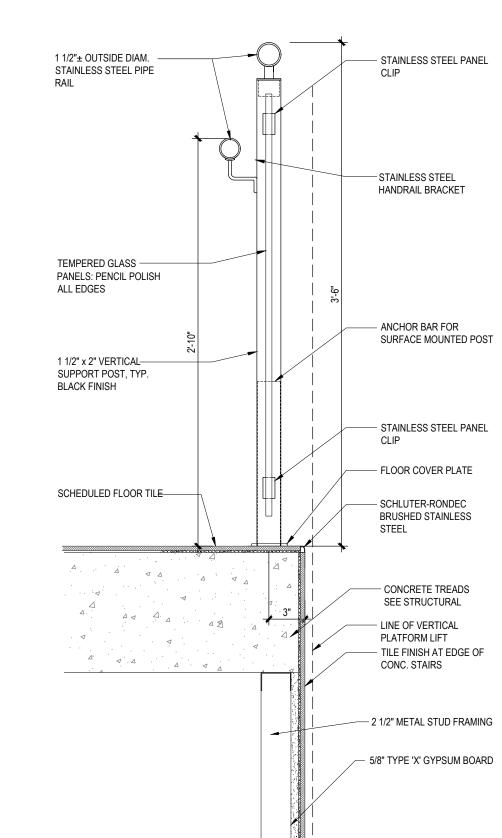



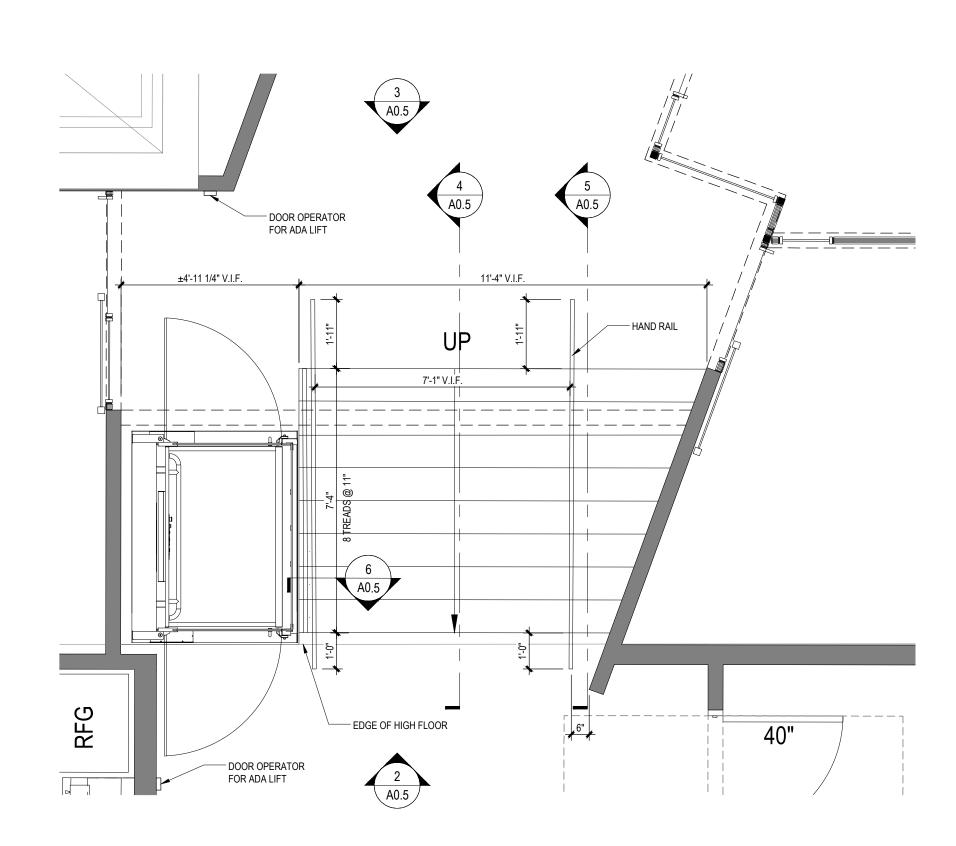

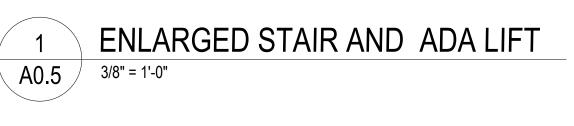

ALL COMPONENTS OF STAIR / RAMP RAILS AS MANUFACTURED BY BELLA STAIRS, LLC OR EQ. FINISH: BLACK ANODIZED ALUMINUM.

COLOR TO MATCH PW FRAME: STEELCASE FINISH - 4803 NEAR BLACK METALLIC



GROUP
9 Galen Street
Suite 117
Watertown, MA 02472
617.576.0007
core-states.com

ARCHITECT OF RECORD

JAMES T. LALLI, AIA, ARCHITECT
LICENSE NO. 32254

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ISSUE DATE DESCRIPTION

- 2022.07.15 PERMIT SET

PROJECT INFORMATION

PROJECT NO: JPM.27118

DATE: 2022.07.15

PROTOTYPE: 20.3

DRAWN BY: S. NUVELMAN

CHECKED BY: M.SIDES

VERSION: SSE_1.00

SHEET TITLE

INTERIOR STAIRS AND ADA LIFT DETAILS

SHEET NUMBER

A0.5

P:\J.P. Margan Chase\Cambridge, MA (Havard Square - 11) Friday, July 8, 2022 9:45:36 AM

DEMO LEGEND

EXISTING WALL CONSTRUCTION TO REMAIN

EXISTING CONSTRUCTION TO BE REMOVED

1 EXISTING STOREFRONT SYSTEM TO BE REMOVED EXISTING NON-BEARING LOW WALL CONSTRUCTION TO

BE REMOVED.

CHIP AWAY 2" OF CONCRETE SLAB FOR PROPOSED CHAIR LIFT: GC TO RADAR SCAN STRUCTURAL SLAB PRIOR TO PERFORMING ANY CORING/DRILLING TO AVOID TENSION TENDONS AND REBAR; SEE STRUCTURAL DRAWINGS FOR MORE INFORMATION

DEMO KEYNOTES

4 EXISTING STOREFRONT DOOR TO BE REMOVED

GENERAL DEMOLITION NOTES

A REMOVE ALL EXISTING CONSTRUCTIONS AND FINISHES NECESSARY FOR THE COMPLETION OF THE WORK AS DEPICTED ON THE DRAWINGS INCLUDING, BUT NOT LIMITED TO, ITEMS SHOWN ON THE PLANS WITH DASHED LINES. NECESSARY DISCONNECTS AND ALTERATIONS TO EXISTING MECHANICAL AND ELECTRICAL SYSTEMS SHALL BE INCLUDED. PATCH AS REQUIRED ALL CONSTRUCTIONS TO REMAIN IN ACCORDANCE WITH THE CONTRACT DRAWINGS. WHERE CONTRACTOR IS DESIGNATED TO MAKE REMOVALS, DISPOSAL OF MATERIALS IS THE RESPONSIBILITY OF THE CONTRACTOR. VERIFY WITH OWNER REP, THE REMOVAL/ DISPOSAL OF ANY COMPONENTS OF SALVAGEABLE VALUE.

B | ALL REMOVALS AND SALVAGE, UNLESS SPECIFICALLY NOTED OR REQUESTED | BY THE OWNER, SHALL BECOME THE PROPERTY OF THE CONTRACTOR.

REMOVE ONLY NON-LOAD BEARING CONSTRUCTION AND PARTITIONS. CONTRACTOR TO VERIFY, PRIOR TO REMOVAL, THAT NO STRUCTURAL COMPONENTS, I.E. BEARING WALLS, BEAMS, HEADERS, ETC. SUPPORTING FLOOR, ROOF, OR CEILING JOISTS ARE DESIGNATED FOR REMOVAL UNLESS SPECIFICALLY NOTED OTHERWISE IN ARCHITECTURAL AND STRUCTURAL PLANS. CONTACT THE ARCHITECT PRIOR TO REMOVAL OF ANY CONSTRUCTION IN QUESTION OR DEVIATING FROM THE DESIGN INTENT. CONTRACTOR'S NON-CONTACT OF ARCHITECT PRIOR TO REMOVAL OF ANY WORK INDICATES HIS COMPLETE UNDERSTANDING THAT NO LOAD BEARING OR STRUCTURAL WORK IS BEING ALTERED UNDER THIS CONTRACT.

D COORDINATE LIMIT OF DEMOLITION WITH THE CONSTRUCTION PLAN. E INSPECT, TEST, AND DISCONNECT UTILITY SERVICES AND MAIN SOURCE OR MAIN BRANCH WITHOUT DISRUPTING UTILITY SERVICE. SECURELY CAP AND/OR VALVE-OFF UTILITY SERVICE BEHIND FINISHED SURFACES OF

INTENDED CONSTRUCTION PRIOR TO DEMOLITION OPERATIONS. UTILITY

ELECTRIC FEEDS TO EXISTING LIGHTS TO BE REUSED WHEREVER POSSIBLE. WHERE EXISTING BUILDING ELEMENTS ARE TO REMAIN, INCLUDING BUT NOT LIMITED TO DOORS, WINDOWS, WINDOW TRIM, FASCIAS AND SOFFITS, PROTECT THOSE PARTS OF THE BUILDING WITH TEMPORARY FENCING OR PADDING AS NEEDED TO ENSURE NO DAMAGE TO THOSE ELEMENTS DURING DEMOLITION. ANY DAMAGE SUSTAINED TO EXISTING BUILDING ELEMENTS TO REMAIN MUST BE REPAIRED TO 'AS NEW' CONDITION AT THE CONTRACTOR'S

G EXISTING CONDITIONS SHOWN ON THE PLAN ARE BASED UPON THE BEST AVAILABLE PUBLIC AND/OR PRIVATE RECORDS AS SUPPLIED BY THE PROJECT OWNER AND/OR DATA OBTAINED FROM OWNERS OR OFFICIALS ASSOCIATED WITH THE PARTICULAR BUILDING. NEITHER THE OWNER NOR THE ARCHITECT GUARANTEE THE ACCURACY OR COMPLETENESS OF THIS INFORMATION AND ASSUME NO RESPONSIBILITY FOR INFORMATION NOT SHOWN ON EXISTING DOCUMENTS OR EXISTING INACCESSIBLE SPACES. WHEN INCLUDED IN THE AREA OF WORK, THE GENERAL CONTRACTOR MUST PERFORM EXPLORATORY DEMOLITION OF ALL INACCESSIBLE LOCATIONS AND NOTIFY THE ARCHITECT, ENGINEERS AND OWNER IMMEDIATELY OF THE CONDITIONS FOUND.

PROVIDE A MINIMUM OF TWO (2), 25 LB FIRE EXTINGUISHERS APPROVED FOR 'A', 'B' AND 'C' TYPE FIRES, TO BE LOCATED AT THE ENTRY/EXIT POINTS TO THE SITE. FIRE EXTINGUISHERS ARE TO REMAIN WORKING ORDER ON THE FLOORS WHEN CONTRACT WORK IS IN PROGRESS.

COORDINATE WITH OWNER/TENANT ON SECURITY SYSTEM REMOVAL AND RELOCATION.

DEMOLITION AND REMOVAL OPERATIONS SHALL NOT UNDERMINE THE STRUCTURAL INTEGRITY OF THE BUILDING. CUTTING METHODS THROUGH ANY STRUCTURAL ITEMS (CONCRETE, CMU, ETC.) TO BE APPROVED BY BUILDING OWNER/LANDLORD.


DEMOLITION SHALL BE DONE IN A NEAT WORKMAN LIKE MANNER, WITHIN THE LIMITS INDICATED ON THE DRAWINGS, AND IN ALL CASES, TO THE EXTENT NEEDED TO PRODUCE THE INTENDED WORK.

L COMPLETELY REMOVE ANY UN-USED ELECTRICAL AND DATA BACK TO SOURCE AS PER NEC GUIDELINES.


M ALL EXISTING FRAMED WALLS TO BE REMOVED AS INDICATED IN PLANS. WHERE EXISTING WALLS ARE TO REAMIN, PATCH GYPSUM DRYWALL OR PLASTER TO MATCH EXISTING THICKNESS AND MAINTAIN UNIFORM WALL THICKNESS. ALL EXPOSED PORTIONS OF WALL SHALL BE FINISHED WITH SPACKLING, SANDED, AND LEFT IN A PAINT READY CONDITION. REFER TO THE PROJECT MANUAL FOR THE REQUIRED LEVEL OF FINISH.

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FLOOR TO BE TRENCHED FOR ELECTRICAL AND PLUMBING CONNECTIONS. TRENCH FROM THE NEAREST TIE-IN LOCATION. REFER TO DRAWINGS FOR LOCATIONS OF J-BOX AND UTILITY LOCATIONS.

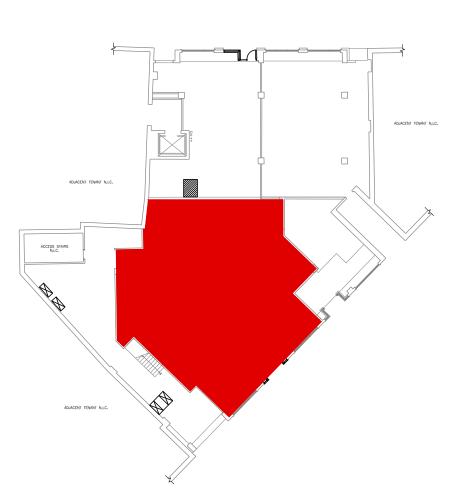

DEMO KEY PLAN



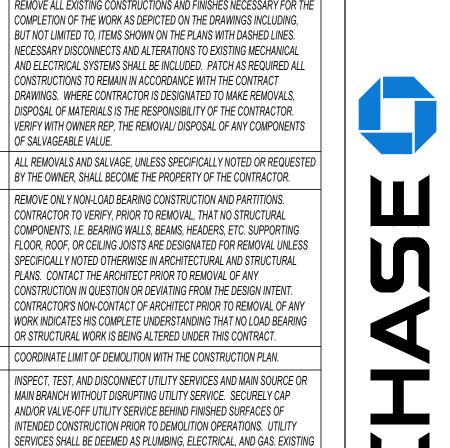

Suite 117 Watertown, MA 02472 617.576.0007 core-states.com ARCHITECT OF RECORD

JAMES T. LALLI, AIA, ARCHITECT LICENSE NO. 32254

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ISSUE DATE DESCRIPTION

2022.07.15 | PERMIT SET

PROJECT INFORMATION

PROJECT NO: JPM.27118 2022.07.15 PROTOTYPE: K.KELLY DRAWN BY: CHECKED BY: M.SIDES VERSION: SSE_1.00 SHEET TITLE

DEMOLITION PLAN

SHEET NUMBER

D1.1.1A

PARTIAL DEMOLITION PLAN

DEMO LEGEND

EXISTING WALL CONSTRUCTION TO REMAIN

EXISTING CONSTRUCTION TO BE REMOVED

1 EXISTING STOREFRONT SYSTEM TO BE REMOVED EXISTING NON-BEARING LOW WALL CONSTRUCTION TO

BE REMOVED.

CHIP AWAY 2" OF CONCRETE SLAB FOR PROPOSED CHAIR LIFT: GC TO RADAR SCAN STRUCTURAL SLAB PRIOR TO PERFORMING ANY CORING/DRILLING TO AVOID TENSION TENDONS AND REBAR; SEE STRUCTURAL DRAWINGS FOR MORE INFORMATION

4 EXISTING STOREFRONT DOOR TO BE REMOVED

DEMO KEYNOTES

GENERAL DEMOLITION NOTES

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E INSPECT, TEST, AND DISCONNECT UTILITY SERVICES AND MAIN SOURCE OR MAIN BRANCH WITHOUT DISRUPTING UTILITY SERVICE. SECURELY CAP AND/OR VALVE-OFF UTILITY SERVICE BEHIND FINISHED SURFACES OF INTENDED CONSTRUCTION PRIOR TO DEMOLITION OPERATIONS. UTILITY SERVICES SHALL BE DEEMED AS PLUMBING, ELECTRICAL, AND GAS. EXISTING ELECTRIC FEEDS TO EXISTING LIGHTS TO BE REUSED WHEREVER POSSIBLE.

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STRUCTURAL INTEGRITY OF THE BUILDING. CUTTING METHODS THROUGH ANY STRUCTURAL ITEMS (CONCRETE, CMU, ETC.) TO BE APPROVED BY BUILDING OWNER/LANDLORD.


K DEMOLITION SHALL BE DONE IN A NEAT WORKMAN LIKE MANNER, WITHIN THE LIMITS INDICATED ON THE DRAWINGS, AND IN ALL CASES, TO THE EXTENT NEEDED TO PRODUCE THE INTENDED WORK.

L COMPLETELY REMOVE ANY UN-USED ELECTRICAL AND DATA BACK TO SOURCE AS PER NEC GUIDELINES.

M ALL EXISTING FRAMED WALLS TO BE REMOVED AS INDICATED IN PLANS. WHERE EXISTING WALLS ARE TO REAMIN, PATCH GYPSUM DRYWALL OR PLASTER TO MATCH EXISTING THICKNESS AND MAINTAIN UNIFORM WALL THICKNESS. ALL EXPOSED PORTIONS OF WALL SHALL BE FINISHED WITH SPACKLING, SANDED, AND LEFT IN A PAINT READY CONDITION. REFER TO THE PROJECT MANUAL FOR THE REQUIRED LEVEL OF FINISH.

N ALL EXISTING FRAMED WALLS TO BE REMOVED AS INDICATED IN PLANS. WHERE EXISTING WALLS ARE TO REAMIN, PATCH GYPSUM DRYWALL OR PLASTER TO MATCH EXISTING THICKNESS AND MAINTAIN UNIFORM WALL THICKNESS. ALL EXPOSED PORTIONS OF WALL SHALL BE FINISHED WITH SPACKLING, SANDED, AND LEFT IN A PAINT READY CONDITION. REFER TO THE PROJECT MANUAL FOR THE REQUIRED LEVEL OF FINISH.

O FLOOR TO BE TRENCHED FOR ELECTRICAL AND PLUMBING CONNECTIONS. TRENCH FROM THE NEAREST TIE-IN LOCATION. REFER TO DRAWINGS FOR LOCATIONS OF J-BOX AND UTILITY LOCATIONS.

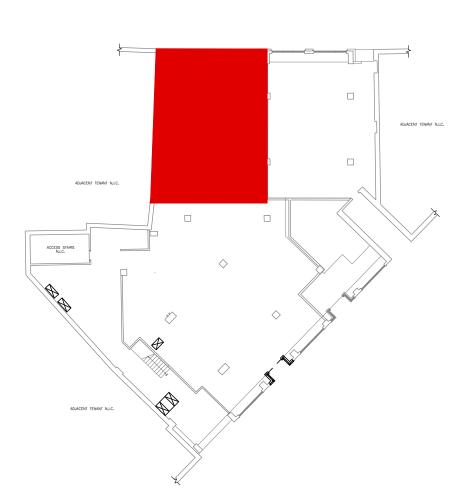

DEMO KEY PLAN





Watertown, MA 02472 617.576.0007 ARCHITECT OF RECORD

JAMES T. LALLI, AIA, ARCHITECT

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ISSUE DATE DESCRIPTION 2022.07.15 | PERMIT SET

PROJECT INFORMATION PROJECT NO: JPM.27118 2022.07.15 PROTOTYPE: K.KELLY DRAWN BY: M.SIDES CHECKED BY: VERSION: SSE_1.00

DEMOLITION PLAN

SHEET NUMBER

SHEET TITLE


D1.1.1B

PARTIAL DEMOLITION PLAN


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NORTH ELEVATION (BRATTLE STREET)

DEMO KEYNOTES

- EXISTING STOREFRONT SILL TO BE REMOVED.
- EXISTING STOREFRONT DOOR TO BE REMOVED

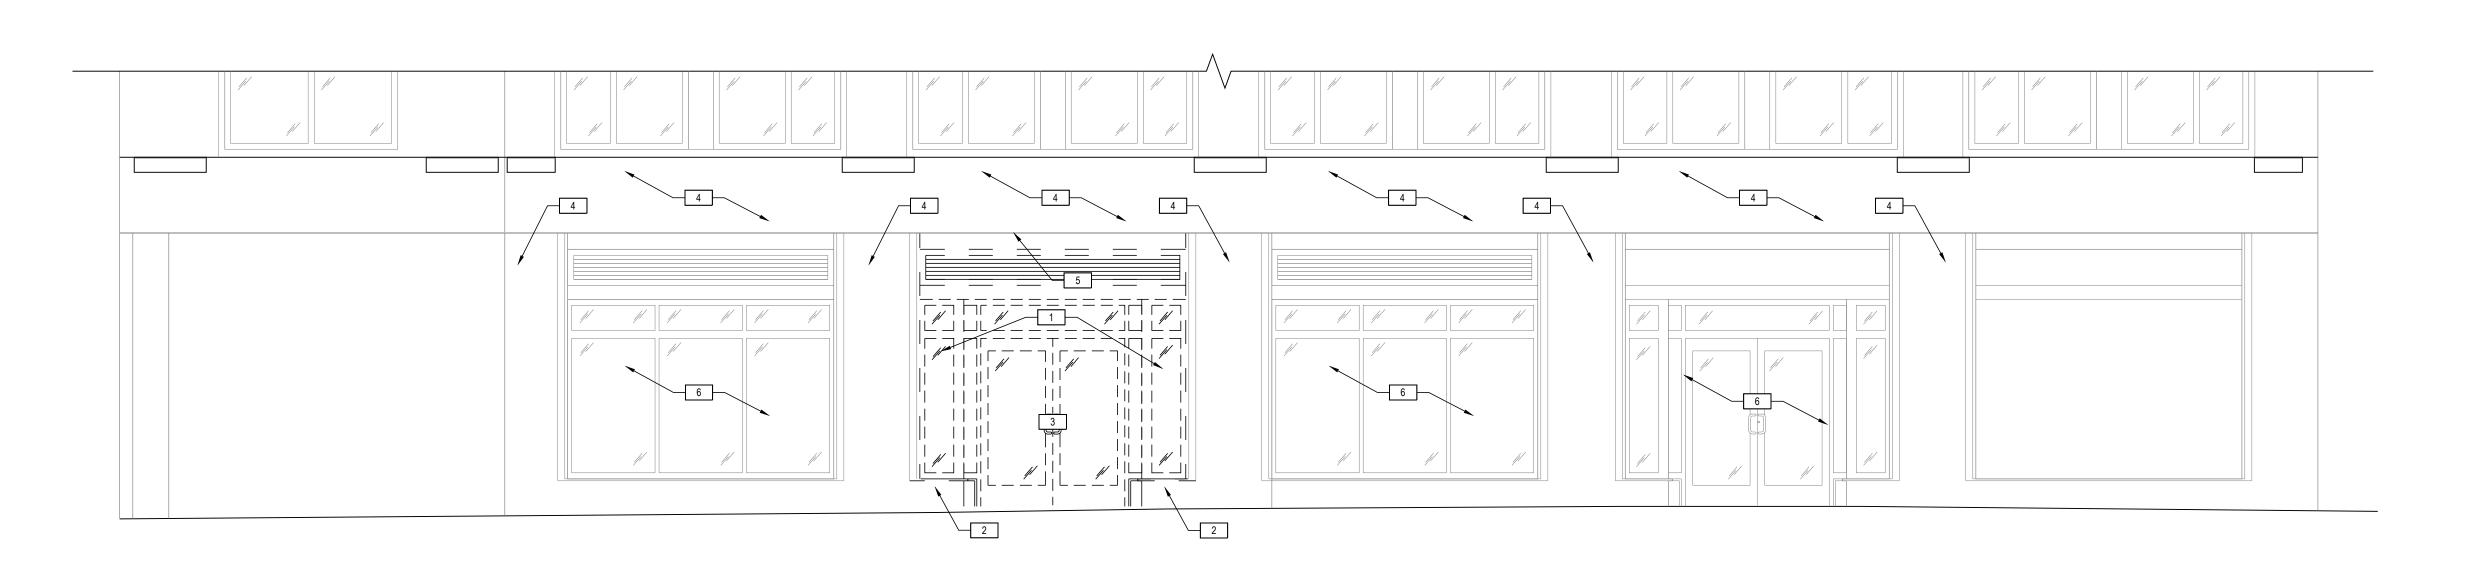6 EXISTING STOREFRONT SYSTEM TO REMAIN.

- 4 PRESERVE & PROTECT EXISTING FACADE
- CONSTRUCTION.

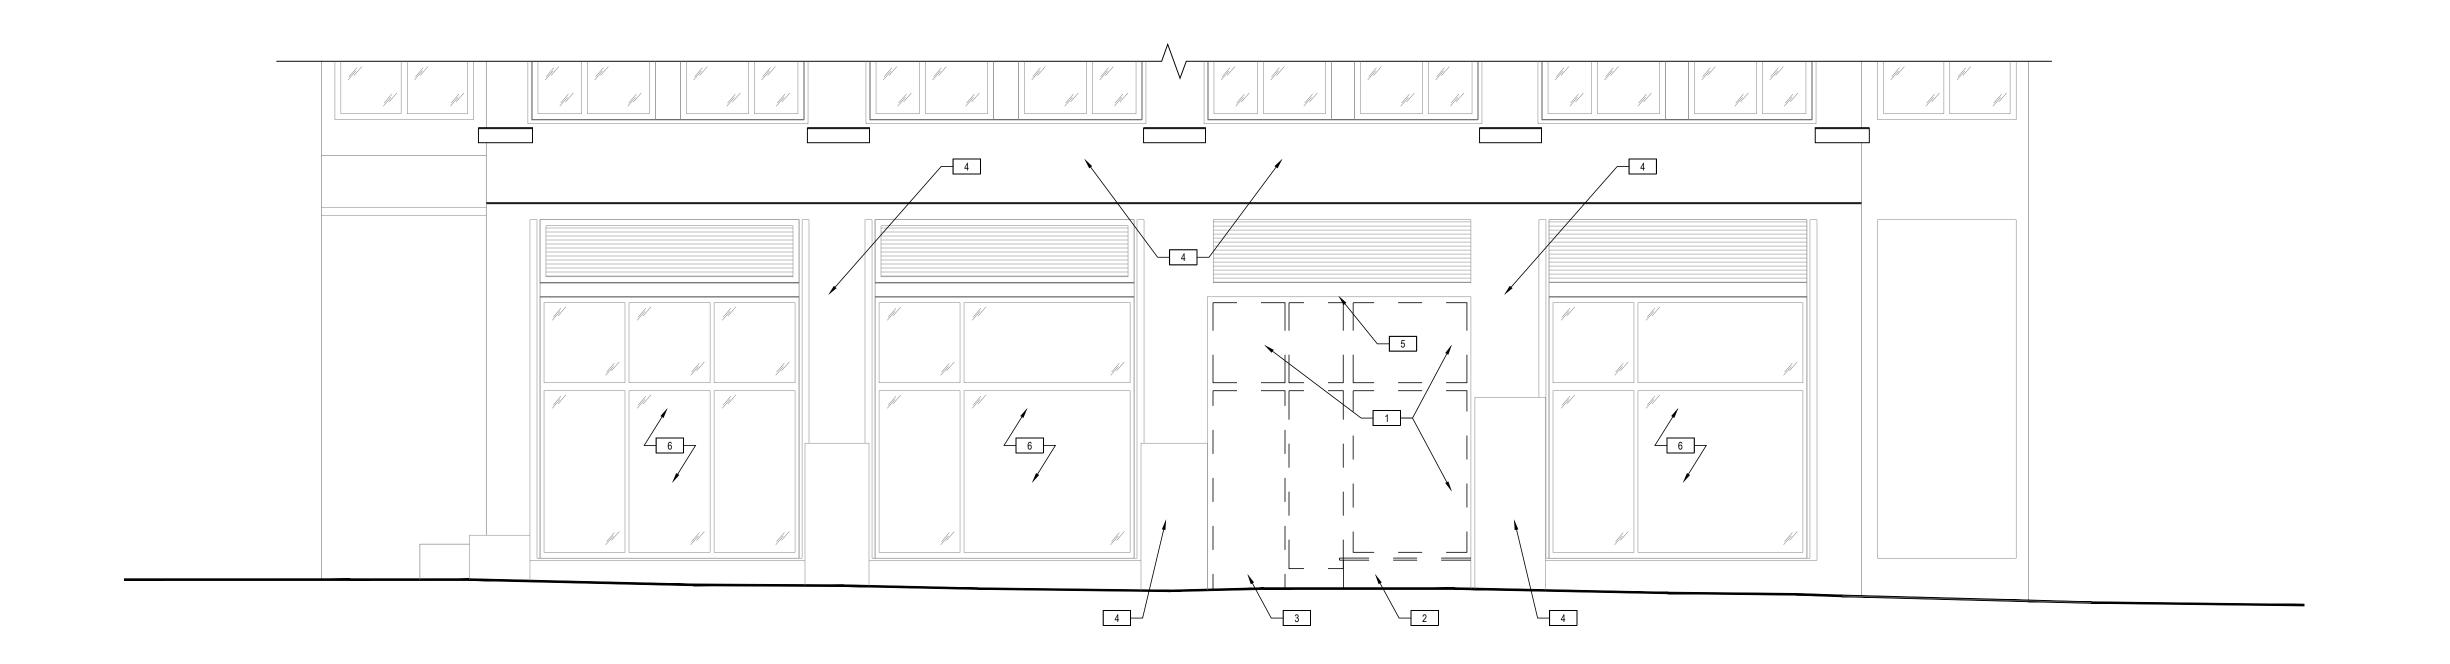

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PROJECT INFORMATION PROJECT NO:

2022.07.15 PROTOTYPE: S.KRAMER M.SIDES CHECKED BY: SSE_1.00

DEMOLITION

ELEVATIONS

SHEET TITLE

SHEET NUMBER

DEMO LEGEND

EXIST CONSTRUCTION TO BE REMOVED

EXIST CONSTRUCTION TO REMAIN

D2.1.0

FIRE EXSTINGUISHER LEGEND

TYPE 1 - 10 LB. DRY CHEMICAL (ABC) MP10 W/ ARCHITECTURAL SERIES CABINET (WHERE NOTED) - 2409-6R VERTICAL DUO LAMINATED SAFETY GLASS ROUGH OPENING = 25' X 10-1/2' X 4" MOUNT AT 50" A.F.F. TO TOP OF OPENING

ACCESSIBILITY NOTES

WHILE IT IS THE INTENT OF THE ARCHITECT, HIS EMPLOYEES, AND ASSIGNS TO ADHERE TO ALL ASPECTS AND REGULATIONS OF THE AMERICANS WITH DISABILITIES ACT (ADA) AND LOCAL ACCESSIBILITY CODES, THE CONTRACTOR SHALL NOT BE RELIEVED OF SOLE RESPONSIBILITY TO VERIFY ALL REQUIREMENTS OF SAID ACTS AS PERTAINING TO CONTRACT DOCUMENT CONTAINED HEREIN PRIOR TO COMMENCEMENT OF ANY WORK. HE SHALL ALSO BE RESPONSIBLE TO IMMEDIATELY NOTIFY DESIGNER OF POSSIBLE DISCREPANCIES. HE SHALL ALSO PAY SPECIAL ATTENTION TO ITEMS LISTED BELOW:

A. REFER TO A0.1, COVER SHEET, FOR CODE SUMMARY & BUILDING

8. REFER TO ARCHITECTURAL FLOOR PLANS FOR BUILDING

REQUIRED ACCESSIBLE PARKING AREAS, CURBS, CROSSWALKS, SIGNS, ETC. SHALL COMPLY WITH CURRENT STATE AND LOCAL

). TACTILE EXIT SIGNS SHALL BE PROVIDED AT THE FOLLOWING LOCATIONS:

D.A. EACH GRADE LEVEL EXTERIOR DOOR SHALL BE IDENTIFIED BY A TACTILE EXIT SIGN WITH THE WORD "EXIT".

D.B. EACH EXIT, EXIT ACCESS DOOR FROM AN INTERIOR ROOM

OR AREA TO A CORRIDOR OR HALLWAY THAT IS REQUIRED TO HAVE A VISUAL EXIT SIGN, SHALL BE IDENTIFIED BY A TACTILE EXIT SIGN WITH THE WORDS, "EXIT ROUTE". THE BOTTOM 10" OF ALL DOORS SHALL HAVE A SMOOTH

UNINTERRUPTED SURFACE TO ALLOW DOOR TO BE OPENED BY A WHEELCHAIR FOOTREST.

NO THRESHOLD SHALL EXCEED 1/2" IN HEIGHT. 6. HAND-OPERATED DOOR OPENING HARDWARE SHALL NOT REQUIRE

DOORS SHALL NOT EXCEED 5 LBS.

TIGHT GRASPING OR TWISTING OF THE WRIST IN ORDER TO OPERATE, AND SHALL BE MOUNTED NO HIGHER THAN 48" A.F.F. . MAXIMUM FORCE REQUIRED TO OPEN EXTERIOR DOORS SHALL NOT EXCEED 8.5 LBS. MAXIMUM FORCE REQUIRED TO OPEN INTERIOR

IF A DOOR HAS A CLOSER, THEN THE SWEEP PERIOD OF THE CLOSER SHALL BE ADJUSTED SO THAT FROM AN OPEN POSITION OF 70 DEGREES, THE DOOR WILL TAKE AT LEAST 3 SECONDS TO MOVE TO A POINT 5 INCHES FROM THE LATCH, MEASURED TO THE LEADING EDGE OF THE DOOR.

FAUCET CONTROL AND OPERATING MECHANISMS SHALL BE OPERABLE WITH ONE HAND AND SHALL NOT REQUIRE TIGHT GRASPING, PINCHING, OR TWISTING OF THE WRIST. THE FORCE REQUIRED TO ACTIVATE CONTROLS SHALL BE NO GREATER THAN 5 LBS. LEVER OPERATED, FLUSH TYPE AND ELECTRONICALLY OPERATED MECHANISMS ARE EXAMPLES OF ACCEPTABLE DESIGNS. IF SELF CLOSING VALVES ARE USED, THE FAUCET SHALL REMAIN OPEN FOR A MINIMUM OF 10 SECONDS.

PROVIDE SIGNAGE WITH INTERNATIONAL SYMBOL OF ACCESSIBILITY IN ACCORDANCE WITH ANSI A117.1 (LATEST EDITION) AND ADA REQUIREMENT.

SIGNAGE HEIGHT SHALL BE IN ACCORDANCE WITH ALL APPLICABLE NATIONAL, STATE AND LOCAL ACCESSABILITY CODES.

TO THE LATCH SIDE OF THE RESPECTIVE RESTROOM DOOR. . 50% OF CABINET SHELVING SHALL BE ADA ACCESSIBLE.


O. ALL ACCESSIBLE LANDINGS SHALL NOT EXCEED THE 2% MAX SLOPE IN ALL DIRECTIONS.

P. IF FIRE ALARM SYSTEMS ARE REQUIRED, REFER TO FIRE ALARM DRAWINGS FOR PULL STATIONS AND STROBE MOUNTING HEIGHTS AND LOCATIONS.

EXITING REQUIREMENTS

ı				
I			REQUIRED	PROVIDED
ı	COMMON PATH OF EGRESS TRAVEL MAX	=	100'	56'
	MINIMUM NUMBER OF EXITS	=	1 EXITS	2
	TRAVEL DISTANCE MAX	=	300'	121'
	DEAD-END CORRIDOR MAX	=	50'	48'
	DIAGONAL OF BUSINESS AREA	=	122'-7"	
	EGRESS DOOR SEPARATION:			
	1/3 MIN. DISTANCE OF DIAGONAL W	V/ AUTC	MATIC SPRINE	KLER SYSTEM
	122 7" / 2	_	40' 10"	100' 7"


LIFE SAFETY LEGEND

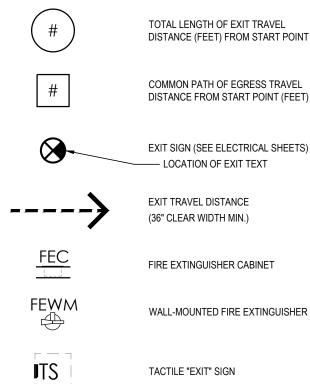

EGRESS CAPACITY LEGEND

Α	OCCUPANT LOAD AT EXIT (# OF OCCUPANTS / # DOORS
В	REQUIRED EXIT WIDTH (0.2" x PER OCCUPANT - INCHES)
С	PROVIDED EXIT WIDTH (INCHES)

WALL LEGEND

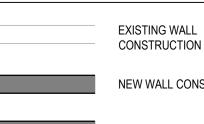

ISA

CONSTRUCTION TO REMAIN NEW WALL CONSTRUCTION

1-HR RATED WALL CONSTRUCTION

LIFE SAFETY & ACCESSIBILITY PLAN

PROJECT INFORMATION

JPM.27118 2022.07.15

K.KELLY

M.SIDES

SSE_1.00

PROJECT NO:

PROTOTYPE:

DRAWN BY:

VERSION:

SHEET TITLE

CHECKED BY:

SHEET NUMBER

A1.1.0

GROUP

Suite 117 Watertown, MA 02472 617.576.0007 core-states.com

ARCHITECT OF RECORD

JAMES T. LALLI, AIA, ARCHITECT LICENSE NO. 32254

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ISSUE DATE DESCRIPTION

2022.07.15 | PERMIT SET

1 LIFE SAFETY & ACCESSIBILITY PLAN
A1.1.0 1/8" = 1'-0"

TRANSACTIÒN (

ENTRY

72" C

SECONDARY

ENTRY

RANSACTION


// VEST/BULE


ADJACENT TENANT N.I.C.

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ISSUE DATE DESCRIPTION - 2022.07.15 PERMIT SET

PROJECT INFORMATION JPM.27118
2021.07.13
20.3
K.KELLY
M.SIDES
SSE_1.00 PROJECT NO: PROTOTYPE: DRAWN BY: CHECKED BY: VERSION: SHEET TITLE

LIFE SAFETY & ACCESSIBILITY PLAN

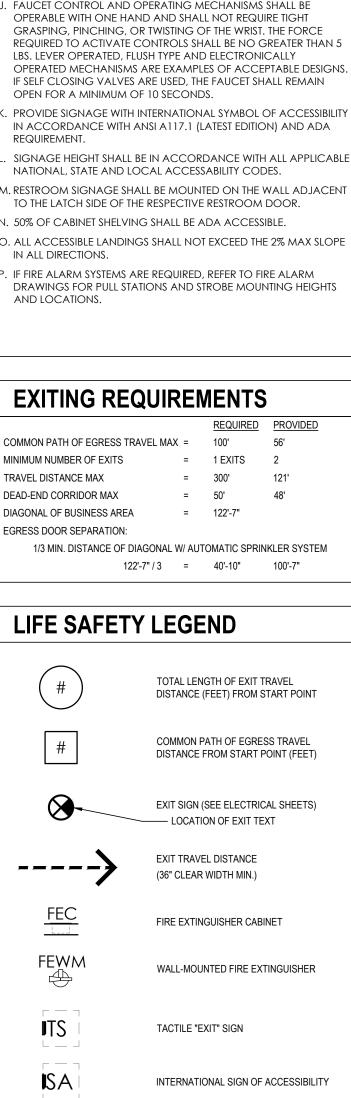
SHEET NUMBER

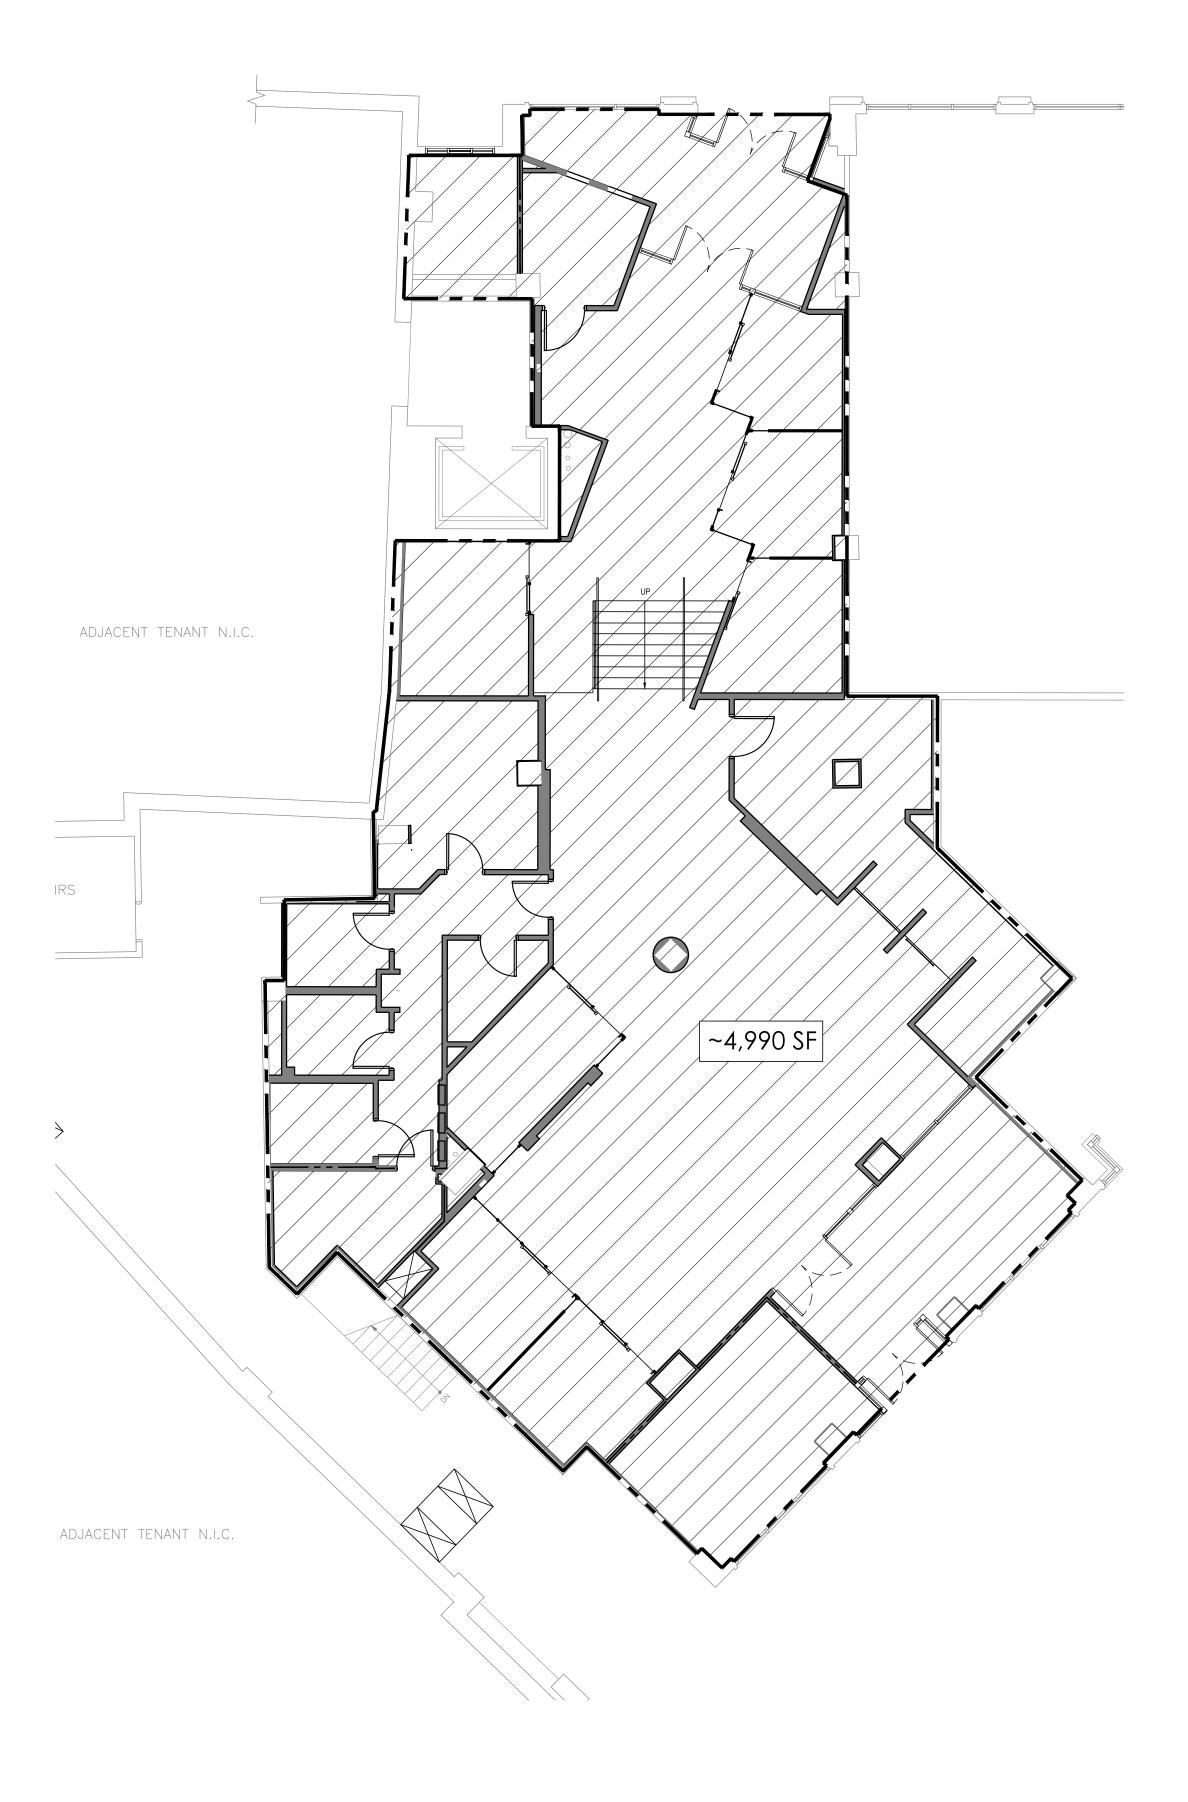
A1.1.0

1 SQUARE FOOTAGE CALCULATION

X1.1.0 1/8" = 1'-0"



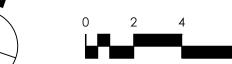

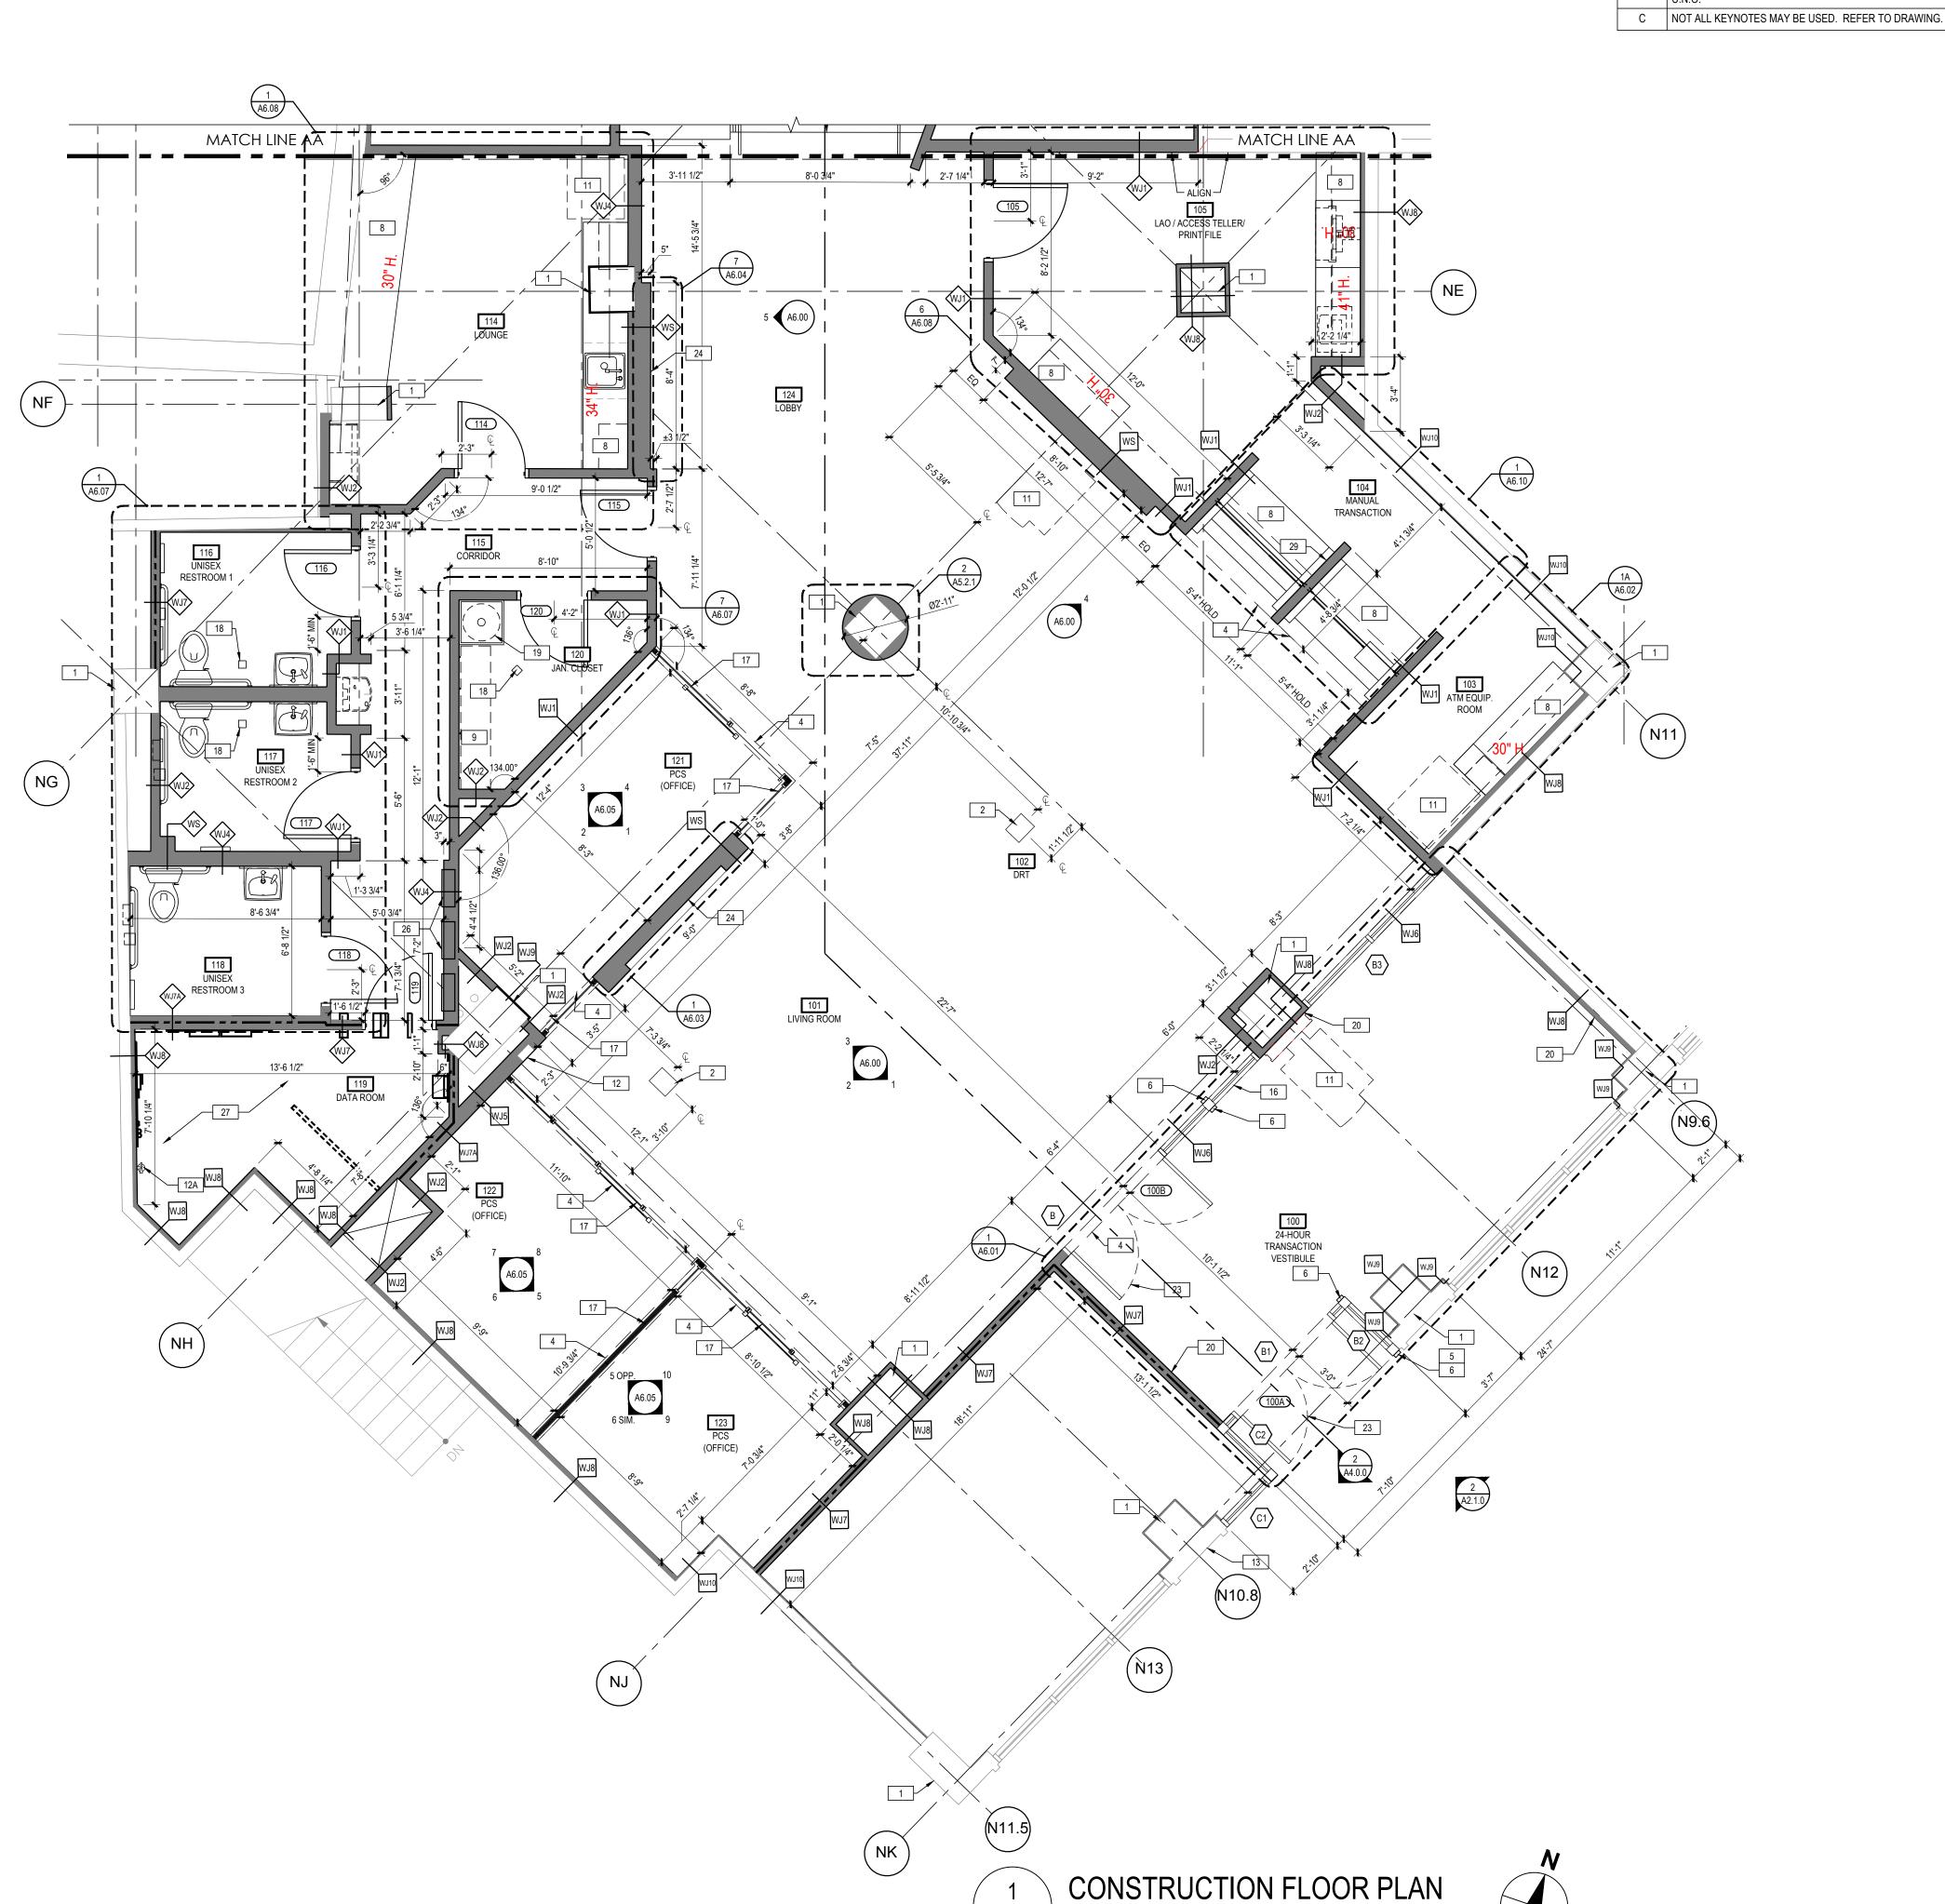

GENERAL FLOOR PLAN NOTES FLOOR PLAN KEYNOTES

A ALL INTERIOR WALL PARTITIONS TO BE 'WJ' U.N.O. (SEE SHEET A3.1.0 FOR ADDITIONAL INFORMATION).

2 POWER DATA FLOOR BOX: REFER TO ELECTRICAL DRAWINGS FOR ADDITIONAL INFORMATION, COORDINATE B ALL DOOR FRAMES TO HAVE 5" RETURN ON HINGE SIDE

LOCATIONS WITH STRUCTURAL DRAWINGS. NOT USED SOFFIT / BULKHEAD ABOVE: REFER TO REFLECTED CEILING PLANS, SECTIONS, DETAILS AND INTERIOR ELEVATIONS. PROVIDE DEFLECTION TRACK AT UNDERSIDE OF ROOF / FLOOR STRUCTURE ABOVE TO ALLOW BULKHEAD TO REST ON DEMOUNTABLE PARTITION SYSTEM BELOW.

CARD READER: REFER TO EXTERIOR ELEVATIONS AND ELECTRICAL DRAWINGS FOR ADDITIONAL INFORMATION. 6 AUTOMATIC DOOR OPERATOR SYSTEM: REFER TO ELEVATIONS AND DOOR SCHEDULE.

7 NOT USED

1 EXISTING COLUMN TO REMAIN

CUSTOM SHOP-FABRICATED BUILT-IN MILLWORK: RFER TO INTERIOR ELEVATIONS - SUBMIT SHOP DRAWINGS AND FINISH SAMPLES TO ARCHITECT FOR APPROVAL.

9 ADJUSTABLE SHELVES: REFER TO INTERIOR ELEVATIONS- PROVIDE BLOCKING IN WALL AS REQUIRED

10 NOT USED

EQUIPMENT/ APPLIANCE:

REFER TO EQUIPMENT INSTALLATION MANUAL -COORDINATE WITH EQUIPMENT INSTALLER - PROVIDE ELECTRICAL, DATA, AND SECURITY ROUGH-IN WORK AS REQUIRED - FRAME WALL OPENING AND PREPARE FLOOR SUBSTRATE AS REQUIRED. PROVIDE BLOCKING IN WALL AS REQUIRED.

FIRE EXTINGUISHER AND CABINET: PROVIDE THE MINIMUM NUMBER REQUIRED AND COORDINATE FINAL LOCATIONS WITH LOCAL FIRE MARSHALL- PROVIDE ADJACENT ACCESSIBILITY CLEARANCES.

12A WALL-MOUNT FIRE EXTINGUISHER: CARBON DIOXIDE ONLY / WATER OR DRY CHEMICAL TYPES NOT PERMITTED, CLASS C OR B-C, 5 LB. OR SMALLER, SET WALL BRACKET TO KEEP HANDLE <48" A.F.F.

13 KNOX BOX: MOUNTED 60" A.F.F. FLUSH WITH

SURROUNDING WALL SURFACE. VERIFY LOCATION WITH LOCAL FIRE MARSHALL TO ENSURE COMPLIANCE. PAINT TO BLEND WITH SURROUNDING WALL FINISH.

14 NEW EXTERIOR STOREFRONT GLAZING SYSTEM; SEE A3.2.1 FOR MORE INFORMATION.

15 RECESSED ATM KEY BOX MOUNTED AT 36" A.F.F.

REFER TO INTERIOR ELEVATIONS 17 DEMOUNTABLE PARTITION SYSTEM WITH INTEGRAL DOORS AND POWER, DATA AND SECURITY CONDUIT SYSTEMS, ANCHORED TO BUILDING WALLS, SUBFLOOR,

18 FLOOR DRAIN: REFER TO PLUMBING DRAWINGS FOR ADDITIONAL INFORMATION.

AND BULKHEADS

19 MOP SINK: REFER TO PLUMBING DRAWINGS FOR ADDITIONAL INFORMATION.

20 INSTALL SECURITY MESH ABOVE CEILING TO STRUCTURAL DECK TO SECURE TRANSACTION VESTIBULE. TYPICAL AT ALL VESTIBULE WALLS. REFER TO ELEVATIONS.

SPANDREL GLASS: OPACI-COAT #3-0770 WARM GREY WINDOW COATING. SEE SPECIFICATIONS. 22 NOT USED

23 ACTIVE DOOR LEAF FOR AUTOMATIC DOOR OPERATOR. 24 AUDIO/VIDEO EQUIPMENT: REFER TO SHEET A1.1.4 FOR SOLUTION TYPE AND

ADDITIONAL INFORMATION. 25 NOT USED 26 ELECTRICAL PANELS:

LOCKING ENCLOSURES FOR ELECTRICAL MAIN SERVICE AND DISTRIBUTION 27 PROVIDE PAINTED F.T. PLYWOOD TO 8' A.F.F. AT ALL DATA ROOM WALLS.

AT MANUAL TRANSACTION STATION. REFER TO SHEET

WALL LEGEND

1-HR RATED WALL CONSTRUCTION

EXISTING WALL
CONSTRUCTION TO REMAIN

NEW WALL CONSTRUCTION

28 NOT USED 29 G.C. TO INSTALL PLASTIC GROMMET AND PVC CONDUIT

A6.10 FOR ADDITIONAL INFORMATION.

16 STOREFRONT GLAZING SYSTEM INTERIOR PARTITION -GROUP Watertown, MA 02472 617.576.0007 ARCHITECT OF RECORD

JAMES T. LALLI, AIA, ARCHITECT LICENSE NO. 32254

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ISSUE DATE DESCRIPTION 2022.07.15 PERMIT SET

PROJECT INFORMATION PROJECT NO:

JPM.27118 2022.07.15 PROTOTYPE: K.KELLY DRAWN BY: M.SIDES CHECKED BY: VERSION: SSE_1.00

CONSTRUCTION FLOOR PLAN

SHEET NUMBER

SHEET TITLE

A1.1.1A

- C NOT ALL KEYNOTES MAY BE USED. REFER TO DRAWING.

GENERAL FLOOR PLAN NOTES

- A ALL INTERIOR WALL PARTITIONS TO BE 'WJ' U.N.O. (SEE SHEET A3.1.0 FOR ADDITIONAL INFORMATION). B ALL DOOR FRAMES TO HAVE 5" RETURN ON HINGE SIDE

FLOOR PLAN KEYNOTES

- 1 EXISTING COLUMN TO REMAIN 2 POWER DATA FLOOR BOX: REFER TO ELECTRICAL
 - DRAWINGS FOR ADDITIONAL INFORMATION, COORDINATE LOCATIONS WITH STRUCTURAL DRAWINGS.
 - NOT USED SOFFIT / BULKHEAD ABOVE: REFER TO REFLECTED CEILING PLANS, SECTIONS,
 - DETAILS AND INTERIOR ELEVATIONS. PROVIDE DEFLECTION TRACK AT UNDERSIDE OF ROOF / FLOOR STRUCTURE ABOVE TO ALLOW BULKHEAD TO REST ON DEMOUNTABLE PARTITION SYSTEM BELOW. CARD READER: REFER TO EXTERIOR ELEVATIONS AND
 - ELECTRICAL DRAWINGS FOR ADDITIONAL INFORMATION. 6 AUTOMATIC DOOR OPERATOR SYSTEM: REFER TO
 - ELEVATIONS AND DOOR SCHEDULE.
 - 7 NOT USED
 - 8 CUSTOM SHOP-FABRICATED BUILT-IN MILLWORK: RFER TO INTERIOR ELEVATIONS - SUBMIT SHOP DRAWINGS AND FINISH SAMPLES TO ARCHITECT FOR APPROVAL.
 - 9 ADJUSTABLE SHELVES: REFER TO INTERIOR ELEVATIONS- PROVIDE BLOCKING IN WALL AS REQUIRED
 - 10 NOT USED

AS REQUIRED.

- EQUIPMENT/ APPLIANCE: REFER TO EQUIPMENT INSTALLATION MANUAL -COORDINATE WITH EQUIPMENT INSTALLER - PROVIDE ELECTRICAL, DATA, AND SECURITY ROUGH-IN WORK AS REQUIRED - FRAME WALL OPENING AND PREPARE FLOOR SUBSTRATE AS REQUIRED. PROVIDE BLOCKING IN WALL
- 12 FIRE EXTINGUISHER AND CABINET: PROVIDE THE MINIMUM NUMBER REQUIRED AND COORDINATE FINAL LOCATIONS WITH LOCAL FIRE MARSHALL- PROVIDE ADJACENT ACCESSIBILITY CLEARANCES.
- 12A WALL-MOUNT FIRE EXTINGUISHER: CARBON DIOXIDE ONLY / WATER OR DRY CHEMICAL TYPES NOT PERMITTED, CLASS C OR B-C, 5 LB. OR SMALLER, SET WALL BRACKET TO KEEP HANDLE <48" A.F.F.
- 13 KNOX BOX: MOUNTED 60" A.F.F. FLUSH WITH SURROUNDING WALL SURFACE. VERIFY LOCATION WITH LOCAL FIRE MARSHALL TO ENSURE COMPLIANCE. PAINT TO BLEND WITH SURROUNDING WALL FINISH.
- 14 NEW EXTERIOR STOREFRONT GLAZING SYSTEM; SEE A3.2.1 FOR MORE INFORMATION.
- 15 RECESSED ATM KEY BOX MOUNTED AT 36" A.F.F.
- 16 STOREFRONT GLAZING SYSTEM INTERIOR PARTITION -REFER TO INTERIOR ELEVATIONS 17 DEMOUNTABLE PARTITION SYSTEM WITH INTEGRAL DOORS AND POWER, DATA AND SECURITY CONDUIT
- SYSTEMS, ANCHORED TO BUILDING WALLS, SUBFLOOR, AND BULKHEADS 18 FLOOR DRAIN: REFER TO PLUMBING DRAWINGS FOR
- ADDITIONAL INFORMATION. 19 MOP SINK: REFER TO PLUMBING DRAWINGS FOR
- ADDITIONAL INFORMATION.
- 20 INSTALL SECURITY MESH ABOVE CEILING TO STRUCTURAL DECK TO SECURE TRANSACTION VESTIBULE. TYPICAL AT ALL VESTIBULE WALLS.
- REFER TO ELEVATIONS. SPANDREL GLASS: OPACI-COAT #3-0770 WARM GREY
- WINDOW COATING. SEE SPECIFICATIONS. 22 NOT USED
- 23 ACTIVE DOOR LEAF FOR AUTOMATIC DOOR OPERATOR. 24 AUDIO/VIDEO EQUIPMENT: REFER TO SHEETS A1.1.4A & A1.1.4B FOR SOLUTION TYPE
- AND ADDITIONAL INFORMATION.
- 25 NOT USED 26 ELECTRICAL PANELS: LOCKING ENCLOSURES FOR ELECTRICAL MAIN SERVICE
- AND DISTRIBUTION 27 PROVIDE PAINTED F.T. PLYWOOD TO 8' A.F.F. AT ALL
- DATA ROOM WALLS. 28 NOT USED
- 29 G.C. TO INSTALL PLASTIC GROMMET AND PVC CONDUIT AT MANUAL TRANSACTION STATION. REFER TO SHEET A6.10 FOR ADDITIONAL INFORMATION.

WALL LEGEND

EXISTING WALL

CONSTRUCTION TO REMAIN

NEW WALL CONSTRUCTION

1-HR RATED WALL CONSTRUCTION





ARCHITECT OF RECORD

JAMES T. LALLI, AIA, ARCHITECT

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PROJECT INFORMATION PROJECT NO: JPM.27118 2022.07.15 PROTOTYPE: K.KELLY DRAWN BY: M.SIDES CHECKED BY: SSE_1.00 VERSION:

> CONSTRUCTION FLOOR PLAN

SHEET NUMBER

SHEET TITLE

A1.1.1B

GENERAL FINISH NOTES

- A. REFER TO SHEET A0.1 FOR FLAME SPREAD REQUIREMENTS.
- B. REFER TO SHEET A3.3.1 FOR INTERIOR FINISH AND FLOOR TRANSITION SCHEDULES.
- C. RUGS ARE SECURED WITH A DOUBLE SIDED STICKY
 MESH, TACTILES, AND OPTITAPE TO SECURE
 TRANSITION EDGING TO THE FLOOR. TRANSITION
 EDGING TO BE SECURED ON THE OUTSIDE PERIMETER
- OF THE CARPET TILE BORDER.

 D. AREA RUG TO BE INSTALLED ASHLAR. TRIM EXCESS PIECES AS NECESSARY.
- E. REFER TO INTERIOR ELEVATIONS, FLOOR PLANS, FINISH PLANS AND REFLECTED CEILING PLANS -DRAWINGS NOTES SUPERCEDE SCHEDULES.
- F. ALL WALLS TO BE PAINTED PT-500, U.N.O.
 G. PAINT FACES AND BOTTOMS OF GYPSUM BOARD
- BULKHEADS TO MATCH ADJACENT WALLS UNLESS
 NOTED OTHERWISE

 H. PAINT ALL DOORS AND FRAMES TO MATCH ADJACENT
 WALL COLOR IN SATIN FINISH, U.N.O., SANDING WD
- DOORS BETWEEN COATS.

 J. PAINT INTERIOR DIFFUSERS, REGISTERS, AND LOUVERS TO MATCH ADJACENT SURFACE.
- ROLLER SHADE FABRIC SELECTION VARIES BY REGION AND CLIMATE - ALL CONFERENCE ROOMS TO RECEIVE DOUBLE ROLLER SHADE WT-7
- RESTROOM WALL TILE FINISH EXTENTS:
 PROVIDE ONLY IF REQUIRED BY JURISDICTIONS
 HAVING AUTHORITY CONTINUOUS AT ALL WALLS
 REGARDLESS OF CODE REQUIREMENTS REFER TO
 INTERIOR ELEVATIONS
- M. WINDOW SHADE ENCLOSURES AND POCKETS:
 WINDOW SHADE HOUSINGS AND POCKETS
 INTEGRATED WITH CEILING GRID CEILING SYSTEMS SHALL BE PROVIDED BY THE CEILING GRID
 MANUFACTURER AND INSTALLED BY THE CEILING
 SYSTEM VENDOR.
- SYSTEM VENDOR.

 FINISH SHALL MATCH THE CEILING GRID

 SURFACE-MOUNTED WINDOW SHADE HOUSING SHALL
 BE PROVIDED BY THE WINDOW SHADE VENDOR.

 FINISH SHALL MATCH THE STOREFRONT GLAZING
- N. FINISH: DARK ACCENT PAINT(S) REQUIRE LEVEL 5
 FINISH
- O. G.C. TO TERMINATE FLOOR TILE AT TOE KICK OF MILLWORK. G.C. TO LEAVE OUT LAST TILE ALONG MILLWORK AND INSTALL IT AFTER MILLWORK IS INSTALLED.

FINISH PLAN KEYNOTES

MANUAL TRANSACTION MILLWORK FURNISHED AND INSTALLED BY FURNITURE VENDOR.

2 FRP FINISH EXTENTS:

FLOOR SINK AREA: SPLASH AREA AT EACH WALL
SURFACE CONTACTING THE SINK FROM THE TOP OF
THE SINK TO THE UNDERSIDE OF THE WATER HEATER
SHELF ABOVE. REFER TO INTERIOR ELEVATIONS.

3 /4" X 4'-0" X 8'-0" HIGH FIRE-RETARDANT PLYWOOD ON

- 3/4" X 4'-0" X 8'-0" HIGH FIRE-RETARDANT PLYWOOD ON GYP. BOARD IN DATA ROOM (ALL WALLS) PAINT PT-500 (RATED LABEL TO REMAIN VISIBLE).
 LAST ROW OF TILE AT TELLER LINE TO BE LEFT OUT
- UNTIL TELLER LINE IS INSTALLED. FINISH UP TO TELLER LINE AFTER INSTALLATION.

 5 FLOOR BOX REFER TO FLOOR PLAN FOR LOCATIONS
- AND ELECTRICAL DRAWINGS.

 6 PAINT COLUMN SURROUND PT-500.
- 7 PAINT ALL WALLS INSIDE NICHE FOR DIGITAL DISPLAY
- 8 REFER TO INTERIOR ELEVATIONS, FLOOR PLANS, FINISH PLANS AND REFLECTED CEILING PLANS DRAWING NOTES SUPERCEDE SCHEDULES.
- 9 ALL WALLS TO BE PAINTED PT-500, U.N.O.
 10 PAINT GYP BD SOFFITS PT-103, U.N.O.
- 11 PAINT ALL DOORS AND FRAMES TO MATCH ADJACENT WALL COLOR IN SATIN FINISH, U.N.O., SANDING WD DOORS BETWEEN COATS.
- 12 LAMINATE OR SOLID SURFACE MILLWORK.
- 13 PAINT INTERIOR DIFFUSERS, REGISTERS, & LOUVERS TO MATCH ADJACENT SURFACE.
- 14 LAST ROW OF TILE AT MILLWORK TO BE LEFT OUT UNTIL MILLWORK IS INSTALLED. FINISH UP TO MILLWORK AFTER INSTALLATION.
- WHERE SLAB IS EXPOSED, INFILL SLAB DEPRESSION
 WITH SLOPED TOPPING COMPOUND FOLLOWED BY A
 LATICRETE WATERPROOFING SYSTEM WITH TILE SET IN
 EXTERIOR THINSET (ET-501).
- 16 REFER TO SHEET A5.2.1 FOR EXTERIOR DOOR THRESHOLD DETAILS.





9 Galen Street Suite 117 Watertown, MA 02472 617.576.0007 core-states.com

core-states.com

ARCHITECT OF RECORD

LICENSE NO. 32254

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JAMES T. LALLI, AIA, ARCHITECT

ISSUE DATE DESCRIPTION

- 2022.07.15 PERMIT SET

ROJECT INFORMATION

PROJECT INFORMATION

PROJECT NO: JPM.27118

DATE: 2022.07.15

PROTOTYPE: 20.3

DRAWN BY: K.KELLY

CHECKED BY: M.SIDES

SSE_1.00

FINISH PLAN

SHEET NUMBER

VERSION:

SHEET TITLE

A1.1.3A

1 FINISH PLAN
A1.1.3A 1/4" = 1'-0"



GENERAL FINISH NOTES

- A. REFER TO SHEET A0.1 FOR FLAME SPREAD REQUIREMENTS.
- B. REFER TO SHEET A3.3.1 FOR INTERIOR FINISH AND FLOOR TRANSITION SCHEDULES.
- C. RUGS ARE SECURED WITH A DOUBLE SIDED STICKY
 MESH, TACTILES, AND OPTITAPE TO SECURE
 TRANSITION EDGING TO THE FLOOR. TRANSITION
 EDGING TO BE SECURED ON THE OUTSIDE PERIMETER
- OF THE CARPET TILE BORDER.

 D. AREA RUG TO BE INSTALLED ASHLAR. TRIM EXCESS PIECES AS NECESSARY.
- E. REFER TO INTERIOR ELEVATIONS, FLOOR PLANS, FINISH PLANS AND REFLECTED CEILING PLANS -DRAWINGS NOTES SUPERCEDE SCHEDULES.
- F. ALL WALLS TO BE PAINTED PT-500, U.N.O.
- G. PAINT FACES AND BOTTOMS OF GYPSUM BOARD BULKHEADS TO MATCH ADJACENT WALLS UNLESS NOTED OTHERWISE
- H. PAINT ALL DOORS AND FRAMES TO MATCH ADJACENT WALL COLOR IN SATIN FINISH, U.N.O., SANDING WD DOORS BETWEEN COATS.
- J. PAINT INTERIOR DIFFUSERS, REGISTERS, AND LOUVERS TO MATCH ADJACENT SURFACE.
- ROLLER SHADE FABRIC SELECTION VARIES BY REGION AND CLIMATE ALL CONFERENCE ROOMS TO RECEIVE DOUBLE ROLLER SHADE WT-7
 RESTROOM WALL TILE FINISH EXTENTS:
- PROVIDE ONLY IF REQUIRED BY JURISDICTIONS
 HAVING AUTHORITY CONTINUOUS AT ALL WALLS
 REGARDLESS OF CODE REQUIREMENTS REFER TO
 INTERIOR ELEVATIONS
- M. WINDOW SHADE ENCLOSURES AND POCKETS:
 WINDOW SHADE HOUSINGS AND POCKETS
 INTEGRATED WITH CEILING GRID CEILING SYSTEMS SHALL BE PROVIDED BY THE CEILING GRID
 MANUFACTURER AND INSTALLED BY THE CEILING
 SYSTEM VENDOR
- SYSTEM VENDOR.

 FINISH SHALL MATCH THE CEILING GRID

 SURFACE-MOUNTED WINDOW SHADE HOUSING SHALL

 BE PROVIDED BY THE WINDOW SHADE VENDOR.
- N. FINISH: DARK ACCENT PAINT(S) REQUIRE LEVEL 5
 FINISH

FINISH SHALL MATCH THE STOREFRONT GLAZING

O. G.C. TO TERMINATE FLOOR TILE AT TOE KICK OF MILLWORK. G.C. TO LEAVE OUT LAST TILE ALONG MILLWORK AND INSTALL IT AFTER MILLWORK IS INSTALLED.

FINISH PLAN KEYNOTES

MANUAL TRANSACTION MILLWORK FURNISHED AND INSTALLED BY FURNITURE VENDOR.

2 FRP FINISH EXTENTS:
FLOOR SINK AREA: SPLASH AREA AT EACH WALL
SURFACE CONTACTING THE SINK FROM THE TOP OF

THE SINK TO THE UNDERSIDE OF THE WATER HEATER SHELF ABOVE. REFER TO INTERIOR ELEVATIONS.

3/4" X 4'-0" X 8'-0" HIGH FIRE-RETARDANT PLYWOOD ON GYP. BOARD IN DATA ROOM (ALL WALLS) - PAINT PT-500 (RATED LABEL TO REMAIN VISIBLE).

- 4 LAST ROW OF TILE AT TELLER LINE TO BE LEFT OUT UNTIL TELLER LINE IS INSTALLED. FINISH UP TO TELLER LINE AFTER INSTALLATION.
- 5 FLOOR BOX REFER TO FLOOR PLAN FOR LOCATIONS AND ELECTRICAL DRAWINGS.
 6 PAINT EXPOSED STEEL COLUMN PT-500.
- 7 PAINT ALL WALLS INSIDE NICHE FOR DIGITAL DISPLAY CSG-PT-104.
- 8 REFER TO INTERIOR ELEVATIONS, FLOOR PLANS,
 FINISH PLANS AND REFLECTED CEILING PLANS DRAWING NOTES SUPERCEDE SCHEDULES.
- 9 ALL WALLS TO BE PAINTED PT-500, U.N.O.

 10 PAINT GYP BD SOFFITS PT-103, U.N.O.
- 11 PAINT ALL DOORS AND FRAMES TO MATCH ADJACENT WALL COLOR IN SATIN FINISH, U.N.O., SANDING WD DOORS BETWEEN COATS.
- 12 LAMINATE OR SOLID SURFACE MILLWORK.
 13 PAINT INTERIOR DIFFUSERS, REGISTERS, & LOUVERS TO MATCH ADJACENT SURFACE.
- 14 LAST ROW OF TILE AT MILLWORK TO BE LEFT OUT UNTIL MILLWORK IS INSTALLED. FINISH UP TO MILLWORK AFTER INSTALLATION.
- 15 WHERE SLAB IS EXPOSED, INFILL SLAB DEPRESSION WITH SLOPED TOPPING COMPOUND FOLLOWED BY A LATICRETE WATERPROOFING SYSTEM WITH TILE SET IN EXTERIOR THINSET (ET-501).
- 16 REFER TO SHEET A5.2.1 FOR EXTERIOR DOOR THRESHOLD DETAILS.





9 Galen Street Suite 117 Watertown, MA 02472 617.576.0007

ARCHITECT OF RECORD

JAMES T. LALLI, AIA, ARCHITECT

LICENSE NO. 32254

THESE DRAWINGS ARE NOT COMPLETE WITHOUT THE SEPARATE TYPE WRITTEN SPECIFICATIONS MANUAL WHICH ARE PART OF THE CONTRACT DOCUMENTS.

ISSUE DATE DESCRIPTION

2022.07.15 PERMIT SET

PROJECT INFORMATION

PROJECT NO: JPM.27118

DATE: 2021.05.21

PROTOTYPE: 20.3

DRAWN BY: K.KELLY

CHECKED BY: M.SIDES

VERSION: SSE_1.00

SHEET TITLE

FINISH PLAN

SHEET NUMBER

A1.1.3B





FURNITURE & EQUIPMENT KEYNOTES

1 ALL FLOOR-MOUNTED BANK EQUIPMENT WITH 24/7
ACCESS REQUIRES FLOOR SLAB ANCHORS - REFER TO
EQUIPMENT INSTALLATION MANUAL

DRTs ARE NOT REQUIRED TO BE CAPTURED BY A SECURITY CAMERA.

TRASH RECEPTABLE BY BRANCH PLANNING
 TRASH RECEPTACLE BY G.C.

5 SOLUTION #3 (75") - WALL MOUNTED DISPLAY MONITOR; SEE GENERAL FURNITURE & EQUIPMENT NOTES. 6 SOLUTION #7 (32") - WALL MOUNTED DISPLAY MONITOR;

SEE GENERAL FURNITURE & EQUIPMENT NOTES.

GENERAL FURNITURE & EQUIPMENT NOTES

- A GC TO COORDINATE IN FIELD BCM OFFICE LOCATION W/BRANCH MANAGEMENT FOR LOCATION OF HOLD-UPBUTTON.
- B WALL MOUNTED DISPLAYS/ SOLUTIONS:
 REFER TO A6 SERIES SHEETS FOR INTERIOR ELEVATIONS
 AND A6.03 & A6.04 FOR MOUNTING HEIGHTS & NICHE
 CONSTRUCTION DETAILS (WHERE SHOWN).





ARCHITECT OF RECORD

JAMES T. LALLI, AIA, ARCHITECT LICENSE NO. 32254

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- 2022.07.15 PERMIT SET

PROJECT INFORMATION

PROJECT NO: JPM.2

DATE: 2022.0

PROTOTYPE:

PROJECT NO: JPM.27118

DATE: 2022.07.15

PROTOTYPE: 20.3

DRAWN BY: K.KELLY

CHECKED BY: M.SIDES

VERSION: SSE_1.00


SHEET TITLE

FURNITURE & EQUIPMENT PLAN

SHEET NUMBER

A1.1.4A

1 FURNITURE & EQUIPMENT PLAN
A1.1.4A 1/4" = 1'-0"

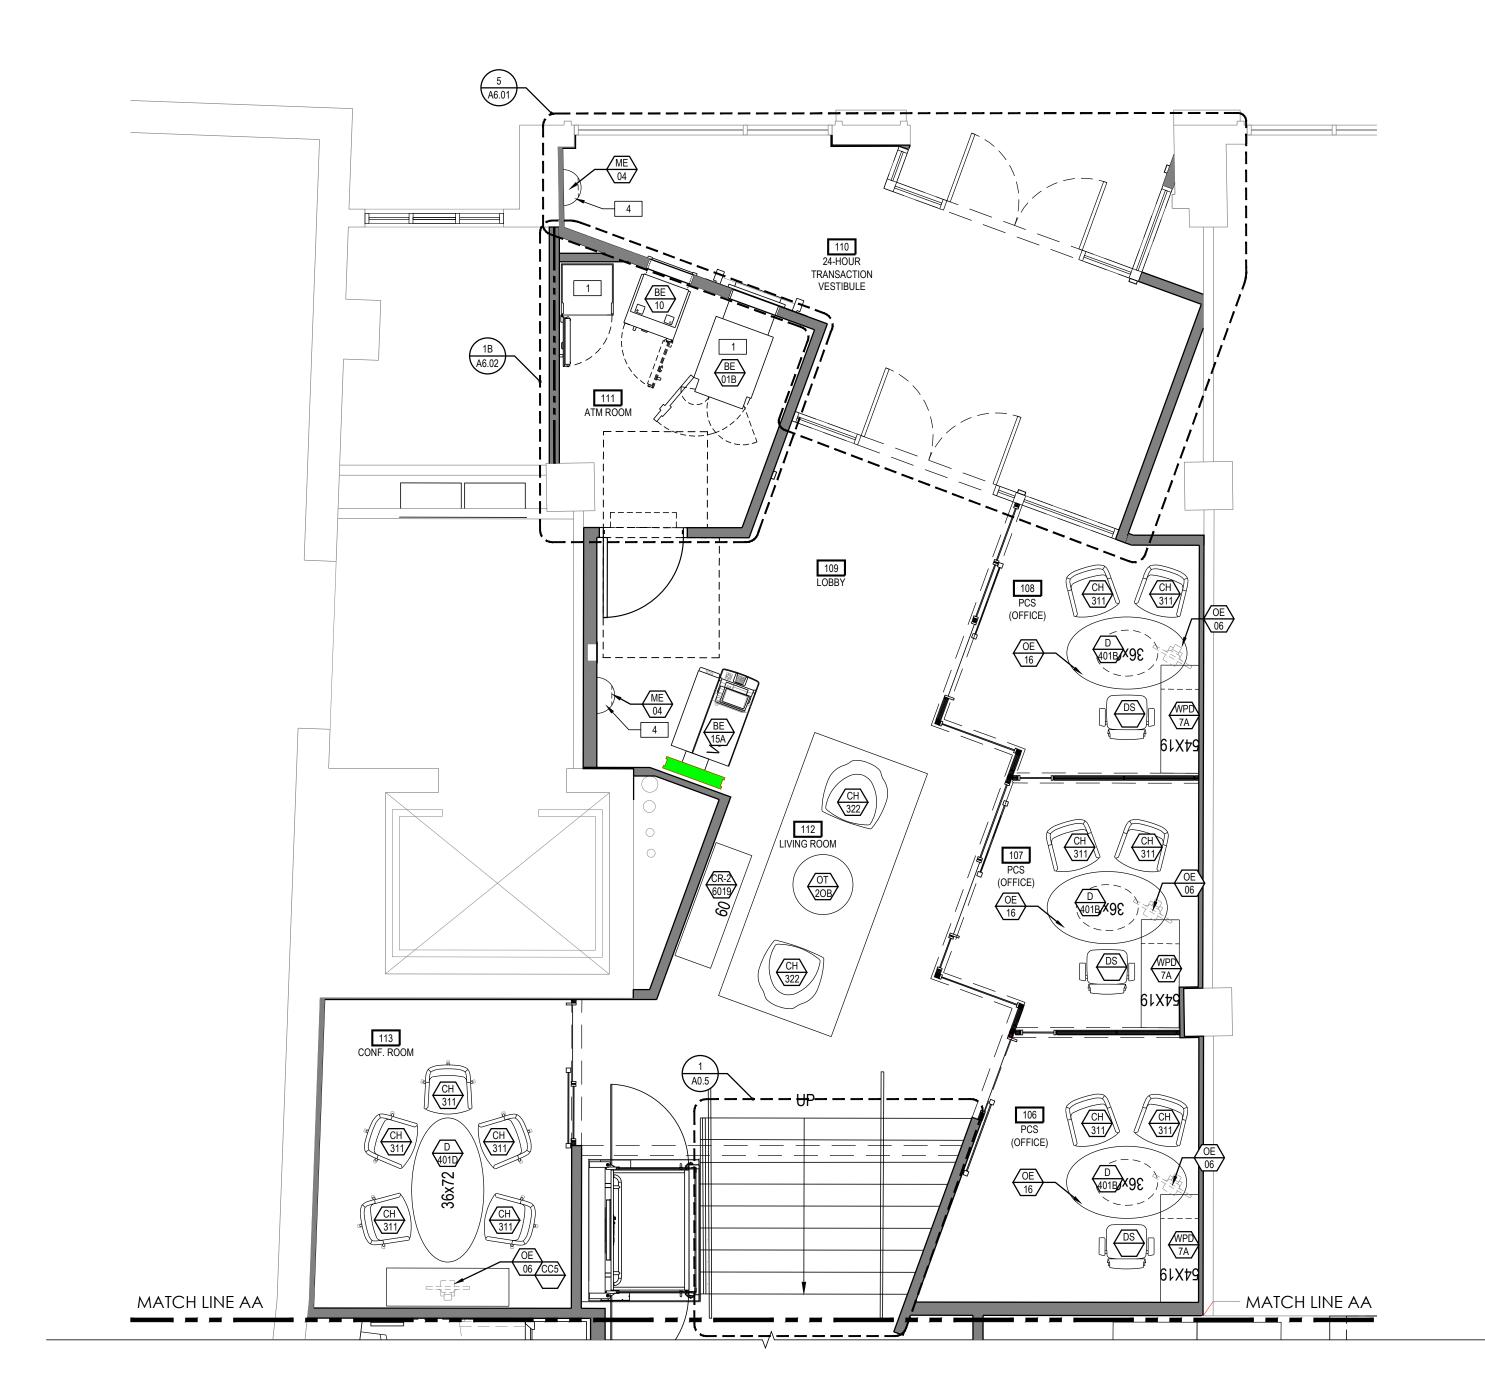



ALL FLOOR-MOUNTED BANK EQUIPMENT WITH 24/7
 ACCESS REQUIRES FLOOR SLAB ANCHORS - REFER TO
 EQUIPMENT INSTALLATION MANUAL

 DRTs ARE NOT REQUIRED TO BE CAPTURED BY A

DRTs ARE NOT REQUIRED TO BE CAPTURED BY A SECURITY CAMERA.

3 TRASH RECEPTABLE BY BRANCH PLANNING

4 TRASH RECEPTACLE BY G.C.
5 SOLUTION #3 (75") - WALL MOUNTED DISPLAY MONITOR;

SEE GENERAL FURNITURE & EQUIPMENT NOTES.

6 SOLUTION #7 (32") - WALL MOUNTED DISPLAY MONITOR; SEE GENERAL FURNITURE & EQUIPMENT NOTES.

GENERAL FURNITURE & EQUIPMENT NOTES

- A GC TO COORDINATE IN FIELD BCM OFFICE LOCATION W/BRANCH MANAGEMENT FOR LOCATION OF HOLD-UPBUTTON.
- B WALL MOUNTED DISPLAYS/ SOLUTIONS:
 REFER TO A6 SERIES SHEETS FOR INTERIOR ELEVATIONS
 AND A6.03 & A6.04 FOR MOUNTING HEIGHTS & NICHE
 CONSTRUCTION DETAILS (WHERE SHOWN).





ARCHITECT OF RECORD

JAMES T. LALLI, AIA, ARCHITECT LICENSE NO. 32254

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ISSUE DATE DESCRIPTION

- 2022.07.15 PERMIT SET

PRO.	JECT INFO	ORMATION	
PRO	OJECT NO:		JPM.27118
DA	TE:		2022.07.13
PRO	OTOTYPE:		20.3
DR.	AWN BY:		K.KELL
CH	ECKED BY:		M.SIDES
VER	RSION:		SSE_1.00

FURNITURE & EQUIPMENT PLAN


SHEET NUMBER

SHEET TITLE


A1.1.4B



22

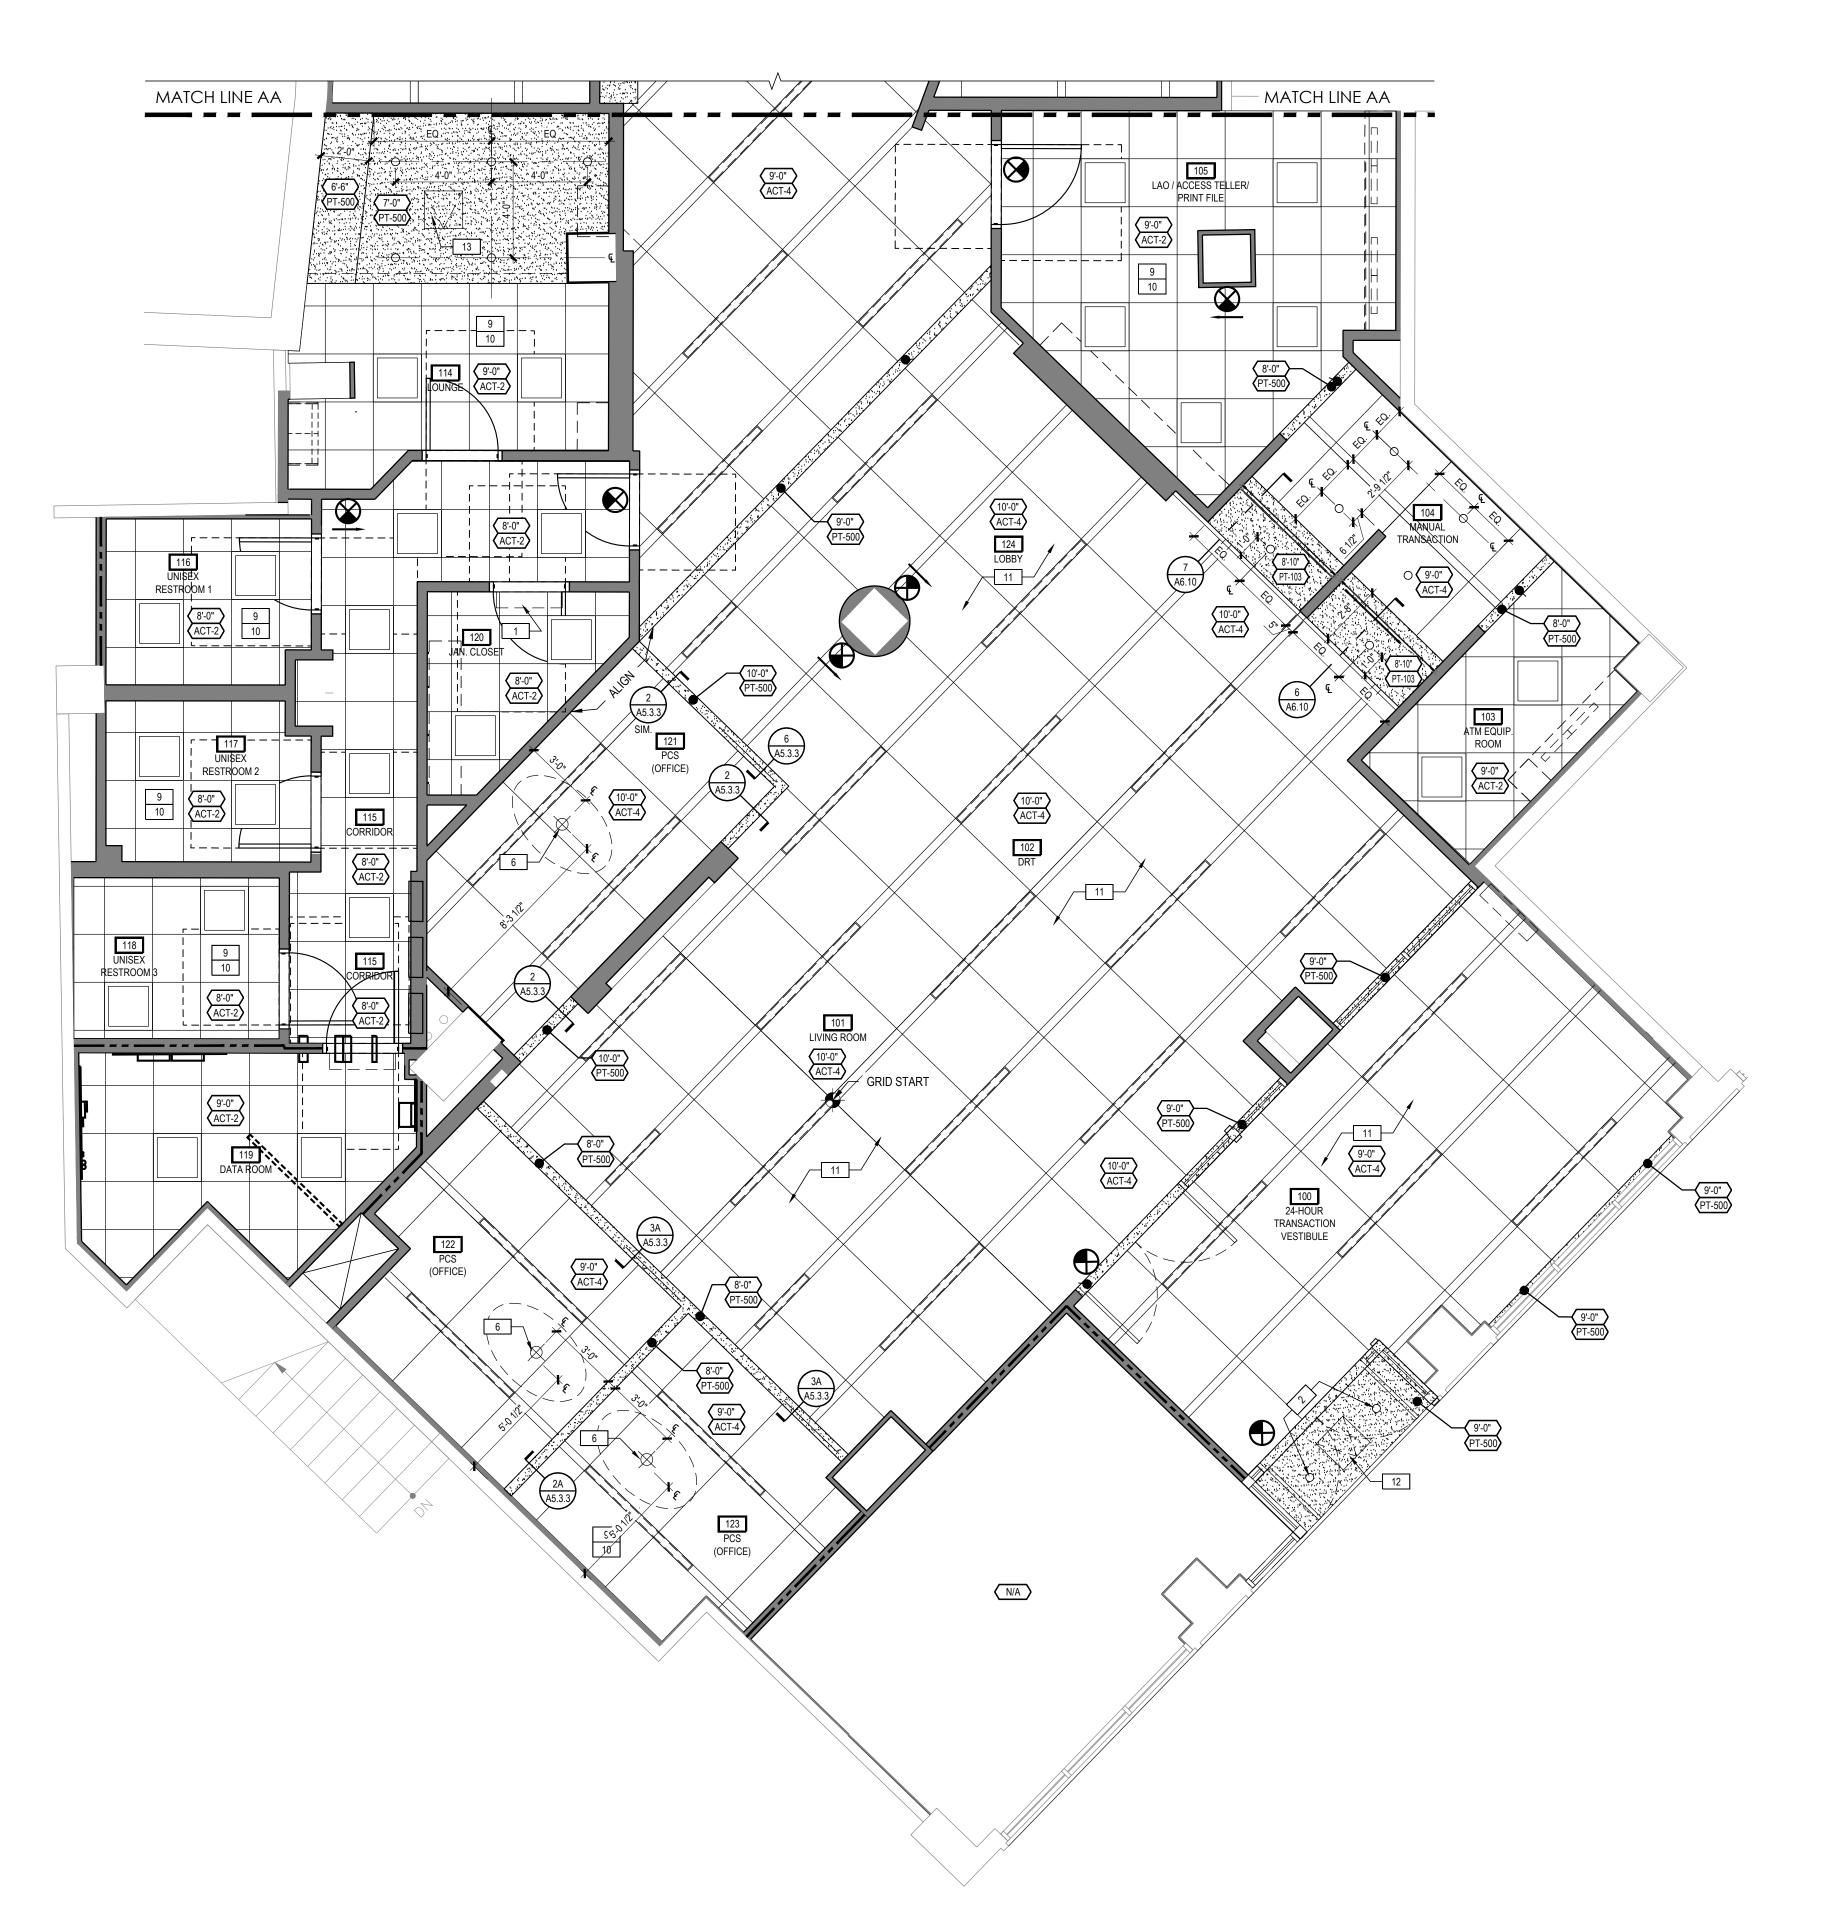



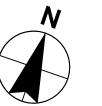



GROUP

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JAMES T. LALLI, AIA, ARCHITECT

LICENSE NO. 32254

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ISSUE DATE DESCRIPTION

PROJECT INFORMATION

PROJECT NO:

PROTOTYPE:

2022.07.15 PERMIT SET

ARCHITECT OF RECORD

RCP SYMBOLS LEGEND

RECESSED DOWNLIGHT:
REFER TO ELEC DWGS FOR ADDL INFO

WALL WASHER: REFER TO ELEC DWGS FOR ADDL INFO

RCP KEYNOTES

1 WALL LIGHT OVER DOOR - REFER TO ELECTRICAL

2 EXTERIOR LIGHTS TO BE RATED FOR EXTERIOR

3 WALL MOUNT HVAC UNIT - REFER TO MECHANICAL

4 VESTIBULE HVAC UNIT ABOVE CEILING - REFER TO

6 OFFICE PENDANT TO BE CENTERED ON DESK/TABLE

BELOW. CONFERENCE ROOM PENDANT TO BE

OFFICE: PENDANT, INSTALLED AT 82" A.F.F.

CONFERENCE: PENDANT, INSTALLED AT 82" A.F.F.

8 WINDOW SHADE; SEE FINISH PLAN AND FINISH SCHEDULE

9 ALL CEILING FIXTURES TO BE CENTERED ON CEILING TILE

UNLESS SHOWN & NOTED OTHERWISE. SEE DETAIL

10 ACOUSTIC CEILING TILE TO BE CENTERED ON SPACE.

12 NEW 20" X 20" MILCOR MODEL M ACCESS PANEL IN GYP. BOARD CEILING. REFER TO SPECIFICATION ON ACCESS

DOORS AND PANELS FOR MORE INFORMATION ON

GYP. BOARD CEILING. REFER TO SPECIFICATION ON ACCESS DOORS AND PANELS FOR MORE INFORMATION

13 NEW 20" X 20" MILCOR MODEL UFR ACCESS PANEL IN

CENTERED ON CEILING TILE. VERIFY DIMENSIONS SHOWN ON PLANS W/ FURNITURE PLANS. COORDINATE WITH ARCHITECT IF LIGHT INTERFERES WITH CEILING GRID. REFER TO ELECTRICAL PLANS FOR MORE INFORMATION.

5 FINISH TO BE EXTERIOR RATED DENSGLASS.

DRAWINGS.

7 NOT USED

MECHANICAL DRAWINGS.

FOR MORE INFORMATION

EXTERIOR UNITS.

3/A5.5.4 FOR MORE INFORMATION.

11 CEILING HEIGHTS ARE FROM FINISH FLOOR

ON FIRE-RATED INTERIOR UNITS.

DECORATIVE PENDANT LIGHT:

REFER TO ELEC DWGS FOR ADDL INFO

WALL MOUNTED LIGHT FIXTURE:
REFER TO ELEC DWGS FOR ADDL INFO

SURFACE MOUNTED LIGHT FIXTURE: REFER TO ELEC DWGS FOR ADDL INFO

LAY-IN LINEAR LIGHT FIXTURE:
REFER TO ELEC DWGS FOR ADDL INFO

2' x 2' LAY-IN LIGHT FIXTURE: REFER TO ELEC DWG. FOR ADDL INFO

SUPPLY AIR DIFFUSER:
REFER TO MECH DWGS FOR ADDL INFO

RETURN AIR GRILL:

EXHAUST FAN:

REFER TO MECH DWGS FOR ADDL INFO

REFER TO MECH DWGS FOR ADDL INFO

ILLUMINATED EXIT SIGN:
REFER TO ELEC DWGS FOR ADDL INFO

UNDER-CABINET TASK LIGHT:
REFER TO ELEC DWGS FOR ADDL INFO

S) CEILING MOUNTED SPEAKER: COORDINATE LOCATIONS W/ VENDOR

LED ACCENT LIGHTING

LED ACCENT LIGHTING
REFER TO ELEC DWG. FOR ADDL INFO

5/8" GYPSUM BOARD

DRAWN BY:
CHECKED BY:
VERSION:
SHEET TITLE

REFLECTED


CEILING PLAN


SHEET NUMBER

A1.2.1A

JPM.27118

2022.07.15

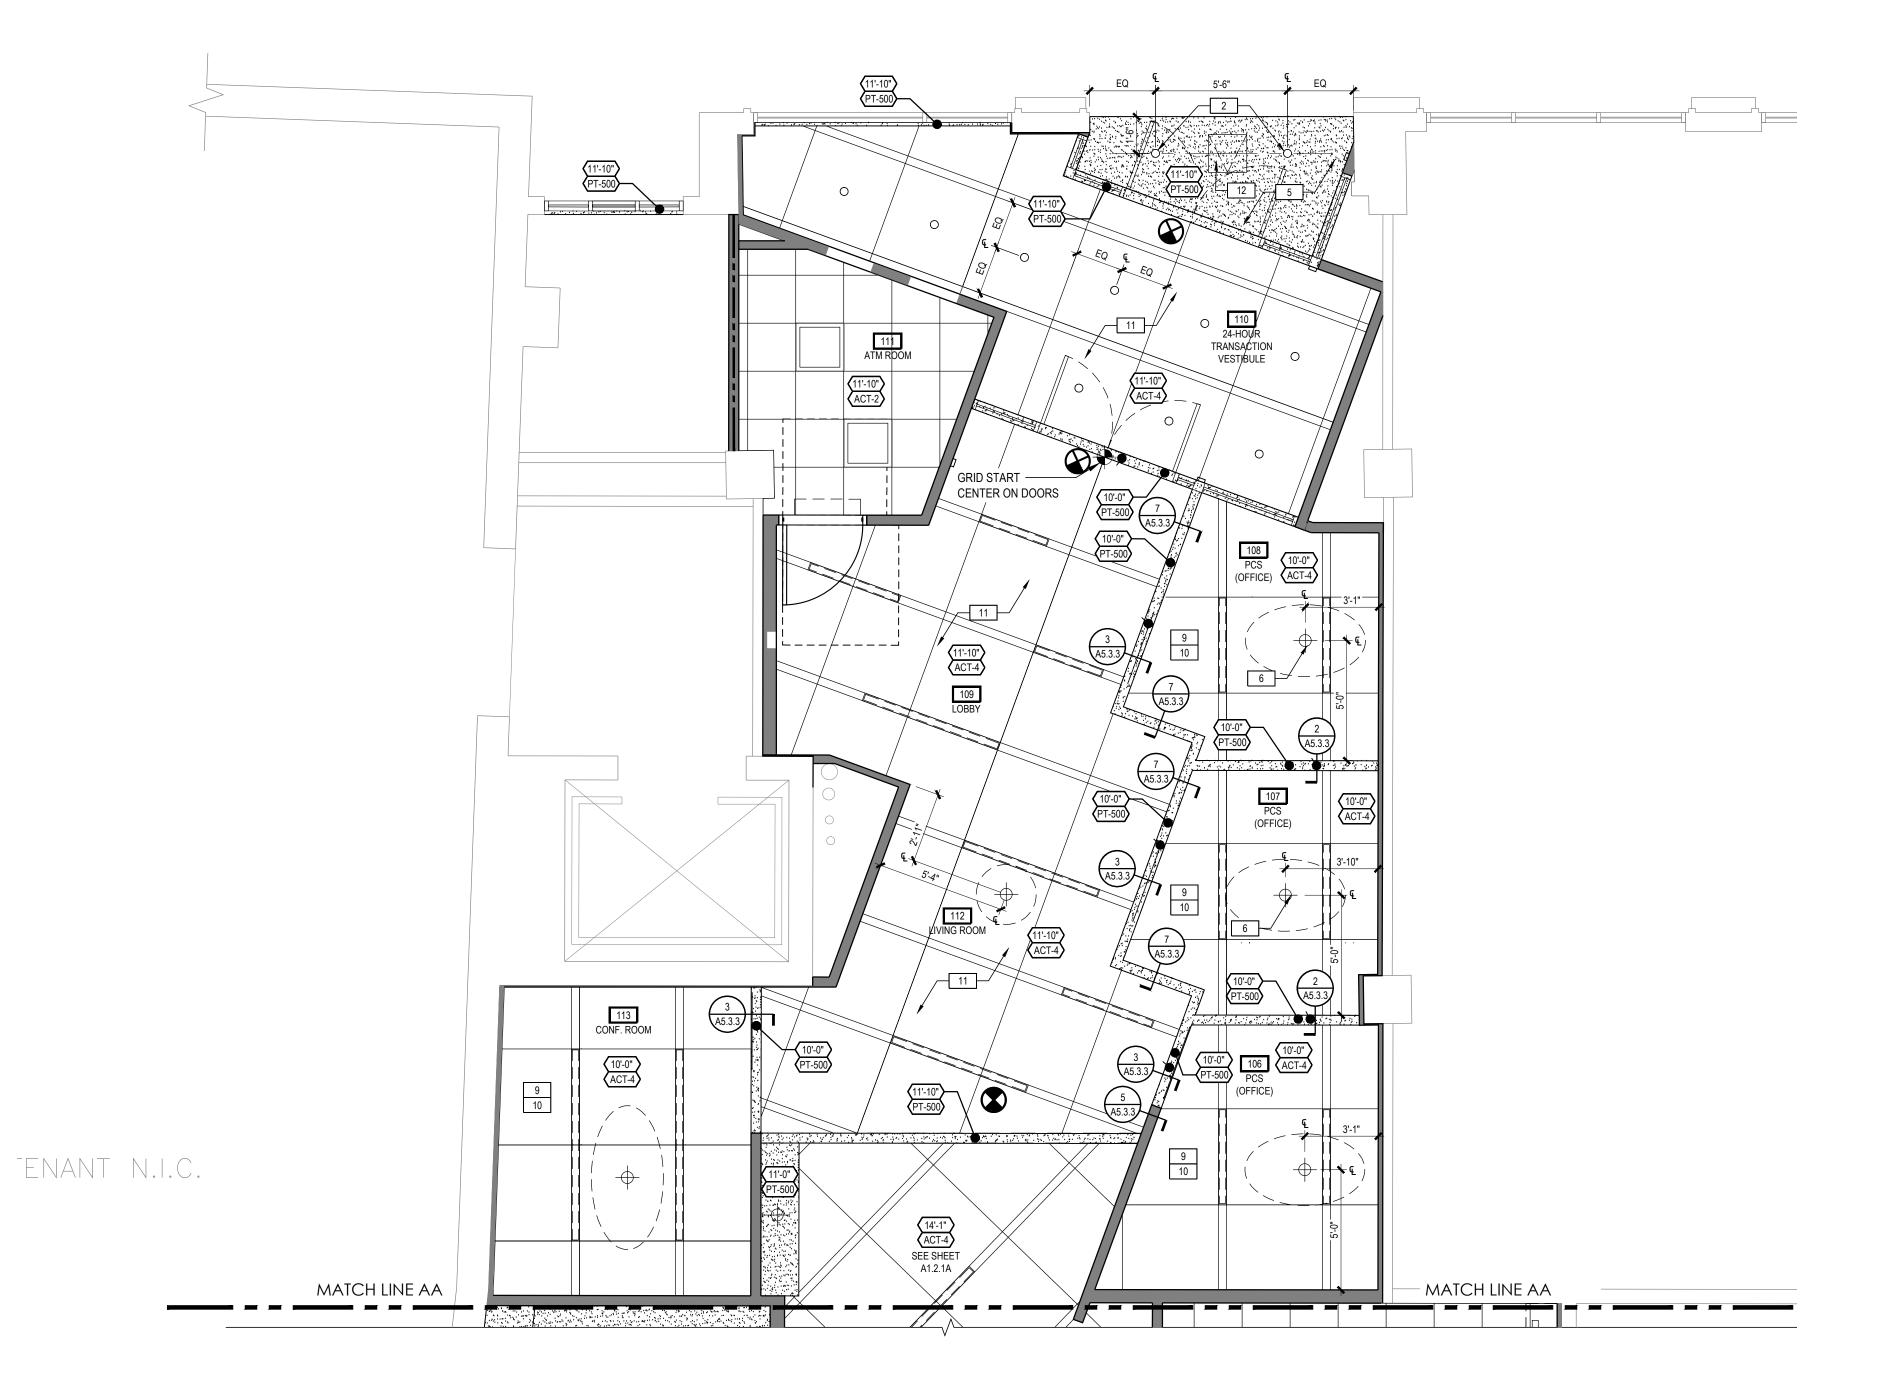


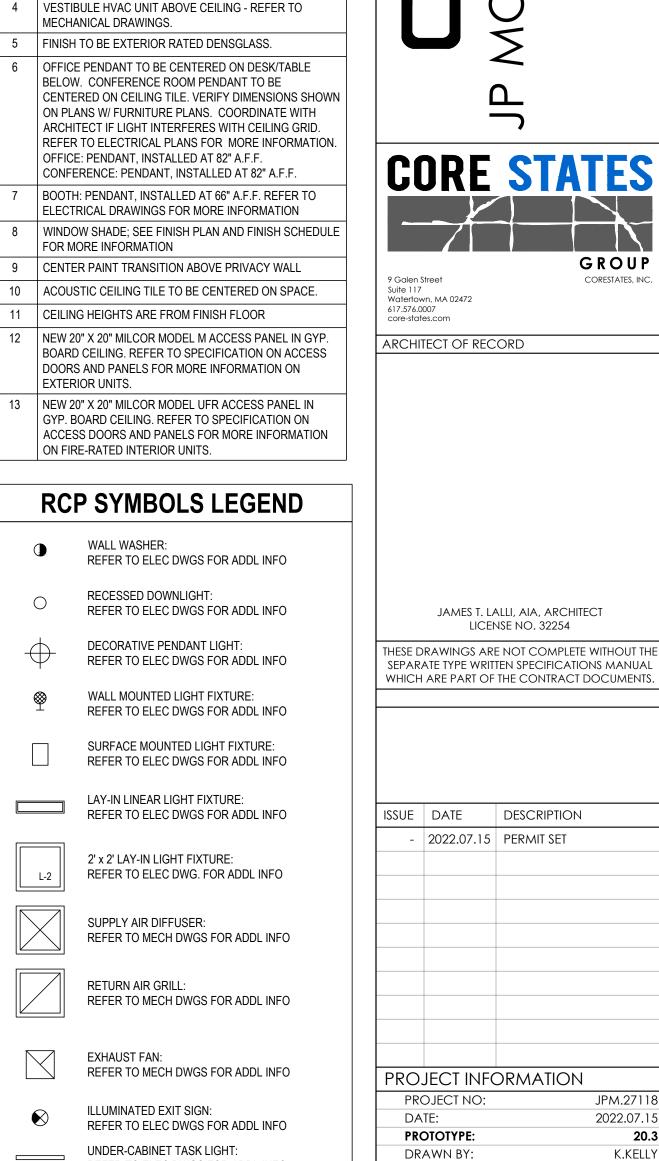


RCP KEYNOTES

1 WALL LIGHT OVER DOOR - REFER TO ELECTRICAL

2 EXTERIOR LIGHTS TO BE RATED FOR EXTERIOR 3 WALL MOUNT HVAC UNIT - REFER TO MECHANICAL

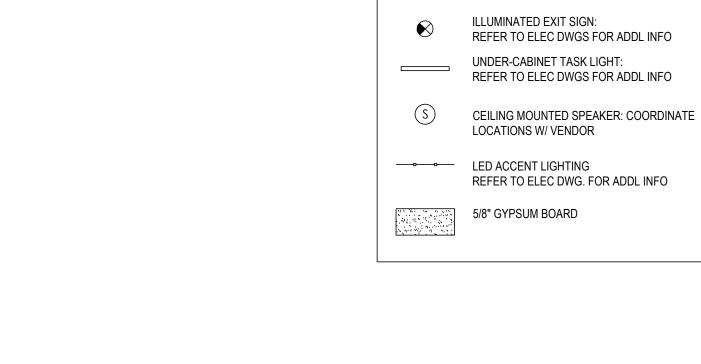

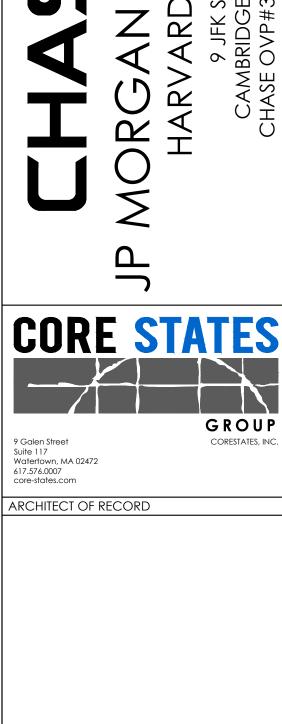

ISSUE DATE DESCRIPTION 2022.07.15 PERMIT SET

JAMES T. LALLI, AIA, ARCHITECT LICENSE NO. 32254

PROJECT INFORMATION PROJECT NO: JPM.27118 2022.07.15 PROTOTYPE:

K.KELLY

M.SIDES

SSE_1.00

DRAWN BY: CHECKED BY: VERSION: SHEET TITLE

REFER TO ELEC DWG. FOR ADDL INFO

A1.2.1B

SHEET NUMBER

REFLECTED

CEILING PLAN

REFLECTED CEILING PLAN

GENERAL EXTERIOR NOTES

A G.C. TO VERIFY EXTERIOR COLOR & MATERIAL LOCATIONS
AS SHOWN ON ELEVATION DRAWINGS WITH CHASE
DESIGNER & APPROVED BRANDING PACKAGE PRIOR TO
PURCHASE & INSTALLATION.

ELEVATION NOTES

1 NOT USED

2 AUTOMATIC SURFACE MOUNT DOOR OPERATOR BUTTON-

DO NOT RECESS .


3 KEYCARD READER RECESSED FLUSH WITH WALL SURFACE- DO NOT SURFACE-MOUNT .

4 SIGNAGE LOCATION:
SIGNAGE BY OWNER'S SIGN VENDOR- N.I.C.- PROVIDE
ROUGH ELEC. WORK AND BLOCKING IN WALL AS REQD.
FOR VENDOR INSTALLATION. CONFIRM FINAL LOCATION


WITH SIGN VENDOR.
5 AWNING BY OTHERS

6 SECURITY CAMERA:
PROVIDE CONCEALED JUNCTION BOX AND CONDUIT TO
INTERIOR; REFER TO OWNER'S SECURITY CONSULTANT
DRAWINGS.

7 NEW ANODIZED ALUMINUM STOREFRONT TO BE
INSTALLED BY LANDLORD. NEW OPAQUE WINDOW FILM TO
BE INSTALLED. REFER TO INTERIOR FINISH SCHEDULE
FOR SPECIFICATION OF NEW WINDOW FILM.

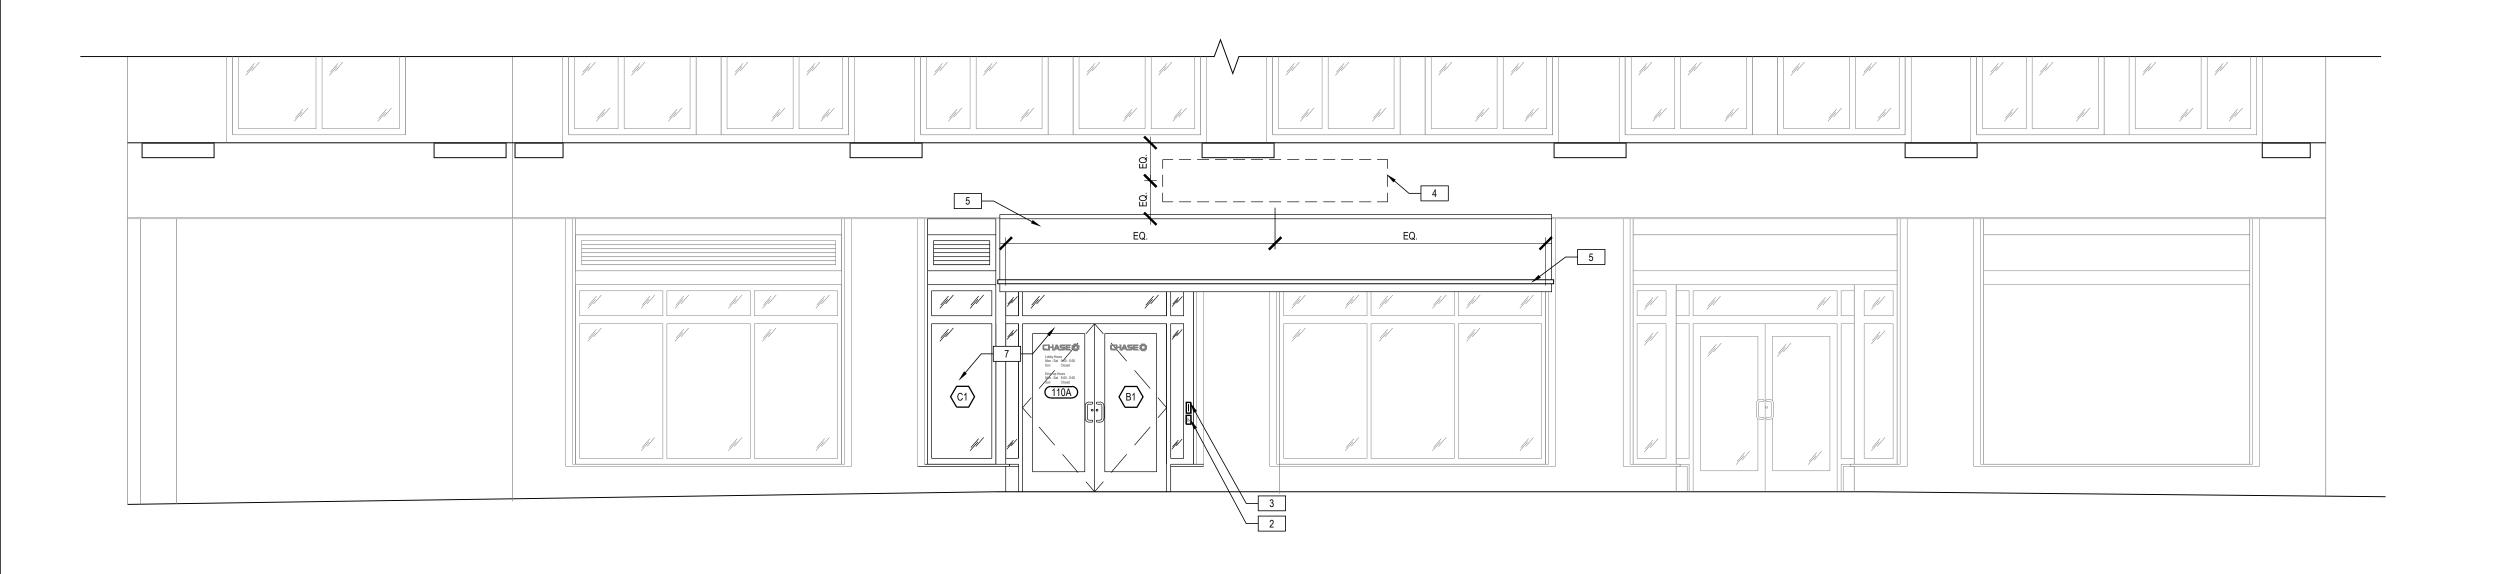



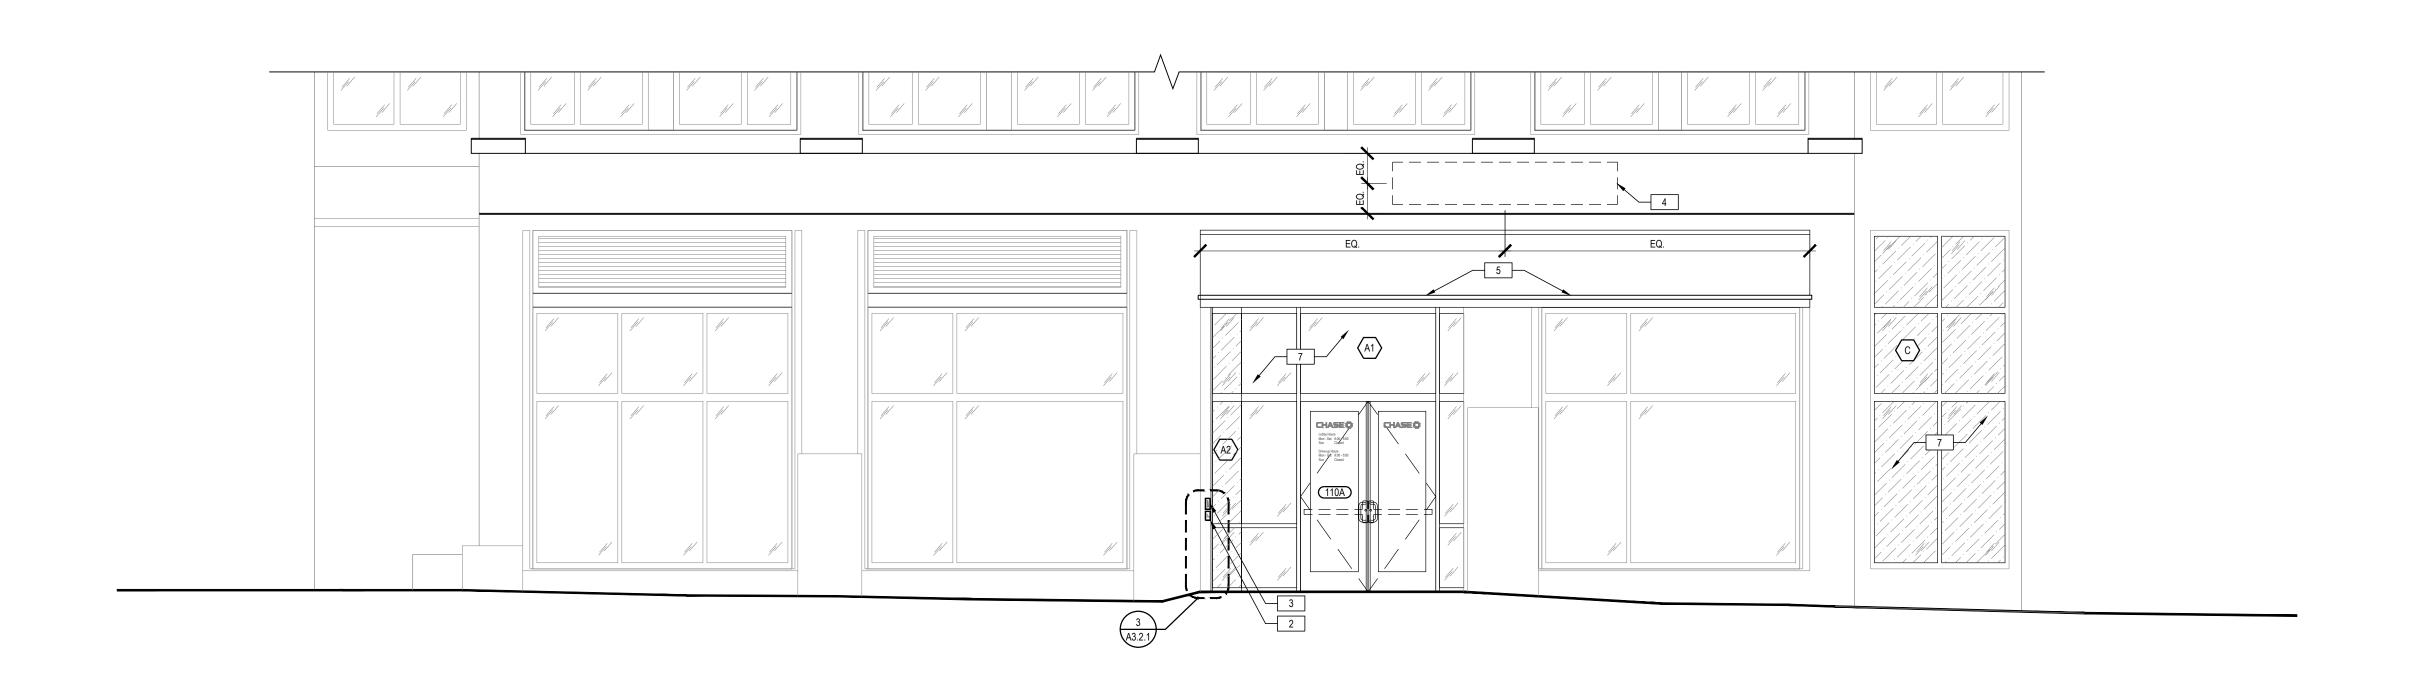



JP MORGAN CHASE, N./
HARVARD SQUARE
9 JFK STRET
CAMBRIDGE, MA 02138
CHASE OVP#38100P322595



JAMES T. LALLI, AIA, ARCHITECT LICENSE NO. 32254

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DATE DESCRIPTION
2022.07.15 PERMIT SET

PROJECT INFORMATION

PROJECT INFORMATION

PROJECT NO: JPM.27118

DATE: 2022.07.15

PROTOTYPE: 20.3

DRAWN BY: S.KRAMER

CHECKED BY: M.SIDES

VERSION: SSE_1.00

EXTERIOR ELEVATIONS

SHEET NUMBER


SHEET TITLE

A2.1.0

P:\J.P. Morgan Chase\Cambridge, MA (Havard Square - 11 JFK Street) #3 Thursday, July 14, 2022 3:56:52 PM

36

NOTE:
ALL WOOD BLOCKING AND PLYWOOD SHALL
BE FIRE-TREATED.

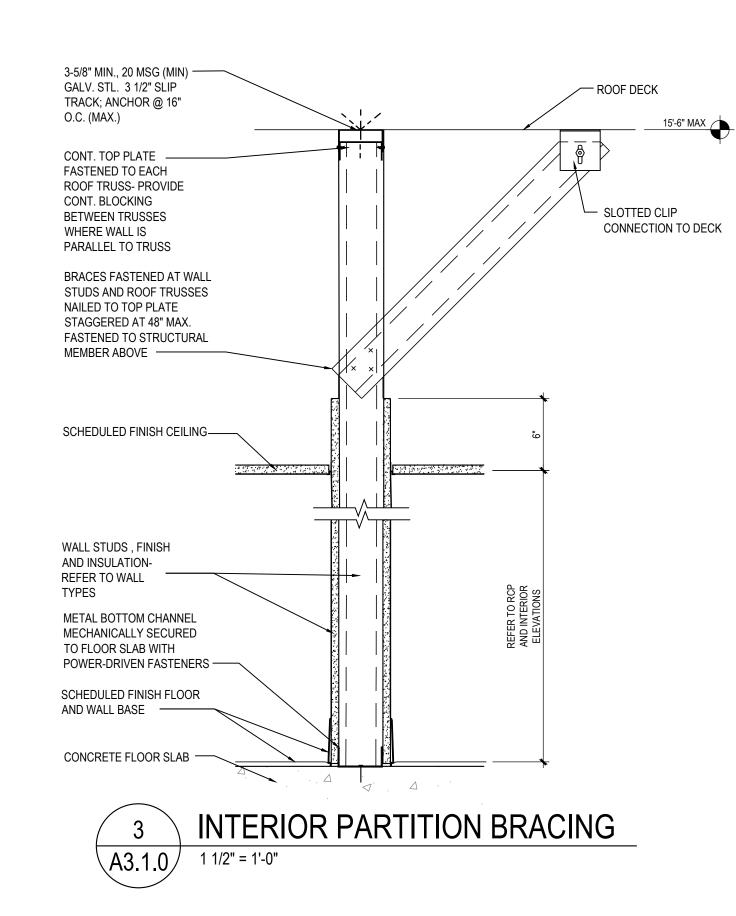

- 3-5/8" MIN., 20 MSG (MIN) GALV. STL.

3 1/2" SLIP TRACK; ANCHOR @ 16"

 AT FIRE-RATED PARTITIONS AND SOUND RATED PARTITIONS ONLY: EXTEND GYP. BOARD TO ROOF DECK

SCHEDULED FINISH CEILING

— 3 1/2" FIBERGLASS BATT ACOUSTIC

INSULATION AT WALL TYPE WJ1

— 3 5/8" METAL STUDS AT 24" o.c.

- 5/8" TYPE 'X' GYPSUM BOARD

PANELS- TAPED AND FINISHED

— AT FIRE- AND SOUND- RATED

PARTITIONS ONLY APPLY

T.O. CONCRETE SLAB

FIRE-RATED OR ACOUSTIC

SEALANT TOP AND BOTTOM OF

O.C. (MAX.)

20GA:

3 5/8" @ 16" O.C. | *17'-6"*

3 5/8" @ 24" O.C. | 15'-4"

6" @ 16" O.C. 26'-0" 6" @ 24" O.C. 22'-8"

TYPICAL INTERIOR PARTITION NO FIRE RATING U.N.O.

WJ1 INTERIOR SOUND-RATED PARTITION
SAME AS WJ EXCEPT ADD SOUND ISOLATION

WJ2 INTERIOR SINGLE-SIDE PARTITION
SAME AS 'WJ' EXCEPT OMIT GYP. BD. ONE SIDE

6" NOMINAL INTERIOR PARTITION
SAME AS 'WJ' EXCEPT SUBSTITUTE 6" METAL STUDS

6" NOMINAL INTERIOR SOUND-RATED PARTITION
SAME AS 'WJ1' EXCEPT SUBSTITUTE 6" METAL STUDS

6" NOMINAL SINGLE-SIDE PARTITION
SAME AS 'WJ2' EXCEPT SUBSTITUTE 6" METAL STUDS

1-HOUR FIRE-RATED PARTITION
CONSTRUCTED TO COMPLY WITH U.L. TYPE 419

6" NOMINAL 1-HOUR FIRE-RATED PARTITION
SAME AS 'WJ7' EXCEPT SUBSTITUTE 6" METAL STUDS

WJ8 1 5/8" NOMINAL INTERIOR PARTITION
SAME AS 'WJ2' EXCEPT SUBSTITUTE 1 5/8" METAL STUDS

WJ6 INTERIOR PARTITION @ 24 HOUR VESTIBULE

SAME AS 'WJ' EXCEPT SECURITY MESH ABOVE CEILING ON 24 HOUR VESTIBULE SIDE OF WALL FRAMING EXTENDED TO UNDERSIDE OF ROOF DECK

B.O. EXISTING STRUCTURE

EXIST. MASONRY WALL

FINISHED

T.O. SECURITY MESH 8'-0" MIN.

WJ9 5/8" GYP. BOARD AT EXPOSED COLUMNS

5/8" GYP. BOARD SECURITY MESH AT DEMISING WALLS
SAME AS WJ9 BUT WITH SECURITY MESH AT DEMISING WALLS

SCHEDULED FINISH CEILING

1/2" GYP. BD. FROM T.O. MESH TO 6"

ABOVE CLG. - TAPED & FINISHED

/ 3/8" GYP. BD. OVER MESH - TAPED &

— ONLY AT WJ10 WALLS: SECURITY MESH MODEL

#ASM.75-13F AS MFRD. BY AMICO w/ AMICO

SECURE CLIPS SPACED 12" O.C. VERT. @ EA. STUD

(24 CLIPS MIN. PER 4'x8' PANEL). USE FINE THREAD

#8 SHANK BUGLE HEAD SELF-TAPPING SCREWS AT

MTL. FRAMING LONG ENOUGH TO PENETRATE FRAMING 3/8" OR 1 5/8" FINE THREADED #6 SHANK

DRYWALL SCREWS AT WD. FRAMING. UL FIRE


BY USING SECURITY MESH (UL SUBJECT FILE

#1857). NO MESH REQD. AT MASONRY WALLS.

___ T.O. EXISTING SUB-FLOOR

RATED ASSEMBLIES WILL NOT BE JEOPARDIZED

B.O. DECK ABOVE

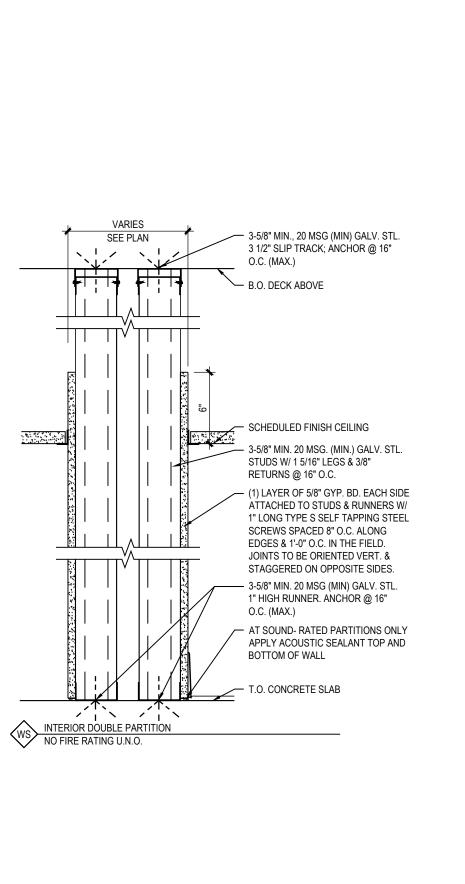

A3.1.0 1 1/2" = 1'-0"



JAMES T. LALLI, AIA, ARCHITECT LICENSE NO. 32254

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ARCHITECT OF RECORD

ISSUE DATE DESCRIPTION

- 2022.07.15 PERMIT SET

PROJECT INFORMATION

PROJECT NO: JPM.27118

DATE: 2022.07.15

PROTOTYPE: 20.3

DRAWN BY: K.KELLY

CHECKED BY: M.SIDES

VERSION: SSE_1.00

SHEET TITLE

WALL TYPES FLOOR TYPES ROOF TYPES

SHEET NUMBER

A3.1.0

P:\J.P. Morgan Chase\Cambridge, MA (Havard Square - 11 JFK Street) #38100P322595 -JPM.27118 Monday, July 18, 2022 8:14:39 PM


Drawings\A310_Cambridge MA (Harvard Squ


.et] #38100P322595 -JPM.27118\AMEPS_Drawings\A310_Cambriv

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27

							DOOR TYPES	SCHEDULE			
				TYPICAL SIZE		DOG	DR .	FR	AME		
DOOR NO.	ROOM NAME	TYPE	W	Н	T	MATERIAL	FINISH	MATERIAL	FINISH	HDWR.	NOTES
100A	TRANS. VEST.	A ENTRANCE	EX	EX	EX	EX	EX	EX	EX	01	DOORS BY LANDLORD; HARDWARE BY GC
100B	TRANS. VEST.	B VESTIBULE	(2) 3'-0"	7'-0"	1 3/4"	ALUMINUM / GLASS	BLACK ANODIZED	ALUMINUM	BLACK ANODIZED	02	WIDE-STILE, 10" BOTTOM RAILS, REMOVABLE MULLION
105	MANUAL TRANSACTION	E SECURED	3'-0"	7'-0"	1 3/4"	SOLID-CORE FLUSH WOOD	PAINT TO MATCH ADJACENT WALL	HOLLOW METAL	PAINT TO MATCH ADJACENT WALL	03	CLOSER CONCEALED FROM CUSTOMER VIEW
110A	TRANS. VEST.	A ENTRANCE	(2) 3'-0"	7'-11 1/4" V.I.F.	1 3/4"	ALUMINUM / GLASS	MATCH EXTERIOR STOREFRONT	ALUMINUM	MATCH EXTERIOR STOREFRONT	01	DOORS TO MATCH EXTERIOR STOREFRONT
110B	TRANS. VEST.	B VESTIBULE	(2) 3'-0"	7'-0"	1 3/4"	ALUMINUM / GLASS	BLACK ANODIZED	ALUMINUM	BLACK ANODIZED	02	WIDE-STILE, 10" BOTTOM RAILS, REMOVABLE MULLION
111	ATM ROOM	E SECURED	3'-0"	7'-0"	1 3/4"	SOLID-CORE FLUSH WOOD	PAINT TO MATCH ADJACENT WALL	HOLLOW METAL	PAINT TO MATCH ADJACENT WALL	03	CLOSER CONCEALED FROM CUSTOMER VIEW
114	LOUNGE	M PASSAGE	3'-0"	7'-0"	1 3/4"	SOLID-CORE FLUSH WOOD	PAINT TO MATCH ADJACENT WALL	HOLLOW METAL	PAINT TO MATCH ADJACENT WALL	05	CLOSER CONCEALED FROM CUSTOMER VIEW
115	HALLWAY	E SECURED	3'-0"	7'-0"	1 3/4"	SOLID-CORE FLUSH WOOD	PAINT TO MATCH ADJACENT WALL	HOLLOW METAL	PAINT TO MATCH ADJACENT WALL	03	CLOSER CONCEALED FROM CUSTOMER VIEW
116	UNISEX RESTROOM #1	F PRIVACY	3'-0"	7'-0"	1 3/4"	SOLID-CORE WOOD	PAINT TO MATCH ADJACENT WALL	HOLLOW METAL	PAINT TO MATCH ADJACENT WALL	04	TYPICAL AT RESTROOMS. UNDERCUT DOORS 1" WHEN ROOM PROVIDED WITH ONLY SUPPLY AIR OR RETURN AIR OR EXHAUST. NOTE: PREP DOOR AND DOOR FRMAE TO ACCEPT MAGNETIC RESET MECHANISM
117	UNISEX RESTROOM #2	F PRIVACY	3'-0"	7'-0"	1 3/4"	SOLID-CORE WOOD	PAINT TO MATCH ADJACENT WALL	HOLLOW METAL	PAINT TO MATCH ADJACENT WALL	04	TYPICAL AT RESTROOMS. UNDERCUT DOORS 1" WHEN ROOM PROVIDED WITH ONLY SUPPLY AIR OR RETURN AIR OR EXHAUST. NOTE: PREP DOOR AND DOOR FRMAE TO ACCEPT MAGNETIC RESET MECHANISM
118	UNISEX RESTROOM #3	F PRIVACY	3'-0"	7'-0"	1 3/4"	SOLID-CORE WOOD	PAINT TO MATCH ADJACENT WALL	HOLLOW METAL	PAINT TO MATCH ADJACENT WALL	04	TYPICAL AT RESTROOMS. UNDERCUT DOORS 1" WHEN ROOM PROVIDED WITH ONLY SUPPLY AIR OR RETURN AIR OR EXHAUST. NOTE: PREP DOOR AND DOOR FRMAE TO ACCEPT MAGNETIC RESET MECHANISM
119	DATA ROOM	L UTILITY	3'-0"	7'-0"	1 3/4"	SOLID-CORE FLUSH WOOD	PAINT TO MATCH ADJACENT WALL	HOLLOW METAL	PAINT TO MATCH ADJACENT WALL	06	1-HR RATED. PROVIDE KICK PLATES AT EACH SIDE, AND COMBINED STOP/HOLDER PER HARDWARE SCHEDULE.
120	JAN. CLOSET	L UTILITY	3'-0"	7'-0"	1 3/4"	SOLID-CORE FLUSH WOOD	PAINT TO MATCH ADJACENT WALL	HOLLOW METAL	PAINT TO MATCH ADJACENT WALL	06	PROVIDE KICK PLATES AT EACH SIDE, AND COMBINED STOP/HOLDER PER HARDWARE SCHEDULE.



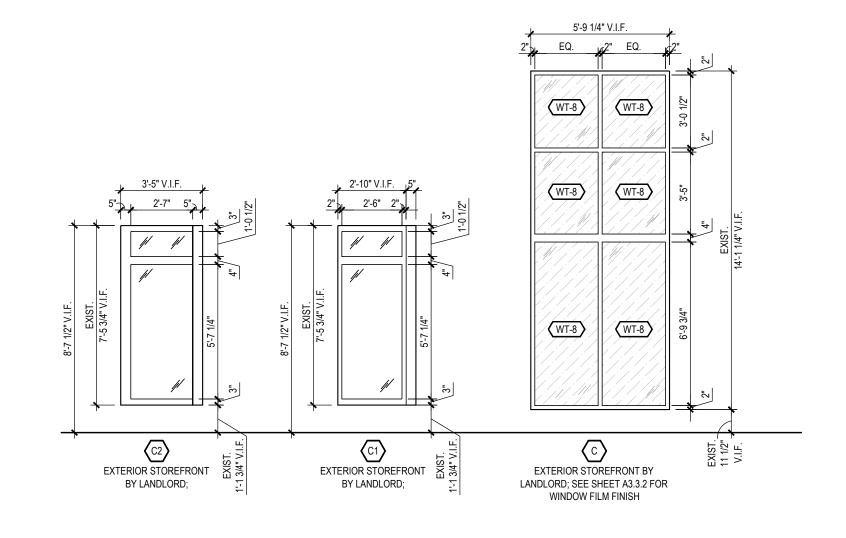

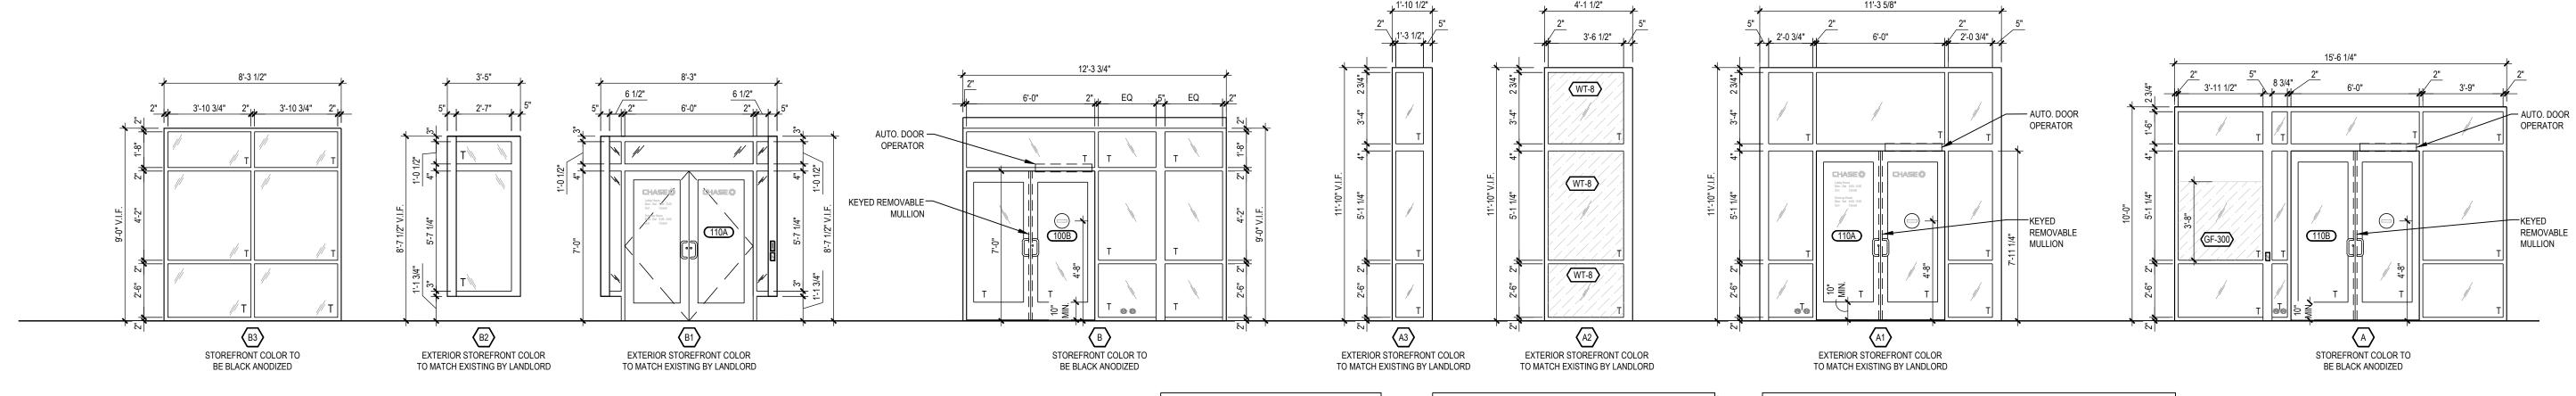
AT NON-ADA-COMPLIANT ENTRANCES, PROVIDE ADA-COMPLIANT DIRECTIONAL SIGNAGE FEATURING THE INTERNATIONAL SYMBOL ACCESSIBILITY AS REQD. TO DIRECT APPROACHING FOOT TRAFFIC TO THE COMPLIANT ENTRANCE

• ALL UNIT DIMENSIONS ARE NOMINAL AND MAY VARY BY MANUFACTURER- COORDINATE WITH WALL SECTIONS • INDIVIDUAL LITES DESIGNATED WITH THE 'T' SYMBOL REQUIRE TEMPERED SAFETY GLASS- VERIFY ADDITIONAL REQUIREMENTS WITH APPLICABLE BUILDING CODES • MODIFY SIGNAGE DESIGN AS REQUIRED TO COMPLY WITH LOCAL BUILDING AND ZONING CODES AND SUBMIT TO OWNER FOR APPROVAL

WINDOW NOTES

- VERIFY ALL DIMENSIONS IN THE FIELD.
- G.C. TO SUBMIT SHOP DRAWINGS TO ARCHITECT FOR REVIEW & APPROVAL PRIOR TO FABRICATION. ALL ALUMINUM STOREFRONT MULLIONS TO BE 2" WIDE x 4 1/2" DEEP UNLESS NOTED OTHERWISE.
- "T" = TEMPERED GLAZING.
- "SP" = SPANDREL GLAZING.
- ALL GLASS TO BE CLEAR, NO TINT UNLESS NOTED OTHERWISE. ALL ALUMINUM STOREFRONT FINISH TO BE BLACK ANODIZED. (U.O.N.)



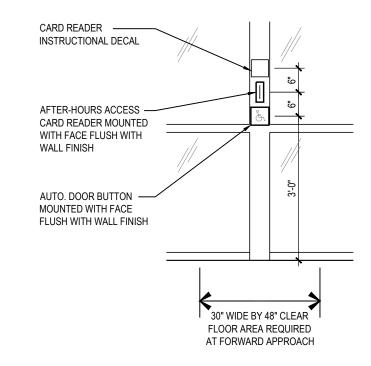

MOUNT CLOSER TO -ROOM SIDE OF DOOR - INTERIOR AUTO. DOOR OPENER LOGO SIGNAGE BY OWNER'S VENDOR 'AUTO-CAUTION-DOOR' SIGNAGE-OMIT DOOR SCOPE -INCLUDED WITH AUTO DOOR AT SDB VIEWING _OPERATOR PACKAGE, OR ROOMS AND PROVIDED SEPARATELY BY G.C.-RESTROOMS COMPLY WITH ANSI/BHMA A159.10.-50" A.F.F. ±12"- COORD. POSITION WITH OWNER'S OTHER SIGNAGE TYPICAL ROOM -IDENTIFICATION SIGNAGE A B UNDERCUT DOORS 1" — AT ROOMS WITHOUT R.A. OPGS. M F REFER TO OWNER'S PUBLICATION CHASE ADA SIGNAGE STANDARDS
AND GUIDELINES, LATEST VERSION, FOR ADDITIONAL OWNER AND
REGULATORY SIGNAGE REQUIREMENTS AND GUIDANCE DOOR NOTES REFER TO SHEET A5.2.1 FOR DOOR HEAD/JAMB AND THRESHOLD DETAILS.

AUTO DOOR BUTTONS AND SIGNAGE

DOOR TYPES 1/4" = 1'-0"

GROUP 9 Galen Street Suite 117 Watertown, MA 02472 617.576.0007 core-states.com ARCHITECT OF RECORD

JAMES T. LALLI, AIA, ARCHITECT LICENSE NO. 32254 THESE DRAWINGS ARE NOT COMPLETE WITHOUT THE

SEPARATE TYPE WRITTEN SPECIFICATIONS MANUAL WHICH ARE PART OF THE CONTRACT DOCUMENTS.

ISSUE DATE DESCRIPTION 2022.07.15 PERMIT SET

PROJECT INFORMATION PROJECT NO: JPM.27118 2022.07.15 PROTOTYPE: K.KELLY DRAWN BY: M.SIDES CHECKED BY:

> DOOR TYPES SCHEDULE DOOR TYPES WINDOW TYPES

SHEET NUMBER

VERSION:

SHEET TITLE

A3.2.1

SSE_1.00

GROUP	COMPONENT	MED	MODEL MODEL	ARDWARE SCHEDU FINISH	NOTES
01	COMPONENT CONTINUOUS GEARED HINGE (2)	MFR. KAWNEER OR	MODEL	MATCH STOREFRONT COLOR	FINISH TO MATCH LL PROVIDED STOREFRONT. CONFIRM HARDWARE COMPATIBILITY WITH EXISTING
ENTRANCE	REMOVABLE MULLION	EQUAL VON DUPRIN	KR4854	MATCH STOREFRONT COLOR	DOOR. PROVIDE REMOVABLE MULLION AT ALL NEW BUILDS. IF REMOVABLE MULLION CANNOT BE INSTALLED
	REWOVABLE WOLLION	VON DOFKIN	NN4054	MATCH STOREFRONT COLOR	DUE TO SITE CONSTRAINTS, PROVIDE ALTERNATE HARDWARE: SEE NOTE 9
	PANIC BAR	VON DUPRIN	CD99EO	MATCH STOREFRONT COLOR	CONFIRM HARDWARE COMPATIBILITY WITH EXISTING DOOR.
	PANIC BAR	VON DUPRIN	CD99NL-OP	MATCH STOREFRONT COLOR	CONFIRM HARDWARE COMPATIBILITY WITH EXISTING DOOR.
	MORTISE CYLINDER MORTISE CYLINDER (2)	SCHLAGE SCHLAGE	20-001/C123 20-001 XQ11-948/C123	626 SATIN CHROMIUM 626 SATIN CHROMIUM	NOTE 8. CONFIRM HARDWARE COMPATIBILITY WITH EXISTING DOOR. NOTE 8. CONFIRM HARDWARE COMPATIBILITY WITH EXISTING DOOR.
	RIM CYLINDER	SCHLAGE	20-022	626 SATIN CHROMIUM	NOTE 8. CONFIRM HARDWARE COMPATIBILITY WITH EXISTING DOOR.
	ELECTRIC STRIKE	VON DUPRIN	6111 FSE DS 24V	630 SATIN STAINLESS STEEL	OMIT AT TYPE 01A (NOTES 4,5). CONFIRM HARDWARE COMPATIBILITY WITH EXISTING DOOR.
	CARD READER SYSTEM	PARABIT	ACSIEV2	BLACK	PROVIDED AND INSTALLED BY OWNER'S SECURITY SYSTEM VENDOR, OMIT AT TYPE 01A (NOTES 4,5)
	OFFSET DOOR PULL (2)	IVES	8190-0-O	630 SATIN STAINLESS STEEL	CONFIRM HARDWARE COMPATIBILITY WITH EXISTING DOOR.
	OFFSET DOOR PULL (ALT.) (2)	TRIMCO	8191191E-3-4.BPVC	PVC	PVC-COATED "STAY-COOL" PULLS FOR USE IN THE DESERT SOUTHWEST ONLY.
	POWER OPERATOR	LCN	4640 CS	MATCH STOREFRONT COLOR	OMIT AT TYPE 01A. MATCH EXISTING STOREFRONT COLOR AT IN-LINE OR EXISTING BUILDING PROJECT GC TO CONFIRM FINISH COLOR WITH ARCHITECT PRIOR TO ORDER. INCLUDE CONCEALED SWITCH BLA END PLATE 334-2. (NOTE 5). CONFIRM HARDWARE COMPATIBILITY WITH EXISTING DOOR.
	DOOR PUSHPLATES (2) EXCEPT CALIFORNIA PROJECTS	LCN	8310-818T (4" SQUARE)	SATIN S.S	OMIT AT TYPE 01A. CONFIRM HARDWARE COMPATIBILITY WITH EXISTING DOOR.
	SURFMOUNT PUSH PLATE ENCLOSURE	LCN	8310-867S	BLACK PLASTIC	FOR USE ONLY AT NON-STANDARD PLANS WHERE A WALL WITH ACCESSIBLE CLEARANCES IS NOT AVAILABLE. NOT TO BE USED AT ANY EXTERIOR NEW-BUILD CONDITION. GC TO CONFIRM WITH ARCHITECT.
	KEY SWITCH	SCHLAGE	653-1414-L2		NARROW-STILE COVER PLATE- OMIT AT TYPE 01A.
	CLOSER	LCN	4111-3077CNS	MATCH STOREFRONT COLOR	PROVIDE 2 AT TYPE 01A, SET TO LOWEST POSSIBLE OPENING FORCE REQUIRED TO MAINTAIN WEATHER SEAL INTEGRITY. CONFIRM HARDWARE COMPATIBILITY WITH EXISTING DOOR.
	SEALS	PEMKO	297AS	MILL-FIN. ALUMINUM	CONFIRM HARDWARE COMPATIBILITY WITH EXISTING DOOR.
	SWEEP- STANDARD	PEMKO	2170 DV	DARK BRONZE VINYL	CONFIRM HARDWARE COMPATIBILITY WITH EXISTING DOOR.
	SWEEP- HIGH WIND CONDITIONS	PEMKO	315 DN	DARK ANOD. BRONZE	ORDER LONG AND CUT METAL SHORT TO ALLOW NEOPRENE TO EXTEND BEYOND DOOR LOCK EDGE
02 VESTIBULE	THRESHOLD	PEMKO	253X3AFG	MILL-FIN. ALUMINUM	CONFIRM HARDWARE COMPATIBILITY WITH EXISTING DOOR.
	CONTINUOUS GEARED HINGE (2)	KAWNEER OR EQUAL	VP-10-1	MATCH STOREFRONT COLOR	CHASE CB2020 PROTYPE COLOR: STANDARD POWDER COAT BLACK
	REMOVABLE MULLION PANIC BAR	VON DUPRIN VON DUPRIN	KR4954 CD99EO	MATCH STOREFRONT COLOR MATCH STOREFRONT COLOR	
	PANIC BAR	VON DUPRIN	CD99NL-OP	MATCH STOREFRONT COLOR	
	MORTISE CYLINDER	SCHLAGE	20-001/C123	626 SATIN CHROMIUM	NOTE 8
	MORTISE CYLINDER (2)	SCHLAGE	20-001 XQ11-948/C123	626 SATIN CHROMIUM	NOTE 8
	RIM CYLINDER	SCHLAGE	20-022	626 SATIN CHROMIUM	NOTE 8
	OFFSET DOOR PULL (2)	IVES	8190-0-O	630 SATIN STAINLESS STEEL	
	POWER OPERATOR	LCN	4640CS	MATCH STOREFRONT COLOR	INCLUDE CONCEALED SWITCH BLANK END PLATE 334-2 (NOTE 5)
	DOOR PUSHPLATES (2) EXCEPT CALIFORNIA PROJECTS	LCN	8310-853T (4" SQUARE)	SATIN S.S	OMIT AT TYPE 01A
	DOOR PUSHPLATES (4) CALIFORNIA PROJECTS ONLY	LCN	8310-853T (4" SQUARE)	SATIN S.S	OMIT AT TYPE 01A
	DOOR PUSHPLATES (2)	LCN	8310-836T	SATIN S.S	OMIT AT TYPE 01A
	OPT. BAR AT CALIFORNIA PROJECTS ONLY SURFMOUNT PUSH PLATE ENCLOSURE	LCN	(6" x 36" BAR) 8310-867S	BLACK PLASTIC	FOR USE ONLY AT NON-STANDARD PLANS WHERE A WALL WITH ACCESSIBLE CLEARANCES IS NOT AVAILABLE. NOT TO BE USED AT ANY EXTERIOR NEW-BUILD CONDITION. GC TO CONFIRM WITH
	KEY SWITCH	LCN	8310-806K		ARCHITECT. RECESSED IN HINGE JAMB MULLION at 38" AFF (NOTE 5)
	CLOSER	LCN	4111-3077CNS	MATCH STOREFRONT COLOR	LEFT-HAND LEAF AS VIEWED FROM EXTERIOR, ADA COMPLIANT
03 SECURED	BUTT HINGE (3)	HAGER	BB1191 ANSI A2112 4.5x4.5	652 SATIN CHROMIUM	
	ELECTRONIC LOCK CLOSER	SCHLAGE LCN	CO-100-CY-70-KP-SPA-626-PD-C123 4011/4041-3077	626 SATIN CHROMIUM SP28 GRAY PAINT	NOTE 8 DOOR-MOUNT ON ROOM SIDE- NOT VISIBLE TO CUSTOMERS; ADA COMPLIANT
	FLOOR STOP	IVES	FS13 / FS17	626 SATIN CHROMIUM	AT DOORS OPENING AGAINST WALL; WITH R14 RISER AS REQUIRED
	OVERHEAD STOP	GLYNN-JOHNSON	410S	630 SATIN STAINLESS STEEL	AT DOORS OPENING AGAINST FURNITURE
	KICK PLATE	IVES	8400	630 SATIN STAINLESS STEEL	PUSH SIDE ONLY; 8" x 2" LESS THAN DOOR WIDTH
	DOOR SCOPE	IPI / DOOR SCOPE	DS2000	SILVER PAINT	ALUMINUM BODY, NOTE 1
	SILENCERS	IVES	SR64	GRAY	
04 PRIVACY	BUTT HINGE (3)	HAGER	BB1191 ANSI A22112 4.5x4.5	652 SATIN CHROMIUM	
FINIVACI	ELECTRONIC LOCK	SCHLAGE	CO-100-CY-40-KP-SPA-626-PD-C123	626 SATIN CHROMIUM	WITH PRIVACY FUNCTION; PREPARE DOOR FOR MAGNETIC RESET FUNCTION. NOTE 8
	CLOSER	LCN	4011/4041-3077	SP28 GRAY PAINT	DOOR-MOUNT ON ROOM SIDE- NOT VISIBLE TO CUSTOMERS, ADA COMPLIANT
	FLOOR STOP	IVES	FS13 / FS17	626 SATIN CHROMIUM	WITH R14 RISER AS REQUIRED
	KICK PLATE COAT HOOKS (2)	IVES IVES	8400 581	630 SATIN STAINLESS STEEL 626 SATIN CHROMIUM	PUSH SIDE ONLY; 8" x 2" LESS THAN DOOR WIDTH AT RESTROOMS ONLY, 1 AT 36" AFF, 1 AT 60" AFF
	DOOR SCOPE	IPI / DOOR SCOPE	DS2000	SILVER PAINT	ALUMINUM BODY- OMIT AT RESTROOMS & SDB VIEWING ROOMS, NOTE 1
	SILENCERS	IVES	SR64	GRAY	
05	BUTT HINGE (3)	HAGER	BB1191 ANSI A2112 4.5x4.5	652 SATIN CHROMIUM	
PASSAGE	PASSAGE LATCH SET	SCHLAGE	ND10S/SPA	626 SATIN CHROMIUM	INCLUDE MILLED GROOVES (/8SP) AT ELECTRICAL ROOM DOORS
	CLOSER	LCN	4011/4041-3077	SP28 GRAY PAINT	DOOR-MOUNT ON ROOM SIDE- NOT VISIBLE TO CUSTOMERS, ADA COMPLIANT
	FLOOR STOP	IVES	FS13 / FS17	626 SATIN CHROMIUM	WITH R14 RISER AS REQUIRED
	KICK PLATE SILENCERS	IVES IVES	8400 SR64	630 SATIN STAINLESS STEEL GRAY	PUSH SIDE ONLY; 8" x 2" LESS THAN DOOR WIDTH
06	BUTT HINGE (3)	HAGER	BB1191 ANSI A2112 4.5x4.5	652 SATIN CHROMIUM	
UTILITY	STOREROOM LOCK SET	SCHLAGE	ND80PD-C123/SPA	626 SATIN CHROMIUM	NOTE 8
	CLOSER	LCN	4011/4041-3077	SP28 GRAY PAINT	DOOR-MOUNT ON ROOM SIDE- NOT VISIBLE TO CUSTOMERS, ADA COMPLIANT
	CONCEALED OVERHEAD STOP/HOLDER	GLYNN-JOHNSON	410H	630 SATIN STAINLESS STEEL	OVERHEAD CONCEALED COMBINED STOP/HOLDER REQUIRED AT PLUMBING/JANITOR CLOSET, ELECTRICAL, AND DATA ROOMS; OMIT AT ROOMS WITH LADDER ONLY.
	KICK PLATE (2)	IVES	8400	630 SATIN STAINLESS STEEL	8" x 2" LESS THAN DOOR WIDTH; PLUMBING/JANITOR CLOSET, ELECTRICAL, AND DATA ROOMS REQUIRE KICK PLATES AT BOTH SIDES OF DOOR.
	DOOR SWEEP	PEMKO	4131CNBL	CLEAR ANOD. ALUMINUM	DATA ROOM DOOR ONLY
	DOOR SCOPE	IPI / DOOR SCOPE	DS2000	SILVER PAINT	ALUMINUM BODY, NOTE 1
TEO:	SILENCERS	IVES	SR64	GRAY	NTO ADEAC ACCECCIBLE TO CHOTOMERO
ES:			·		NTO AREAS ACCESSIBLE TO CUSTOMERS. IT THE 4" BEVELLED BOTTOM RAIL EXCEPTION TO THE 10" DOOR BOTTOM RAIL REQUIREMENT.
OTES.	3. DOOR HARDWARE VENDOR IS TO VER	IFY COMPATIBILITY OF HARDWARE MUST BE A	SPECIFIED HARDWARE AND SUBMIT APPROVED BY THE OWNER. CHANGE (RECOMMENDATIONS AS REQUIRED TO DRDERS RESULTING FROM NON-COMP	THE G.C. TO CONFORM TO THE LOCK FUNCTION AND FINISH HARDWARE CONFIGURATION DESIGN INTENT PATIBIILTY OF HARDWARE WILL NOT BE ACCEPTED.
	5. REFER TO AUTO DOOR CONTROL DIAG	GRAMS, SHEET E3.			
					RCE AS LOW AS POSSIBLE WHILE ALLOWING THE DOOR TO FULLY LATCH.
	6. ADJUST DOOR CLOSERS TO COMPLY	WITH ANSI A117.1 REC	UIREMENTS FOR OPENING FORCE AN	D CLOSING SPEED. SET OPENING FOR	RCE AS LOW AS POSSIBLE WHILE ALLOWING THE DOOR TO FULLY LATCH.
	7. FOR PROJECTS WITH A SINGLE ALARM				S WITH MULTIPLE ALARMED DOORS, INSTALL SIZE POWER SUPPLY FOR MULTIPLE DOORS AND INSTALL IN A
	7. FOR PROJECTS WITH A SINGLE ALARM CENTRAL LOCATION.	MED EGRESS DOOR, IN	ISTALL POWER SUPPLY ABOVE FINISH	CEILING OVER DOOR. FOR PROJECTS	

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ISSUE DATE DESCRIPTION
- 2022.07.15 PERMIT SET

PROJECT INFORMATION

PROJECT NO: JPM.27118

DATE: 2022.07.15

PROTOTYPE: 20.3

DRAWN BY: K.KELLY

CHECKED BY: M.SIDES

VERSION: SSE_1.00

DOOR HARDWARE SCHEDULE

SHEET NUMBER

A3.2.2

	INTERIOR FINISH SCHE TRANSACTION VESTIBULE	:DULE
	WALK-OFF MAT	CPT-302
	WALL BASE	WB-402
	ATM WALL	WC-402
	7111111111	
	WALLS (NON-ATM)	PT-500
	SUSPENDED GRID CEILING	ACT-4
	SOFFITS- FACE AND BOTTOM	PT-500
	LIGHT FIXTURES- GENERAL	L-500
	ILLUMINATED OCTAGON	PREFERRED
	LOBBY AND CORRIDOR	
		T 504
	FLOOR- FIELD TILE	T-501
	WALL BASE	WB-402
	WALLS - GENERAL	PT-500
	WALL - CAFÉ / COMMUNITY WALL	PT-311 (NOTE 13)
	WALL - ATM WITH DIGITAL SCREEN	PT-311 (NOTE 13)
	SUSPENDED GRID CEILING	ACT-4
		701-4
	GYPSUM CEILINGS, SOFFIT BOTTOMS AND SOFFIT FACES NOT FLUSH WITH WALL	PT-500
	WINDOW SILLS	SS-300
	LIGHT FIXTURES- GENERAL	L-500
	LIGHT FIXTURES - CEILING ACCENT	L-11
	WINDOW SHADES (NOTE 6B)	WT-1 / WT-2
	LIVING ROOM	
	FLOOR- AREA RUG	I DAD 4
		LRAR-4
	WALLS- GENERAL	PT-500
L	FEATURE WALL PANELS	WD-601
	LIGHT FIXTURES- GENERAL	L-500
	MANUAL TRANSACTIONS	1
	FLOOR	CPT-321
	WALL BASE	WB-402
	WALLS - GENERAL	PT-500
	WALLS - MANUAL TRANSACTION BACK WALL	PT-500
	WALLS- ACCENT	(NOTE 13)
	MILLWORK- GENERAL	PL-502 / PL-503
	MANUAL TRANSACTION MODULE FRONT PANELS	(NOTE 5)
	MANUAL TRANSACTION MODULE COUNTER	(NOTE 5)
	CEILING	ACT-4
		AC1-4
	SOFFITS- BOTTOM AND FACES NOT FLUSH WITH	PT-500
		1.44
	LIGHT FIXTURES- GENERAL	L-11
	ILLUMINATED OCTAGON	PREFERRED
	SCRIM	WT-20
	CASUAL AND PRIVATE CONSULTATION SPAC	E (CCS, PCS)
		,
	FLOOR - GENERAL	CPT-320
	FLOOR - GENERAL WALL BASE	CPT-320 WB-400
	FLOOR - GENERAL	CPT-320
	FLOOR - GENERAL WALL BASE	CPT-320 WB-400
	FLOOR - GENERAL WALL BASE WALLS WALLS - PARTIAL HEIGHT	CPT-320 WB-400 (NOTE 12)
	FLOOR - GENERAL WALL BASE WALLS	CPT-320 WB-400 (NOTE 12) (NOTE 12)
	FLOOR - GENERAL WALL BASE WALLS WALLS - PARTIAL HEIGHT GLAZING HARDWARE	CPT-320 WB-400 (NOTE 12) (NOTE 12) DEMOUNTABLE WALL SYTEM (NOTE 12) DEMOUNTABLE WALL
	FLOOR - GENERAL WALL BASE WALLS WALLS - PARTIAL HEIGHT	CPT-320 WB-400 (NOTE 12) (NOTE 12) DEMOUNTABLE WALL SYTEM (NOTE 12)
	FLOOR - GENERAL WALL BASE WALLS WALLS - PARTIAL HEIGHT GLAZING HARDWARE	CPT-320 WB-400 (NOTE 12) (NOTE 12) DEMOUNTABLE WALL SYTEM (NOTE 12) DEMOUNTABLE WALL
	FLOOR - GENERAL WALL BASE WALLS WALLS - PARTIAL HEIGHT GLAZING HARDWARE DOOR CLOSER COVER CEILING	CPT-320 WB-400 (NOTE 12) (NOTE 12) DEMOUNTABLE WALL SYTEM (NOTE 12) DEMOUNTABLE WALL SYTEM (NOTE 12) ACT-4
	FLOOR - GENERAL WALL BASE WALLS WALLS - PARTIAL HEIGHT GLAZING HARDWARE DOOR CLOSER COVER CEILING PCS/CMS BULKHEADS	CPT-320 WB-400 (NOTE 12) (NOTE 12) DEMOUNTABLE WALL SYTEM (NOTE 12) DEMOUNTABLE WALL SYTEM (NOTE 12)
	FLOOR - GENERAL WALL BASE WALLS WALLS - PARTIAL HEIGHT GLAZING HARDWARE DOOR CLOSER COVER CEILING	CPT-320 WB-400 (NOTE 12) (NOTE 12) DEMOUNTABLE WALL SYTEM (NOTE 12) DEMOUNTABLE WALL SYTEM (NOTE 12) ACT-4
	FLOOR - GENERAL WALL BASE WALLS WALLS - PARTIAL HEIGHT GLAZING HARDWARE DOOR CLOSER COVER CEILING PCS/CMS BULKHEADS SOFFITS - BOTTOM AND FACES NOT FLUSH WITH WALL	CPT-320 WB-400 (NOTE 12) (NOTE 12) DEMOUNTABLE WALL SYTEM (NOTE 12) DEMOUNTABLE WALL SYTEM (NOTE 12) ACT-4 PT-500 PT-500
	FLOOR - GENERAL WALL BASE WALLS WALLS - PARTIAL HEIGHT GLAZING HARDWARE DOOR CLOSER COVER CEILING PCS/CMS BULKHEADS SOFFITS - BOTTOM AND FACES NOT FLUSH WITH WALL LIGHT FIXTURES- GENERAL	CPT-320 WB-400 (NOTE 12) (NOTE 12) DEMOUNTABLE WALL SYTEM (NOTE 12) DEMOUNTABLE WALL SYTEM (NOTE 12) ACT-4 PT-500 PT-500 L-500
	FLOOR - GENERAL WALL BASE WALLS WALLS - PARTIAL HEIGHT GLAZING HARDWARE DOOR CLOSER COVER CEILING PCS/CMS BULKHEADS SOFFITS - BOTTOM AND FACES NOT FLUSH WITH WALL LIGHT FIXTURES- GENERAL LIGHT FIXTURES- PENDANT - PCS	CPT-320 WB-400 (NOTE 12) (NOTE 12) DEMOUNTABLE WALL SYTEM (NOTE 12) DEMOUNTABLE WALL SYTEM (NOTE 12) ACT-4 PT-500 PT-500 L-500 L-410
	FLOOR - GENERAL WALL BASE WALLS WALLS - PARTIAL HEIGHT GLAZING HARDWARE DOOR CLOSER COVER CEILING PCS/CMS BULKHEADS SOFFITS - BOTTOM AND FACES NOT FLUSH WITH WALL LIGHT FIXTURES- GENERAL LIGHT FIXTURES- PENDANT - PCS WINDOW SHADES: PCS / CMS (NOTE 6B)	CPT-320 WB-400 (NOTE 12) (NOTE 12) DEMOUNTABLE WALL SYTEM (NOTE 12) DEMOUNTABLE WALL SYTEM (NOTE 12) ACT-4 PT-500 PT-500 L-500
	FLOOR - GENERAL WALL BASE WALLS WALLS - PARTIAL HEIGHT GLAZING HARDWARE DOOR CLOSER COVER CEILING PCS/CMS BULKHEADS SOFFITS - BOTTOM AND FACES NOT FLUSH WITH WALL LIGHT FIXTURES- GENERAL LIGHT FIXTURES- PENDANT - PCS	CPT-320 WB-400 (NOTE 12) (NOTE 12) DEMOUNTABLE WALL SYTEM (NOTE 12) DEMOUNTABLE WALL SYTEM (NOTE 12) ACT-4 PT-500 PT-500 L-500 L-410
	FLOOR - GENERAL WALL BASE WALLS WALLS - PARTIAL HEIGHT GLAZING HARDWARE DOOR CLOSER COVER CEILING PCS/CMS BULKHEADS SOFFITS - BOTTOM AND FACES NOT FLUSH WITH WALL LIGHT FIXTURES- GENERAL LIGHT FIXTURES- PENDANT - PCS WINDOW SHADES: PCS / CMS (NOTE 6B)	CPT-320 WB-400 (NOTE 12) (NOTE 12) DEMOUNTABLE WALL SYTEM (NOTE 12) DEMOUNTABLE WALL SYTEM (NOTE 12) ACT-4 PT-500 PT-500 L-500 L-410
	FLOOR - GENERAL WALL BASE WALLS WALLS - PARTIAL HEIGHT GLAZING HARDWARE DOOR CLOSER COVER CEILING PCS/CMS BULKHEADS SOFFITS - BOTTOM AND FACES NOT FLUSH WITH WALL LIGHT FIXTURES- GENERAL LIGHT FIXTURES- PENDANT - PCS WINDOW SHADES: PCS / CMS (NOTE 6B) CONFERENCE ROOM	CPT-320 WB-400 (NOTE 12) (NOTE 12) DEMOUNTABLE WALL SYTEM (NOTE 12) DEMOUNTABLE WALL SYTEM (NOTE 12) ACT-4 PT-500 PT-500 L-500 L-410 WT-1 / WT-2
	FLOOR - GENERAL WALL BASE WALLS WALLS - PARTIAL HEIGHT GLAZING HARDWARE DOOR CLOSER COVER CEILING PCS/CMS BULKHEADS SOFFITS - BOTTOM AND FACES NOT FLUSH WITH WALL LIGHT FIXTURES- GENERAL LIGHT FIXTURES- PENDANT - PCS WINDOW SHADES: PCS / CMS (NOTE 6B) CONFERENCE ROOM FLOOR - GENERAL WALL BASE	CPT-320 WB-400 (NOTE 12) (NOTE 12) DEMOUNTABLE WALL SYTEM (NOTE 12) DEMOUNTABLE WALL SYTEM (NOTE 12) ACT-4 PT-500 PT-500 L-500 L-410 WT-1 / WT-2 CPT-320 WB-402
	FLOOR - GENERAL WALL BASE WALLS WALLS - PARTIAL HEIGHT GLAZING HARDWARE DOOR CLOSER COVER CEILING PCS/CMS BULKHEADS SOFFITS - BOTTOM AND FACES NOT FLUSH WITH WALL LIGHT FIXTURES- GENERAL LIGHT FIXTURES- PENDANT - PCS WINDOW SHADES: PCS / CMS (NOTE 6B) CONFERENCE ROOM FLOOR - GENERAL WALL BASE WALLS	CPT-320 WB-400 (NOTE 12) (NOTE 12) DEMOUNTABLE WALL SYTEM (NOTE 12) DEMOUNTABLE WALL SYTEM (NOTE 12) ACT-4 PT-500 PT-500 L-500 L-410 WT-1 / WT-2 CPT-320 WB-402 (NOTE 12)
	FLOOR - GENERAL WALL BASE WALLS WALLS - PARTIAL HEIGHT GLAZING HARDWARE DOOR CLOSER COVER CEILING PCS/CMS BULKHEADS SOFFITS - BOTTOM AND FACES NOT FLUSH WITH WALL LIGHT FIXTURES- GENERAL LIGHT FIXTURES- PENDANT - PCS WINDOW SHADES: PCS / CMS (NOTE 6B) CONFERENCE ROOM FLOOR - GENERAL WALL BASE	CPT-320 WB-400 (NOTE 12) (NOTE 12) DEMOUNTABLE WALL SYTEM (NOTE 12) DEMOUNTABLE WALL SYTEM (NOTE 12) ACT-4 PT-500 PT-500 L-500 L-410 WT-1 / WT-2 CPT-320 WB-402 (NOTE 12) (NOTE 12)
	FLOOR - GENERAL WALL BASE WALLS WALLS - PARTIAL HEIGHT GLAZING HARDWARE DOOR CLOSER COVER CEILING PCS/CMS BULKHEADS SOFFITS - BOTTOM AND FACES NOT FLUSH WITH WALL LIGHT FIXTURES- GENERAL LIGHT FIXTURES- PENDANT - PCS WINDOW SHADES: PCS / CMS (NOTE 6B) CONFERENCE ROOM FLOOR - GENERAL WALL BASE WALLS	CPT-320 WB-400 (NOTE 12) (NOTE 12) DEMOUNTABLE WALL SYTEM (NOTE 12) DEMOUNTABLE WALL SYTEM (NOTE 12) ACT-4 PT-500 PT-500 L-500 L-410 WT-1 / WT-2 CPT-320 WB-402 (NOTE 12) (NOTE 12) DEMOUNTABLE WALL
	FLOOR - GENERAL WALL BASE WALLS WALLS - PARTIAL HEIGHT GLAZING HARDWARE DOOR CLOSER COVER CEILING PCS/CMS BULKHEADS SOFFITS - BOTTOM AND FACES NOT FLUSH WITH WALL LIGHT FIXTURES- GENERAL LIGHT FIXTURES- PENDANT - PCS WINDOW SHADES: PCS / CMS (NOTE 6B) CONFERENCE ROOM FLOOR - GENERAL WALL BASE WALLS WALLS - PARTIAL HEIGHT	CPT-320 WB-400 (NOTE 12) (NOTE 12) DEMOUNTABLE WALL SYTEM (NOTE 12) DEMOUNTABLE WALL SYTEM (NOTE 12) ACT-4 PT-500 PT-500 L-500 L-410 WT-1 / WT-2 CPT-320 WB-402 (NOTE 12) (NOTE 12) DEMOUNTABLE WALL SYTEM (NOTE 12)
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	FLOOR - GENERAL WALL BASE WALLS WALLS - PARTIAL HEIGHT GLAZING HARDWARE DOOR CLOSER COVER CEILING PCS/CMS BULKHEADS SOFFITS - BOTTOM AND FACES NOT FLUSH WITH WALL LIGHT FIXTURES- GENERAL LIGHT FIXTURES- PENDANT - PCS WINDOW SHADES: PCS / CMS (NOTE 6B) CONFERENCE ROOM FLOOR - GENERAL WALL BASE WALLS WALLS - PARTIAL HEIGHT GLAZING HARDWARE DOOR CLOSER COVER CEILING CONFERENCE BULKHEADS SOFFITS - BOTTOM AND FACES NOT FLUSH WITH WALL LIGHT FIXTURES- GENERAL LIGHT FIXTURES- GENERAL LIGHT FIXTURES- GENERAL LIGHT FIXTURES - ACCENT - CONFERENCE ROOM WINDOW SHADES: CONFERENCE (NOTE 6B)	CPT-320 WB-400 (NOTE 12) (NOTE 12) DEMOUNTABLE WALL SYTEM (NOTE 12) DEMOUNTABLE WALL SYTEM (NOTE 12) ACT-4 PT-500 PT-500 L-500 L-410 WT-1 / WT-2 CPT-320 WB-402 (NOTE 12) (NOTE 12) DEMOUNTABLE WALL SYTEM (NOTE 12) DEMOUNTABLE WALL SYTEM (NOTE 12) DEMOUNTABLE WALL SYTEM (NOTE 12) ACT-4 PT-500 PT-500 L-500
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	FLOOR - GENERAL WALL BASE WALLS WALLS - PARTIAL HEIGHT GLAZING HARDWARE DOOR CLOSER COVER CEILING PCS/CMS BULKHEADS SOFFITS - BOTTOM AND FACES NOT FLUSH WITH WALL LIGHT FIXTURES- PENDANT - PCS WINDOW SHADES: PCS / CMS (NOTE 6B) CONFERENCE ROOM FLOOR - GENERAL WALL BASE WALLS WALLS - PARTIAL HEIGHT GLAZING HARDWARE DOOR CLOSER COVER CEILING CONFERENCE BULKHEADS SOFFITS - BOTTOM AND FACES NOT FLUSH WITH WALL LIGHT FIXTURES - ACCENT - CONFERENCE ROOM WINDOW SHADES: CONFERENCE (NOTE 6B) BOOTH FLOOR WALL BASE WALLS - ACCENT PAINT WALLS - WOOD ACCENT CEILING BOOTH BULKHEADS SOFFITS - BOTTOM AND FACES NOT FLUSH WITH WALLS - WOOD ACCENT CEILING BOOTH BULKHEADS SOFFITS - BOTTOM AND FACES NOT FLUSH WITH WALLS - WOOD ACCENT	CPT-320 WB-400 (NOTE 12) (NOTE 12) DEMOUNTABLE WALL SYTEM (NOTE 12) DEMOUNTABLE WALL SYTEM (NOTE 12) ACT-4 PT-500 L-500 L-410 WT-1 / WT-2 CPT-320 WB-402 (NOTE 12) (NOTE 12) DEMOUNTABLE WALL SYTEM (NOTE 12) CNOTE 12) DEMOUNTABLE WALL SYTEM (NOTE 12) DEMOUNTABLE WALL SYTEM (NOTE 12) ACT-4 PT-500 PT-500 L-500 L-413 WT-7 T-501 WB-402 PT-501 (NOTE 12) WD-502 PT-500 PT-500 L-500 L-500 L-500
	FLOOR - GENERAL WALL BASE WALLS WALLS - PARTIAL HEIGHT GLAZING HARDWARE DOOR CLOSER COVER CEILING PCS/CMS BULKHEADS SOFFITS - BOTTOM AND FACES NOT FLUSH WITH WALL LIGHT FIXTURES- GENERAL LIGHT FIXTURES- PENDANT - PCS WINDOW SHADES: PCS / CMS (NOTE 6B) CONFERENCE ROOM FLOOR - GENERAL WALL BASE WALLS WALLS - PARTIAL HEIGHT GLAZING HARDWARE DOOR CLOSER COVER CEILING CONFERENCE BULKHEADS SOFFITS - BOTTOM AND FACES NOT FLUSH WITH WALL LIGHT FIXTURES - ACCENT - CONFERENCE ROOM WINDOW SHADES: CONFERENCE (NOTE 6B) BOOTH FLOOR WALL BASE WALLS - ACCENT PAINT WALLS - WOOD ACCENT CEILING BOOTH BULKHEADS SOFFITS - BOTTOM AND FACES NOT FLUSH WITH WALLS - WOOD ACCENT CEILING BOOTH BULKHEADS SOFFITS - BOTTOM AND FACES NOT FLUSH WITH WALLS - WOOD ACCENT	CPT-320 WB-400 (NOTE 12) (NOTE 12) DEMOUNTABLE WALL SYTEM (NOTE 12) DEMOUNTABLE WALL SYTEM (NOTE 12) ACT-4 PT-500 L-500 L-410 WT-1 / WT-2 CPT-320 WB-402 (NOTE 12) (NOTE 12) DEMOUNTABLE WALL SYTEM (NOTE 12) CNOTE 12) DEMOUNTABLE WALL SYTEM (NOTE 12) DEMOUNTABLE WALL SYTEM (NOTE 12) ACT-4 PT-500 PT-500 L-500 L-413 WT-7 T-501 WB-402 PT-501 (NOTE 12) WD-502 WD-502 PT-500 PT-500 PT-500
	FLOOR - GENERAL WALL BASE WALLS WALLS - PARTIAL HEIGHT GLAZING HARDWARE DOOR CLOSER COVER CEILING PCS/CMS BULKHEADS SOFFITS - BOTTOM AND FACES NOT FLUSH WITH WALL LIGHT FIXTURES- GENERAL LIGHT FIXTURES- PENDANT - PCS WINDOW SHADES: PCS / CMS (NOTE 6B) CONFERENCE ROOM FLOOR - GENERAL WALL BASE WALLS WALLS - PARTIAL HEIGHT GLAZING HARDWARE DOOR CLOSER COVER CEILING CONFERENCE BULKHEADS SOFFITS - BOTTOM AND FACES NOT FLUSH WITH WALL LIGHT FIXTURES - ACCENT - CONFERENCE ROOM WINDOW SHADES: CONFERENCE (NOTE 6B) BOOTH FLOOR WALL BASE WALLS - ACCENT PAINT WALLS - WOOD ACCENT CEILING BOOTH BULKHEADS SOFFITS - BOTTOM AND FACES NOT FLUSH WITH WALLS - WOOD ACCENT CEILING BOOTH BULKHEADS SOFFITS - BOTTOM AND FACES NOT FLUSH WITH WALLS - WOOD ACCENT	CPT-320 WB-400 (NOTE 12) (NOTE 12) DEMOUNTABLE WALL SYTEM (NOTE 12) DEMOUNTABLE WALL SYTEM (NOTE 12) ACT-4 PT-500 L-500 L-410 WT-1 / WT-2 CPT-320 WB-402 (NOTE 12) (NOTE 12) DEMOUNTABLE WALL SYTEM (NOTE 12) CPT-320 WB-402 (NOTE 12) DEMOUNTABLE WALL SYTEM (NOTE 12) DEMOUNTABLE WALL SYTEM (NOTE 12) ACT-4 PT-500 PT-500 L-500 L-413 WT-7 T-501 WB-402 PT-501 (NOTE 12) WD-502 WD-502 PT-500 PT-500 PT-500 PT-500


DINING ROOM TABLE (I	DRT)
FLOOR (DRT ON HARD SURFACE)	T-501
WALL BASE	WB-402
WALLS - GENERAL	PT-500
WALLS - DIGITAL	PT-311 (NOTE 13)
WALLS - PARTIAL HEIGHT	PT-500
CEILING	ACT-4
LIGHT FIXTURES- GENERAL	L-500
SDB CHEST ROOM O	PR VAULT
FLOOR	CPT-320
WALL BASE	WB-402
WALLS - GENERAL	PT-500
CEILING	ACT-2
LIGHT FIXTURES	L-2
SDB VIEWING ROOM	 M
FLOOR	CPT-320
WALL BASE	WB-402
WALLS	PT-500
WALL- ACCENT (COUNTER WALL)	PT-501
MILLWORK COUNTER	SS-300
CARREL COUNTER	SS-300
CEILING	ACT-2
LIGHT FIXTURES- GENERAL	L-2
RESTROOMS (NOTE 6	
FLOOR- FIELD	, T-402
WALLS - GENERAL	PT-500
WALL- VANITY	PT-501
WALL TILE	T-402
CEILING	ACT-2
LIGHT FIXTURES- GENERAL	L-2
VORK / PRINT / FILE / STORAGE ROOMS, LTOS AND	
MANUAL TRANSACTION	
FLOOR	CPT-320
WALL BASE	WB-402
WALLS	PT-500
MILLWORK	PL-502 / PL-503
	ACT-2
CEILING	
CEILING LIGHT FIXTURES	L-2
	L-2
LIGHT FIXTURES	L-2
LIGHT FIXTURES LAO (FORMERLY LTOS) / CASH ROOMS- OPEN TO	L-2 MANUAL TRANSACTION AREAS
LIGHT FIXTURES LAO (FORMERLY LTOS) / CASH ROOMS- OPEN TO FLOOR	L-2 MANUAL TRANSACTION AREAS CPT-321
LIGHT FIXTURES LAO (FORMERLY LTOS) / CASH ROOMS- OPEN TO FLOOR WALL BASE	L-2 MANUAL TRANSACTION AREAS CPT-321 WB-402
LIGHT FIXTURES LAO (FORMERLY LTOS) / CASH ROOMS- OPEN TO FLOOR WALL BASE WALLS	L-2 MANUAL TRANSACTION AREAS CPT-321 WB-402 PT-500
LIGHT FIXTURES LAO (FORMERLY LTOS) / CASH ROOMS- OPEN TO FLOOR WALL BASE WALLS MILLWORK	L-2 MANUAL TRANSACTION AREAS CPT-321 WB-402 PT-500 PL-502 / PL-503
LIGHT FIXTURES LAO (FORMERLY LTOS) / CASH ROOMS- OPEN TO FLOOR WALL BASE WALLS MILLWORK CEILING	L-2 MANUAL TRANSACTION AREAS CPT-321 WB-402 PT-500 PL-502 / PL-503 ACT-2
LIGHT FIXTURES LAO (FORMERLY LTOS) / CASH ROOMS- OPEN TO FLOOR WALL BASE WALLS MILLWORK CEILING LIGHT FIXTURES	L-2 MANUAL TRANSACTION AREAS CPT-321 WB-402 PT-500 PL-502 / PL-503 ACT-2
LIGHT FIXTURES LAO (FORMERLY LTOS) / CASH ROOMS- OPEN TO FLOOR WALL BASE WALLS MILLWORK CEILING LIGHT FIXTURES LOUNGE	L-2 MANUAL TRANSACTION AREAS CPT-321 WB-402 PT-500 PL-502 / PL-503 ACT-2 L-2
LIGHT FIXTURES LAO (FORMERLY LTOS) / CASH ROOMS- OPEN TO FLOOR WALL BASE WALLS MILLWORK CEILING LIGHT FIXTURES LOUNGE FLOOR	L-2 MANUAL TRANSACTION AREAS CPT-321 WB-402 PT-500 PL-502 / PL-503 ACT-2 L-2 T-402
LIGHT FIXTURES LAO (FORMERLY LTOS) / CASH ROOMS- OPEN TO FLOOR WALL BASE WALLS MILLWORK CEILING LIGHT FIXTURES LOUNGE FLOOR WALL BASE	L-2 MANUAL TRANSACTION AREAS CPT-321 WB-402 PT-500 PL-502 / PL-503 ACT-2 L-2 T-402 WB-402
LIGHT FIXTURES LAO (FORMERLY LTOS) / CASH ROOMS- OPEN TO FLOOR WALL BASE WALLS MILLWORK CEILING LIGHT FIXTURES LOUNGE FLOOR WALL BASE WALLS WALLS	L-2 MANUAL TRANSACTION AREAS CPT-321 WB-402 PT-500 PL-502 / PL-503 ACT-2 L-2 T-402 WB-402 PT-500
LIGHT FIXTURES LAO (FORMERLY LTOS) / CASH ROOMS- OPEN TO FLOOR WALL BASE WALLS MILLWORK CEILING LIGHT FIXTURES LOUNGE FLOOR WALL BASE WALLS MILLWORK MILLWORK MILLWORK MILLWORK	L-2 MANUAL TRANSACTION AREAS CPT-321 WB-402 PT-500 PL-502 / PL-503 ACT-2 L-2 T-402 WB-402 PT-500 PT-500 PL-503
LIGHT FIXTURES LAO (FORMERLY LTOS) / CASH ROOMS- OPEN TO FLOOR WALL BASE WALLS MILLWORK CEILING LIGHT FIXTURES LOUNGE FLOOR WALL BASE WALLS MILLWORK MILLWORK MILLWORK MILLWORK	L-2 MANUAL TRANSACTION AREAS CPT-321 WB-402 PT-500 PL-502 / PL-503 ACT-2 L-2 T-402 WB-402 PT-500 PL-503 PL-503 PL-503 PL-503
LIGHT FIXTURES LAO (FORMERLY LTOS) / CASH ROOMS- OPEN TO FLOOR WALL BASE WALLS MILLWORK CEILING LIGHT FIXTURES LOUNGE FLOOR WALL BASE WALLS MILLWORK CEILING CEILING CEILING FLOOR WALL BASE WALLS MILLWORK COUNTER MILLWORK CEILING	L-2 MANUAL TRANSACTION AREAS CPT-321 WB-402 PT-500 PL-502 / PL-503 ACT-2 L-2 T-402 WB-402 PT-500 PL-503 PL-503 PL-503 PL-502 ACT-2 L-2
LIGHT FIXTURES LAO (FORMERLY LTOS) / CASH ROOMS- OPEN TO FLOOR WALL BASE WALLS MILLWORK CEILING LIGHT FIXTURES FLOOR WALL BASE WALLS MILLWORK CEILING LIGHT FIXTURES LOUNGE FLOOR WALL BASE WALLS MILLWORK COUNTER MILLWORK CEILING LIGHT FIXTURES	L-2 MANUAL TRANSACTION AREAS CPT-321 WB-402 PT-500 PL-502 / PL-503 ACT-2 L-2 T-402 WB-402 PT-500 PL-503 PL-503 PL-503 PL-502 ACT-2 L-2
LIGHT FIXTURES LAO (FORMERLY LTOS) / CASH ROOMS- OPEN TO FLOOR WALL BASE WALLS MILLWORK CEILING LIGHT FIXTURES LOUNGE FLOOR WALL BASE WALLS MILLWORK COUNTER MILLWORK CEILING LIGHT FIXTURES MILLWORK CEILING LIGHT FIXTURES	L-2 MANUAL TRANSACTION AREAS CPT-321 WB-402 PT-500 PL-502 / PL-503 ACT-2 L-2 T-402 WB-402 PT-500 PL-503 PL-503 PL-503 PL-502 ACT-2 L-2 DER / ATM ROOMS
LIGHT FIXTURES LAO (FORMERLY LTOS) / CASH ROOMS- OPEN TO FLOOR WALL BASE WALLS MILLWORK CEILING LIGHT FIXTURES LOUNGE FLOOR WALL BASE WALLS MILLWORK COUNTER MILLWORK CEILING LIGHT FIXTURES FLOOR WALL BASE WALLS MILLWORK CEILING LIGHT FIXTURES JANITOR / DATA / ELECTRICAL/ LADI FLOOR WALL BASE	L-2 MANUAL TRANSACTION AREAS CPT-321 WB-402 PT-500 PL-502 / PL-503 ACT-2 L-2 T-402 WB-402 PT-500 PL-503 PL-503 PL-502 ACT-2 L-2 DER / ATM ROOMS SC (NOTE 14) WB-403
LIGHT FIXTURES LAO (FORMERLY LTOS) / CASH ROOMS- OPEN TO FLOOR WALL BASE WALLS MILLWORK CEILING LIGHT FIXTURES LOUNGE FLOOR WALL BASE WALLS MILLWORK COUNTER MILLWORK CEILING LIGHT FIXTURES MILLWORK CEILING LIGHT FIXTURES	L-2 MANUAL TRANSACTION AREAS CPT-321 WB-402 PT-500 PL-502 / PL-503 ACT-2 L-2 T-402 WB-402 PT-500 PL-503 PL-503 PL-502 ACT-2 L-2 DER / ATM ROOMS SC (NOTE 14)

LIGHT FIXTURES

L-2 (U.N.O.)

WB-402	3/8" 4 1/4" 4 1/4"	MB-405 MB-405	5/8" 4 7/8" 4 1/4" 4 1/4"	WB-403	WB-502
TILE	WALK-OFF MAT	UNCUSHIONED CARPET	CUSHIONED CARPET	CONCRETE (RESILIENT SIMILAR)	BOOTH

ACCENT PAINT LOCATION GUIDELINES:
REQUIRED AT: • WALLS WITH LETTERSETS
PREFERRED AT: SOFFITS WITH LETTERSETS BRAND FOCAL WALLS MERCH WALLS SO YOU CAN" FEATURE WALLS PAPER DOMINANT WALLS (EXCEPT BEHIND TELLER LINE) LOBBY FOCAL POINTS
NOTES: 1. PREFERENCE TO TERMINATE ACCENT PAINT AT INSIDE CORNERS 2. REFER TO FINISH SCHEDULE FOR ACCENT PAINT COLOR

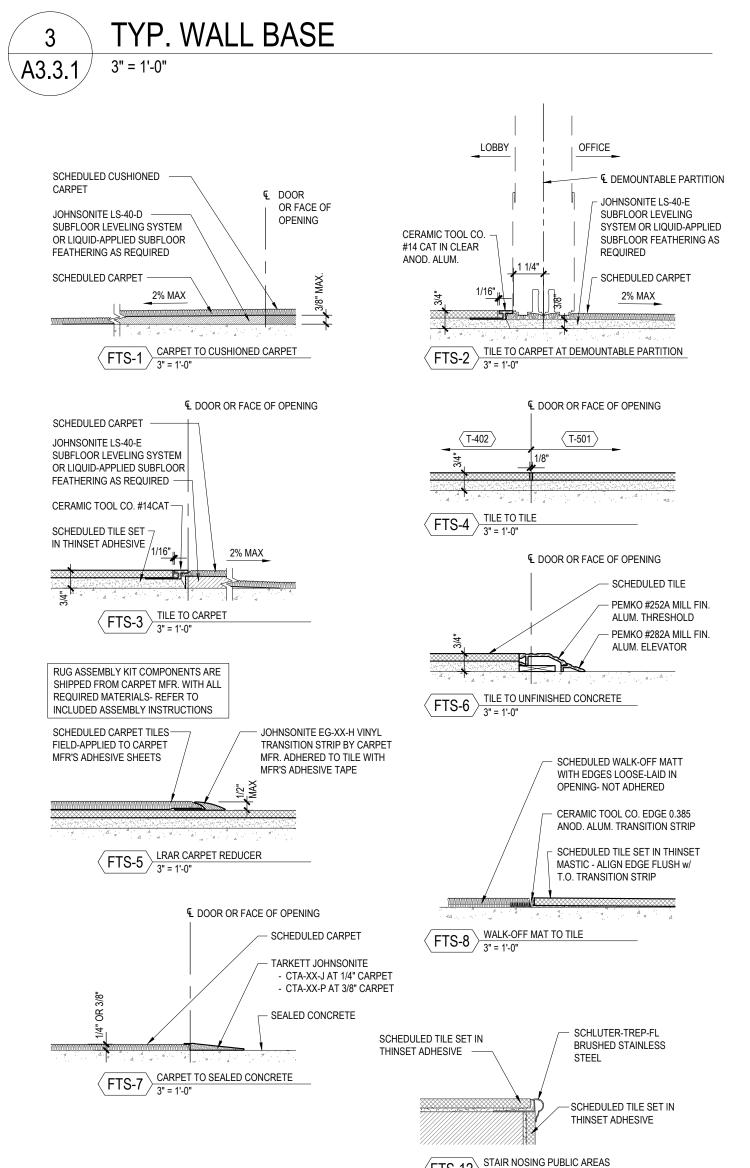

 SOFFITS WITH LETTERSETS BRAND FOCAL WALLS eMERCH WALLS "SO YOU CAN" FEATURE WALLS PAPER DOMINANT WALLS (EXCEPT BEHIND TELLER LINE) LOBBY FOCAL POINTS
NOTES: 1. PREFERENCE TO TERMINATE ACCENT PAINT AT INSIDE CORNERS 2. REFER TO FINISH SCHEDULE FOR ACCENT PAINT COLOR

- PARTITION SYSTEM DOOR FRAME — PARTITION SYSTEM BASE TRACK

BENTLEY PRINCE STREET	CHRIS CLARK	800-423-4709 x5844	Chris.Clark@bentleymills.com
BROOKSIDE VENEERS	KEVIN HALL	718-369-0526	kevinh@brooksideveneers.com
CARRIER	JOANNE HERTEL	315-432-7634	joanne.hertel@carrier.utc.com Strategic.Accounts1@carrier.utc.com
CBBE	KRISTI FRANKS	770-342-8272	Kfranks@cbbe.net
CERTAINTEED	LOCAL DISTRIBUTOR		
CORONADO STONE	DERRICK JOHNSON	909-561-8922	derrick@coronado.com
DAINTREE B.M.S. (CURRENT BY GE)	PETER MEGAN	603-247-3363	peter.megan@gecurrent.com
DESIGN TEX	JULIE BRINKWORTH	800-221-1540	jbrinkworth@designtex.com
DL COUCH	MEGAN CUDA	800-433-0790 x1113	mcuda@dlcouch.com
EMSER	AMBER SHOWALTER	323-650-2000	chase@emser.com
FSG	ISAIAH RAMDEEN	888-671-4074	jpmc@fsgi.com
GORDON, INC.	ERIC MAU	847-797-1010	eric@mauinc.com
HARVEY CEMENT PRODUCTS, INC.	ELLICE HERMAN CRAIG KIRK	708-833-1900 708-822-3907	
HINES, INC.	NATE HINES	870-233-7925 480-710-7474	nate@hinesinc.com
INTERFACE FLOR	JOE FOLEY	312-961-7046	joe.foley@interface.com
JOHNSONITE	LOCAL DISTRIBUTOR		
LLUMAR	SCOTT CURRY LISA BOAZ	888-257-5470	
LUMENOMICS, LLC	MARTI HOFFER	206-327-9037	chaseteam@lumenomics.com
MADICO	LOCAL DISTRIBUTOR		
MAPES ARCHITECTURAL CANOPIES	CHAD FREEBURGER	888-273-1132	cfreeberger@mapes.com
MATTHEWS PAINT	LOCAL DISTRIBUTOR		
NICHIHA FIBER CEMENT	ADAM COSSICK	770-570-0011	chase@nichiha.com
NEVAMAR	LOCAL DISTRIBUTOR		
CERTAINTEED WOOD CEILINGS & WALLS (FORMERLY NORTON INDUSTRIES, INC.)	DONALD TOMSIK	216-304-8403	donald.tomsik@saint-gobain.com
PHOTOVOLTAIC SYSTEM (FUTURE)	CHRIS ROGGE	913-458-8110	RoggeC@bv.com
PIONEER MILLWORKS	JERED SLUSSER	800-951-9663	jered@pioneermillworks.com
PIONITE	LOCAL DISTRIBUTOR		
PRINCIPLE USA	CHASE HEARING LOOP PROJECT MANAGER	865-692-4104	chasehearingloop@principleglobal.com
PULP STUDIOS	ALEX ROSUL	216-227-1801	arosul@sbcglobal.neet
QMI SECURITY SOLUTIONS	KEVIN BECERRA	800-446-2500	kbecerra@qmiusa.com
ROLL-A-SHADE	DEANNA MCCOY	951-245-5077	Deanna.McCoy@RollAShade.com
SBEMCO	MARK TUCCI	800-468-0860 x51	mtucci@mattingbydesign.com
SHERWIN-WILLIAMS	LOCAL DISTRIBUTOR		
STEELCASE (EMPIRE OFFICE)	MARIBETH CAREY	212-607-5568	mcarey@empireoffice.com
STONE SOURCE	DAVID SELTZER	212-979-6400	dseltzer@stonesource.com
TELLEREX	BRIAN LECHLITNER	888-395-0170	brian.lechlitner@tellerex.com
TELEPRESENCE (CHASE GTI)	TODD YORK	972-324-8100	todd.york@jpmorgan.com
USG	BLAKE PANNO	515-707-9179	bpanno@usg.com
	T .		

FLOORING TRANSITION FINISHES

PALETTE

ALL

ALL

ALL

VENDOR CONTACTS

708-344-1000

NOTE: CONFIRM CONTACT INFORMATION FOR APPROVED VENDORS WITH CHASE PROJECT MANAGER/COORDINATOR.

CONTACT

LOCAL DISTRIBUTOR

CHRIS CLARK

FINISH

BLACK

CLEAR ANODIZED ALUMINUM

CLEAR ANODIZED ALUMINUM

E-MAIL

800-423-4709 x5844 Chris.Clark@bentleymills.com

MATERIAL

NON-METALLIC TRANSITIONS

METALLIC TRANSITIONS

T-BAR

VENDOR / MFR.

ACME BRICK CO.

BENJAMIN MOORE

BENTLEY

G.C. TO OBTAIN THE MOST UP-TO-DATE PROJECT SPECIFIC VENDOR LIST FROM THE CHASE PROJECT MANAGER.

PAUL DECONINCK

BRODIE BRUNER

LOCAL DISTRIBUTOR

877-680-8361


972-926-2170

brodie.bruner@weathermatic.com

WASTE WISE PRODUCTS, INC

WEATHERMATIC

WILSONART

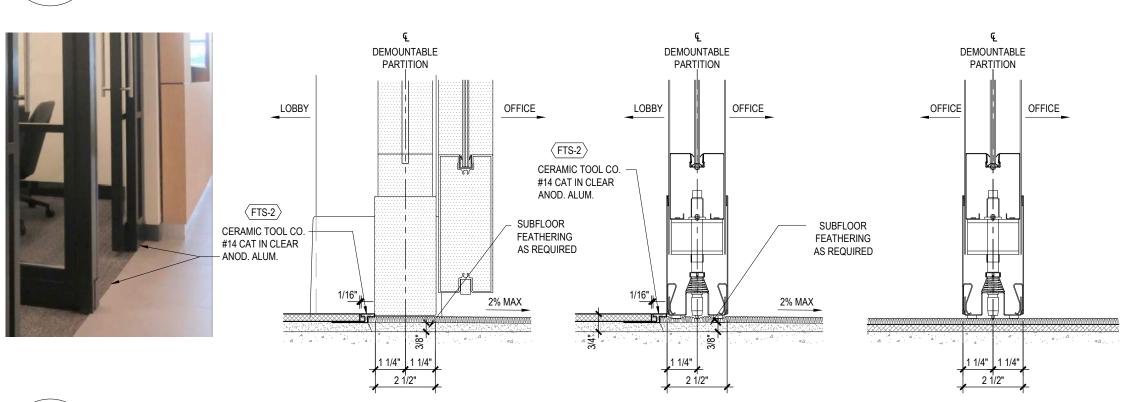

DEMOUNTABLE WALL FLOOR TRANSITIONS A3.3.1 3" = 1'-0"

FLOOR TRANSITION TYPES AND

STAIR BULLNOSE PROFILES

A3.3.1 3" = 1'-0"

NOTE: NOT ALL ITEMS MAY BE USED IN THIS PROJECT.

Suite 117 Watertown, MA 02472 617.576.0007 core-states.com

ARCHITECT OF RECORD

JAMES T. LALLI, AIA, ARCHITECT LICENSE NO. 32254 HESE DRAWINGS ARE NOT COMPLETE WITHOUT THE SEPARATE TYPE WRITTEN SPECIFICATIONS MANUAL WHICH ARE PART OF THE CONTRACT DOCUMENTS.

GROUP

ISSUE DATE DESCRIPTION 2022.07.15 PERMIT SET

PROJECT INFORMATION PROJECT NO: JPM.27118 2022.07.13 PROTOTYPE: K.KELLY DRAWN BY: M.SIDES CHECKED BY: SSE_1.00 VERSION:

> INTERIOR FINISH SCHEDULE FLOOR TRANSITION TYPES & FINISHES SCHEDULE VENDOR CONTACTS

SHEET NUMBER

SHEET TITLE

A3.3.1

<u> </u>	NT. FIN. MATE	RIALS SCHEDULE			
		PAINT			
PT-311	ACCENT PAINT - NAVY				
	MFR.	BENJAMIN MOORE			
	PRODUCT	AURA WATERBORNE INTERIOR PAINT			
	PRODUCT NUMBER	OLD NAVY #2063-10			
	FINISH	MATTE FINISH 522			
	NOTE	DARK PAINT TO RECEIVE LEVEL 5 FINISH			
	FIRE CLASSIFICATION	CLASS A			
	VOC LEVEL	ZERO VOC			
PT-500	GENERAL WALL / CEILING PAINT				
	MFR.	BENJAMIN MOORE			
	PRODUCT	AURA WATERBORNE INTERIOR PAINT			
	COLOR	CLOUD WHITE #CC-40			
	FINISH	EGGSHELL FINISH 524 (WALLS)			
		SATIN FINISH 526 (DOORS & FRAMES)			
	FIRE CLASSIFICATION	CLASS A			
	VOC LEVEL	ZERO VOC			
PT-501	ACCENT WALL PAINT- GREY				
	MFR.	BENJAMIN MOORE			
	PRODUCT	AURA WATERBORNE INTERIOR PAINT			
	COLOR	HEARTHSTONE #1601			
	FINISH	EGGSHELL FINISH 524 (WALLS)			
		SATIN FINISH 526 (DOORS & FRAMES)			
	FIRE CLASSIFICATION	CLASS A			
	VOC LEVEL	ZERO VOC			

CSG-PT-104	TYPICAL AV NICHE WALL PAINT			
	MFR.	BENJAMIN MOORE		
	PRODUCT	AURA WATERBORNE INTERIOR PAINT		
	COLOR	JET BLACK #2120-10		
	FINISH	FLAT FINISH		
	FIRE CLASSIFICATION	CLASS A		
	VOC LEVEL	ZERO VOC		

	AIAI	LL FINISHES			
WC-402		M WALL (WALLCOVERING 1)			
VVC-402					
	MFR.	MOMENTUM TEXTILES			
	PRODUCT	RECORE 'BACCARAT'			
	COLOR	BASALT #NA-4C-JPM501			
	WIDTH	54" ROLLED MATERIAL			
	FIRE CLASSIFICATION	CLASS A			
FRP-1	FIBERGLASS-REINFORG	T			
	MFR.	CRANE COMPOSITES			
	PRODUCT	GLASBORD PIF			
	FINISH	84 IVORY			
	LOCATIONS	JANITOR CLOSET / LADDER ROOM			
	FIRE CLASSIFICATION	CLASS C			
	WINDO	W TREATMENTS			
WT-1	MOTORIZED ROLLING S	HADE (5% OPENNESS FACTOR)			
	VENDOR / INSTALLER	LUMENOMICS			
	PRODUCT	SHEER WEAVE 2000			
	SHADE COLOR	WHITE PLATINUM P05			
	HOUSING	REFER TO INTERIOR FINISH SCHEDULE			
	NOTES	PRODUCT INSTALLED BY LUMENOMICS, REFER TO STANDARDS FOR GC COORDINATION WITH VENDOR			
WT-1 ALT	MOTORIZED ROLLING SHADE (5% OPENNESS FACTOR)				
	VENDOR / INSTALLER	ROLL-A-SHADE			
	PRODUCT	SHEER WEAVE 2000			
	SHADE COLOR	WHITE PLATINUM P05			
	HOUSING	REFER TO INTERIOR FINISH SCHEDULE			
	NOTES	PRODUCT INSTALLED BY ROLL-A-SHADE, REFER TO STANDARDS FOR GC COORDINATION WITH VENDOR			
WT-2	MOTORIZED ROLLING S	HADE (3% OPENNESS FACTOR)			
	VENDOR / INSTALLER	LUMENOMICS			
	PRODUCT	SHEER WEAVE 2410 P14			
	SHADE COLOR	PEARL GREY / OYSTER			
	HOUSING	REFER TO INTERIOR FINISH SCHEDULE			
	NOTES	PRODUCT INSTALLED BY LUMENOMICS, REFER TO STANDARDS FOR GC COORDINATION WITH VENDOR			
WT-2 ALT	MOTORIZED ROLLING S	HADE (3% OPENNESS FACTOR)			
	VENDOR / INSTALLER	ROLL-A-SHADE			
	PRODUCT	SHEER WEAVE 2410 P14			
	SHADE COLOR	PEARL GREY / OYSTER			
	HOUSING	REFER TO INTERIOR FINISH SCHEDULE			
	NOTES	PRODUCT INSTALLED BY ROLL-A-SHADE, REFER TO STANDARDS FOR GC COORDINATION WITH VENDOR			
WT-4	FROSTED WINDOW FILM				
	MFR.	LLUMAR			
	PRODUCT	NRM PS2			
	COLOR	FROSTED 69% TRANSMITTANCE			
	USES	AT CLOSED VESTIBULE GLAZING ADJACENTO BANKER CUBICLES			

WT-5	MANUAL ROLLING SHA	DE (5% OPENNESS FACTOR)
	VENDOR / INSTALLER	LUMENOMICS
	PRODUCT	SHEER WEAVE 2000
	SHADE COLOR	WHITE PLATINUM P05
	HOUSING	REFER TO INTERIOR FINISH SCHEDULE
WT-5 ALT	MANUAL ROLLING SHA	DE (5% OPENNESS FACTOR)
	VENDOR / INSTALLER	ROLL-A-SHADE
	PRODUCT	SHEER WEAVE 2000
	SHADE COLOR	WHITE PLATINUM P05
	HOUSING	REFER TO INTERIOR FINISH SCHEDULE
WT-6		DE (3% OPENNESS FACTOR)
	VENDOR / INSTALLER	LUMENOMICS
	PRODUCT	SHEER WEAVE 2410 P14
	SHADE COLOR HOUSING	PEARL GREY / OYSTER REFER TO INTERIOR FINISH SCHEDULE
WT-6 ALT		DE (3% OPENNESS FACTOR)
WI-0 ALI	VENDOR / INSTALLER	ROLL-A-SHADE
	PRODUCT	SHEER WEAVE 2410 P14
	SHADE COLOR	PEARL GREY / OYSTER
	HOUSING	REFER TO INTERIOR FINISH SCHEDULE
WT-7	DOUBLE-ROLLER SHAI	DE
	VENDOR / INSTALLER	LUMENOMICS
	PRODUCT	MBOR
	FRONT SHADE	MATCH TYPICAL FABRIC WITHIN BRANCH,
	DACK CHASE	WT-1 OR WT-2
	BACK SHADE	INDIANA COATED GRAY (OPAQUE)
	HOUSING	REFER TO INTERIOR FINISH SCHEDULE
	NOTES	PRODUCT INSTALLED BY LUMENOMICS, REFER TO STANDARDS FOR GC
	11070	COORDINATION WITH VENDOR
	USES	TYPICAL AT ALL CONFERENCE ROOM WINDOWS
WT-7 ALT	DOUBLE-ROLLER SHAI	
	VENDOR / INSTALLER	ROLL-A-SHADE
	PRODUCT	MBOR
	FRONT SHADE	MATCH TYPICAL FABRIC WITHIN BRANCH,
	DACK CHADE	WT-1 OR WT-2
	BACK SHADE HOUSING	INDIANA COATED GRAY (OPAQUE) REFER TO INTERIOR FINISH SCHEDULE
	NOTES	PRODUCT INSTALLED BY LUMENOMICS,
	NOTES	REFER TO STANDARDS FOR GC
	11050	COORDINATION WITH VENDOR
	USES	TYPICAL AT ALL CONFERENCE ROOM WINDOWS
WT-8	FIELD-APPLIED SPAND	REL FILM
	VENDOR / INSTALLER	3M
	PRODUCT	SCOTCHCAL GRAPHIC FILM
	COLOR	3630-51, SILVER
	FURNISHED BY	GENERAL CONTRACTOR
	USES	RETROFIT STOREFRONT GLAZING TO BLOVISIBILITY
	FIRE CLASSIFICATION	CLASS A
WT-20	MOTORIZED ROLLING	TELLER SCRIM (OPAQUE)
	VENDOR / INSTALLER	LUMENOMICS
	PRODUCT	MOBR INTERIOR SUN CONTROL FABRICS
	SHADE COLOR	PHIFER SHEAR WEAVE 7100 WHITE P-02
	ENCLOSURE COLOR	ANODIZED ALUMINUM - PAINT TO MATCH
	LINOLOGOINE GOLUK	ADJACENT FINISHES
	EXPOSED HEM BAR	ANODIZED ALUMINUM WITH GREY RUBBER
	NOTES	BOTTOM SEAL PRODUCT INSTALLED BY LUMENOMICS,
	15120	REFER TO STANDARDS FOR GC
WT 20 ALT	MOTODIZED DOLL WA	COORDINATION WITH VENDOR
WT-20 ALT		TELLER SCRIM (OPAQUE)
WT-20 ALT	VENDOR / INSTALLER	ROLL-A-SHADE
WT-20 ALT		TELLER SCRIM (OPAQUE)
WT-20 ALT	VENDOR / INSTALLER	ROLL-A-SHADE MOBR INTERIOR SUN CONTROL FABRICS
WT-20 ALT	VENDOR / INSTALLER PRODUCT	ROLL-A-SHADE MOBR INTERIOR SUN CONTROL FABRICS PHIFER SHEAR WEAVE 7100 WHITE P-02 ANODIZED ALUMINUM - PAINT TO MATCH
WT-20 ALT	VENDOR / INSTALLER PRODUCT SHADE COLOR ENCLOSURE COLOR	ROLL-A-SHADE MOBR INTERIOR SUN CONTROL FABRICS PHIFER SHEAR WEAVE 7100 WHITE P-02 ANODIZED ALUMINUM - PAINT TO MATCH ADJACENT FINISHES
WT-20 ALT	VENDOR / INSTALLER PRODUCT SHADE COLOR	ROLL-A-SHADE MOBR INTERIOR SUN CONTROL FABRICS PHIFER SHEAR WEAVE 7100 WHITE P-02 ANODIZED ALUMINUM - PAINT TO MATCH ADJACENT FINISHES
WT-20 ALT	VENDOR / INSTALLER PRODUCT SHADE COLOR ENCLOSURE COLOR	ROLL-A-SHADE MOBR INTERIOR SUN CONTROL FABRICS PHIFER SHEAR WEAVE 7100 WHITE P-02 ANODIZED ALUMINUM - PAINT TO MATCH ADJACENT FINISHES ANODIZED ALUMINUM WITH GREY RUBBER BOTTOM SEAL PRODUCT INSTALLED BY ROLL-A-SHADE,
WT-20 ALT	VENDOR / INSTALLER PRODUCT SHADE COLOR ENCLOSURE COLOR EXPOSED HEM BAR	ROLL-A-SHADE MOBR INTERIOR SUN CONTROL FABRICS PHIFER SHEAR WEAVE 7100 WHITE P-02 ANODIZED ALUMINUM - PAINT TO MATCH ADJACENT FINISHES ANODIZED ALUMINUM WITH GREY RUBBER BOTTOM SEAL
WT-20 ALT	VENDOR / INSTALLER PRODUCT SHADE COLOR ENCLOSURE COLOR EXPOSED HEM BAR NOTES	ROLL-A-SHADE MOBR INTERIOR SUN CONTROL FABRICS PHIFER SHEAR WEAVE 7100 WHITE P-02 ANODIZED ALUMINUM - PAINT TO MATCH ADJACENT FINISHES ANODIZED ALUMINUM WITH GREY RUBBER BOTTOM SEAL PRODUCT INSTALLED BY ROLL-A-SHADE, REFER TO STANDARDS FOR GC
	VENDOR / INSTALLER PRODUCT SHADE COLOR ENCLOSURE COLOR EXPOSED HEM BAR NOTES	ROLL-A-SHADE MOBR INTERIOR SUN CONTROL FABRICS PHIFER SHEAR WEAVE 7100 WHITE P-02 ANODIZED ALUMINUM - PAINT TO MATCH ADJACENT FINISHES ANODIZED ALUMINUM WITH GREY RUBBER BOTTOM SEAL PRODUCT INSTALLED BY ROLL-A-SHADE, REFER TO STANDARDS FOR GC COORDINATION WITH VENDOR
	VENDOR / INSTALLER PRODUCT SHADE COLOR ENCLOSURE COLOR EXPOSED HEM BAR NOTES SPANDREL GLAZING (S	ROLL-A-SHADE MOBR INTERIOR SUN CONTROL FABRICS PHIFER SHEAR WEAVE 7100 WHITE P-02 ANODIZED ALUMINUM - PAINT TO MATCH ADJACENT FINISHES ANODIZED ALUMINUM WITH GREY RUBBER BOTTOM SEAL PRODUCT INSTALLED BY ROLL-A-SHADE, REFER TO STANDARDS FOR GC COORDINATION WITH VENDOR SPECIAL- CASE USE ONLY)
	VENDOR / INSTALLER PRODUCT SHADE COLOR ENCLOSURE COLOR EXPOSED HEM BAR NOTES SPANDREL GLAZING (SMFR.	ROLL-A-SHADE MOBR INTERIOR SUN CONTROL FABRICS PHIFER SHEAR WEAVE 7100 WHITE P-02 ANODIZED ALUMINUM - PAINT TO MATCH ADJACENT FINISHES ANODIZED ALUMINUM WITH GREY RUBBER BOTTOM SEAL PRODUCT INSTALLED BY ROLL-A-SHADE, REFER TO STANDARDS FOR GC COORDINATION WITH VENDOR SPECIAL- CASE USE ONLY) VIRACON
	VENDOR / INSTALLER PRODUCT SHADE COLOR ENCLOSURE COLOR EXPOSED HEM BAR NOTES SPANDREL GLAZING (SMFR. PRODUCT	ROLL-A-SHADE MOBR INTERIOR SUN CONTROL FABRICS PHIFER SHEAR WEAVE 7100 WHITE P-02 ANODIZED ALUMINUM - PAINT TO MATCH ADJACENT FINISHES ANODIZED ALUMINUM WITH GREY RUBBEF BOTTOM SEAL PRODUCT INSTALLED BY ROLL-A-SHADE, REFER TO STANDARDS FOR GC COORDINATION WITH VENDOR SPECIAL- CASE USE ONLY) VIRACON
	VENDOR / INSTALLER PRODUCT SHADE COLOR ENCLOSURE COLOR EXPOSED HEM BAR NOTES SPANDREL GLAZING (SMFR. PRODUCT COLOR	ROLL-A-SHADE MOBR INTERIOR SUN CONTROL FABRICS PHIFER SHEAR WEAVE 7100 WHITE P-02 ANODIZED ALUMINUM - PAINT TO MATCH ADJACENT FINISHES ANODIZED ALUMINUM WITH GREY RUBBER BOTTOM SEAL PRODUCT INSTALLED BY ROLL-A-SHADE, REFER TO STANDARDS FOR GC COORDINATION WITH VENDOR SPECIAL- CASE USE ONLY) VIRACON VIRAPSAN MEDIUM GRAY
	VENDOR / INSTALLER PRODUCT SHADE COLOR ENCLOSURE COLOR EXPOSED HEM BAR NOTES SPANDREL GLAZING (SMFR. PRODUCT COLOR	ROLL-A-SHADE MOBR INTERIOR SUN CONTROL FABRICS PHIFER SHEAR WEAVE 7100 WHITE P-02 ANODIZED ALUMINUM - PAINT TO MATCH ADJACENT FINISHES ANODIZED ALUMINUM WITH GREY RUBBER BOTTOM SEAL PRODUCT INSTALLED BY ROLL-A-SHADE, REFER TO STANDARDS FOR GC COORDINATION WITH VENDOR SPECIAL- CASE USE ONLY) VIRACON VIRAPSAN MEDIUM GRAY LEAD FREE OPTION FOR FIELD APPLIED TREATMENT
WT-11	VENDOR / INSTALLER PRODUCT SHADE COLOR ENCLOSURE COLOR EXPOSED HEM BAR NOTES SPANDREL GLAZING (SMFR. PRODUCT COLOR NOTES	ROLL-A-SHADE MOBR INTERIOR SUN CONTROL FABRICS PHIFER SHEAR WEAVE 7100 WHITE P-02 ANODIZED ALUMINUM - PAINT TO MATCH ADJACENT FINISHES ANODIZED ALUMINUM WITH GREY RUBBEF BOTTOM SEAL PRODUCT INSTALLED BY ROLL-A-SHADE, REFER TO STANDARDS FOR GC COORDINATION WITH VENDOR SPECIAL- CASE USE ONLY) VIRACON VIRAPSAN MEDIUM GRAY LEAD FREE OPTION FOR FIELD APPLIED TREATMENT
WT-11	VENDOR / INSTALLER PRODUCT SHADE COLOR ENCLOSURE COLOR EXPOSED HEM BAR NOTES SPANDREL GLAZING (SMFR. PRODUCT COLOR NOTES DISTRACTION BANDING	ROLL-A-SHADE MOBR INTERIOR SUN CONTROL FABRICS PHIFER SHEAR WEAVE 7100 WHITE P-02 ANODIZED ALUMINUM - PAINT TO MATCH ADJACENT FINISHES ANODIZED ALUMINUM WITH GREY RUBBEF BOTTOM SEAL PRODUCT INSTALLED BY ROLL-A-SHADE, REFER TO STANDARDS FOR GC COORDINATION WITH VENDOR SPECIAL- CASE USE ONLY) VIRACON VIRAPSAN MEDIUM GRAY LEAD FREE OPTION FOR FIELD APPLIED TREATMENT
WT-11	VENDOR / INSTALLER PRODUCT SHADE COLOR ENCLOSURE COLOR EXPOSED HEM BAR NOTES SPANDREL GLAZING (SMFR. PRODUCT COLOR NOTES DISTRACTION BANDING MFR.	ROLL-A-SHADE MOBR INTERIOR SUN CONTROL FABRICS PHIFER SHEAR WEAVE 7100 WHITE P-02 ANODIZED ALUMINUM - PAINT TO MATCH ADJACENT FINISHES ANODIZED ALUMINUM WITH GREY RUBBER BOTTOM SEAL PRODUCT INSTALLED BY ROLL-A-SHADE, REFER TO STANDARDS FOR GC COORDINATION WITH VENDOR SPECIAL- CASE USE ONLY) VIRACON VIRAPSAN MEDIUM GRAY LEAD FREE OPTION FOR FIELD APPLIED TREATMENT G DESIGNTEX

STOREFRONT - INSTALLED 30" AFF (44" TALL

		TRIM				
WB-402	VINYL WALL BASE- ST	TRAIGHT- AREAS WITH FLOORING				
	MFR.	JOHNSONITE				
	PRODUCT	TIGHTLOCK				
	COLOR	20 CHARCOAL WG				
	PROFILE	4 1/2" STRAIGHT (TOELESS)				
WB-403	VINYL WALL BASE- CO	OVE- AREAS WITH EXPOSED SLAB				
	MFR.	JOHNSONITE				
	PRODUCT	TRADITIONAL WALL BASE				
	COLOR	20 CHARCOAL WG				
	PROFILE	4" COVE				
WB-502	WALL BASE - AT BOO	TH ONLY				
	MFR.	PIONEER MILLWORKS				
	PRODUCT/COLOR	MODERN FARMHOUSE- CLEAN ASH				
	PROFILE	4 1/4" X 5/8"				
	NOTES	MATCHING 5/8" PERIMETER TRIM IN WIDTHS PER ELEVATIONS TO BE ORDERED THROUGH PIONEER MILLWORKS. SEE NOTE 1.				

	MILLWO	RK SURFACES
SS-300	SOLID SURFACE MATERI	AL
	DESCRIPTION	1/2" ACRYLIC SOLID SURFACE WITH EASED EDGES
	MFR.	DUPONT CORIAN
	COLOR	SILVER BIRCH
	USES	WINDOW SILLS & MILLWORK SURFACES

PLASTIC LAMINATE

NATURAL RECON 7996-38

PL-502 MILLWORK LAMINATE

COLOR

NOTES

	USES	MILLWORK, CHECK DESK
PL-503	MILLWORK LAMINATE	
	DESCRIPTION	PLASTIC LAMINATE
	MFR.	WILSONART
	COLOR	LECHE VISTA 4987K-07
	USES	BOH MILLWORK COUNTER SURFACE
WD-502	WOOD ACCENT	
	DESCRIPTION	ENGINEERED PLANK, RAKED PROFILE
	MFR.	PIONEER MILLWORKS
	PRODUCT	MODERN FARMHOUSE- CLEAN ASH
	SIZE	5 1/2" X 5/8", FCS MIX
	TEXTURE	RAKED
	FINISH	CLEAR, POLY CLASS A FIRE RETARDANT
	USES	BOOTH MILLWORK
	NOTES	MATCHING 5/8" PERIMETER TRIM IN WIDTHS PER ELEVATIONS, AND BOOTH BASE (WB-502) TO BE ORDERED THROUGH PIONEER MILLWORKS
WD-601	VENEER PANELS	
	MFR.	BROOKSIDE VENEERS
	PRODUCT	10.84 UNFINISHED
	SPECIES	PLANKED SLAVONY OAK
	FINISH	CLEAR MATTE UV INHIBITOR, LOW VOC FLAT ACRYLIC POLYURETHANE (FIELD APPLIED)
	INSTALLER	G.C.
	USES	ARCHITECTURAL WALL MILLWORK

APPLIED TO FEATURE DIGITAL WALL

REFER TO FINISH PLAN AND ELEVATIONS

		CARPET
CPT-302	WALK-OFF MAT	
	MFR.	SBEMCO / MATTING BY DESIGN
	PRODUCT	ULTRA DRY PCR PET
	COLOR	PUMICE #620
	SIZE	PER PLAN
	BACKING	THERMAL BONDED, BLOWN PVC, ANTI-MICROBIAL PINK
	NOTES	LOOSE-LAID/NOT ADHERED
		RIB DIRECTION TO RUN PARALLEL TO ENTRY DOOR
	FIRE CLASSIFICATION	CLASS 1
CPT-320	GENERAL CARPET	
	MFR.	INTERFACE
	PRODUCT	HARMONIZE
	COLOR	GRAVEL 104043
	SIZE	25CM X 1M TILE (9.84" x 39.37")
	BACKING	GLASBAC
	PATTERN	ASHLAR
	FIRE CLASSIFICATION	CLASS 1
CPT-321	MANUAL TRANSACTION	AREA CARPET
	MFR.	INTERFACE
	PRODUCT	HARMONIZE
	COLOR	GRAVEL 104043
	SIZE	25CM X 1M TILE (9.84" x 39.37")
	BACKING	CUSHIONBAC PLUS (ANTI-FATIGUE CUSHION
	PATTERN	ASHLAR
	FIRE CLASSIFICATION	CLASS 1
	Α	REA RUGS
LRAR -4	FLOATING CARPET- NA	VY
	MFR.	INTERFACE
	PRODUCT	HAPTIC
	COLOR	INDIGO
	SIZE	PER PLAN
	BACKING	GLASBAC
	EDGING	MFR.: JOHNSONITE PRODUCT # EG-XX-H COLOR: 40 BLACK B
	NOTES	EDGE BANDING/RUG KIT PROVIDED BY MANUFACTURER
	LEIDE OF AGOIETO ATTOM	01.400.4

FIRE CLASSIFICATION | CLASS 1

T-402 RESTROOM WALL & FLOOR TILE/ LOUNGE

PRODUCT COLOR

SIZE

GROUT JOINT

GENERAL FLOOR TILE

NOTES

PRODUCT

COLOR

FINISH

GROUT

GROUT JOINT

SC CONCRETE FLOOR PAINT

FIRE CLASSIFICATION | CLASS A

FIRE CLASSIFICATION CLASS 1

PRODUCT

COLOR

VCT-1 VINYL COMPOSITION TILE

DESCRIPTION

COLOR

ET-501 EXTERIOR FLOOR TILE

COLLECTION

COLOR

FINISH

SIZE

GROUT

GROUT JOINT

SIZE

T-501

TILE

DORIAN

STONE SOURCE

NATURAL FINISH

"NATURAL GREY"

LATICRETE PERMACOLOR SELECT GROUT #24

MATCHING TILE WALL BASE AVAILABLE FOR

LATICRETE PERMACOLOR SELECT GROUT #24

TREAD-PLEX 100% ACRYLIC WATER BASED

ARMSTRONG FLOORING - EXCELON SDT

DATA ROOM FLOOR (WHERE NOTED)

LATICRETE WATERPROOFING SYSTEM

GROUT #24 "NATURAL GREY"

12" x 24" x 3/8"

RESTROOMS

STONE SOURCE

NATURAL FINISH

30" X 30" x 3/8"

"NATURAL GREY"

SHERWIN WILLIAMS

SEMI-GLOSS, SLIP-RESISTANT

FLOOR COATING

PLASTIC LAMINATE

ARMOR GRAY #51951

STONE SOURCE

CINDER - PLAIN

NATURAL FINISH

30" X 30" x 3/8"

EXTERIOR TILE

ARENA

DECK GRAY

CREOS

DORIAN

T 1/8"

MISCELLANEOUS FLOORING

ACT-2	ACOUSTICAL CEILING (I	NON-CUSTOMER AREAS)
	MFR.	USG
	PRODUCT	MARS CLIMAPLUS HIGH-NRC (ITEM NO. 871
	COLOR	WHITE
	SIZE	24"x24"x7/8"
	EDGE	9/16" FINELINE BEVEL (FLB)
	GRID	CENTRICITEE DXT 9/16" EXPOSED TEE SYSTEM
		E USG Centricitee™ DXT™
	GRID FINISH	FLAT WHITE
	FIRE CLASSIFICATION	CLASS A
ACT-4	ACOUSTICAL CEILING (CUSTOMER AREAS)
	MFR.	USG
	PRODUCT	MARS HIGH-NRC LOGIX CLIMAPLUS PERFORMANCE FIELD AND CHANNEL PANE
	COLOR	WHITE
	SIZE	48" x 48" x 1" FIELD PANELS (#80281) AND 4"x48"x1" CHANNEL PANELS (#80268)
	EDGE	9/16" FINELINE BEVEL (FLB)
	GRID	IDENTITEE DXI 9/16" TEE SYSTEM WITH 9/10 STANDARD PERIMETER MOLDING PROFILE EDGE DETAIL
		19/16" 113/16" USG Donn* Brand Fineline* Bevel
	GRID FINISH	FLAT WHITE
	FIRE CLASSIFICATION	CLASS A
IOTES		
1	INTUMESCENT FLAME R BY UNIVERSAL FIRE SHI	ETARDANT: FIREKOTE 100 AS MANUFACTURE ELD, CLEAR FINISH

REGIONAL	WINDOW SHAD	E FABRICS
NORTHEAST REGION	3% OPENNESS FACTOR	5% OPENNESS FACTO
DNNECTICUT		Х
AINE		Х

CONNECTICUT X MAINE X MASSACHUSETTES X NEW HAMPSHIRE X NEW JERSEY X NEW YORK X PENNSYLVANIA X RHODE ISLAND X VERMONT X	NORTHEAST REGION	3% OPENNESS FACTOR	5% OPENNESS FACTOR
MASSACHUSETTES X NEW HAMPSHIRE X NEW JERSEY X NEW YORK X PENNSYLVANIA X RHODE ISLAND X	CONNECTICUT		Х
NEW HAMPSHIRE X NEW JERSEY X NEW YORK X PENNSYLVANIA X RHODE ISLAND X	MAINE		X
NEW JERSEY X NEW YORK X PENNSYLVANIA X RHODE ISLAND X	MASSACHUSETTES		X
NEW YORK X PENNSYLVANIA X RHODE ISLAND X	NEW HAMPSHIRE		X
PENNSYLVANIA X RHODE ISLAND X	NEW JERSEY		X
RHODE ISLAND X	NEW YORK		X
	PENNSYLVANIA		X
VERMONT X	RHODE ISLAND		X
	VERMONT		X

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ARCHITECT OF RECORD

THESE DRAWINGS ARE NOT COMPLETE WITHOUT THE SEPARATE TYPE WRITTEN SPECIFICATIONS MANUAL WHICH ARE PART OF THE CONTRACT DOCUMENTS.

JAMES T. LALLI, AIA, ARCHITECT

LICENSE NO. 32254

GROUP

- 2022.07.15 PERMIT SET

PROJECT INFORMATION
PROJECT NO:

PROJECT NO: JPM.27118

DATE: 2022.07.15

PROTOTYPE: 20.3

DRAWN BY: K.KELLY

CHECKED BY: M.SIDES

VERSION: SSE_1.00

SHEET TITLE

INTERIOR FINISH MATERIAL REGIONAL WINDOW SHADE FABRICS

SHEET NUMBER

A3.3.2

				FURNITU	RE SCHEDUL	E								
								FUI	RNISHI	ED BY	Y	IN	STALL	LED B
GROUP	OGL TAG	DESCRIPTION	VENDOR	VENDOR#	MANUFACTURER	MODEL	FINISH	OWNER) (GC::::::::::::::::::::::::::::::::::::	EQUIP. VENDOR	FURN. VENDOR	OWNER	99	EQUIP. VENDOR
	2AF	30" 2-DRAWER LATERAL FILE	EMPIRE	2A1	STEELCASE	900 SERIES	MF-1		\pm	$\frac{+}{-}$				
	2AP	15" PEDESTAL BBF	EMPIRE	2A1	STEELCASE	900 SERIES	MF-1			_	-			\rightarrow
	2AW	30" 2-DRAWER LATERAL FILE W/ WOOD TOP	EMPIRE	2A1W	STEELCASE	901 SERIES	OAK COMPOSITE		_	+	•			\rightarrow
	2BF 2BP	36" 2-DRAWER LATERAL FILE	EMPIRE	2B1	STEELCASE	900 SERIES	MF-1		+	+	•			\rightarrow
	2BP 2BW	15" PEDESTAL BBF 36" 2-DRAWER LATERAL FILE W/ WOOD TOP	EMPIRE EMPIRE	2B1 2B1W	STEELCASE STEELCASE	900 SERIES 901 SERIES	MF-1 OAK COMPOSITE		+	-	-			
	2CF	42" 2-DRAWER LATERAL FILE W/ WOOD TOP	EMPIRE	2BTVV 2C1	STEELCASE	901 SERIES 900 SERIES	MF-1		_	+				
FILES	2CP	15" PEDESTAL BBF	EMPIRE	2C1	STEELCASE	900 SERIES	MF-1		_	-	-			
	2CW	42" 2-DRAWER LATERAL FILE W/ WOOD TOP	EMPIRE	2C1W	STEELCASE	901 SERIES	OAK COMPOSITE			+	_			
	3A	30" 3-DRAWER LATERAL FILE	EMPIRE	3A1	STEELCASE	900 SERIES	MF-1		+	+	•			
	3B	36" 3-DRAWER LATERAL FILE	EMPIRE	3B1	STEELCASE	900 SERIES	MF-1		+	+	•			
	3C	42" 3-DRAWER LATERAL FILE	EMPIRE	3C1	STEELCASE	900 SERIES	MF-1		+	+	•			
	5A	30" 5-DRAWER LATERAL FILE	EMPIRE	5A1	STEELCASE	900 SERIES	MF-1				•			
	5B	36" 5-DRAWER LATERAL FILE	EMPIRE	5B1	STEELCASE	900 SERIES	MF-1				•			
	5C	42" 5-DRAWER LATERAL FILE	EMPIRE	5C1	STEELCASE	900 SERIES	MF-1				•			
	LC	5-TIER LOCKERS (15"D x 15"W x 72"H)	EMPIRE	FLC-11	PENCO		028 GRAY		•				•	
	BT4-A	LOUNGE TABLE, 36" DIA.	EMPIRE	FT-14	STEELCASE	853600	ARCTIC WHITE				-			
LOUNGE	BT4-B	LOUNGE TABLE, 48" DIA.	EMPIRE	FT-14 48	STEELCASE	853600	ARCTIC WHITE				•			
LOUNGE	BT4-C	LOUNGE TABLE, 60x35	EMPIRE	FT-14 60X35	STEELCASE	853600	ARCTIC WHITE				•			
	BS	LOUNGE CHAIR	EMPIRE	FS-14	TURNSTONE	TS37101	BLACK			\perp	•			
		TALL KITCHEN TRASH RECEPTACLE	CHASE BP GROUP					•				•		
		WIRE SHELVING - HANG TRACK			CLOSETMAID	282400, 282600, 283600 280000, 280100,	WHITE		-	_			•	
JANITOR'S CLOSET / GENERAL STORAGE		WIRE SHELVING - STANDARD			CLOSETMAID	280800, 281200, 280400	WHITE		•				•	
	WS-1	WIRE SHELVING - 12" SHELF ("SUPERSLIDE")			CLOSETMAID	471400, 471700, 471800, 471900	WHITE		-	\perp			•	
		WIRE SHELVING - 12" BRACKET			CLOSETMAID	5285300	WHITE		•	_			•	
		WIRE SHELVING - 16" SHELF ("CLOSE MESH")			CLOSETMAID	139500, 3731800	WHITE		-	+			•	
	07.004	WIRE SHELVING - 16" BRACKET			CLOSETMAID	5285400	WHITE		•	+			•	
	OT-20A OT-20B	KIMBERLY TABLE- 36"DIA X 21"H KIMBERLY TABLE- 30"DIA X 18"H	EMPIRE EMPIRE		STEELCASE STEELCASE	CUSTOM	PLANKED OAK PLANKED OAK		+	+	_			
	OT-20B	KIMBERLY TABLE- 25"DIA X 15"H	EMPIRE		STEELCASE	CUSTOM	PLANKED OAK		_	+	-			
	OT-20D	KIMBERLY TABLE- 20"DIA X 18"H	EMPIRE		STEELCASE	CUSTOM	PLANKED OAK		+	+	-			_
	OT-21	GINGKO WIRE CAFÉ TABLE- 30" DIA	EMPIRE		DAVIS	GINGKO	PLANKED OAK TOP, BLACK BASE		_	+	_			
	CH-322	ALWAYS LOUNGE CHAIR	EMPIRE		NAUGHTONE	ALWAYS	GEIGER: IOTA- NAVY, BLACK BASE		+	+				_
	CH-323	STYLEX SHARE SOFA- CURVED	EMPIRE		STYLEX	SHARE	DESIGNTEX: WOOLISH- OSPREY, BLACK		+					
IG ROOM/ LOBBY	CH-324	STYLEX SHARE SOFA- CURVED 1/2 UPHOLSTERED, 1/2 VINYL	EMPIRE		STYLEX	SHARE	MATTE LEGS BLACK METAL SLED FRAME, BACK OF SOFA UPHOLSTERY: DESIGNTEX: BARKCLOTH-CHARCOAL, SEAT OF SOFA UPHOLSTERY: DESIGNTEX: SORANO-KEYSTONE		<u>+</u>		•			
	CH-325	DRT CHAIR - ALWAYS CHAIR	EMPIRE		NAUGHTONE	ALWAYS	DESIGNTEX: EVERYWHERE TEXTURE- STORM				•			
	PF	WHIMSY POUF	EMPIRE		NATIONAL	WHIMSY	BLACK STRAP HANDLE, UPHOLSTERY: DESIGNTEX: SPANDAU-COGNAC				•			
	FS-3	STOOL-CAFÉ HEIGHT	EMPIRE		GORDON	FORMULA	BLACK MATTE FRAME, UPHOLSTERY: DESIGNTEX: HYDE STONE				-			
	TP	TELEPRESENCE SIDE TABLE- LIVING ROOM	GTI		SALAMANDER	CUSTOM	NATURAL OAK-NOT TEXTURED		+	•				_
	DRT	DINING ROOM TABLE (4 OR 6 PERSON)	CBBE	34X72	CBBE	CUSTOM	STAIN TO MATCH: OAK		+					
	CR-2 3619	COFFEE CREDENZA, 36x19	EMPIRE	34X96 36X19	STEELCASE	TBD	OAK, SILVER BIRCH CORIAN		_	+	_			_
	CR-2 4819	COFFEE CREDENZA, 48x19	EMPIRE	48X19	STEELCASE	TBD	OAK, SILVER BIRCH CORIAN		_	-	-			_
	CR-2 6019	COFFEE CREDENZA, 60x19	EMPIRE	60X19	STEELCASE	TBD	OAK, SILVER BIRCH CORIAN		_	-	-			_
	CT	CAFÉ TABLE- HIGH TOP	EMPIRE	30D, 36D	COALESSE	MONTARA	WHITE TOP, BLACK BASE		+	_	_			_
	WT	WORK TABLE- DESK HEIGHT	EMPIRE	36D	COALESSE	MONTARA	WHITE TOP, BLACK BASE		+	+	•			_
MISC.	BT-2	BOOTH TABLE WITH POWER MODULE	EMPIRE	57X30, 57X36, 57X42, 57X48	COALESSE	LAGUNITAS	WHITE TOP, BLACK BASE				•			
	BB-1	BOOTH BENCH (QTY- 2 BENCHES)	CBBE		CBBE	CUSTOM	BACK OF BOOTH UPHOLSTERY: DESIGNTEX- WOOLISH: OSPREY, BOOTH SEAT UPHOLSTERY: DESIGNTEX: SORANO- KEYSTONE, BLACK FEET BACK OF BOOTH UPHOLSTERY:		<u> </u>		•			
	BB-2	DROP IN BOOTH	EMPIRE	40V00 00V00	NATIONAL	FRINGE	DESIGNTEX- WOOLISH: OSPREY, BOOTH SEAT UPHOLSTERY: DESIGNTEX: SORANO- KEYSTONE, BLACK FEET				•			
	TD	TRAINING CHAIR	EMPIRE	48X30, 60X30, 72X30	COALESSE	AKIRA	ARCTIC WHITE SURFACE, BLACK BASE/CASTERS BLACK SHELL/SEAT, BLACK				-			
	TC	TRAINING CHAIR	EMPIRE		COALESSE	KART	BASE/CASTERS, NESTING			\perp	•			
	MST-3	MANUAL TRANSACTION MODULE - MST	EMPIRE	TC 1M	STEELCASE	CUSTOM	QUARTER CUT OAK COMPOSITE		\perp	\perp	•			
MANUAL	AST-3	MANUAL TRANSACTION MODULE - LEFT AST	EMPIRE	TC 1AL	STEELCASE	CUSTOM	QUARTER CUT OAK COMPOSITE		\perp		=			
	AST-3	MANUAL TRANSACTION MODULE - RIGHT AST	EMPIRE	TC 1A	STEELCASE	CUSTOM	QUARTER CUT OAK COMPOSITE				•			
RANSACTIONS	701-0		+					 	-+	-		-		

CBBE

ACR1

CLEAR

ACRYLIC RISER (1 PER AST)

CBBE

ACR1

ACR1

	D-401D	CONF. TABLE WITH X BASE (72X36)	EMPIRE	72X36	STEELCASE/GORDON		QUARTER CUT OAK COMPOSITE, BLACK 'X' BASE	•	•
	D-401E	CONF. TABLE WITH X BASE(84X36)	EMPIRE	84X36	STEELCASE/GORDON		QUARTER CUT OAK COMPOSITE, BLACK 'X' BASE	•	•
CONFERENCE	D-401F	CONF. TABLE WITH X BASE (96X48)	EMPIRE	96X48	STEELCASE/GORDON		QUARTER CUT OAK COMPOSITE, BLACK 'X' BASE	•	•
	CC5	CONF CREDENZA W/ WOOD TOP	EMPIRE	CCREDDW	STEELCASE		QUARTER CUT OAK COMPOSITE	-	•
	CC6	CONF CREDENZA W/ CORIAN TOP	EMPIRE	CCREDPWC/CCREDDW	C STEELCASE		QUARTER CUT OAK COMPOSITE, SILVER BIRCH CORIAN	•	•
	D-400A / DB-400	BANKER DESK, WOOD TOP, X BASE, (36R)	EMPIRE	36DIA	STEELCASE		QUARTER CUT OAK COMPOSITE, BLACK HARDWARE	•	•
	D-401A / DB-400	BANKER DESK, WOOD TOP, X BASE, (42R)	EMPIRE	42DIA	STEELCASE		QUARTER CUT OAK COMPOSITE, BLACK HARDWARE	•	•
	D-401B / DB-400	BANKER DESK, OVAL, WOOD TOP, X BASE, (54X36)	EMPIRE	54X36	STEELCASE		QUARTER CUT OAK COMPOSITE, BLACK HARDWARE	•	•
	D-401 C/ DB-400	BANKER DESK, OVAL, WOOD TOP, X BASE, (60x36)	EMPIRE	60X36	STEELCASE		QUARTER CUT OAK COMPOSITE, BLACK HARDWARE	•	•
PRIVATE CONSULTATION	HAD-2	OLOGY HEIGHT ADJUSTABLE DESK	EMPIRE		STEELCASE	OLOGY	QUARTER CUT OAK COMPOSITE TOP, BLACK ADJUSTABLE BASE	•	•
SPACE	WPD-6A	BANKER DESK PEDESTAL FILE- 18"	EMPIRE		STEELCASE	CUSTOM	QUARTER CUT OAK COMPOSITE, BLACK HARDWARE	•	•
	WPD-6B	BANKER DESK PEDESTAL FILE- 30"	EMPIRE		STEELCASE	CUSTOM	QUARTER CUT OAK COMPOSITE, BLACK HARDWARE	•	•
	WPD-7A	LATERAL FILE WITH CPU CABINET- MEDIUM OFFICE- 54"	EMPIRE		STEELCASE	CUSTOM	QUARTER CUT OAK COMPOSITE, BLACK HARDWARE	•	•
	WPD-7B	LATERAL FILE WITH CPU CABINET- MEDIUM OFFICE- 48"	EMPIRE		STEELCASE	CUSTOM	QUARTER CUT OAK COMPOSITE, BLACK HARDWARE	•	•
	WPD-8	IWS TALL PEDESTAL FILE	EMPIRE		STEELCASE	CUSTOM	QUARTER CUT OAK COMPOSITE, BLACK HARDWARE	•	•
DESK, CONFERENCE	DS	BANKER DESK AND LAO CHAIR	EMPIRE	FS-11T	STEELCASE	THINK	BLACK, NON-NESTING, ADJUSTABLE ARMS	•	•
AND GUEST CHAIRS	CH-311	BINDU CONFERENCE CHAIR- LOW BACK ON CASTERS	EMPIRE		COALESSE	BINDU	DESIGNTEX: BARK CLOTH-DARK CHARCOAL, BLACK BASE ON CASTERS	•	-
	CS-3	SDB CARREL / VIEWING ROOM	EMPIRE	TRADCARREL-C	STEELCASE	CARREL	QUARTER CUT OAK COMPOSITE	•	-
SDB	CH-320	SDB ARMLESS CHAIR	EMPIRE		STEELCASE	FORMULA	DESIGNTEX: BARKCLOTH-DARK CHARCOAL, BLACK SLED BASE	•	•

			F	NUDIO	/ VIDE	O EQUI	PMENT SCH	EDULE
			FU	JRNISHED E		IN	NSTALLED BY	
DESCRIPTION	MFR.	PRODUCT	OWNER	GC	EQUIP VENDOR	OWNER	GC VENDOR	NOTES
.UTION #1: SCALA SIGNAGE			I I			1		
55" LED DISPLAY	SAMSUNG	QM55H						PREFERRED SIZE
*49" LED DISPLAY	SAMSUNG	QM49H					•	
SWING ARM MOUNT	CHIEF	TS318TU					•	
AUDIO SPEAKERS	LEON	PROFILE PrUT					•	VERTICAL SPEAKERS, EACH SIDE OF DISPLAY
AMPLIFIER	QSC	SPA2-60			•		•	LOCATE BEHIND DISPLAY AT RECESSED DISPLAY, IN DATA ROOM AT SURFACE MOUNTED DISPLAY
RECEIVER	EXTRON	DTP HDMI 4K 230 RX			•		•	LOCATE BEHIND DISPLAY
TRANSMITTER	EXTRON	DTP HDMI 4K 230 TX			•		•	LOCATE IN DATA ROOM
MEDIA PLAYER	MEDIAVUE	SUREVUE D2			•		•	LOCATE IN DATA ROOM
SURGE PROTECTOR	CYBERPOWER	PDU15SW8FWNET			•		•	LOCATE IN DATA ROOM
 _UTION #1: 75" SCALA SIGNAGE, TELE	PRESENCE ROUGH-IN		1			1		
75" LED DISPLAY	SAMSUNG	QM75F			•		•	
SWING ARM MOUNT	CHIEF	TS525TU			•		•	
(1) IN-WALL BOX	CHIEF	PAC527F		•			•	
AUDIO SPEAKERS	LEON	HZUT					•	HORIZONTAL SPEAKER, ABOVE DISPLAY
AMPLIFIER	QSC	SPA2-60					•	LOCATE BEHIND DISPLAY AT RECESSED DISPLAY, IN DATA ROOM AT SURFACE MOUNTED DISPLAY
RECEIVER	EXTRON	DTP HDMI 4K 230 RX					•	LOCATE BEHIND DISPLAY
TRANSMITTER	EXTRON	DTP HDMI 4K 230 TX					•	LOCATE IN DATA ROOM
MEDIA PLAYER	MEDIAVUE	SUREVUE D2			•		•	LOCATE IN DATA ROOM
SURGE PROTECTOR	CYBERPOWER	PDU15SW8FWNET					•	LOCATE IN DATA ROOM
LUTION #2: NOT USED	-	1			1		<u> </u>	
LUTION #3: SCALA SIGNAGE WITH 2-WA	AY TELEPRESENCE							
75" LED DISPLAY	SAMSUNG	QM75F					•	PREFERRED SIZE
*55" LED DISPLAY	SAMSUNG	QM55H					•	
SWING ARM MOUNT	CHIEF	TS525TU					•	CHIEF LSM1U AT 55" VERSION
(1) IN-WALL BOX	CHIEF	PAC527F		•			•	(1) AT 55" VERSION
QUAD CAMERA	CISCO	CS-QUADCAM+					•	
TELEPRESENCE CODEC	CISCO	CS-CODEC-PLUS+					•	LOCATE BEHIND DISPLAY AT RECESSED DISPLAY, IN CREDNZA AT SURFACE MOUNTED DISPLAY
CONTROL PANEL	CISCO	CTS-CTRL-DVX-10					•	LOCATE AT CAFÉ OR CREDENZA
WIRED MICROPHONE	SHURE	SM58S					•	LOCATE AT CAFÉ OR CREDENZA
WIRELESS MICROPHONE	SHURE	ULX-D					•	LOCATE AT CAFÉ OR CREDENZA
AV CONNECTIVITY		HDMI, AUDIO			•		•	LOCATE AT CAFÉ OR CREDENZA
MICROPHONE PREAMPLIFIER	RDL	FP-MP1			-		•	LOCATE BEHIND DISPLAY AT RECESSED DISPLAY, IN CREDENZA AT SURFACE MOUNTED DISPLAY
WIRELESS RECEIVER	SHURE	QLXD4			•		•	LOCATE BEHIND DISPLAY AT RECESSED DISPLAY, IN CREDENZA AT SURFACE MOUNTED DISPLAY
RECEIVER	EXTRON	DTP HDMI 4K 230 RX			•		•	LOCATE BEHIND DISPLAY, OMIT AT SURFACE MOUNTED DISPLAY
TRANSMITTER	EXTRON	DTP HDMI 4K 230 TX			•		•	LOCATE IN DATA ROOM, OMIT AT SURFACE MOUNTED DISPLAY
MEDIA PLAYER	MEDIAVUE	SUREVUE D2			•		•	LOCATE IN DATA ROOM AT RECESSED DISPLAY, IN CREDENZA AT SURFACE MOUNTED DISPLAY
SURGE PROTECTOR	CYBERPOWER	PDU15SW8FWNET			•		•	LOCATE IN DATA ROOM AT RECESSED DISPLAY, IN CREDENZA AT SURFACE MOUNTED DISPLAY
LUTION #4: DESKTOP TELEPRESENCE	1	•					1	
TELEPRESENCE UNIT	CISCO	DX80			•		•	WITH DESKTOP STAND
_	N	1			1	<u>. </u>	l	•
32" MONITOR	SAMSUNG	DM32E					•	
WALL-MOUNT BRACKET	CHIEF	FSR1U					•	
RECEIVER	EXTRON	DTP HDMI 4K 230 RX			•		•	LOCATE IN CAFÉ BASE CABINET
TRANSMITTER	CRESTRON	HD-MD-400-C-E TX			•		•	LOCATE AT CREDENZA
MEDIA PLAYER	MEDIAVUE	SUREVUE D2			•			LOCATE IN DATA ROOM
SURGE PROTECTOR	CYBERPOWER	PDU15SW8FWNET			•			LOCATE IN DATA ROOM



JAMES T. LALLI, AIA, ARCHITECT LICENSE NO. 32254

THESE DRAWINGS ARE NOT COMPLETE WITHOUT THE SEPARATE TYPE WRITTEN SPECIFICATIONS MANUAL WHICH ARE PART OF THE CONTRACT DOCUMENTS.

ISSUE DATE DESCRIPTION
- 2022.07.15 PERMIT SET

PROJECT INFORMATION

PROJECT NO: JPM.27118

DATE: 2022.07.15

PROTOTYPE: 20.3

PROTOTYPE: 20.3

DRAWN BY: K.KELLY

CHECKED BY: M.SIDES

VERSION: SSE_1.00

SHEET TITLE

FURNITURE SCHEDULE AUDIO / VIDEO EQUIPMENT SCHEDULE

SHEET NUMBER

A3.4.1

ATM VENDOR TO PROVIDE AND INSTALL SCREEN LOCKING BRACKETS TO MAINTAIN SCREEN POSITION WITH ALL OPERABLE PARTS WITHIN ACCESSIBLE REACH RANGE.

Suite 117 Watertown, MA 02472 617.576.0007 ARCHITECT OF RECORD JAMES T. LALLI, AIA, ARCHITECT LICENSE NO. 32254 THESE DRAWINGS ARE NOT COMPLETE WITHOUT THE SEPARATE TYPE WRITTEN SPECIFICATIONS MANUAL WHICH ARE PART OF THE CONTRACT DOCUMENTS. ISSUE DATE DESCRIPTION 2022.07.15 PERMIT SET PROJECT INFORMATION PROJECT NO: PROTOTYPE: DRAWN BY: CHECKED BY: VERSION: SHEET TITLE BANK EQUIPMENT SCHEDULE SHEET NUMBER

NOTE: NOT ALL EQUIPMENT USED IN THE SCOPE OF THIS PROJECT.

A3.4.2

2022.07.15

K.KELLY

M.SIDES

SSE_1.00

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GROUP

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						FURNIS	SHED BY	T		INSTA	LLED BY		
TAG	DESCRIPTION	MANUFACTURER	PRODUCT	FINISH	OWNER	GC	EQUIP VENDOR	FURN VENDOR	OWNER	GC	EQUIP VENDOR	FURN VENDOR	NOTES
OE-01-BW	MULTI-FUNCTIONAL DEVICE (MFD) - B/W	LEXMARK	24T7401	PUTTY	•				•				
	SWIVEL BASE	LEXMARK	40G0855	BLACK	•				•				
	5.1" SPACER	LEXMARK	40G0854	PUTTY	•				•				
	550 SHEET DRAWER	LEXMARK	40G0802	PUTTY	•				•				
OE-01-C	MULTI-FUNCTIONAL DEVICE (MFD) - COLOR	LEXMARK	42K0177	PUTTY	•				•				
	SWIVEL BASE	LEXMARK	21K2501	BLACK	•				•				
	5.1" SPACER	LEXMARK	40G0854	PUTTY	•				•				
	550 SHEET DRAWER	LEXMARK	21G0567	PUTTY	•				•				
OE-02	NOT USED												
OE-03	MICR 9720 PRINTER	SOURCE TECHNOLOGIES	R0006912		•				•				
	MICR 9720 LOCKING DRAWER	SOURCE TECHNOLOGIES	R0007399		•				•				
	MICR 9720 UNDERCOUNTER STAND	BRETFORD	C15 \ A2188209	BLACK	•				•				
OE-04	ADA MONITOR & KEYBOARD STAND	HUMANSCALE	QSLBHD	BLACK								•	
OE-05	NOT USED												
OE-06	23" MONITOR AND STAND	HP	1FH48A8#ABA	SILVER	•				•				ALL MONITORS EXCEPT AST
	PRIVACY SCREEN FILTER	VARIES	VARIES		•				•				
	SOUND BAR	TBD	TBD	WHITE									
OE-07	TELLER CPU	HP	N8P49US#ABA	BLACK	_								
OE-08	WIRED KEYBOARD & MOUSE	LOGITECH	MK520	WHITE	•								
OE-09	NOT USED	200112011			_				_				
OE-10	NOT USED												
OE-10	ACCESS TELLER MONITOR STAND	HUMANSCALE	QSBH30FNN	BLACK									
OE-12	DESK MONITOR ARM	HUMANSCALE	MFLEX	GRAY				•					POLE-MOUNT THROUGH GROMMET
OE-12	NOT USED	HOWANSCALL	IVII LLX	GIVAT				-				-	FOLE-WOON THROUGH GROWINE
OE-13	23" MONITOR LESS STAND	TBD	TBD	WHITE	_				_				AST MONITOR
OL-14	PRIVACY SCREEN FILTER	VARIES	VARIES		_				_				AST MONITOR
	SOUND BAR	TBD	TBD	WHITE	_				_				
OF 15		HP			_				_				
OE-15	VDI TERMINAL	nr nr	4DT99UC#ABA-CUSTCHS	SILVER	•				•				
05.40	VDI TERMINAL ADAPTER	DELL / LENOVO	500 ADTV		•				•				
OE-16	WIRELESS KEYBOARD AND MOUSE	DELL/ LENOVO	580-ADTY	BLACK/SILVER	₹ ■				•				
OE-17 OE-18	NOT USED CPU/VDI UNDER SURFACE MOUNT	HUMANSCALE	CPU200	WHITE BR				•					UNDER SURFACE MOUNT WITH 360 DEGREE
		TIONII II IOON LEE		ALUM.				_					SWIVEL CAPABILITY
OE-19	NOT USED												
OE-20	NOT USED												
OE-21	NOT USED												
OE-22	NOT USED												
OE-23	NOT USED												
OE-24A	NOT USED												
OE-24B	NOT USED												
OE-24C	NOT USED												
OE-25	NOT USED												
OE-26	NOT USED												
OE-27	PLATFORM STATION WIRED 10-KEY KEYPAD	CONTROL INC	A0674838	BLACK	•					•			
OE-28	PHONE	CISCO	IP 7962	BLACK	•					•			
05.00.1/	PHONE - VIDEO PHONE	CISCO	CP-8865-K9	CHARCOAL						•			
OE-28-V					'		I		'				

			MISCELLA	ANEOUS	S EQUI	PME	NT SC	HEDU	LE			
						FURNIS	HED BY			INSTA	LLED BY	
TAG	DESCRIPTION	MANUFACTURER	PRODUCT	FINISH	OWNER	GC	EQUIP VENDOR	FURN VENDOR	OWNER	GC	EQUIP VENDOR	FURN VENDOR NOTES
ME-01	SHRED BIN				•				•			FURNISHED & INSTALLED BY CHASE FACILITIES GRO
ME-02	DUAL BAND QUEUE ROPES AND STANCHIONS	LAWRENCE METALS	TENSABARRIER	BLACK		•				•		REFER TO FLOOR PLANS FOR QUANTITIES
	POST WITH BELT	LAWRENCE METALS	889 DUAL	BLACK		•				•		
	POST WITHOUT BELT	LAWRENCE METALS	889 T2U-33-RCV	BLACK		•				•		
ME-03	BRUSH EXTRUSION KIT	DOUG MOCKETT	BRKIT1	BLACK		•		-		•		FURNITURE OR MILLWORK VENDOR TO COORDINAT WITH OWNER FOR REQUIRED OPENING
ME-04	HALF ROUND WASTE RECEPTACLE	RUBBERMAID COMMERCIAL	FGSO8SSSPL	STAINLESS STEEL		•				•		(2) COUNT - IN MAIN LOBBY AND ENTRY VESTIBULE
ME OF	EXTERIOR WASTE RECEPTACLE	RUBBERMAID	FGS3ETBKPL	BLACK								(1) COUNT - EXTERIOR NEAR ENTRY DOOR
ME-05	ANCHOR KIT	HILTI	3.3.8 KWIK BOLT 3	N/A								
ME-06	MUSIC PLAYER AND SPEAKERS	MOOD MEDIA	PROFUSION IS	BLACK	•				•			LOCATE IN PRINT/FILE ROOM.
ME-07	WIRELESS SDB SERVICE ENUNCIATOR SYSTEM	NUTONE	LA223WH			•				•		'OR EQUAL' SUBSTITUTIONS PERMITTED BASED ON LOCAL AVAILABILITY. INSTALL 1 PUSH BUTTON AT E SDB VIEWING STATION. DELIVER ENUNCIATOR TO CHASE REAL ESTATE PROJECT MANAGER AT PROJ CLOSE-OUT. MOUNT BUTTON 44" A.F.F.
ME-08	DUAL-CONTROL KEY BOX	BLOCK AND COMPANY	STEELMASTER #201SP8801	GRAY	•					•		INCLUDES KABA LOCK. G.C. TO PROVIDE SOLID WO BLOCKING AS REQUIRED.
ME-09A	BULLETIN BOARD	QUARTET	QRT 303			•				•		AVAILABLE FROM OFFICE DEPOT/MAX. 'OR EQUAL' SUBSTITUTIONS PERMITTED BASED ON LOCAL AVAILABILITY- 36"W x 24"H NATURAL CORK WITH OAFRAME.
ME-09B	DRY ERASE BOARD	QUARTET	EMA 203			•				•		AVAILABLE FROM OFFICE DEPOT/MAX. 'OR EQUAL' SUBSTITUTIONS PERMITTED BASED ON LOCAL AVAILABILITY- 36"W x 24"H ALUM. FRAME WITH PEN LEDGE AND WHTE MELAMINE SURFACE.
ME-09C	MAGNETIC STRIP BULLETIN BOARD	THREE BY THREE	31189 (8 REQUIRED)	NAVY BLUE		•				•		EIGHT 28" X 2.5" PAINTED METAL STRIPS WITH INCLUDED SCREWS AND MAGNETS ADHERED TO WITH 3M SCOTCH OR EQUAL PERMANENT DOUBLE-SIDED FOAM MOUNTING TAPE.
	NEW YORK CITY RECYCLING COMPONENTS											REQUIRED AT NEW YORK CITY PROJECTS ONLY
	ME-10A: TRIPLE-COMPARTMENT REFUSE BIN	WASTE WISE PRODUCTS INC.	RC-1528-3-SS WITH CUSTOM LABELS									NYC PROJECTS ONLY- ONE REQD. AT EACH VESTIE AND LOBBY OR SIMILAR AREA; CUSTOM LABELS: PA TRASH, METAL/GLASS/PLASTIC
	ME-10B: RECYCLING INSTRUCTIONAL SIGN	NA	NA	NA	•				•			NYC PROJECTS ONLY- REQUIRED AT EACH ME-10B TRIPLE-COMPARTMENT BIN AND ME-10D SORTING STATION
ME-10	ME-10C: RECYCLING COMPLIANCE PLACCARD	NA	NA	NA	•				•			NYC PROJECTS ONLY; PROVIDED BY REFUSE HAUL AND INSTALLED BY J.L.L. FACILITIES
	ME-10D: 3-BIN SORTING STATION	NA	NA	NA	•				•			NYC PROJECTS ONLY; PROVIDED AND INSTALLED CHASE BRANCH PLANNING
	ME-10E: TRASH BIN LABELS	NA	NA	NA	•				•			NYC PROJECTS ONLY; PROVIDED AND APPLIED BY CHASE BRANCH PLANNING TO ALL NON-RECYCLIN BINS; HTTP://STORE.RECYCLEACROSSAMERICA.ORG/LAE TRASH-LABELS/TRASH-4X9.HTML
ME-11	TABLET CHARGING CABINET	KENSINGTON	K67862AM	BLACK	•				•			PROVIDE AND INSTALLED BY CHASE GTI.
ME-12	RECESSED ATM KEY BOX	TELLEREX	RECESSED TRACCESS BOX	BLACK		-				•		PER RDC 20-007, GC PROCURED AND INSTALLED. CONTACT TELLEREX AT 888.395.0170 - CONTACT MELISSA DORMAN/BRIAN LECHLITNER

	OFFICE EQUI	PMENT	ΓBY P	ROGRAMMATIC ELEMENT				1	23" MONITOR AND STAND	
PROC	GRAMMATIC ELEMENT						OE-06	1	PRIVACY SCREEN FILTER	
ABBREV.	DESCRIPTION	TAG	QTY.	DESCRIPTION			05.40	1	SOUND BAR	
			1	23" MONITOR AND STAND		PRIVATE CONSULTATION	OE-12	1	MONITOR ARM	
MST	MERCHANT SERVICES	OE-06	1		PCS	SPACE	OE-15	1	VDI TERMINAL	
	TELLER, PST PERSONAL SERVICES TELLER, OR AT ACCESS TELLER		1	SOUND BAR			05.40	1	VDI TERMINAL ADAPTER	
PST		OE-07	1	TELLER CPU			OE-16	1	WIRELESS KEYBOARD AND MOUSE	
AT		OE-08	1	WIRED KEYBOARD & MOUSE			OE-27	1	PLATFORM STATION WIRED 10-KEY KEYPAD	
		OE-10	1	WIRE MANAGEMENT KIT			OE-28	1	PHONE	
		OE-04	1	ADA MONITOR & KEYBOARD STAND			05.00	1	23" MONITOR	
		OE-07	1	TELLER CPU			OE-06	1	PRIVACY SCREEN FILTER	
	AST ACCESSIBLE SERVICES TELLER	OE-08	1	WIRED KEYBOARD & MOUSE			05.40	1	SOUND BAR	
AST		OE-10	1	WIRE MANAGEMENT KIT		CONFERENCE ROOM	OE-12	1	MONITOR ARM	
			1	23" MONITOR - LESS STAND		MARKET CONFERENCE	OE-15	1	VDI TERMINAL 3	
		OE-14	1	PRIVACY SCREEN FILTER		SPACE		1	VDI TERMINAL ADAPTER	
			1	SOUND BAR			OE-16	1	WIRELESS KEYBOARD AND MOUSE	
		OE-05	1	NOT USED			OE-27	1	PLATFORM STATION WIRED 10-KEY KEYPAD	
	LAO LEAD ASSOCIATE OPERATIONS		1	23" MONITOR AND STAND		INDIVIDUAL WORK SPACE	OE-28	1	PHONE	
		OE-06	1	PRIVACY SCREEN FILTER			OE-06 OE-15	1	23" MONITOR AND STAND	
LAO			1	SOUND BAR				1	PRIVACY SCREEN FILTER	
		OE-07	1	TELLER CPU				1	SOUND BAR	
		OE-08	1	WIRED KEYBOARD & MOUSE	IWS			1	VDI TERMINAL	
		OE-10	1	WIRE MANAGEMENT KIT				1	VDI TERMINAL ADAPTER	
		OE-18	1	CPU/VDI UNDER SURFACE MOUNT			OE-16	1	WIRELESS KEYBOARD AND MOUSE	
DRT	DINING ROOM TABLE	OE-29	1	NOT USED			OE-27	1	PLATFORM STATION WIRED 10-KEY KEYPAD	
			1	23" MONITOR AND STAND			OE-28	1	PHONE	
		OE-06	1	PRIVACY SCREEN FILTER	NOTES	MONITOR ADM PROVIDED AND INSTALLED BY FURNITURE VENDOR AND CONTROL OF THE CONTROL				
			1	SOUND BAR	1.	MONITOR ARM PROVIDED AND INSTALLED BY FURNITURE VENDOR. ALL OTHER SCHEDULED EQUIPMENT PROCHASE GLOBAL TECHNOLOGY INFRASTRUCTURE (GTI).				
			1	VDI TERMINAL	2.			O ACCOMMODATE A VIDEO ADVISOR, MANAGING DIRECTOR OR REGIONAL DI		
	ВООТН	OE-15	1	VDI TERMINAL ADAPTER		ADD A/V SOLUTION 4				
		OE-16	1	WIRELESS KEYBOARD AND MOUSE	3.	IF TABLE IS CENTERED IN ROOM AND FLOOR POWER/ DATA CONNECTIONS ARE PROVIDED.			R/ DATA CONNECTIONS ARE PROVIDED. ADD CPU/VDI	
		OE-18	1	CPU/VDI UNDER SURFACE MOUNT	4.	UNDER-SURFACE MOUNT [OE-18] ONE OFFICE TO RECEIVE 2-ARM MONITOR STAND, LOCATION TO BE DETERMINED BY BRANCH PLANNING				
		OE-28	1	PHONE		DURING TURNOVER.	ram morari or	. 017.1110, 2		
		OE-29	1	CUSTOMER UNIVERSAL CHARGING STATION						
			1	23" MONITOR						
		OE-06	1	PRIVACY SCREEN FILTER						
			1	SOUND BAR						
		OE-12	1	MONITOR ARM						
ccs	CASUAL CONSULTATION		1	VDI TERMINAL						
	SPACE	OE-15	1	VDI TERMINAL ADAPTER						
		OE-16	1	WIRELESS KEYBOARD AND MOUSE						
		OE-27	1	PLATFORM STATION WIRED 10-KEY KEYPAD						
		OE-28		PHONE						

			1	22" MONITOR AND STAND
		05.00	1	23" MONITOR AND STAND
		OE-06	1	PRIVACY SCREEN FILTER
			1	SOUND BAR
	PRIVATE CONSULTATION	OE-12	1	MONITOR ARM
PCS	SPACE	OE-15	1	VDI TERMINAL
			1	VDI TERMINAL ADAPTER
		OE-16	1	WIRELESS KEYBOARD AND MOUSE
		OE-27	1	PLATFORM STATION WIRED 10-KEY KEYPAD
		OE-28	1	PHONE
			1	23" MONITOR
		OE-06	1	PRIVACY SCREEN FILTER
			1	SOUND BAR
	CONFERENCE ROOM	OE-12	1	MONITOR ARM
MARKET CONFERENCE SPACE	OF 45	1	VDI TERMINAL 3	
		OE-15	1	VDI TERMINAL ADAPTER
		OE-16	1	WIRELESS KEYBOARD AND MOUSE
		OE-27	1	PLATFORM STATION WIRED 10-KEY KEYPAD
		OE-28	1	PHONE
			1	23" MONITOR AND STAND
		OE-06	1	PRIVACY SCREEN FILTER
			1	SOUND BAR
			1	VDI TERMINAL
WS	INDIVIDUAL WORK SPACE	OE-15	1	VDI TERMINAL ADAPTER
		OE-16	1	WIRELESS KEYBOARD AND MOUSE
		OE-27	1	PLATFORM STATION WIRED 10-KEY KEYPAD
		OE-28	1	PHONE
TES			<u> </u>	
				IDE VENDOR ALL OTHER COHERLILER COHERNEY PROVIDER BY

1. MONITOR ARM PROVIDED AND INSTALLED BY FURNITURE VENDOR. ALL OTHER SCHEDULED EQUIPMENT PROVIDED BY CHASE GLOBAL TECHNOLOGY INFRASTRUCTURE (GTI). IF SPACE IS BEING DESIGNED TO ACCOMMODATE A VIDEO ADVISOR, MANAGING DIRECTOR OR REGIONAL DIRECTOR, ADD A/V SOLUTION 4

UNDER-SURFACE MOUNT [OE-18] 4. ONE OFFICE TO RECEIVE 2-ARM MONITOR STAND, LOCATION TO BE DETERMINED BY BRANCH PLANNING MANAGER DURING TURNOVER.

NOTE: NOT ALL EQUIPMENT USED IN THE SCOPE OF THIS PROJECT.

9 Galen Street Suite 117 Watertown, MA 02472 617.576.0007 core-states.com

JAMES T. LALLI, AIA, ARCHITECT LICENSE NO. 32254

ARCHITECT OF RECORD

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ISSUE DATE DESCRIPTION - 2022.07.15 PERMIT SET


PROJECT INFORMATION PROJECT NO: JPM.27118 2022.07.15 PROTOTYPE: K.KELLY DRAWN BY: M.SIDES CHECKED BY: VERSION: SSE_1.00

OFFICE EQUIPMENT BY PROGRAMMATIC ELEMENT OFFICE EQUIPMENT SCHEDULE MISCELLANEOUS EQUIPMENT SCHEDULE

SHEET NUMBER

SHEET TITLE

A3.4.3

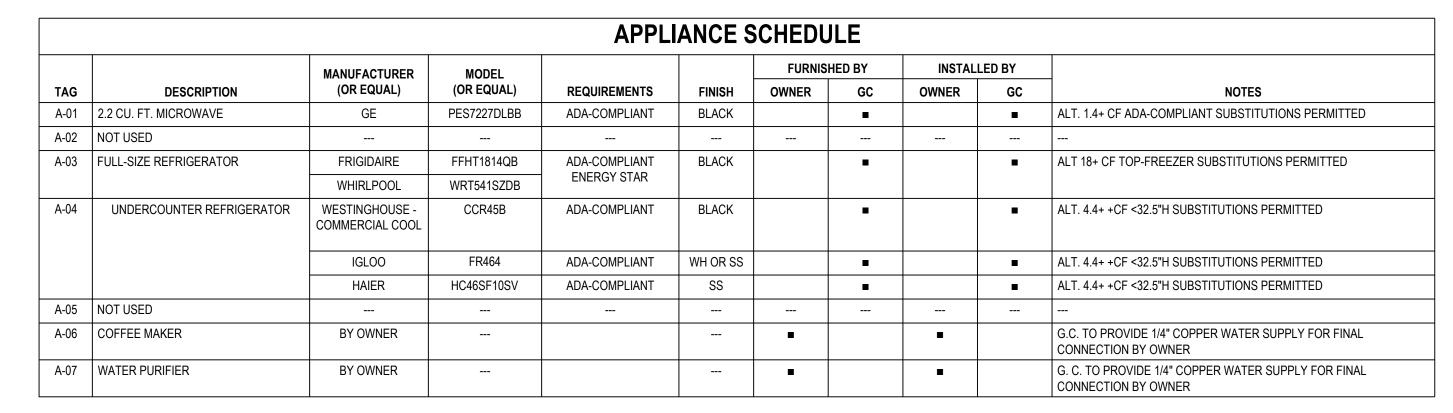

	RESTROOM ACCESSORIES SCHEDULE							
TAG	DESCRIPTION	MFR.	MODEL	FINISH	NOTES			
TA-01	TOILET TISSUE DISPENSER	BOBRICK	B-2888	S.S.	1, 6			
TA-02 (OPT.)	UNIVERSAL C-FOLD / MULTI-FOLD PAPER TOWEL DISPENSER	BOBRICK	B-262	S.S.	1			
TA-02 (OPT.)	UNIVERSAL 8" ROLL PAPER TOWEL DISPENSER	BOBRICK	B-2860	S.S.	1, 3			
TA-03	WASTE RECEPTACLE	BOBRICK	B-279	S.S.	6			
TA-04	GRAB BARS	BOBRICK	B-5806 SERIES	S.S.	6			
TA-05	MIRROR	BOBRICK	B-165 2448	S.S.	6			
TA-06 (OPT.)	LIQUID SOAP DISPENSER: LAVMOUNT, LONG SHANK, 4" SPOUT	BOBRICK	B-822	POL. S.S.	1, 2, 6			
TA-06 (OPT.)	FOAM SOAP DISPENSER: LAVMOUNT, LONG SHANK, 4" SPOUT	BOBRICK	B-823	POL. S.S.	1, 2, 6			
TA-07	SANITARY NAPKIN DISPOSAL	BOBRICK	B-270	S.S.	6			
TA-08	TOILET SEAT COVER DISPENSER	BOBRICK	B-4221	S.S.	6			
TA-09	SHELF	GAMCO	B-7816	S.S.	4, 6			
TA-10	BABY CHANGING STATION (ONLY WHERE CODE REQUIRED)	GAMCO	BCS-2	GREY HOPE	4, 5, 6			

NOTES:

- 1. G.C. TO VERIFY OPTION PREFERENCE WITH OWNER'S LOCAL FACILITIES MANAGER.
- 2. FIELD-CUT SOAP DISPENSER SHANK TO MINIMIZE RESERVOIR EXPOSURE.
- 3. AoR TO COORDINATE DISPENSER POSITION TO MAINTAIN ACCESSIBLE REACH RANGE AND PATH TO DISPENSER AND ADJACENT FIXTURES
- 4. AVAILABLE FROM BOBRICK.
- 5. BABY CHANGING STATION TO BE PROVIDED ONLY WHEN REQUIRED BY A.H.J.. MOUNT FOR ACCESSIBILITY COMPLIANCE, AT HEIGHT OF 27" A.F.F., HANDLE < 44" AFF.
- 6. PROVIDE IN ALL RESTROOMS

ELECTRICAL DEVICE FINISHES LOCATION LUTRON LEVITON, LEGRAND						
SURFACE	FINISH					
CEILINGS AND SOFFIT FACES	PT-103	WHITE	WHITE			
TYPICAL WALL	ANY OTHER THAN PT-103	WHITE	WHITE			
ACCENT WALL	ANY OTHER THAN PT-103	WHITE	WHITE			





Suite 117 Watertown, MA 02472 617.576.0007 core-states.com

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ARCHITECT OF RECORD

JAMES T. LALLI, AIA, ARCHITECT LICENSE NO. 32254

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- 2022.07.15 PERMIT SET

PROJECT INFORMATION

PROJECT NO: JPM.27118

DATE: 2022.07.15

PROTOTYPE: 20.3

DRAWN BY: K.KELLY

CHECKED BY: M.SIDES


APPLIANCE SCHEDULE
RESTROOM ACCESSORIES
ELECTRICAL DEVICES FINISHES

SHEET NUMBER


VERSION: SHEET TITLE

A3.5

SSE_1.00

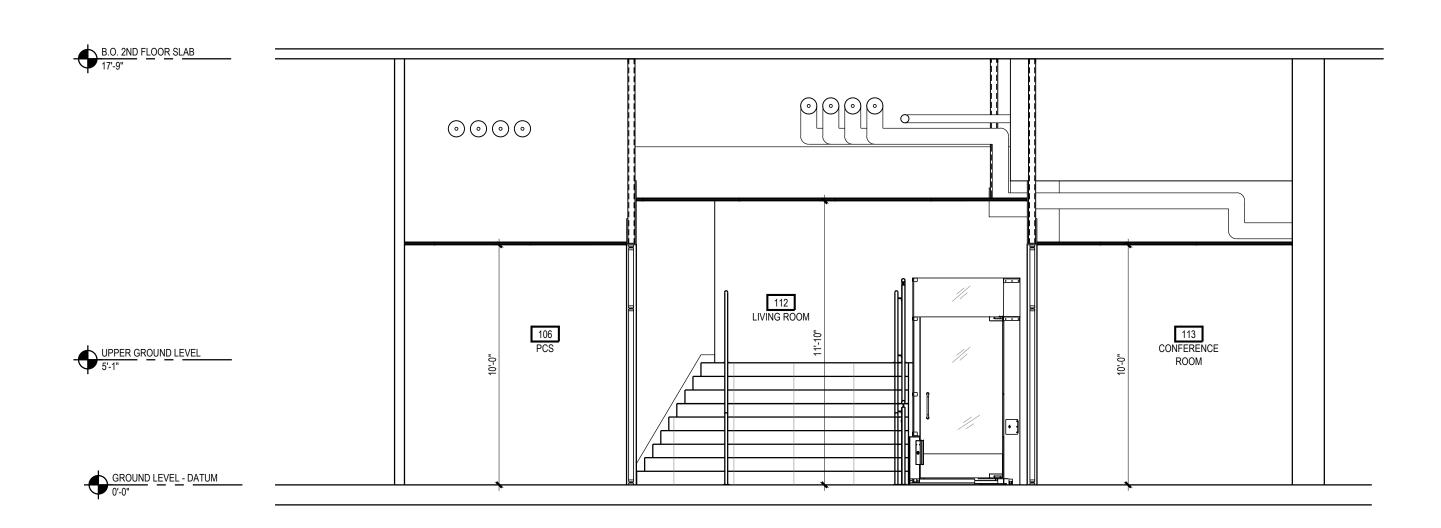



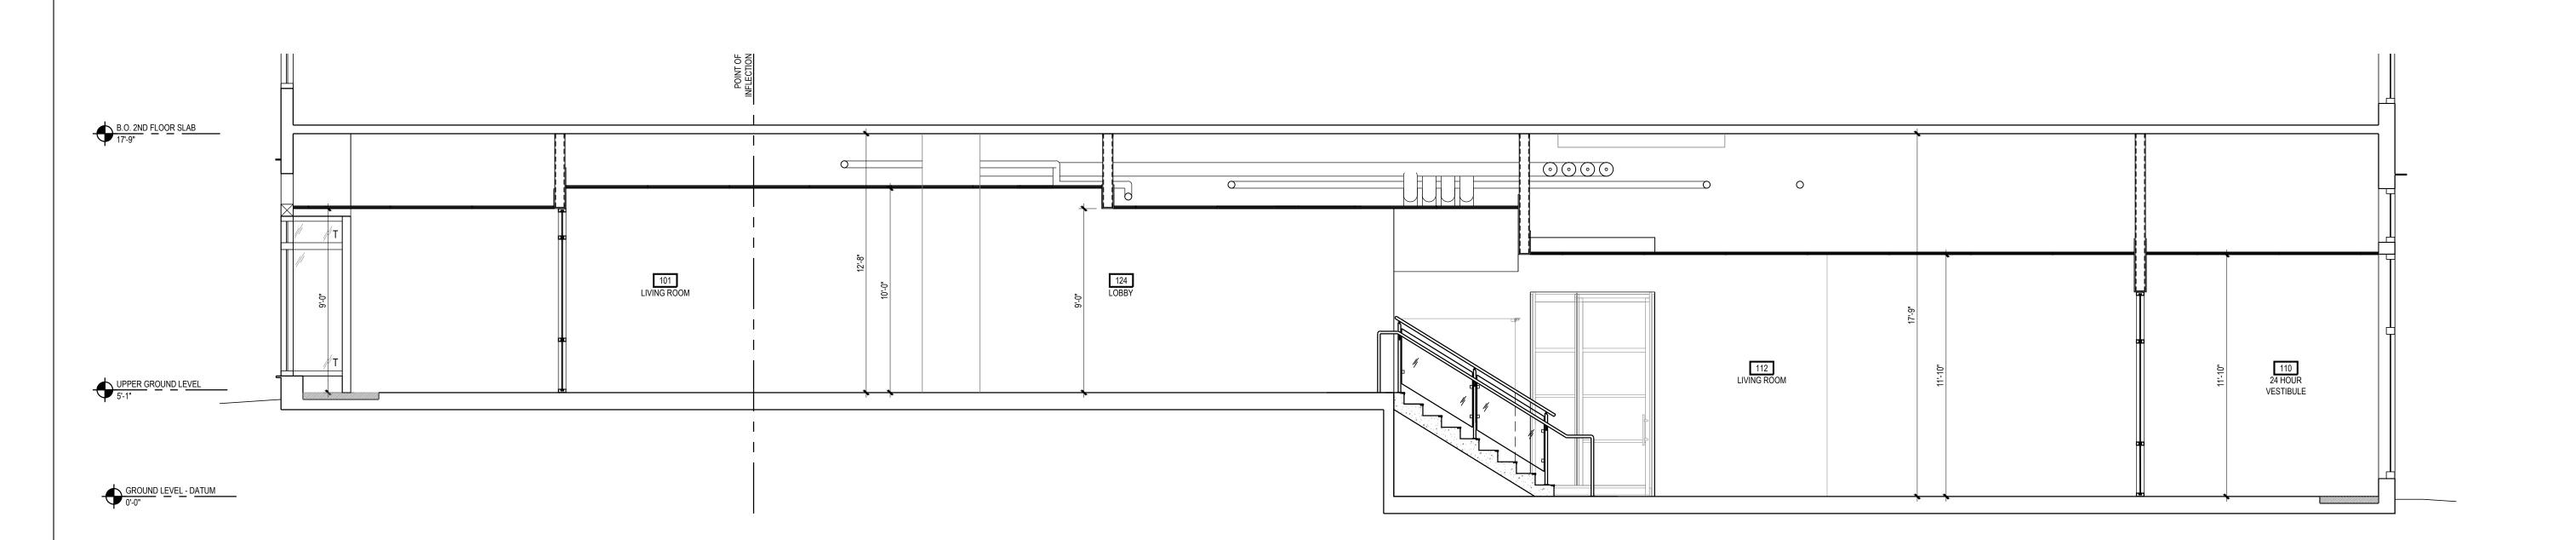

2 BUILDING SECTION
A4.0.0 1/4" = 1'-0"

JP MORGAN CHASE, N.A.

HARVARD SQUARE

9 JFK STREET

CAMBRIDGE, MA 02138

GROUP

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DATE: 2022.07.15

PROTOTYPE: 20.3

DRAWN BY: S.NUVELMAN

DATE: 2022.07.15

PROTOTYPE: 20.3

DRAWN BY: S.NUVELMAN

CHECKED BY: M.SIDES


VERSION: SSE_1.00

SHEET TITLE


BUILDING SECTIONS

SHEET NUMBER


A4.0.0

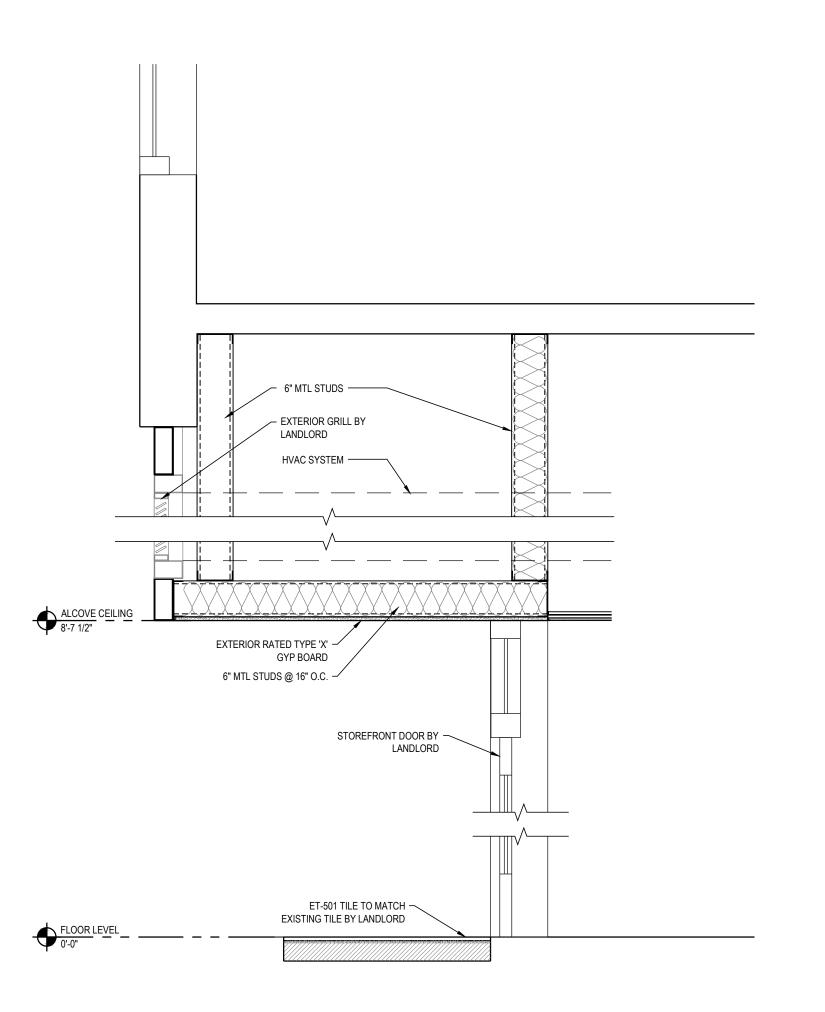


SECTION AT FRONT ENTRY ALCOVE - JFK ST.

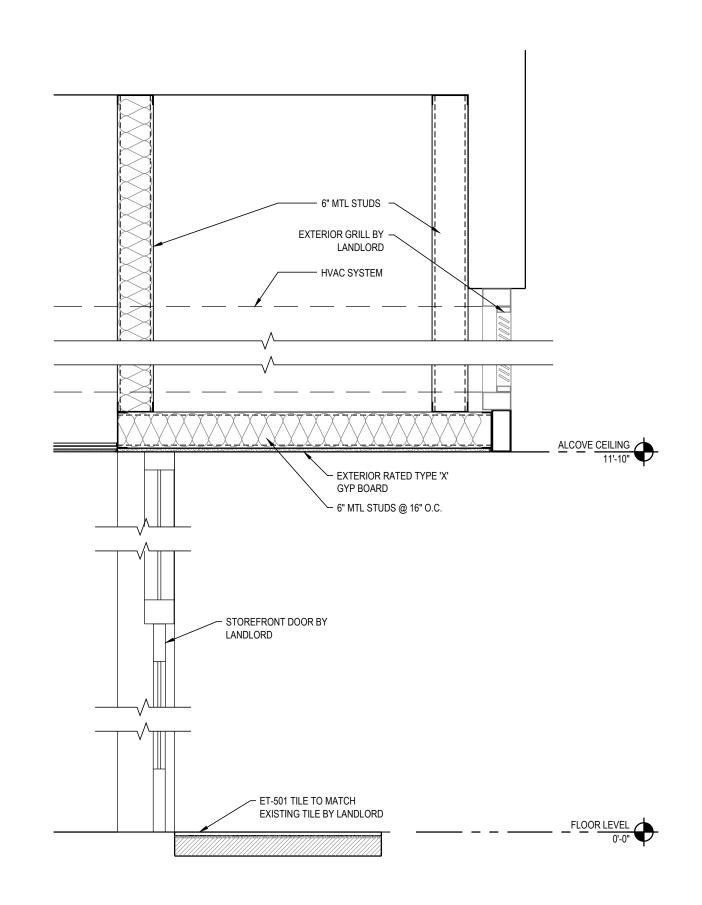


SECTION AT FRONT ENTRY ALCOVE - BRATTLE ST.

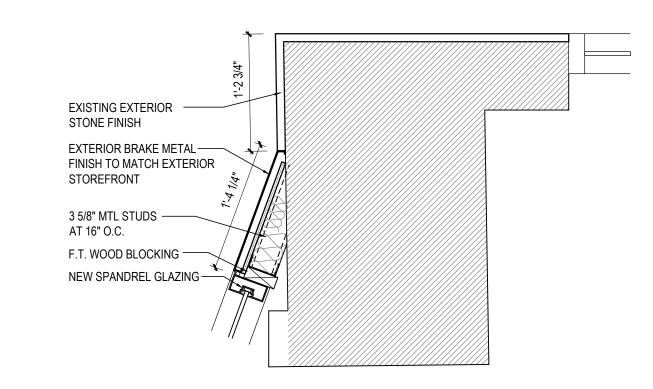


BRATTLE ST WALL DETAIL 02

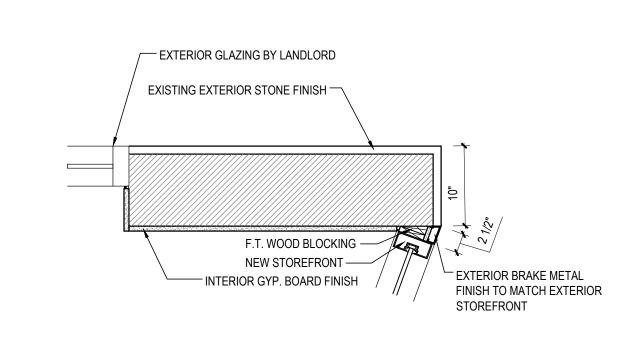

BRATTLE STREET WALL DETAIL 01

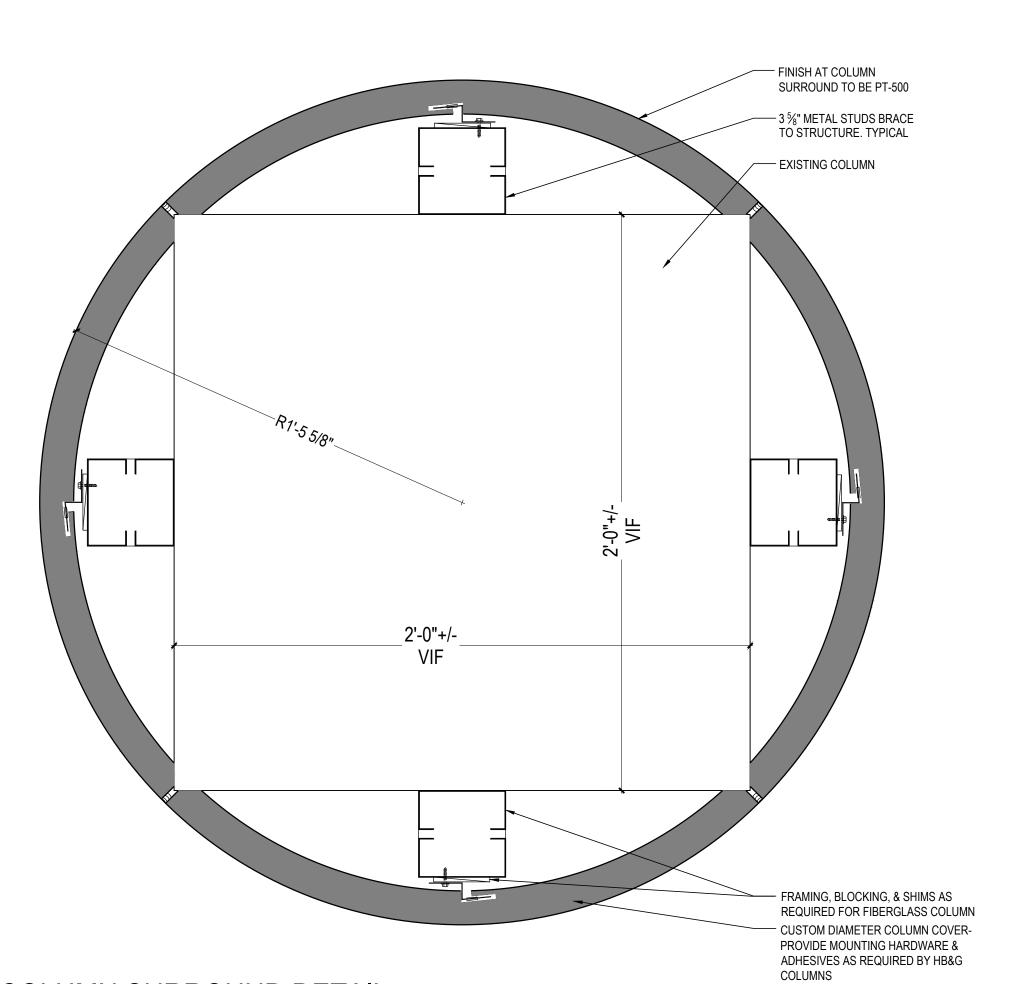

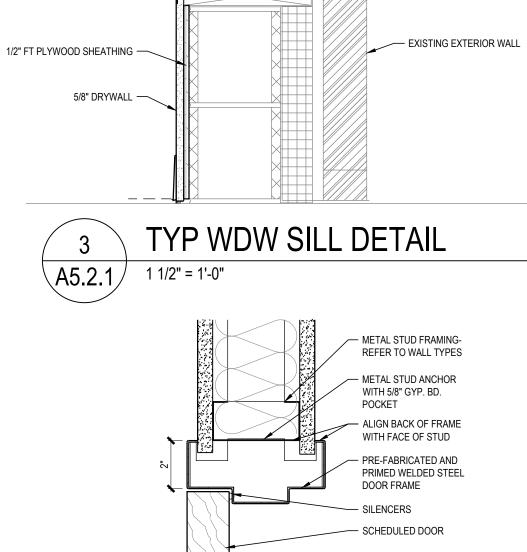

PEMKO 315DN DOOR SWEEP-MATCH STOREFRONT
MATERIAL FINISH

TYPICAL STOREFRONT

ENTRANCE THRESHOLD


NEW EXTERIOR TILE TO MATCH EXISTING EXTERIOR TILE

A5.2.1 3'' = 1'-0''

CONT. BACKER ROD AND — SEALANT (TYP.)

SCHEDULED WINDOW SILL

INTERIOR DOOR HEAD / JAMB SIMILAR

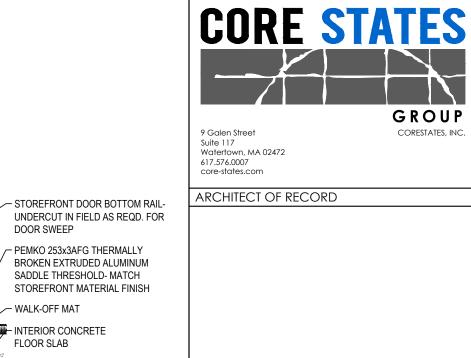

SADDLE THRESHOLD- MATCH

✓ WALK-OFF MAT

INTERIOR CONCRETE FLOOR SLAB

— STOREFRONT

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ISSUE	DATE	DESCRIPTION
-	2022.07.15	PERMIT SET

PRO.	JECT INFO	ORMATION	
PRC	DJECT NO:		JPM.27118
DA	TE:		2022.07.15
PRC	OTOTYPE:		20.3
DR	AWN BY:		K.KELLY
CH	ECKED BY:		M.SIDES
VER	RSION:		SSE_1.00
SHEET 1	TITLE		


DETAILS: WALL OPENINGS & INTERIOR DETAILS


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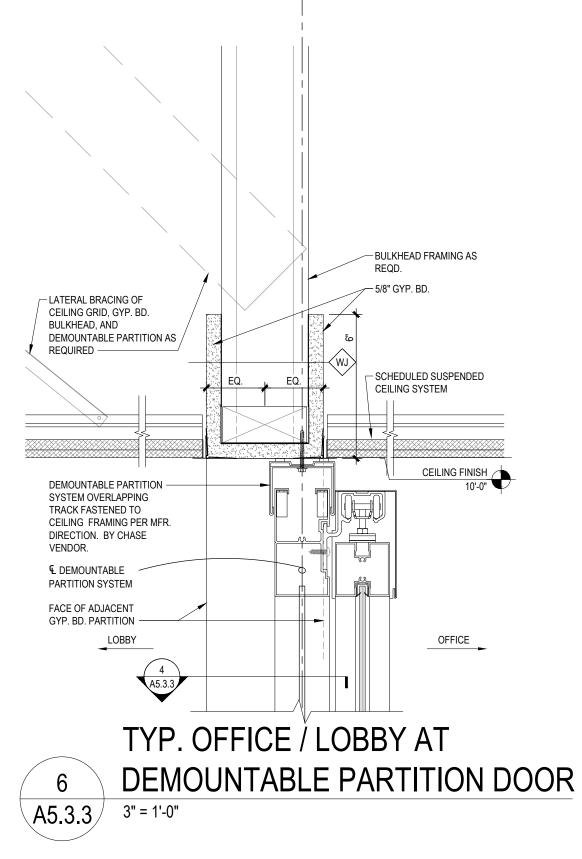
A5.2.1


A5.2.1 3" = 1'-0"


COLUMN SURROUND DETAIL




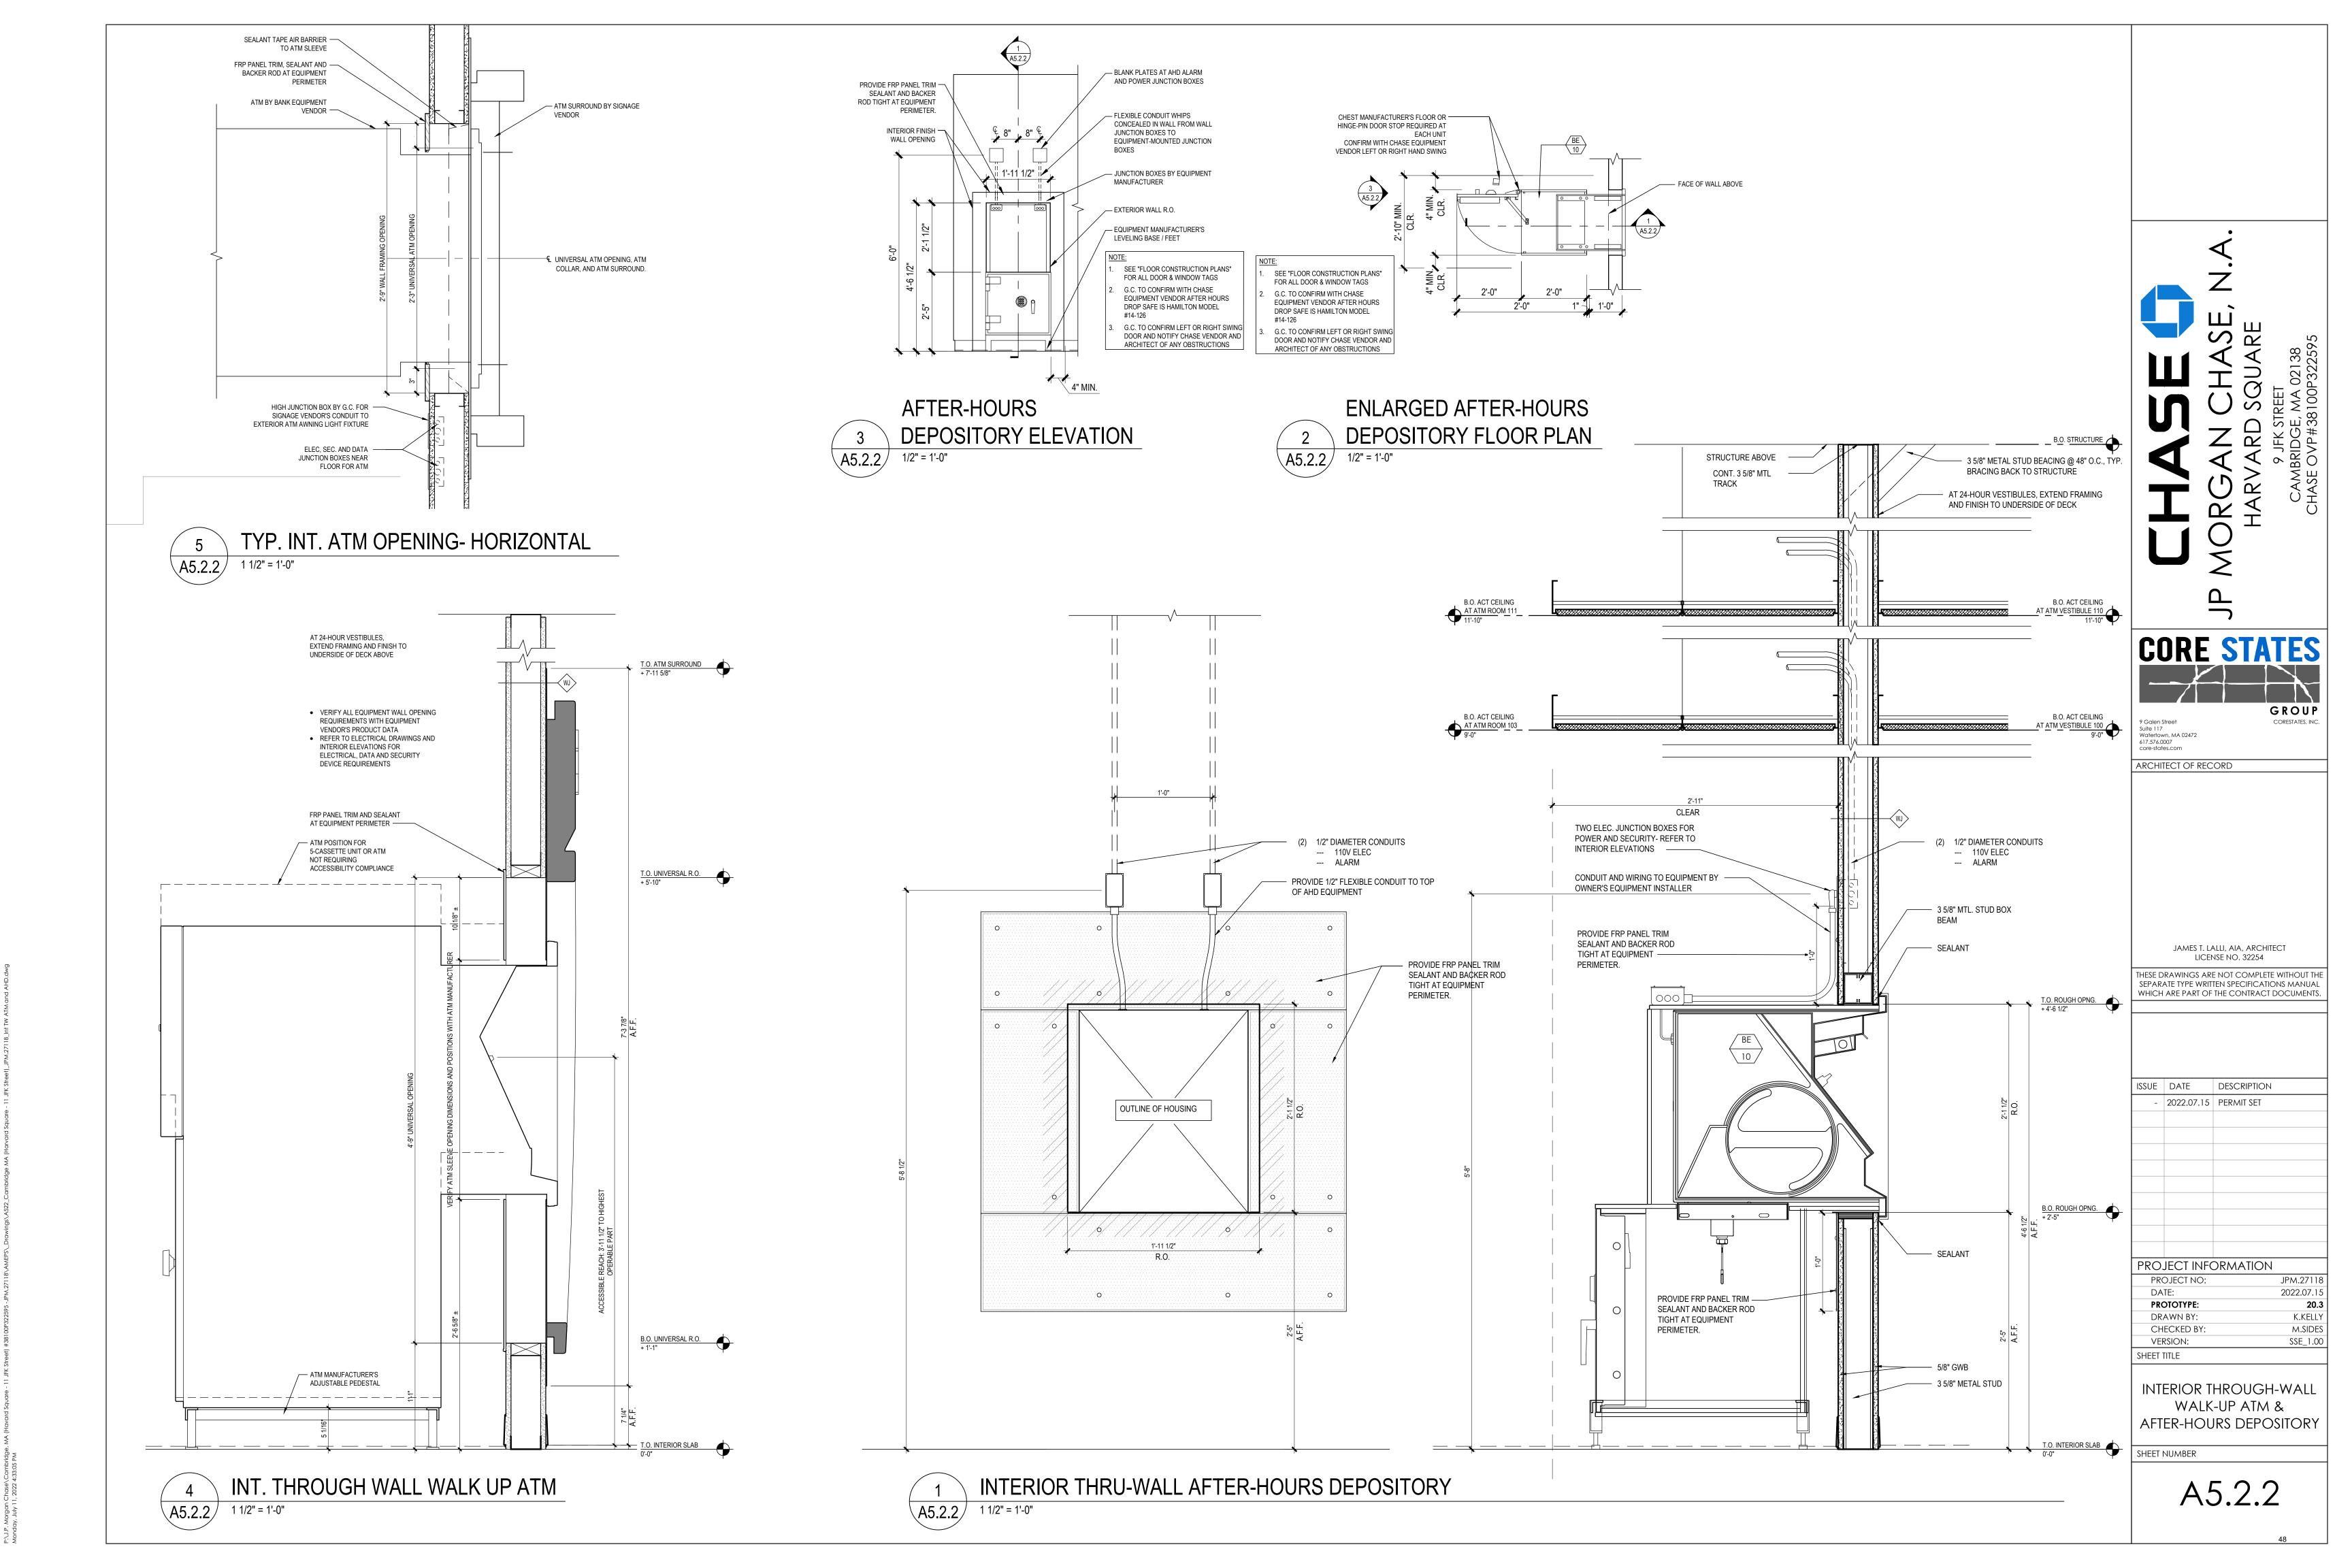


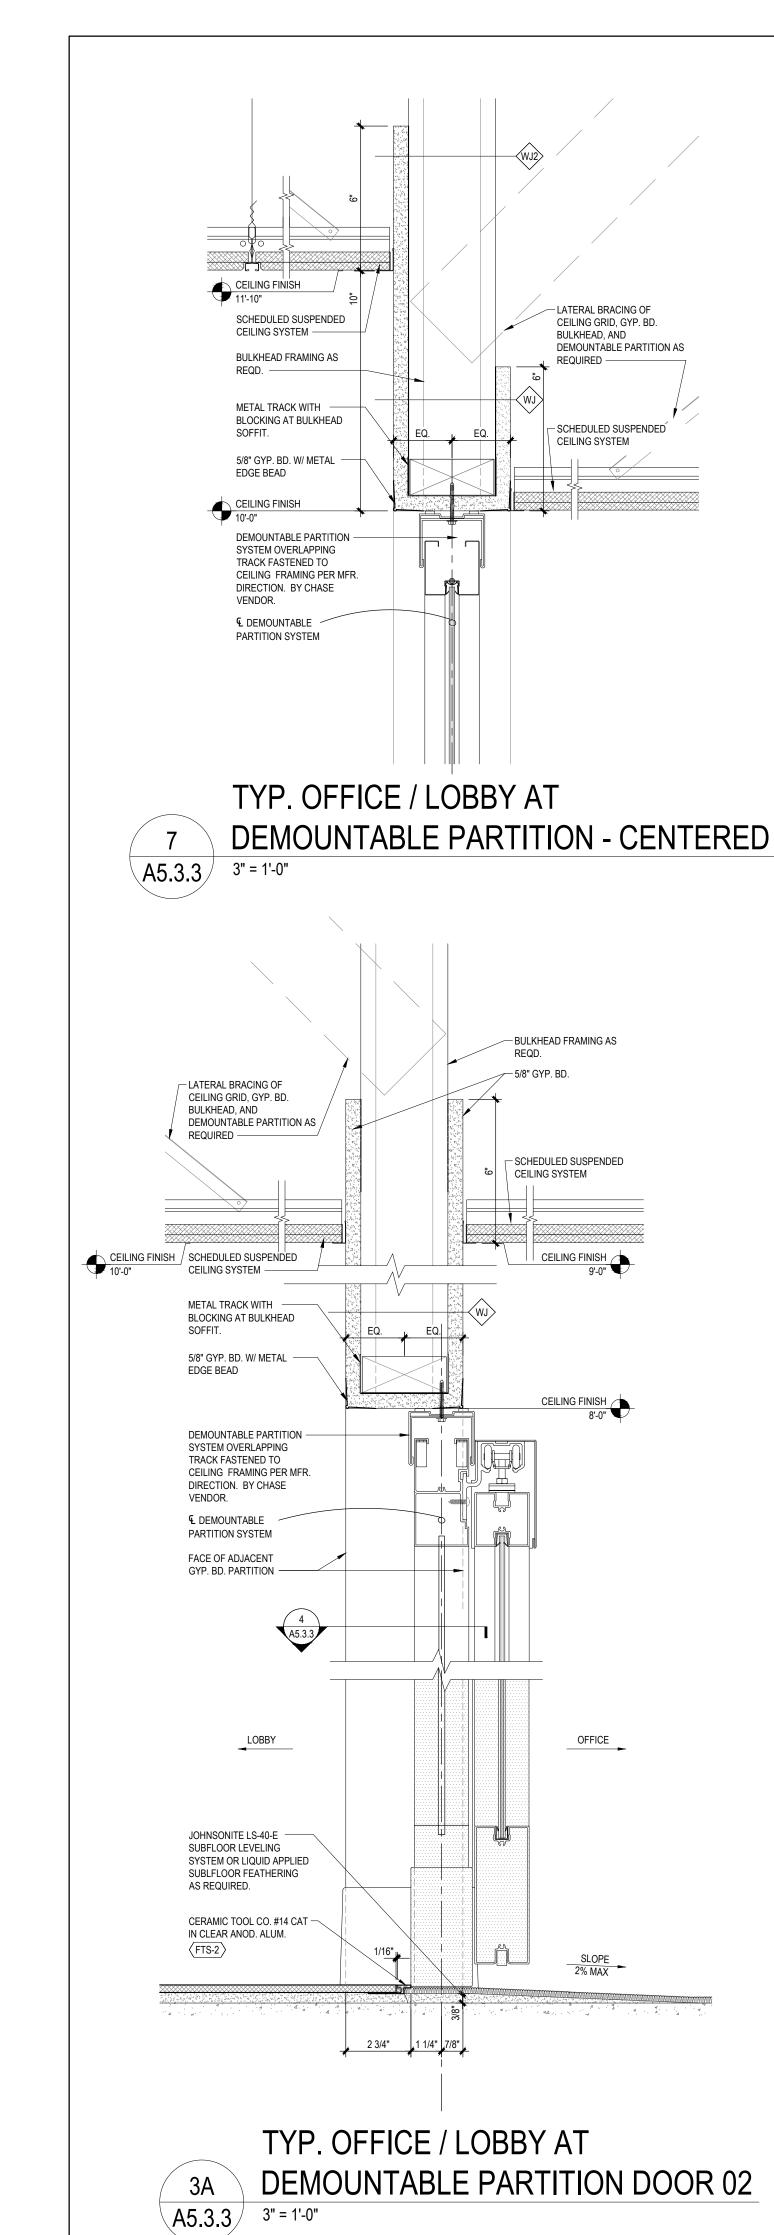

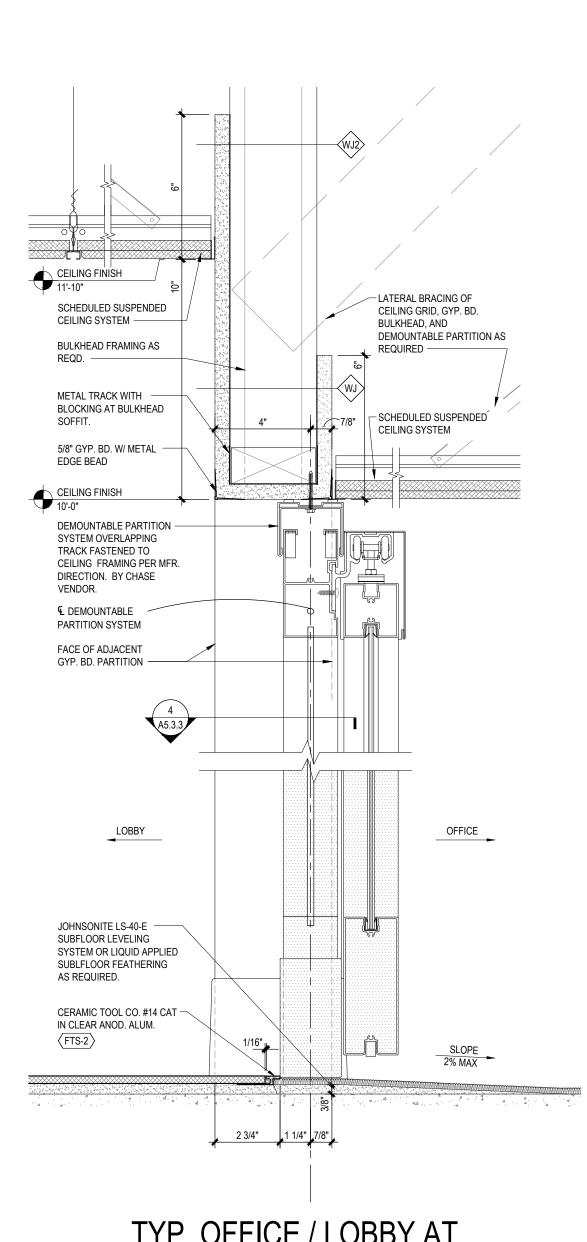

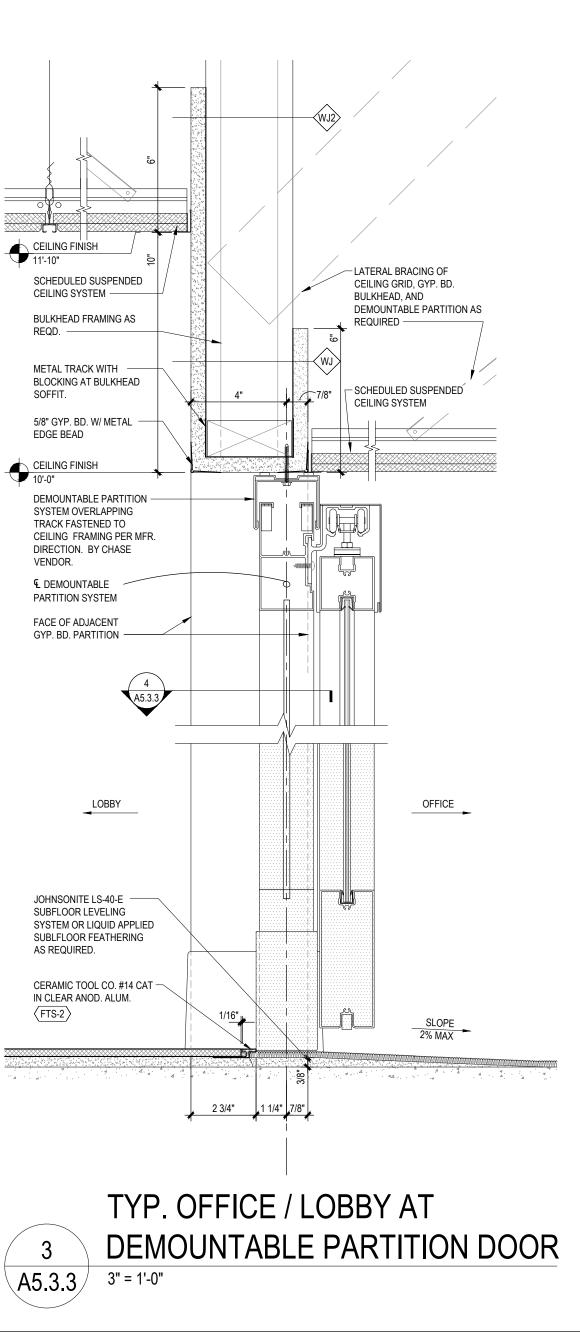


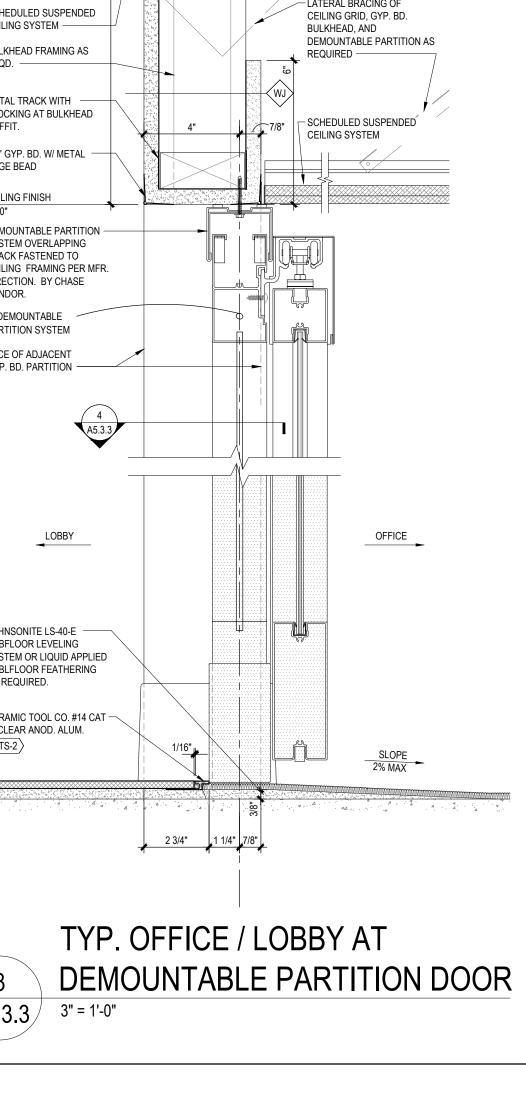


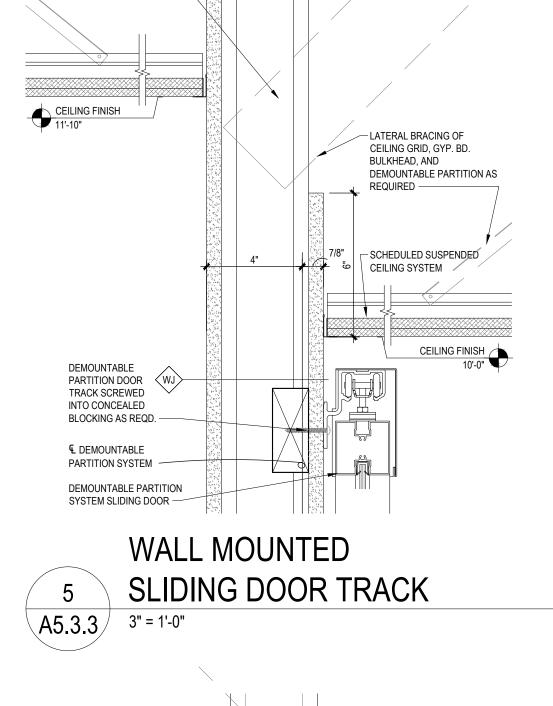


LATERAL BRACING OF CEILING GRID, GYP. BD. BULKHEAD, AND DEMOUNTABLE PARTITION


AS REQUIRED -

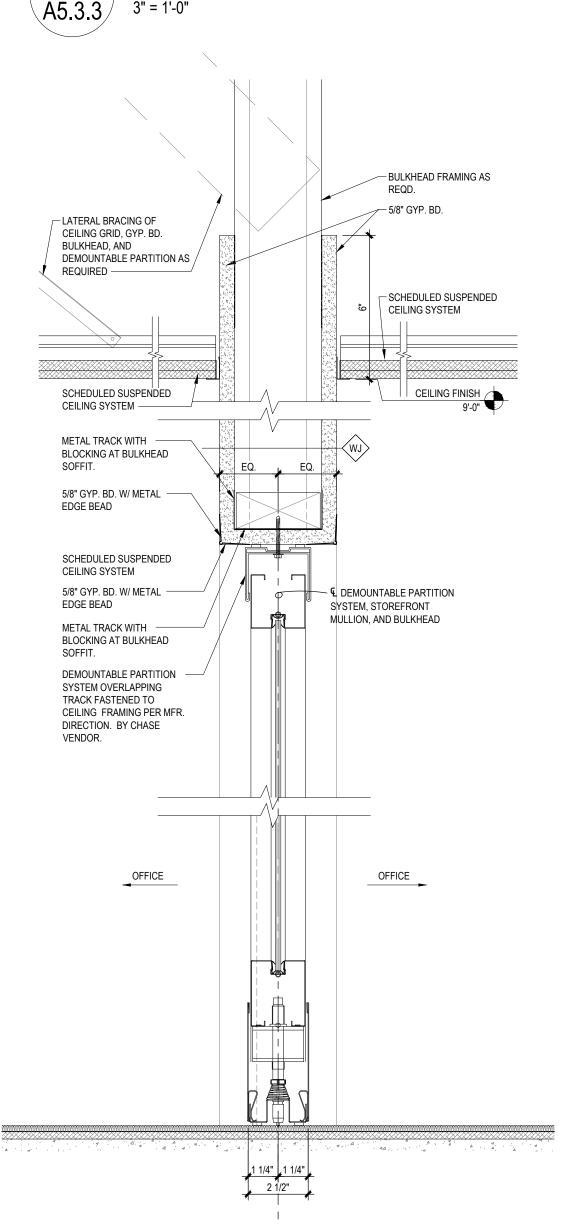

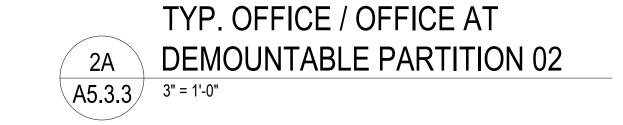


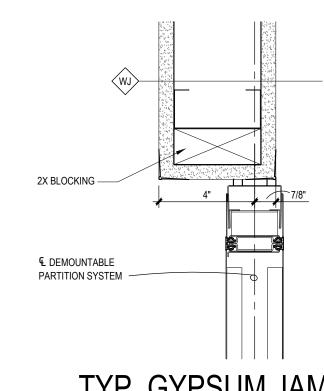

TYP. GYPSUM JAMB AT DEMOUNTABLE PARTITION

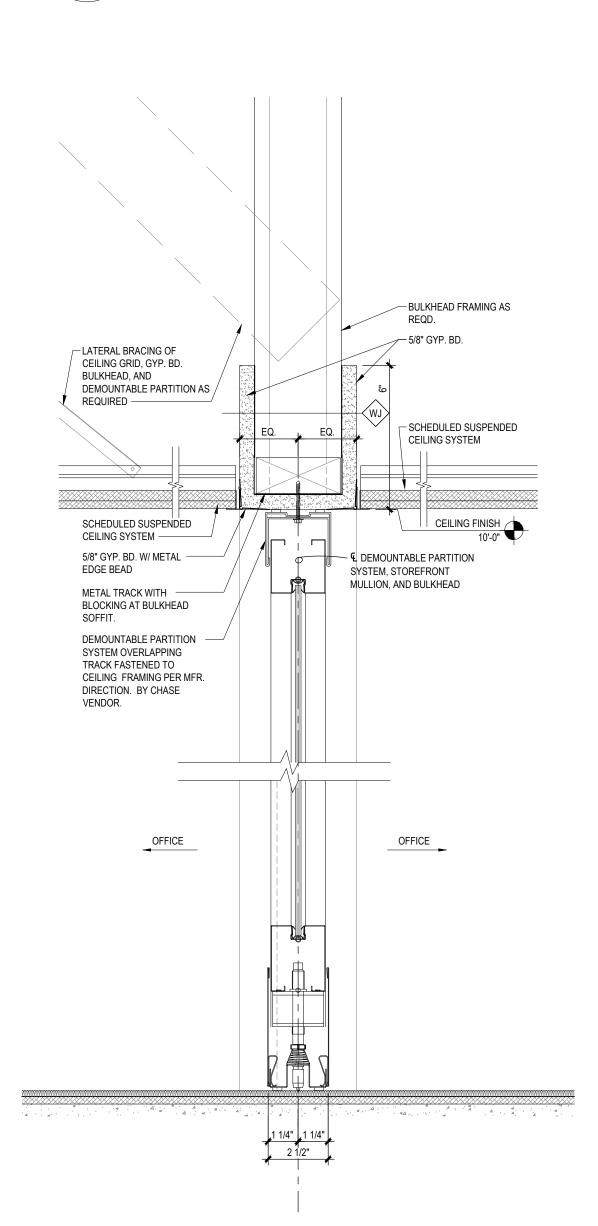





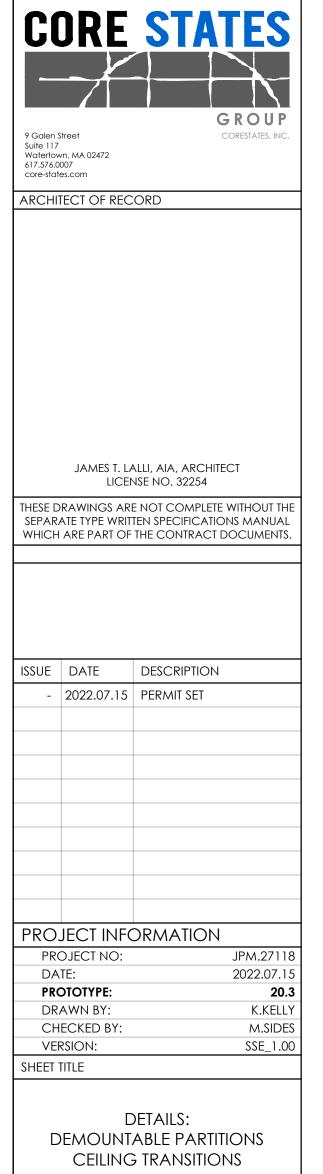

A5.3.3


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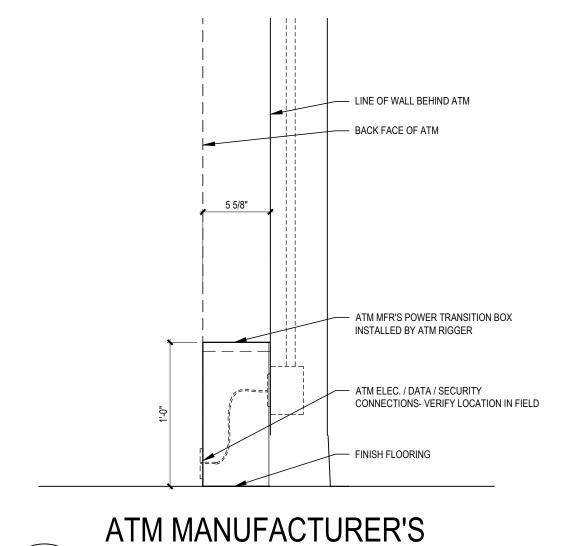


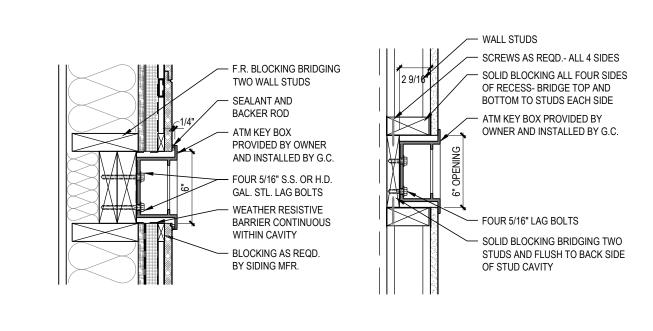

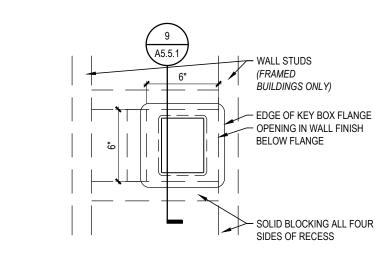INTERIOR PARTITION







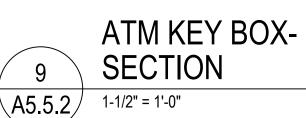


POWER TRANSITION BOX

A5.5.2 1 1/2" = 1'=0"

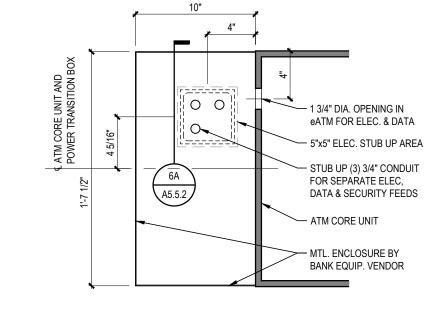

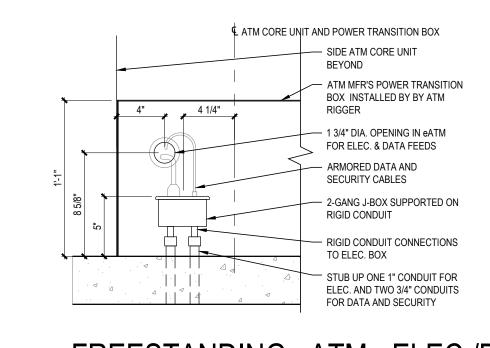


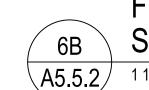



FREESTANDING eATM - ELEC./DATA/ SECURITY ROUGH-INS (HORIZ.)


A5.5.2 1 1/2" = 1'=0"



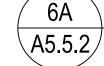


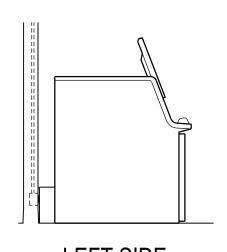


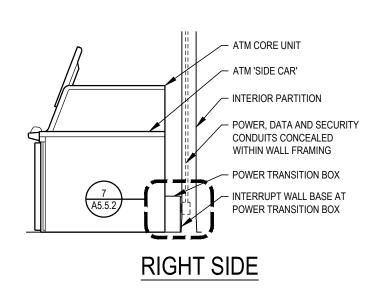

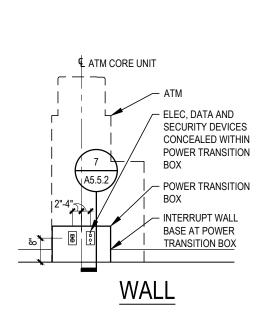

ELEC. JUNCTION BOX

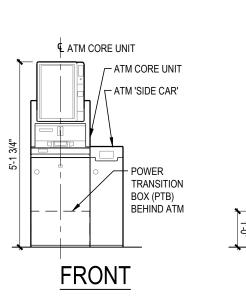


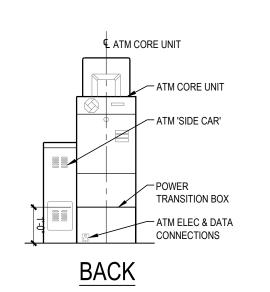





ATM v3.0 ELEVATIONS


A5.5.2 3/8" = 1'-0"

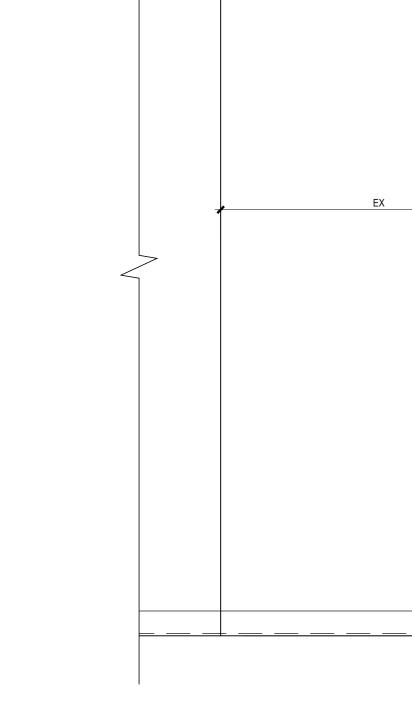

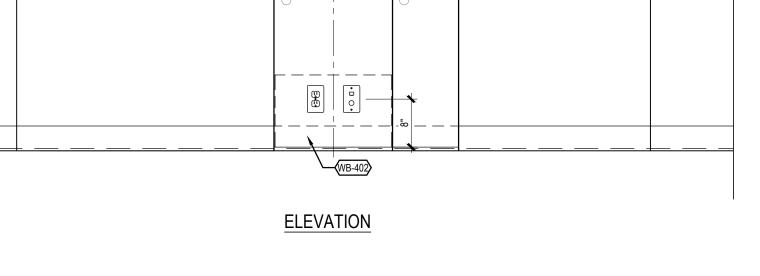


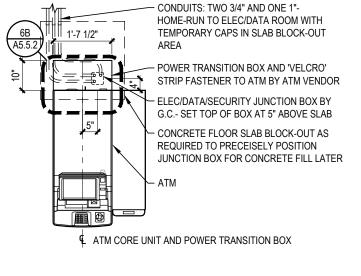



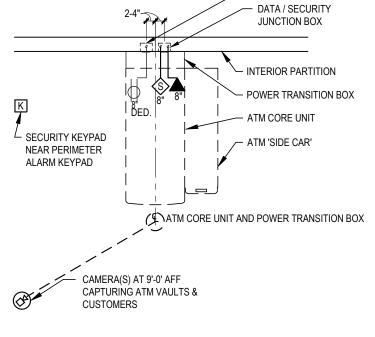



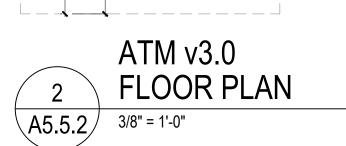

L ATM CORE UNIT AND POWER TRANSITION BOX

9 7/8" 9 7/8" CLEARAN
1'-7 11/16" 1'-1" 1'-7 3/4" 11 1/16" 1'-7 11/16"

2'-6 11/16"

A5.5.2

─ INT. PARTITION

 POWER TRANSITION BOX (PTB)- REFER TO

BANK EQUIPMENT SCHEDULE

BOLT ATM TO FLOOR

MANUFACTURER'S

- REQUIRED EQUIPMENT

CLEARANCE AREA

STRUCTURE PER


DIRECTION



GROUP 9 Galen Street Suite 117 Watertown, MA 02472 617.576.0007 core-states.com ARCHITECT OF RECORD JAMES T. LALLI, AIA, ARCHITECT LICENSE NO. 32254 THESE DRAWINGS ARE NOT COMPLETE WITHOUT THE SEPARATE TYPE WRITTEN SPECIFICATIONS MANUAL WHICH ARE PART OF THE CONTRACT DOCUMENTS. DESCRIPTION ISSUE DATE 2022.07.15 | PERMIT SET PROJECT INFORMATION PROJECT NO: JPM.27118 2022.07.13 PROTOTYPE: K.KELLY DRAWN BY: M.SIDES CHECKED BY: SSE_1.00 VERSION: SHEET TITLE **DETAILS:** ATM


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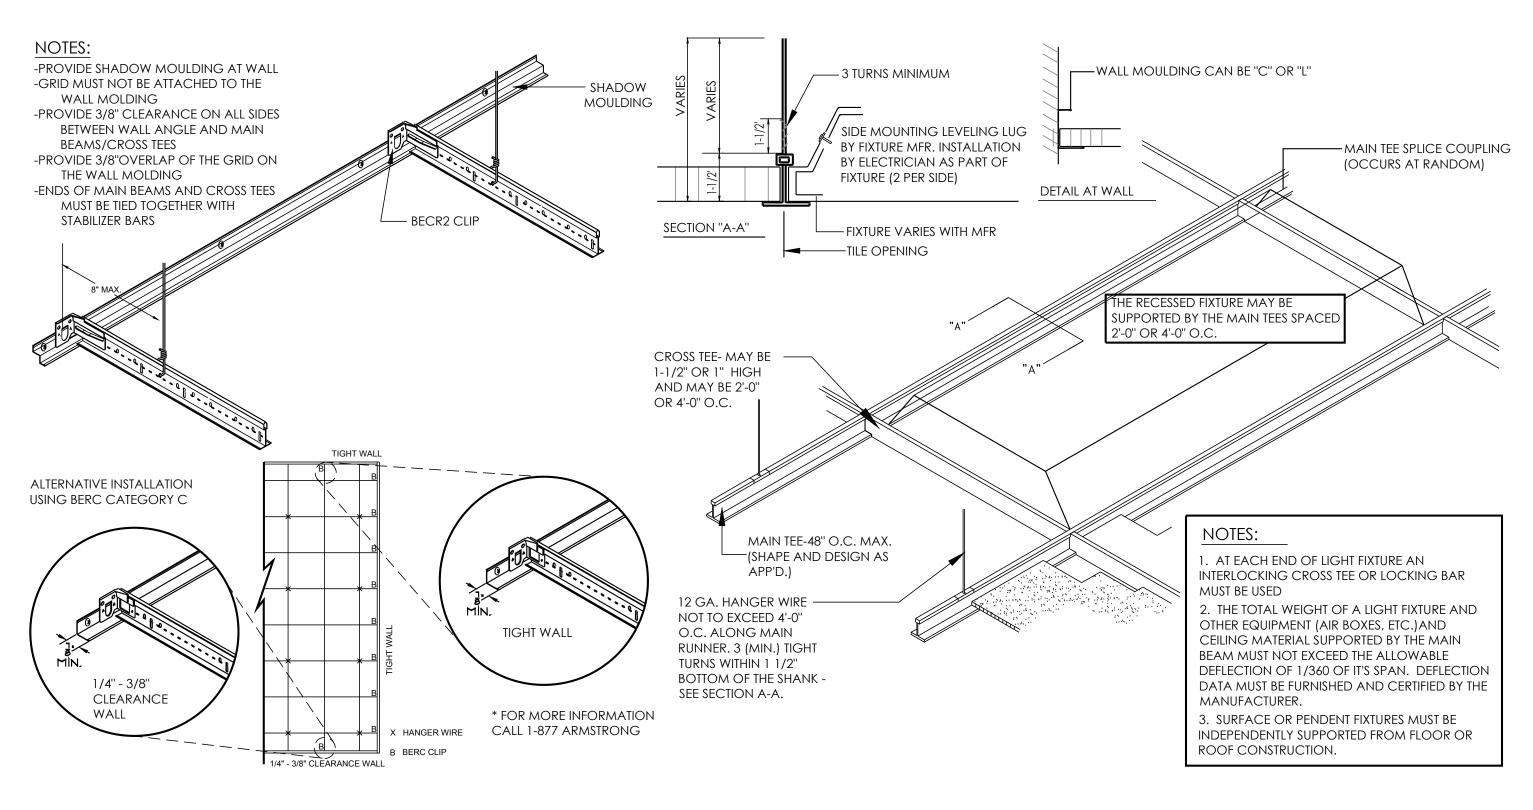
A5.5.2

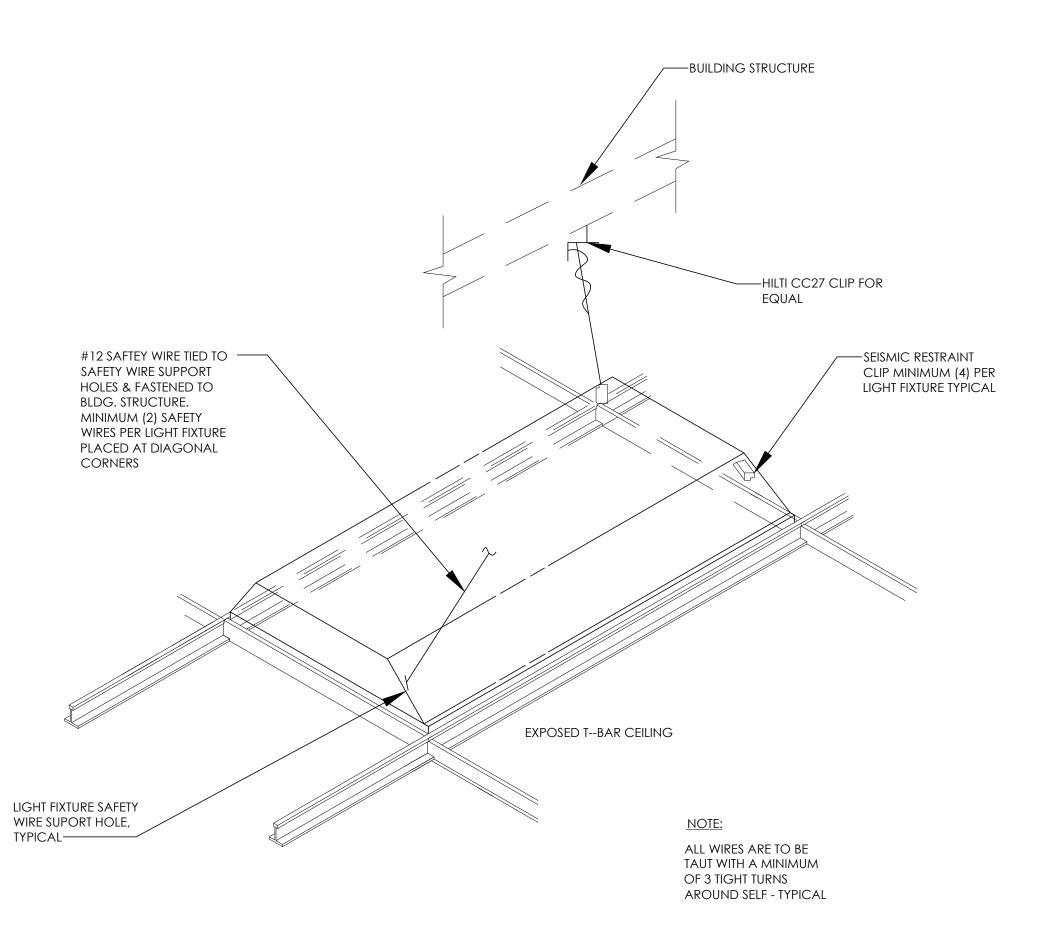

3 LIGHT FIXTURE DETAIL
A5.5.4 1/4" = 1'-0"

Utility Channel Created with Main Tees



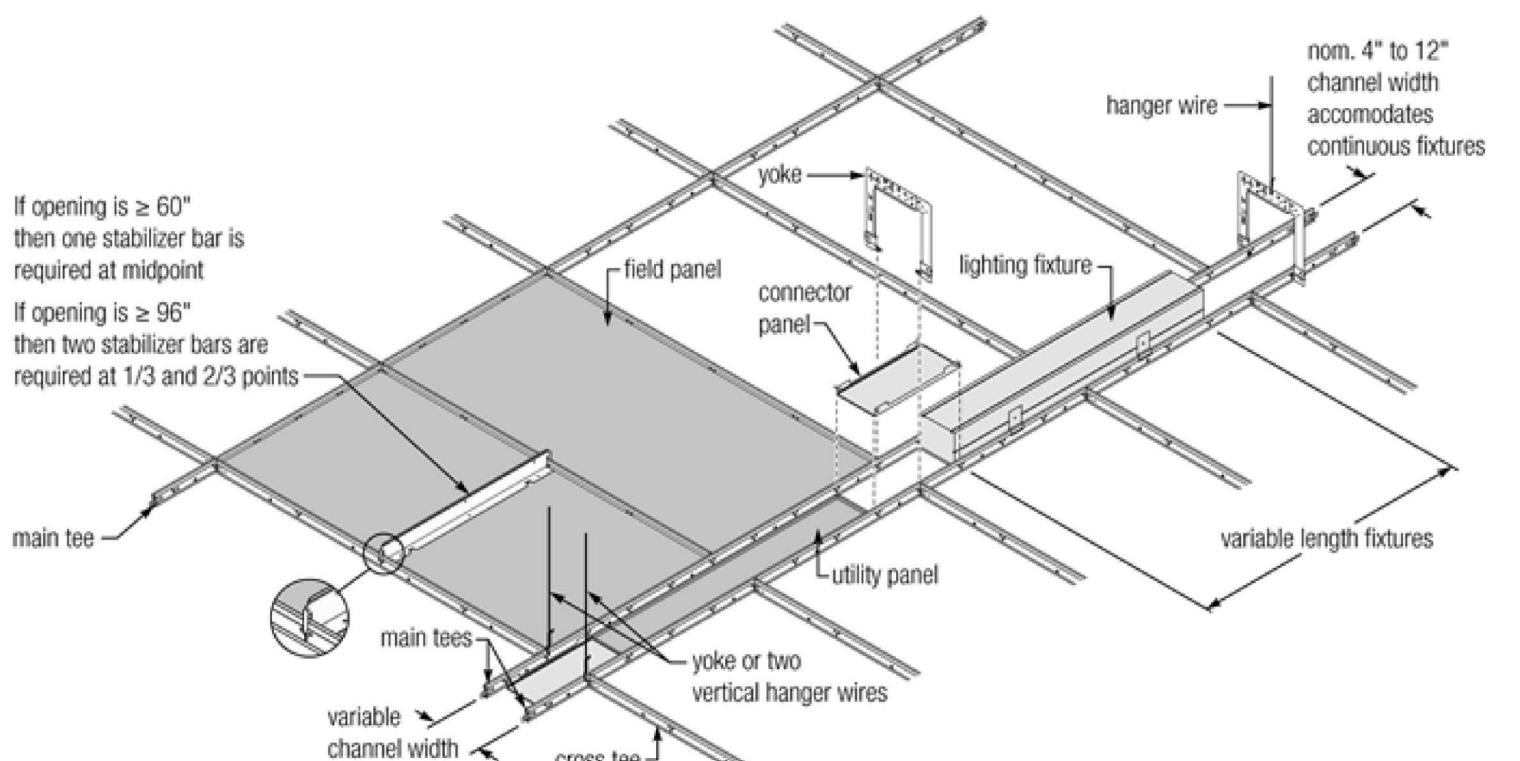

NOTES:

HANGER OR BRACING WIRE ANCHORS TO THE STRUCTURE SHOULD BE INSTALLED IN SUCH A MANNER THAT THE DIRECTION OF THE ANCHOR ALIGNS AS CLOSELY AS POSSIBLE WITH THE DIRECTION OF THE WIRE.

PENDANT LIGHT DETAILS

A5.5.4

3/4" = 1'-0"



THASE N.A.

JP MORGAN CHASE, N.A.

HARVARD SQUARE

9 JFK STRET

CAMBRIDGE, MA 02138

CLASE OXIGNOSCOL

GROUP

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Suite 117
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ARCHITECT OF RECORD

JAMES T. LALLI, AIA, ARCHITECT

LICENSE NO. 32254

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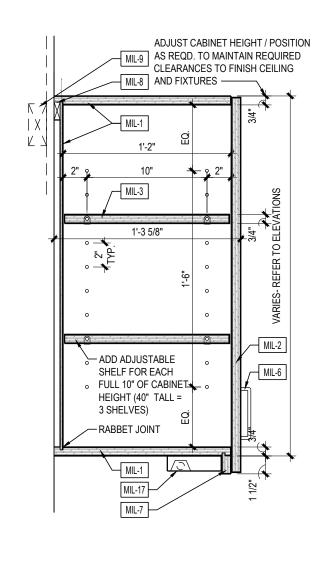
PROTOTYPE:20.3DRAWN BY:K.KELLYCHECKED BY:M.SIDESVERSION:SSE_1.00SHEET TITLE


DETAILS: CEILING


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A5.5.4

51







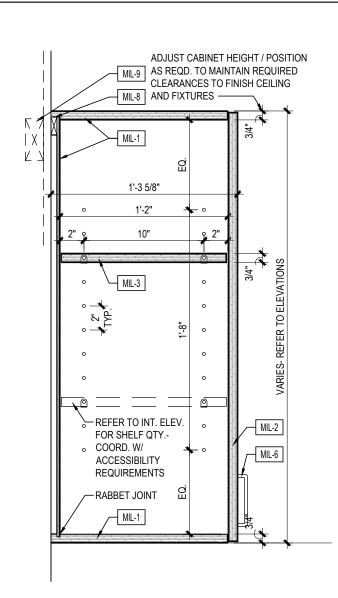


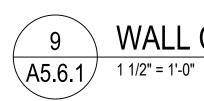
WALL CABINET W/ DOORS & LIGHT FIXTURE




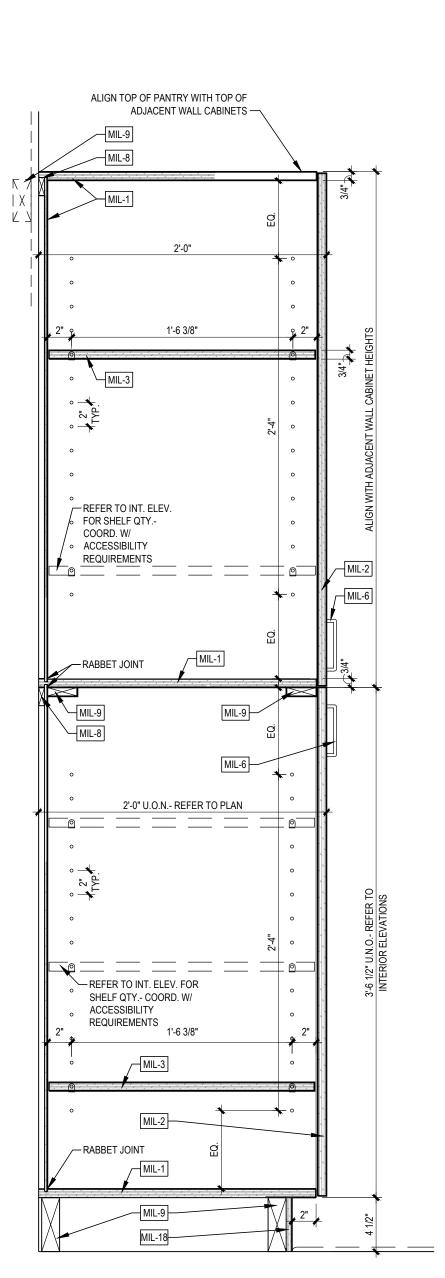


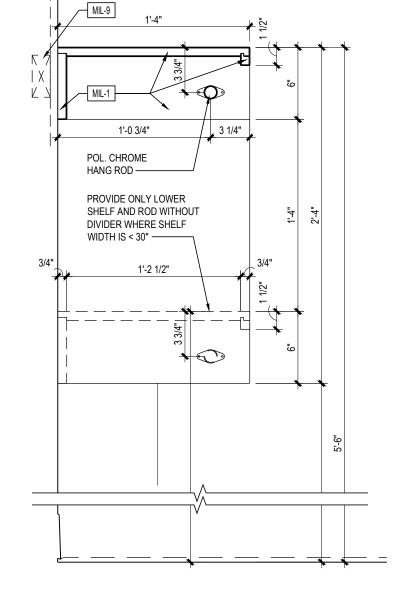


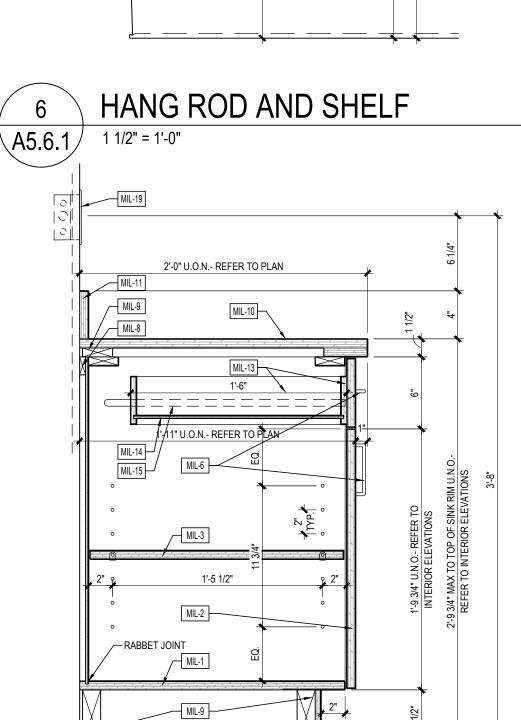

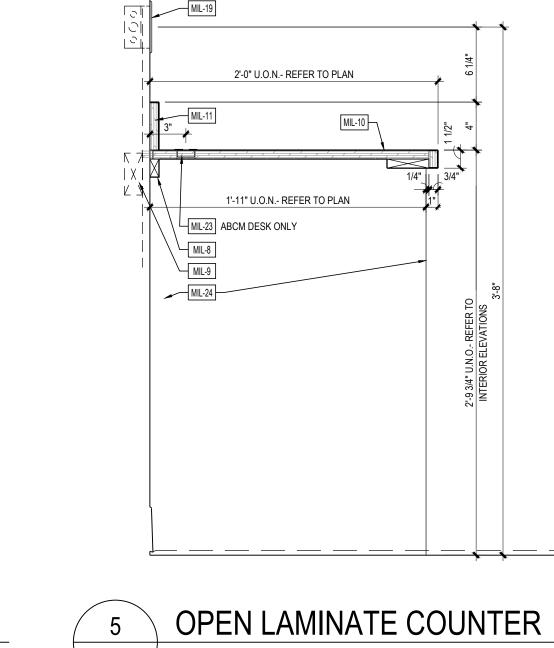

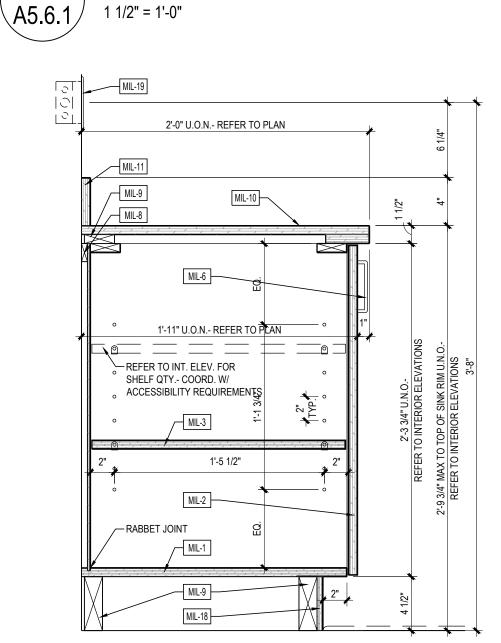

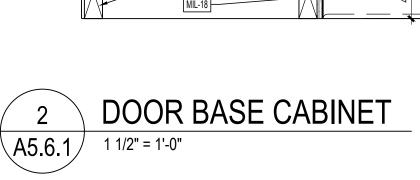

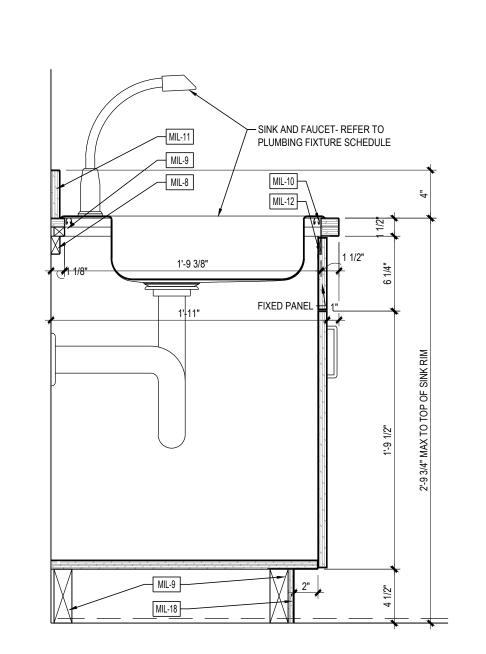

STANDARD SINK BASE SINK BASE CABINET

	CUSTOM CABINET NOTES]	
	P DRAWINGS AND MATERIALS TO ARCHITECT OF RECORD FOR REVIEW AND	_	
	RIOR TO FABRICATION	-	
	TERIOR FINISH MATERIALS SCHEDULE FOR LAMINATE SPECIFICATIONS	_	
MIL-1	CABINET TOP / BOTTOM / SIDE PANEL: 3/4" PLASTIC LAMINATE MDF ALL EXPOSED SURFACES - INTERIOR SURFACES WHITE MELAMINE		
MIL-2	CABINET DOOR: 3/4" PLASTIC LAMINATE MDF ALL 6 FACES		
MIL-3	ADJUSTABLE SHELF: 3/4" PLASTIC LAMINATE MDF ALL 6 FACES - PROVIDE FOUR 5MM NICKEL-PLATED SPOON-SHAPED PINS EACH SHELF-DRILL 5MM HOLES IN CABINET SIDE PANELS AS NOTED		
MIL-4	CABINET BACK: 1/4" PLASTIC LAMINATE MDF EXPOSED FACE]	
MIL-5	SURFACE-MOUNT ELECTRICAL / DATA RACEWAY		
MIL-6	WIRE PULL		
MIL-7	LIGHT VALENCE: 3/4" PLASTIC LAMINATE MDF EXPOSED FACES]	4
MIL-8	CONTINUOUS WOOD CLEAT: SIZE AS REQUIRED-PAINT TO MATCH ADJACENT WALL SURFACE		
MIL-9	WOOD BLOCKING AS REQUIRED		_
MIL-10	COUNTER TOP: REFER TO INTERIOR FINISH MATERIALS SCHEDULE		
MIL-11	COUNTER SPLASH: MATCH COUNTER TOP MATERIAL		Ш
MIL-12	COUNTER APRON: MATCH COUNTER TOP MATERIAL		A S A
MIL-13	DRAWER BACK / SIDE / SUB-FRONT: 1/2" WHITE MELAMINE MDF] • - 4	⋖
MIL-14	DRAWER BOTTOM: 1/4" WHITE MELAMINE MDF		
MIL-15	DRAWER SLIDE: FULL-EXTENSION BALL-BEARING		
MIL-16	COUNTER EDGE SUPPORT: CONT. STEEL ANGLE BOLTED TO SOLID WOOD BLOCKING CONCEALED WITHIN WALLS- RE-PRIME FOLLOWING INSTALLATION		
MIL-17	SCHEDULED LIGHT FIXTURE		_
MIL-18	TOE-KICK: 1/2" MINIMUM PLASTIC LAMINATE MDF- COLOR AND PATTERN TO MATCH CABINET PANELS		
MIL-19	ELECTRICAL / DATA ROUGH-IN AND COVER PLATE		7
MIL-20	SINK APRON: 3/4" PLASTIC LAMINATE MDF		('
MIL-21	COUNTER EQUIPMENT SUPPORT: 1 1/2" x 1 1/2" x 1/4" STEEL ANGLE BOLTED TO CABINET BACK, SIDES AND APRON - PRIME AND PAINT TO MATCH CABINET COLOR)R(
MIL-22	GROMMET: MOCKET #BRKIT 12" BLACK LINEAR BRUSH GROMMET		
MIL-23	GROMMET: MOCKET #BG 1 1/2" ROUND BLACK PLASTIC GROMMET		~
MIL-24	COUNTER SUPPORT: 3/4" THICK PLASTIC LAMINATE MDF PANEL MATCHING COUNTER DEPTH- QUANTITY AND POSITIONS AS REQUIRED TO ENSURE MAX. COUNTER DEFLECTION OF L/768 (1/8" OVER 8')		<i>∠</i>
MIL-25	CABINET TOP / BOTTOM / SIDE / DOOR PANEL: 3/4" PLASTIC LAMINATE MDF ALL SURFACES EXPOSED TO VIEW, INCLUDING INTERIOR- REFER TO INTERIOR FINISH SCHEDULE FOR LAMINATE SPECIFICATION		
MIL-26	SOLID SURFACE COUNTER: 2" BUILT-UP FRONT EDGES, OPENINGS, AND VERTICAL PANELS, ALL CONTACT EDGES EASED- REFER TO INTERIOR FINISH SCHEDULE FOR MATERIAL SPECIFICATION	COR	E
MIL-27	REFUSE CAN TRAY, 36-QT PLASTIC CAN, AND DRAWER GLIDES ATTACHED TO CABINET BOTTOM AND DRAWER PANELS		
MIL-28	OPEN COUNTER SUPPORT BRACKET: CENTERLINE BRACKETS #CSA-004-20, COLOR WHITE- 24" MAX. O.C CUT MINIMAL OPENING IN WALL FINISH AS REQD, LAG-SCREW TO WALL STUDS OR BLOCKING- PATCH WALL FINISH OPENING	9 Galen Street Suite 117	/
MIL-29	ELECTRICAL / DATA OUTLETS: COORD. WITH ELECTRICIAN TO PROVIDE MUD RING OF SUFFICIENT DEPTH TO REACH CABINET BACK- INSTALL OVER PLATES OVER CABINET BACK	Watertown, MA 0247 617.576.0007 core-states.com	
MIL-30	CONTINUOUS COUNTER UNDERLAYMENT: 3/4" PLYWOOD- PROVIDE WHITE PLASTIC LAMINATE FACE AT UNDERSIDE OF OPEN COUNTER SECTIONS	ANCHILLETON	KLCOK
MIL-31	STOP: 1/2" x 3/4" EASED-EDGE PAINT GRADE-WOOD]	
MIL-32	CABINET PULL: AMEROCK #BP55364G10 'RIVA' IN SATIN NICKEL, 3" CTC]	
MIL-33	HARDWOOD FIN: 1" x 3 1/2" AND 2" x 9 1/4" SOLID AND VENEER NATURAL RED OAK FOR STAIN AND CLEAR FINISH- REFER TO FINISH MATERIALS SCHEDULE- MITER CORNERS OF ASSEMBLIES TO CONCEAL JOINTS		
MIL-34	PAINTED CABINET BACK: 1/2" MDF FOR PAINT FINISH- REFER TO FINISH MATERIAL SHEDULE FOR PAINT SPECIFICATIONS		
MIL 25	FINEDLINTLE COLID DED CAR FOR CTAIN AND CLEAR FINICILIDED MATERIAL C	1 I	

FIN PLINTH: SOLID RED OAK FOR STAIN AND CLEAR FINISH PER MATERIALS FINISH SCHEDULE- APPLY FACE BOARD WITH MINIMAL FINISH NAILS TO

FACE-FRAME CABINET SIDE PANEL: EXTENDED 3/4" PLASTIC LAMINATE MDF

CABINET SIDE PANEL AND FACE ALIGNED WITH HARDWOOD FIN ABOVE

MIL-36 SACRIFICIAL BASE: 1/2" x 4" SOLID RED OAK FOR STAIN AND CLEAR FINISH-

REFUSE OPENING: 4" DIAM. HOLE WITH 2" BUILT-UP EASED EDGE

MIL-39 FIXED DRAWER SHELF: PLASTIC LAMINATE

GC TO PROVIDE GROMMETS TO BE FIELD-LOCATED BY CHASE BRANCH BANK STAFF AND INSTALLED BY GC AT TURNOVER.

(2) - DOUG MOCKETT OG3 - 1" WHITE AT MANUAL TRANSACTION

(2) - DOUG MOCKETT AG SERIES - 3/4" WHITE AT MANUAL

GROMMET NOTES

TRANSACTION MILLWORK.

(6) - DOUG MOCKETT BG3 1-1/2" WHITE (6) - DOUG MOCKETT BG3 1-1/2" BLACK

MÍLLWORK.

APPLY WITH MINIMAL FINISH NAILS TO FACILITATE REPLACEMENT

JAMES T. LALLI, AIA, ARCHITECT LICENSE NO. 32254

GROUP

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ISSUE DATE DESCRIPTION 2022.07.15 PERMIT SET

PROJECT NO:	JPM.271
DATE:	2022.07
PROTOTYPE:	2
DRAWN BY:	K.KEI
CHECKED BY:	M.SIE
VERSION:	SSE_1
ET TITLE	_

PROJECT INFORMATION

DETAILS: CABINETRY

SHEET NUMBER

A5.6.1

√A5.6.1


PANTRY 1 1/2" = 1'-0"

\A5.6.1


DOOR / DRAWER BASE CABINET 1 1/2" = 1'-0"

\A5.6.1/




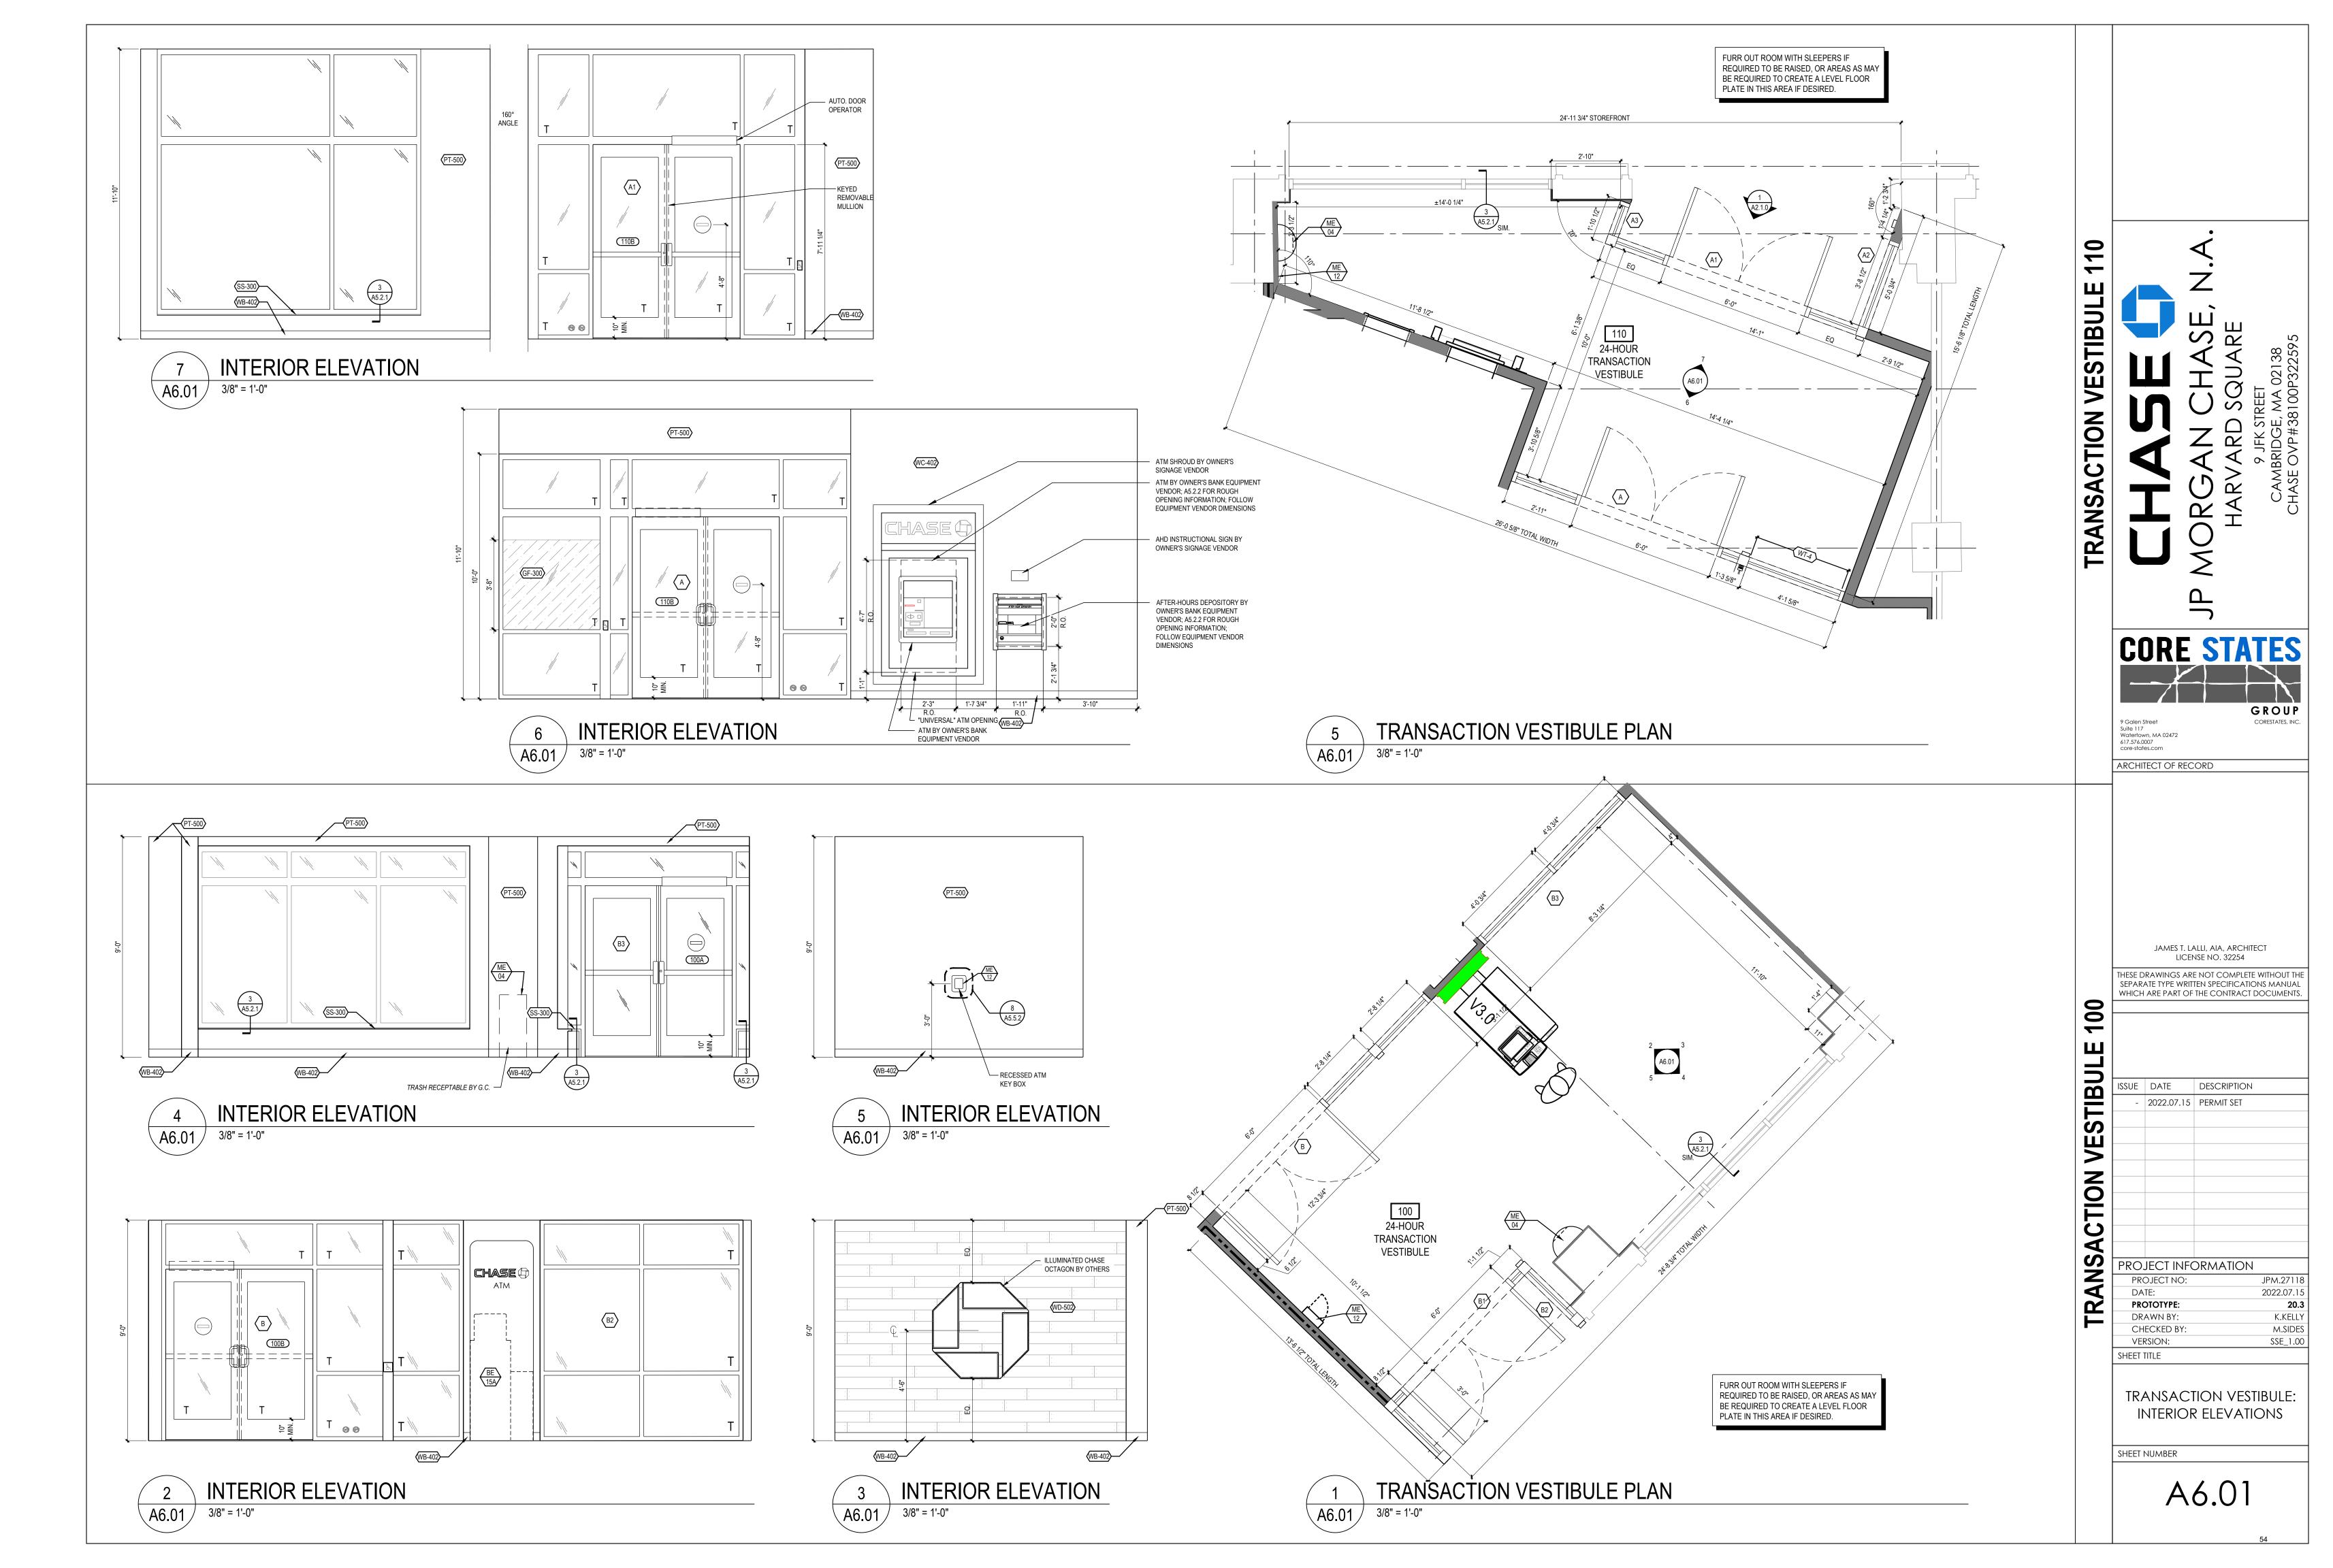


P:\J.P. Margan Chase\Cambridge, MA (Havard Square - 11 JFK Street) #38100P322595 -JPM.27118\ Monday, July 18, 2022 8:18:56 PM

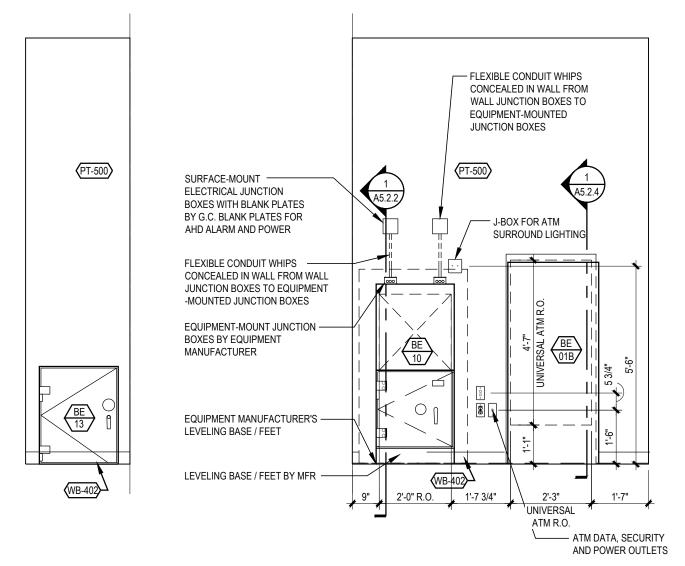


3 INTERIOR ELEVATION
A6.02 3/8" = 1'-0"

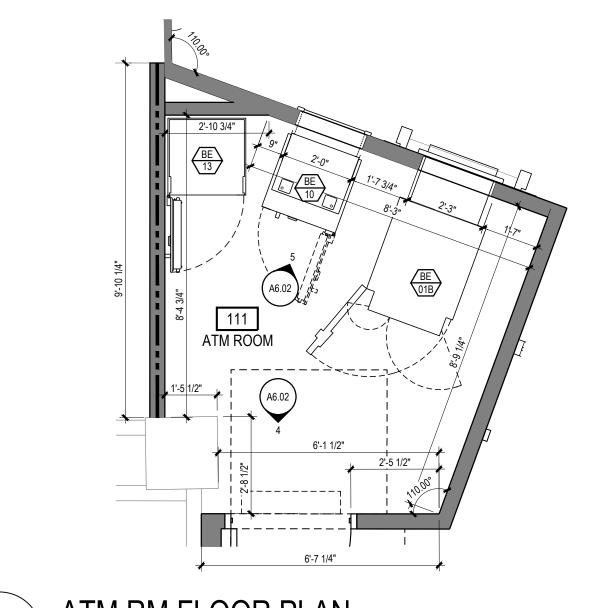

1B ATM RM FLOOR PLAN
A6.02 3/8" = 1'-0"

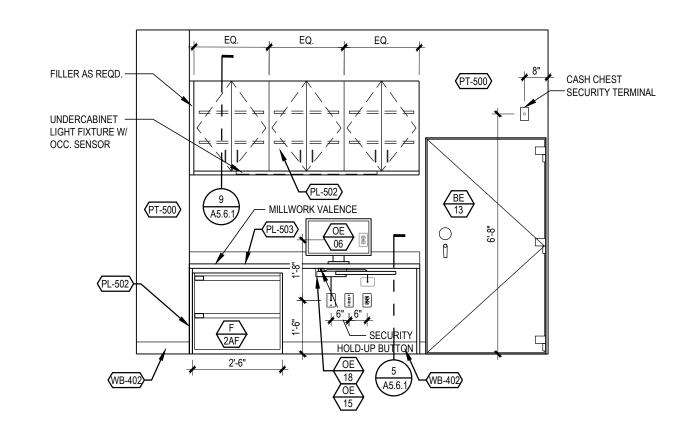



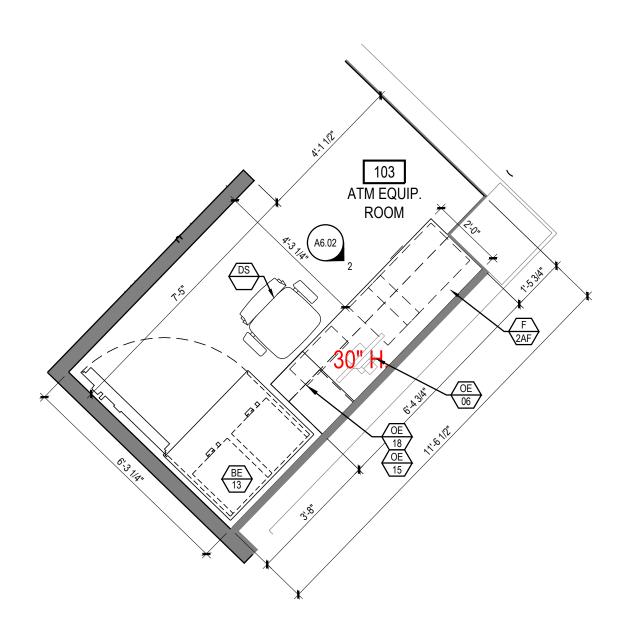

1A CASH & ATM EQUIP. RM FLOOR PLAN
A6.02 3/8" = 1'-0"

JP MORGAN CHASE, NARVARD SQUARE

9 JFK STREET

9 JFK STREET

ROOM

ASH ROOM

JAMES T. LALLI, AIA, ARCHITECT LICENSE NO. 32254

ARCHITECT OF RECORD

GROUP

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ISSUE DATE DESCRIPTION

- 2022.07.15 PERMIT SET

PROJECT INFORMATION

PROJECT NO: JPM.27118

DATE: 2022.07.15

PROTOTYPE: 20.3

DRAWN BY: K.KELLY

CHECKED BY: M.SIDES


VERSION: SSE_1.00

CASH / ATM EQUIP ROOM : ENLARGED PLANS AND INTERIOR ELEVATIONS

SHEET NUMBER

SHEET TITLE

A6.02

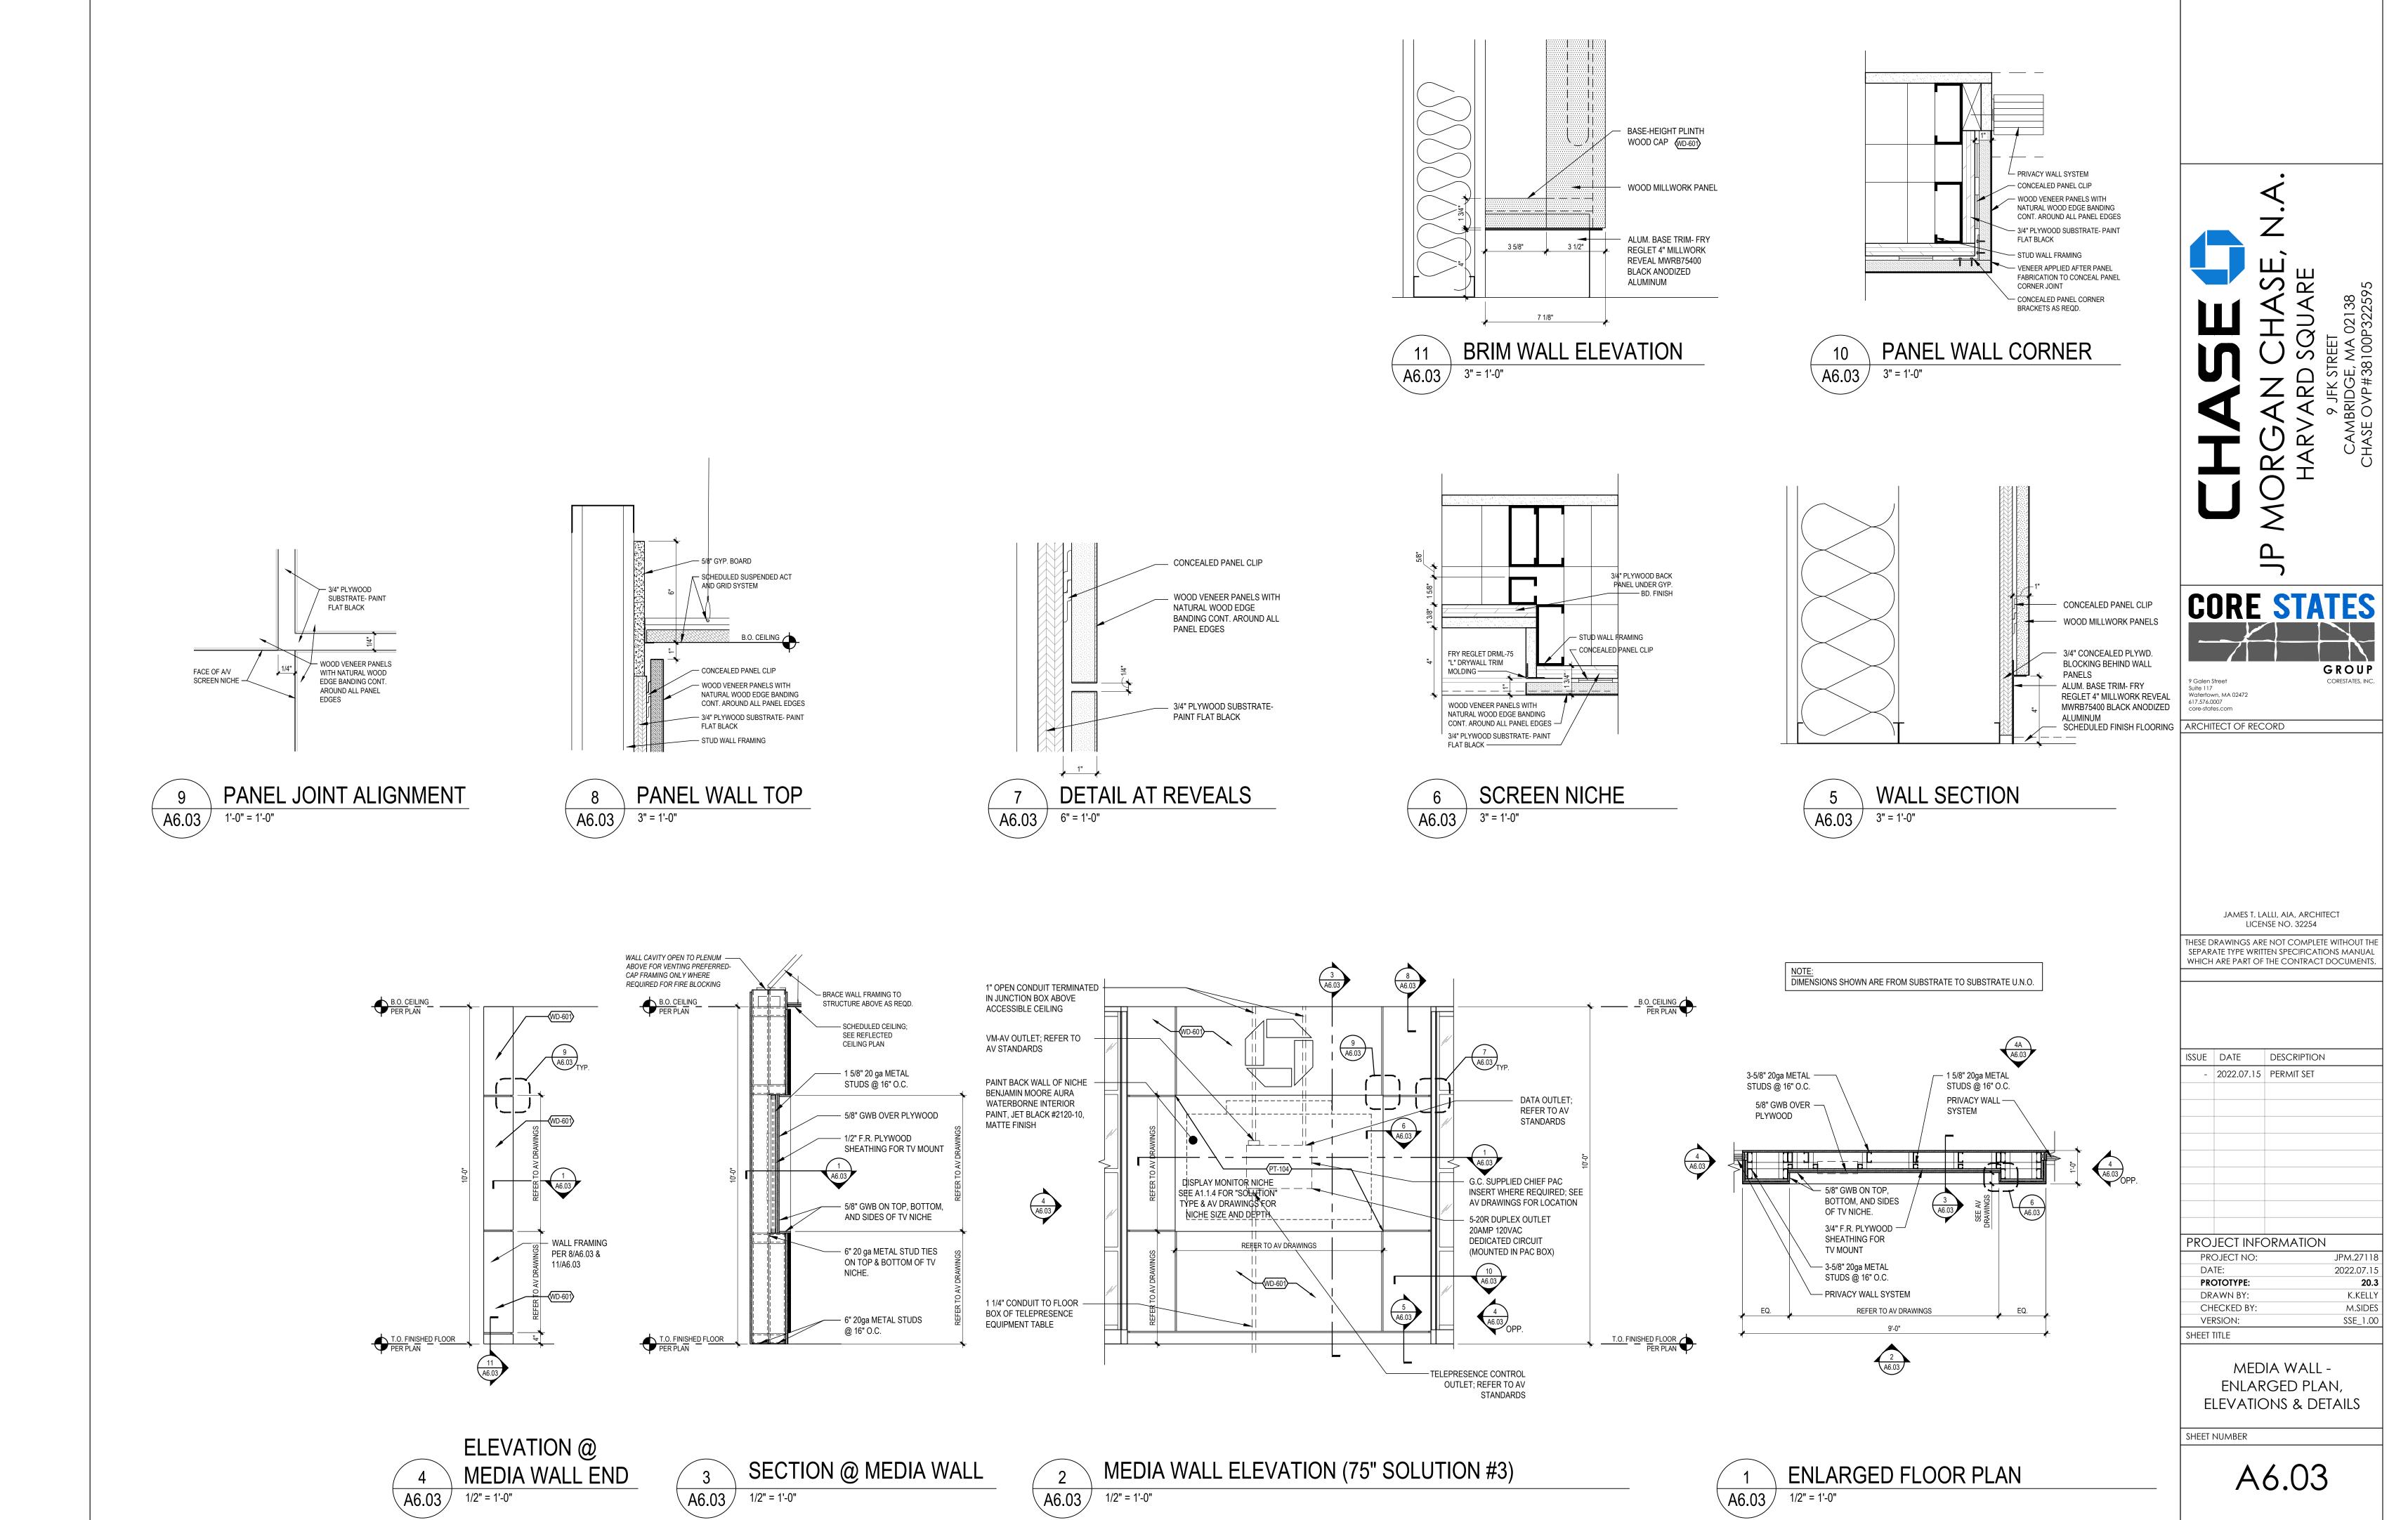


P:\J.P. Morgan Chase\Cambridge, MA (Havard Square - 11 JFK Street) #38100P322595 -JPM.27118\AMEPS_Drawings\A603_C Thursday, July 14, 2022 11:38:59 AM


PROVIDE 1" CONDUIT TO JUNCTION BOX ABOVE ACCESSIBLE CEILING

18"x18"x34" PLYWOOD BACKING DRYWALL
CHIEF FSR1U WALL MOUNT (BY CHASE VENDOR)

1 GANG BACK BOX BY GC, DATA JACKS W/ DEVICE BY OWNER
BLACK RECESSED DUPLEX OUTLET

DIGITAL DISPLAY

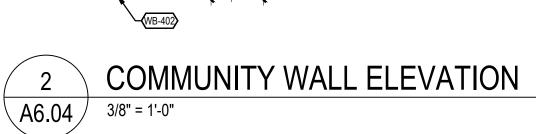

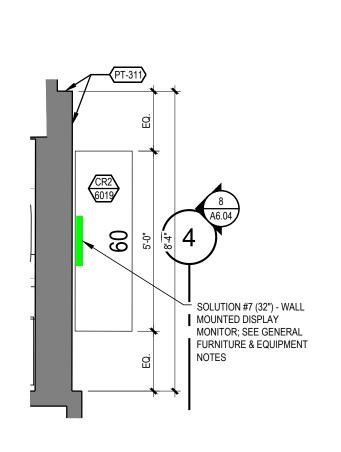







7.KGIMEGI GI KEGGKB

JAMES T. LALLI, AIA, ARCHITECT LICENSE NO. 32254

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DATE	DESCRIPTION
2022.07.15	PERMIT SET

PRO.	JECT INFO	ORMATION	
PRO	DJECT NO:		JPM.27118
DA	TE:		2021.07.15
PRC	OTOTYPE:		20.3
DR	AWN BY:		K.KELLY
СН	ECKED BY:		M.SIDES
VEF	rsion:		SSE_1.00
SHEET 1	TITLE		


CAFE AND BOOTH: ENLARGED PLANS, ELEVATIONS, AND DETAILS

SHEET NUMBER

A6.04

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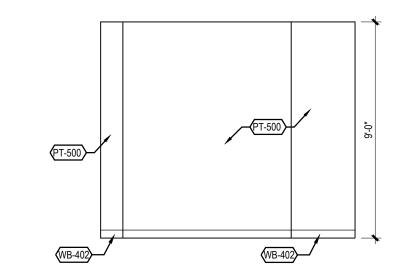
57

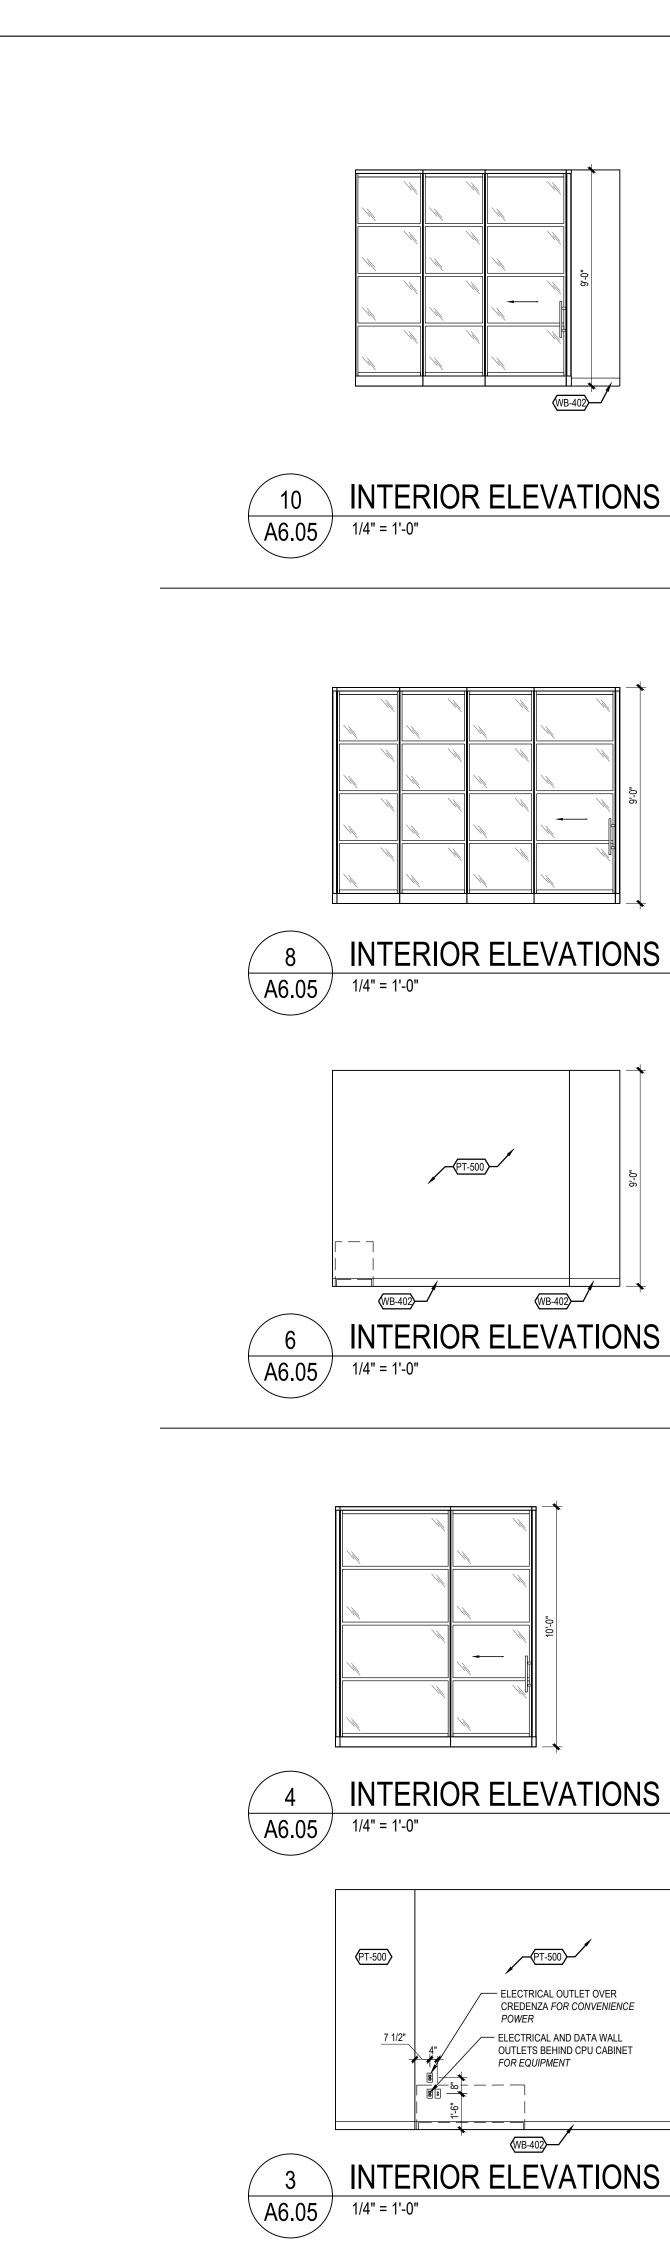


WB-402

— ELECTRICAL OUTLET OVER CREDENZA FOR CONVENIENCE


ELECTRICAL AND DATA WALL
OUTLETS BEHIND CPU CABINET
FOR EQUIPMENT






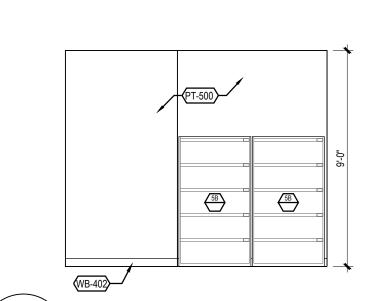




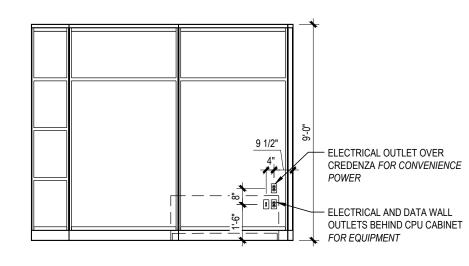

INTERIOR ELEVATIONS A6.05 1/4" = 1'-0"

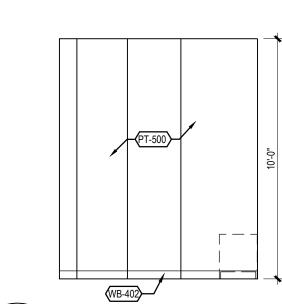

INTERIOR ELEVATIONS A6.05 1/4" = 1'-0"

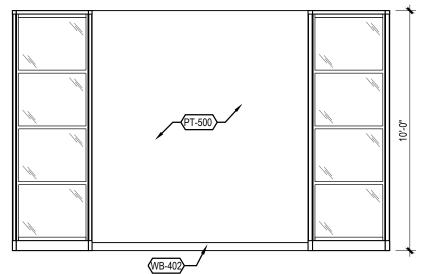

1	INTERIOR ELEVATIONS
A6.05	1/4" = 1'-0"

PRIVATE CONSULTATION SPACE (PCS) #123 (PCS) #122 CONSULTATION ARCHITECT OF RECORD

JAMES T. LALLI, AIA, ARCHITECT LICENSE NO. 32254

PRIVATE

GROUP

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S	ISSUE	DATE	DESCRIPTION			
Ü	-	2022.07.15	PERMIT SET			
(PCS)						
Щ						
A				_		
SPACE				_		
S						
Z				_		
	DDO					
	PROJECT INFORMATION					
		OJECT NO:	JPM.27			
	DA		2022.07			
		OTOTYPE:		20		
	DR.	AWN BY:	K.KE	LI		
	СН	ECKED BY:	M.SII			
<u> </u>	VEI	rsion:	SSE_1).		
Z	SHEET	TITLE				
CONSULTATION	DDI	· / A TE CO				


PROJE			
PROJECT NO:			JPM.271
DATE:			2022.07.
PROTOTYPE:			20
DRAWN BY:			K.KEL
CHECKED BY:			M.SIDI
VERSI	SSE_1.0		

PRIVATE CONSULATION SPACE: INTERIOR ELEVATIONS


SHEET NUMBER


PRIVATE

A6.05

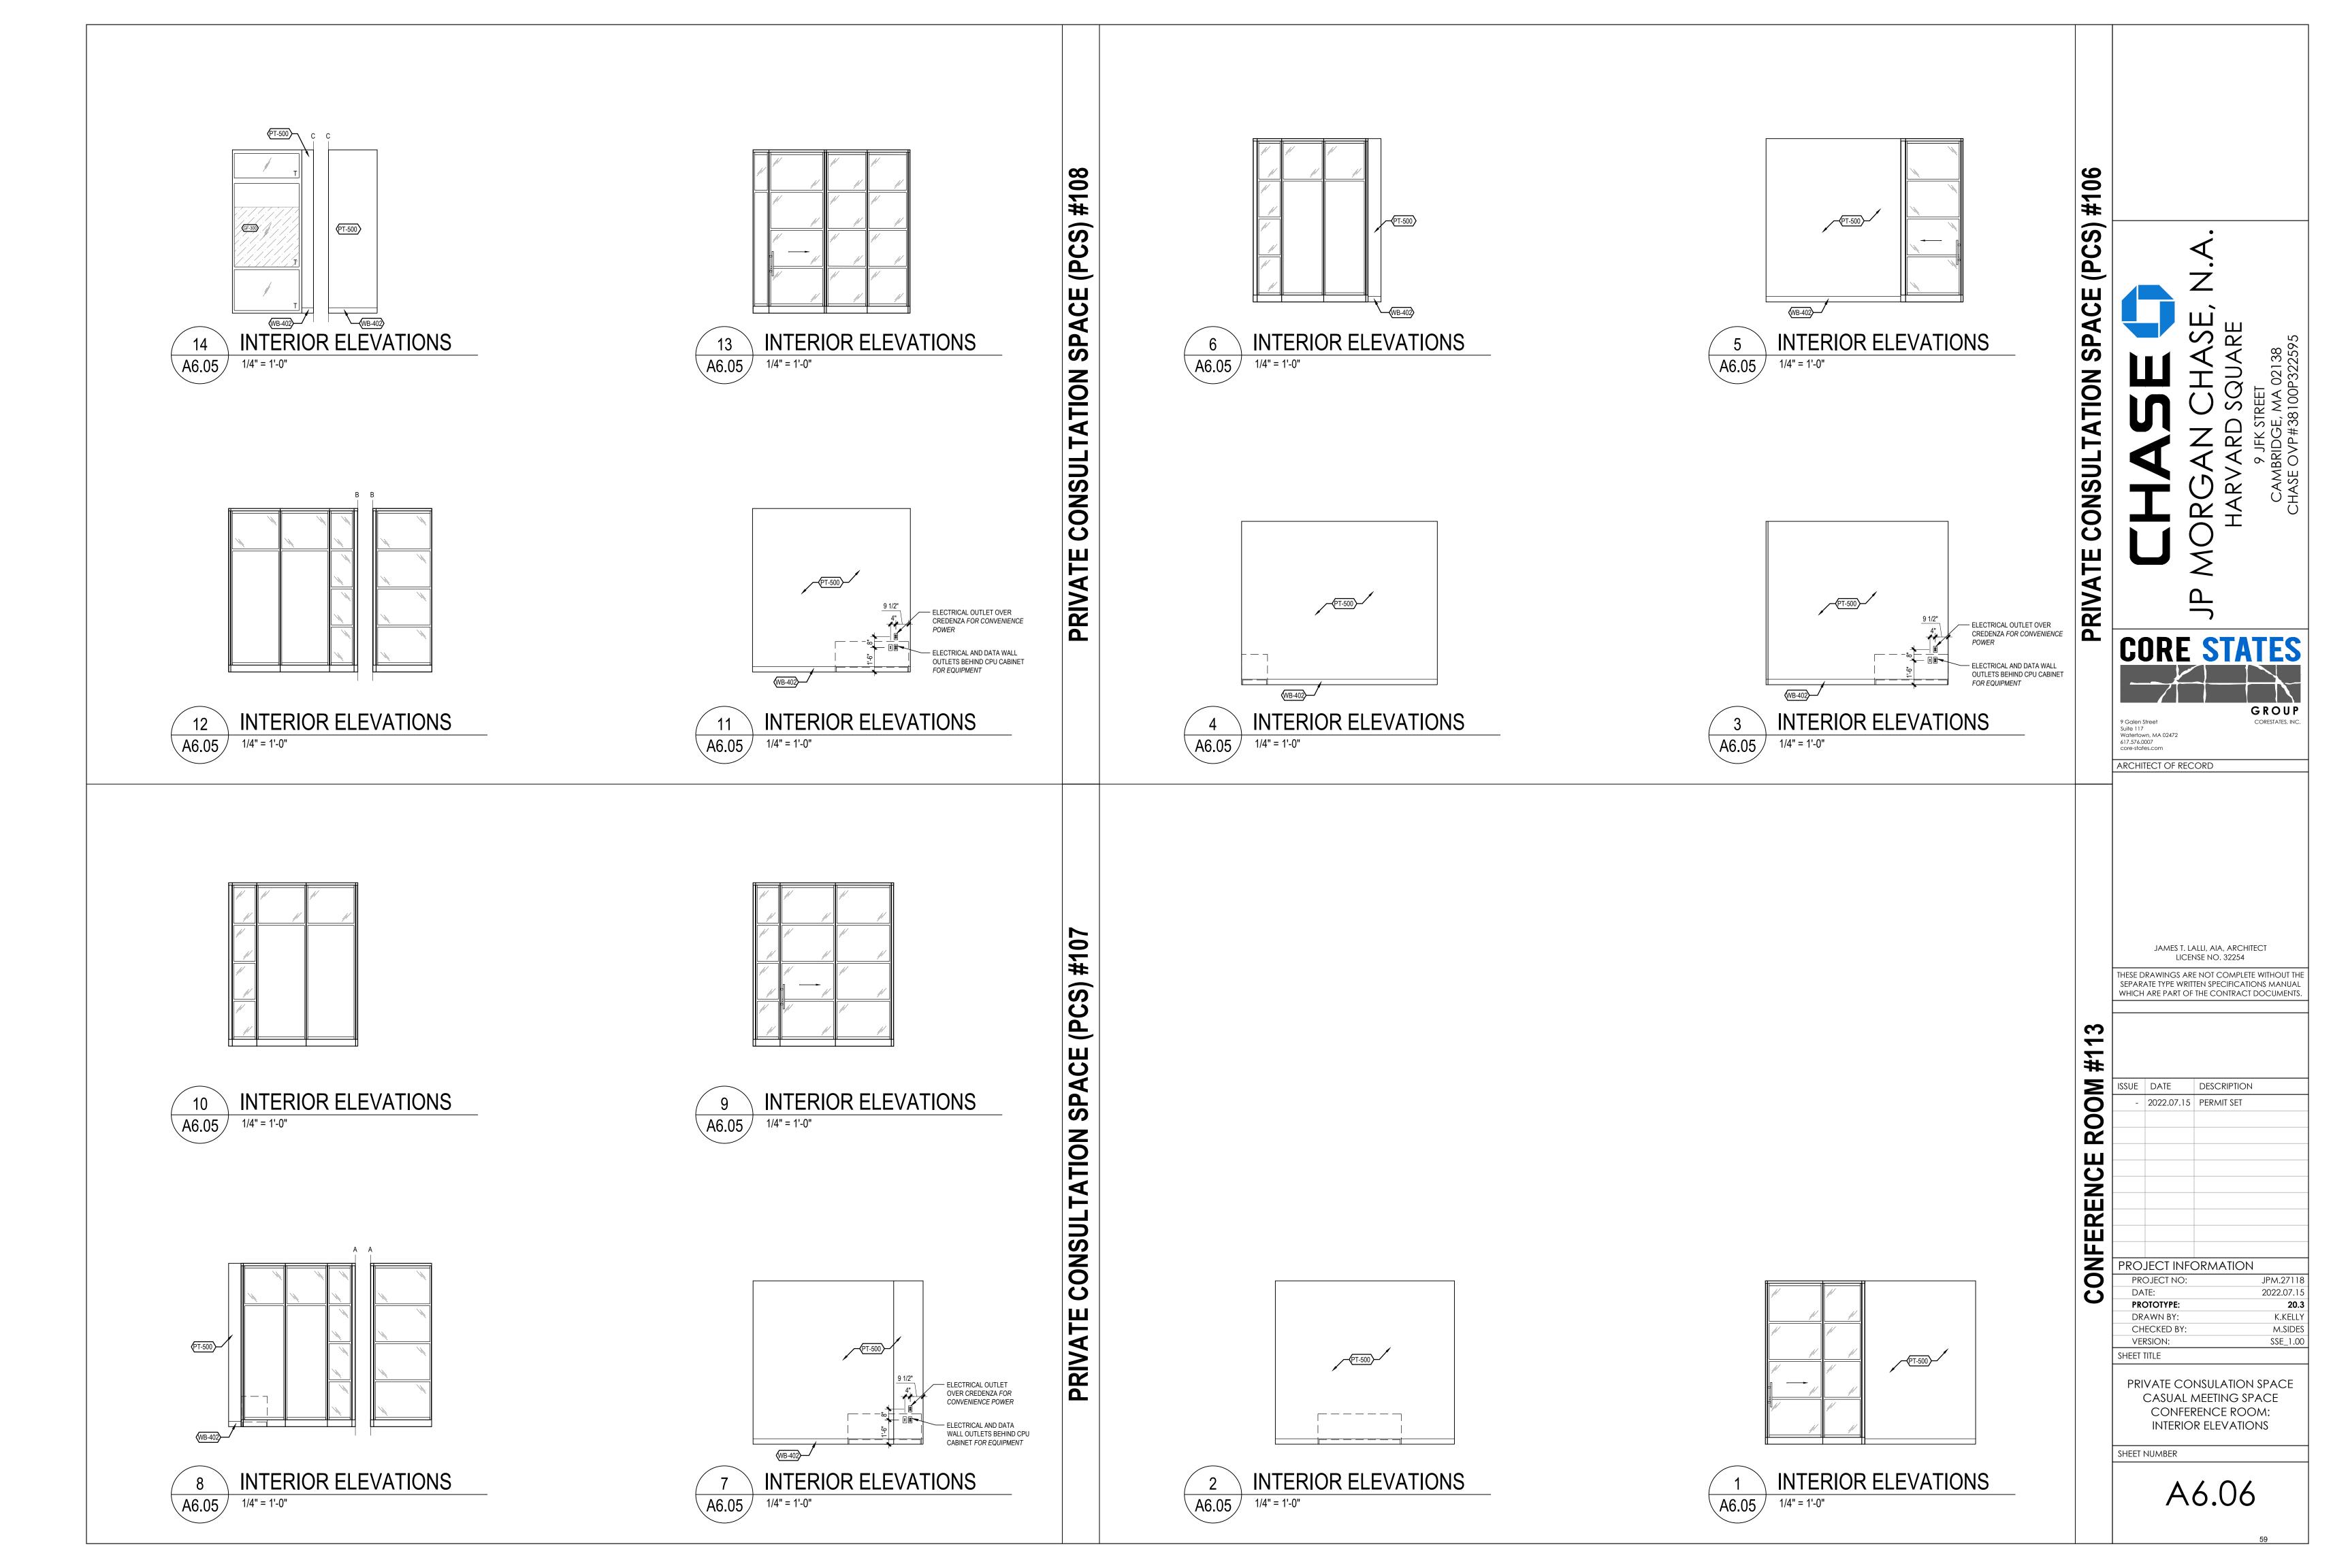


P:\J.P. Margan Chase\Cambridge, MA (Havard Square - 11 JFK Street) #38100P322595 -JPM.27118\AMEPS_Drawings\A606_Cambridge MA (Harvard Square - 11 JFK Stre

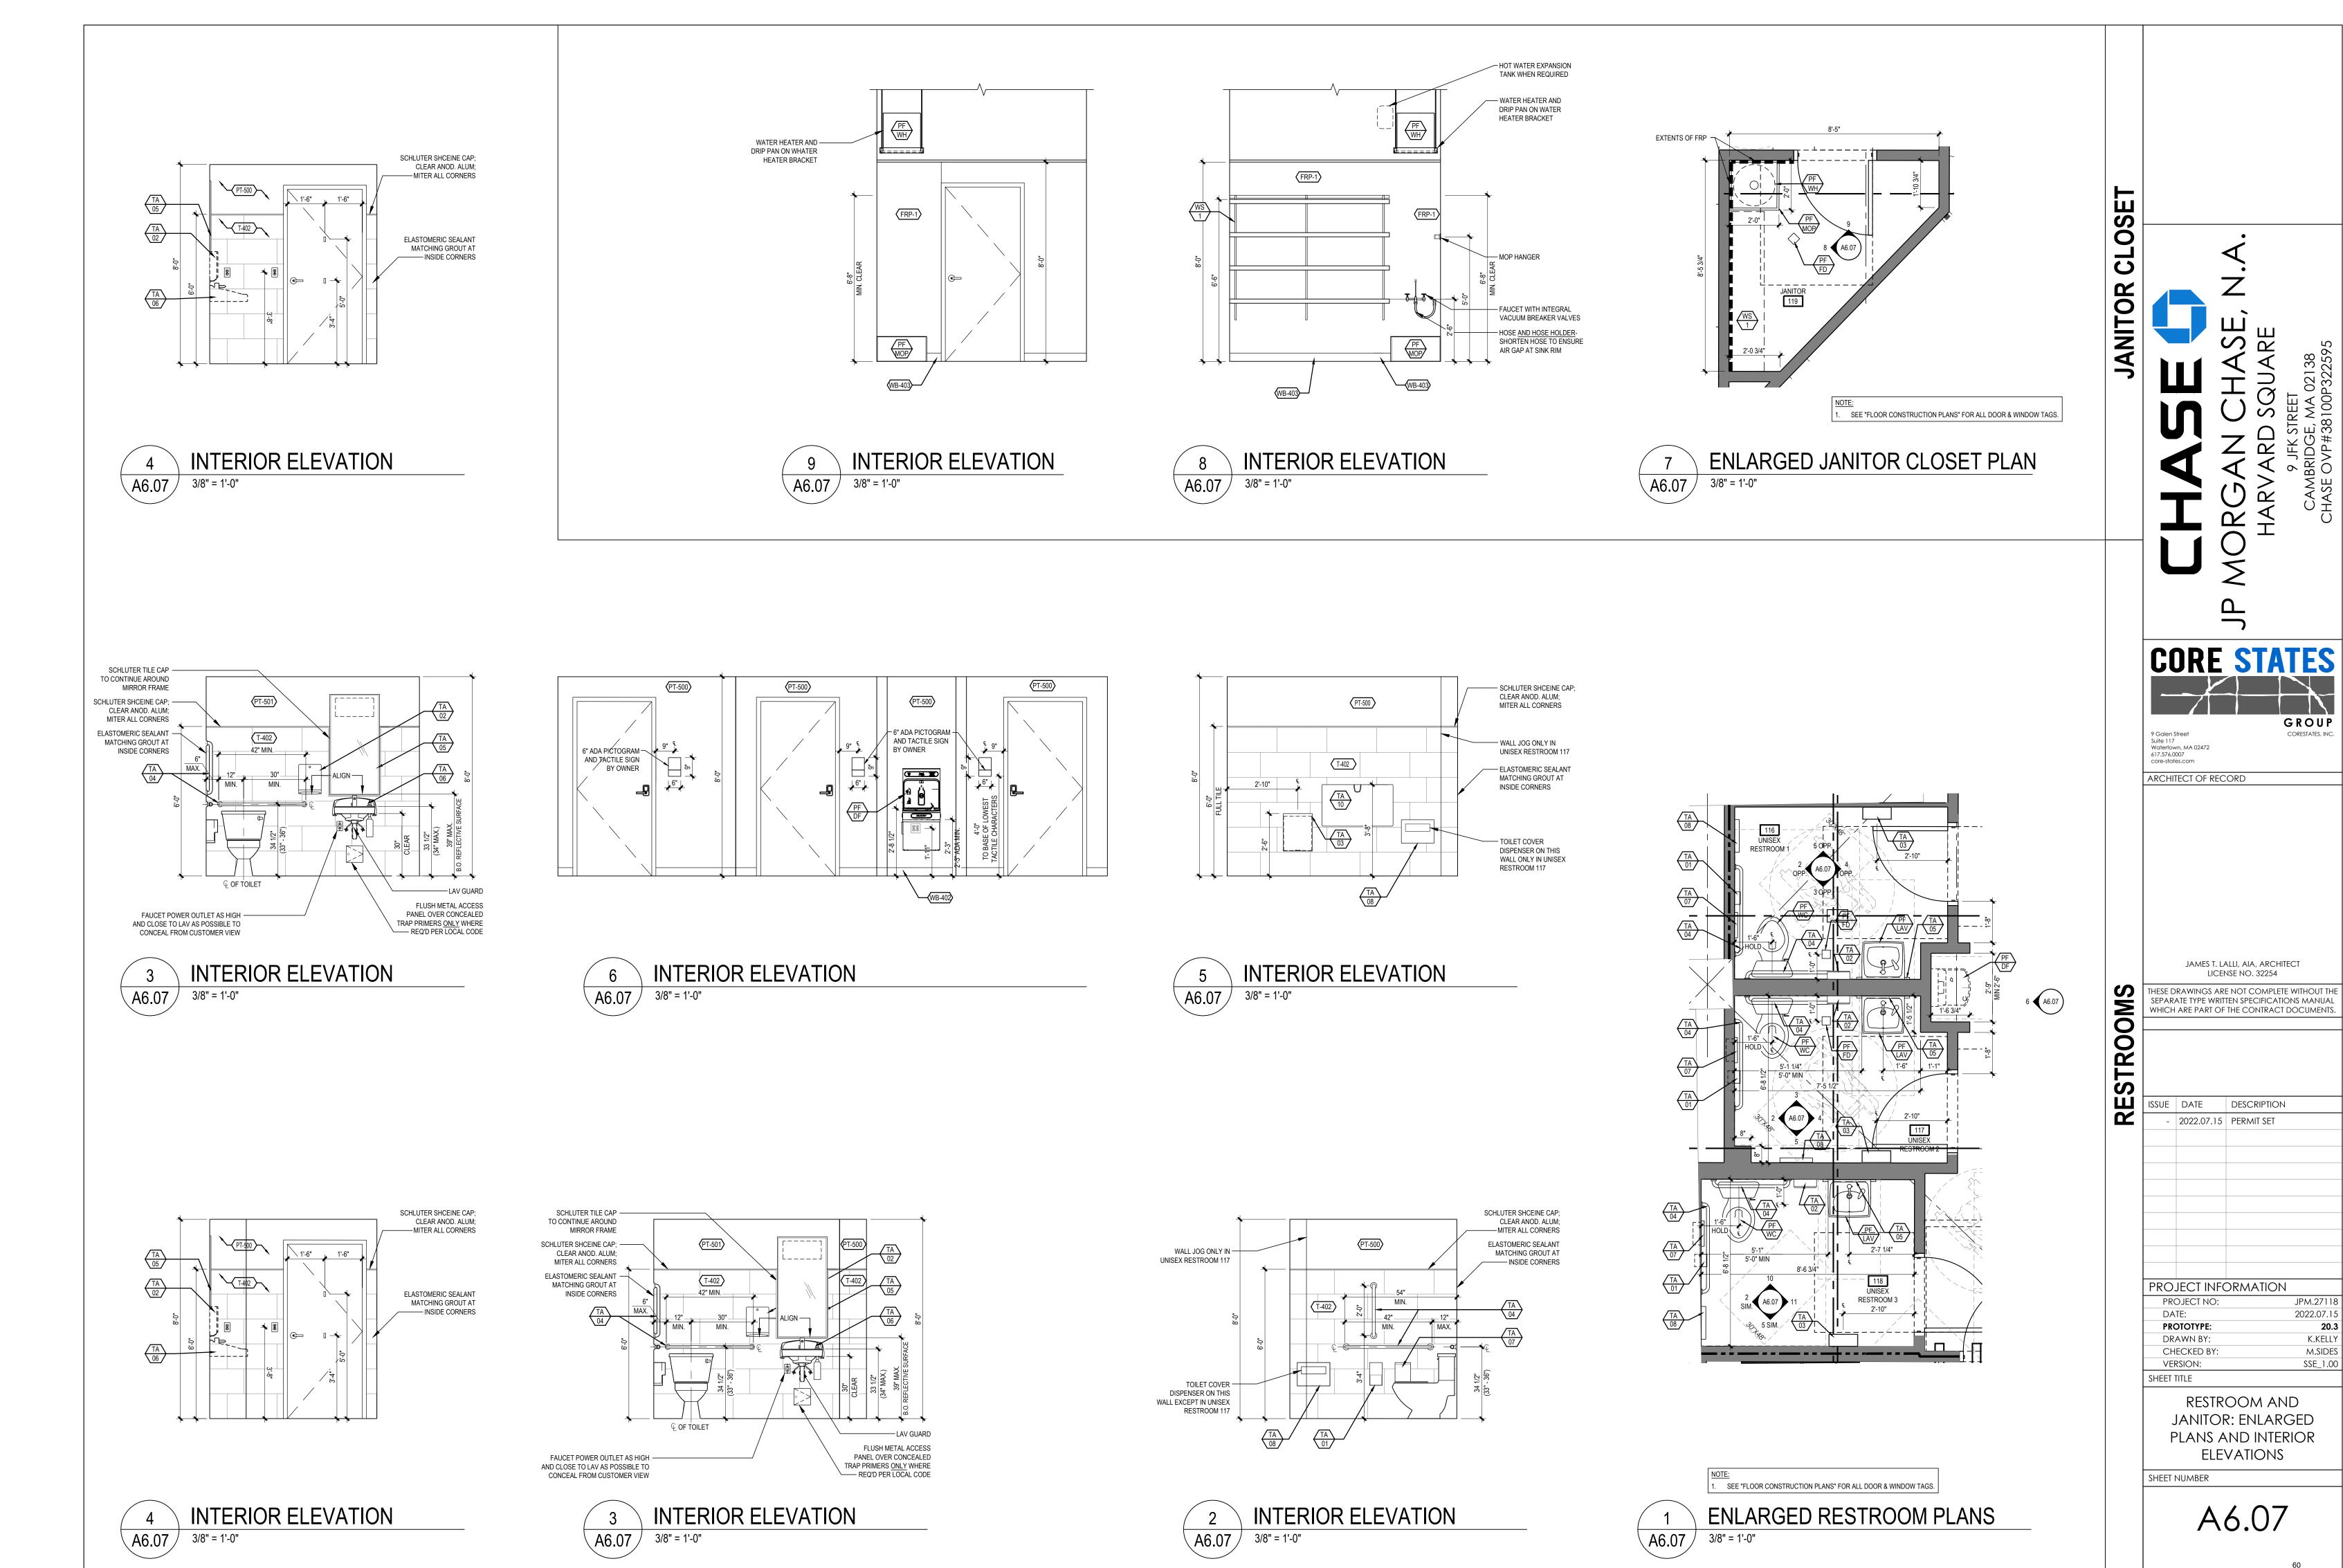


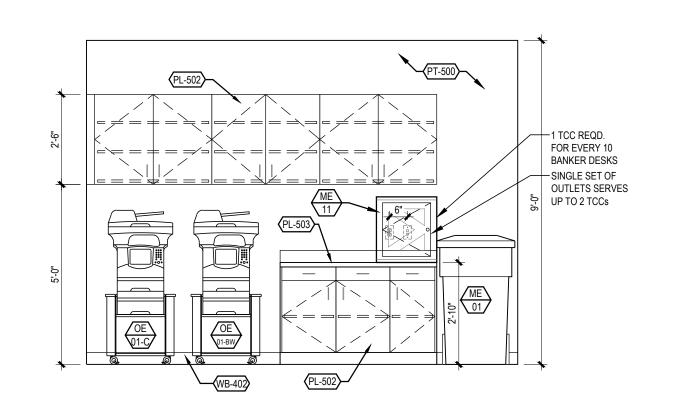

10 INTERIOR ELEVATION
A6.08 3/8" = 1'-0"

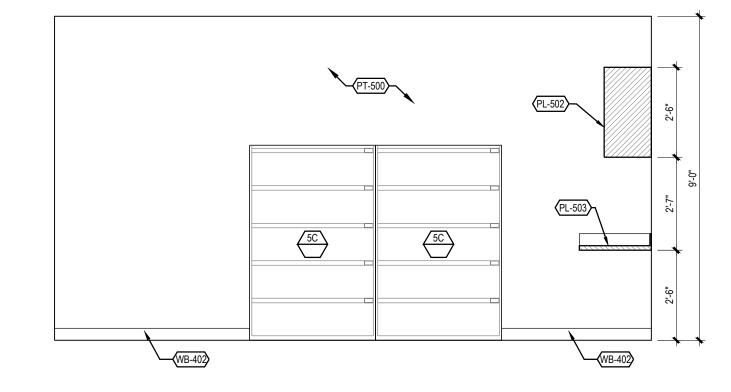

8 INTERIOR ELEVATION
A6.08 3/8" = 1'-0"

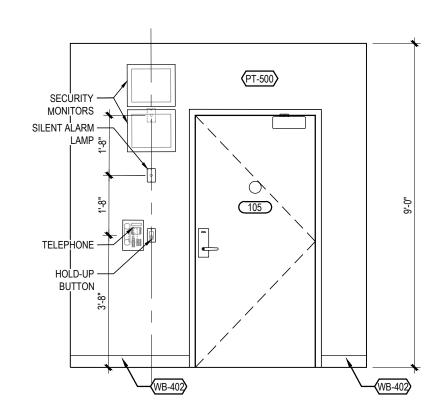


WALL CABINET SIZE DESIGN INTENT


1. ADJUST CABINET POSITIONS & SIZES AS REQUIRED TO UTILIZE STANDARD MODULAR UNITS. FILL THE AVAILABLE WALL SPACE WHILE MINIMIZING THE AMOUNT OF MATERIAL & HARDWARE REQUIRED.

2. MINIMUM FILE/ PRINT ROOM UPPER WALL CABINETS ARE TO MATCH BASE CABINET WIDTH & FINISH AS PROVIDE.



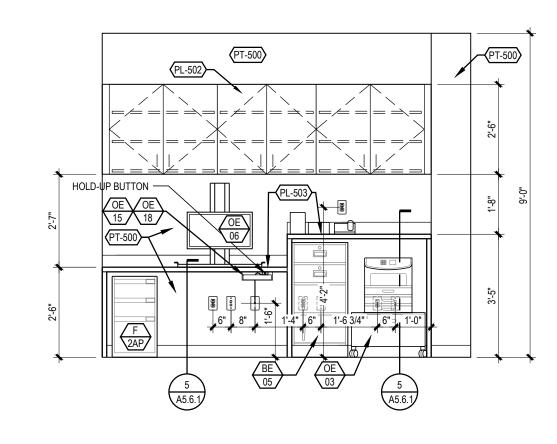


7 INTERIOR ELEVATION
A6.08 3/8" = 1'-0"

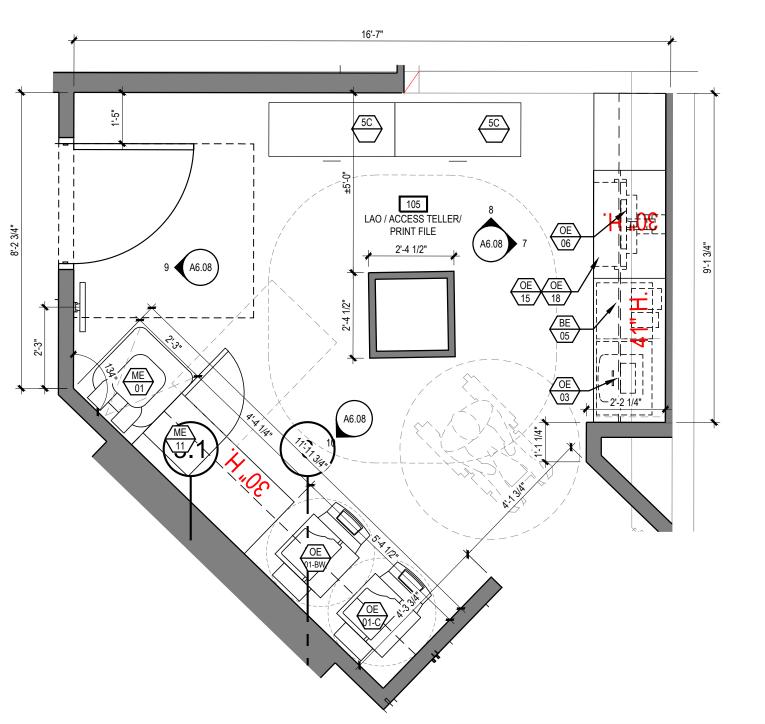


OTE:

SEE "FLOOR CONSTRUCTION PLANS" FOR ALL WALL, DOOR & WINDOW TAGS.


ALL FURNITURE TO BE VERIFIED BY CLIENT & FURNITURE VENDOR.

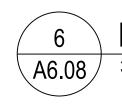


ENLARGED LAO / ACCESS TELLER / PRINT PLAN

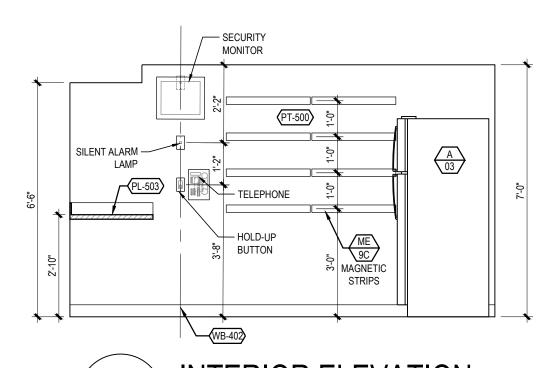

5 INTERIOR ELEVATION
A6.08 3/8" = 1'-0"

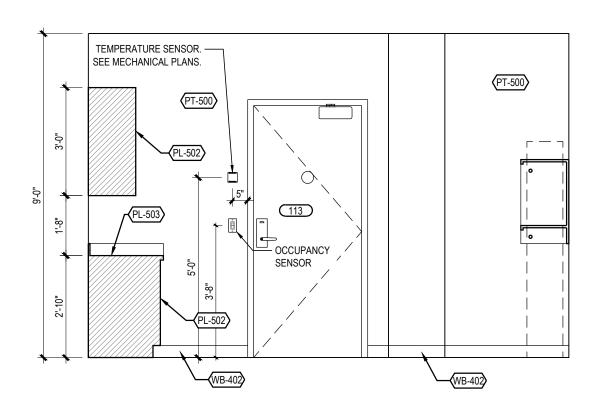

3 INTERIOR ELEVATION
A6.08 3/8" = 1'-0"

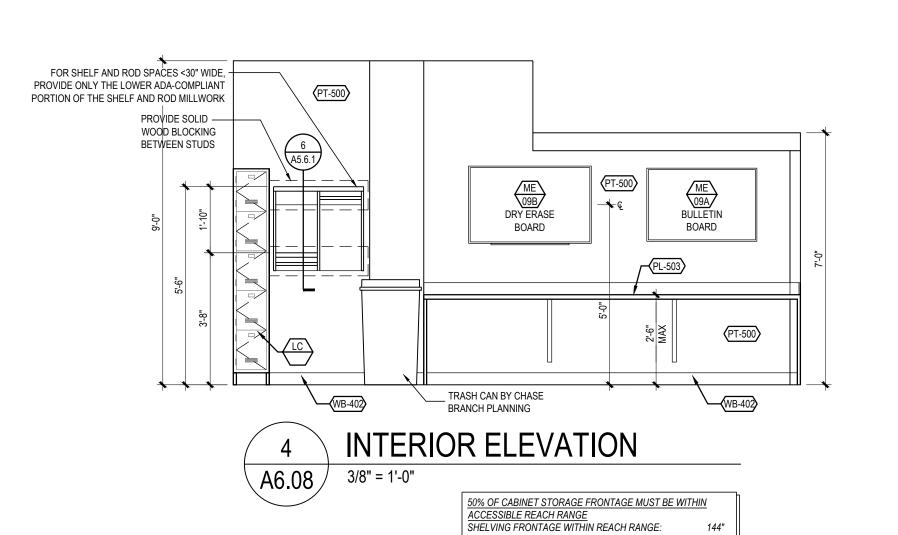


PT-500)

PT-500

SHELFING FRONTAGE BEYOND REACH RANGE:


2 INTERIOR ELEVATION
A6.08 3/8" = 1'-0"

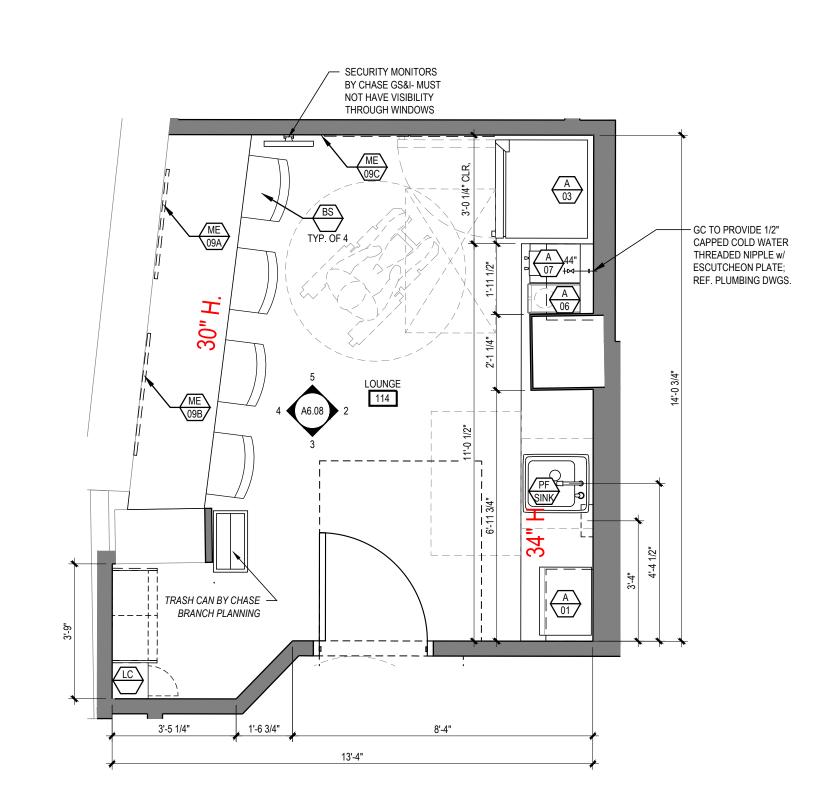

NOTE:

1. SEE "FLOOR CONSTRUCTION PLANS" FOR ALL WALL, DOOR & WINDOW TAGS.

2. ALL FURNITURE TO BE VERIFIED BY CLIENT & FURNITURE VENDOR.

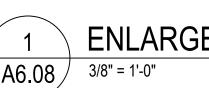

ENLARGED LOUNGE PLAN
3/8" = 1'-0"

LAO / ACCESS TELLER / PRINTER ROOM

CHASE, N.A.

HARVARD SQUARE

PARVARD SQUARE

GROUP

9 Galen Street
Suite 117
Watertown, MA 02472
617.576.0007
core-states.com

ARCHITECT OF RECORD

JAMES T. LALLI, AIA, ARCHITECT
LICENSE NO. 32254

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SEPARATE TYPE WRITTEN SPECIFICATIONS MANUAL

WHICH ARE PART OF THE CONTRACT DOCUMENTS.

ISSUE DATE DESCRIPTION

- 2022.07.15 PERMIT SET

PROJECT INFORMATION

PROJECT NO: JPM.271

DATE: 2022.07.

PROTOTYPE: 20

DRAWN BY: K KEL

PROJECT NO: JPM.27118

DATE: 2022.07.15

PROTOTYPE: 20.3

DRAWN BY: K.KELLY

CHECKED BY: M.SIDES

VERSION: SSE_1.00


SHEET TITLE


LOUNGE, FILE, AND
PRINTER ROOM:
ENLARGED PLANS AND
INTERIOR ELEVATIONS


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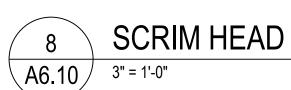
A6.08


61



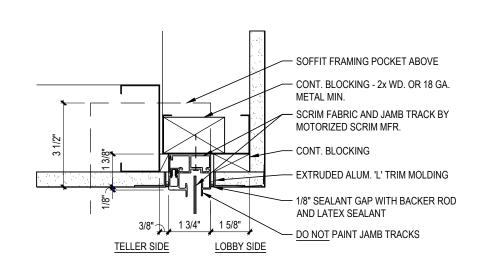


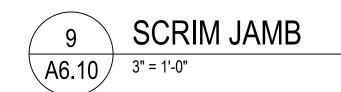

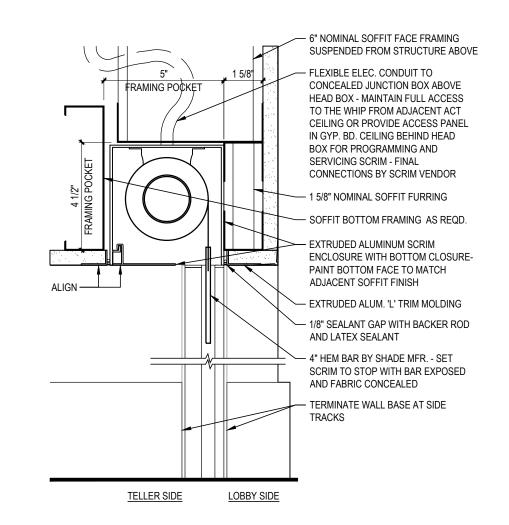

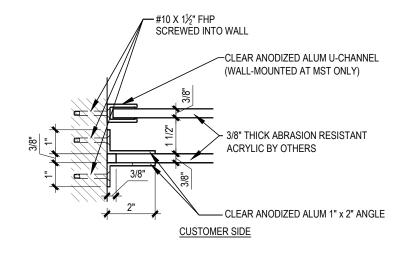


SNEEZE GUARD VERTICAL ANGLE DETAIL √A6.10 /

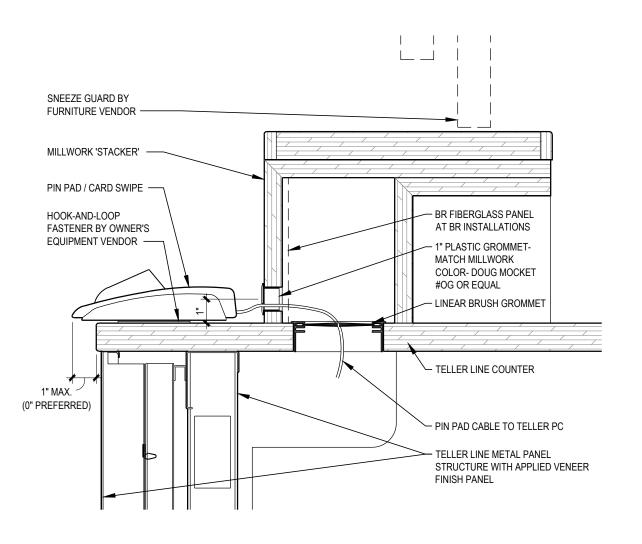


MILLWORK 'STACKER' -PIN PAD / CARD SWIPE AT — STACKER SIDE OF ADA-COMPLIANT COUNTER ROUTE CABLE ACROSS — COUNTER AND AROUND STACKER TO BRUSH GROMMET


A6.10 1/2" = 1'-0"

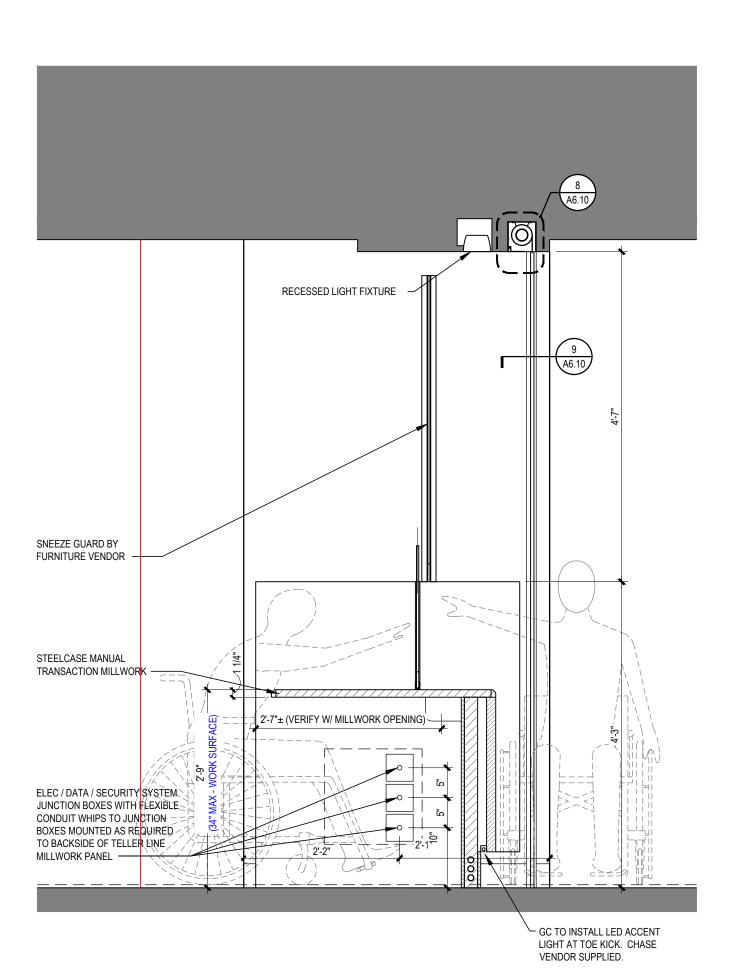


SECTION @ ACCESSIBLE TELLER

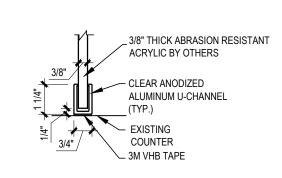


SNEEZE GUARD U CHANNEL DETAIL A6.10 3" = 1'-0"

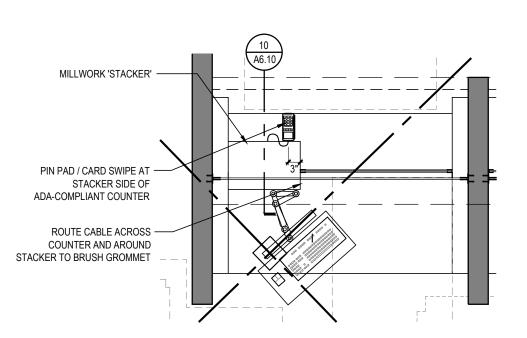


TYPICAL PIN PAD/ CARD SWIPE POSITON

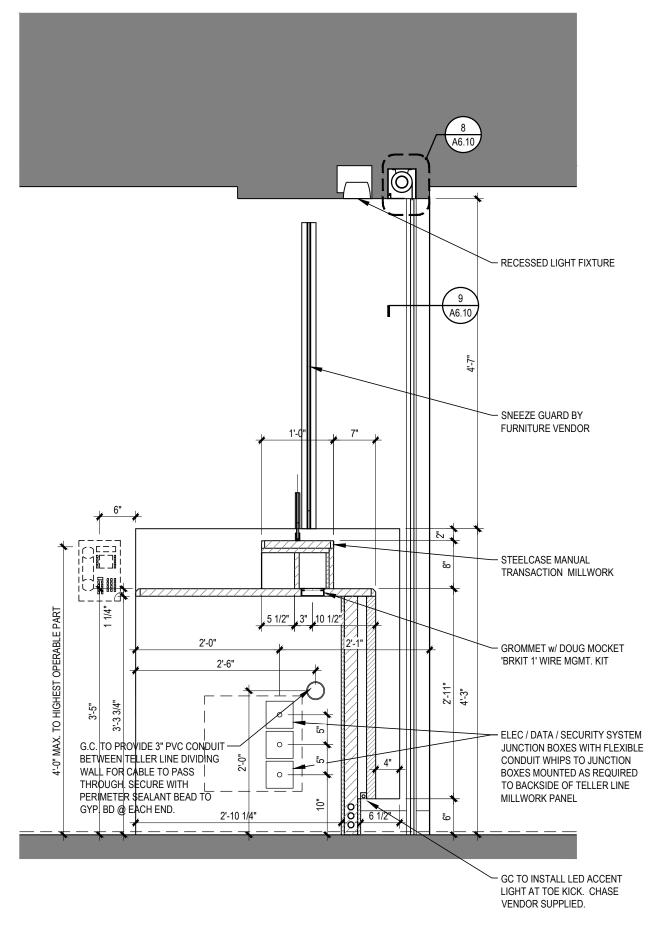


SECTION @ STANDARD TELLER

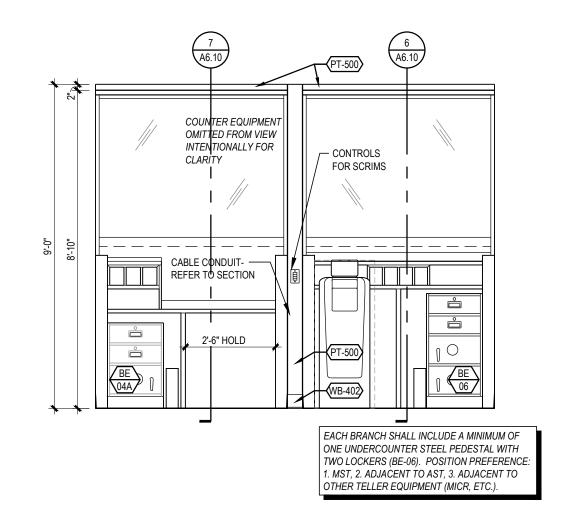


INTERIOR ELEVATION - EMPLOYEE SIDE

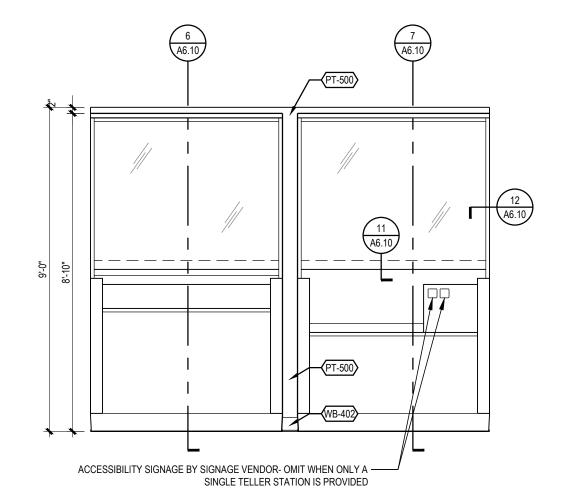

3/8" = 1'-0"

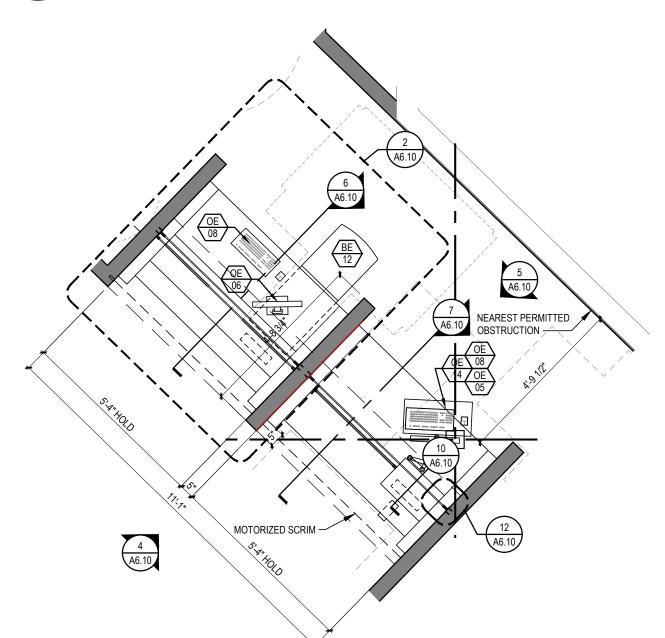

ENLARGED TELLER PLAN

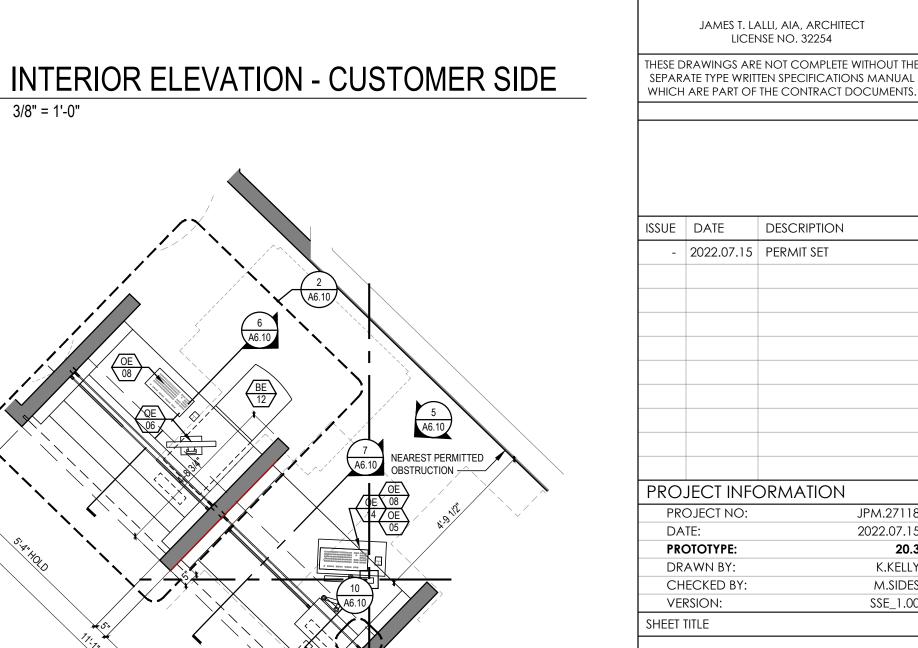

MANUAL TRANSACTION: ENLARGED PLAN, INTERIOR ELEVATIONS, AND DETAILS

DESCRIPTION

A6.10

SHEET NUMBER

PIN PAD/ CARD SWIPE MOUNTING DETAIL

SECURITY MOTION SENSOR- -

CEILING- OR WALL-MOUNT

CAMERA AT 9'-0" AFF MAX.

CAPTURING FRONT OF CR

CASH RECYCLER -CLEARANCES AND CONNECTIONS

— EDGE OF TELLER COUNTER OR OTHER OVERHEAD OBSTRUCTION

A6.10 3/8" = 1'-0"

2022.07.13

K.KELLY

M.SIDES

SSE_1.00

GROUP

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ARCHITECT OF RECORD