SHEET NOTES

CODED NOTES

- SEE SHEET G0.02 FOR GENERAL NOTES. PROTECT ALL ADJACENT CONSTRUCTION THAT IS TO REMAIN. PATCH AND REPAIR ANY EXISTING CONSTRUCTION DAMAGED BY CONSTRUCTION ACTIVITIES
- AND TO ACCOMMODATE NEW WORK. REPAIRS SHALL MATCH EXISTING ADJACENT MATERIALS AND FINISHES OR
 - SEE SHEET A2.91 FOR ROOM FINISH SCHEDULE
- SEE SHEET A2.92 FOR DOOR SCHEDULE
 PAINT ALL NEW AND EXISTING WALLS AND CEILNGS ON 1ST



LEGEND



EXISTING TO REMAIN



SEE MECHANICAL FOR

GENERATOR ROOM LAYOUT

2" ACOUSTICAL INSULATION AT EXTERIOR WALL

SURFACES AND CEILING AT

EXTG GENERATOR

ENCLOSURE

NEW CONCRETE RAMP AT -DOOR - SEE LANDSCAPE DRAWINGS

A3.04

2 GENERATOR ROOM PLAN

1/8" = 1'-0"


ROOF DRAIN WITH OVERFLOW




Issue No. Description Date 09/30/20 01 BID DOCUMENTS DRAWING TITLE

FLOOR PLAN - LEVEL 1

SHEET NO.

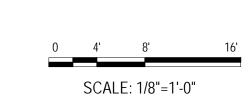

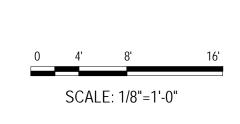



SHEET NOTES

- SEE SHEET G0.02 FOR GENERAL NOTES. PROTECT ALL ADJACENT CONSTRUCTION THAT IS TO REMAIN. PATCH AND REPAIR ANY EXISTING CONSTRUCTION DAMAGED BY CONSTRUCTION ACTIVITIES AND TO ACCOMMODATE NEW WORK. REPAIRS SHALL MATCH EXISTING ADJACENT MATERIALS AND FINISHES OR
 - SEE SHEET A2.91 FOR ROOM FINISH SCHEDULE
- 4. SEE SHEET A2.92 FOR DOOR SCHEDULE5. PAINT ALL NEW AND EXISTING WALLS ON 2nd FLOOR

(11)(12)(13)7'-0 1/2" 5'-8" 4'-11" 4'-5" 4'-11" 5'-11" 7'-7 1/4" 3'-5" 7'-5" 1'-11" 7'-5" 3'-3"2'-6" **CODED NOTES** →(A3 ` A4.10 (A2 A1 (A4

(D

G

134'-0 1/2"

COMPUTER

CONFERENCE ROOM

PRE-ENGINEERED CANOPY BELOW —

4

A9.53

UNIT TYPE 1

(11)

CORRIDOR

2-HR FA CHASE, LEVELS 4

2,4,6,8 A4.10

(17)

(15)

2ND FLOOR PLAN

(13)

(19)

(21)(22)

-LÂUNDRY

ROOF BELOW


SOUTH CORRIDOR

18'-0"

UNIT TYPE 1

PATCH AND SEAL PENETRATIONS -AT REMOVED FEEDER

LEGEND

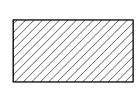

EXISTING TO REMAIN




ROOF DRAIN WITH OVERFLOW



Housing

Issue No. Description 09/30/20 01 BID DOCUMENTS DRAWING TITLE

FLOOR PLAN - LEVEL 2

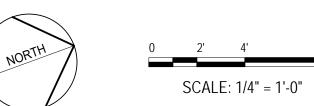

SHEET NO. PROJECT NO. 2005

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BUILDING BODY

FIBER CEMENT CLADDING





WINDOW BAYS FIBER CEMENT CLADDING



TWO-TONE WINDOWS







OPERABLE SASHES, STOREFRONTS AND SOLID DOORS



THIN STONE VENEER AT 1ST LEVEL (3" to 7" H X 4" to 14" W)



10" H GREY CAST STONE WATER TABLE





SMOOTH HORIZONTAL FIBER CEMENT PANELS (18" X 72")




RIBBED HORIZONTAL FIBER CEMENT PANELS (18" X 72" - 9 RIBS)




FAUX WOOD HORIZONTAL FIBER CEMENT PANELS (18" X 72" - 3 RIBS)




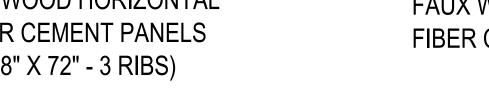



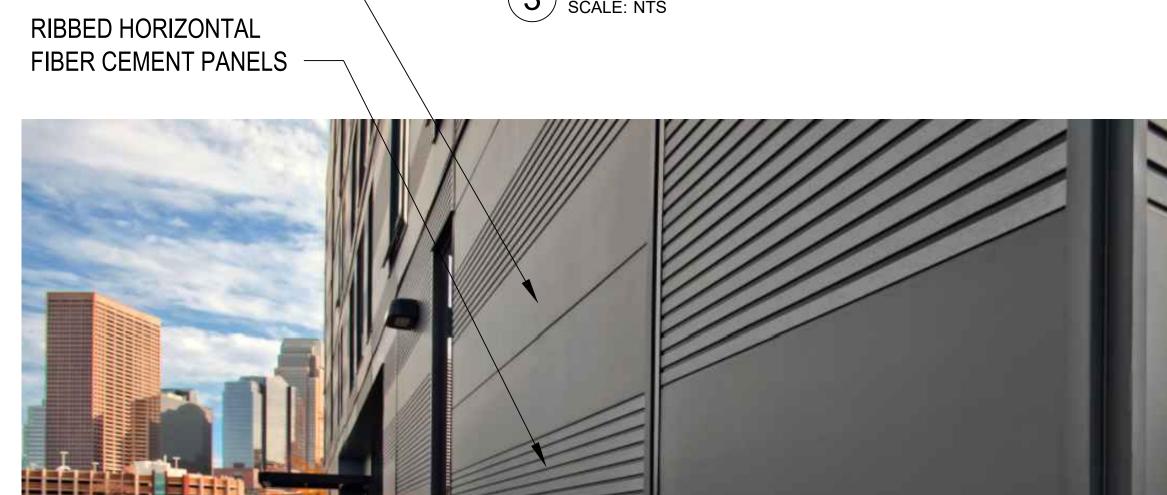


2 TEXTURE CLOSE-UP SCALE: NTS

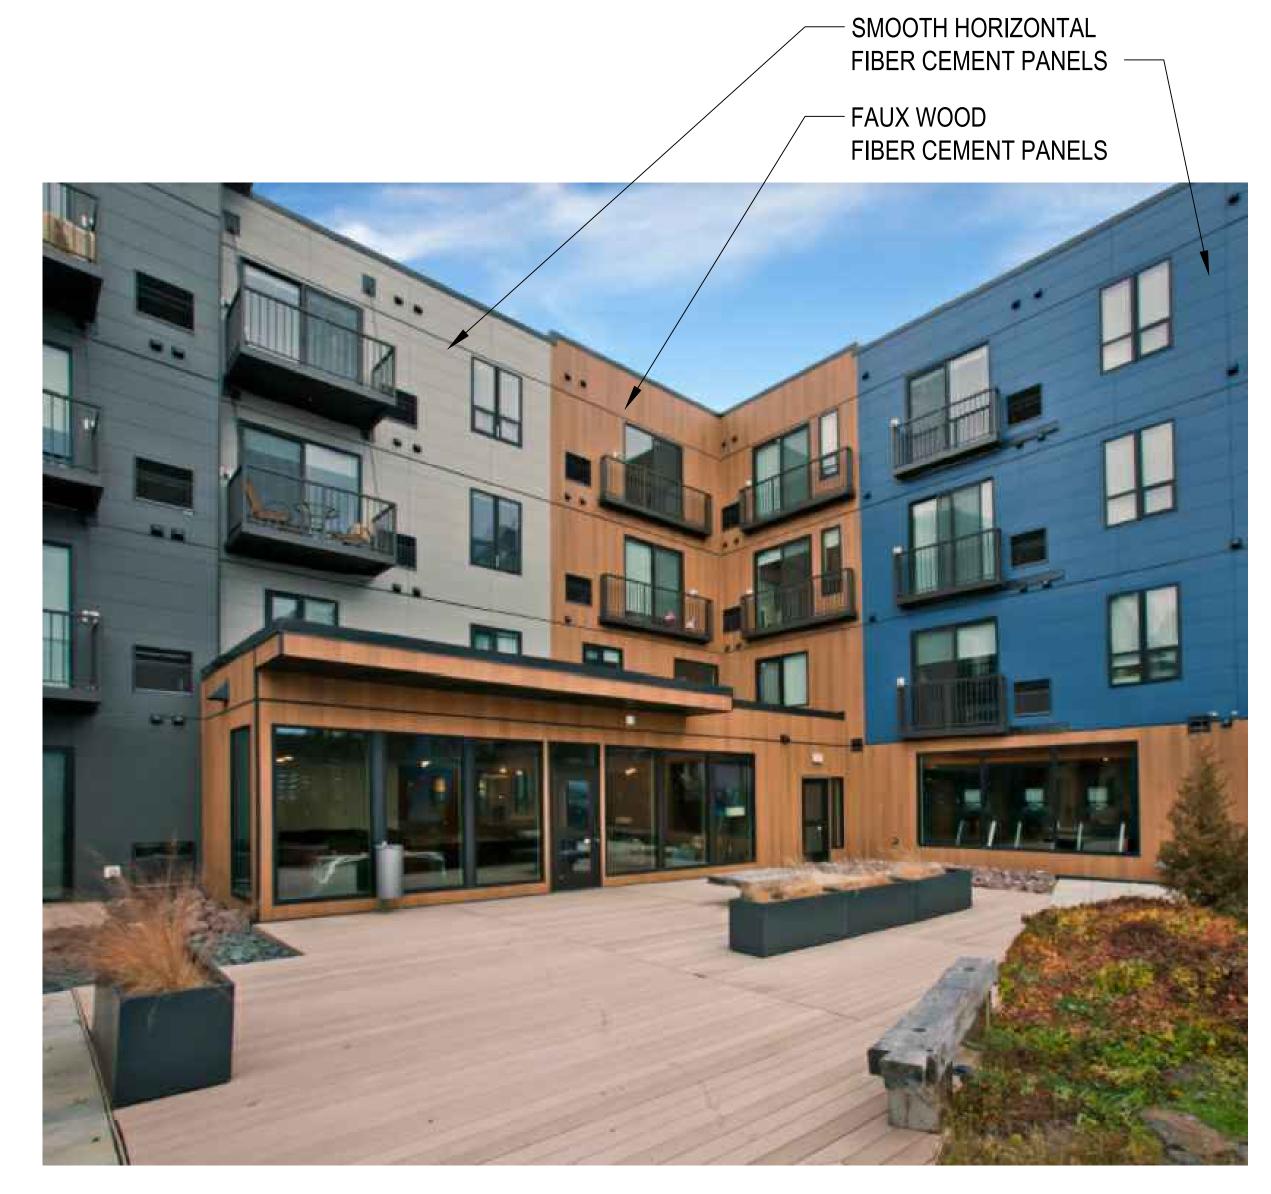









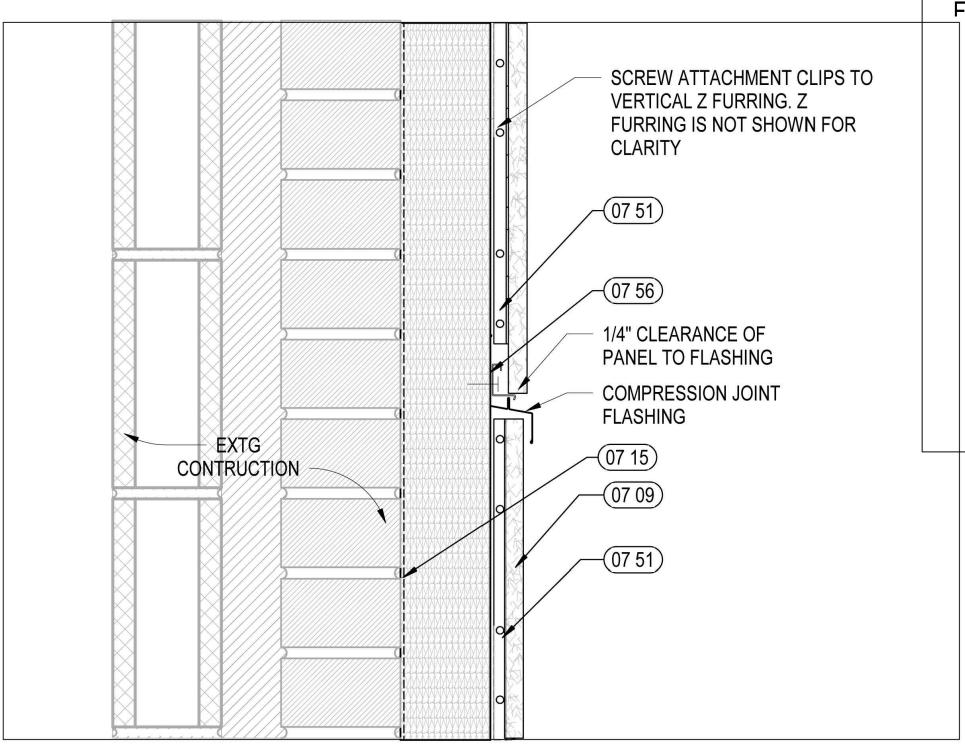

FIBER CEMENT HORIZONTAL COMPRESSION JOINTS
SCALE: NTS

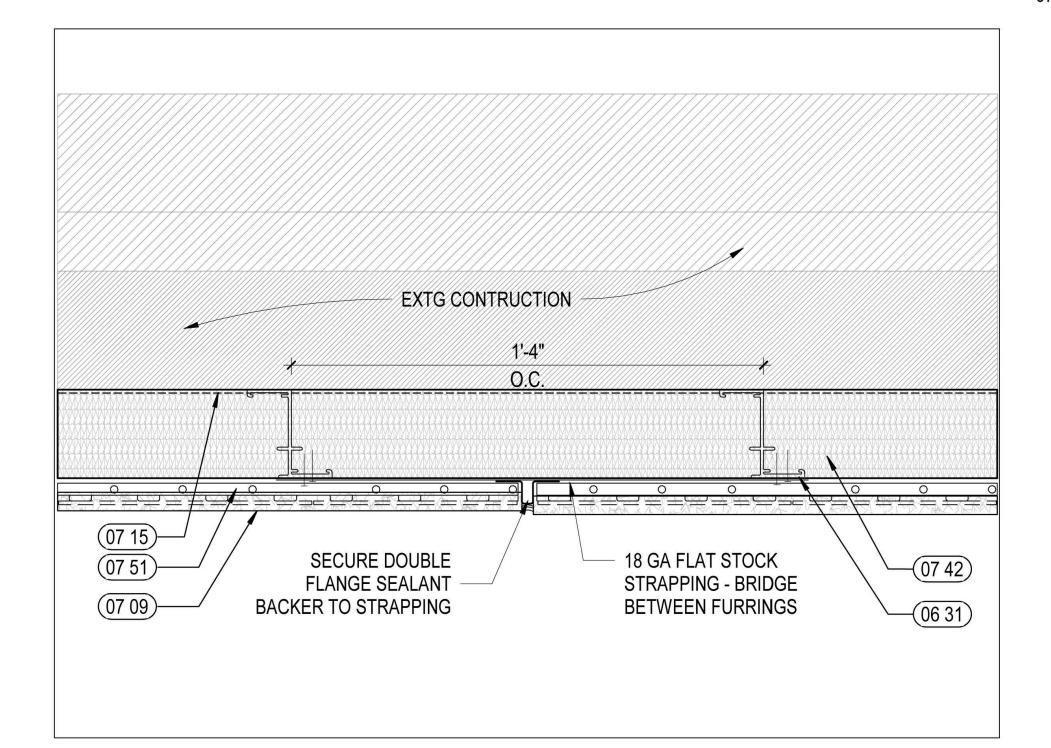


3 FIBER CEMENT VERTICAL SEAMS
SCALE: NTS 72" SPACING MAX BETWEEN SEAMS

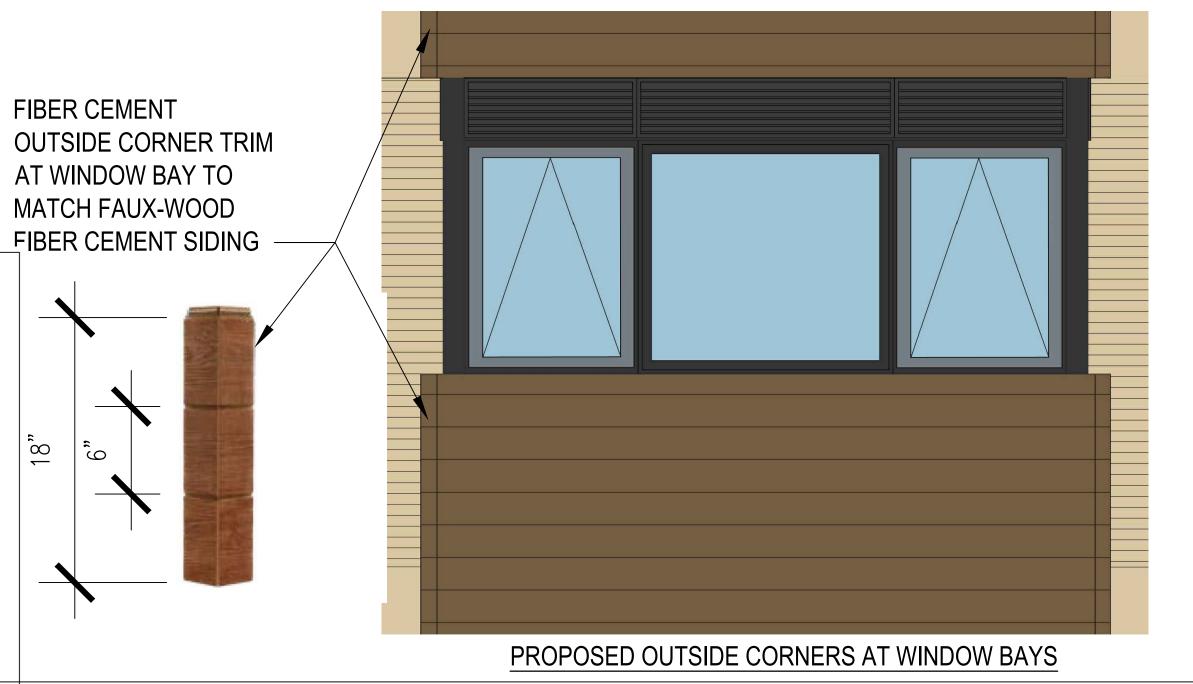


5 BAY WINDOW CORNERS
SCALE: NTS

CODED NOTES


05 02	MTL CLIP
06 31	FIBERGLASS "Z" FURRING
07 09	FIBER CEMENT SIDING
07 15	AIR AND WEATHER BARRIER
07 31	CONT SEALANT
07 42	3" RIGID MINERAL WOOL INSULATION
07 51	PANEL ATTACHMENT CLIP
07 56	STARTING TRACK

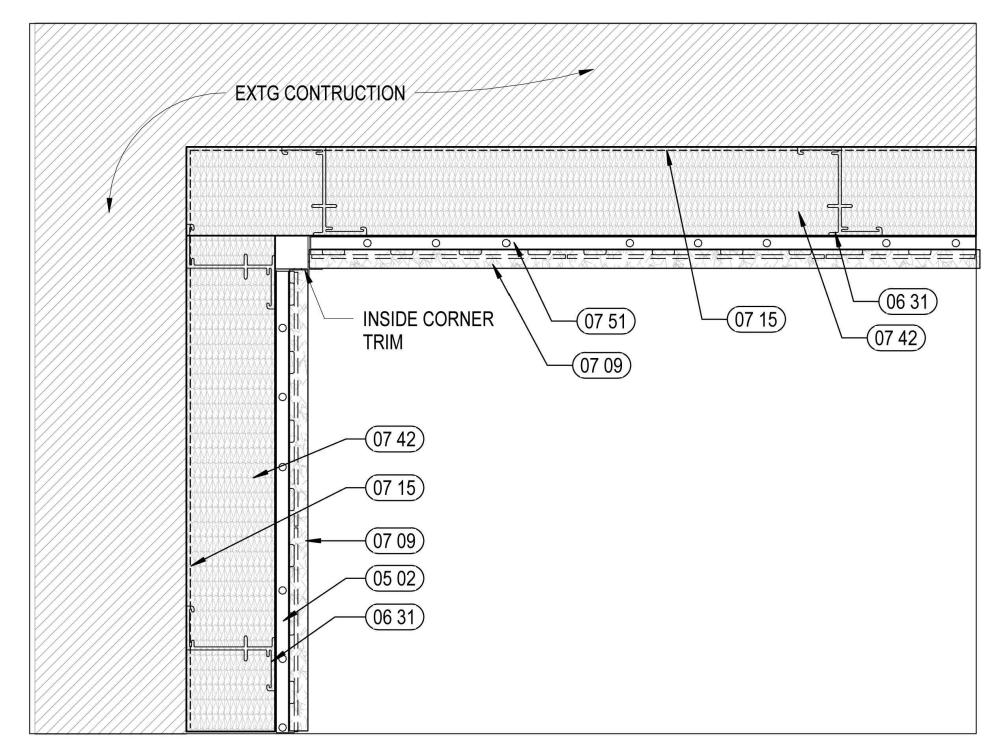

2 FIBER CEMENT INSIDE CORNERS
SCALE: NTS

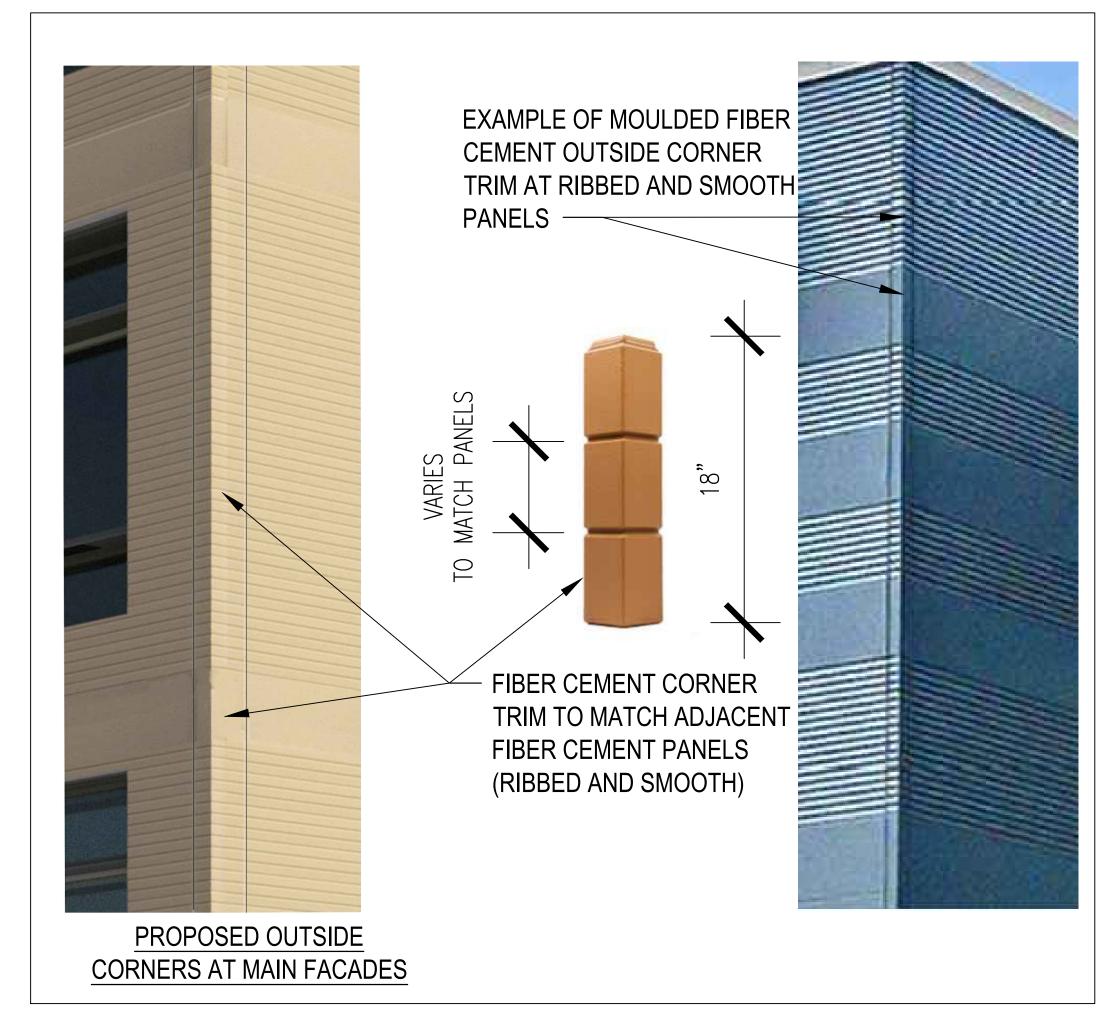

6 MAIN FACADE CORNERS
SCALE: NTS

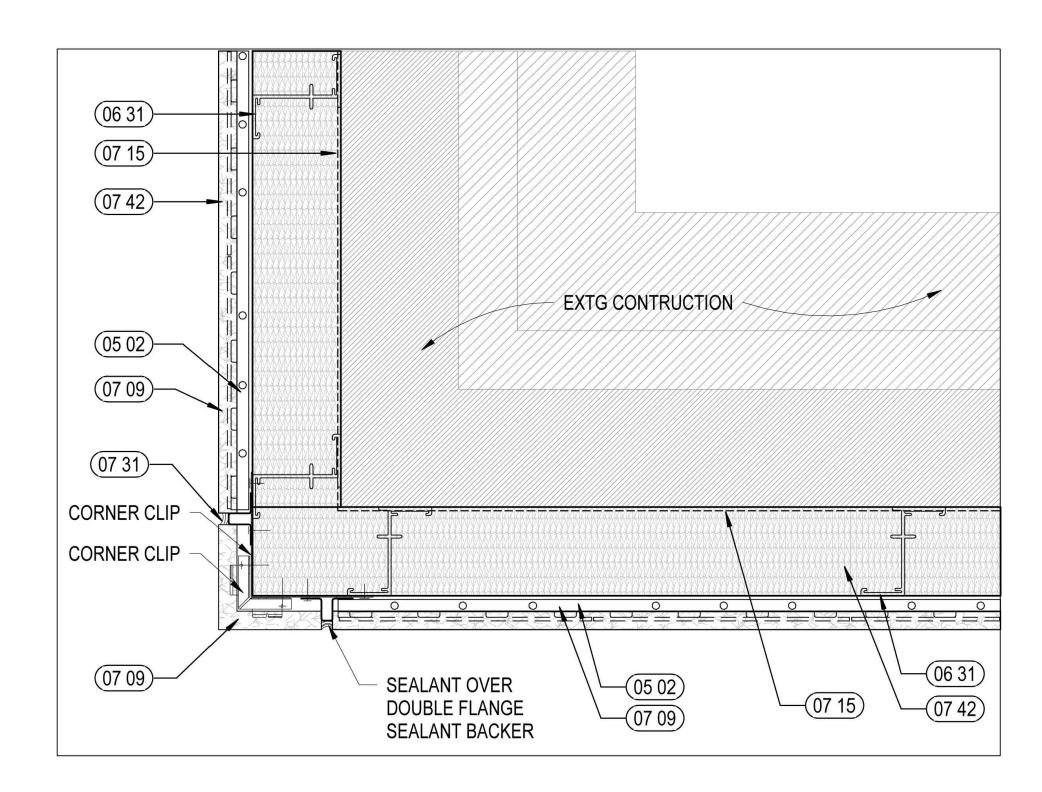


1 FIBER CEMENT OUTSIDE CORNERS
SCALE: NTS



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REVITALIZATION OF TRUMAN APARTMENTS



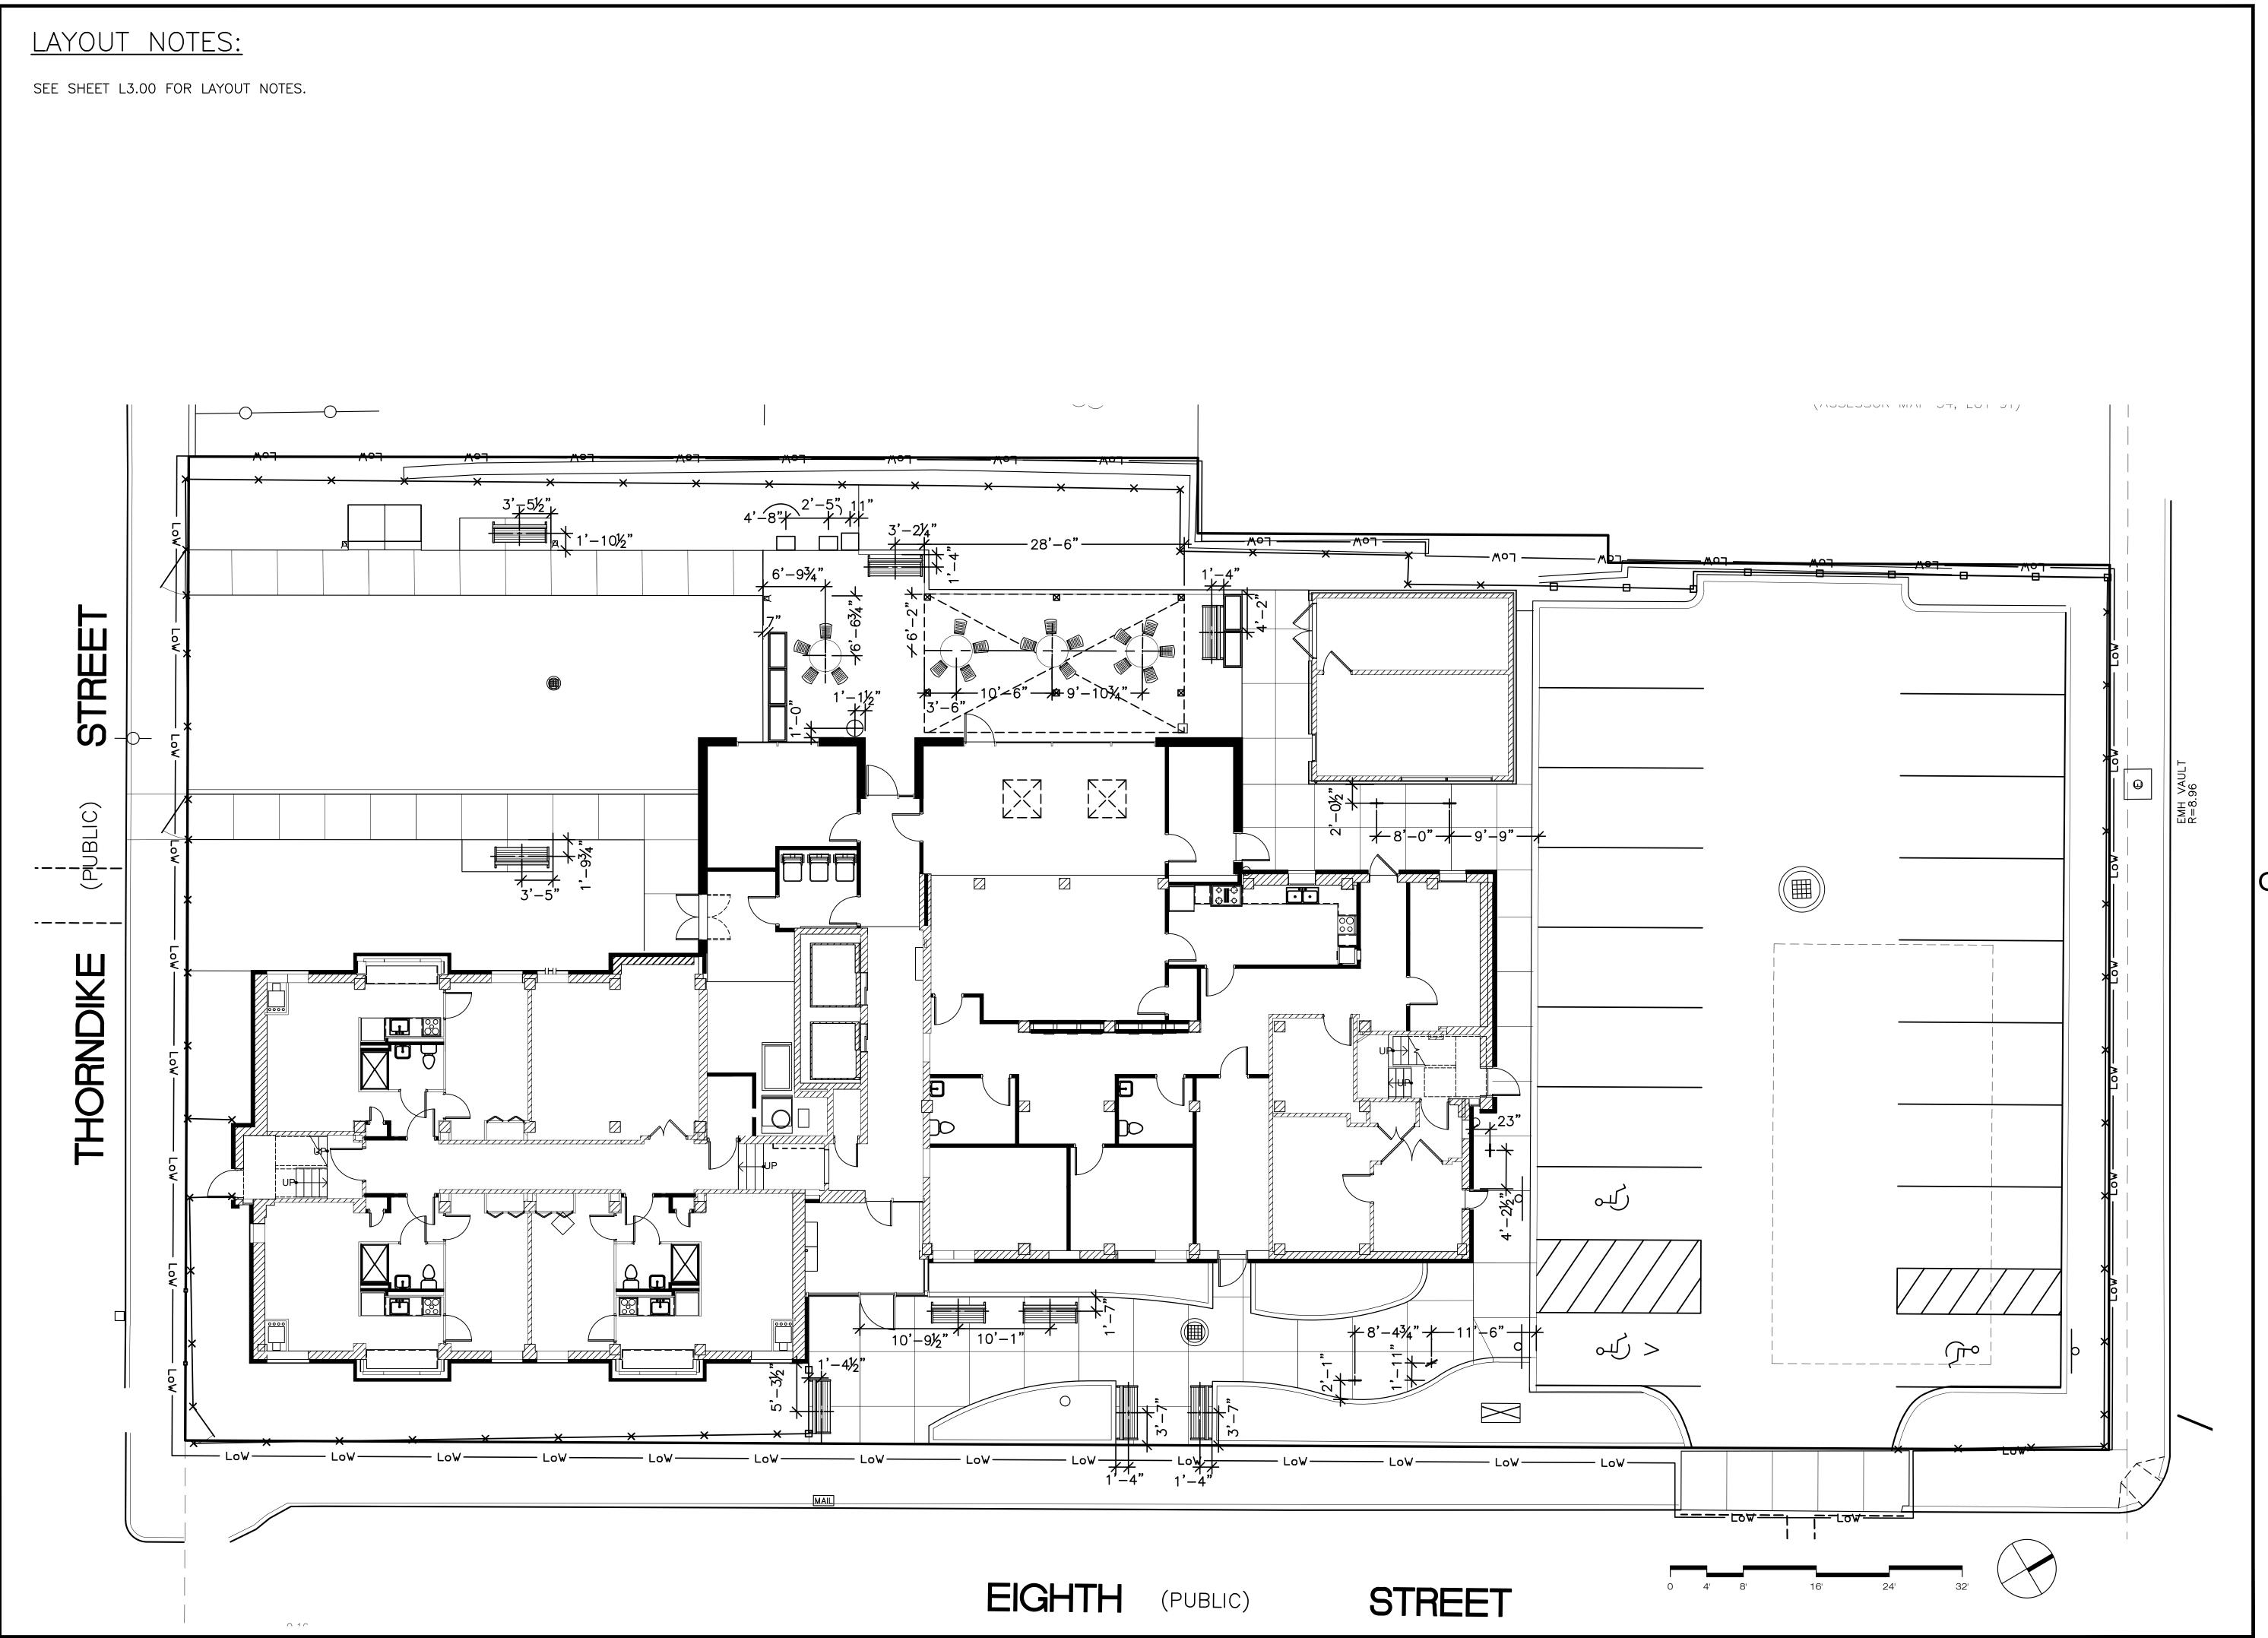

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 02
 50% PRICING SET
 04-02-20

 03
 50% SCHEMATIC SET
 04-17-20

 04
 SCHEMATIC PRICING SET
 05-21-20

 05
 SCHEMATIC PRICING SET
 06-05-20

 06
 50% CD SET
 07-20-20

 07
 90% CD SET
 08-28-20

DRAWING TITLE

LAYOUT PLAN: SITE FURNITURE

SHEET NO.

L3.01

PROJECT NO. 2009
SCALE 1" = 1/8'
DRAWN BY JAW
CHECKED BY KAB

PLANTING NOTES:

STREET

VN (3)

SB (5)


- 1. The Landscape Contractor shall protect all utilities prior to starting construction.
- 2. The Contractor shall supply all plant materials in quantities sufficient to complete all planting shown on this drawing.
- 3. All plant materials to conform to guidelines established by the American Standard for Nursery Stock published by the American Assn. of Nurserymen, current edition.
- 4. All plant materials to be selected by the Landscape Architect with the Contractor at the nursery.
- 5. No substitution of plant materials shall be allowed without written approval of Landscape Architect.
- 6. All plants to be located on the site for approval of the Landscape Architect
- 7. If the Plant List quantities do not agree with the Planting Plan, the Plan shall be followed.
- 8. The Contractor shall guarantee all plant materials and lawns for one year following final acceptance. See Specifications for conditions of final acceptance.

- 9. All planting beds to have a minimum of 12" of topsoil; all new lawns to be hydroseeded. Add topsoil so that all lawns to have a minimum 6" depth of
- 10. All plant beds to receive 3" un—dyed dark brown ages shredded bark mulch; supply sample for approval by Landscape Architect.
- 11. Maintenance shall begin immediately after an area is planted and shall continue until final acceptance. The minimum maintenance period shall be ninety (90) calendar days after completion of all plant installations. Watering and mowing shall be done by the Contractor for the full 90 days.
- 12. All areas called out as lawn within Limit of Landscape Work are to be hydroseeded lawn. Remove old lawn, weeds and mulch, and rototill. Add topsoil so that all lawns have a minimum 6" depth of topsoil. See Specs for soil and hydroseeding requirements, maintenance and warranty.
- 13. In addition to areas indicated on the plan, the Contractor is responsible for new hydroseeded lawn in any area of lawn damaged during construction.

PLANTING SCHEDULE:

TREE	ES			
<u>SYM</u>	QTY	BOTANICAL NAME	COMMON NAME	SIZE
AR	4	Acer rubrum 'October Glory'	Red Maple	3.5—4" Cal. B&B
CA	2	Cornus alternifolia	Pagoda Dogwood	7—8' Ht., Multistem Tree Form, B&B

SHRUBS SYM QTY BOTANICAL NAME COMMON NAME CS 14 Clethra alnifolia 'Sixteen Candles' 18-24" High x Wide Dwarf Summersweet 24-36" High x Wide llex glabra 'Shamrock' Dwarf Inkberry Holly 18-24" High x Wide Fothergilla gardenii 'Suzanne' Dwarf Fothergilla 36-48" High x Wide Hydrangea paniculata 'Vanilla Strawberry' Panicle Hydrangea Syringa 'Bloomerang Dark Purple' Dark Purple Reblooming Lilac 24-36" High x Wide Viburnum nudum 'Brandywine' Brandywine Winterthur Viburnum 36-48" High x Wide

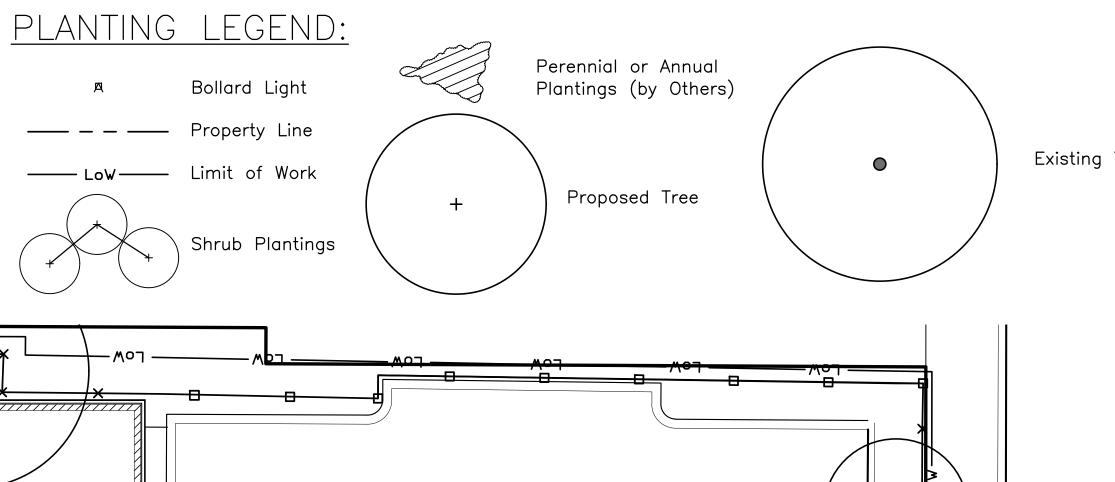

BLIC) Lawn (Sod) | THORNDIKE

Lawn (Sod)

Lawn (Sod)

Perennials/Annuals

by Others, Typ.

CA (2)

IG (3) VN (4) 0

EIGHTH (PUBLIC) STREET

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HOUSING

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No. Description 01 EXISTING CONDITIONS 02-27-20 02 50% PRICING SET 04-02-20 04-17-20 03 50% SCHEMATIC SET 04 | SCHEMATIC PRICING SET | 05-21-20 06 50% CD SET 07-20-20 08-28-20 07 90% CD SET

DRAWING TITLE

PLANTING AND LANDSCAPE LIGHTING PLAN

SHEET NO.

VGC

_5.00

DRAWN BY **JAW** CHECKED BY KAB

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NOTES:

1. Score joints every 6' (maximum), typical dimensions 6'x6' (see Plan).

OF' (resultable) Expansion joints are to be ½" Expansion joints every 25' (maximum). Expansion joints are to be $\frac{1}{2}$ " wide. Locate expansion joints where paving abut's structures, curbs, walls, or existing paving.

2. All walks and plaza's shall slope to drain (1.8% maximum cross slope). Coordinate with existing grades.

CONCRETE PAVING

Scale: 1"=1'-0"

Scale: 1" = 1'-0"

NOTES:

Scale: 1" = 1'-0"

1'-6" -4"\ 1'-2" -\

_ _ _ _ _ _

<u>Plan View</u>

4. Install according to Mfr's instructions.

2. Debris trap to be "The Eliminator" 8" Diameter

3. Catch Basin Frame & Grate are to be Model #

R-4558 by Neenah Foundry Inc. of Neenah, WI,


or Approved Equal. Minimum inlet capacity is 1.1

PRECAST CONCRETE AREA DRAIN

Trap by Ground Water Rescue, or Approved Equal.

1. Shop Drawings required.

Precast Pervious Ceramic Concrete Pavers; Sizes per plan. Max. 1/8" Joint, Sweep with Fine Sand. See Specifications. 3" Sharp Angular, Washed Stone Leveling Bed Planting Bed, Lawn, or Concrete (See Plans) Aluminum Paver Restraint ¾6 x 2¼ - ¾"x10" Spiral Steel Spike at 12" O.C. Crushed Stone to Extend 6" Beyond Paving Compacted ¾" Crushed Stone. Compact In 6" Lifts — Non—Woven Geosynthetic Fabric As Required — Compacted Subgrade

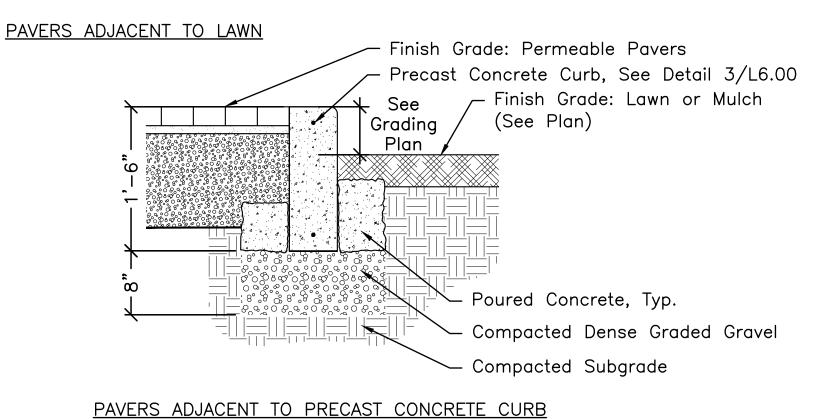

PERMEABLE PRECAST CERAMIC CONCRETE PAVERS

— Precast Concrete

12" & 18"

Risers As

Catch Basin

NOTES:

RAISED PLANT BED

to have rubbed finish.

Scale: 1" = 1'-0"

1. Concrete to be 5.000 PSI air—entrained.

super-plasticized concrete. Top and 10" down face

PRECAST CONCRETE CURB

1. Pavers to be hydroPavers by Green Innovations Ltd. of Uxbridge, ON, Canada (T:1-888-599-6444), or Approved Equal. Provide Manufacturer's information for approval and colors selection. Two colors to be selected by Landscape Architect from full range of product colors.

Finish Grade Per Plan; Plant Bed Shown

Chamfered Edges and (2) #4 Rebar

— Ht. Varies: 9" Max.,

Finish Grade:

Poured Concrete

ompacted Graded

Compacted Dense

Compacted Subgrade

Graded Gravel

(See Specs.)

Concrete Paving Shown

- Precast Concrete Curb with ¾"

See Grading Plan

- 2. Lay pavers in patterns shown on plan. Provide an 8'x8' sample layout for approval before continuing.
- 3. Contractor to complete test, confirm infiltration rate of existing soils and submit results to Landscape Architect before beginning paving work.
- 4. Paver restraints to be Permaloc StructurEdge or Approved Equal.
- 5. Do not cover entire top of Aggregate Base with Geotextile.
- 6. Geotextile to be turned up at edges per Manufacturer's instructions.
- 7. Concrete To Be 5,000 PSI Air-Entrained, Super-Plasticized Top And 8" Down Front Face To Have Rubbed Finish. Concrete.
- 8. All Concrete Curbs To Be Butt Jointed With Adjacent Items And/Or Materials.

ADA Compliant

Finish Grade:

Graded Gravel

Pipe Knockout

Debris Trap

(See Notes)

- Outlet Pipe

Concrete

Wire Mesh

- Invert Elevation

(See Grading Plan)

4,000 PSI Precast

6"x6" W4/W4 Welded

Prepared Subgrade

& Grate

Bit. Conc.


(Typ.)

Cast Iron Frame

Compacted Dense

NOTES:

- 1. All concrete shall have a light broom finish.
- 2. Color of detectable warning panel to be selected by Landscape Architect from Manufacturer's full range of available colors. Submit sample and product information for approval. Product must be available in at least 2 contrasting colors to pavement, per ADA requirements.
- 3. Curb ramps to conform to all federal, state, and local codes. Meet existing curbs.
- 4. Detectable warning panels in permanent sidewalks to be set atop 4" concrete slab, cast into place per manufacturer's instructions.

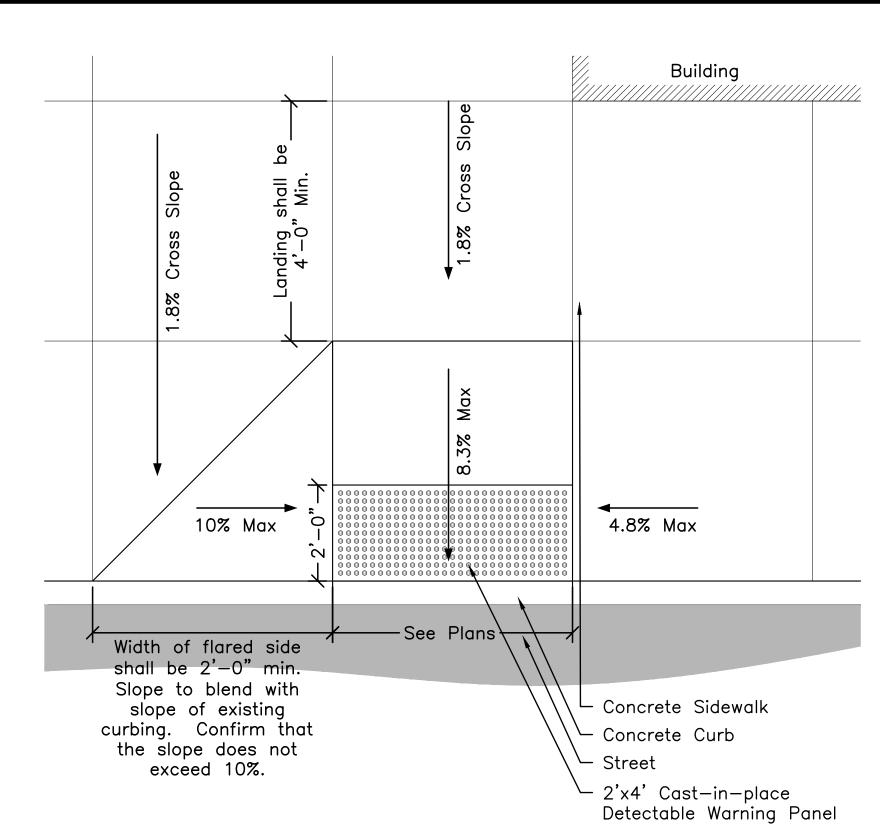


DETECTABLE WARNING PANEL & CONCRETE RAMP AT CURB CUT Scale: $\frac{1}{2}$ " = 1'-0"

NOTES:


1. Outdoor grill to be "Park Charcoal Grill with ADA Accommodations-Model#ASW-20-B2" by Pilot Rock, Cherokee, IA 51012-0946 (Ph. 800-762-5002), or approved


- 2. Grill to be finished with heat resistant black enamel.
- 3. Grill shall rotate freely 360° for draft control.
- 4. Place grill on support. Line up holes in internal pin and post. insert $\frac{3}{8}$ " ϕ roll pin until grill rotates freely.

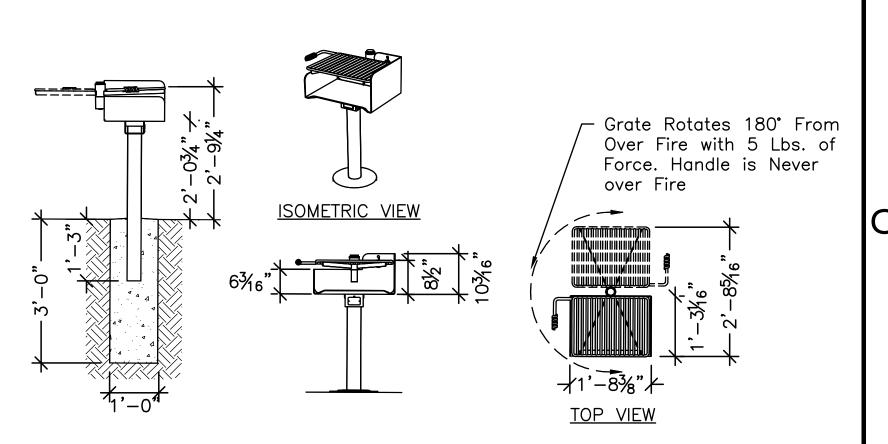

OUTDOOR GRILL

Scale: $\frac{1}{2}$ " = 1'-0"

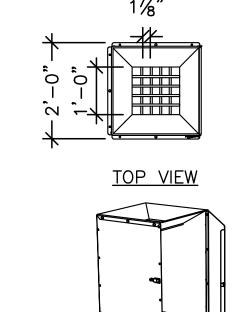

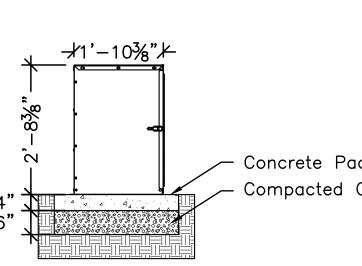

ISOMETRIC VIEW

Concrete Pad Compacted Gravel FRONT ELEVATION

1. Hot coal bin to be "Hot Coal Bin" - Model HCB-1 by Pilot Rock, Cherokee, IA 51012-0946 (Ph. 800-762-5002), or approved

equal. 2. Anchor bin to concrete surface by means of four concrete anchors (Model no. BR-4HSA)

COAL BIN Scale: ½" = 1'-0"

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lss		
No.	Description	Date
01	EXISTING CONDITIONS	02/27/
02	50% PRICING SET	04/02/2
03	50% SCHEMATIC SET	04/17/2
04	SCHEMATIC PRICING SET	05/21/2
05	SCHEMATIC PRICING SET	06/03/2
06	50% CD SET	07/24/


DRAWING TITLE

07 90% CD SET


DETAIL SHEET

SHEET NO.

08/28/20

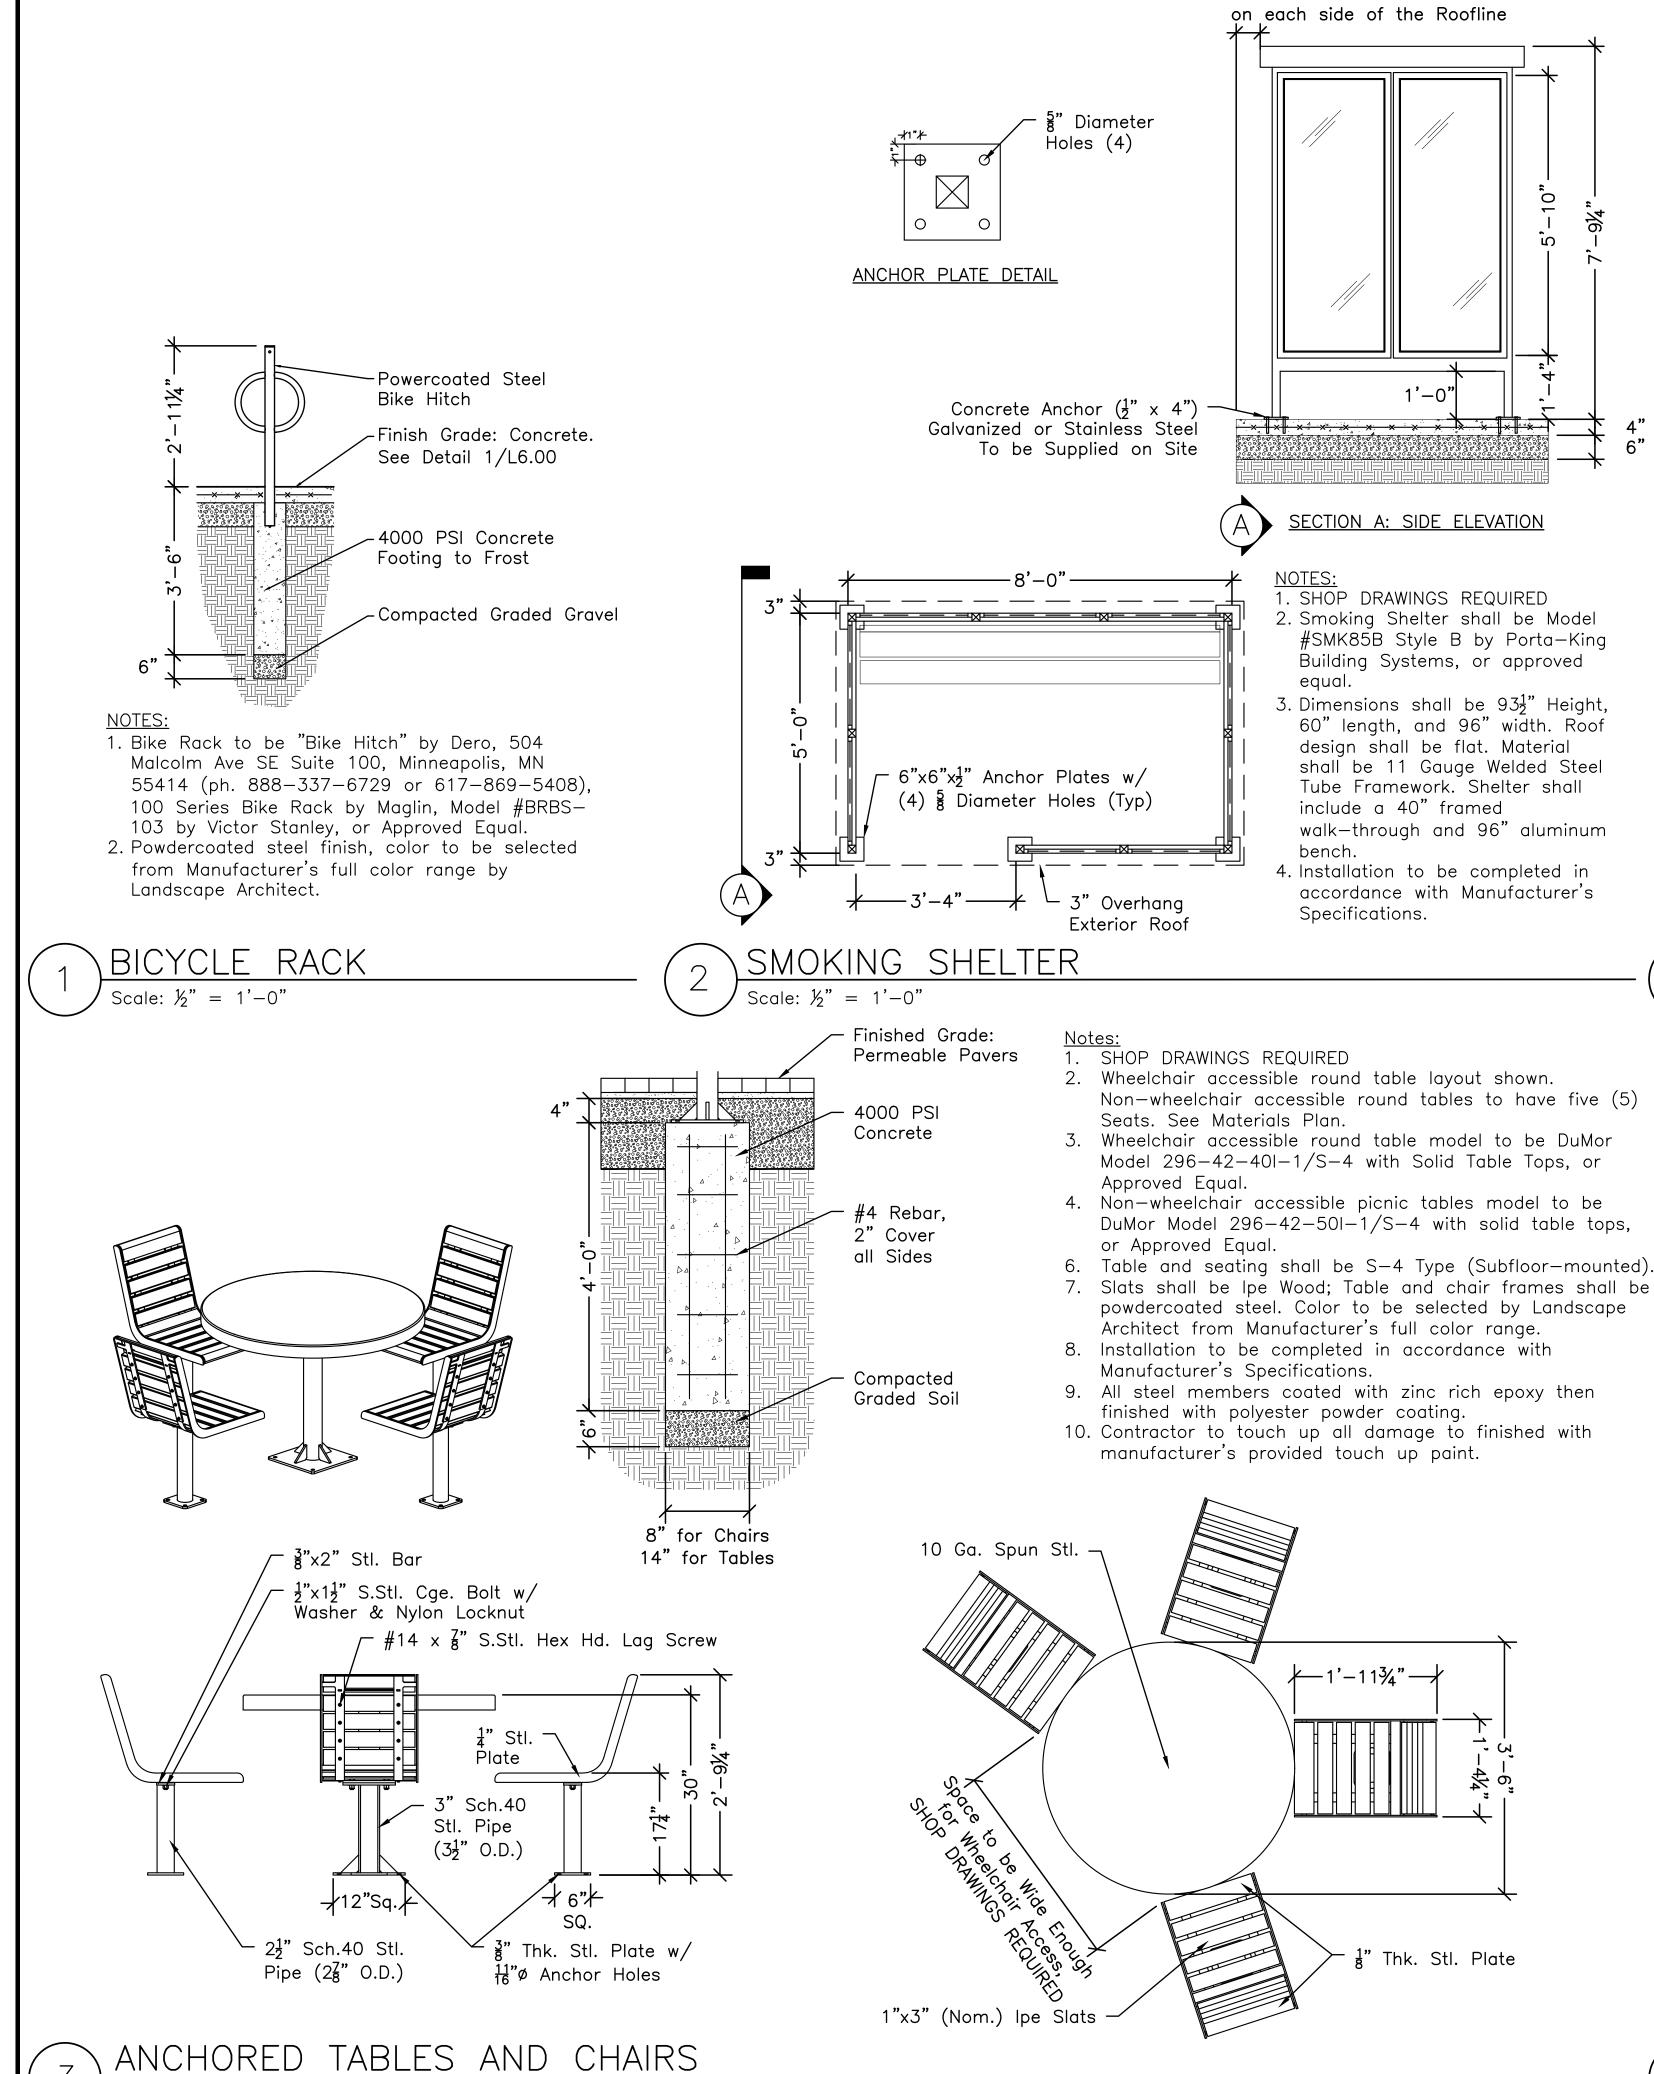

SCALE: 3/4" = 1'-0"

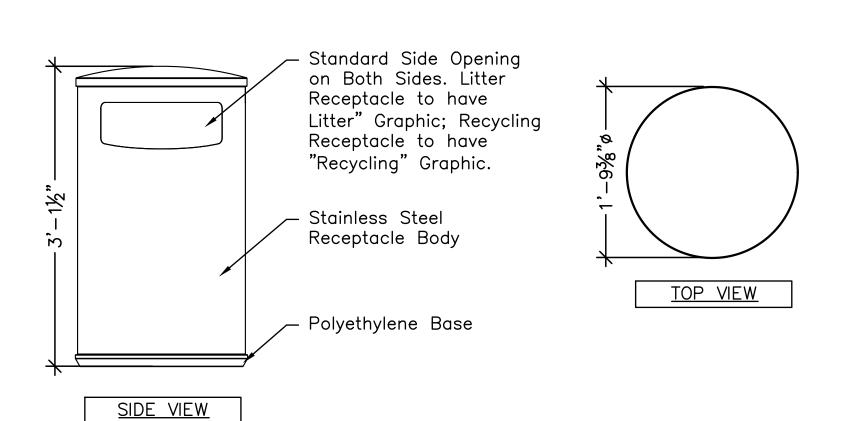

Minimum 6" Concrete Border

NOTES:


1. SHOP DRAWINGS REQUIRED.

2. Trash and Recycling Receptacle shall be a dual-use receptacle; Model shall be Universal Litter & Recycling Receptacle 30 Gal. with Standard Side Openings by Forms+Surfaces of Pittsburgh, PA 15223 (Tel: 800.451.0410); Lexicon Trash and Recycle Receptacle (Model #XRC1502-32-MS-LD0ST-LD0ST -RS) by Maglin Site Furniture of Woodstock, ON (Tel: 800.716.5506 x6070); Sage Dual Receptacle by Victor Stanley of Dunkirk, MD 20754 (Tel: 800.368.2573); or Approved

3. Color and finishes to be selected by Landscape Architect from Manufacturer's full color and finish range.

- 4. Receptacles to be subfloor-mounted. Installation to be completed in accordance with Manufacturer's Specifications.
- 5. All hardware to be supplied by Manufacturer and shall be tamper-resistant and stainless steel.

LITTER AND RECYCLING RECEPTACLE

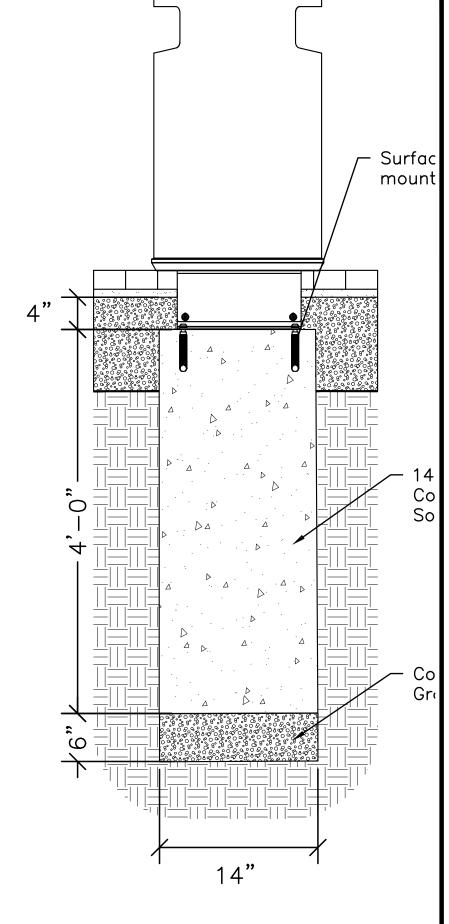

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BWA ARCHITECTURE

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Issue


INO.	Description	Date	
01	EXISTING CONDITIONS	02/27/20	
02	50% PRICING SET	04/02/20	
03	50% SCHEMATIC SET	04/17/20	
04	SCHEMATIC PRICING SET	05/21/20	
05	SCHEMATIC PRICING SET	06/03/20	
06	50% CD SET	07/24/20	
07	90% CD SET	08/28/20	
	01 02 03 04 05 06	01 EXISTING CONDITIONS 02 50% PRICING SET 03 50% SCHEMATIC SET 04 SCHEMATIC PRICING SET 05 SCHEMATIC PRICING SET 06 50% CD SET	

DRAWING TITLE

DETAIL SHEET

SHEET NO.

PROJECT NO. 2009

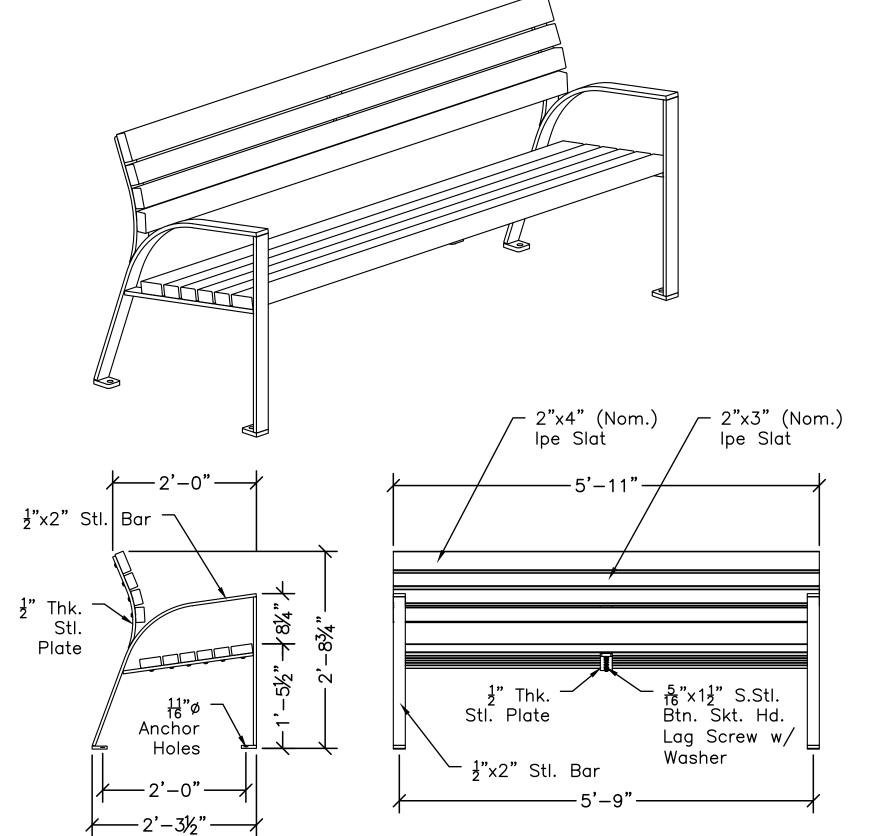

1. Wood and metal bench shall be Bench #270-601 by DuMor, Inc. of Mifflintown PA 17059-0142 (Tel: 717.436.2106); Eva Bench by Victor Stanley of Dunkirk, MD

20754 (Tel: 800.368.2573); Bench 870 (Model #MBE-0870-00025 by Maglin Site Furniture of Woodstock, ON (Tel: 800.716.5506 x5070); or Approved Equal.

2. Bench shall be available with surface-mounted and sub-floor (S-4 Type) mounting options. 3. Bench shall have a powdercoat

steel frame and ipe (or equivalent in the sole judgement of the Landscape Architect) wood slats. 4. All steel members to be polyester

powder coated. Color to be selected from standard colors. Touch-up Paint Kit to be provided. 5. All welds to be continuous and

then ground smooth.

6. All benches shall be shipped fully

7. $\frac{1}{2}$ "x $3\frac{3}{4}$ " Expansion Anchor bolts shall be provided by Manufacturer.

8. Installation to be completed in accordance with Manufacturer's Specifications.


9. Contractor to touch up all damage to finished with manufacturer's provided touch up kit.


10. Shim to make level. Use threadlocking adhesive to prevent


loosening.


SHOP DRAWINGS REQUIRED

BACKED BENCH SCALE: 3/4" = 1'-0"

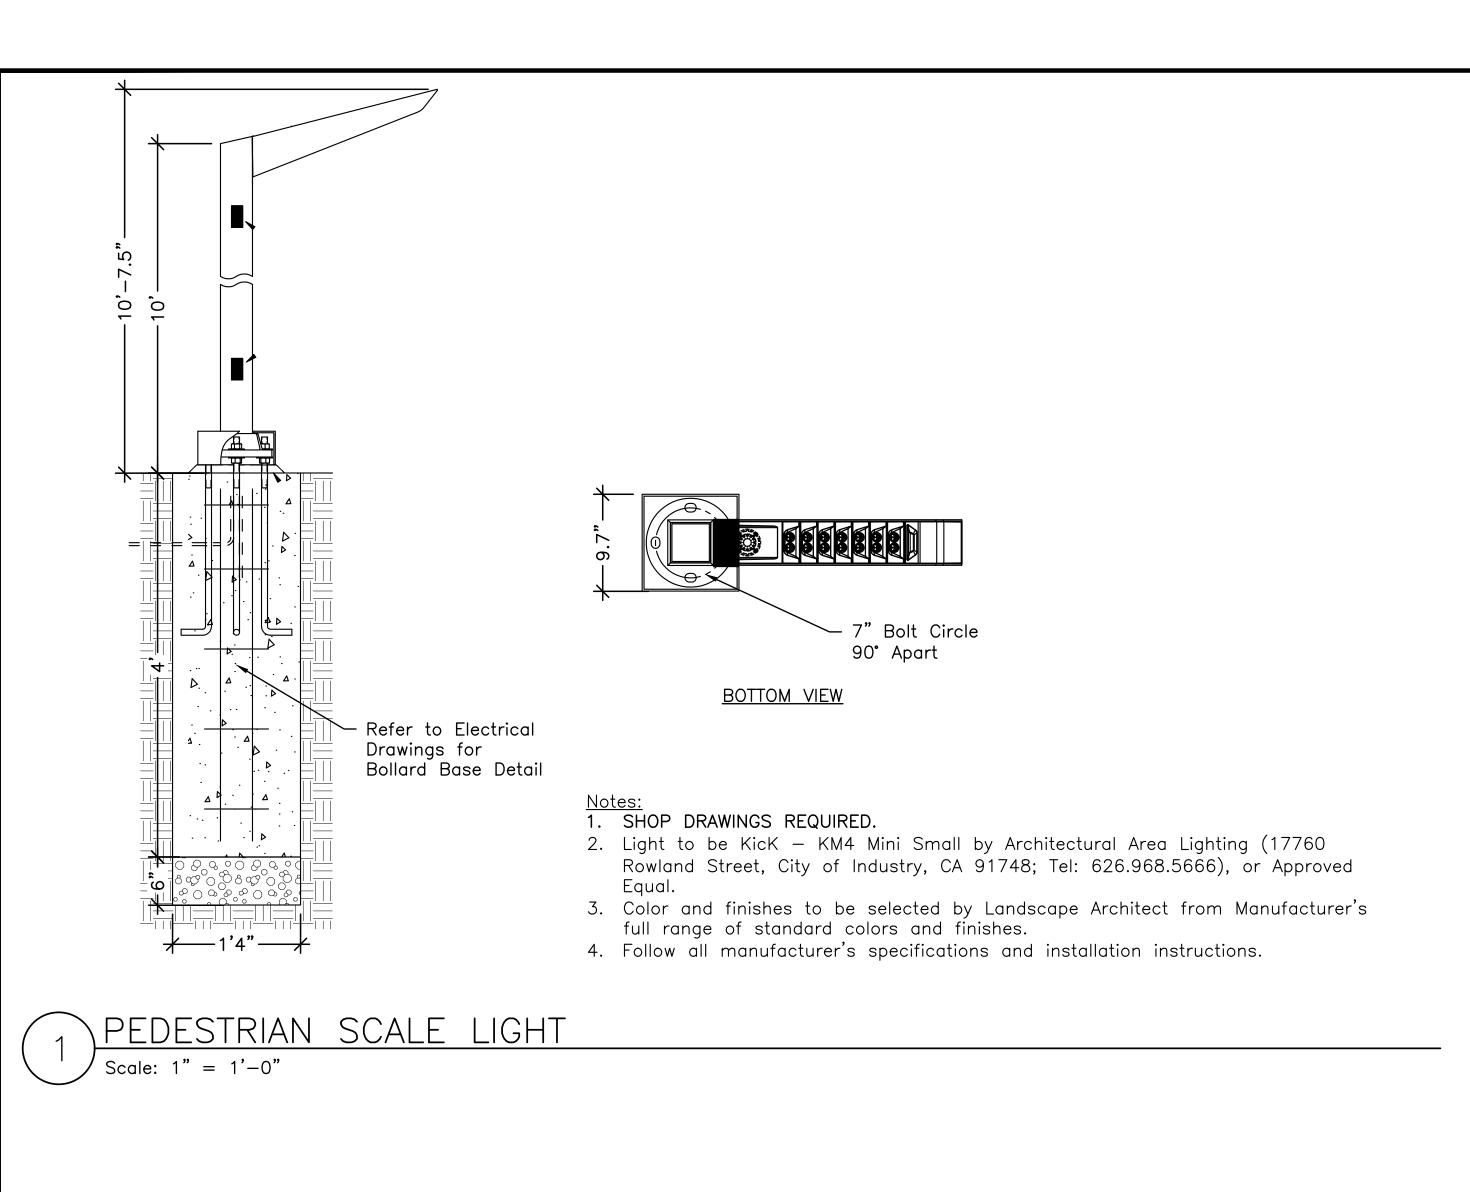

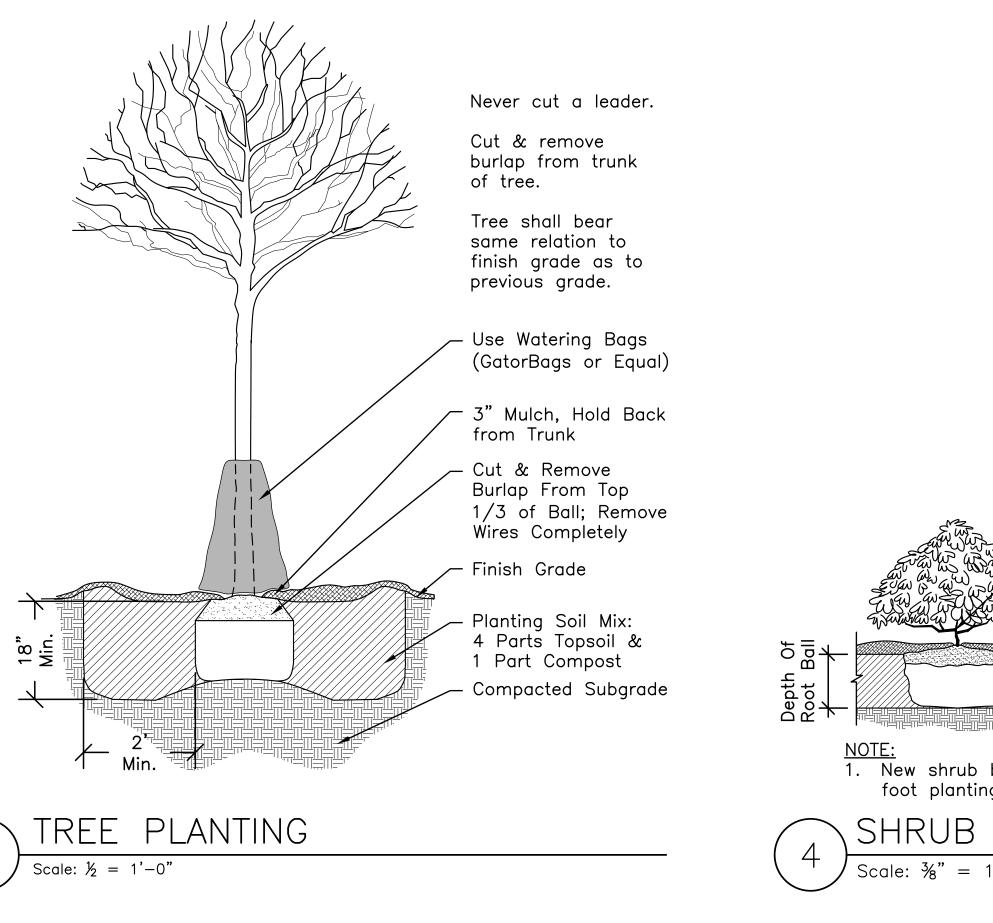

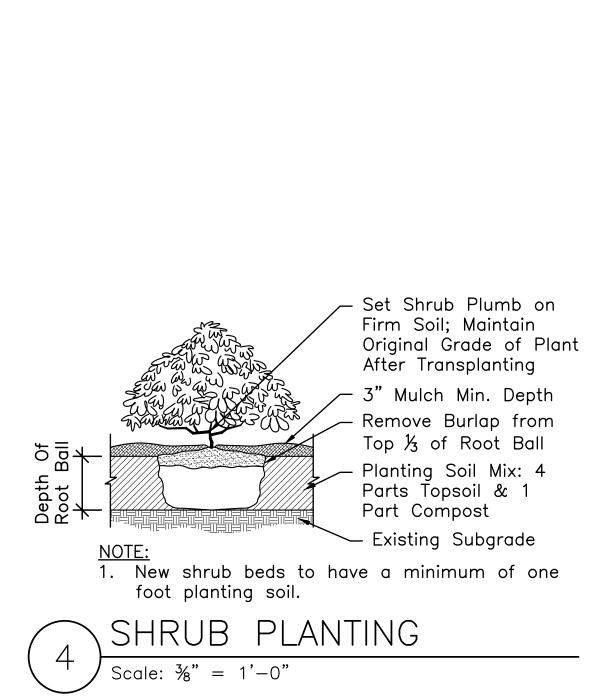

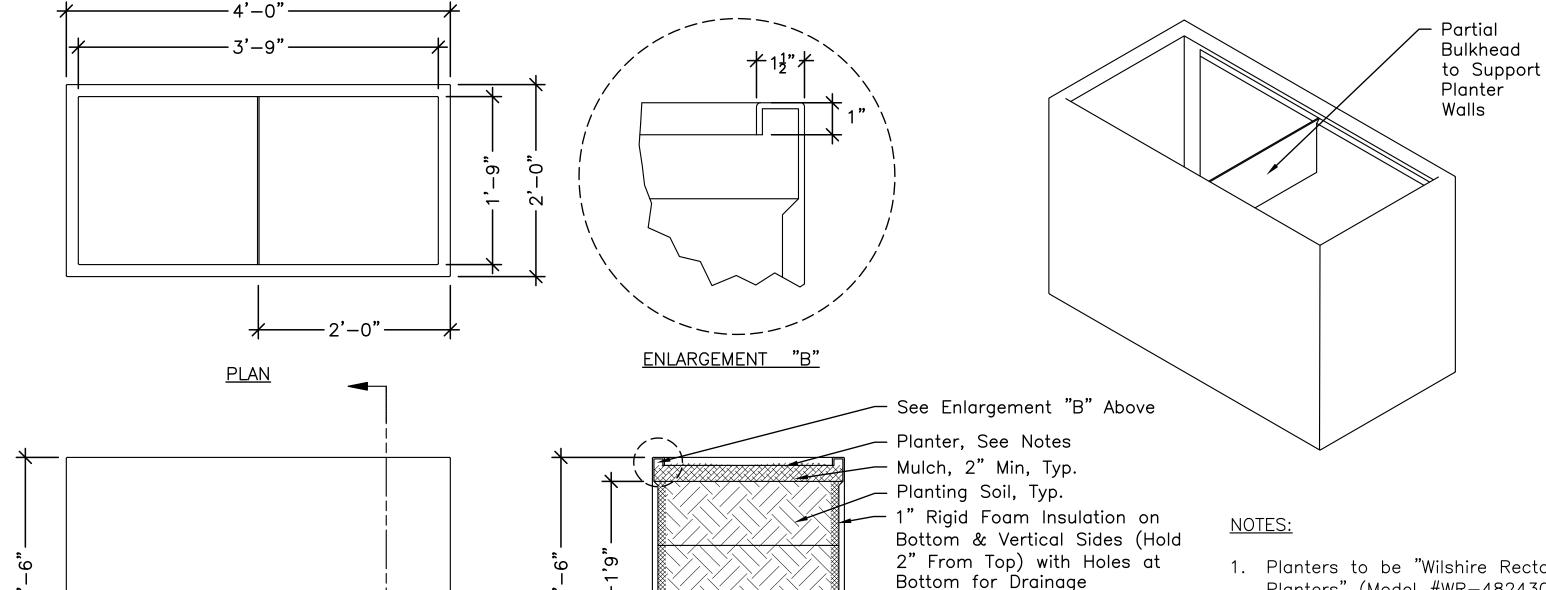

SECTION

Filter Fabric, Typ.

– Gravel for Drainage, Typ. –

Submit Sample for Approval

TALL INSULATED PLANTER


ELEVATION



1. Planters to be "Wilshire Rectangular Planters" (Model #WR-482430) by Tournesol Siteworks.

2. Material to be Fiberglass Reinforced Plastic (FRP), finish, and color(s) to be selected by Landscape Architect.

3. All planters to be irrigated with drip system (See irrigation notes).
Dripperline: Netafim TLDL-6-18 will be used and stabled every 2' with 100 PSI 1" Poly Pipe for poly lateral

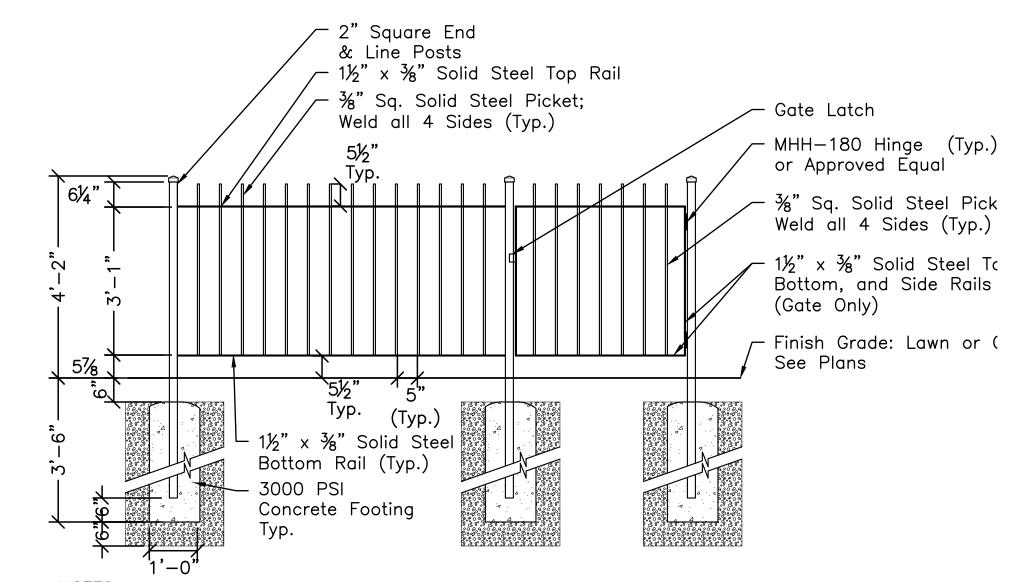

NOTES:

1. SHOP DRAWINGS REQUIRED.

2. New ornamental fence should match the refurbished existing ornamental iron fence in design

3. Sections to be bolted to posts. DO NOT weld sections to posts.

4. Provide new posts if existing posts cannot be salvaged. Pour new footings per detail above.

5. Prime & paint with (2) two coats of epoxy paint. (Color to be black.)

6. Weld and grind smooth all edges and joints. All edges to be hand smoothed. All welds to be continuous; no spot or tack welds.
7. See Sheet and Specifications for more information

ORNAMENTAL STEEL GATE AND FENCE

Scale: ½" = 1'-0"

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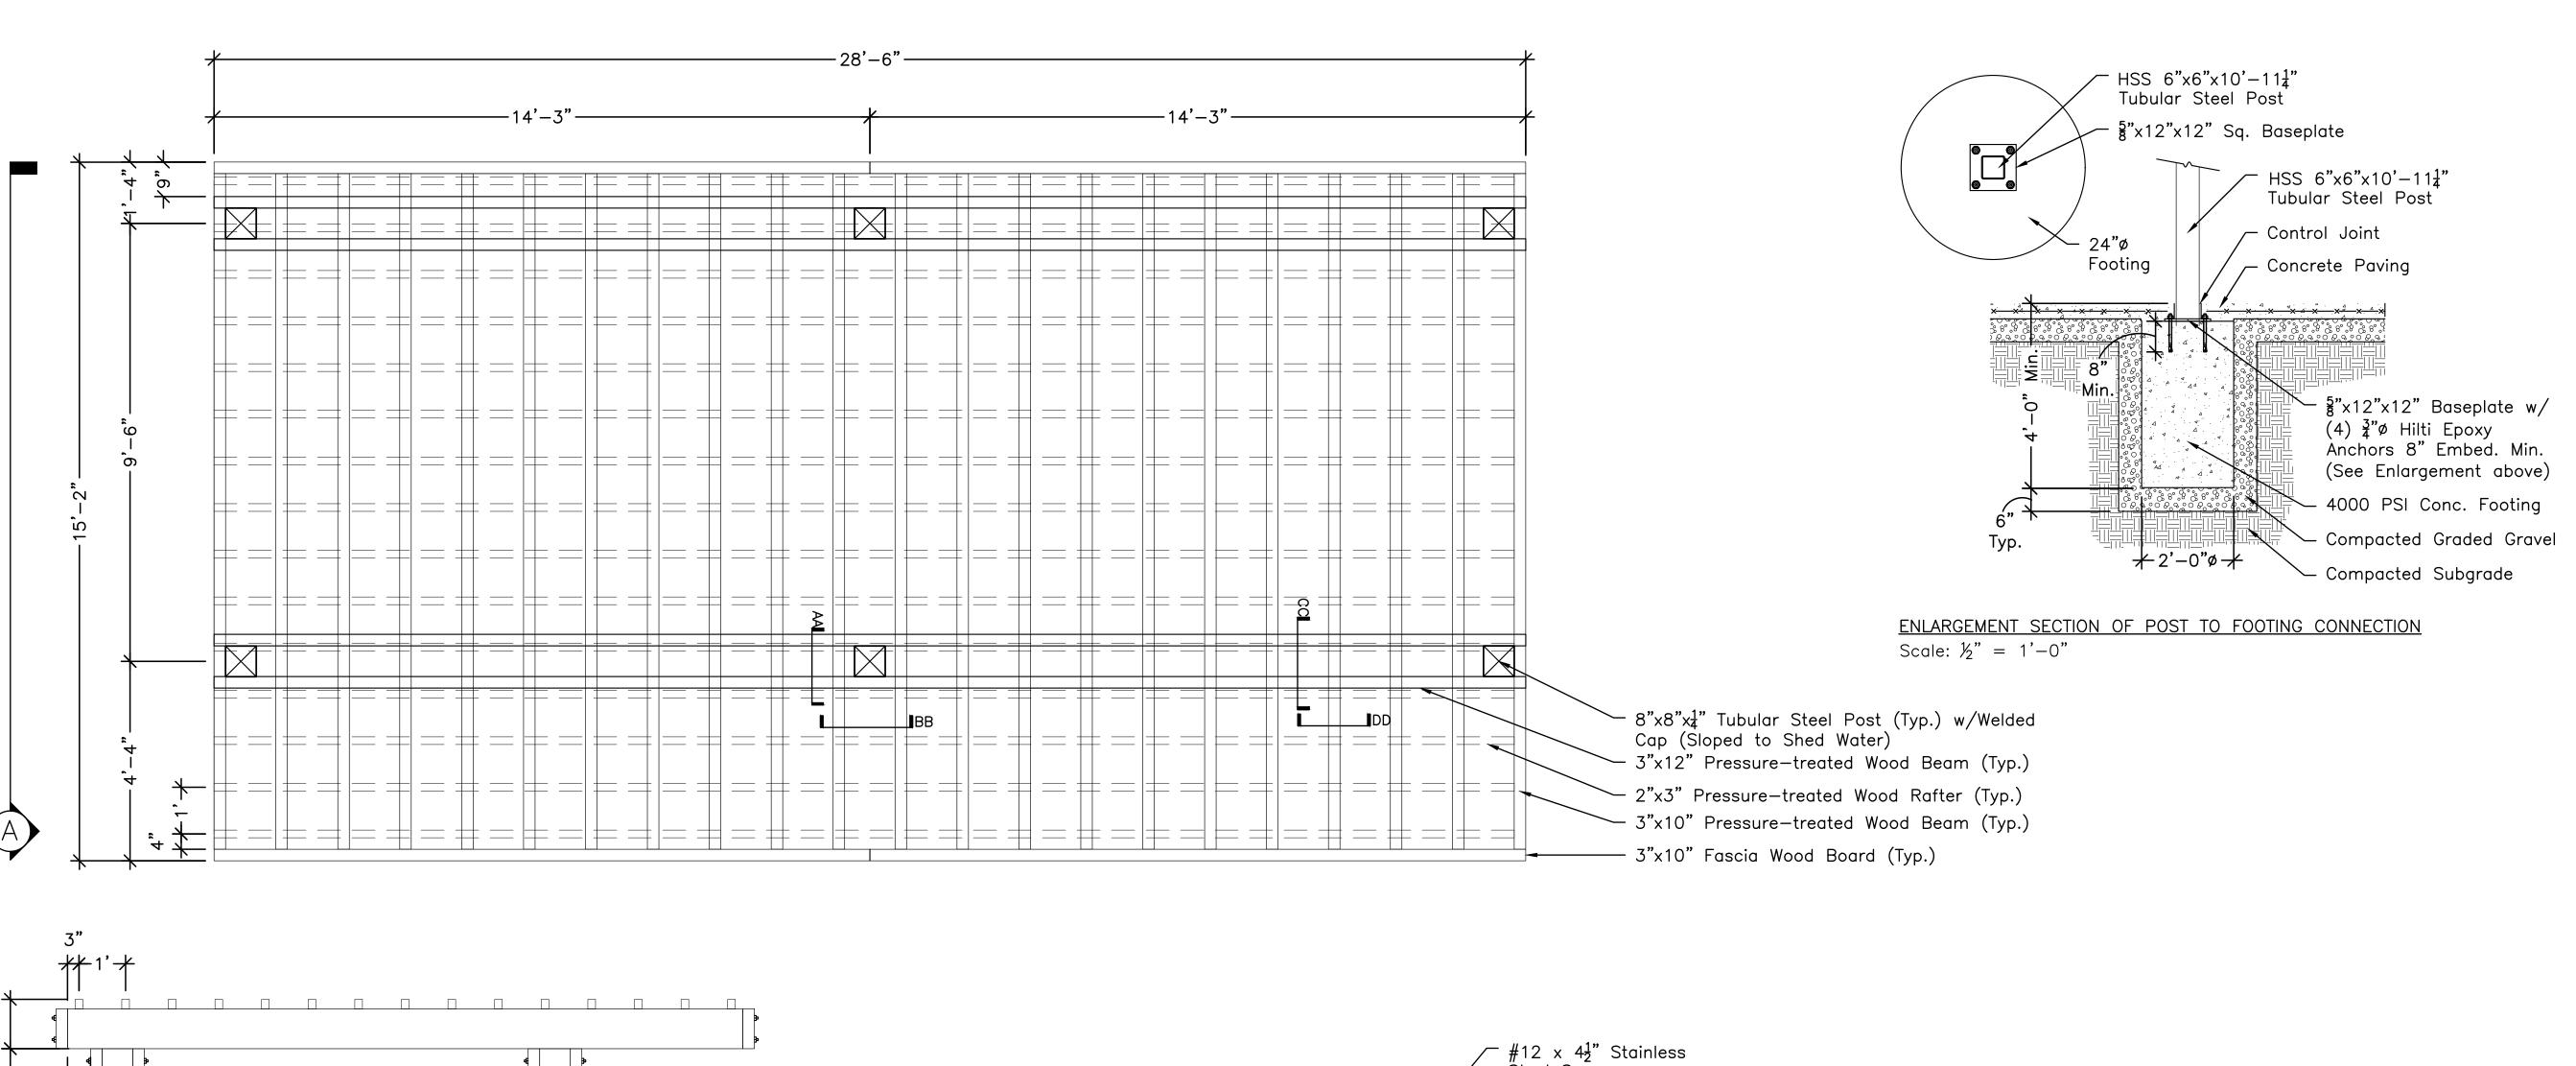
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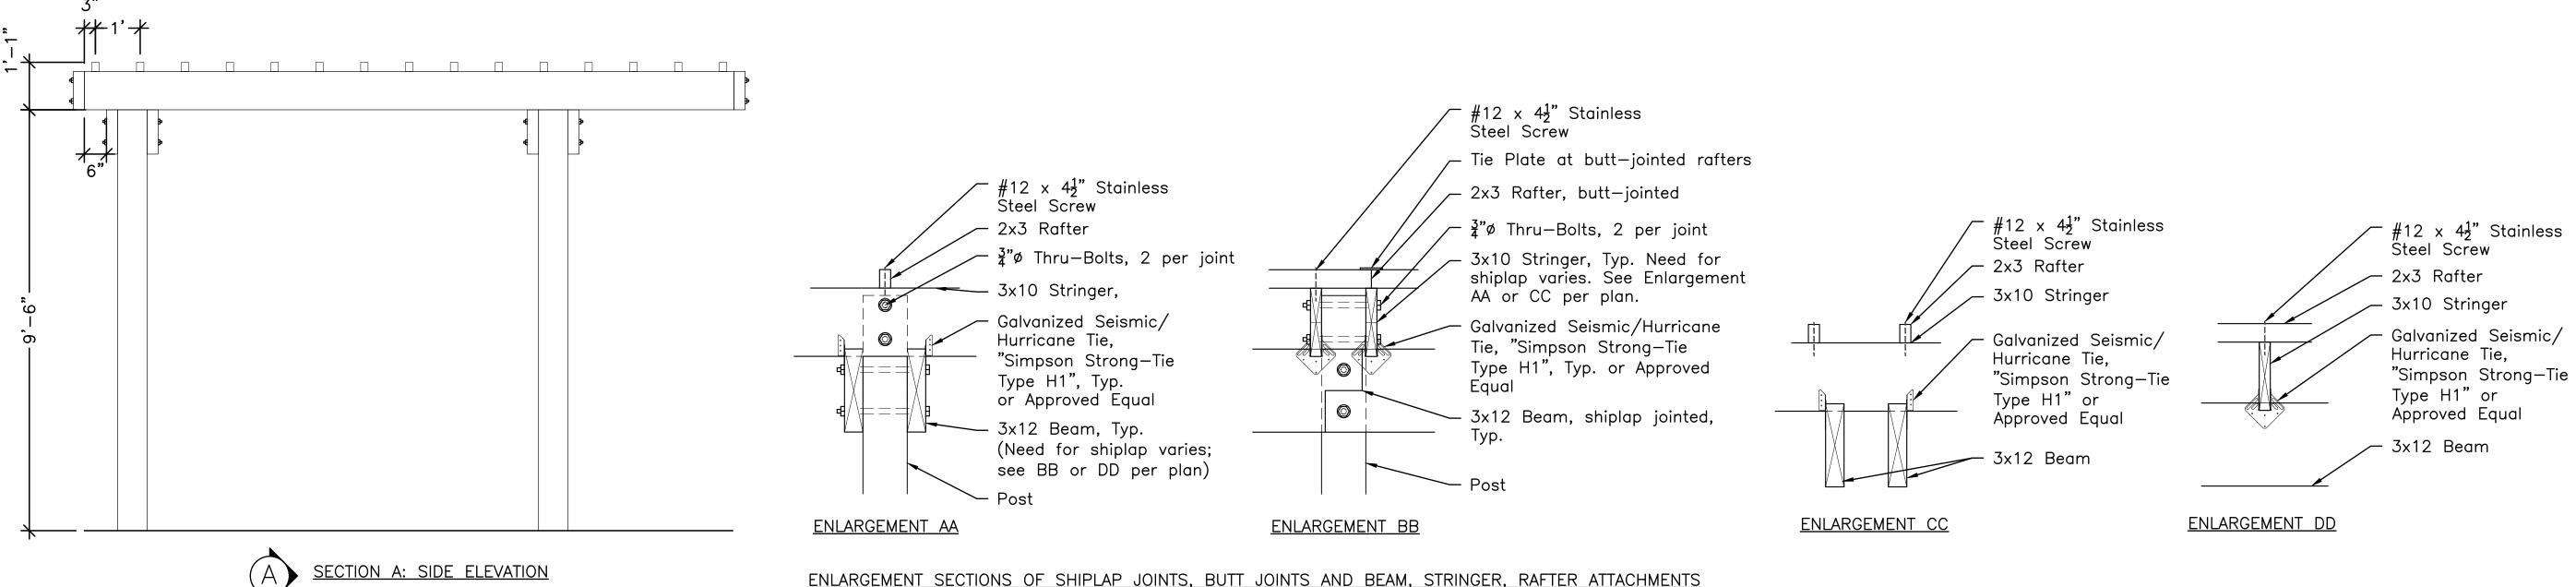
ISS		
No.	Description	Date
01	EXISTING CONDITIONS	02/27/20
02	50% PRICING SET	04/02/20
03	50% SCHEMATIC SET	04/17/20
04	SCHEMATIC PRICING SET	05/21/20
05	SCHEMATIC PRICING SET	06/03/20
06	50% CD SET	07/20/20
07	90% CD SET	08/28/20

DRAWING TITLE

DETAIL SHEET

SHEET NO.






1. <u>SHOP DRAWINGS REQUIRED.</u> Submit drawings for approval by Landscape Architect before ordering material.

- 2. Metal finish shall be a color galvanized finish or Approved Equal. Color to be be selected by Landscape Architect. 3. All fasteners shall be tamperproof hardware, galvanized or stainless steel, suitable for use with pressure—treated lumber where necessary.
- 4. Exposed fasteners on metal components shall be painted or powdercoated to match the finished metal assembly.
- 5. Wood members shall be pressure—treated (non—CCA) No. 2 Southern Yellow Pine or Approved Equal wood with a minimum Fb of 1050 psi. Submit proposed preservative for Approval. Except for joints as indicated on the drawings, all wood members shall be a single piece, free of knots or damage that would impair structural integrity of the sizes and nominal dimensions shown on the Drawings.

Not to Scale

6. Top of beams to be notched where beam and stringers meet.

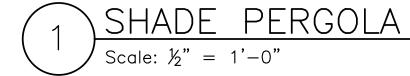

CAMBRIDGE HOUSING **AUTHORITY**

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RRY S. TRUMAN APARTMENTS

FOR PRICING ONLY NOT FOR CONSTRUCTION

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Issue

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